



BEGIN PROJECT NO. 0063-0737
 BEGIN MILL AND OVERLAY
 MATCH EXISTING PAVEMENT
 STA. 27+86.32
 N 839687.451'
 E 1022168.179'
 MATCH EXISTING

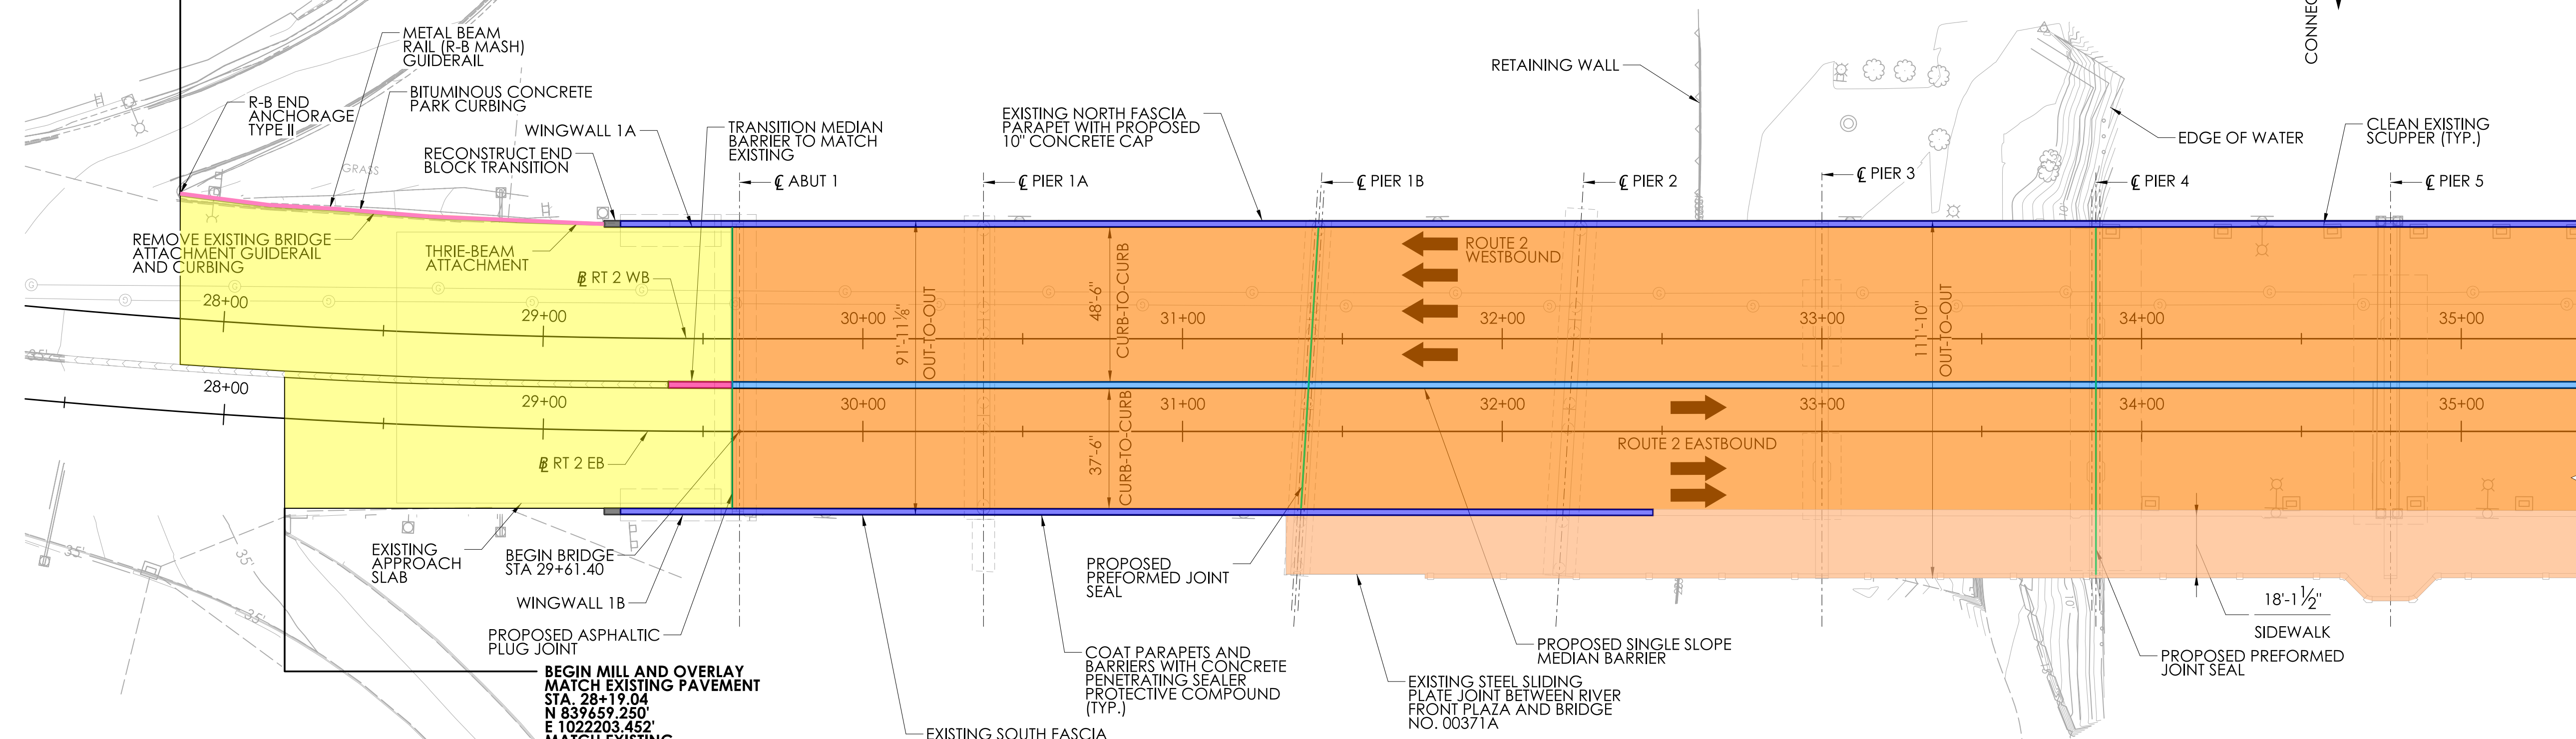

GENERAL PLAN
 SCALE: 1" = 30'-0"

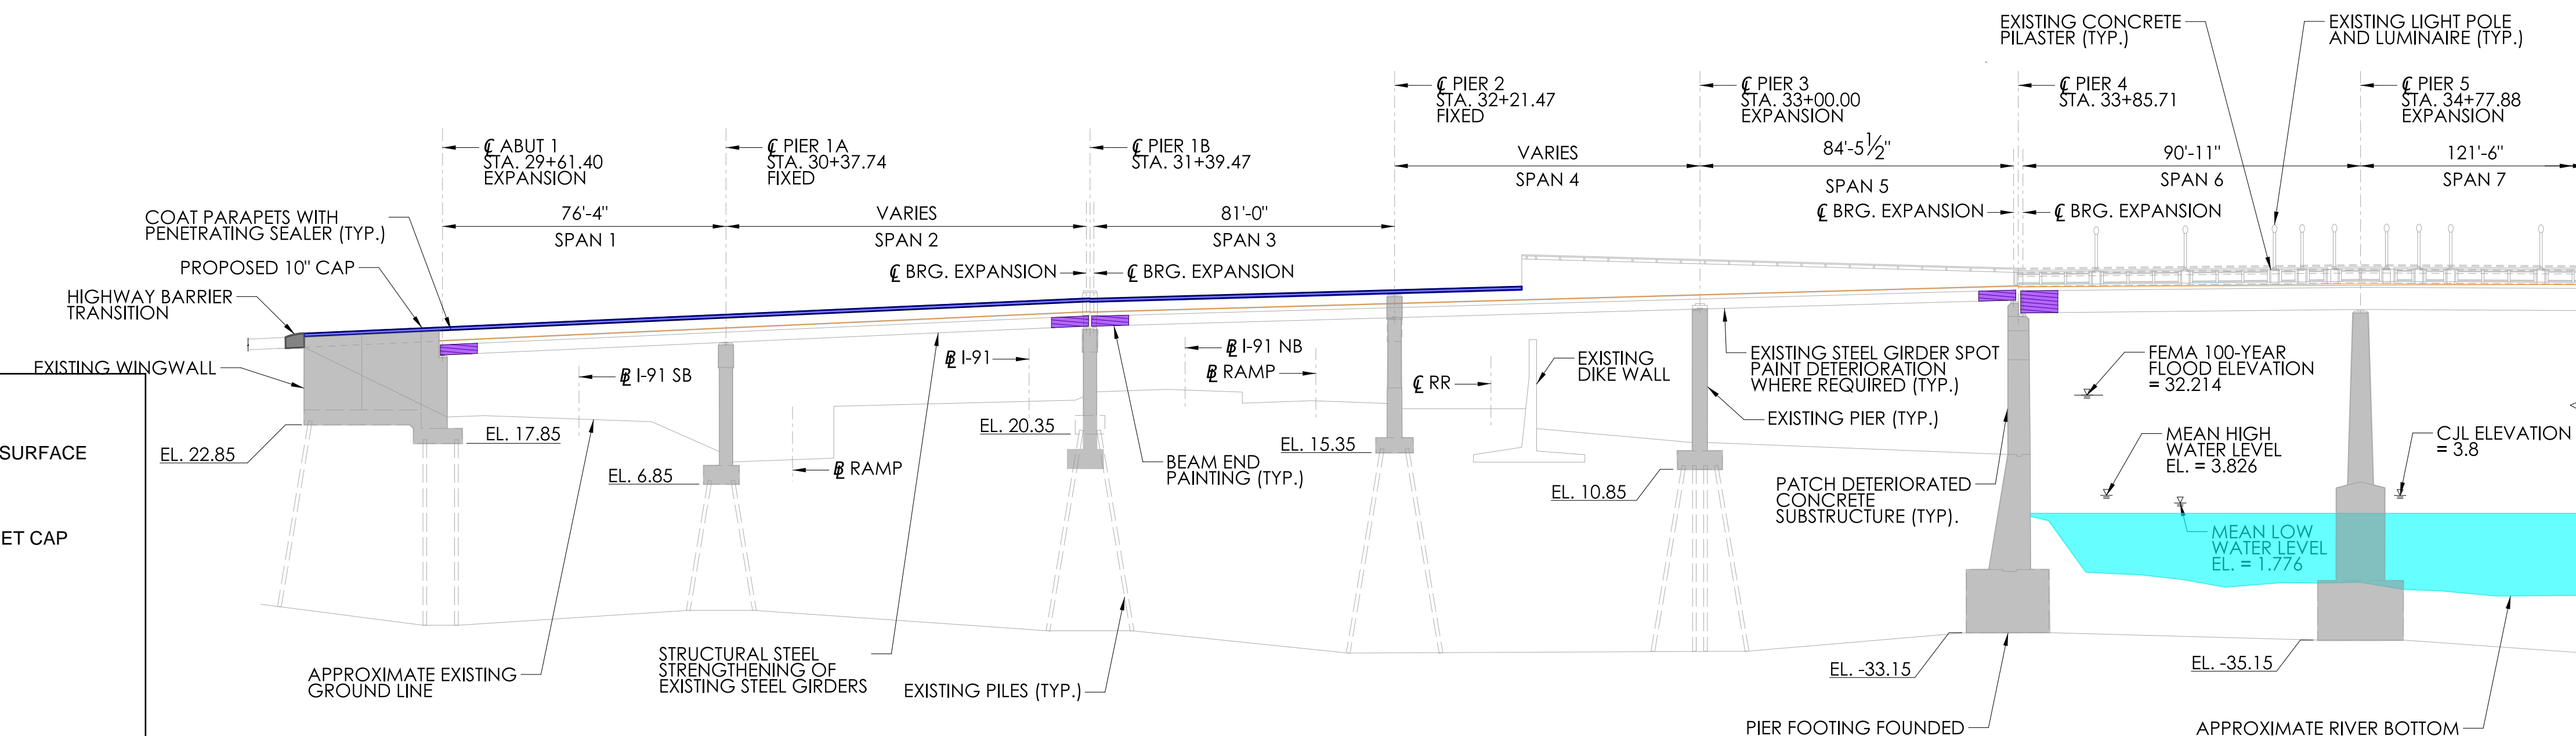

SOUTH ELEVATION
 SCALE: 1" = 30'-0"

LEGEND:


	PROPOSED BRIDGE WEARING SURFACE
	PROPOSED APPROACH WORK
	PROPOSED CONCRETE PARAPET CAP
	PROPOSED MEDIAN BARRIER
	EXISTING SIDEWALK
	BEAM END PAINTING
	PROPOSED DECK JOINT
	RECONSTRUCTED END BLOCK TRANSITION
	PROPOSED MEDIAN BARRIER TRANSITION
	PROPOSED METAL BEAM RAIL
	EXISTING SUBSTRUCTURE TO BE PATCHED
	WATERCOURSE

REV.	DATE	REVISION DESCRIPTION

REHABILITATION STUDY REPORT




DESIGNER/DRAFTER: CLR CHECKED BY: RRC

SIGNATURE/BLOCK:

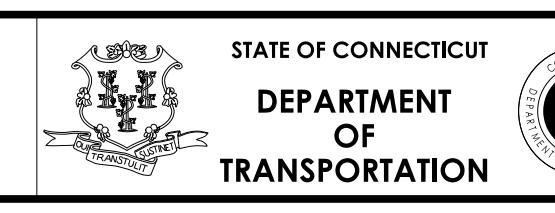

PROJECT NUMBER: 0063-0737
 PROJECT DESCRIPTION: REHABILITATION OF BRIDGE NO. 00371A ROUTE 2 OVER I-91, CONNECTICUT RIVER AND CONNECTICUT SOUTHERN RAILROAD
 TOWN(S): HARTFORD AND EAST HARTFORD
 DRAWING TITLE: GENERAL PLAN AND ELEVATION I


DRAWING NO. S-02
 SHEET NO.

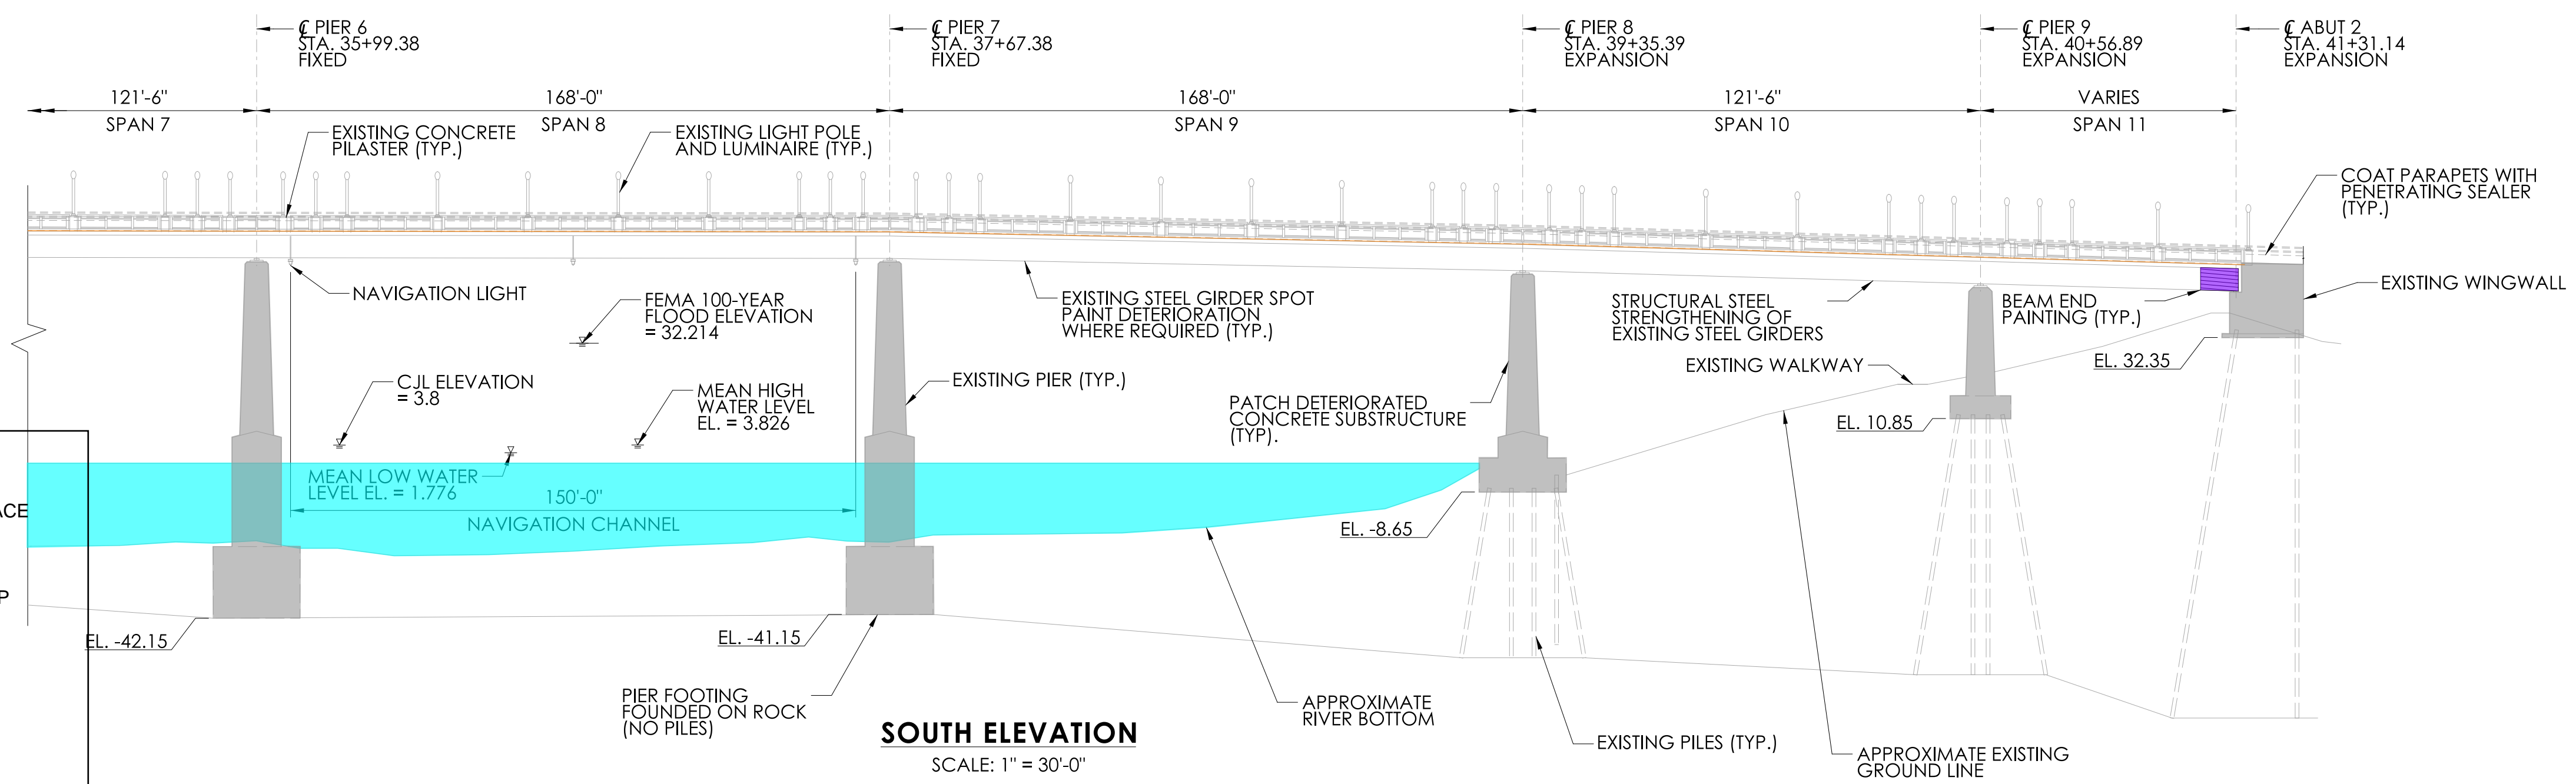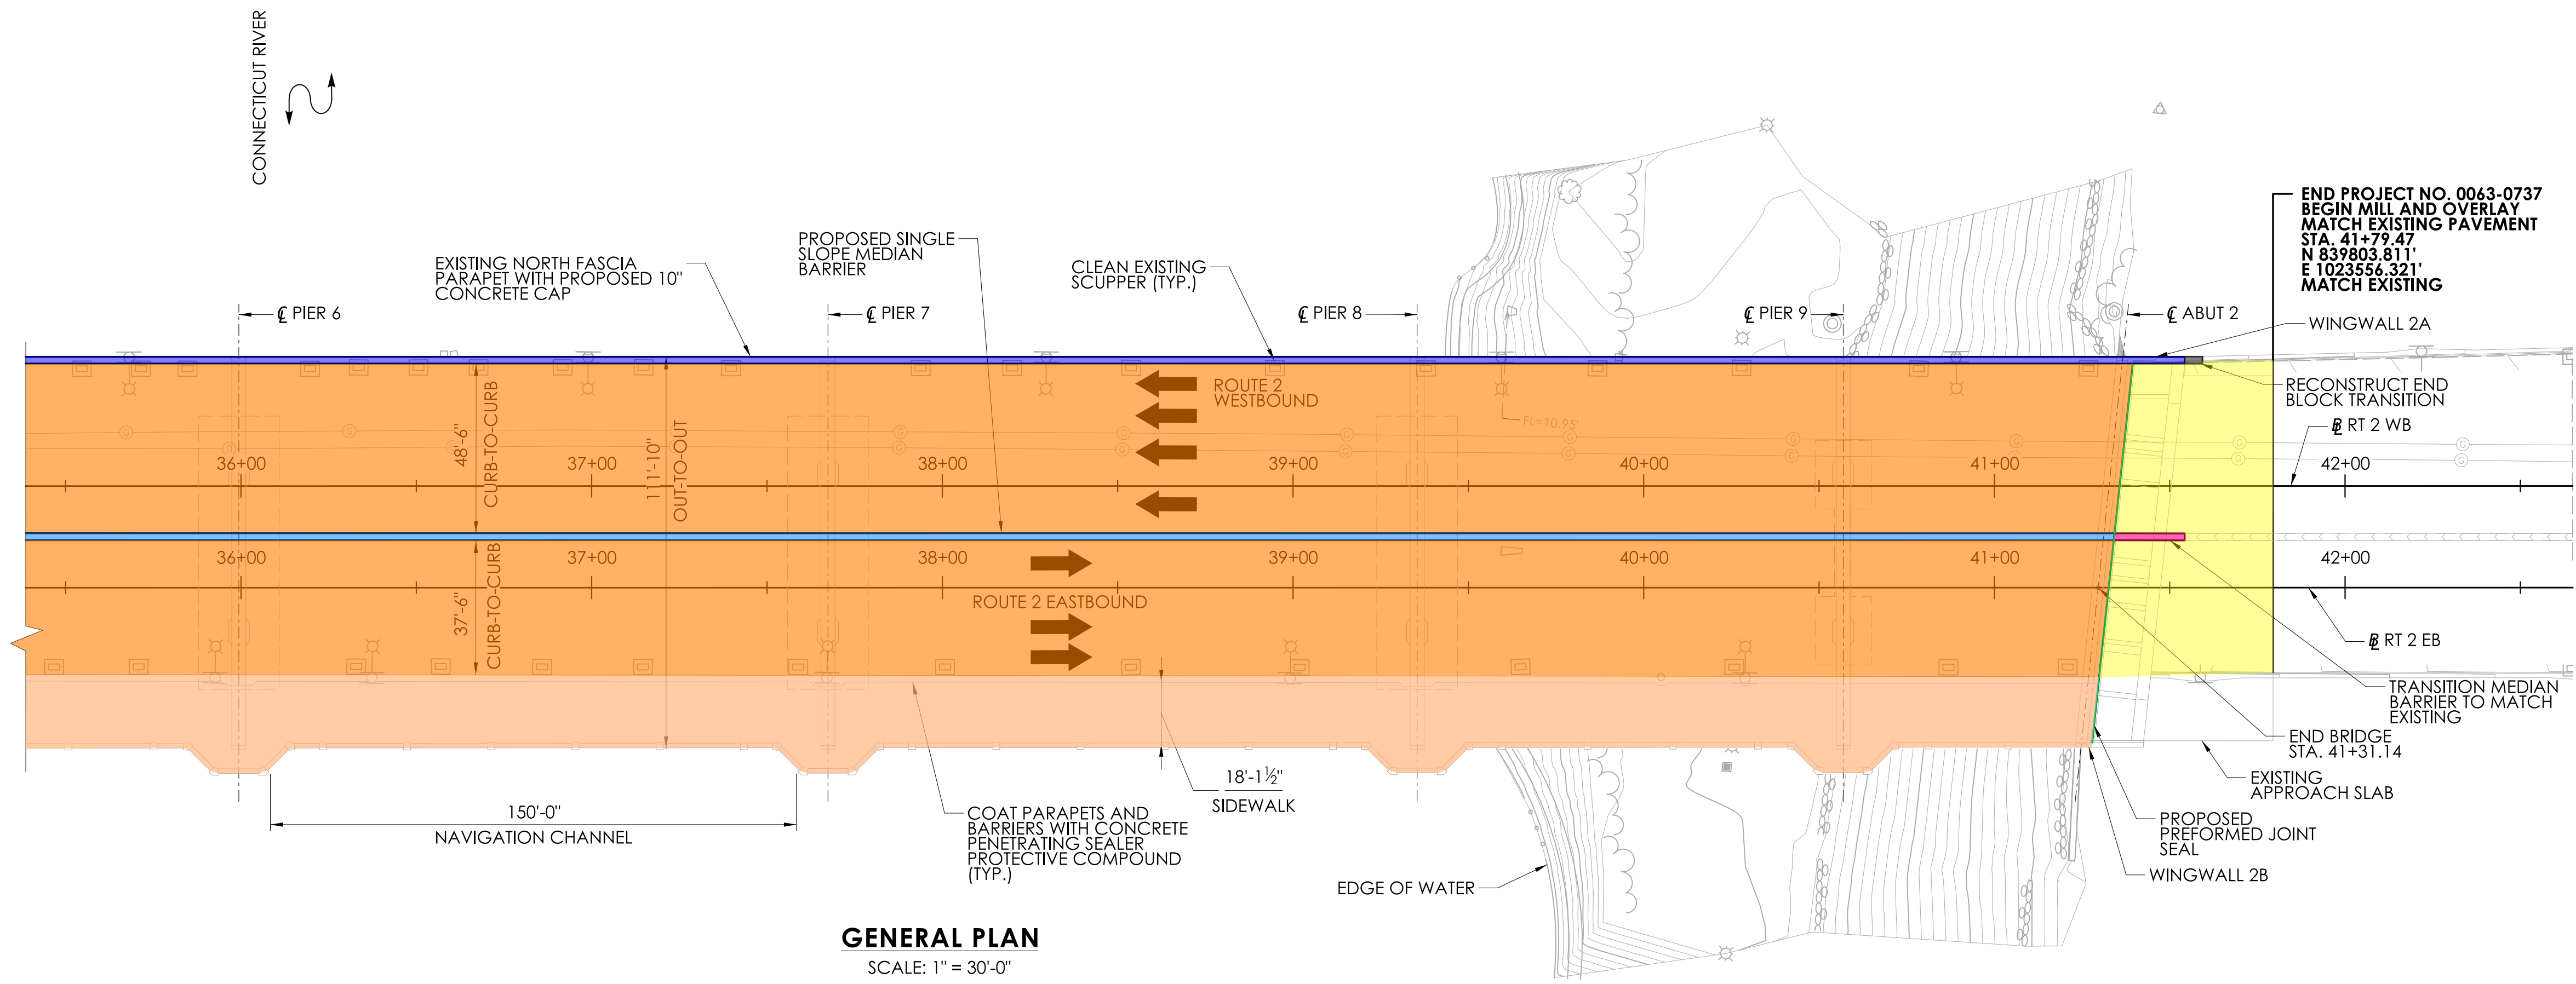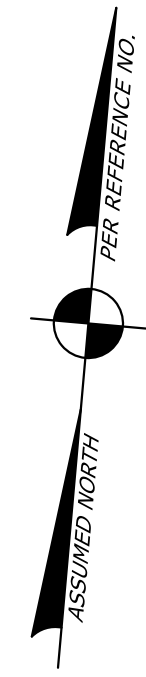

- LEGEND:**
- PROPOSED BRIDGE WEARING SURFACE
 - PROPOSED APPROACH WORK
 - PROPOSED CONCRETE PARAPET CAP
 - PROPOSED MEDIAN BARRIER
 - EXISTING SIDEWALK
 - BEAM END PAINTING
 - PROPOSED DECK JOINT
 - RECONSTRUCTED END BLOCK TRANSITION
 - PROPOSED MEDIAN BARRIER TRANSITION
 - PROPOSED METAL BEAM RAIL
 - EXISTING SUBSTRUCTURE TO BE PATCHED
 - WATERCOURSE


END PROJECT NO. 0063-0737
 BEGIN MILL AND OVERLAY
 MATCH EXISTING PAVEMENT
 STA. 41+79.47
 N 839803.811'
 E 1023556.321'
 MATCH EXISTING

REV.	DATE	REVISION DESCRIPTION

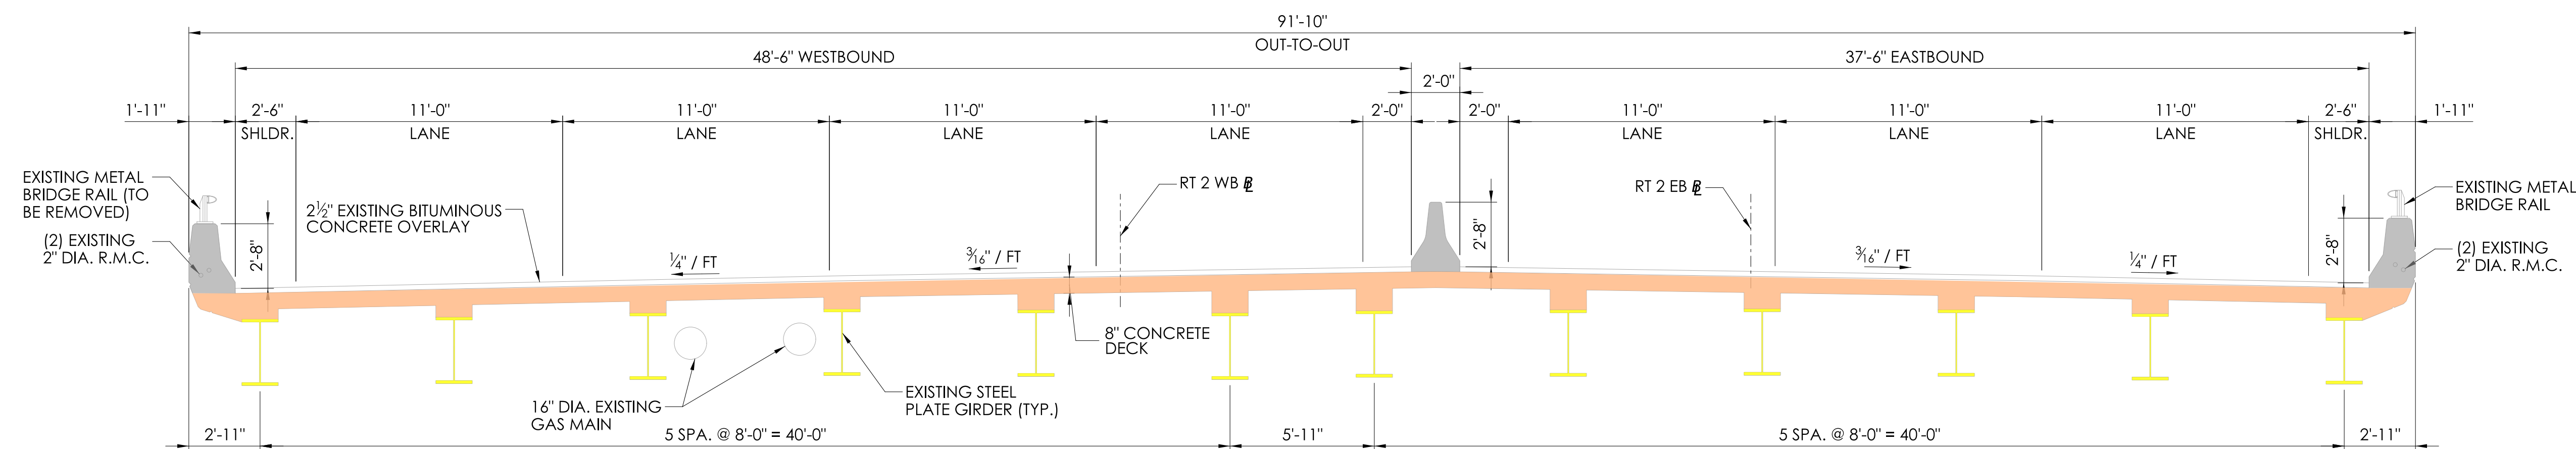

EXISTING TYPICAL SECTION SPANS 1 TO 5

SCALE: 1/4" = 1'-0"
NOTE - TYPICAL SECTION TAKEN AT PIER 3

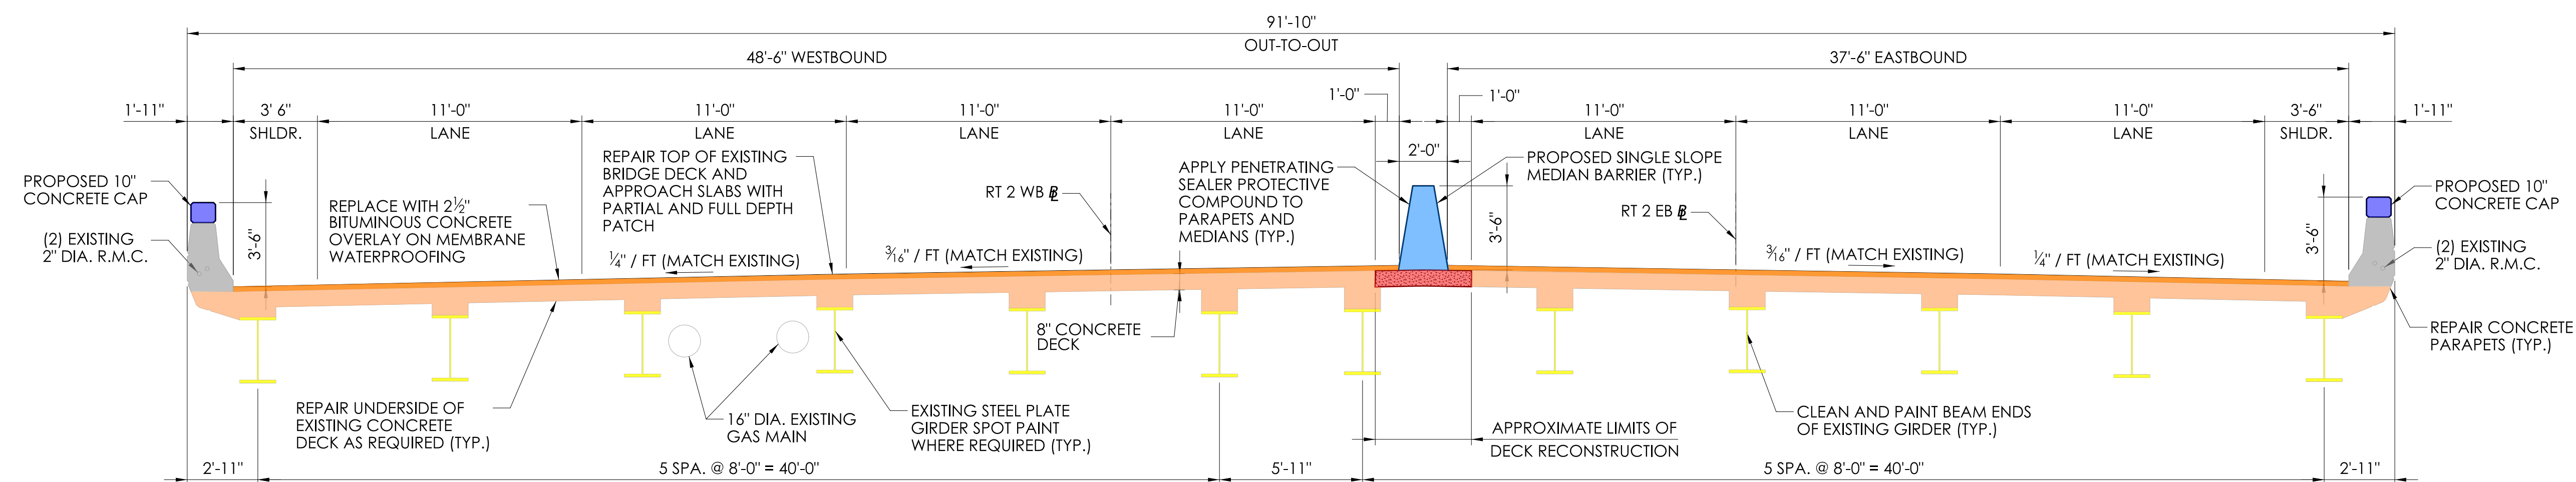

PROPOSED TYPICAL SECTION SPANS 1 TO 5


SCALE: 1/4" = 1'-0"

- LEGEND:**
- PROPOSED BRIDGE WEARING SURFACE
 - EXISTING BRIDGE DECK
 - PROPOSED DECK RECONSTRUCTION
 - PROPOSED CONCRETE PARAPET CAP
 - PROPOSED MEDIAN BARRIER
 - EXISTING PARAPETS AND BARRIERS
 - EXISTING STEEL GIRDERS

REHABILITATION STUDY REPORT

DESIGNER/DRAFTER: CLR CHECKED BY: RRC

SIGNATURE/BLOCK:

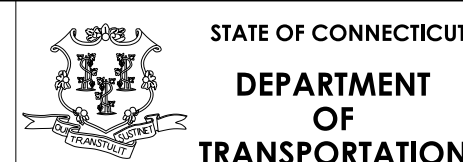

PROJECT NUMBER: 0063-0737

PROJECT DESCRIPTION: REHABILITATION OF BRIDGE NO. 00371A ROUTE 2 OVER I-91, CONNECTICUT RIVER AND CONNECTICUT SOUTHERN RAILROAD


TOWN(S): HARTFORD AND EAST HARTFORD

DRAWING TITLE: TYPICAL SECTION SHEET 1 OF 2

DRAWING NO.


S-04

SHEET NO.

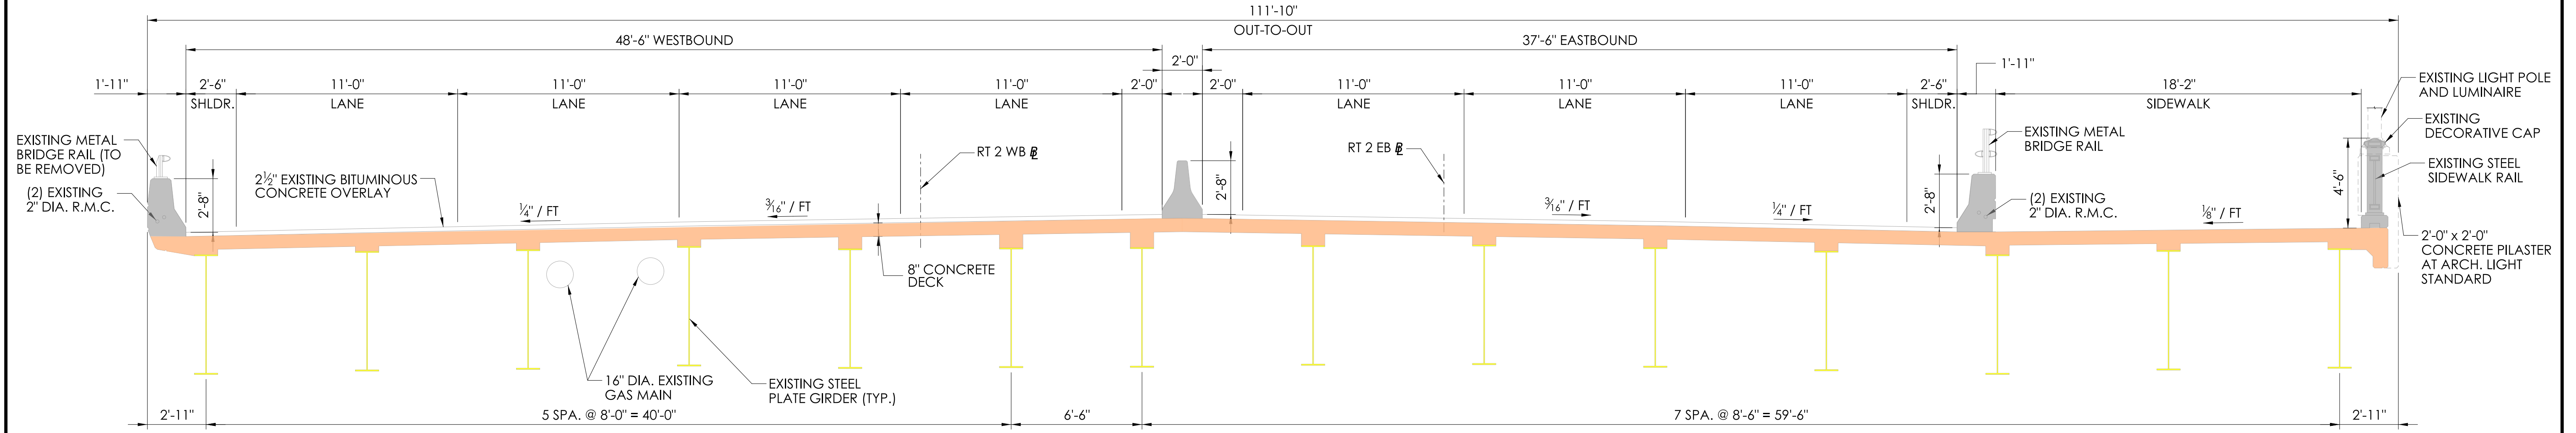

EXISTING TYPICAL SECTION SPANS 6 TO 11

SCALE: 1/4" = 1'-0"
NOTE - TYPICAL SECTION TAKEN AT PIER 9

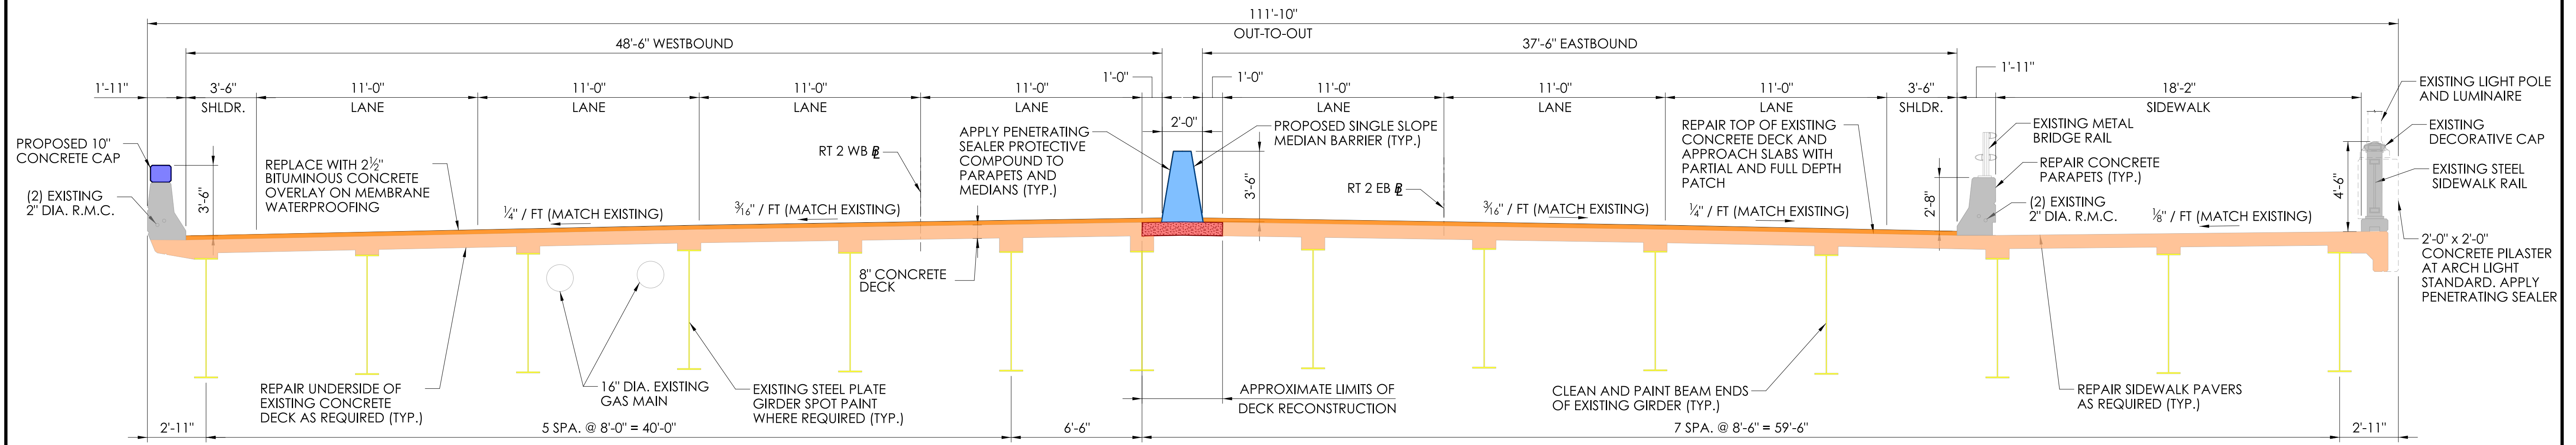

PROPOSED TYPICAL SECTION SPANS 6 TO 11

SCALE: 1/4" = 1'-0"


LEGEND:

- PROPOSED BRIDGE WEARING SURFACE
- EXISTING BRIDGE DECK
- PROPOSED DECK RECONSTRUCTION
- PROPOSED CONCRETE PARAPET CAP
- PROPOSED MEDIAN BARRIER
- EXISTING PARAPETS AND BARRIERS
- EXISTING STEEL GIRDERS

REHABILITATION STUDY REPORT

DESIGNER/DRAFTER: CLR CHECKED BY: RRC

SIGNATURE/ BLOCK:

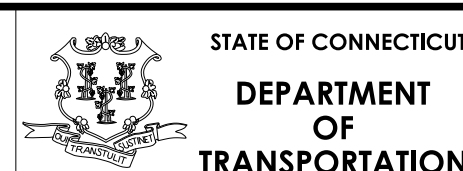

PROJECT NUMBER: 0063-0737
PROJECT DESCRIPTION: REHABILITATION OF BRIDGE NO. 00371A ROUTE 2 OVER I-91, CONNECTICUT RIVER AND CONNECTICUT SOUTHERN RAILROAD
TOWN(S): HARTFORD AND EAST HARTFORD
DRAWING TITLE: TYPICAL SECTION SHEET 2 OF 2

DRAWING NO. S-05
SHEET NO.