
# **ENVIRONMENTAL PERMIT PLANS STATE PROJECT 000-999 ROUTE ZZ AT A ROAD AND B STREET** CITY OF

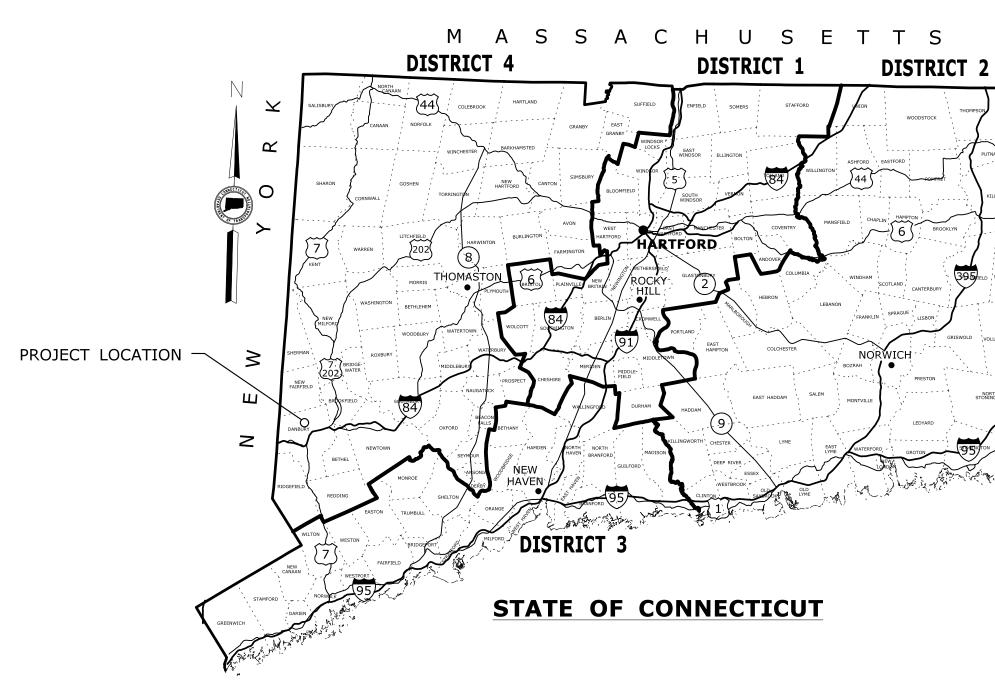

### **GENERAL NOTES:**

1. THESE PLANS ARE NOT FOR CONSTRUCTION AND ARE INTENDED ONLY FOR ENVIRONMENTAL PERMITTING PURPOSES. THESE PLANS HOLD AUTHORITY FOR ALL ACTIVITIES CONCERNING THE REGULATED AREA. FOR DETAILED PLANIMETRIC INFORMATION AND PAYMENT REFER TO THE APPLICABLE CONTRACT DOCUMENTS.

2. THE DEPARTMENT OF TRANSPORTATION WILL ONLY SUBMIT REVISIONS TO CTDEEP AND USACE FOR CHANGES TO THE DESIGN THAT WILL AFFECT REGULATED AREAS.

3. FOR A DESCRIPTION OF THE WATERCOURSES, WETLAND AND WETLAND SOILS SEE RELEVANT SECTIONS OF THE PERMIT APPLICATION.

4. 400 FOOT GRID BASED ON CONNECTICUT COORDINATE SYSTEM N.A.D. 1983 VERTICIAL DATUM BASED ON N.A.V.D. OF 1988.

5. ALL CONSTRUCTION ACTIVITIES WILL BE CONDUCTED IN ACCORDANCE WITH THE DEPARTMENT'S STANDARD SPECIFICATIONS FOR ROADS, BRIDGE, AND INCIDENTAL CONSTRUCTION, FORM 818, SECTION 1.10 AND WILL ALSO FOLLOW REQUIRED BEST MANAGEMENT PRACTICES (BMPs) AND SEDIMENT AND EROSION CONTROL MEASURES IN ACCORDANCE WITH THE 2002 EROSION & SEDIMENTATION CONTROL GUIDELINES AND THE 2004 STORMWATER QUALITY MANUAL.

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					DESIGNER/DRAFTER:
				THE INFORMATION, INCLUDING ESTIMATED QUANTITIES OF WORK, SHOWN ON THESE	
				SHEETS IS BASED ON LIMITED INVESTIGATIONS BY THE STATE AND IS	CHECKED BY:
				IN NO WAY WARRANTED TO INDICATE THE CONDITIONS OF ACTUAL QUANTITIES	
				OF WORK WHICH WILL BE REQUIRED.	
					SCALE AS NOTED
REV.	DATE	REVISION DESCRIPTION	SHEET NO.	Plotted Date: 9/27/2022	

### GUIDE FOR THE DEVELOPMENT OF THE PERMIT PLAN SET

NOTE: For additional information, see also the Department's Office of Environmental Planning webpage, Environmental Permitting Unit, for the Permit Plan Set Checklist

# SAMPLE PROJECT USED FOR PLANS

The following sample is a roadway improvement project approximately 2,100 feet long. This specific project includes roadway realignment, storm drainage improvements, and approx. 0.24 ac. of wetland impacts. For this specific project, no water handling, staging plans, flood impact plans, or planting plans were required. Control of invasive species is included in the project.

The following permits are anticipated for this project:

DEEP General Permit for Water Resource Construction Activities (LWRD GP) DEEP GP for Stormwater & Dewatering Wastewaters from Construction Activities (Must be completed in ezFile. Contact EPC Unit for information) US Army Corps of Engineers Pre-Contruction Notice (USACE PCN) DEEP PCN (Concurrence of Eligibility DEEP PCN GP)

Environmental impact areas include ALL areas to be impacted due to the project construction and activities related to the project, both temporary and permanent. Engineering judgement should be used to determine the amount of area the contractor needs to perform the work, while trying to minimize the disturbance to the wetland resources. The designer should also evaluate utility work needed as part of the project and include any impacts due to project related utility work. In addition, evaluate the need for stormwater control and ensure enough area for the contractor to incorporate.

**T** Any associated impacts for stormwater control are to be included.

• NOTE: This sample project has been altered from the actual project to produce this sample set of plans.

NOTE: For alternative layouts of long linear projects with few impact areas, an overall m project map can be shown (reduced scale, similar to the index plan) along with the necessary additional plan sheets which show the specific impact areas (at a scale that can clearly show work in the regulated area. ie. 1"=20'; 1"=40')

### Title Sheet:

- 1. Location Plan at an appropriate scale that shows project location and nearby cross streets (ex: 1" = 500', 1" = 1000'). For long lateral projects, depict beginning and end of Project (Project Limits). 2. State of Connecticut map with Town shaded and call-out project location.
- 3. General index for "LIST OF DRAWINGS" - for projects requiring a permit planting plan, see "Sample Plans - Culverts"
- on the OEP webpage for a sample layout. - if mitigation is required, coordinate with OEP and Landscape Design early
- in the project design to allow enough time to work through the mitigation process and develop mitigation plans. - for projects involving impact to watercourse(s), a sequence of construction
- and method of water handling shall be included within the plans (not necessarily needed to be its own plan sheet)
- 4. GENERAL NOTES 1-5 (additional notes may be added as appropriate for the project)
- 5. Signature block for Consultant Engineer, if needed.

6. PLAN DATE (Latest revision date of sheet. Dates do not need to match within the plan sheet)

### On All Other Plan Views:

1. Show/bold wetland limits and ordinary high water (OHW) 2. If within a regulated flood zone, show existing flood limit lines on plan views (bold). Identify using the guidance in the "Regulatory Floodplain Delineation, Permit Plan Set' dayed May 2016 which can found on the OEP webpage and summarized here:

- A) Calculated elevation on a FEMA map governs. Label as "FEMA 100-YR FLOOD (CALCULATED)"
- B) Otherwise, show hydraulic analysis elevation. Label "EXISTING 100-YR FLOOD (CALCULATED)"
- C) If no calculations were performed, show mapped FEMA

lines. Label "MAPPED FEMA 100-YR FLOOD LIMIT" 3. Show Floodway lines (if present). This would be graphical from the FEMA map. (If floodplain/floodway appears illogical, designer may consult with H&D regarding possible adjustment in order to depict on plans)

4. Show Cut/Fill limits 5. Flow arrows (existing and proposed)

6. If present in survey file, for inland watercourses, include stream line and/or edge of waterbody (screened with survey file). Not necessary to include for tidal watercourses.


7. For Permit Plans, remove references to Contract Drawings as these drawings are not provided as part of the permit plan set. Remove reference to Specifications/Special Provisions. These documents are not provided to

the regulators unless requested.

PORTANT FOR PERMIT PLAN DEVELOPMEN	IT:
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SIGNER: ELIMINARY PERMIT PLAN DEVELOPMENT SHOULD BE TIATED AFTER THE 30% DESIGN REVIEW HAS BEEN MPLETED. THEREFORE, PLEASE ENSURE ANY **RTINENT/APPLICABLE 30% DESIGN REVIEW** MMENTS ARE INCORPORATED INTO THE PERMIT

	LIST OF DRAWINGS	
DRAWING NO.	DRAWING TITLE	
PMT-01	TITLE SHEET	
PMT-02	INDEX PLAN	
PMT-03-05	GENERAL SITE PLAN	
PMT-06-08	WETLAND IMPACT PLAN	




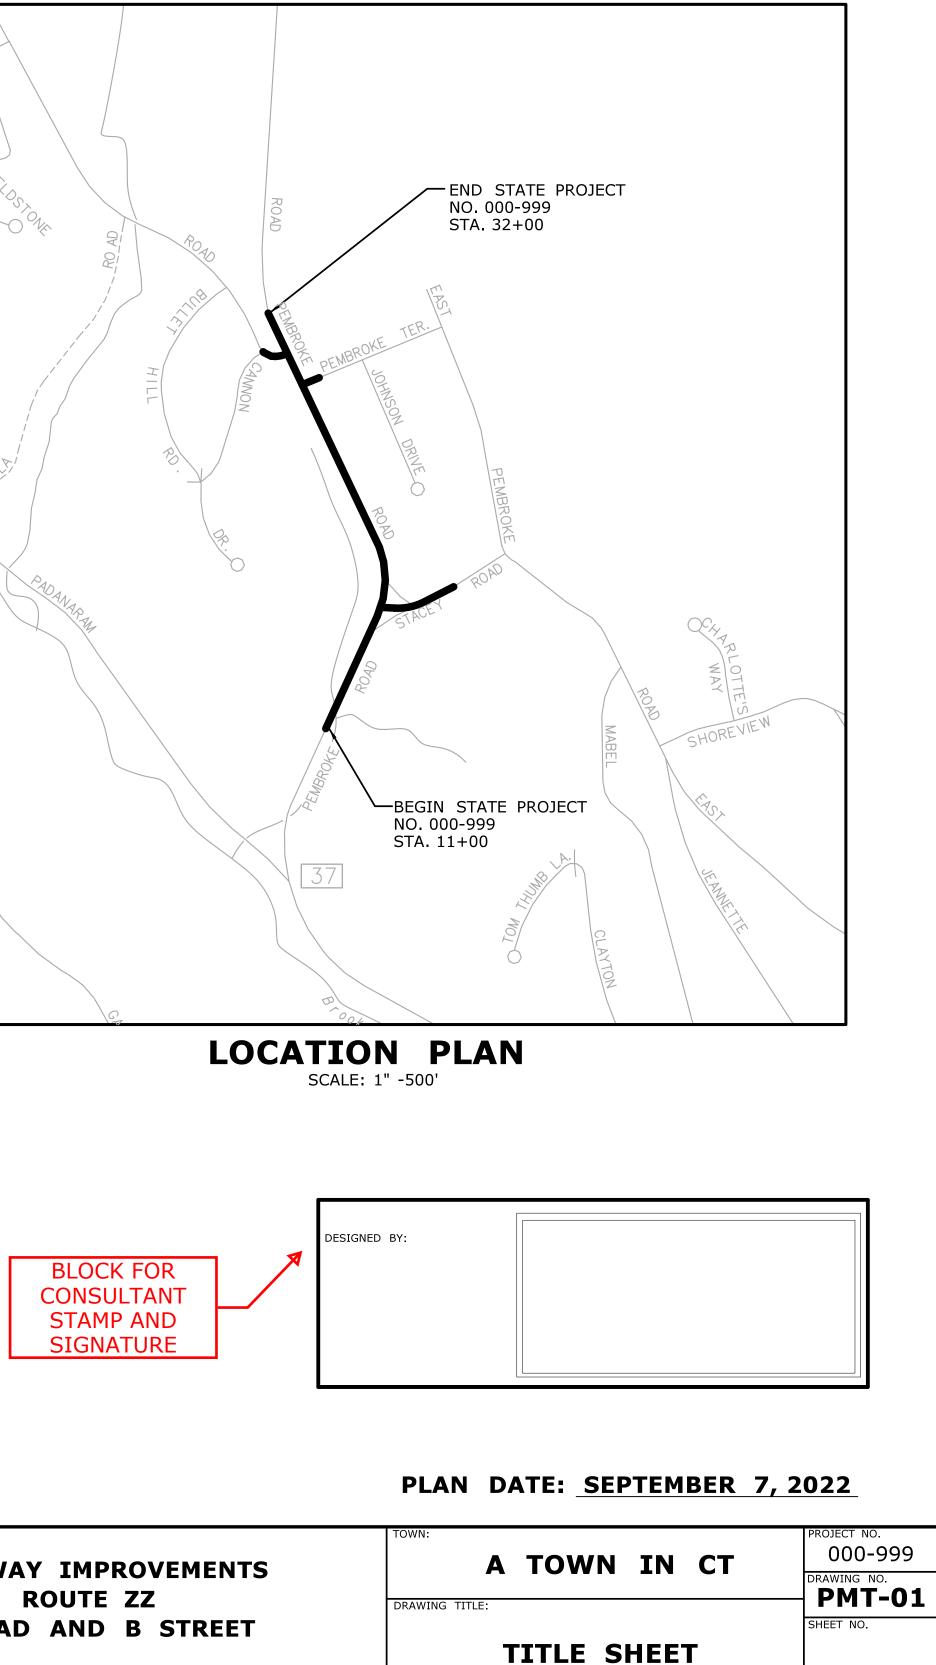





STATE OF CONNECTICUT


**DEPARTMENT OF TRANSPORTATION** 

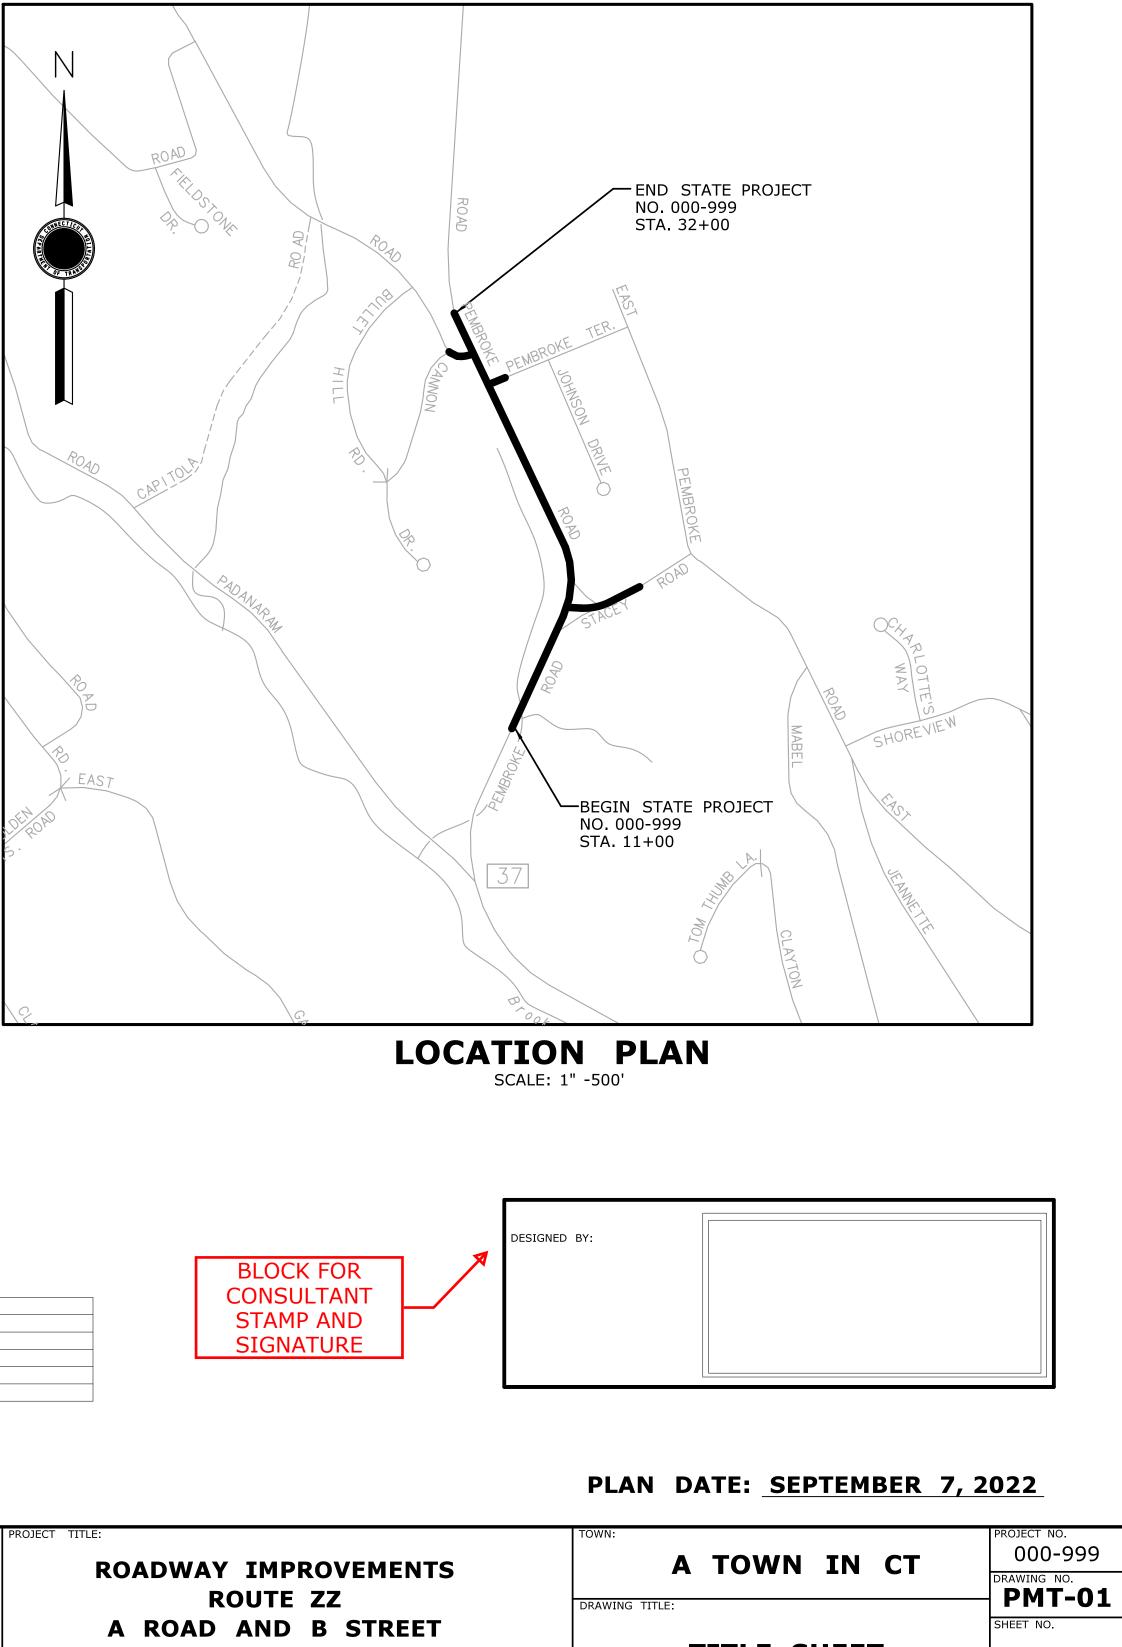

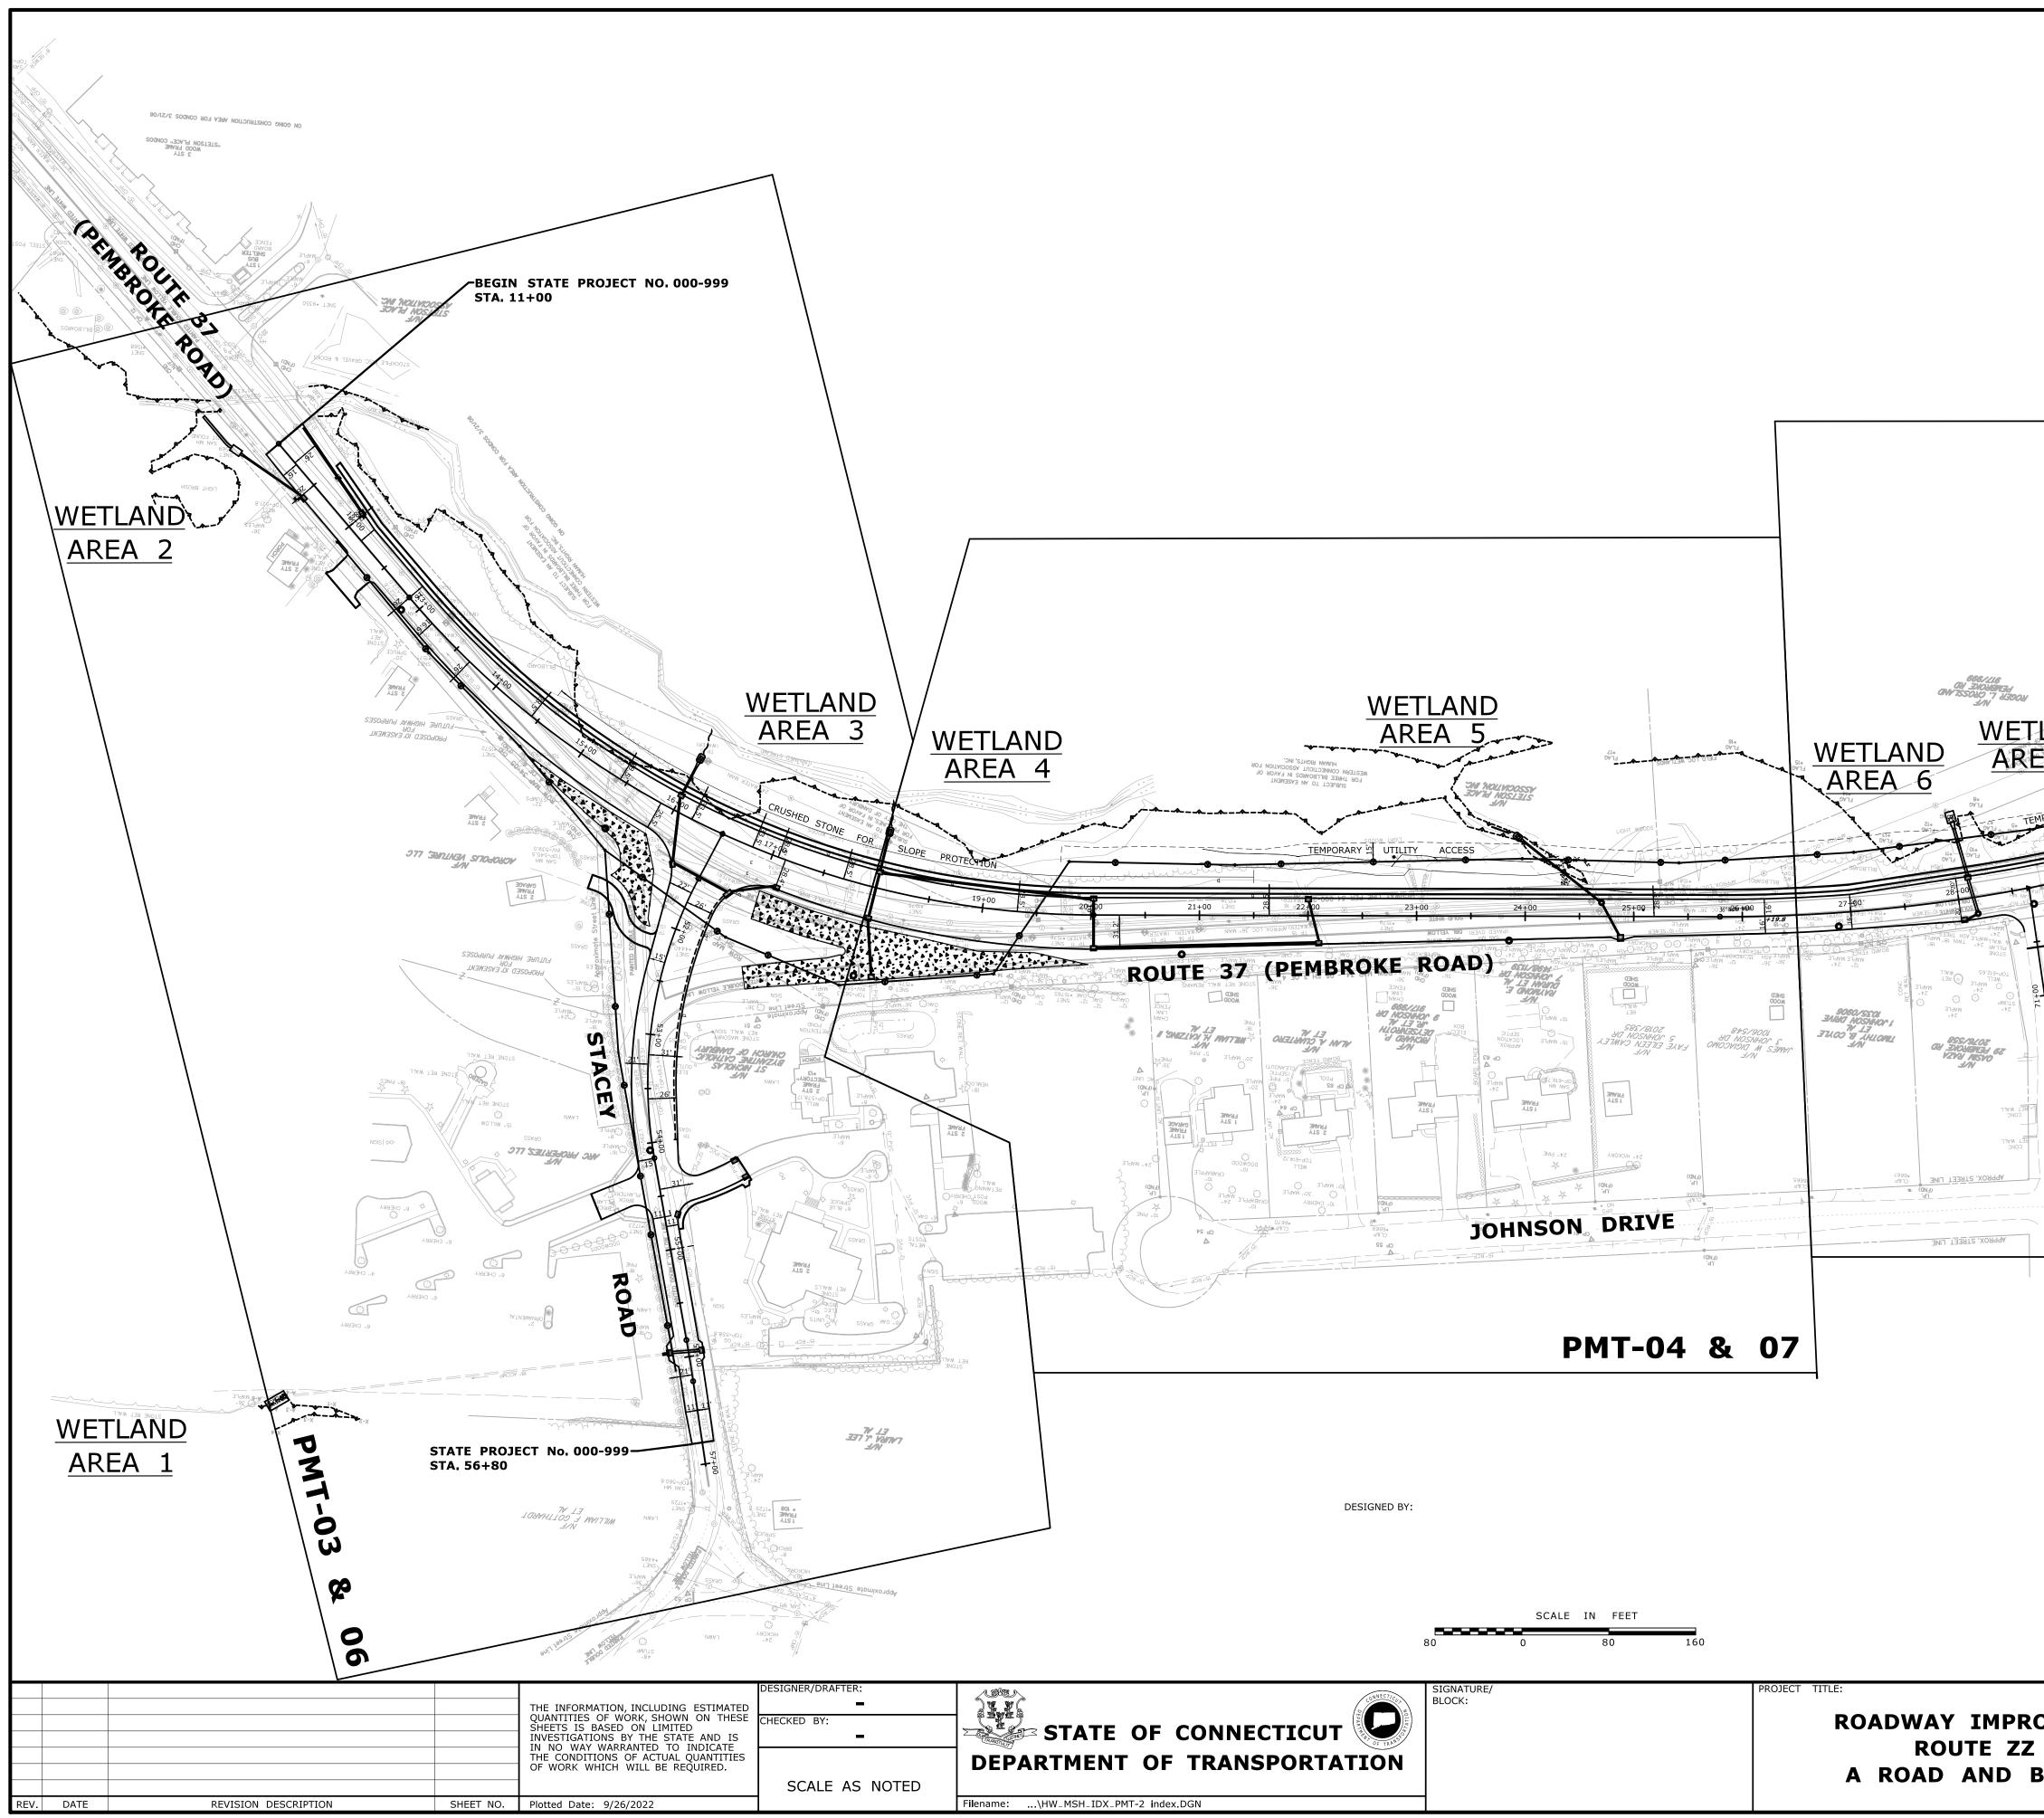

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	END STATE PROJECT No. 000-999 STA. 32+00	
	PM1-05	5 & 08
THE PERMI Index Map:	DEVELOPMENT OF T PLAN SET	
relationship to we of the plan sheets ground survey inf all be necessary. 2. The need for a number of sheets. 3. Include overall 4. Show wetland with the identifica	<ul> <li>is intended for overall project information, major features, etlands and floodplain/floodway, and to show the location</li> <li>The index is not intended to be a regulatory sheet. The formation shown here on this plan is extensive and may not</li> <li>in index plan is determined based on the length of the project/</li> <li>(ie. a project with 2-3 sheets may not require and index) project limits and associated sheet numbers.</li> <li>limits (bold, not screened). Identify wetland area locations ation as depicted on the impact table.</li> </ul>	
5. Show floodplai 6. Show proposed 7. If feasible, show	n/floodway limit lines (bold). d roadway and drainage (bold) w and identify any needed access roads for the project that areas. Call-out as temporary or permanent.	
ENVIR	ONMENTAL PERMIT F PLAN DATE: <u>SEPTEMBER 7, 2022</u>	
OVEMENTS AT	TOWN: <b>A TOWN IN CT</b> DRAWING TITLE:	PROJECT NO. 000-999 DRAWING NO. PMT-02 SHEET NO.
<b>B</b> STREET	INDEX MAP	SHELL NO.

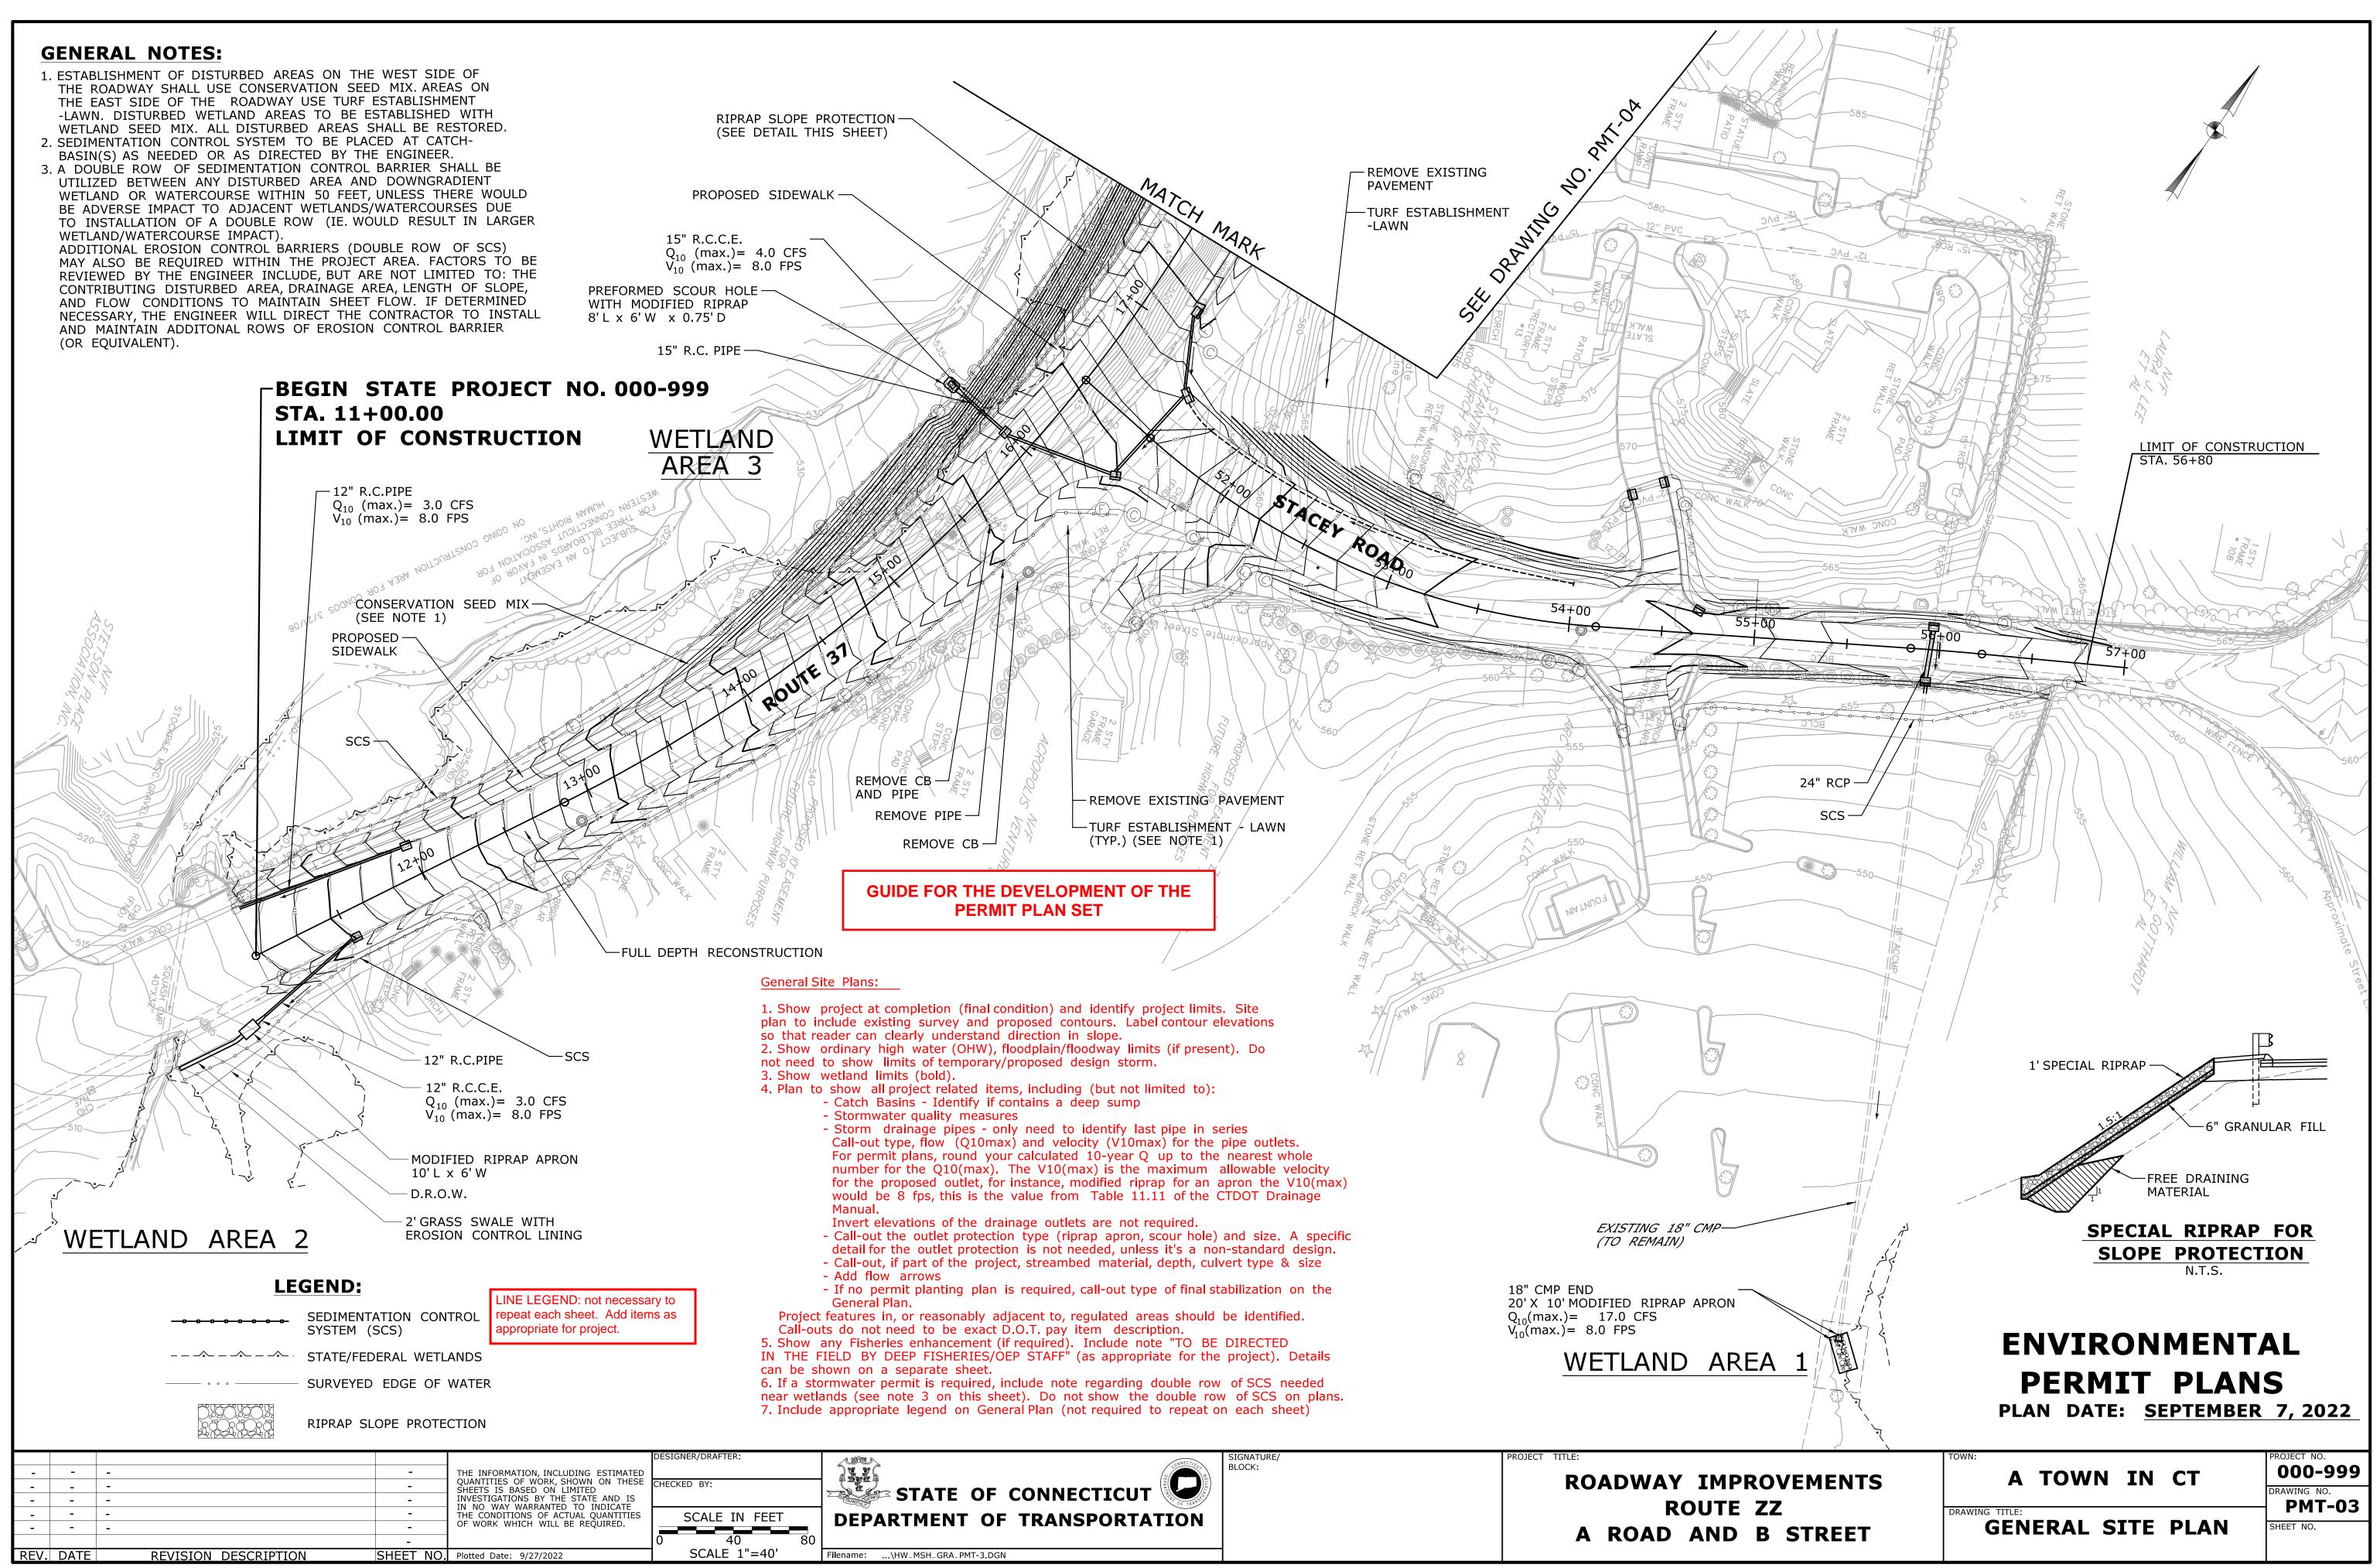


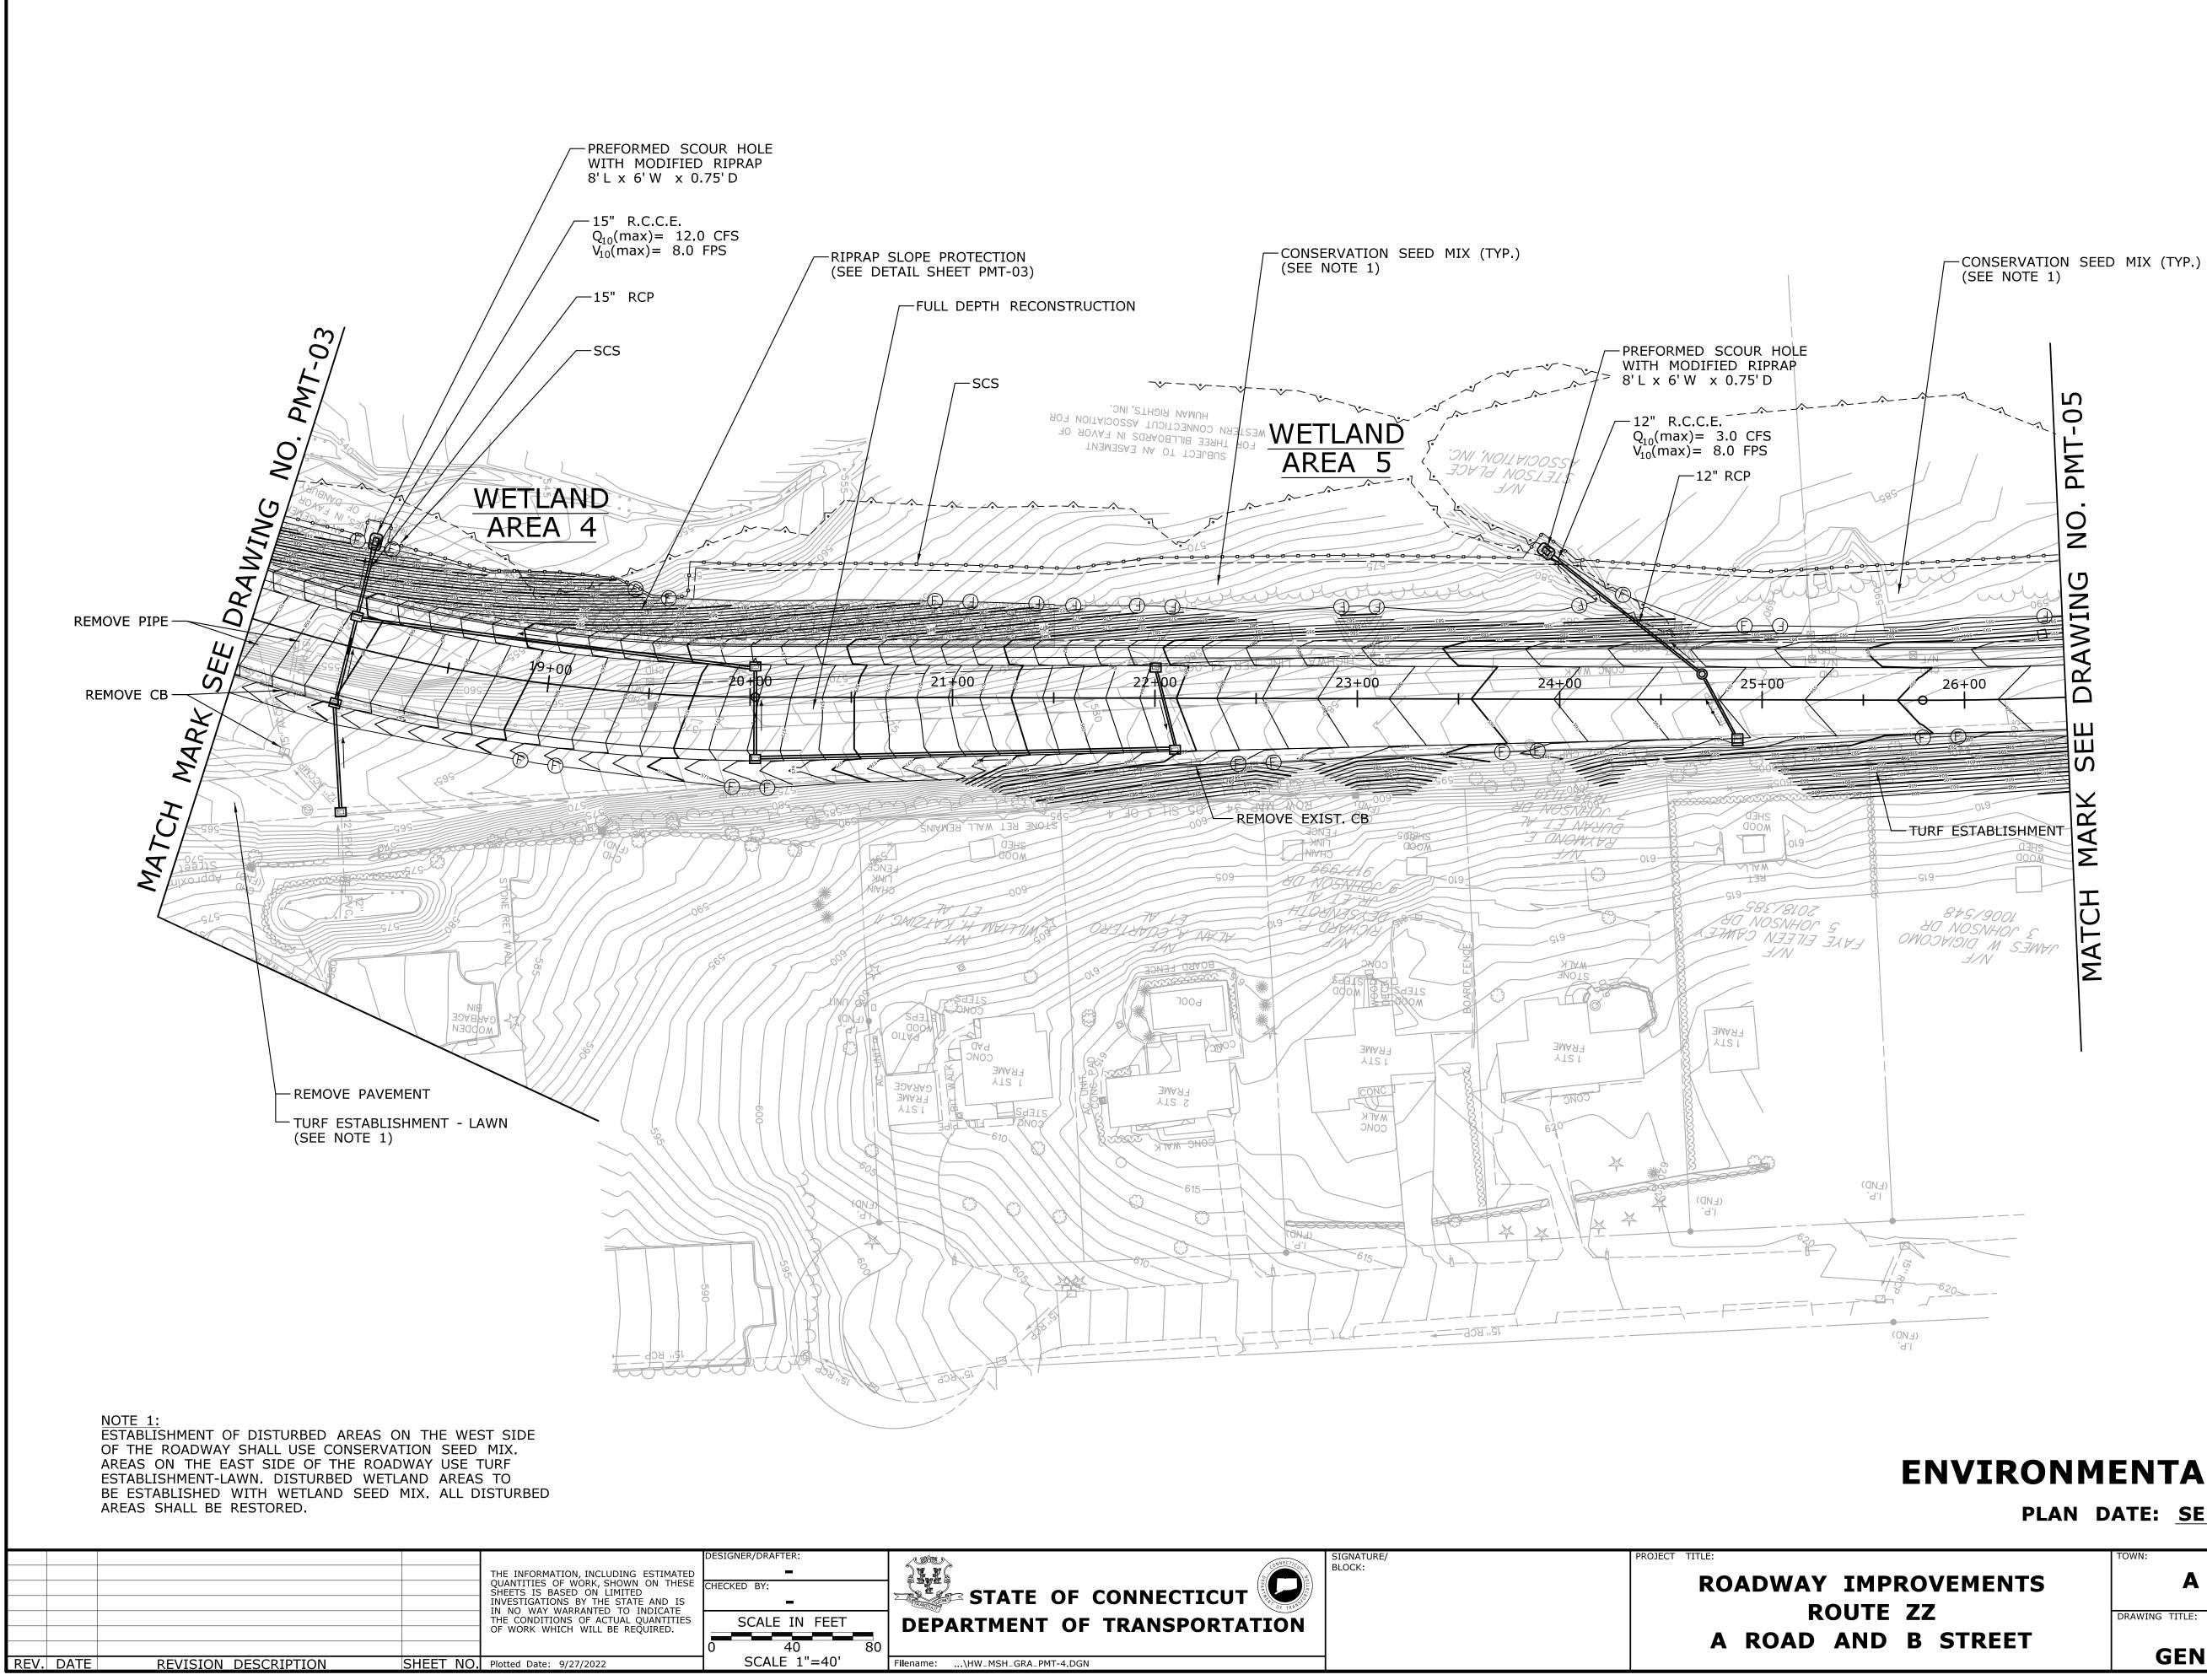


# **ENVIRONMENTAL PERMIT PLANS**

PLAN DATE: <u>SEPTEMBER 7, 2022</u>

ROVEMENTS	A TOWN IN CT	PROJECT NO. 000-999 DRAWING NO. PMT-04
ZZ	DRAWING TITLE:	SHEET NO.
<b>B</b> STREET	GENERAL SITE PLAN	

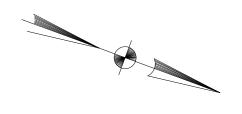

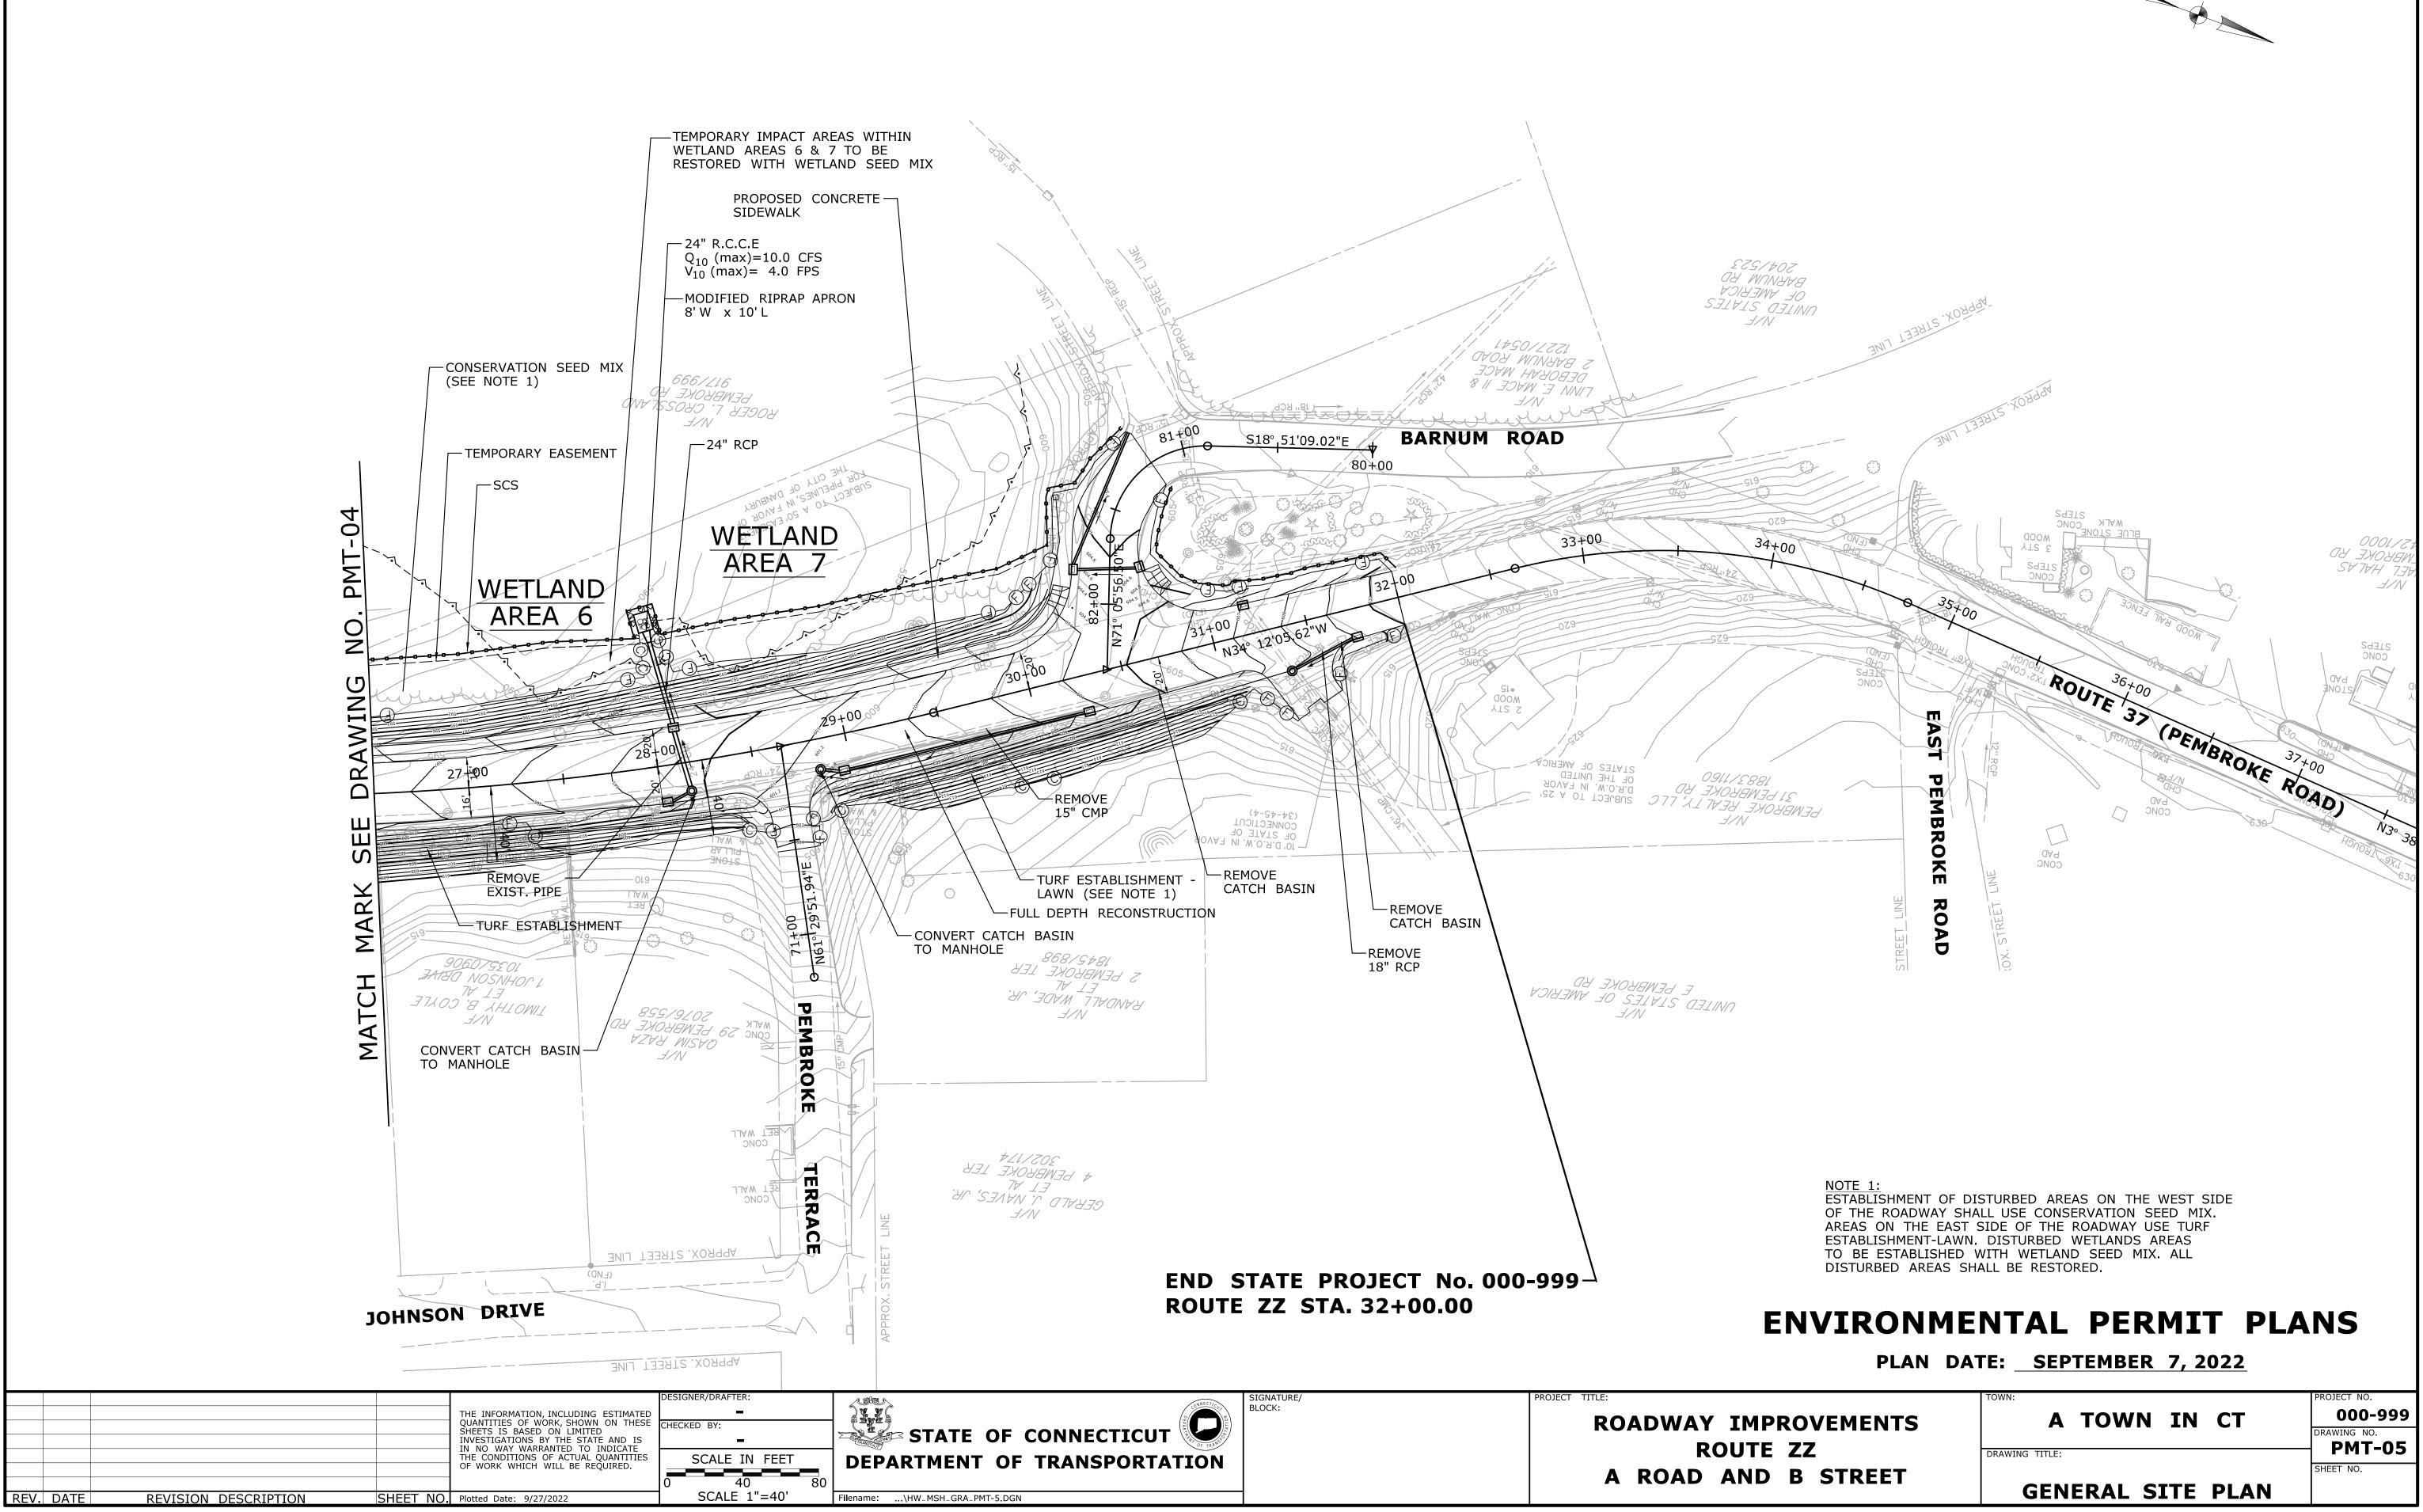

NVIRONME	NTAL PERMIT PL	ANS
PLAN DA	TE: <u>SEPTEMBER 7, 2022</u>	
ROVEMENTS ZZ	A TOWN IN CT	PROJECT NO. 000-999 DRAWING NO. PMT-05
B STREET	GENERAL SITE PLAN	SHEET NO.

WETLAND IMPACT TABLE					
AREA #	PERMANENT	TEMPORARY	TOTAL		
1	110 S.F. (0.003 ac.)	0	110 S.F. (0.003 ac.)		
2	0	0	0		
3	5,450 S.F. (0.125 ac.)	90 S.F. (0.002 ac.)	5,540 S.F. (0.127 ac.)		
4	350 S.F. (0.008 ac.)	0	350 S.F. (0.008 ac.)		
5	610 S.F. (0.014 ac.)	0	610 S.F. (0.014 ac.)		
6	300 S.F. (0.007 ac.)	1,550 S.F. (0.036 ac.)	1,850 S.F. (0.043 ac.)		
7	90 S.F. (0.002 ac.)	1,500 S.F. (0.034 ac)	1,590 S.F. (0.036 ac.)		
TOTAL	6,910 S.F. (0.159 ac.)	3,140 S.F. (0.072 ac.)	10,050 S.F. (0.231 ac.)		

hese values can be rounded up as shown in this example.

For projects with watercourse mpacts, include additional olumns for those impacts. The FOTAL' column will then include oth wetland and watercourse mpacts combined.


INVASIVE SPECIES CONTROL -(SEE NOTE A)

LIMITS OF IMPACT

NO WATERCOURSE IMPACT FOR THE PROJECT.

### NOTE:

THE CONTRACTOR SHALL NOT WORK WITHIN THE LIMITS OF THE WETLANDS AND WATERCOURSES WITH THE EXCEPTION OF THOSE AREAS DELINEATED AS TEMPORARY OR PERMANENT IMPACTS TO THE WETLANDS AND WATERCOURSE. ALL DISTURBED AREAS SHALL BE RESTORED.

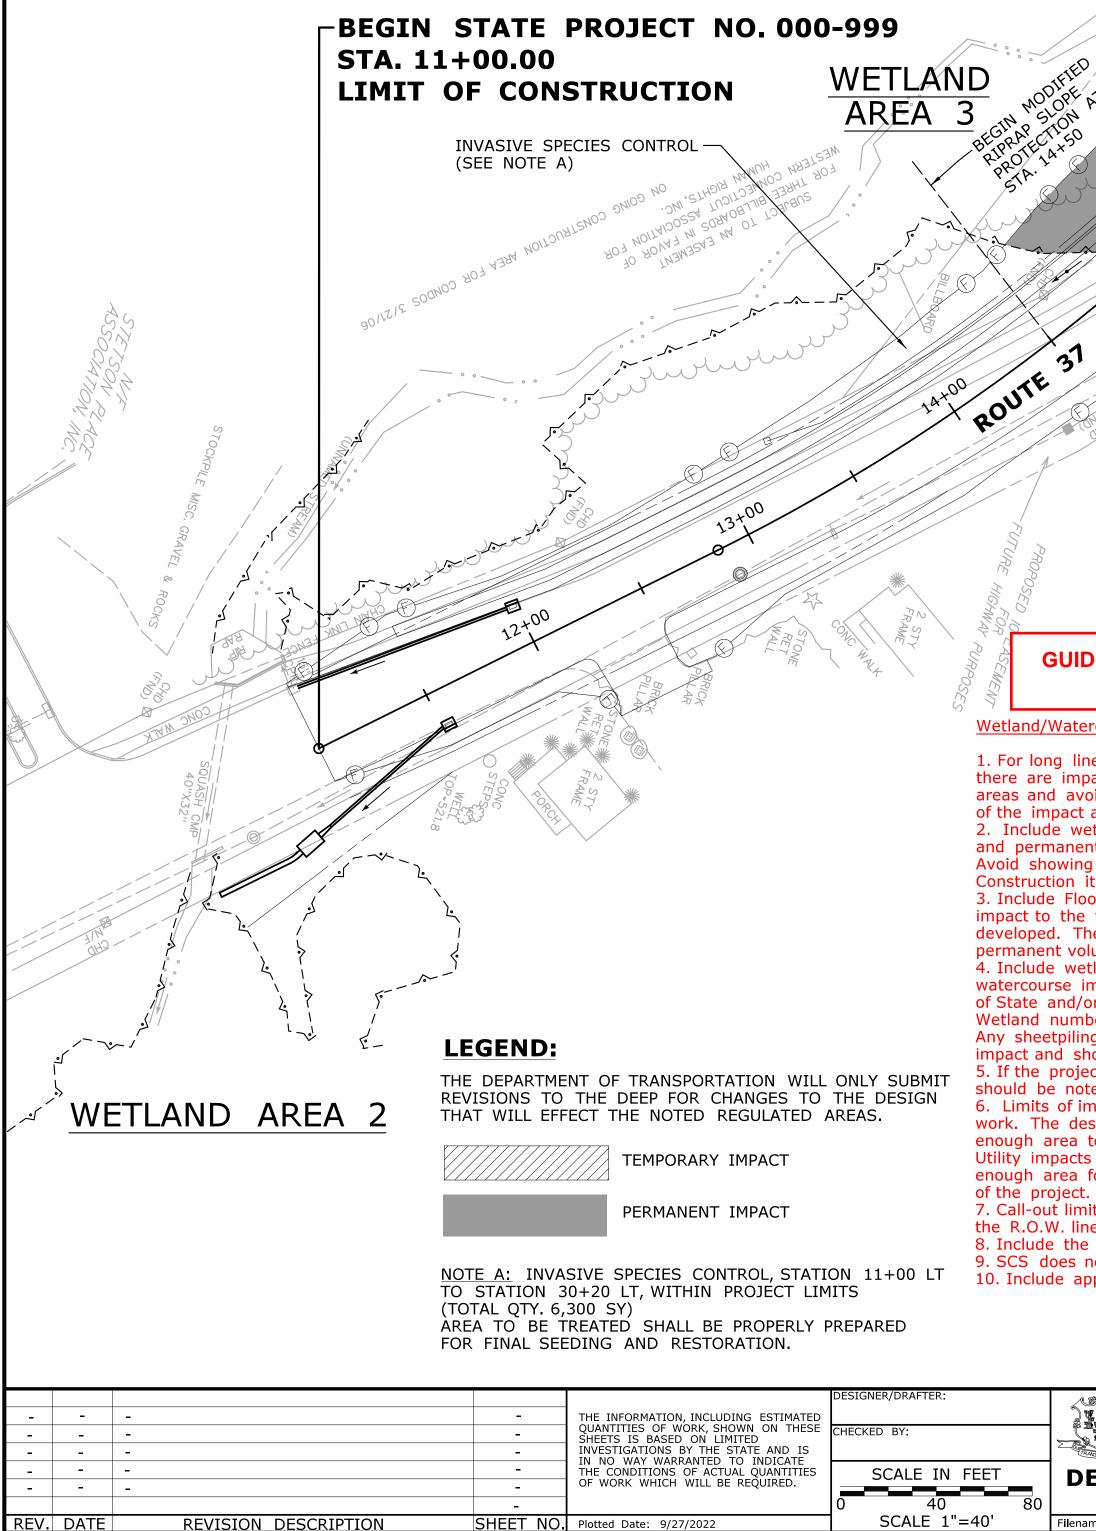

**GUIDE FOR THE DEVELOPMENT OF THE** PERMIT PLAN SET

Wetland/Watercourse Impact Plan(s):

1. For long linear projects, the only impact sheets that need to be provided are where there are impacts to regulated areas. The impact plans can focus solely on the impact areas and avoid repeating entire project limits. The index sheet should show the location  $\stackrel{\scriptstyle imes}{\sim}$ of the impact areas and identify the associated impact sheet.

2. Include wetland limits (bold) and OHW limits (bold). Plan to clearly depict temporary and permanent impacts. To maintain clarity, do not show existing or proposed contours. Avoid showing patterns for items which interfere with clearly understanding impacts. Construction item call-outs not required.

3. Include Floodplain/Floodway limits, if present. Bold (not screened). If the project involves impact to the floodplain/floodway, a separate plan sheet identifying those impacts should be developed. The plan can use the same base map as the wetland impact plan. Only provide the permanent volume of impact in cubic yards (see culvert sample set for more detailed info) 4. Include wetland and watercourse impact table. Quantify wetland impacts (above OHW) and watercourse impacts (below OHW). Values can be rounded up. If there are independent areas of State and/or Federal wetlands, then impacts to those resources must listed separately.

Wetland numbers should correspond with the wetland report. Any sheetpiling that must be left in place in a regulated area shall be counted as permanent

impact and shown on the plans. 5. If the project includes impact to a watercourse (below OHW), a method of waterhandling should be noted (contact OEP/EPC for further guidance).

6. Limits of impact should be defined based on enough space for the Contractor to perform the work. The designer should carefully consider how the project may be constructed and provide enough area to allow the Contractor the ability for minor variation in construction methods. Utility impacts as part of the project should be evaluated and included. In addition, ensure enough area for the Contractor to configure any stormwater control as needed for the construction

7. Call-out limits of impact. Limits should be clearly shown and may or may not coincide with the R.O.W. line or easement line.

8. Include the note to Contractor for restriction of work in regulated areas.

9. SCS does not need to be shown. 10. Include appropriate legend and note regarding D.O.T. submittals for revisions.

## **ENVIRONMENTAL PERMIT PLANS** PLAN DATE: <u>SEPTEMBER 7, 2022</u>

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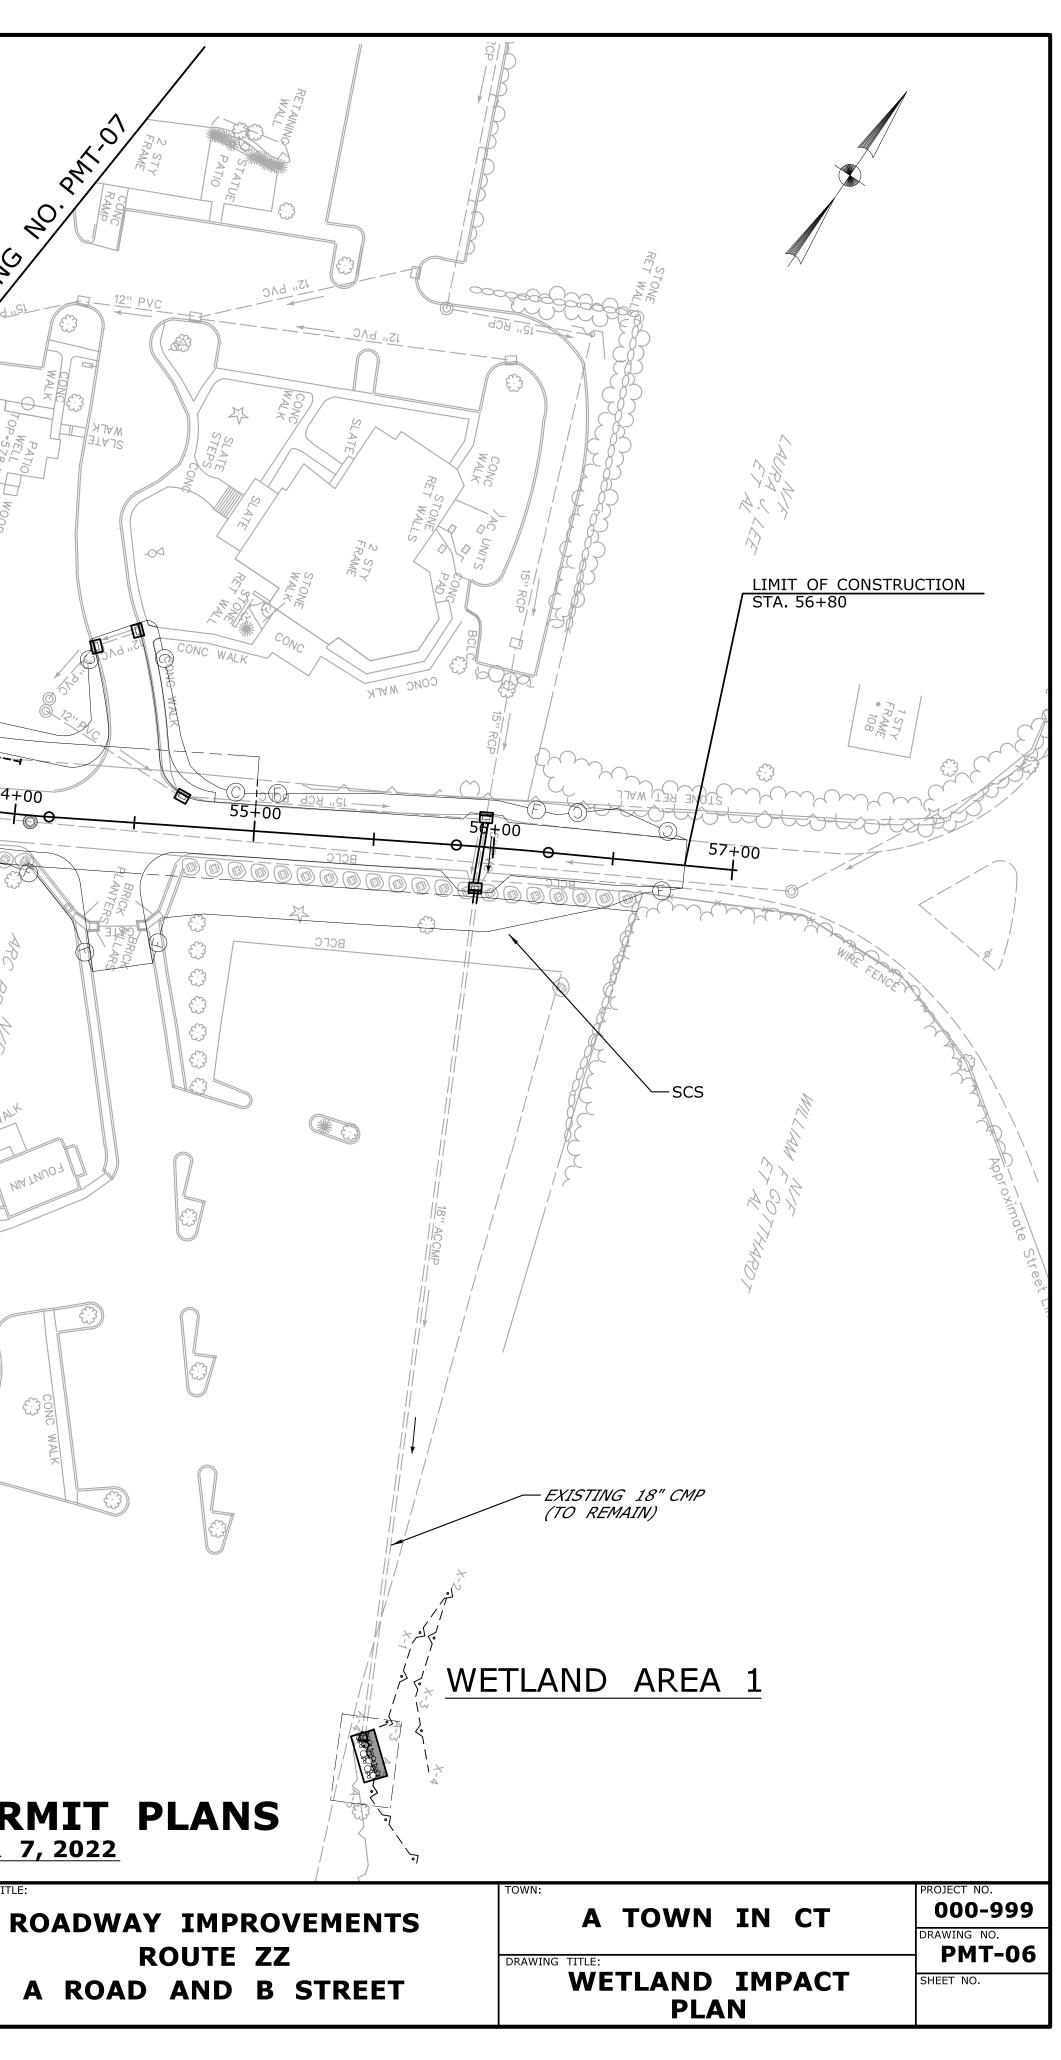
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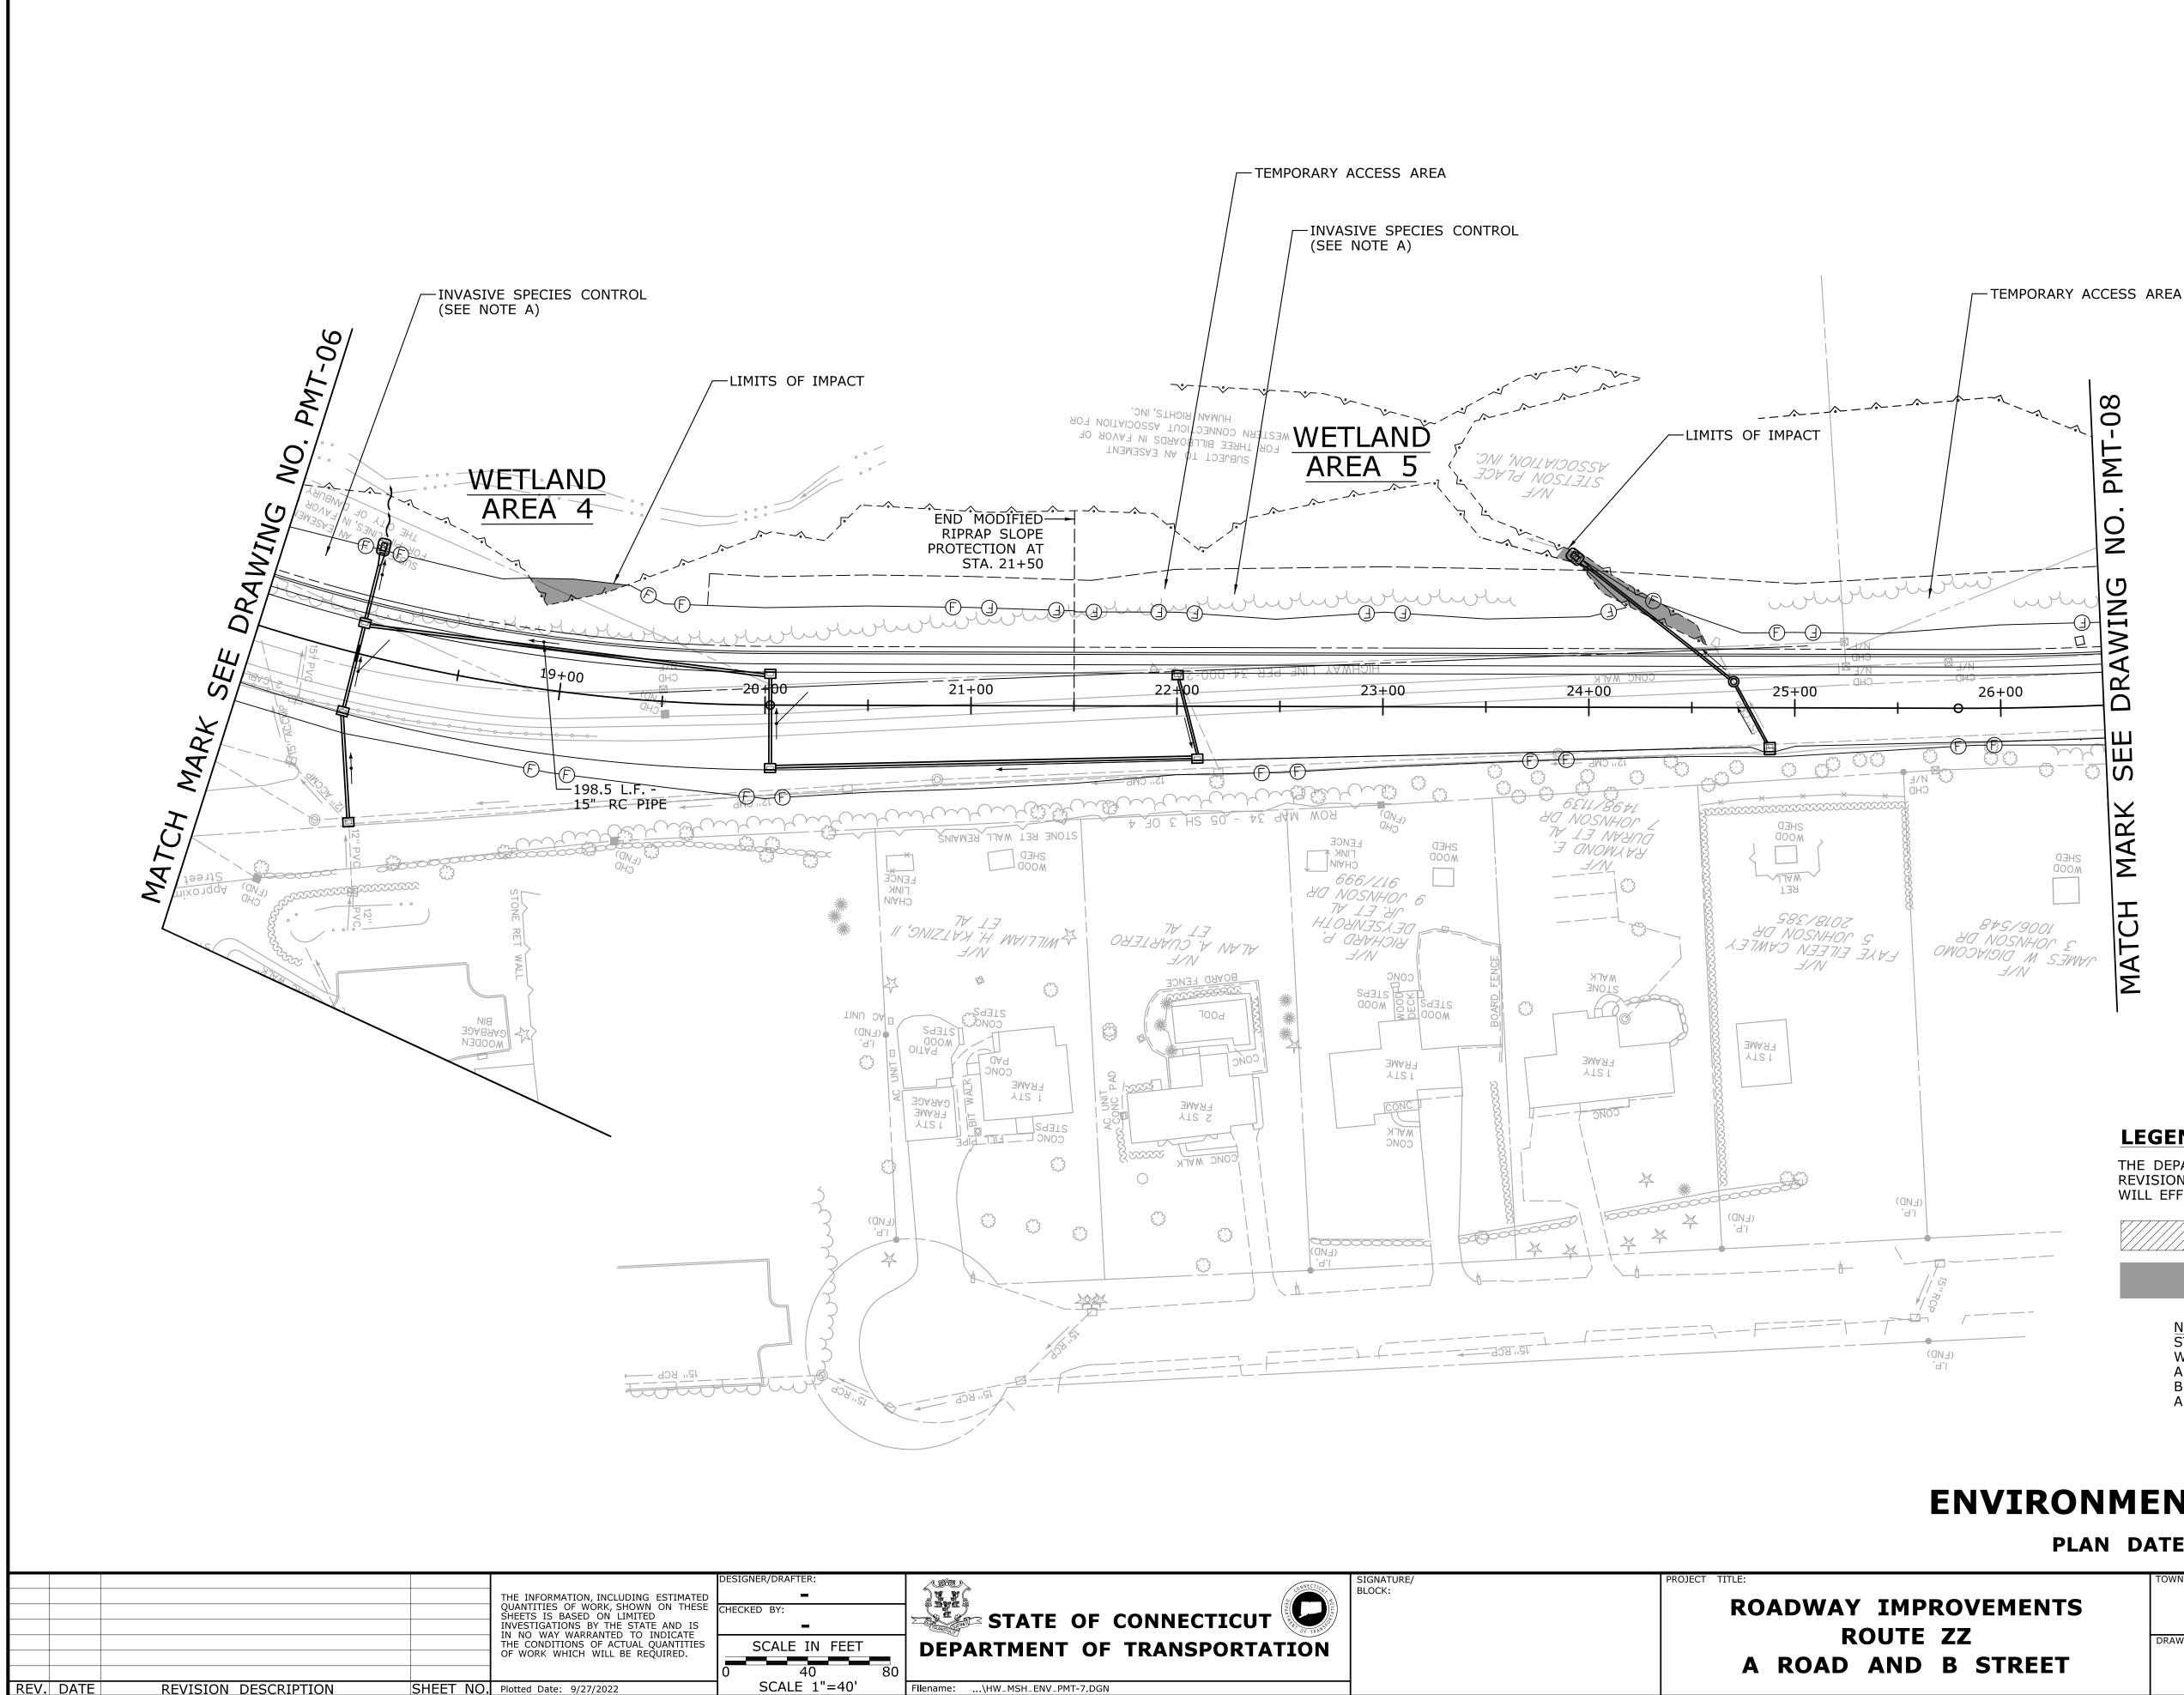
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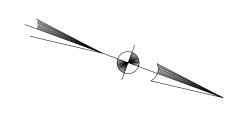
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**ROUTE ZZ** A ROAD AND B STREET





Filename: ...\HW\_MSH\_ENV\_PMT-7.DGN



## **LEGEND:**

THE DEPARTMENT OF TRANSPORTATION WILL ONLY SUBMIT REVISIONS TO THE DEEP FOR CHANGES TO THE DESIGN THAT WILL EFFECT THE NOTED REGULATED AREAS.

TEMPORARY IMPACT

PERMANENT IMPACT

NOTE A: INVASIVE SPECIES CONTROL, STATION 11+00 LT TO STATION 30+20 LT, WITHIN PROJECT LIMITS (TOTAL 6,300 SY). AREA TO BE TREATED FOR INVASIVES SHALL BE PROPERLY PREPARED FOR FINAL SEEDING AND RESTORATION.

# **ENVIRONMENTAL PERMIT PLANS**

## PLAN DATE: <u>SEPTEMBER 7, 2022</u>

RO	VEMENTS
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В	STREET

	Α	TOWN	IN	СТ	
ORAWING	TITLE:				
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		PLA	N		



PERMANENT IMP NOTE A: INVASIVE SPECIES CONT STATION 11+00 LT TO STATION 3 WITHIN PROJECT LIMITS. (TOTAL QTY. 6,300 SY) AREA TO BE TREATED FOR INVAS BE PROPERLY PREPARED FOR FINA SEEDING AND RESTORATION.	ROL, BO+20 LT, IVES SHALL	
	JOHNSON DRIVE	, SHOWN ON THESE CHECKED BY:
	INVESTIGATIONS BT IT IN NO WAY WARRANTI THE CONDITIONS OF A	ED TO INDICATE

