From: Daniel Hatab <daniel.hatab@ramapocom.com>
Sent: Friday, April 2, 2021 10:34 AM
To: CSC-DL Siting Council <Siting.Council@ct.gov>
Subject: EM-CING-153-201105 (AT&T Site CTL01835)

Good Morning,

The site below has been completed on 3/19, CSC letter is attached for reference and also CCA letter.

AT&T Site: CTL01835 Address: 655 Bassett Road, Watertown CT 06795

Thank You,

# Daniel Hatab

daniel.hatab@ramapocom.com 20 Romanelli Ave, S. Hackensack, NJ 07606 Cell Phone: (201) 742-1070 Office Phone: (201) 343-2995



Date: March 30, 2021

State of Connecticut Connecticut Siting Council Ten Franklin Square New Britain, Ct. 06051 Phone: (860) 827-2935

SMW Engineering Group, Inc. 158 Business Center Dr Birmingham AL. 35244 (205) 252-6985

RE:	EM-CING-153-201105
Subject:	Special Inspection Letter – Final Certification
ATC Site:	Watertown CT – 283424
AT&T site:	CTL01835 – FA:10128117
Site Address:	655 Bassett Road
	Watertown, Ct. 06795-1139
AT&T Scope of work:	3C,4C,4TX4RX Retrofit, 5G NR – Antenna Amendment Drawings
SMW Engineering Project:	20-10237.1

Dear Sir or Madam,

On March 30, 2021, SMW Engineering Group, Inc., reviewed detailed photographs of the AT&T telecommunication facility located at the above referenced site. The purpose of these pictures was to inspect the installation in accordance with the following codes:

- International Building Code (IBC)
- National Electric Code (NEC)
- Local Building Code
- City / County Ordinances

### Proposed scope of work on tower from Construction Drawings:

- Removal of (6) existing Andrew SBNH-1D6565C antennas (2) per sector
- Relocate of (3) existing CCI HPA-65R-BUU-H8 antennas (1) per sector
- Removal of (6) existing RRUS-11 B12 (2) per sector
- Removal of (3) existing RRUS-12 B2 + A2 B25 (1) per sector
- Installation of Site Pro 1 Handrail Kit Part # HRK12 Typ. of (3) sectors
- Installation of Site Pro 1 Crossover Plates Part number SCX1-K Typ. of (3) sectors
- Installation of (3) new CCI OPA65R-BU8DA antennas (1) per sector
- Installation of (3) new CCI DMP65R-BU8DA antennas (1) per sector

SMW Engineering Group, Inc.

- Installation of (3) RRUS 11 B5 (1) per sector
- Installation of (3) RRUS 4449 B5/B12 (1) per sector
- Installation of (3) RRUS 4478 B14 (1) per sector
- Installation of (3) RRUS 8843 B2/B66A (1) per sector
- Installation of (1) DC2-48-60-8-18F-02 squid

## **Discrepancies from Permitted Drawings:**

None


To the best of our knowledge, belief, and professional judgment, the connections of the installed equipment were performed **in substantial compliance** with the approved construction drawings prepared by SMW Engineering Group, Inc. dated 11-30-20.

Should you have any questions or wish to discuss any aspect of this letter, please do not hesitate to contact the undersigned.

Sincerely,

John T. Liu, PE SMW Engineering Group, INC. Principal Engineer Connecticut Registration #33076



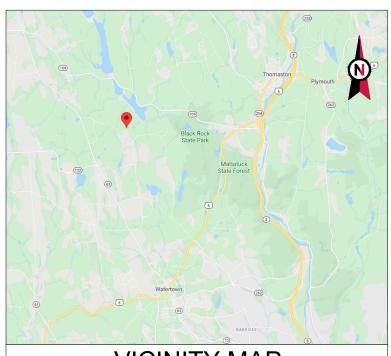

# VICINITY MAP



# **AMERICAN TOWER®**

ATC SITE NAME: WATERTOWN CT ATC SITE NUMBER: 283424 AT&T PACE NUMBER: MRCTB046623/MRCTB046543/ MRCTB046501/MRCTB046499/MRCTB046647 AT&T SITE ID: CTL01835 AT&T FA CODE:10128117 AT&T SITE NAME: WATERTOWN BASSETT ROAD PROJECTS: 3C/4C/4TX4RX RETROFIT/5G NR SITE ADDRESS: 655 BASSETT ROAD WATERTOWN, CT 06795-1139



# AT&T MOBILITY ANTENNA AMENDMENT DRAWINGS

	-1			-								
COMPLIANCE CODE	PROJECT SU	JMMARY	PROJECT DESCRIPTION		SHEET INDEX							
ALL WORK SHALL BE PERFORMED AND MATERIALS INSTALLED IN ACCORDANCE WITH THE CURRENT EDITIONS OF THE	SITE ADDR		AND TOWER MOUNTED EQUIPMENT AS INDICATED PER BELOW: <u>TOWER WORK</u> : REMOVE (6) LTE ANTENNAS AND (6) LTE RRH'S	SHEET NO:	DESCRIPTION:	REV:	DATE:	BY:				
FOLLOWING CODES AS ADOPTED BY THE LOCAL GOVERNMENT AUTHORITIES. NOTHING IN THESE PLANS IS	655 BASSET			G-001	COVER SHEET	1	09/22/20	ZDS				
TO BE CONSTRUED TO PERMIT WORK NOT CONFORMING TO THESE CODES.	DNFORMING TO WATERTOWN, CT 06/95-1139			G-002	GENERAL NOTES	1	09/22/20	ZDS				
1. INTERNATIONAL BUILDING CODE (IBC)	COUNTY: LITCHFIELD		0.78" 8AWG6 CABLES, AND MOUNT MODIFICATIONS	C-001	OVERALL SITE PLAN	1	09/22/20	ZDS				
2. NATIONAL ELECTRIC CODE (NEC)	<u>GEOGRAPHIC CO</u>		EXISTING (3) UMTS ANTENNAS, (3) LTE ANTENNAS, (3) UMTS RRH'S,	C-101	DETAILED SITE PLAN	1	09/22/20	ZDS				
3. LOCAL BUILDING CODE 4. CITY/COUNTY ORDINANCES	LATITUDE: 41.6 LONGITUDE: -7		(2) DC/FIBER SQUIDS, (4) 0.78" 8AWG6 CABLES AND (2) 0.39" FIBER CABLES TO REMAIN.	C-102	SHELTER LAYOUT	1	09/22/20	ZDS				
4. OH HOUNT ONDINANCES	GROUND ELEVATIO		GROUND WORK:	C-201	TOWER ELEVATION	1	09/22/20	ZDS				
			INSTALL (1) 6630 AND (1) IDLE CABLE.	C-401	RF SCHEDULE AND ANTENNA INSTALLATION	1	09/22/20	ZDS				
				C-501	CONSTRUCTION DETAILS	1	09/22/20	ZDS				
				C-502	EQUIPMENT SPECIFICATIONS	1	09/22/20	ZDS				
	PROJECT	TEAM	PROJECT NOTES	E-501 GROUNDING DETAILS 1		09/22/20	ZDS					
	TOWER OWNER: APP	MERICAN TOWER AT&T MOBILITY	<ol> <li>THE FACILITY IS UNMANNED.</li> <li>A TECHNICIAN WILL VISIT THE SITE APPROXIMATELY ONCE A MONTH FOR ROUTINE INSPECTION AND MAINTENANCE.</li> <li>THE PROJECT WILL NOT RESULT IN ANY SIGNIFICANT LAND DISTURBANCE OR EFFECT OF STORM WATER DRAINAGE.</li> <li>NO SANITARY SEWER, POTABLE WATER OR TRASH DISPOSAL IS REQUIRED.</li> <li>HANDICAP ACCESS IS NOT REQUIRED.</li> </ol>	R-601	SUPPLEMENTAL							
UTILITY COMPANIES	AMERICAN TOWER			R-602	SUPPLEMENTAL							
	10 PRESIDENTIAL WAY											
	,											
POWER COMPANY: CONNECTICUT LIGHT & POWER	JEREMY SHARIT											
PHONE: (888) 783-6617	SMW ENGINEERING GROUP INC. 158 BUSINESS CENTER DR.						PROJECT LOCATION DIRECTIONS					
TELEPHONE COMPANY: FRONTIER PHONE: (800) 921-8102	BIRMINGHAM, AL. 35244											
<b></b>	JOB# 20-10237		FROM DOWNTOWN WATERBURY START OUT GOING WEST ON E MAIN ST TOWARD MAPLE ST. TURN RIGHT ONTO RIVERSIDE	REDLINED CD	REDLINED CDs		1					
	PROPERTY OWNER:         CONSULTING ENGINEER           FRANK GUSTAFSON REVOCABLE         TRUST         JOHN LIU, PE           FRANK GUSTAFSON         (423) 541-0561         (423) 541-0561	ST. MERGE ONTO CT-8 N/JAMES H DARCEY MEMORIAL HWY N TOWARD WATERTOWN/TORRINGTON. TAKE THE CT-262 EXIT.		Ramapo Communica	tion Corp							
		(423) 541-0561	EXIT 37, TOWARD WATERTOWN. TURN LEFT ONTO FROST BRIDGE RD/CT-262. CONTINUE TO FOLLOW CT-262. TURN RIGHT		3/23/2021 Matthew Schlosser							
	655 BASSETT ROAD WATERTOWN, CT 06795		<ul> <li>BRIDGE RD/C1-262. CONTINUE TO FOLLOW C1-262. TURN RIGHT ONTO BUCKINGHAM ST/CT-262. BUCKINGHAM ST/CT-262</li> <li>BECOMES FERN HILL RD. FERN HILL RD BECOMES SMITH POND RD. TURN RIGHT ONTO LINKFIELD RD 999 LINKFIELD RD IS ON THE LEFT</li> </ul>		Matthew Schlosser							
Know what's below.	Know what's below.				REDLINED PAGE	: 5						
Call before you dig.								-				

AMERICAN TOWER®
ENGINEERING GROUP, ING ENGINEERING GROUP, ING TOCETTEE PLANNING A BETTER TOMORPOW 158 BUSINESS CENTER DRIVE BIRMINGHAM, AL 35244 TEL: 205-252-6985 FAX: 205-320-1504
REV.         DESCRIPTION         BY         DATE           1         FOR CONSTRUCTION         ZDS         09/22/20
283424 ATC SITE NAME: WATERTOWN CT SITE ADDRESS: 655 BASSETT ROAD WATERTOWN, CT 06795-1139
SEAL: No. 33076 No. 33076 SS/ONAL ENGINE 9/22/2020
DATE DRAWN:         05/29/20           ATC JOB NO:         283424           CUSTOMER ID:         10128117           CUSTOMER #:         20-10237
COVER SHEET
SHEET NUMBER: REVISION: G-001 1

#### GENERAL CONSTRUCTION NOTES:

- OWNER FURNISHED MATERIALS, AT&T MOBILITY "THE COMPANY" WILL PROVIDE AND THE 22. CONTRACTOR WILL INSTALL
  - A. BTS EQUIPMENT FRAME (PLATFORM) AND ICEBRIDGE SHELTER (GROUND BUILD/CO-LOCATE ONLY) AC/TELCO INTERFACE BOX (PPC)
  - ICE BRIDGE (CABLE TRAY WITH COVER) (GROUND BUILD/CO-LOCATE ONLY, GC TO FURNISH AND INSTALL FOR ROOFTOP INSTALLATION)
  - D. TOWERS, MONOPOLES
  - TOWER LIGHTING
  - GENERATORS & LIQUID PROPANE TANK
  - ANTENNA STANDARD BRACKETS, FRAMES AND PIPES FOR MOUNTING ANTENNAS (INSTALLED BY OTHERS)
  - TRANSMISSION LINE
  - TRANSMISSION LINE JUMPERS
  - TRANSMISSION LINE CONNECTORS WITH WEATHERPROOFING KITS
  - TRANSMISSION LINE GROUND KITS
  - HANGERS
  - HOISTING GRIPS O. BTS EQUIPMENT
- 2 THE CONTRACTOR IS RESPONSIBLE TO PROVIDE ALL OTHER MATERIALS FOR THE COMPLETE INSTALLATION OF THE SITE INCLUDING, BUT NOT LIMITED TO, SUCH MATERIALS AS FENCING, STRUCTURAL STEEL SUPPORTING SUB-FRAME FOR PLATFORM ROOFING LABOR AND MATERIALS GROUNDING RINGS GROUNDING WIRES COPPER-CLAD OR XIT CHEMICAL GROUND ROD(S), BUSS BARS, TRANSFORMERS AND DISCONNECT SWITCHES WHERE APPLICABLE, TEMPORARY ELECTRICAL POWER, CONDUIT, LANDSCAPING COMPOUND STONE, CRANES, CORE DRILLING, SLEEPERS AND RUBBER MATTING, REBAR, CONCRETE CAISSONS, PADS AND/OR AUGER MOUNTS, MISCELLANEOUS FASTENERS, CABLE TRAYS, NON-STANDARD ANTENNA FRAMES AND ALL OTHER MATERIAL AND LABOR REQUIRED TO COMPLETE THE JOB ACCORDING TO THE DRAWINGS AND SPECIFICATIONS. IT IS THE POSITION OF AT&T MOBILITY TO APP FOR PERMITTING AND CONTRACTOR RESPONSIBLE FOR PICKUP AND PAYMENT OF REQUIRED PERMITS.
- ALL WORK SHALL CONFORM TO ALL CURRENT APPLICABLE FEDERAL, STATE, AND LOCAL CODES, INCLUDING ANSI/EIA/TIA-222, AND COMPLY WITH ATC CONSTRUCTION SPECIFICATIONS
- CONTRACTOR SHALL CONTACT LOCAL 811 FOR IDENTIFICATION OF UNDERGROUND UTILITIES PRIOR TO START OF CONSTRUCTION
- CONTRACTOR SHALL BE RESPONSIBLE FOR COORDINATING ALL REQUIRED 5. INSPECTIONS.
- ALL DIMENSIONS TO, OF, AND ON EXISTING BUILDINGS, DRAINAGE STRUCTURES, AND SITE IMPROVEMENTS SHALL BE VERIFIED IN FIELD BY CONTRACTOR WITH ALL DISCREPANCIES REPORTED TO THE ENGINEER.
- DO NOT CHANGE SIZE OR SPACING OF STRUCTURAL ELEMENTS 7
- DETAILS SHOWN ARE TYPICAL; SIMILAR DETAILS APPLY TO SIMILAR CONDITIONS UNLESS 32. 8
- THESE DRAWINGS DO NOT INCLUDE NECESSARY COMPONENTS FOR CONSTRUCTION 9. SAFETY WHICH SHALL BE THE SOLE RESPONSIBILITY OF THE CONTRACTOR
- CONTRACTOR SHALL BRACE STRUCTURES UNTIL ALL STRUCTURAL ELEMENTS NEEDED 33. 10. FOR STABILITY ARE INSTALLED. THESE ELEMENTS ARE AS FOLLOWS: LATERAL BRACING, ANCHOR BOLTS, ETC.
- CONTRACTOR SHALL DETERMINE EXACT LOCATION OF EXISTING UTILITIES. GROUNDS 11. DRAINS, DRAIN PIPES, VENTS, ETC, BEFORE COMMENCING WORK
- INCORRECTLY FABRICATED, DAMAGED, OR OTHERWISE MISFITTING OR NONCONFORMING MATERIALS OR CONDITIONS SHALL BE REPORTED TO THE AT&T MOBILITY REP PRIOR TO REMEDIAL OR CORRECTIVE ACTION. ANY SUCH REMEDIAL 12. ACTION SHALL REQUIRE WRITTEN APPROVAL BY THE AT&T MOBILITY REP PRIOR TO PROCEEDING
- EACH CONTRACTOR SHALL COOPERATE WITH THE AT&T MOBILITY REP, AND 13. COORDINATE HIS WORK WITH THE WORK OF OTHERS
- CONTRACTOR SHALL REPAIR ANY DAMAGE CAUSED BY CONSTRUCTION OF THIS PROJECT TO MATCH EXISTING PRE-CONSTRUCTION CONDITIONS TO THE SATISFACTION 14. OF THE AT&T MOBILITY CONSTRUCTION MANAGER.
- 15. ALL CABLE/CONDUIT ENTRY/EXIT PORTS SHALL BE WEATHERPROOFED DURING INSTALLATION USING A SILICONE SEALANT
- WHERE EXISTING CONDITIONS DO NOT MATCH THOSE SHOWN IN THIS PLAN SET, 16. CONTRACTOR SHALL NOTIFY THE AT&T MOBILITY REP AND ENGINEER OF RECORD
- CONTRACTOR SHALL ENSURE ALL SUBCONTRACTORS ARE PROVIDED WITH A COMPLETE AND CURRENT SET OF DRAWINGS AND SPECIFICATIONS FOR THIS PROJECT. 17.
- CONTRACTOR SHALL REMOVE ALL RUBBISH AND DEBRIS FROM THE SITE AT THE END OF 18. FACH DAY
- 19. CONTRACTOR SHALL COORDINATE WORK SCHEDULE WITH AMERICAN TOWER CORPORATION (ATC) AND TAKE PRECAUTIONS TO MINIMIZE IMPACT AND DISRUPTION OF OTHER OCCUPANTS OF THE FACILITY.
- CONTRACTOR SHALL FURNISH AT&T MOBILITY AND AMERICAN TOWER CORPORATION 20. (ATC) WITH A PDF MARKED UP AS-BUILT SET OF DRAWINGS UPON COMPLETION OF WORK
- PRIOR TO SUBMISSION OF BID, CONTRACTOR SHALL COORDINATE WITH AT&T MOBILITY 21. REP TO DETERMINE WHAT, IF ANY, ITEMS WILL BE PROVIDED. ALL ITEMS NOT PROVIDED SHALL BE PROVIDED AND INSTALLED BY THE CONTRACTOR. CONTRACTOR WILL INSTALL 2. ALL EXTERIOR #6 GREED GROUND WIRE "DAISY CHAIN" CONNECTIONS ARE TO BE

ALL ITEMS PROVIDED.

24.

31

- PRIOR TO SUBMISSION OF BID. CONTRACTOR SHALL COORDINATE WITH AT&T MOBILITY REP TO DETERMINE IF ANY PERMITS WILL BE OBTAINED BY CONTRACTOR. ALL REQUIRED PERMITS NOT OBTAINED BY AT&T MOBILITY MUST BE OBTAINED, AND PAID FOR, BY THE CONTRACTOR
- 23. CONTRACTOR SHALL INSTALL ALL SITE SIGNAGE IN ACCORDANCE WITH AT&T MOBILITY SPECIFICATIONS AND REQUIREMENTS.
  - CONTRACTOR SHALL SUBMIT ALL SHOP DRAWINGS TO AT&T MOBILITY FOR REVIEW AND APPROVAL PRIOR TO FABRICATION.
- 25. ALL EQUIPMENT SHALL BE INSTALLED ACCORDING TO MANUFACTURER'S SPECIFICATIONS AND LOCATED ACCORDING TO AT&T MOBILITY SPECIFICATIONS, AND AS SHOWN IN THESE PLANS.
- THE CONTRACTOR SHALL SUPERVISE AND DIRECT THE PROJECT DESCRIBED HEREIN. 26. THE CONTRACTOR SHALL BE SOLELY RESPONSIBLE FOR ALL THE CONSTRUCTION MEANS, METHODS, TECHNIQUES, SEQUENCES AND PROCEDURES AND FOR COORDINATING ALL PORTIONS OF THE WORK UNDER THE CONTRACT.
- 27. CONTRACTOR SHALL NOTIFY AT&T MOBILITY REP A MINIMUM OF 48 HOURS IN ADVANCE OF POURING CONCRETE OR BACKFILLING ANY UNDERGROUND UTILITIES, FOUNDATIONS OR SEALING ANY WALL, FLOOR OR ROOF PENETRATIONS FOR ENGINEERING REVIEW
- CONTRACTOR SHALL BE RESPONSIBLE FOR SITE SAFETY INCLUDING COMPLIANCE WITH ALL APPLICABLE OSHA STANDARDS AND RECOMMENDATIONS AND SHALL PROVIDE ALL 28. NECESSARY SAFETY DEVICES INCLUDING PPE AND PPM AND CONSTRUCTION DEVICES SUCH AS WELDING AND FIRE PREVENTION, TEMPORARY SHORING, SCAFFOLDING TRENCH BOXES/SLOPING, BARRIERS, ETC.
- THE CONTRACTOR SHALL PROTECT AT HIS OWN EXPENSE, ALL EXISTING FACILITIES AND 29. SUCH OF HIS NEW WORK LIABLE TO INJURY DURING THE CONSTRUCTION PERIOD. ANY DAMAGE CAUSED BY NEGLECT ON THE PART OF THIS CONTRACTOR OR HIS REPRESENTATIVES, OR BY THE ELEMENTS DUE TO NEGLECT ON THE PART OF THIS CONTRACTOR OR HIS REPRESENTATIVES FITHER TO THE EXISTING WORK OR TO HIS WORK OR THE WORK OF ANY OTHER CONTRACTOR, SHALL BE REPAIRED AT HIS EXPENSE TO THE OWNER'S SATISFACTION.
- 30. ALL WORK SHALL BE INSTALLED IN A FIRST CLASS, NEAT AND WORKMANLIKE MANNER BY MECHANICS SKILLED IN THE TRADE INVOLVED. THE QUALITY OF WORKMANSHIP SHALL BE SUBJECT TO THE APPROVAL OF THE AT&T MOBILITY REP. ANY WORK FOUND BY THE AT&T MOBILITY REP TO BE OF INFERIOR QUALITY AND/OR WORKMANSHIP SHALL BE REPLACED AND/OR REWORKED AT CONTRACTOR EXPENSE UNTIL APPROVAL IS
  - IN ORDER TO ESTABLISH STANDARDS OF QUALITY AND PERFORMANCE, ALL TYPES OF MATERIALS LISTED HEREINAETER BY MANUFACTURER'S NAMES AND/OF MANUFACTURER'S CATALOG NUMBER SHALL BE PROVIDED BY THESE MANUFACTURERS AS SPECIFIED

AT&T MOBILITY FURNISHED EQUIPMENT SHALL BE PICKED-UP AT THE AT&T MOBILITY WAREHOUSE, NO LATER THAN 48HR AFTER BEING NOTIFIED INSURED, STORED, UNCRATE, PROTECTED AND INSTALLED BY THE CONTRACTOR WITH ALL APPURTENANCES REQUIRED TO PLACE THE EQUIPMENT IN OPERATION. READY FOR USE. THE CONTRACTOR SHALL BE RESPONSIBLE FOR THE EQUIPMENT AFTER PICKING IT

AT&T MOBILITY OR HIS ARCHITECT/ENGINEER RESERVES THE RIGHT TO REJECT ANY FOUIPMENT OR MATERIALS WHICH. IN HIS OWN OPINION ARE NOT IN COMPLIANCE WITH EQUIPMENT SHALL BE REPLACED WITH EQUIPMENT CONFORMING TO THE REQUIREMENTS OF THE CONTRACT DOCUMENTS BY THE CONTRACTOR AT NO COST TO AT&T MOBILITY OR THEIR ARCHITECT/ENGINEER

#### SPECIAL CONSTRUCTION

#### ANTENNA INSTALLATION NOTES:

1. WORK INCLUDED

- ANTENNA AND COAXIAL CABLES ARE FURNISHED BY AT&T MOBILITY UNDER A SEPARATE CONTRACT, THE CONTRACTOR SHALL ASSIST ANTENNA INSTALLATION CONTRACTOR IN TERMS OD COORDINATION AND SITE ACCESS. ERECTION SUBCONTRACTOR SHALL BE RESPONSIBLE FOR THE PROTECTION OF PERSONNEL AND
- B. INSTALL ANTENNA AS INDICATE ON DRAWINGS AND AT&T MOBILITY SPECIFICATIONS
- C. INSTALL GALVANIZED STEEL ANTENNA MOUNTS AS INDICATED ON DRAWINGS
- D. INSTALL FURNISHED GALVANIZED STEEL OR ALUMINUM WAVEGUIDE AND PROVIDE PRINTOUT OF THAT TEST.
- E. CONTRACTOR SHALL PROVIDE FOUR (4) SETS OF SWEEP TESTS USING ANRITZU-PACKARD 8713B RF SCALAR NETWORK ANALYZER. SUBMIT FREQUENCY DOMAIN REFLECTOMETER(FDR) TESTS RESULTS TO THE PROJECT MANAGER. SWEEP TESTS SHALL BE AS PER ATTACHED RES "MINIMUM FIELD TESTING RECOMMENDED FOR ANTENNA AND HELIAX COAXIAL CABLE SYSTEMS" DATED 10/5/93. TESTING SHALL BE PERFORMED BY AN INDEPENDENT TESTING SERVICE AND BE BOUND AND SUBMITTED WITHIN ONE WEEK OF WORK COMPLETION.
- INSTALL COAXIAL CABLES AND TERMINATING BETWEEN ANTENNAS AND EQUIPMENT PER MANUFACTURER'S RECOMMENDATIONS. WEATHERPROOF ALL CONNECTIONS BETWEEN THE ANTENNA AND FOUIPMENT PER MANUFACTURER'S REQUIREMENTS. TERMINATE ALL COAXIAL CABLE THREE (3) FEET IN EXCESS OF ENTRY PORT LOCATION UNLESS OTHERWISE STATED.

G. ANTENNA AND COAXIAL CABLE GROUNDING:

WEATHER SEALED WITH RFS CONNECTORS/SPLICE WEATHERPROOFING KIT #221213 OR EQUAL

ALL COAXIAL CABLE GROUNDING KITS ARE TO BE INSTALLED ON STRAIGHT RUNS OF COAXIAL CABLE (NOT WITHIN BENDS)

REDLINED CDs

Matthew Schlosser

3/23/2021


Matthew Schlosser


Ramapo Communication Corp


ENGINEERING IMMEDIATELY FOR CORRECTION OR RE-DESIGN. **RESPONSIBILITY OF THE GENERAL CONTRACTOR.** 



ALL DISCREPANCIES FROM WHAT IS SHOWN ON THESE CONSTRUCTION DRAWINGS SHALL BE COMMUNICATED TO ATC FAILURE TO COMMUNICATE DIRECTLY WITH ATC ENGINEERING OR ANY CHANGES FROM THE DESIGN CONDUCTED WITHOUT PRIOR APPROVAL FROM ATC ENGINEERING SHALL BE THE SOLE

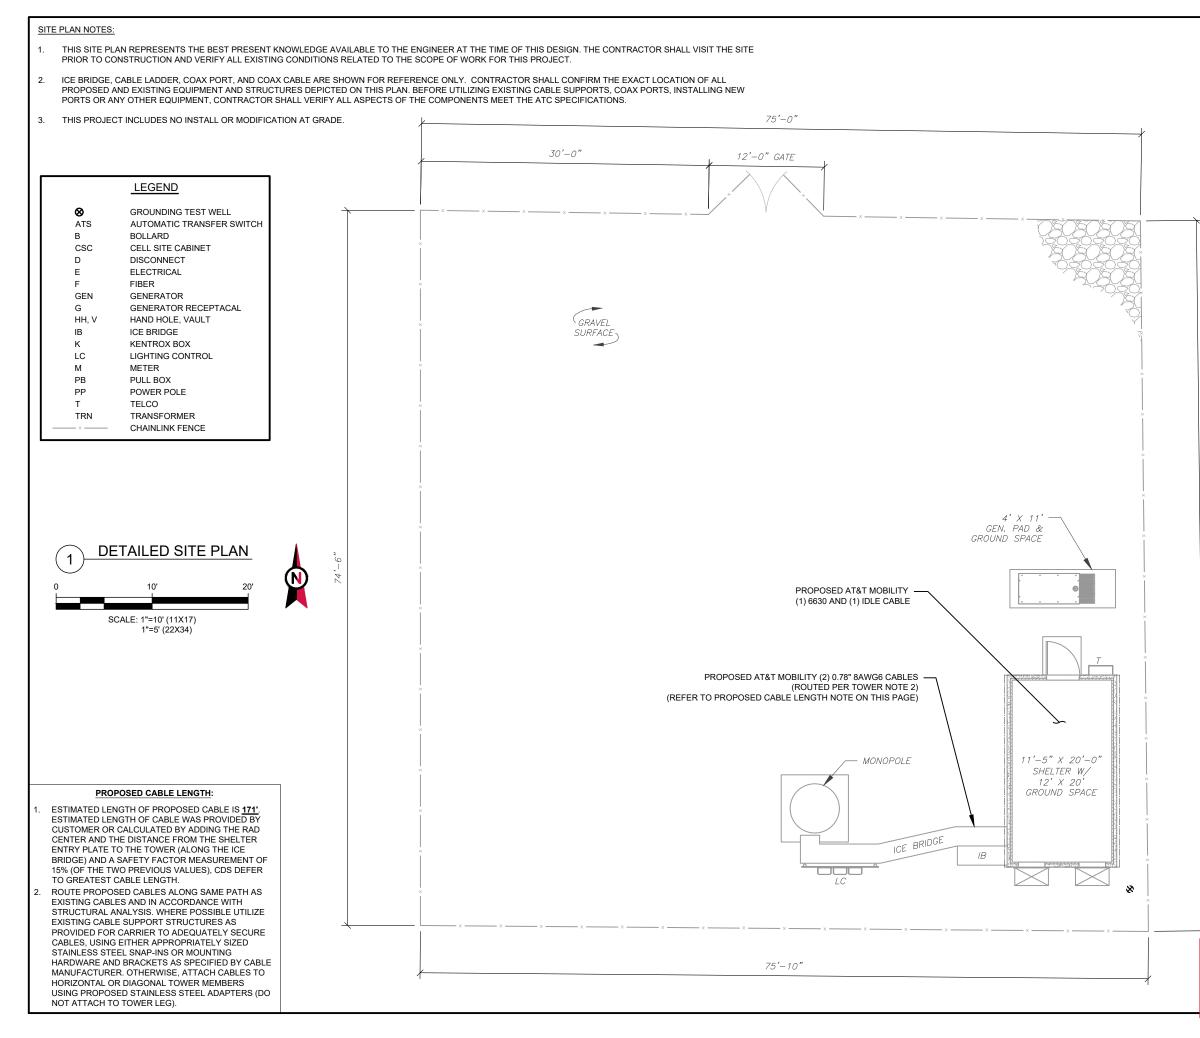

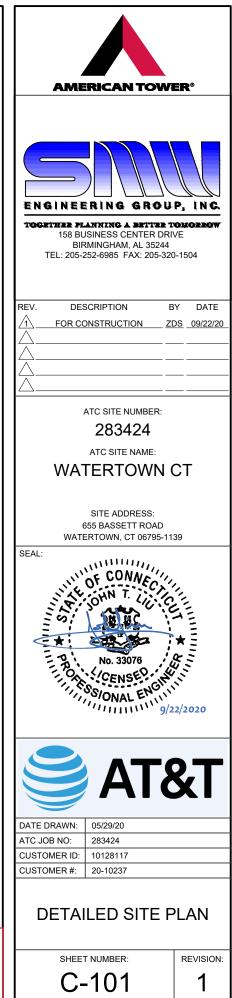

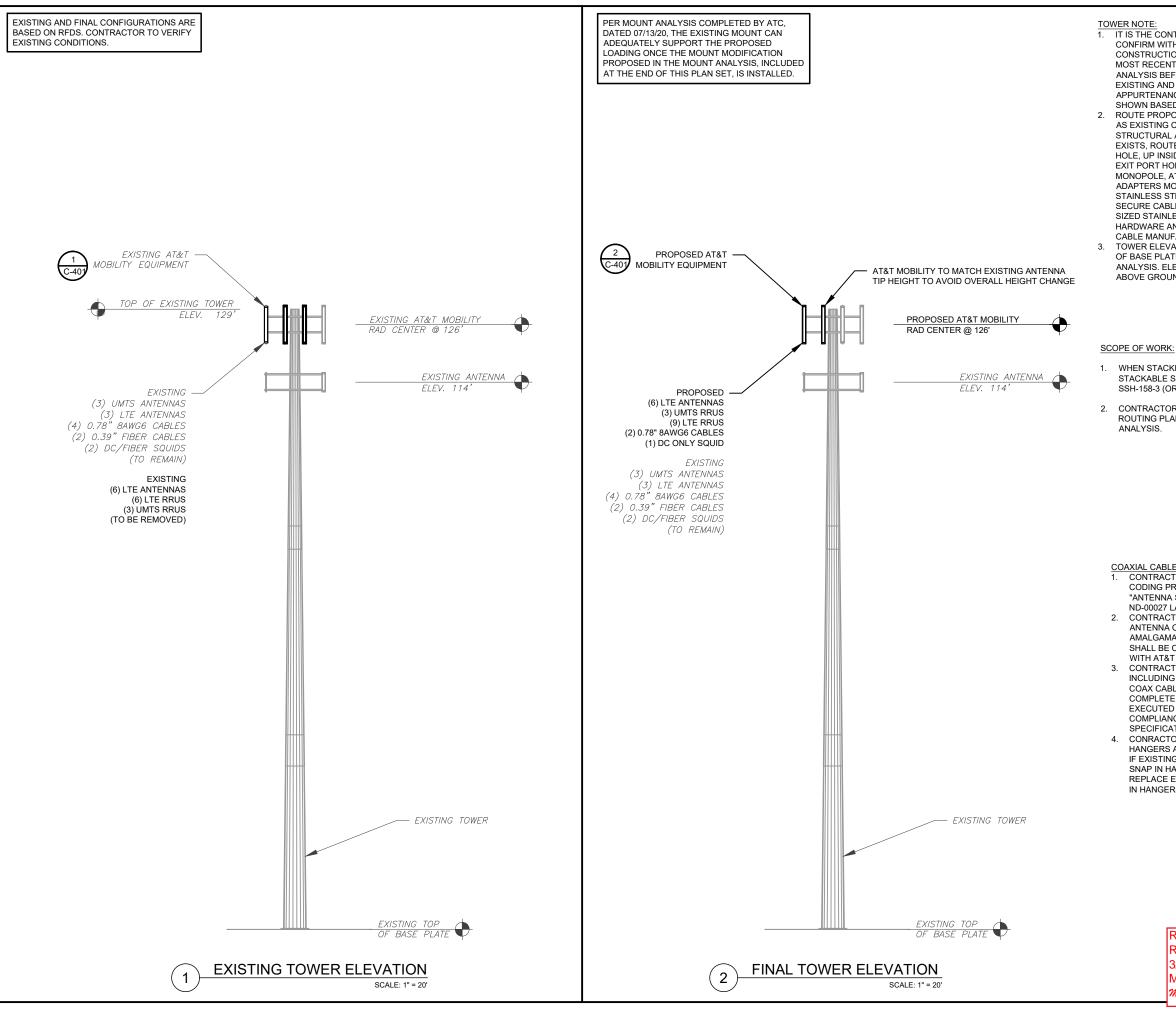


TOWER NOTE: 1. IT IS THE CONTRACTOR'S RESPONSIBILITY TO CONFIRM WITH THE AMERICAN TOWER CONSTRUCTION MANAGER THAT THEY HAVE THE MOST RECENT VERSION OF THE STRUCTURAL ANALYSIS BEFORE COMMENCING WORK. EXISTING AND PROPOSED TOWER APPURTENANCES, MOUNTS, AND ANTENNAS ARE SHOWN BASED ON THE STRUCTURAL ANALYSIS. 2. ROUTE PROPOSED CABLES ALONG SAME PATH AS EXISTING CABLES AND IN ACCORDANCE WITH STRUCTURAL ANALYSIS. IF ADEQUATE SPACE EXISTS, ROUTE CABLES THROUGH ENTRY PORT HOLE, UP INSIDE OF MONOPOLE, AND THROUGH EXIT PORT HOLE. IF ROUTING OUTSIDE THE MONOPOLE, ATTACH CABLES USING STAND-OFF ADAPTERS MOUNTED TO TOWER USING STAINLESS STEEL BANDING ADEQUATELY SECURE CABLES USING EITHER APPROPRIATELY SIZED STAINLESS STEEL SNAP-INS OR MOUNTING HARDWARE AND BRACKETS AS SPECIFIED BY CABLE MANUFACTURER. TOWER ELEVATIONS ARE MEASURED FROM TOP OF BASE PLATE TO MATCH STRUCTURAL ANALYSIS. ELEVATIONS DO NOT REFLECT TRUE ABOVE GROUND LEVEL (A.G.L.) REV WHEN STACKING CABLES 3 OR MORE DEEP, USE STACKABLE SNAP-INS, TALLEY PART NUMBER SSH-158-3 (OR ENGINEER APPROVED EQUAL). CONTRACTOR SHALL CONFIRM THE FINAL CABLE ROUTING PLAN WITH THE STRUCTURAL SEAL COAXIAL CABLE NOTES: CONTRACTOR SHALL CONFIRM COAX COLOR CODING PRIOR TO CONSTRUCTION. REFER TO "ANTENNA SYSTEM LABELING STANDARD" ND-00027 LATEST VERISON 2. CONTRACTOR SHALL WEATHERPROOF ALL ANTENNA CONNECTORS WITH SELF AMALGAMATING TAPE. WEATHERPROOFING SHALL BE COMPLETED IN STRICT ACCODRANCE WITH AT&T STANDARDS. CONTRACTOR SHALL GROUND ALL EQUIPMENT. INCLUDING ANTENNAS RET MOTORS TMA'S COAX CABLES, AND RET CONTROL CBALES AS A COMPLETE SYTEM. GROUNDING SHALL BE EXECUTED BY QUALIFIED WIREMEN IN

COMPLIANCE WITH MANUFACTURER'S SPECIFICATION AND RECOMMENDATION. CONRACTOR TO VERIFY THAT EXISTING COAX HANGERS ARE STACKABLE SNAP IN HANGERS. IF EXISTING HANGERS ARE NOT STACKABLE SNAP IN HANGERS THE CONTRACTOR SHALL REPLACE EXISTING HANGERS WITH NEW SNAP IN HANGERS IF APPLICABLE.

> REDLINED CDs Ramapo Communication Corp 3/23/2021 Matthew Schlosser *Matthew Schlosser*



C-201

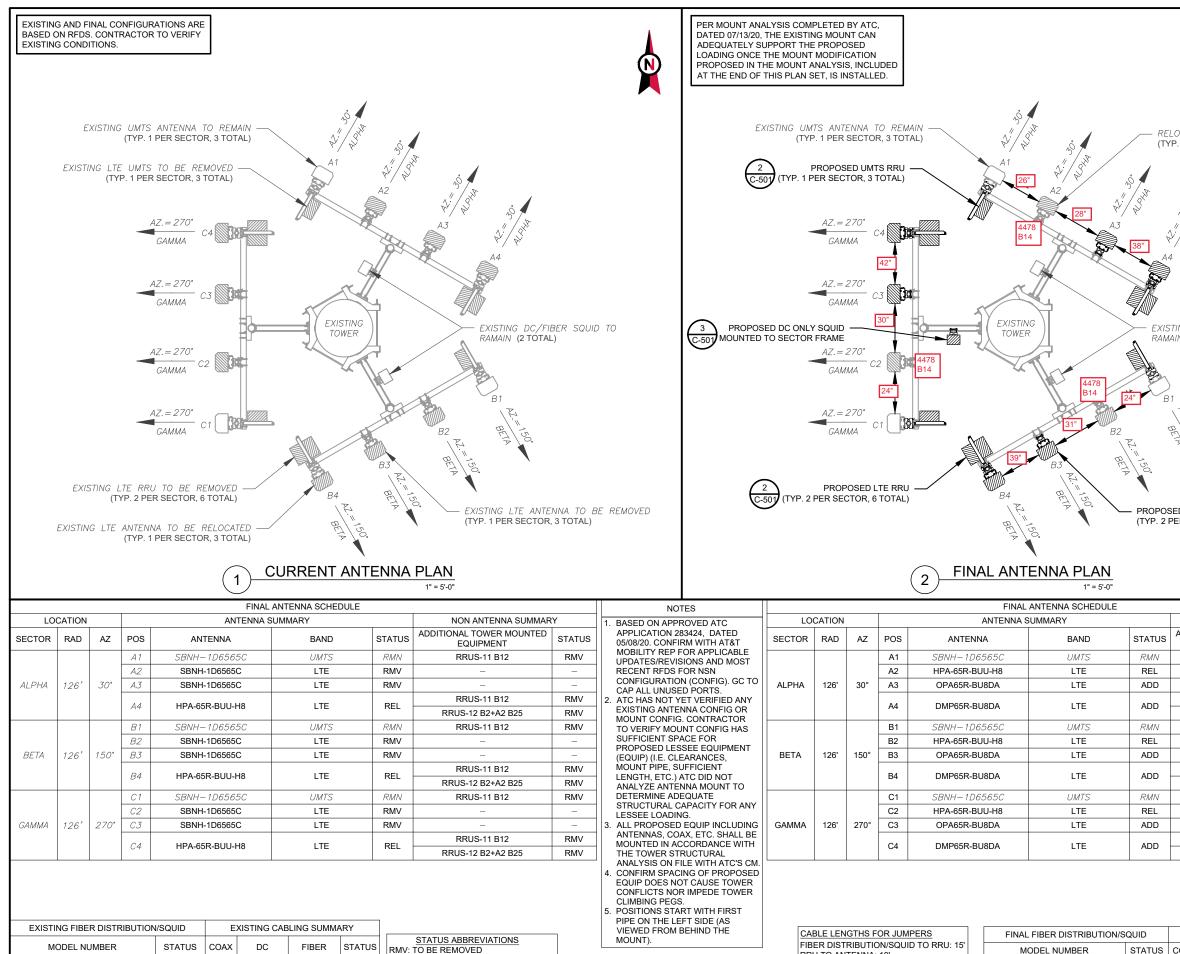

EQUIPMENT SCHEDULES 3

RMN: TO REMAIN

ADD. TO BE ADDED

REL: TO BE RELOCATED

DSC: TO BE DISCONNECTED & REMAIN

(2) DC2-48-60-8-18F-02

RMN


(4) 0.78"

(2) 0.39

RMN

RRU TO ANTENNA: 10'

MODEL NUMBER STATUS (2) DC2-48-60-8-18F-02 RMN DC2-48-60-8-18F-02 ADD

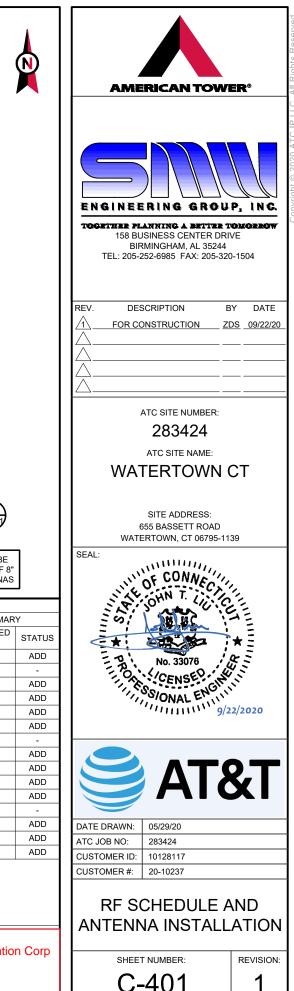

RELOCATED LTE ANTENNA (TYP. 1 PER SECTOR, 3 TOTAL)



EXISTING DC/FIBER SQUID TO RAMAIN (2 TOTAL)




PROPOSED I TE ANTENNA (TYP. 2 PER SECTOR, 6 TOTAL)




PROPOSED RRUS MUST BE INSTALLED A MINIMUM OF 8" AWAY FROM ALL ANTENNAS


NON ANTENNA SUMMARY ADDITIONAL TOWER MOUNTED EQUIPMENT RRUS-11 B5 RRUS-4478 B14 RRUS-4449 B5/B12 RRUS-8843 B2/B66A RRUS-11 B5 RRUS-4478 B14 RRUS-4449 B5/B12 RRUS-8843 B2/B66A RRUS-11 B5 RRUS-4478 B14 RRUS-4449 B5/B12 RRUS-8843 B2/B66A

REDLINED CDs CRAMAPO COMMUNICATION CORP 3/23/2021 Matthew Schlosser Matthew Schlosser

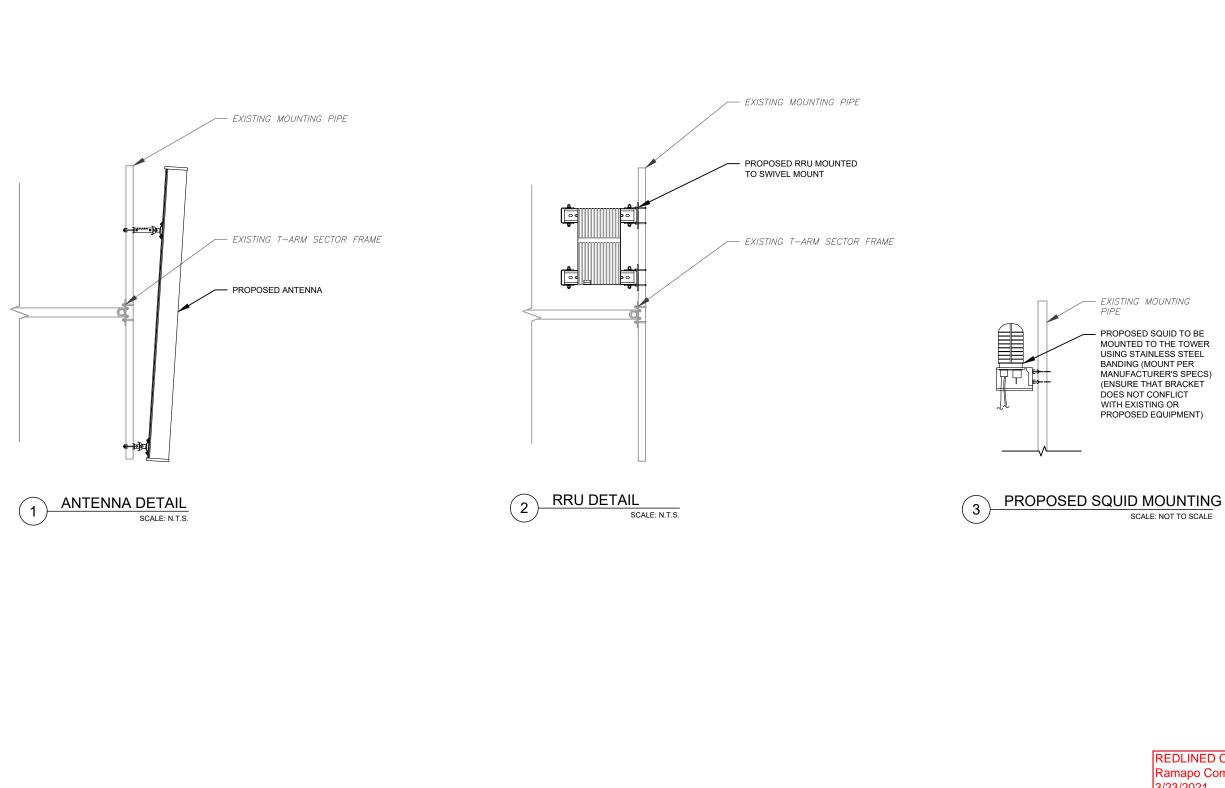



SCALE: NOT TO SCALE

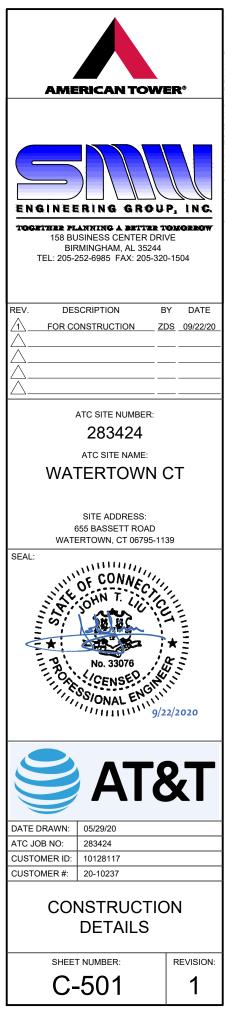

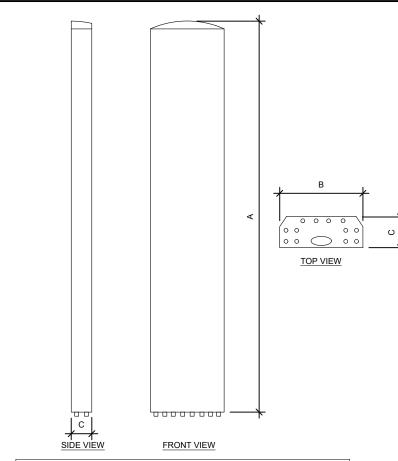


ANTENNA SPECIFICATIONS						
	ANTENNA MODEL	А	В	С	WEIGHT (LBS)	
	OPA65R-BU8DA	96.0"	21"	7.8"	76.5	
	DMP65R-BU8DA	96.0"	20.7"	7.7"	95.7	

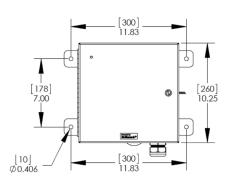

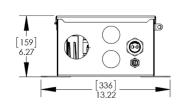

RAYCAP SPECIFICATIONS					
RAYCAP MODEL	A	В	с	WEIGHT (LBS)	
DC2-48-60-8-18F-02	13.22"	11.64"	6.27"	16.0	

TOP VIEW

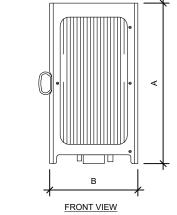

U

С


SIDW VIEW


RRU SPECIFICATIONS						
RRU MODEL A B C W						
RRUS-11 B5	19.69"	16.97"	7.17"	55.0		
RRUS-4478 B14	18.1"	13.4"	8.3"	59.4		
RRUS-4449 B5/B12	17.9"	13.2"	9.4"	71.0		
RRUS-8843 B2/B66A	18.0"	13.2"	11.3"	75.0		

RAYCAP SPECIFICATIONS							
RAYCAP MODEL	A	В	С	WEIGHT (LBS)			
DC2-48-60-8-18F-02	13.22"	11.64"	6.27"	16.0			


EQUIPMENT SPECIFICATIONS SCALE: NOT TO SCALE

1

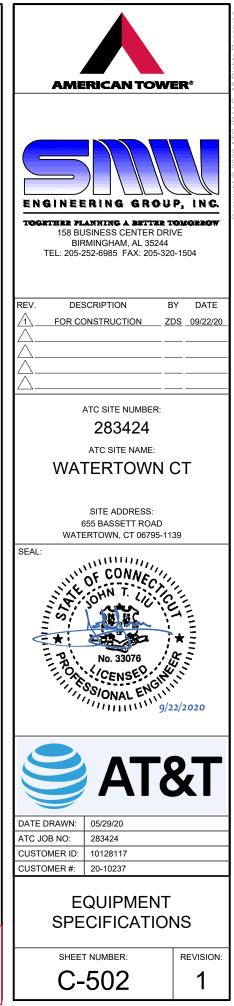

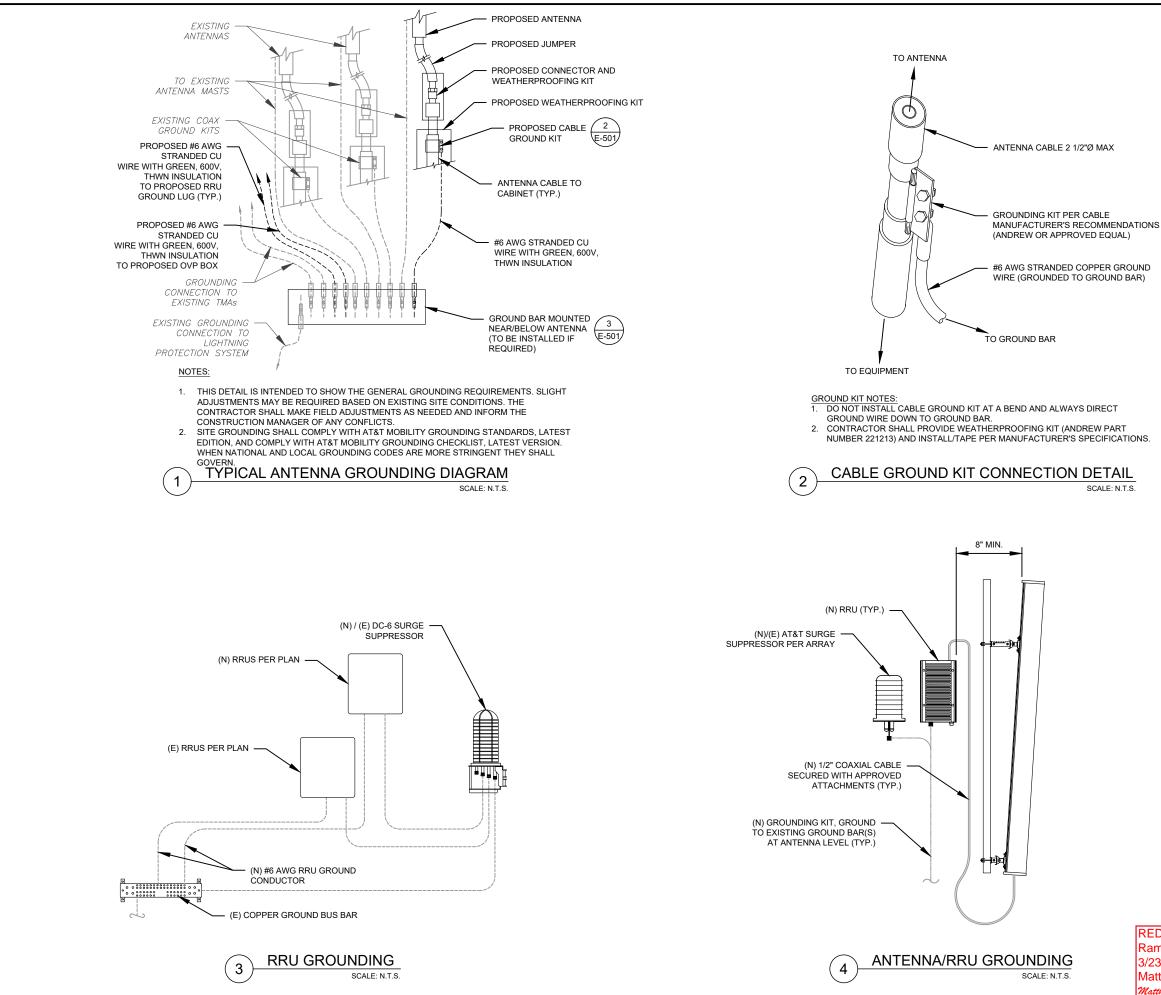

**AMERICAN TOWER®** ENGINEERING GROUP, INC. TOGETHER PLANNING & BETTER TOMORROW 158 BUSINESS CENTER DRIVE BIRMINGHAM, AL 35244 TEL: 205-252-6985 FAX: 205-320-1504 DESCRIPTION BY DATE REV. FOR CONSTRUCTION ZDS 09/22/20 ATC SITE NUMBER: 283424 ATC SITE NAME: WATERTOWN CT SITE ADDRESS: 655 BASSETT ROAD WATERTOWN, CT 06795-1139 SEAL OF CONNEC No. 33076 SSIONAL ENG SONAL EN 9/22/2020 DATE DRAWN: 05/29/20 ATC JOB NO: 283424 CUSTOMER ID: 10128117 CUSTOMER #: 20-10237 GROUNDING DETAILS SHEET NUMBER: REVISION E-501 1

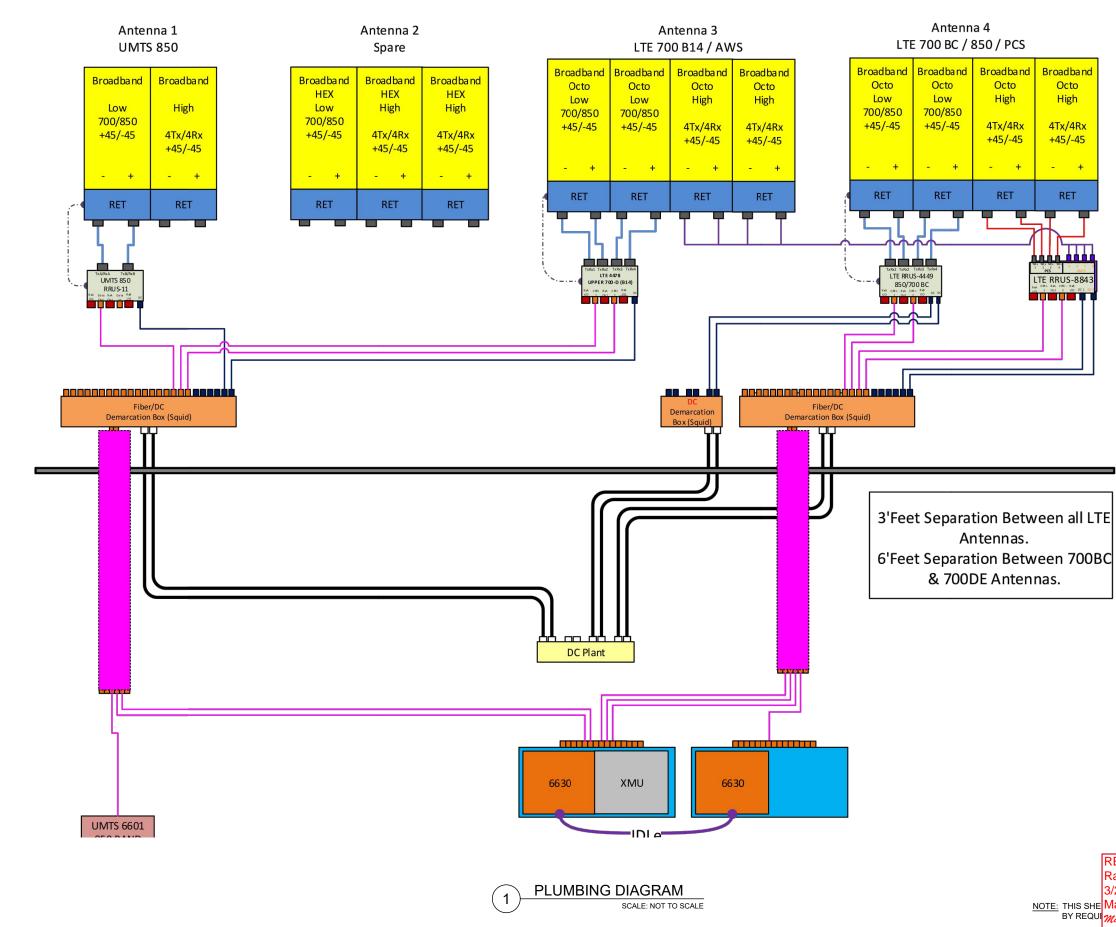

REDLINED CDs
Ramapo Communication Corp
3/23/2021
Matthew Schlosser
Matthew Schlosser



**REVISION:** -

# SUPPLEMENTAL



### **AMERICAN TOWER®**

CORPORATION

## Antenna Mount Analysis Report

ATC Site Name	:	WATERTOWN CT, CT
ATC Site Number	:	283424
Engineering Number	:	13213496_C9_06
Mount Elevation	:	124 ft
Carrier	:	AT&T Mobility
Carrier Site Name	:	MRCTB046623
Carrier Site Number	:	CTL01835
Site Location	:	655 Bassett Road Watertown, CT 06795-1139 41.65707777 , -73.1362611
County	:	Litchfield
Date	:	July 13, 2020
Max Usage	:	98%
Result	:	Contingent Pass

Prepared By: Mitchell Chen Structural Engineer I

COA: PEC.0001553

A.T. Engineering Service, PLLC - 3500 Regency Parkway, Suite 100 - Cary, NC 27518 - 919.468.0112 Office - 919.466.5414 Fax - www.americantower.com

Reviewed By:



#### Introduction

The purpose of this report is to summarize results of the antenna mount analysis performed for A Mobility at 124 ft.

### Supporting Documents

Mount Mapping	MasTec Project #202197, dated June 17, 2020
Radio Frequency Data Sheet	RFDS ID #10128117, dated March 24, 2020
Reference Photos	Site photos from 2020

#### <u>Analysis</u>

This antenna mount was analyzed using American Tower Corporation's Mount Analysis Program

Basic Wind Speed:	115 mph (3-Second Gust)
Basic Wind Speed w/ Ice:	50 mph (3-Second Gust) w/ 1" radial ice concurrent
Codes:	ANSI/TIA-222-H
Exposure Category:	С
Risk Category:	11
Topographic Factor Procedure:	Method 2
Feature:	Flat
Crest Height (H):	0 ft
Crest Length (L):	0 ft
Spectral Response:	Ss = 0.185, S1 = 0.054
Site Class:	D - Stiff Soil
Live Loads:	Lm = 500 lbs, Lv = 250 lbs


#### **Conclusion**

Based on the analysis results, the antenna mount does not meet the requirements per the applical listed above. The mount can support the equipment as described in this report after the below list modifications are completed:

• Install modifications per ATC drawing #13213496\_C9\_06.


If you have any questions or require additional information, please contact American Tower via Engineering@americantower.com. Please include the American Tower site name, site number engineering number in the subject line for any questions.

A.T. Engineering Service, PLLC - 3500 Regency Parkway, Suite 100 - Cary, NC 27518 - 919.468.0112 Office - 919.466.5414 Fax - www.americantov

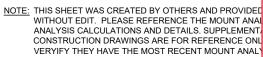



And RISA-3D  and RISA-3D  ble codes  ted  a email at , and  REDLINED CDs Ramapo Communication Corp			
REDLINED CDs Ramapo Communication Corp 3/23/2021 SHEET NUMBER: REVISION: Rathew Schlosser			
REDLINED CDs Ramapo Communication Corp 3/23/2021 SHEET NUMBER: REVISION: Rathew Schlosser			
REDLINED CDs Ramapo Communication Corp 3/23/2021 SHEET NUMBER: REVISION: Rathew Schlosser			
REDLINED CDs Ramapo Communication Corp 3/23/2021 SHEET NUMBER: REVISION: Rathew Schlosser			
REDLINED CDs Ramapo Communication Corp 3/23/2021 SHEET NUMBER: REVISION: Rathew Schlosser			
Page 1 T&T T&T Tat and RISA-3D ble codes ted a email at r, and REDLINED CDs Ramapo Communication Corp 3/23/2021 SHEET NUMBER: R=602	3496_C9_06		
T&T			
And RISA-3D  and RISA-3D  ble codes ted  a email at t, and  REDLINED CDs Ramapo Communication Corp 3/23/2021  SHEET NUMBER: REVISION: Rathew Schlosser	Page 1		
And RISA-3D  and RISA-3D  ble codes ted  a email at t, and  REDLINED CDs Ramapo Communication Corp 3/23/2021  SHEET NUMBER: REVISION: Rathew Schlosser			
And RISA-3D  and RISA-3D  ble codes ted  a email at t, and  REDLINED CDs Ramapo Communication Corp 3/23/2021  SHEET NUMBER: REVISION: Rathew Schlosser			
And RISA-3D  and RISA-3D  ble codes ted  a email at t, and  REDLINED CDs Ramapo Communication Corp 3/23/2021  SHEET NUMBER: REVISION: Rathew Schlosser	тет		
Able codes ted a email at r, and REDLINED CDS Ramapo Communication Corp 3/23/2021 Matthew Schlosser REVISION: Ramapo Communication Corp	1.01		
Able codes ted a email at r, and REDLINED CDS Ramapo Communication Corp 3/23/2021 Matthew Schlosser REVISION: Ramapo Communication Corp			
Able codes ted a email at r, and REDLINED CDS Ramapo Communication Corp 3/23/2021 Matthew Schlosser REVISION: Ramapo Communication Corp			
Able codes ted a email at r, and REDLINED CDS Ramapo Communication Corp 3/23/2021 Matthew Schlosser REVISION: Ramapo Communication Corp			
Able codes ted a email at r, and REDLINED CDS Ramapo Communication Corp 3/23/2021 Matthew Schlosser REVISION: Ramapo Communication Corp			
Able codes ted a email at r, and REDLINED CDS Ramapo Communication Corp 3/23/2021 Matthew Schlosser REVISION: Ramapo Communication Corp			
Able codes ted a email at r, and REDLINED CDS Ramapo Communication Corp 3/23/2021 Matthew Schlosser REVISION: Ramapo Communication Corp			
Able codes ted a email at r, and REDLINED CDS Ramapo Communication Corp 3/23/2021 Matthew Schlosser REVISION: Ramapo Communication Corp			
Able codes ted a email at r, and REDLINED CDS Ramapo Communication Corp 3/23/2021 Matthew Schlosser REVISION: Ramapo Communication Corp	and RISA-3D		
REDLINED CDs Ramapo Communication Corp 3/23/2021 Matthew Schlosser			
REDLINED CDs Ramapo Communication Corp 3/23/2021 Matthew Schlosser			
REDLINED CDS Ramapo Communication Corp 3/23/2021 Matthew Schlosser	able codes		
REDLINED CDs Ramapo Communication Corp 3/23/2021 Matthew Schlosser	sted		
REDLINED CDs Ramapo Communication Corp 3/23/2021 Matthew Schlosser			
REDLINED CDs Ramapo Communication Corp 3/23/2021 Matthew Schlosser			
REDLINED CDs Ramapo Communication Corp 3/23/2021 Matthew Schlosser			
REDLINED CDs Ramapo Communication Corp 3/23/2021 Matthew Schlosser	a email at		
REDLINED CDs Ramapo Communication Corp 3/23/2021 Matthew Schlosser Revision: REVISION:	r, and		
REDLINED CDs Ramapo Communication Corp 3/23/2021 Matthew Schlosser Revision: REVISION:			
REDLINED CDs Ramapo Communication Corp 3/23/2021 Matthew Schlosser Revision: REVISION:			
REDLINED CDs Ramapo Communication Corp 3/23/2021 Matthew Schlosser Revision: REVISION:			
REDLINED CDs Ramapo Communication Corp 3/23/2021 Matthew Schlosser Revision: REVISION:			
REDLINED CDs Ramapo Communication Corp 3/23/2021 Matthew Schlosser Revision: REVISION:			
REDLINED CDs Ramapo Communication Corp 3/23/2021 Matthew Schlosser Revision: REVISION:			
REDLINED CDs Ramapo Communication Corp 3/23/2021 Matthew Schlosser Revision: REVISION:			
REDLINED CDs         Ramapo Communication Corp         3/23/2021         Matthew Schlosser			
REDLINED CDs         Ramapo Communication Corp         3/23/2021         Matthew Schlosser	wer.com		
REDLINED CDs         Ramapo Communication Corp         3/23/2021         Matthew Schlosser			
REDLINED CDs         Ramapo Communication Corp         3/23/2021         Matthew Schlosser			
REDLINED CDs         Ramapo Communication Corp         3/23/2021         Matthew Schlosser			
REDLINED CDs         Ramapo Communication Corp         3/23/2021         Matthew Schlosser		SUPPLEMENT	AL
Ramapo Communication Corp     SHEET NUMBER:     REVISION:       3/23/2021     REVISION:     REVISION:       Matthew Schlosser     R_602     -	REDLINED CDs		
3/23/2021 Matthew Schlosser <b>R_602</b> -	Ramapo Communication Corp		
Matthew Schlosser Matthew Schlosser –	3/23/2021		REVISION:
INlatthew Schlosser		R-602	_
	Matthew Schlosser		

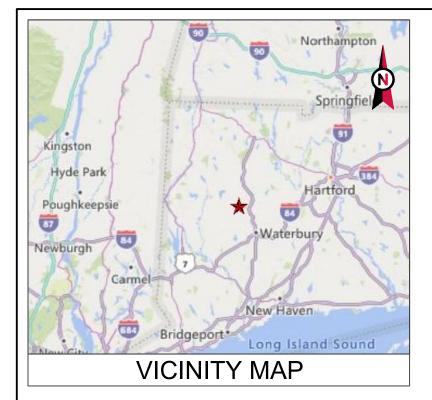



SITE NAME: WATERTOWN CT SITE NUMBER: 283424 ATC PROJECT NUMBER: 13213496\_C9\_06 SITE ADDRESS: 655 BASSETT ROAD WATERTOWN, CT 06795



# MOUNT REINFORCEMENT DRAWINGS PREPARED FOR AT&T MOBILITY

PROJECT TEAM	PROJECT DESCRIPTION	SHEET	SHEET TITLE
		G-002	IBC GENERAL NOTES AND MOUNT MODIFICATION INSPECTION
TOWER OWNER	THE MODIFICATIONS PRESENTED ON THESE DRAWINGS ARE BASED ON THE	S-101	MODIFICATION PROFILE
AMERICAN TOWER	RECOMMENDATIONS OUTLINED IN THE MOUNT ANALYSIS COMPLETED UNDER ENGINEERING PROJECT NUMBER 13213496 C8 03 DATED 07/02/20.	R-601	SUPPLEMENTAL
10 PRESIDENTAL WAY	SATISFACTORY COMPLETION OF THE WORK INDICATED ON THESE DRAWINGS WILL RESULT IN THE MOUNT MEETING THE REQUIREMENTS OF THE	R-602	SUPPLEMENTAL
WOBURN, MA 01801	SPECIFICATIONS UNDER WHICH THE MOUNT ANALYSIS WAS COMPLETED.		
ENGINEERED BY			
ATC TOWER SERVICES	COMPLIANCE CODE		
3500 REGENCY PARKWAY, SUITE 100	ALL WORK SHALL BE PERFORMED AND MATERIALS INSTALLED IN		
CARY, NC 27518	ACCORDANCE WITH THE CURRENT EDITIONS OF THE FOLLOWING CODES AS ADOPTED BY THE LOCAL GOVERNMENT AUTHORITIES, NOTHING IN THESE		
	PLANS IS TO BE CONSTRUED TO PERMIT WORK NOT CONFORMING TO THESE CODES.		
CARRIER INFORMATION	oodes.		
CARRIER: AT&T MOBILITY	1. ANSI/TIA/EIA: STRUCTURAL STANDARDS (222-H EDITION)		
CARRIER SITE NAME: MRCTB046623	2. INTERNATIONAL BUILDING CODE (2015 IBC)		
CARRIER SITE NUMBER: CTL01835	3. CONNECTICUT STATE BUILDING CODE (2018)		
000	PROJECT LOCATION		
Know what's below. Call before you dig.	GEOGRAPHIC COORDINATES		
	LONGITUDE: -73.1362611		


	,			
		A.T. ENGI 3500 PH	ERICAN TOWN NEERING SERVIC D REGENCY PARKWAY SUITE 100 CARY, NC 27518 IONE: (919) 468-0112 COA: PEC.0001553	E, PLLC Y
EMOSET LE		OF AMERICAN TOWE RESTRICTED TO THE PREPARED. ANY USE RELATES TO AMERIC STRICTLY PROHIBIT REMAIN THE PROPEF THE PROJECT IS EXE ENGINEER WILL BE OF THIS PROJECT. O DISCREPANCIES. AND AD DISCREPANCIES.	X SERVICE ARE THE EXCLUS R. THER USE AND PUBLICAT ORIGINAL SITE FOR WHICH OR DISCLOSURE OTHER TH AN TOWER OR THE SPECIFIE D. TITLE TO THESE DOCUME TY OF AMERICAN TOWER W :CUTED. NEITHER THE ARCH ROVIDING ON-SITE CONSTRI ONTRACTOR(S) MUST VERIF VISE AMERICAN TOWER OF PRIOR ISSUANCE OF THIS E LATEST VERSION ON FILE V	ION SHALL BE THEY ARE AN THAT WHICH ED CARRIER IS INTS SHALL HETHER OR NOT ITECT NOR THE JCTION REVIEW Y ALL ANY DRAWING IS
KFIEL				BY DATE
LINKFIELD RD	Ser and		<u></u>	<u>GM_07/15/20</u>
I MAP		<u> </u>		
		$\triangle \_$		
			ATC SITE NUMBER:	
			283424	
			ATC SITE NAME:	
		W	ATERTOWN CT	-
		c	ONNECTICUT	
			SITE ADDRESS: 55 BASSETT ROAD	
	REV.		ATERTOWN, CT 06795	
	0			
	0			
	0	·	OF CONNE	
		11,4		11,
		=*	En mik N	Joan
		II PO	32593	2
		11000	SONAL ENGIN	ii ii
		""	NONAL ENTIT	
			32593 SONAL ENGIN	
		DRAWN BY: APPROVED BY:	CGM MCC	
		DATE DRAWN:	07/15/20	
		ATC JOB NO:	13213496_C9_06	
			COVER	
REDLINED CDs	ination Corn			
Ramapo Commun 3/23/2021	ication Corp	SHEET	NUMBER:	REVISION:
Matthew Schlosse Matthew Schlosser	r	G	-001	0
maunew Schlosser		L		

#### GENERAL

- ALL WORK TO BE COMPLETED PER APPLICABLE LOCAL, STATE, FEDERAL CODES AND ORDINANCES AND COMPLY WITH ATC CONSTRUCTION SPECIFICATIONS FOR WIRELESS TOWER SITES. THE CONTRACTOR IS RESPONSIBLE FOR OBTAINING AND ABIDING BY ALL REQUIRED PERMITS.
- 2. ALL WORK INDICATED ON THESE DRAWINGS SHALL BE PERFORMED BY QUALIFIED CONTRACTORS EXPERIENCED IN TOWER AND FOUNDATION CONSTRUCTION.
- THE CONTRACTOR SHALL NOTIFY THE ENGINEER OF RECORD IMMEDIATELY OF ANY INSTALLATION INTERFERENCES. ALL NEW WORK SHALL ACCOMMODATE EXISTING CONDITIONS. DETAILS NOT SPECIFICALLY SHOWN ON THE DRAWINGS SHALL FOLLOW SIMILAR DETAILS FOR THIS JOB.
- 4. ANY SUBSTITUTIONS SHALL CONFORM TO THE REQUIREMENTS OF THESE NOTES AND SPECIFICATIONS, AND SHOULD BE SIMILAR TO THOSE SHOWN. ALL SUBSTITUTIONS SHALL BE SUBMITTED TO THE ENGINEER OF RECORD FOR REVIEW AND APPROVAL PRIOR TO FABRICATION.
- 5. ANY MANUFACTURED DESIGN ELEMENTS SHALL CONFORM TO THE REQUIREMENTS OF THESE NOTES AND SPECIFICATIONS AND SHOULD BE SIMILAR TO THOSE SHOWN. THESE DESIGN ELEMENTS MUST BE STAMPED BY AN ENGINEER PROFESSIONALLY REGISTERED IN THE STATE OF THE PROJECT, AND SUBMITTED TO THE ENGINEER OF RECORD FOR APPROVAL PRIOR TO FABRICATION.
- 6. ALL WORK SHALL BE DONE IN ACCORDANCE WITH LOCAL CODES AND OSHA SAFETY REGULATIONS.
- THE CONTRACTOR IS RESPONSIBLE FOR THE DESIGN AND EXECUTION OF ALL MISCELLANEOUS SHORING, BRACING, TEMPORARY SUPPORTS, ETC. NECESSARY, PER ANSI/TIA-322 AND ANSI/ASSE A10.48, TO PROVIDE A COMPLETE AND STABLE STRUCTURE AS SHOWN ON THESE DRAWINGS.
- 8. CONTRACTOR'S PROPOSED INSTALLATION SHALL NOT INTERFERE, NOR DENY ACCESS TO, ANY EXISTING OPERATIONAL AND SAFETY EQUIPMENT.

#### STRUCTURAL STEEL

- 1. ALL DETAILING, FABRICATION AND ERECTION OF STRUCTURAL STEEL SHALL CONFORM TO THE AISC SPECIFICATIONS, LATEST EDITION.
- 2. ALL EXPOSED STRUCTURAL STEEL MEMBERS SHALL BE HOT-DIPPED GALVANIZED AFTER FABRICATION PER ASTM A123. EXPOSED STEEL HARDWARE AND ANCHOR BOLTS SHALL BE GALVANIZED PER ASTM A153 OR B695.
- 3. ALL U-BOLTS SHALL BE ASTM A36 OR EQUIVALENT, WITH LOCKING DEVICE, UNLESS NOTED OTHERWISE.
- 4. FIELD CUT EDGES, EXCEPT DRILLED HOLES, SHALL BE GROUND SMOOTH.
- 5. ALL FIELD CUT SURFACES, FIELD DRILLED HOLES & GROUND SURFACES WHERE EXISTING PAINT OR GALVANIZATION REMOVAL WAS REQUIRED SHALL BE REPAIRED WITH (2) BRUSHED COATS OF ZRC GALVILITE COLD GALVANIZING COMPOUND PER ASTM A780 AND MANUFACTURERS RECOMMENDATIONS.
- 6. ALL STRUCTURAL STEEL EMBEDDED IN THE CONCRETE SHALL BE APPLIED WITH (2) BRUSHED COATS OF POLYGUARD CA-14 MASTIC OR EQUIVALENT. REFER TO THE MANUFACTURER SPECIFICATIONS FOR SURFACE PREPARATION AND APPLICATION. APPLICATION OF POLYGUARD 400 WRAP IS NOT ESSENTIAL.
- 7. CONTRACTOR SHALL PERFORM WORK ON ONLY ONE (1) TOWER FACE AND REPLACE/REINFORCE ONE (1) BOLT/MEMBER AT A TIME.
- 8. ALL FIELD DRILLED HOLES TO BE USED FOR FIELD BOLTING INSTALLATION SHALL BE STANDARD HOLES, AS DEFINED BY AISC, UNLESS NOTED OTHERWISE.

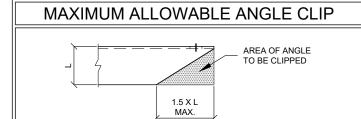

PAINT

1. AS REQUIRED, CLEAN AND PAINT PROPOSED STEEL ACCORDING TO FAA ADVISORY CIRCULAR AC 70/7460-1L.

#### WELDING

- 1. ALL WELDING TO BE PERFORMED BY AWS CERTIFIED WELDERS AND CONDUCTED IN ACCORDANCE WITH THE LATEST EDITION OF THE AWS WELDING CODE D1.1.
- 2. ALL WELDS SHALL BE INSPECTED VISUALLY. IF DIRECTED BY ENGINEER OF RECORD, 25% OF WELDS SHALL BE INSPECTED WITH DYE PENETRANT OR MAGNETIC PARTICLE (100% IF REJECTABLE DEFECTS ARE FOUND) TO MEET THE ACCEPTANCE CRITERIA OF AWS D1.1. REPAIR ALL WELDS AS NECESSARY.
- 3. INSPECTION SHALL BE PERFORMED BY AN AWS CERTIFIED WELD INSPECTOR.
- 4. ALL ELECTRODES TO BE LOW HYDROGEN, MATCHING FILLER AND/OR BASE METAL, PER AWS D1.1, UNLESS NOTED OTHERWISE.
- 5. IN CASES WHERE BASE METAL GRADE IS UNKNOWN, ALL WELDING ON LATTICE TOWERS SHALL BE DONE WITH E70XX ELECTRODES; ALL WELDING ON POLE STRUCTURES SHALL BE DONE WITH E80XX ELECTRODES, UNLESS NOTED OTHERWISE.
- 6. PRIOR TO FIELD WELDING GALVANIZED MATERIAL, CONTRACTOR SHALL GRIND OFF GALVANIZING 1/2" BEYOND ALL FIELD WELD SURFACES. AFTER WELD AND WELD INSPECTION IS COMPLETE, REPAIR ALL GROUND AND WELDED SURFACES WITH ZRC GALVILITE COLD GALVANIZING COMPOUND PER ASTM A780 AND MANUFACTURERS RECOMMENDATIONS.

#### BOLT TIGHTENING PROCEDURE

- 1. STRUCTURAL CONNECTIONS TO BE ASSEMBLED AND INSPECTED IN ACCORDANCE WITH RCSC SPECIFICATIONS.
- 2. FLANGE BOLTS SHALL BE INSTALLED AND TIGHTENED USING DIRECT TENSION INDICATING (DTI) SQUIRTER WASHERS. DTI SQUIRTER WASHERS ARE TO BE INSTALLED AND ORIENTED / TIGHTENED PER MANUFACTURER SPECIFICATIONS TO ACHIEVE DESIRED LEVEL OF BOLT PRE-TENSION.
- 3. IN LIEU OF USING DTI SQUIRTER WASHERS, FLANGE BOLTS MAY BE TIGHTENED USING AISC / RCSC "TURN-OF-THE-NUT" METHOD, PENDING APPROVAL BY THE ENGINEER OF RECORD (EOR). TIGHTEN FLANGE BOLTS USING THE CHART BELOW:

#### BOLT LENGTHS UP TO AND INCLUDING FOUR DIAMETERS

- 1/2" BOLTS UP TO AND INCLUDING 2.0 INCH LENGTH +1/3 TURN BEYOND SNUG TIGHT 5/8" BOLTS UP TO AND INCLUDING 2.5 INCH LENGTH +1/3 TURN BEYOND SNUG TIGHT
- 5/8" BOLTS UP TO AND INCLUDING 2.5 INCH LENGTH +1/3 TURN BEYOND SNUG TIGHT 3/4" BOLTS UP TO AND INCLUDING 3.0 INCH LENGTH +1/3 TURN BEYOND SNUG TIGHT
- 7/8" BOLTS UP TO AND INCLUDING 3.5 INCH LENGTH +1/3 TURN BEYOND SNUG TIGHT
- 1" BOLTS UP TO AND INCLUDING 4.0 INCH LENGTH +1/3 TURN BEYOND SNUG TIGHT
- 1-1/8" BOLTS UP TO AND INCLUDING 4.5 INCH LENGTH +1/3 TURN BEYOND SNUG TIGHT
- 1-1/4" BOLTS UP TO AND INCLUDING 5.0 INCH LENGTH +1/3 TURN BEYOND SNUG TIGHT 1-3/8" BOLTS UP TO AND INCLUDING 5.5 INCH LENGTH +1/3 TURN BEYOND SNUG TIGHT
- 1-3/8 BOLTS UP TO AND INCLUDING 5.5 INCH LENGTH +1/3 TORN BEYOND SNUG TIGHT 1-1/2" BOLTS UP TO AND INCLUDING 6.0 INCH LENGTH +1/3 TURN BEYOND SNUG TIGHT

#### BOLT LENGTHS OVER FOUR DIAMETERS BUT NOT EXCEEDING EIGHT DIAMETERS

1/2"	BOLTS 2.25 TO 4.0 INCH LENGTH	+1/2 TURN BEYOND SNUG TIGHT
5/8'	BOLTS 2.75 TO 5.0 INCH LENGTH	+1/2 TURN BEYOND SNUG TIGHT
3/4'	BOLTS 3.25 TO 6.0 INCH LENGTH	+1/2 TURN BEYOND SNUG TIGHT
7/8'	BOLTS 3.75 TO 7.0 INCH LENGTH	+1/2 TURN BEYOND SNUG TIGHT
1"	BOLTS 4.25 TO 8.0 INCH LENGTH	+1/2 TURN BEYOND SNUG TIGHT
1-1/	8" BOLTS 4.75 TO 9.0 INCH LENGTH	+1/2 TURN BEYOND SNUG TIGHT
1-1/	4" BOLTS 5.25 TO 10.0 INCH LENGTH	+1/2 TURN BEYOND SNUG TIGHT
1-3/	8" BOLTS 5.75 TO 11.0 INCH LENGTH	+1/2 TURN BEYOND SNUG TIGHT
1-1/	2" BOLTS 6.25 TO 12.0 INCH LENGTH	+1/2 TURN BEYOND SNUG TIGHT

#### MODIFICATION INSPECTION NOTES

THE MOUNT MODIFICATION INSPECTION (MMI) PROCEDURE IS INTENDED TO CONFIRM THAT CONSTRUCTION AND INSTALLATION MEETS ENGINEERING DESIGN, ATC PROCEDURES AND ATC STANDARD SPECIFICATIONS FOR WIRELESS TOWER SITES.

TO ENSURE THAT THE REQUIREMENTS OF THE MMI ARE MET, IT IS VITAL THAT THE GENERAL CONTRACTOR SUBMIT ALL REQUIRED PHOTOGRAPHS AND DRAWINGS TO AMERICAN TOWER CORPORATION (ATC).

#### BOLT TIGHTENING PROCEDURE (CONTINUED

 SPLICE BOLTS SUBJECT TO DIRECT TENSION SHALL BE INSTA SECTION 8.2.1 OF THE AISC "SPECIFICATION FOR STRUCTURA BOLTS", LOCATED IN THE AISC MANUAL OF STEEL CONSTRUC PROCEDURE IS PARAPHRASED AS FOLLOWS:

FASTENERS SHALL BE INSTALLED IN PROPERLY ALIGNED OF THE METHODS DESCRIBED IN SUBSECTION 8.2.1 THRO

#### 8.2.1 TURN-OF-NUT PRETENSIONING

BOLTS SHALL BE INSTALLED IN ALL HOLES OF THE CONNECTION AS DEFINED IN SECTION 8.1, UNTIL SIMULTANEOUSLY SNUG TIGHT AND THE CONNECTION IS FOLLOWING THIS INITIAL OPERATION ALL BOLTS IN THE CO TIGHTENED FURTHER BY THE APPLICABLE AMOUNT OF RO DURING THE TIGHTENING OPERATION THERE SHALL BE NO TURNED BY THE WRENCH. TIGHTENING SHALL PROGRESS

#### 5. ALL OTHER BOLTED CONNECTIONS SHALL BE BROUGHT TO A IN SECTION 8.1 OF THE SPECIFICATION.


ALL BOLT HOLES SHALL BE ALIGNED TO PERMIT INSERTION UNDUE DAMAGE TO THE THREADS. BOLTS SHALL BE PLAC WASHERS POSITIONED AS REQUIRED AND NUTS THREADE ASSEMBLY. COMPACTING THE JOINT TO THE SNUG-TIGHT SYSTEMATICALLY FROM THE MOST RIGID PART OF THE JOI CONDITION IS THE TIGHTNESS THAT IS ATTAINED WITH A F WRENCH OR THE FULL EFFORT OF AN IRONWORKER USING TO BRING THE CONNECTED PLIES INTO FIRM CONTACT.

#### GENERAL CONTRACTOR


- THE GENERAL CONTRACTOR IS REQUIRED TO:
- REVIEW THE REQUIREMENTS OF THE MMI CHECKL
- UNDERSTAND ALL INSPECTION REQUIREMENTS.
- THE GENERAL CONTRACTOR SHALL PERFORM AND REACCORDANCE WITH THE REQUIREMENTS OF THE MMI (

	MOUNT MODIFICATION INSPECTION CHECKLIST	
INSPECTION DOCUMENT	DESCRIPTION	INSP
ON-SITE COLD GALVANIZING VERIFICATION	PHOTOGRAPHIC EVIDENCE OF COLD GALVANIZATION TYPE AND APPLICATION IN ALL APPLICABLE LOCATIONS TO BE INCLUDED WITHIN THE MMI REPORT	
GC AS-BUILT DRAWINGS WITH CONSTRUCTION RED-LINES	"AS-BUILT" DRAWINGS INDICATING ANY APPROVED CHANGES TO ENGINEERED PLANS TO MMI FOR APPROVAL/REVIEW AND INCLUSION IN MMI REPORT	
PHOTOGRAPHS	PHOTOGRAPHIC EVIDENCE OF MOUNT MODIFICATION INSPECTION, ON SITE REMEDIATION, AND ITEMS FAILING INSPECTION & REQUIRING FOLLOW UP TO BE INCLUDED WITHIN THE MMI REPORT. COMPLETE PHOTO LOG IS TO BE SUBMITTED WITHIN MMI REPORT.	R
TABLE KEY: MMI - MOUNT MODIFICATION INSPECTION GC - GENERAL CONTRACTOR ATC - AMERICAN TOWER CORPORATION		Ra 3/ M
		200

	325 OR A490 LATION ENED BY ONE SHT TO A JRE	A.T. ENGI 3500	RICAN TOW NEERING SERVIC D REGENCY PARKWA SUITE 100 CARY, NC 27518 10NE: (919) 468-0112 COA: PEC.0001553	E, PLLC
L ALL THE BOLTS ARE FULLY COMPACTED. DNNECTION SHALL BE DTATION SPECIFIED ABOVE. D ROTATION OF THE PART NOT S SYSTEMATICALLY. SNUG TIGHT CONDITION AS DEFINED N OF THE BOLTS WITHOUT ED IN ALL HOLES WITH ED TO COMPLETE THE CONDITION SHALL PROGRESS INT. THE SNUG-TIGHTENED EW IMPACTS OF AN IMPACT G AN ORDINARY SPUD WRENCH		AS INSTRUMENTS OF OF AMERICAN TOWE RESTRICTED TO THE PREPARED ANY USE RELATES TO AMERIC STRICTLY PROHIBITE REMAIN THE PROPEET THE PROJECT IS EXE ENGINEER WILL BE POF THIS PROJECT. C DIMENSIONS AND AD DISCREPANCIES. AN' SUPERSEDED BY THI TOWER. REV. DES A		ED CARRIER IS ENTS SHALL VHETHER OR NOT IITECT NOR THE RUCTION REVIEW Y ALL ANY DRAWING IS
		W. C	ATC SITE NUMBER: 283424 ATC SITE NAME: ATERTOWN C ONNECTICUT SITE ADDRESS: 555 BASSETT ROAD ATERTOWN, CT 06795	
LIST. CORD THE INSPEC CHECKLIST.	TION RESULTS IN	11111 PRO	OF CONNEC KAUSHAL 32593 CENSED	A 11111
PECTION TESTING REQUIRED	RESPONSIBILITY	DRAWN BY: APPROVED BY: DATE DRAWN:	CGM MCC 07/15/20	
✓	GC	ATC JOB NO:	13213496_C9_06	
<	GC	AND MC	GENERAL NOT DUNT MODIFIC	
	GC			
EDLINED CDs amapo Commi				

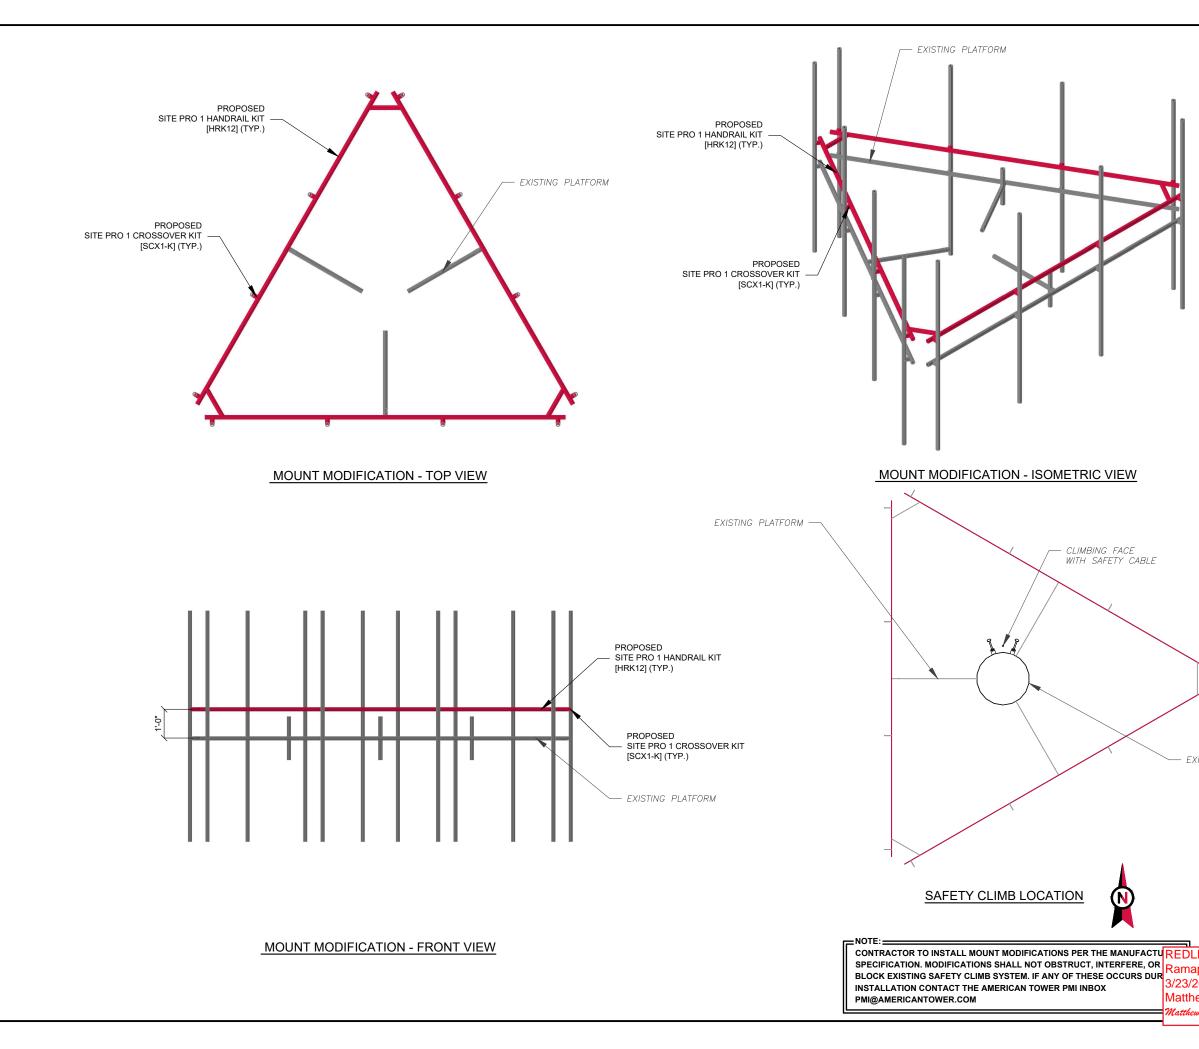

		•	
	A.T. ENGI 350	RICAN TOW NEERING SERVIC 0 REGENCY PARKWA SUITE 100 CARY, NC 27518 HONE: (919) 468-0112 COA: PEC.0001553	E, PLLC
	AS INSTRUMENTS OI OF AMERICAN TOWE RESTRICTED TO THE PREPARED, ANY USE RELATES TO AMERIC STRICTLY PROHIBIT REMAIN THE PROPEET THE PROJECT IS EXI ENGINEER WILL BE F OF THIS PROJECT. C DISCREPANCIES. AND AD DISCREPANCIES.	ND/OR THE ACCOMPANYING R SERVICE ARE THE EXCLUS R. THEIR USE AND PUBLICAT ORIGINAL SITE FOR WHICH OR DISCLOSURE OTHER TH AN TOWER OR THE SPECIFI ED. ITTLE TO THESE DOCUME TY OF AMERICAN TOWER W SCUTED. NEITHER THE ARCH YOVIDING ON SITE CONSTR ONTRACTOR(S) MUST VENIE VISE AMERICAN TOWER OF Y PRIOR ISSUANCE OF THIS E LATEST VERSION ON FILE	IVE PROPERTY TION SHALL BE THEY ARE IAN THAT WHICH ED CARRIER IS SINTS SHALL (HETHER OR NOT ITECT NOR THE UCTION REVIEW Y ALL ANY DRAWING IS
		SCRIPTION E	BY DATE
			GM_07/15/20_
	$\triangle$		
	<u> </u> ∆		
	└┘		
		ATC SITE NUMBER:	
		283424	
		ATC SITE NAME:	
	W	ATERTOWN C	г
		ONNECTICUT	
		SITE ADDRESS:	
		655 BASSETT ROAD	
		ATERTOWN, CT 06795	
XX	= * 5		
ISTING TOWER		32593 CENSED	~
	DRAWN BY:	CGM	
	APPROVED BY:	MCC	
	DATE DRAWN: ATC JOB NO:	07/15/20 13213496_C9_06	
INED CDs		FICATION PRO	FILE
po Communication Corp			1
021		T NUMBER:	REVISION:
ew Schlosser	S-	-101	0
v Schlosser			<b>-</b>

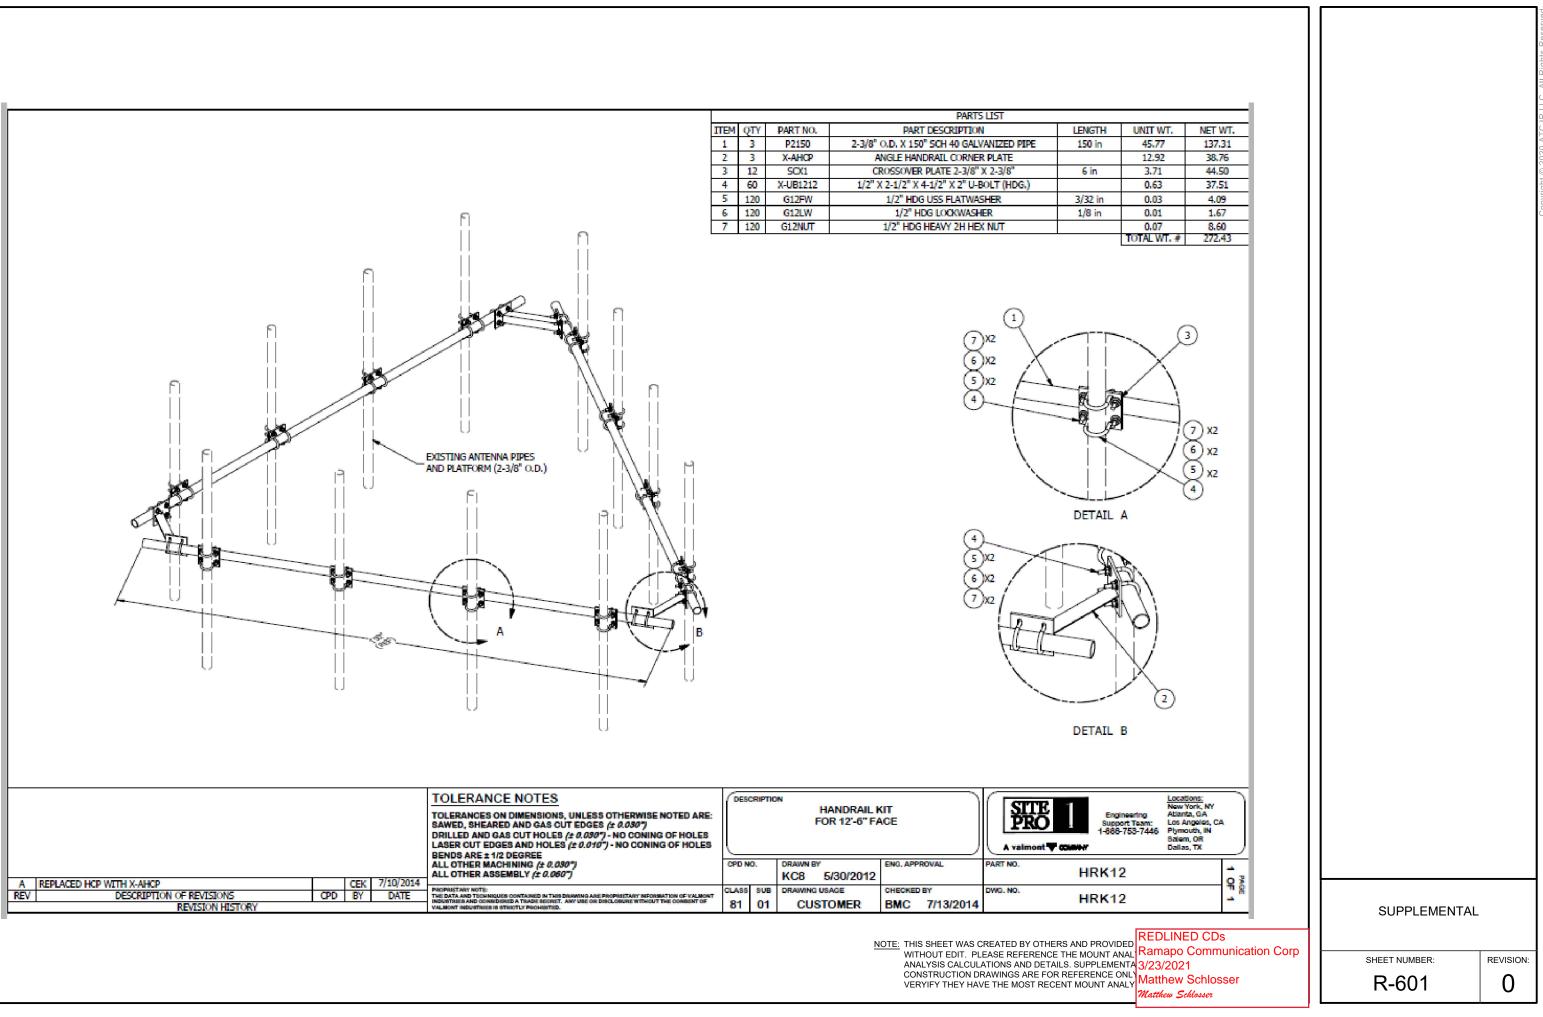

2.38" O.D. ANTENNA PIPE (ORDERED SEPARATELY)		1 1 2 4 3 3 8 4 8 5 8 2 X2 2 X2		PART DESCRIPTIO ROSSOVER PLATE 2-3/8 X 2-1/2" X 4-1/2" X 2" U-E 1/2" HDG USS FLATWA 1/2" HDG LOCKWASI 1/2" HDG HEAVY 2H HE	N LENGT " X 2-3/8" IOLT (HDG.) SHER HER	H UNIT WT. 3.71 0.63 0.03 0.01 0.07 TOTAL WT. #	NET WT. 3.71 2.50 0.27 0.11 0.57 7.16
A ADDED MISSING U-BOLT AND HRDWE KC8 7/5/2012 REV DESCRIPTION OF REVISIONS CPD BY DATE REVISION HISTORY	TOLERANCE NOTES TOLERANCES ON DIMENSIONS, UNLESS OTHERWISE NOTED ARE: SAWED, SHEARED AND GAS CUT EDGES (± 0.030") DRILLED AND GAS CUT HOLES (± 0.030")- NO CONING OF HOLES LASER CUT EDGES AND HOLES (± 0.010")- NO CONING OF HOLES BENDS ARE ± 1/2 DEGREE ALL OTHER MACHINING (± 0.030") ALL OTHER ASSEMBLY (± 0.060") PROPRIETARY NOTIC THE DATA AND TECHNIQUES CONTAINED IN THIS DRAWING ARE PROPRIETARY INFORMATION OF VALIMONT INFORMATION OF VALIMONT OF VALIM		CROSSOVER P DRAWN BY CEK 6/30/2011 DRAWING USAGE CUSTOMER	ENG. APPROVAL	PART NO. DWG. NO.	Engineering Atia Support Team: Los -888-753-7446 Sale Dali 1-K	tilions: http://srk.NY http://srk.

NOTE: THIS SHEET WAS CREATED BY OTHERS AND PROVIDED WITHOUT EDIT. PLEASE REFERENCE THE MOUNT ANAL ANALYSIS CALCULATIONS AND DETAILS. SUPPLEMENTA 3/23/2021 CONSTRUCTION DRAWINGS ARE FOR REFERENCE ONLY VERYIFY THEY HAVE THE MOST RECENT MOUNT ANALY Watthew Schlosser

SHEET NUMBER:	
R-602	

## SUPPLEMENTAL