From: Jason Blinkhorn < jblinkhorn@qualtekwireless.com>

Sent: Wednesday, May 26, 2021 3:37 PM

To: CSC-DL Siting Council <Siting.Council@ct.gov>; towngov@wallingfordct.gov

Cc: Adam Trapani <a trapani@qualtekwireless.com>; Corey Michaud <cmichaud@qualtekwireless.com>;

Michael Cypranowski <mcypranowski@qualtekwireless.com>; Karin Turner

<kturner@qualtekwireless.com>; Siyuan Liu <sliu@qualtekwireless.com>; ATT Closeouts

<attcloseouts@empiretelecomm.com>; New England Compliance

<newenglandcompliance@empiretelecomm.com>

Subject: CSC SITE EM-AT&T-148-210405 ATT SITE CT5111

CSC team,

Please see attached. We will be looking to start 6-10-2021. Please let us know if anything else is needed.

COP team,

Please note CSC will require additional COP documents.

Thank You,

Jason Blinkhorn / Project Manager / 401-787-6007 / jblinkhorn@qualtekwireless.com 16 Esquire Rd, N Billerica MA 01862 125 Depot St, Bellingham, MA 02019



Disclaimer: This email is intended only for the use of the individual or entity to which it is addressed, and may contain information that is privileged, confidential and exempt from disclosure under applicable law. If you received this communication in error, please do not distribute it and notify us immediately by email (administrator@qualtekservices.com) or via telephone (484.804.4500) and delete the original message. Unless expressly stated in this email, nothing in this message or any attachment should be construed as a digital or electronic signature.

PERMIT NUMBER: 42896 Permit Date: ### 7, 2021 FAX (203) 294-2095
BUILDING ELECTRICAL MECHANICAL PLUMBING (please circle one)
(p. 200 on the one)
PROPERTY ADDRESS: 316 WOODHOUSE PHENVE.
OWNER'S NAME / PHONE: CONNECTT CLUT STREET ROD ALSOC, 860-209-4690
PROPERTY OWNER ADDRESS: P.O. Box 1517 WALLING GT. 06492
CONTRACTOR NAME/BUSINESS NAME: ROWN CASTLE USA TAIC.
CONTRACTOR ADDRESS: 200 CORPORATE DRIVE, CANONSBURG, PA 15317
CONTRACTOR PHONE #203-435-3640 LICENSE NUMBER: MOD 0903225
DESCRIPTION FOR PERMITTED ACTIVITY: ANTENNA UPGRADE REMINE
(6) TMA +12 Diplexers Replace (3) ANTENNA, INSTALL
hander L Kit Anots) This on Toute Tustally CRY and Diplomes O.
NEW H FRANCE CONSTRUCTION TYPE: COMMERCE LA CUSE GROUP:
CONSTRUCTION COST: \$ 30,000
APPLICANT NAME: DENISE SABO
APPLICANT SIGNATURE: ON App
office use only
BUILDING OFFICIAL SIGNATURE: Solar Clandle 430.00
PERMIT FEE: \$ CO/COA FEE: \$ LATE FEE: \$
TOTAL FEE PAID: \$ 430.00 CASH CHECK NO. 21192

yellow: Assessor

WLFD Bidg permit form 4-2020

white: Building

pink: Applicant



STATE OF CONNECTICUT CONNECTICUT SITING COUNCIL

Ten Franklin Square, New Britain, CT 06051 Phone: (860) 827-2935 Fax: (860) 827-2950 E-Mail: siting.council@ct.gov Web Site: portal.ct.gov/csc

VIA ELECTRONIC MAIL

April 26, 2021

Denise Sabo Northeast Site Solutions 54 Main Street, Unit 3 Sturbridge, MA 01566

RE: **EM-AT&T-148-210405** - AT&T notice of intent to modify an existing telecommunications facility located at 316 Woodhouse Avenue, Wallingford, Connecticut.

Dear Ms. Sabo:

The Connecticut Siting Council (Council) hereby acknowledges your notice to modify this existing telecommunications facility, pursuant to Section 16-50j-73 of the Regulations of Connecticut State Agencies with the following conditions:

- 1. Prior to AT&T's antenna installation, the antenna mount modifications shall be installed in accordance with the Mount Analysis prepared by Tower Engineering Professionals, dated February 24, 2021 and stamped and signed by Aaron Thomas Rucker;
- 2. Within 45 days following completion of equipment installation, AT&T shall provide documentation certified by a Professional Engineer that its installation complied with the recommendations of the Mount Analysis;
- 3. Any deviation from the proposed modification as specified in this notice and supporting materials with the Council shall render this acknowledgement invalid;
- 4. Any material changes to this modification as proposed shall require the filing of a new notice with the Council:
- 5. The Council shall be notified in writing at least two weeks prior to the commencement of site construction activities;
- 6. Within 45 days after completion of construction, the Council shall be notified in writing that construction has been completed;
- 7. Any nonfunctioning antenna and associated antenna mounting equipment on this facility owned and operated by AT&T shall be removed within 60 days of the date the antenna ceased to function:
- 8. The validity of this action shall expire one year from the date of this letter; and
- 9. The applicant may file a request for an extension of time beyond the one year deadline provided that such request is submitted to the Council not less than 60 days prior to the expiration.

The proposed modifications including the placement of all necessary equipment and shelters within the tower compound are to be implemented as specified here and in your notice dated April 1, 2021. The modifications are in compliance with the exception criteria in Section 16-50j-72 (b) of the Regulations of Connecticut State Agencies as changes to an existing facility site that would not increase tower height, extend the boundaries of the tower site by any dimension, increase noise levels at the tower site boundary by six decibels or more, and increase the total radio frequencies electromagnetic radiation power density measured at the tower site boundary to or above the standards adopted by the Federal Communications Commission pursuant to Section 704 of the Telecommunications Act of 1996 and by the state Department of Energy and Environmental Protection pursuant to Connecticut General Statutes § 22a-162. This facility has also been carefully modeled to ensure that radio frequency emissions are conservatively below state and federal standards applicable to the frequencies now used on this tower.

This decision is under the exclusive jurisdiction of the Council. Please be advised that the validity of this action shall expire one year from the date of this letter. Any additional change to this facility will require explicit notice to this agency pursuant to Regulations of Connecticut State Agencies Section 16-50j-73. Such notice shall include all relevant information regarding the proposed change with cumulative worst-case modeling of radio frequency exposure at the closest point of uncontrolled access to the tower base, consistent with Federal Communications Commission, Office of Engineering and Technology, Bulletin 65. Thank you for your attention and cooperation.

Sincerely,

s/Melanie A. Bachman

Melanie A. Bachman Executive Director

MAB/IN/emr

c: The Honorable William W. Dickinson, Jr., Mayor, Town of Wallingford (towngov@wallingfordct.gov)



APPROVED

By Benjamin Chamberlain at 12:30 pm, May 26, 2021

SITE PHOTO



CROWN 3 CORPORATE PARK DRIVE, SUITE 101 CLIFTON PARK, NY 12065

AT&T SITE NUMBER: **CT5111**

BU #: **828915** WALLINGFORD/ I-91/ X14/ S

316 WOODHOUSE AVENUE WALLINGFORD, CT 06492

EXISTING 148'-0" MONOPOLE

	ISSUED FOR:								
EV	DATE	DRWN	DESCRIPTION	DES./QA					
A	05/11/20	MLC	PRELIMINARY	RO					
В	06/04/20	RO	PRELIMINARY						
С	2/22/21	JTS	PRELIMINARY	RMC					
0	3/31/21	JTS	CONSTRUCTION	MTJ					
1	5/13/21	GEH	CONSTRUCTION	GEH					



B&T ENGINEERING, INC. PEC.0001564 Expires 2/10/22

IT IS A VIOLATION OF LAW FOR ANY PERSON UNLESS THEY ARE ACTING UNDER THE DIRECTION OF A LICENSED PROFESSIONAL ENGINEER. TO ALTER THIS DOCUMENT

SHEET NUMBER:

REVISION:

AT&T SITE NUMBER: CT5111

AT&T SITE NAME: WALLINGFORD-POND HILL

AT&T FA CODE: 10071340

AT&T PACE NUMBER: MRCTB046821 AT&T PROJECT: AT&T LTE 5C **BUSINESS UNIT #:** 828915

316 WOODHOUSE AVENUE **SITE ADDRESS:** WALLINGFORD, CT 06492 **COUNTY: NEW HAVEN**

MONOPOLE SITE TYPE:

148'-0" **TOWER HEIGHT:**

LOCATION MAP

NO SCALE

SITE INFORMATION

CROWN CASTLE USA INC.

SITE NAME: WALLINGFORD/ I-91/ X14/ S SITE ADDRESS: 316 WOODHOUSE AVENUE WALLINGFORD, CT 06492

COUNTY: NEW HAVEN

MAP/PARCEL #: WALL-000190-000000-000028

AREA OF CONSTRUCTION: EXISTING LATITUDE: 41° 26' 02.76' LONGITUDE: -72° 48' 05.26" NAD83 LAT/LONG TYPE: GROUND ELEVATION: 220 FT. CURRENT ZONING: CA-40

TOWN OF WALLINGFORD IURISDICTION:

OCCUPANCY CLASSIFICATION: U TYPE OF CONSTRUCTION:

A&E FIRM:

CONTACTS:

CROWN CASTLE

USA INC. DISTRICT

FACILITY IS UNMANNED AND NOT FOR A.D.A. COMPLIANCE:

HUMAN HABITATION PROPERTY OWNER: CONNECTICUT STREET ROD ASSOCIATION

PO BOX 1517

WALLINGFORD, CT 06492

TOWER OWNER: CCTMO LLC

2000 CORPORATE DRIVE CANONSBURG, PA 15317

AT&T TOWER ASSET GROUP

CARRIER/APPLICANT: 575 MOROSGO DRIVE

ATLANTA, GA 30324-3300

CROWNAE.APPROVAL@CROWNCASTLE.COM

3 CORPORATE PARK DRIVE, SUITE 101

VERONICA DELIA - PROJECT MANAGER

ELECTRIC PROVIDER: WALLINGFORD ELECTRIC

(203) 294-2020 TELCO PROVIDER:

AT&T (866) 620-6900

PROJECT TEAM

CROWN CASTLE USA INC.

2000 CORPORATE DRIVE

CANONSBURG PA 15317

CLIFTON PARK, NY 12065

FINAL EQUIPMENT SCHEDULE C-3 EQUIPMENT SPECS C-4 EQUIPMENT SPECS C-4.1 GROUNDING SCHEMATIC GROUNDING DETAILS ATTACHED PLUMBING DIAGRAM

DRAWING INDEX

EXISTING & FINAL EQUIPMENT PLANS

FINAL ELEVATION & ANTENNA PLANS

SHEET DESCRIPTION

ALL DRAWINGS CONTAINED HEREIN ARE FORMATTED FOR 1X17. CONTRACTOR SHALL VERIFY ALL PLANS AND EXISTING DIMENSIONS AND CONDITIONS ON THE JOB SITE AND SHALI IMMEDIATELY NOTIFY THE ENGINEER IN WRITING OF ANY DISCREPANCIES BEFORE PROCEEDING WITH THE WORK OR BE RESPONSIBLE FOR SAME



SHEET#

T-1

T-2

C-1.1

C-1.2

C-2

TITLE SHEET

SITE PLAN

GENERAL NOTES

CALL CONNECTICUT ONE CALL



PROJECT DESCRIPTION

THE PURPOSE OF THIS PROJECT IS TO ENHANCE BROADBAND CONNECTIVITY AND CAPACITY TO THE EXISTING ELIGIBLE WIRELESS FACILITY.

TOWER SCOPE OF WORK:

- REMOVE (3) POWERWAVE 7770 ANTENNAS
- REMOVE (12) KATHREIN 860 10025 DIPLEXERS • RELOCATE (3) KATHREIN - 782-10254 SMART BIAS TEEs
- INSTALL MOUNT MODIFICATIONS PER MOUNT MODIFICATION ANALYSIS BY TOWER
- ENGINEERING PROFESSIONALS DATED 5/6/21 • INSTALL (3) CCI - HPA-65R-BU6AA ANTENNAS • INSTALL (3) CCI - TMABPD7823VG12A TMAs

GROUND SCOPE OF WORK:

- REMOVE (1) 3206
- INSTALL (1) 6630 + IDLe CABLE
- INSTALL (1) DC12
- INSTALL (1) FLEX16 DOOR UPGRADE KIT
- INSTALL (3) ERICSSON 4449 B5/B12 RRHS • INSTALL (3) ERICSSON - 4426 B66 RRHS
- INSTALL (6) KAELUS DBC0115F1V91-2 DIPLEXERS
- INSTALL (1) H-FRAME

INSTALLER NOTE:

NO PROPOSED LOADING TO BE ADDED UNTIL MOUNT MODIFICATIONS ARE INSTALLED PER MOUNT MODIFICATION ANALYSIS BY TOWER ENGINEERING PROFESSIONALS DATED MAY 26, 2020

APPLICABLE CODES/REFERENCE DOCUMENTS

THE CURRENT EDITIONS OF THE FOLLOWING CODES AS ADOPTED BY THE LOCAL GOVERNING AUTHORITIES. NOTHING IN THESE PLANS IS TO BE CONSTRUED TO PERMIT WORK NOT CONFORMING TO THESE CODES:

2018 CT STATE BUILDING CODE/2015 IMC W/ CT AMENDMENTS MECHANICAL 2018 CT STATE BUILDING CODE/2017 NEC W/ CT AMENDMENTS ELECTRICAL.

STRUCTURAL ANALYSIS: CROWN CASTLE

DATED: 8/20/20

MOUNT MODIFICATION ANALYSIS: TOWER ENGINEERING PROFESSIONALS DATED: 5/6/21

DATED: 2/11/21

CROWN NOC AT (800) 788-7011 & CROWN CONSTRUCTION MANAGER.

ALL WORK SHALL BE PERFORMED AND MATERIALS INSTALLED IN ACCORDANCE WITH

CODE TYPE BUILDING

2018 CT STATE BUILDING CODE/2015 IBC W/ CT AMENDMENTS

REFERENCE DOCUMENTS:

RFDS REVISION: 2

ORDER ID: 517093 REVISION: 1

PRIOR TO ACCESSING/ENTERING THE SITE YOU MUST CONTACT THE

JASON D'AMICO - CONSTRUCTION MANAGER

CROWN CASTLE USA INC. SITE ACTIVITY REQUIREMENTS:

- NOTICE TO PROCEED- NO WORK SHALL COMMENCE PRIOR TO CROWN CASTLE USA INC. WRITTEN NOTICE TO PROCEED (NTP) AND THE ISSUANCE OF A PURCHASE ORDER. PRIOR TO ACCESSING/ENTERING THE SITE YOU MUST CONTACT THE CROWN CASTLE USA INC. NOC AT 800-788-7011 & THE CROWN CASTLE USA INC. CONSTRUCTION MANAGER.
- "LOOK UP" CROWN CASTLE USA INC. SAFETY CLIMB REQUIREMENT: THE INTEGRITY OF THE SAFETY CLIMB AND ALL COMPONENTS OF THE CLIMBING FACILITY SHALL BE CONSIDERED DURING ALL STAGES OF DESIGN, INSTALLATION, AND INSPECTION. TOWER MODIFICATION, MOUNT REINFORCEMENTS, AND/OR EQUIPMENT INSTALLATIONS SHALL NOT COMPROMISE THE INTEGRITY OR REINFUNCEMENTS, AND/OR EQUIPMENT INSTALLATIONS SHALL NOT COMPROMISE THE INTEGRIT OR "FUNCTIONAL USE OF THE SAFETY CLIMB OR ANY COMPONENTS OF THE CLIMBING FACILITY ON THE STRUCTURE. THIS SHALL INCLUDE, BUT NOT BE LIMITED TO: PINCHING OF THE WIRE ROPE, BENDING OF THE WIRE ROPE FROM ITS SUPPORTS, DIRECT CONTACT OR CLOSE PROXIMITY TO THE WIRE ROPE WHICH MAY CAUSE FRICTIONAL WEAR, IMPACT TO THE ANCHORAGE POINTS IN ANY WAY, OR TO IMPEDE/BLOCK ITS INTENDED USE. ANY COMPROMISED SAFETY CLIMB, INCLUDING EXISTING CONDITIONS MUST BE TAGGED OUT AND REPORTED TO YOUR CROWN CASTLE USA INC. POC OR CALL THE NOC TO GENERATE A SAFETY CLIM MAINTENANCE AND CONTRACTOR NOTICE TICKET.
- PRIOR TO THE START OF CONSTRUCTION, ALL REQUIRED JURISDICTIONAL PERMITS SHALL BE OBTAINED. THIS INCLUDES, BUT IS NOT LIMITED TO, BUILDING, ELECTRICAL, MECHANICAL, FIRE, FLOOD ZONE, ENVIRONMENTAL, AND ZONING. AFTER ONSITE ACTIVITIES AND CONSTRUCTION ARE COMPLETED, ALL REQUIRED PERMITS SHALL BE SATISFIED AND CLOSED OUT ACCORDING TO LOCAL JURISDICTIONAL REQUIREMENTS
- ALL CONSTRUCTION MEANS AND METHODS; INCLUDING BUT NOT LIMITED TO, ERECTION PLANS, RIGGING PLANS, CLIMBING PLANS, AND RESCUE PLANS SHALL BE THE RESPONSIBILITY OF THE GENERAL CONTRACTOR RESPONSIBLE FOR THE EXECUTION OF THE WORK CONTAINED HEREIN, AND SHALL MEET ANSI/ASSE A10.48 (LATEST EDITION); FEDERAL, STATE, AND LOCAL REGULATIONS; AND ANY APPLICABLE INDUSTRY CONSENSUS STANDARDS RELATED TO THE CONSTRUCTION ACTIVITIES BEING PERFORMED. ALL RIGGING PLANS SHALL ADHERE TO ANSI/ASSE A10.48 (LATEST EDITION) AND CROWN CASTLE USA INC. STANDARD CED—STD—10253, INCLUDING THE REQUIRED INVOLVEMENT OF A QUALIFIED ENGINEER FOR CLASS IV CONSTRUCTION. TO CERTIFY THE SUPPORTING STRUCTURE(S) IN ACCORDANCE WITH ANSI/TIA-322
- ALL SITE WORK TO COMPLY WITH DAS-STD-10068 "INSTALLATION STANDARDS FOR CONSTRUCTION ACTIVITIES ON CROWN CASTLE USA INC. TOWER SITE," CED-STD-10294 "STANDARD FOR INSTALLATION OF MOUNTS AND APPURTENANCES," AND LATEST VERSION OF ANSI/TIA-1019-A-2012 "STANDARD FOR
- INSTALLATION, ALTERATION, AND MAINTENANCE OF ANTENNAS SUPPORTING STRUCTURES AND ANTENNAS."

 IF THE SPECIFIED EQUIPMENT CAN NOT BE INSTALLED AS SHOWN ON THESE DRAWINGS, THE CONTRACTOR SHALL PROPOSE AN ALTERNATIVE INSTALLATION FOR APPROVAL BY CROWN CASTLE USA INC. PRIOR TO PROCEEDING WITH ANY SUCH CHANGE OF INSTALLATION.
- PROCEEDING WITH ANY SUCH CHANGE OF INSTALLATION.
 ALL MATERIALS FURNISHED AND INSTALLED SHALL BE IN STRICT ACCORDANCE WITH ALL APPLICABLE
 CODES, REGULATIONS AND ORDINANCES. CONTRACTOR SHALL ISSUE ALL APPROPRIATE NOTICES AND
 COMPLY WITH ALL LAWS, ORDINANCES, RULES, REGULATIONS AND LAWFUL ORDERS OF ANY PUBLIC
 AUTHORITY REGARDING THE PERFORMANCE OF THE WORK. ALL WORK CARRIED OUT SHALL COMPLY WIT
 ALL APPLICABLE MUNICIPAL AND UTILITY COMPANY SPECIFICATIONS AND LOCAL JURISDICTIONAL CODES, ORDINANCES AND APPLICABLE REGULATIONS
- THE CONTRACTOR SHALL INSTALL ALL EQUIPMENT AND MATERIALS IN ACCORDANCE WITH MANUFACTURER'S RECOMMENDATIONS UNLESS SPECIFICALLY STATED OTHERWISE.
- RECOMMENDATIONS OURLESS SPECIFICALLY STATED OTHERWISE.

 9. THE CONTRACTOR SHALL CONTACT UTILITY LOCATING SERVICES PRIOR TO THE START OF CONSTRUCTION.

 10. ALL EXISTING ACTIVE SEWER, WATER, GAS, ELECTRIC AND OTHER UTILITIES WHERE ENCOUNTERED IN THE WORK, SHALL BE PROTECTED AT ALL TIMES AND WHERE REQUIRED FOR THE PROPER EXECUTION OF THE WORK, SHALL BE RELOCATED AS DIRECTED BY CONTRACTOR. EXTREME CAUTION SHOULD BE USED BY THE CONTRACTOR WHEN EXCAVATING OR DRILLING PIERS AROUND OR NEAR UTILITIES. CONTRACTOR SHALL PROVIDE SAFETY TRAINING FOR THE WORKING CREW. THIS WILL INCLUDE BUT NOT BE LIMITED TO A) FALL PROTECTION BY CONSIDER SAFE OF THE WORKING CREW. THIS WILL INCLUDE BUT NOT BE LIMITED TO A) FALL PROTECTION B) CONFINED SPACE C) ELECTRICAL SAFETY D) TRENCHING AND EXCAVATION E) CONSTRUCTION SAFFTY PROCEDURES
- CONSTRUCTION SAFETY PROCEDURES.
 ALL SITE WORK SHALL BE AS INDICATED ON THE STAMPED CONSTRUCTION DRAWINGS AND PROJECT
 SPECIFICATIONS, LATEST APPROVED REVISION.
 CONTRACTOR SHALL KEEP THE SITE FREE FROM ACCUMULATING WASTE MATERIAL, DEBRIS, AND TRASH AT
 THE COMPLETION OF THE WORK. IF NECESSARY, RUBBISH, STUMPS, DEBRIS, STICKS, STONES AND OTHER
 REFUSE SHALL BE REMOVED FROM THE SITE AND DISPOSED OF LEGALLY.
 ALL EXISTING INACTIVE SEWER, WATER, GAS, ELECTRIC AND OTHER UTILITIES, WHICH INTERFERE WITH THE
- EXECUTION OF THE WORK, SHALL BE REMOVED AND/OR CAPPED, PLUGGED OR OTHERWISE DISCONTINUED AT POINTS WHICH WILL NOT INTERFERE WITH THE EXECUTION OF THE WORK, SUBJECT TO THE APPROVAL OF CONTRACTOR, TOWER OWNER, CROWN CASTLE USA INC., AND/OR LOCAL UTILITIES.
- THE CONTRACTOR SHALL PROVIDE SITE SIGNAGE IN ACCORDANCE WITH THE TECHNICAL SPECIFICATION FOR SITE SIGNAGE REQUIRED BY LOCAL JURISDICTION AND SIGNAGE REQUIRED ON INDIVIDUAL PIECES OF EQUIPMENT, ROOMS, AND SHELTERS.
- THE SITE SHALL BE GRADED TO CAUSE SURFACE WATER TO FLOW AWAY FROM THE CARRIER'S EQUIPMENT
- THE SUB GRADE SHALL BE COMPACTED AND BROUGHT TO A SMOOTH UNIFORM GRADE PRIOR TO FINISHED SURFACE APPLICATION.
- THE AREAS OF THE OWNERS PROPERTY DISTURBED BY THE WORK AND NOT COVERED BY THE TOWER, EQUIPMENT OR DRIVEWAY, SHALL BE GRADED TO A UNIFORM SLOPE, AND STABILIZED TO PREVENT EROSION AS SPECIFIED ON THE CONSTRUCTION DRAWINGS AND/OR PROJECT SPECIFICATIONS.
- CONTRACTOR SHALL MINIMIZE DISTURBANCE TO EXISTING SITE DURING CONSTRUCTION, EROSION CONTRO SURES, IF REQUIRED DURING CONSTRUCTION, SHALL BE IN CONFORMANCE WITH THE LOCAL GUIDELINES. EROSION AND SEDIMENT CONTROL.
- 19. THE CONTRACTOR SHALL PROTECT EXISTING IMPROVEMENTS, PAVEMENTS, CURBS, LANDSCAPING AND STRUCTURES. ANY DAMAGED PART SHALL BE REPAIRED AT CONTRACTOR'S EXPENSE TO THE SATISFACTION
- 20. CONTRACTOR SHALL LEGALLY AND PROPERLY DISPOSE OF ALL SCRAP MATERIALS SUCH AS COAXIAL CABLES AND OTHER ITEMS REMOVED FROM THE EXISTING FACILITY. ANTENNAS REMOVED SHALL BE RETURNED TO THE OWNER'S DESIGNATED LOCATION.
- CONTRACTOR SHALL LEAVE PREMISES IN CLEAN CONDITION. TRASH AND DEBRIS SHOULD BE REMOVED FROM SITE ON A DAILY BASIS.
- 22. NO FILL OR EMBANKMENT MATERIAL SHALL BE PLACED ON FROZEN GROUND. FROZEN MATERIALS, SNOW OR ICE SHALL NOT BE PLACED IN ANY FILL OR EMBANKMENT.

GENERAL NOTES:

- FOR THE PURPOSE OF CONSTRUCTION DRAWING, THE FOLLOWING DEFINITIONS SHALL APPLY: CONTRACTOR: GENERAL CONTRACTOR RESPONSIBLE FOR CONSTRUCTION CARRIER: AT&T TOWER OWNER: CROWN CASTLE USA INC.
- TOWER OWNER: CROWN CASTLE USA INC.
 THESE DRAWINGS HAVE BEEN PREPARED USING STANDARDS OF PROFESSIONAL CARE AND COMPLETENESS NORMALLY
 EXERCISED UNDER SIMILAR CIRCUMSTANCES BY REPUTABLE ENGINEERS IN THIS OR SIMILAR LOCALITIES. IT IS
 ASSUMED THAT THE WORK DEPICTED WILL BE PERFORMED BY AN EXPERIENCED CONTRACTOR AND/OR WORKPEOPLE
 WHO HAVE A WORKING KNOWLEDGE OF THE APPLICABLE CODE STANDARDS AND REQUIREMENTS AND OF INDUSTRY
 ACCEPTED STANDARD GOOD PRACTICE. AS NOT EVERY CONDITION OR ELEMENT IS (OR CAN BE) EXPLICITLY SHOWN ON THESE DRAWINGS, THE CONTRACTOR SHALL USE INDUSTRY ACCEPTED STANDARD GOOD PRACTICE FOR MISCELLANEOUS WORK NOT EXPLICITLY SHOWN
- MISCELLANEOUS WORK NOT EXPLICITLY SHOWN.
 THESE DRAWINGS REPRESENT THE FINISHED STRUCTURE. THEY DO NOT INDICATE THE MEANS OR METHODS OF
 CONSTRUCTION. THE CONTRACTOR SHALL BE SOLELY RESPONSIBLE FOR THE CONSTRUCTION MEANS, METHODS,
 TECHNIQUES, SEQUENCES, AND PROCEDURES. THE CONTRACTOR SHALL PROVIDE ALL MEASURES NECESSARY FOR
 PROTECTION OF LIFE AND PROPERTY DURING CONSTRUCTION. SUCH MEASURES SHALL INCLUDE, BUT NOT BE LIMITED
 TO, BRACING, FORMWORK, SHORING, ETC. SITE VISITS BY THE ENGINEER OR HIS REPRESENTATIVE WILL NOT INCLUDE
 INSPECTION OF THESE ITEMS AND IS FOR STRUCTURAL OBSERVATION OF THE FINISHED STRUCTURE ONLY.
- INSPECTION OF THESE ITEMS AND IS FOR STRUCTURAL OBSERVATION OF THE FINISHED STRUCTURE ONLY.
 NOTES AND DETAILS IN THE CONSTRUCTION DRAWINGS SHALL TAKE PRECEDENCE OVER GENERAL NOTES AND TYPICAL
 DETAILS. WHERE NO DETAILS ARE SHOWN, CONSTRUCTION SHALL CONFORM TO SIMILAR WORK ON THE PROJECT,
 AND/OR AS PROVIDED FOR IN THE CONTRACT DOCUMENTS. WHERE DISCREPANCES OCCUR BETWEEN PLANS, DETAILS,
 GENERAL NOTES, AND SPECIFICATIONS, THE GREATER, MORE STRICT REQUIREMENTS, SHALL GOVERN. IF FURTHER
 CLARIFICATION IS REQUIRED CONTACT THE ENGINEER OF RECORD.
 SUBSTANTIAL EFFORT HAS BEEN MADE TO PROVIDE ACCURATE DIMENSIONS AND MEASUREMENTS ON THE DRAWINGS TO
- ASSIST IN THE FABRICATION AND/OR PLACEMENT OF CONSTRUCTION ELEMENTS BUT IT IS THE SOLE RESPONSIBILITY OF THE CONTRACTOR TO FIELD VERIFY THE DIMENSIONS, MEASUREMENTS, AND/OR CLEARANCES SHOWN IN THE CONSTRUCTION DRAWINGS PRIOR TO FABRICATION OR CUTTING OF ANY NEW OR EXISTING CONSTRUCTION ELEMENTS.
- CONSTRUCTION DRAWINGS PRIOR TO FABRICATION OR CUTTING OF ANY NEW OR EXISTING CONSTRUCTION ELEMENTS. IF IT IS DETERMINED THAT THERE ARE DISCREPANCIES AND/OR CONFLICTS WITH THE CONSTRUCTION DRAWINGS THE ENGINEER OF RECORD IS TO BE NOTIFIED AS SOON AS POSSIBLE.

 PRIOR TO THE SUBMISSION OF BIDS, THE BIDDING CONTRACTOR SHALL VISIT THE CELL SITE TO FAMILIARIZE WITH THE EXISTING CONDITIONS AND TO CONFIRM THAT THE WORK CAN BE ACCOMPLISHED AS SHOWN ON THE CONSTRUCTION DRAWINGS. ANY DISCREPANCY FOUND SHALL BE BROUGHT TO THE ATTENTION OF CROWN CASTLE.

 ALL MATERIALS FURNISHED AND INSTALLED SHALL BE IN STRICT ACCORDANCE WITH ALL APPLICABLE CODES, REGULATIONS AND ORDINANCES. CONTRACTOR SHALL ISSUE ALL APPROPRIATE NOTICES AND COMPLY WITH ALL LAWS, ORDINANCES, RULES, REGULATIONS AND LAWFUL ORDERS OF ANY PUBLIC AUTHORITY REGARDING THE PERFORMANCE OF THE WORK. ALL WORK CARRIED OUT SHALL COMPLY WITH ALL APPLICABLE MUNICIPAL AND UTILITY COMPANY SPECIFICATIONS AND LOCAL JURISDICTIONAL CODES, ORDINANCES AND APPLICABLE REGULATIONS.

 UNLESS NOTED OTHERWISE, THE WORK SHALL INCLUDE FURNISHING MATERIALS, EQUIPMENT, APPURTENANCES AND LABOR NECESSARY TO COMPLETE ALL INSTALLATIONS AS INDICATED ON THE DRAWINGS.

 THE CONTRACTOR SHALL INSTALLAL ALL EQUIPMENT AND MATERIALS, EQUIPMENT, MADUFACTURER'S

- THE CONTRACTOR SHALL INSTALLAL EQUIPMENT AND MATERIALS IN ACCORDANCE WITH MANUFACTURER'S RECOMMENDATIONS UNLESS SPECIFICALLY STATED OTHERWISE. IF THE SPECIFIED EQUIPMENT CAN NOT BE INSTALLED AS SHOWN ON THESE DRAWINGS, THE CONTRACTOR SHALL PROPOSE AN ALTERNATIVE INSTALLATION FOR APPROVAL BY THE CARRIER AND CROWN CASTLE PRIOR TO PROCEEDING WITH ANY SUCH CHANGE OF INSTALLATION.

 CONTRACTOR IS TO PERFORM A SITE INVESTIGATION AND IS TO DETERMINE THE BEST ROUTING OF ALL CONDUITS FOR POWER, AND TELCO AND FOR GROUNDING CABLES AS SHOWN IN THE POWER, TELCO, AND GROUNDING PLAN
- THE CONTRACTOR SHALL PROTECT EXISTING IMPROVEM<mark>ENTS, PAVEMENTS, CURBS, LAND</mark>SCAPING AND STRUCTURES, ANY
- DAMAGED PART SHALL BE REPAIRED AT CONTRACTOR'S EXPENSE TO THE SATISFACTION OF GROWN CASTLE USA INC.
 CONTRACTOR SHALL LEGALLY AND PROPERLY DISPOSE OF ALL SCRAP MATERIALS SUCH AS COAXIAL CABLES AND
 OTHER ITEMS REMOVED FROM THE EXISTING FACILITY. ANTENNAS REMOVED SHALL BE RETURNED TO THE OWNER'S DESIGNATED LOCATION
- CONTRACTOR SHALL LEAVE PREMISES IN CLEAN CONDITION. TRASH AND DEBRIS SHOULD BE REMOVED FROM SITE ON

CONCRETE, FOUNDATIONS, AND REINFORCING STEEL:

- ALL CONCRETE WORK SHALL BE IN ACCORDANCE WITH THE ACI 301, ACI 318, ACI 336, ASTM A184, ASTM A185 AND THE DESIGN AND CONSTRUCTION SPECIFICATION FOR CAST—IN—PLACE CONCRETE.
 UNLESS NOTED OTHERWISE, SOIL BEARING PRESSURE USED FOR DESIGN OF SLABS AND FOUNDATIONS IS ASSUMED TO BF 1000 psf.
- ALL CONCRETE SHALL HAVE A MINIMUM COMPRESSIVE STRENGTH (f'c) OF 3000 psi AT 28 DAYS, UNLESS NOTED OTHERWISE. NO MORE THAN 90 MINUTES SHALL ELAPSE FROM BATCH TIME TO TIME OF PLACEMENT UNLESS APPROVED BY THE ENGINEER OF RECORD. TEMPERATURE OF CONCRETE SHALL NOT EXCEED 90'F AT TIME OF
- CONCRETE EXPOSED TO FREEZE-THAW CYCLES SHALL CONTAIN AIR ENTRAINING ADMIXTURES. AMOUNT OF AIR ENTRAINMENT TO BE BASED ON SIZE OF AGGREGATE AND F3 CLASS EXPOSURE (VERY SEVERE). CEMENT USED TO BE TYPE II PORTLAND CEMENT WITH A MAXIMUM WATER-TO-CEMENT RATIO (W/C) OF 0.45.
- ALL STEEL REINFORCING SHALL CONFORM TO ASTM A615. ALL WELDED WIRE FABRIC (WWF) SHALL CONFORM TO ASTM A185. ALL SPLICES SHALL BE CLASS "B" TENSION SPLICES, UNLESS NOTED OTHERWISE. ALL HOOKS SHALL BE STANDARD 90 DEGREE HOOKS, UNLESS NOTED OTHERWISE. YIELD STRENGTH (Fy) OF STANDARD DEFORMED BARS ARE AS FOLLOWS. AS FOLLOWS: #4 RARS AND SMALLER
- ON DRAWINGS
- CONCRETE CAST AGAINST AND PERMANENTLY EXPOSED TO EARTH... CONCRETE EXPOSED TO EARTH OR WEATHER:
 #6 BARS AND LARGER..... #5 BARS AND SMALLER. .1-1/2'
- CONCRETE NOT EXPOSED TO FARTH OR WEATHER: BEAMS AND COLUMNS.
- A TOOLED EDGE OR A 3/4" CHAMFER SHALL BE PROVIDED AT ALL EXPOSED EDGES OF CONCRETE, UNLESS NOTED OTHERWISE, IN ACCORDANCE WITH ACI 301 SECTION 4.2.4.

GREENFIELD GROUNDING NOTES:

- ALL GROUND ELECTRODE SYSTEMS (INCLUDING TELECOMMUNICATION, RADIO, LIGHTNING PROTECTION AND AC POWER GES'S) SHALL BE BONDED TOGETHER AT OR BELOW GRADE, BY TWO OR MORE COPPER BONDING CONDUCTORS IN ACCORDANCE WITH THE NEC
- THE CONTRACTOR SHALL PERFORM IEEE FALL—OF—POTENTAL RESISTANCE TO EARTH TESTING (PER IEEE 1100 AND 81) FOR GROUND ELECTRODE SYSTEMS, THE CONTRACTOR SHALL FURNISH AND INSTALL SUPPLEMENTAL GROUND ELECTRODES AS NEEDED TO ACHIEVE A TEST RESULT OF 5 OHMS OR LESS.

 THE CONTRACTOR IS RESPONSIBLE FOR PROPERLY SEQUENCING GROUNDING AND UNDERGROUND CONDUIT INSTALLATION AS TO PREVENT ANY LOSS OF CONTINUITY IN THE GROUNDING SYSTEM OR DAMAGE TO THE CONDUIT AND PROVIDE METAL CONDUIT AND TRAY SHALL BE GROUNDED AND MADE ELECTRICALLY CONTINUOUS WITH LISTED BONDING FITTINGS OR BY BONDING ACROSS THE DISCONTINUITY WITH #6 COPPER WIRE UL APPROVED GROUNDING TYPE CONDUIT
- METAL RACEWAY SHALL NOT BE USED AS THE NEC REQUIRED EQUIPMENT GROUND CONDUCTOR. STRANDED COPPER CONDUCTORS WITH GREEN INSULATION, SIZED IN ACCORDANCE WITH THE NEC, SHALL BE FURNISHED AND INSTALLED WITH THE POWER CIRCUITS TO BTS EQUIPMENT.
- EACH CABINET FRAME SHALL BE DIRECTLY CONNECTED TO THE MASTER GROUND BAR WITH GREEN INSULATED SUPPLEMENTAL EQUIPMENT GROUND WIRES, #6 STRANDED COPPER OR LARGER FOR INDOOR BTS; #2 BARE SOLID TINNED COPPER FOR OUTDOOR BTS.
- CONNECTIONS TO THE GROUND BUS SHALL NOT BE DOUBLED UP OR STACKED BACK TO BACK CONNECTIONS ON OPPOSITE SIDE OF THE GROUND BUS ARE PERMITTED.
- ALL EXTERIOR GROUND CONDUCTORS BETWEEN EQUIPMENT/GROUND BARS AND THE GROUND RING SHALL BE #2 SOLID TINNED COPPER UNLESS OTHERWISE INDICATED.
 ALUMINUM CONDUCTOR OR COPPER CLAD STEEL CONDUCTOR SHALL NOT BE USED FOR GROUNDING CONNECTIONS.
 USE OF 90' BENDS IN THE PROTECTION GROUNDING CONDUCTORS SHALL BE AVOIDED WHEN 45' BENDS CAN BE ADEQUATELY SUPPORTED.
 EXCITHERMIC WELDS SHALL BE USED FOR ALL GROUNDING CONNECTIONS BELOW GRADE.

- ALL GROUND CONNECTIONS ABOVE GRADE (INTERIOR AND EXTERIOR) SHALL BE FORMED USING HIGH PRESS CRIMPS.

 COMPRESSION GROUND CONNECTIONS MAY BE REPLACED BY EXOTHERMIC WELD CONNECTIONS.

 ICE BRIDGE BONDING CONDUCTORS SHALL BE EXOTHERMICALLY BONDED OR BOLTED TO THE BRIDGE AND THE TOWER GROUND BAR.

- ICE BRIDGE BONDING CONDUCTORS SHALL BE EXCHERMICALLY BONDED OR BULLED TO THE BRIDGE AND THE TOWER GROUND BAR.

 APPROVED ANTIOXIDANT COATINGS (i.e. CONDUCTIVE GEL OR PASTE) SHALL BE USED ON ALL COMPRESSION AND BOLTED GROUND CONNECTIONS.

 ALL EXTERIOR GROUND CONNECTIONS SHALL BE COATED WITH A CORROSION RESISTANT MATERIAL.

 MISCELLANGOUS ELECTRICAL AND NON-ELECTRICAL METAL BOXES, FRAMES AND SUPPORTS SHALL BE BONDED TO THE GROUND RING, IN ACCORDANCE WITH THE NEC.

 BOND ALL METALLIC OBJECTS WITHIN 6 ft OF MAIN GROUND RING WITH (1) #2 BARE SOLD TINNED COPPER GROUND CONDUCTORS.

 GROUND CONDUCTORS USED FOR THE FACILITY GROUNDING AND LIGHTNING PROTECTION SYSTEMS SHALL NOT BE ROUTED THROUGH METALLIC OBJECTS THAT FORM A RING AROUND THE CONDUCTOR, SUCH AS METALLIC CONDUITS,

 METAL SUPPORT CLIPS OR SLEEVES THROUGH WALLS OR FLOORS. WHEN IT IS REQUIRED TO BE HOUSED IN CONDUIT TO MEET COPE REQUIREMENTS OR LOCAL CONDITIONS, NON-METALLIC MATERIAL SUCH AS PVC CONDUIT SHALL BE
- USED. WHERE USE OF METAL CONDUIT IS UNAVOIDABLE (i.e., NONMETALLIC CONDUIT PROHIBITED BY LOCAL CODE) THE GROUND CONDUCTOR SHALL BE BONDED TO EACH END OF THE METAL CONDUIT.

 ALL GROUNDS THAT TRANSITION FROM BELOW GRADE TO ABOVE GRADE MUST BE #2 BARE SOLID TINNED COPPER IN 3/4" NON-METALLIC, FLEXIBLE CONDUIT FROM 24" BELOW GRADE TO WITHIN 3" TO 6" OF CAD-WELD TERMINATION
- POINT. THE EXPOSED END OF THE CONDUIT MUST BE SEALED WITH SILICONE CAULK. (ADD TRANSITIONING GROUND STANDARD DETAIL AS WELL).
 BUILDINGS WHERE THE MAIN GROUNDING CONDUCTORS ARE REQUIRED TO BE ROUTED TO GRADE, THE CONTRACTOR SHALL ROUTE TWO GROUNDING CONDUCTORS FROM THE ROOFTOP, TOWERS, AND WATER TOWERS GROUNDING RING, TO THE EXISTING GROUNDING SYSTEM, THE GROUNDING CONDUCTORS SHALL NOT BE SMALLER THAN 2/O COPPER. ROOFTOP GROUNDING RING SHALL BE BONDED TO THE EXISTING GROUNDING SYSTEM, THE BUILDING STEEL COLUMNS, LIGHTNING PROTECTION SYSTEM, AND BUILDING MAIN WATER LINE (FERROUS OR NONFERROUS METAL PIPING ONLY).

ELECTRICAL INSTALLATION NOTES:

- ALL ELECTRICAL WORK SHALL BE PERFORMED IN ACCORDANCE WITH THE PROJECT SPECIFICATIONS, NEC AND ALL APPLICABLE
- FEDERAL, STATE, AND LOCAL CODES/ORDINANCES.
 CONDUIT ROUTINGS ARE SCHEMATIC. CONTRACTOR SHALL INSTALL CONDUITS SO THAT ACCESS TO EQUIPMENT IS NOT BLOCKED
- AND TRIP HAZARDS ARE FLIMINATED WIRING RACEWAY AND SUPPORT METHODS AND MATERIALS SHALL COMPLY WITH THE REQUIREMENTS OF THE NEC

- WIRING, RACEWAY AND SUPPORT METHODS AND MATERIALS SHALL COMPLY WITH THE REQUIREMENTS OF THE NEC.

 ALL CIRCUITS SHALL BE SEGREGATED AND MAINTAIN MINIMUM CABLE SEPARATION THE REQUIREMENTS OF THE NEC.

 ALL EQUIPMENT SHALL BEAR THE UNDERWRITERS LABORATORIES LABEL OF APPROVAL, AND SHALL CONFORM TO REQUIREMENT OF THE NATIONAL ELECTRICAL CODE.

 ALL OVERCURRENT DEVICES SHALL HAVE AN INTERRUPTING CURRENT RATING THAT SHALL BE GREATER THAN THE SHORT CIRCUIT CURRENT TO WHICH THEY PARE SUBJECTED, 22,000 AIC MINIMUM, VERYIPY AVAILABLE SHORT CIRCUIT CURRENT DOES NOT EXCEED THE RATING OF ELECTRICAL EQUIPMENT IN ACCORDANCE WITH ARTICLE 110.24 NEC OR THE MOST CURRENT ADDRETED.
- ADDITED CODE PRE THE GOVERNING JURISDICTION.

 EACH END OF EVERY POWER PHASE CONDUCTOR, GROUNDING CONDUCTOR, AND TELCO CONDUCTOR OR CABLE SHALL BE
 LABELED WITH COLOR—CODED INSULATION OR ELECTRICAL TAPE (3M BRAND, 1/2" PLASTIC ELECTRICAL TAPE WITH UV
- PROTECTION, OR EQUAL). THE IDENTIFICATION METHOD SHALL CONFORM WITH NEC AND OSHA.

 ALL ELECTRICAL COMPONENTS SHALL BE CLEARLY LABELED WITH LAMICOID TAGS SHOWING THEIR RATED VOLTAGE, PHASE
 CONFIGURATION, WIRE CONFIGURATION, POWER OR AMPACITY RATING AND BRANCH CIRCUIT ID NUMBERS (i.e. PANEL BOARD AND CIRCUIT ID'S).

- PANEL BOARDS (ID NUMBERS) SHALL BE CLEARLY LABELED WITH PLASTIC LABELS.
 ALL TIE WRAPS SHALL BE CUT FLUSH WITH APPROVED CUTTING TOOL TO REMOVE SHARP EDGES.
 ALL POWER AND EQUIPMENT GROUND WIRING IN TUBING OR CONDUIT SHALL BE SINGLE COPPER CONDUCTOR (#14 OR LARGER)
 WITH TYPE THHW, THWN, THWN-2, XHHW, XHHW-2, THW, THW-2, FHW, OR RHW-2 INSULATION UNLESS OTHERWISE SPECIFIED.
- SUPPLEMENTAL EQUIPMENT GROUND WIRING LOCATED INDOORS SHALL BE SINGLE COPPER CONDUCTOR (#6 OR LARGER) WITH TYPE THHW, THWN, THWN-2, XHHW, XHHW-2, THW, THW-2, RHW, OR RHW-2 INSULATION UNLESS OTHERWISE SPECIFIED.

 POWER AND CONTROL WIRING IN FLEXIBLE CORD SHALL BE MULTI-CONDUCTOR, TYPE SOOW CORD (#14 OR LARGER) UNLESS
- OTHERWISE SPECIFIED.
- POWER AND CONTROL WIRING FOR USE IN CABLE TRAY SHALL BE MULTI-CONDUCTOR, TYPE TC CABLE (#14 OR LARGER), WITH TYPE THHW, THWN, THWN, THWN-2, XHHW, XHHW-2, THW, THW-2, RHW, OR RHW-2 INSULATION UNLESS OTHERWISE SPECIFIED. ALL POWER AND GROUNDING CONNECTIONS SHALL BE CRIMP-STYLE, COMPRESSION WIRE LUGS AND WIRE NUTS BY THOMAS AND BETTS (OR EQUAL). LUGS AND WIRE NUTS SHALL BE RATED FOR OPERATION NOT LESS THAN 75 C (90° C IF AVAILABLE).
- RACEWAY AND CABLE TRAY SHALL BE LISTED OR LABELED FOR ELECTRICAL USE IN ACCORDANCE WITH NEMA, UL. ANSI/JEEE
- 15. ELECTRICAL METALLIC TUBING (EMT), INTERMEDIATE METAL CONDUIT (IMC), OR RIGID METAL CONDUIT (RMC) SHALL BE USED FOR
- EXPOSED INDOOR LOCATIONS.
- ELECTRICAL METALLIC TUBING (EMT) OR METAL—CLAD CABLE (MC) SHALL BE USED FOR CONCEALED INDOOR LOCATIONS.

 SCHEDULE 40 PVC UNDERGROUND ON STRAIGHTS AND SCHEDULE 80 PVC FOR ALL ELBOWS/90s AND ALL APPROVED ABOVE
- GRADE PVC CONDUIT. 18. LIQUID-TIGHT FLEXIBLE METALLIC CONDUIT (LIQUID-TITE FLEX) SHALL BE USED INDOORS AND OUTDOORS, WHERE VIBRATION
- COURS OF FLEXIBLEY IS NEEDED.

 COURS OF FLEXIBLEY IS NEEDED.

 CONDUIT AND APPROVED FOR THE LOCATION USED. SET SCREW FITTINGS ARE NOT ACCEPTABLE.
- 20. CABINETS, BOXES AND WIRE WAYS SHALL BE LABELED FOR ELECTRICAL USE IN ACCORDANCE WITH NEMA, UL, ANSI/IEEE AND
- WIREWAYS SHALL BE METAL WITH AN ENAMEL FINISH AND INCLUDE A HINGED COVER, DESIGNED TO SWING OPEN DOWNWARDS
- (WIREMOLD SPECMATE WIREWAY).
 SLOTTED WIRING DUCT SHALL BE PVC AND INCLUDE COVER (PANDUIT TYPE E OR EQUAL).
- . SLOTTED WIRING DUCT SHALL BE PVC AND INCLUDE COVER (PANDUIT TYPE E OR EQUAL).

 CONDUITS SHALL BE FASTENED SECURELY IN PLACE WITH APPROVED NON-PERFORATED STRAPS AND HANGERS. EXPLOSIVE DEVICES (i.e., POWDER-ACTUATED) FOR ATTACHING HANGERS TO STRUCTURE WILL NOT BE PERMITTED. CLOSELY FOLLOW THE LINES OF THE STRUCTURE, MAINTAIN CLOSE PROXIMITY TO THE STRUCTURE AND KEEP CONDUITS IN TIGHT ENVELOPES. CHANGES IN DIRECTION TO ROUTE AROUND OBSTACLES SHALL BE MADE WITH CONDUIT OUTLET BODIES. CONDUIT SHALL BE INSTALLE IN A NEAT AND WORKMANLIKE MANNER. PARALLEL AND PERPENDICULAR TO STRUCTURE WALL AND CEILING LINES. ALL CONDUIT SHALL BE INSTRUCTURE WALL AND CEILING LINES. ALL CONDUIT SHALL BE FISHED TO CLEAR OBSTRUCTIONS, ENDS OF CONDUITS SHALL BE RIGIDLY CLAMPED TO BOXES BY GALVANIZED MALLEABLE IRON BUSHING ON INSIDE AND GALVANIZED MALLEABLE IRON LOCKNUT ON OUTSIDE AND INSIDE.

 MALLEABLE IRON BUSHING ON INSIDE AND GALVANIZED MALLEABLE IRON LOCKNUT ON OUTSIDE AND INSIDE.

 SEQUIPMENT CABINETS, TERMINAL BOXES, JUNCTION BOXES AND PULL BOXES SHALL BE GALVANIZED OR EPOXY—COATED SHEET STEEL. SHALL MEET OR EXCEED UL 50 AND BE RATED NEMA 1 (OR BETTER) FOR INTERIOR LOCATIONS AND NEMA 3R (OR BETTER) FOR EXTERIOR LOCKNUT.
- BETTER) FOR EXTERIOR LOCATIONS.
- METAL RECEPTACLE, SWITCH AND DEVICE BOXES SHALL BE GALVANIZED, EPOXY—COATED OR NON—CORRODING; SHALL MEET OR EXCEED UL 514A AND NEMA OS 1 AND BE RATED NEMA 1 (OR BETTER) FOR INTERIOR LOCATIONS AND WEATHER PROTECTED (WP OR BETTER) FOR EXTERIOR LOCATIONS
- NONMETALLIC RECEPTACLE, SWITCH AND DEVICE BOXES SHALL MEET OR EXCEED NEMA OS 2 (NEWEST REVISION) AND BE RATED NEMA 1 (OR BETTER) FOR INTERIOR LOCATIONS AND WEATHER PROTECTED (WP OR BETTER) FOR EXTERIOR LOCATIONS.
- 27 THE CONTRACTOR SHALL NOTIFY AND OBTAIN NECESSARY AUTHORIZATION FROM THE CARRIER AND/OR CROWN CASTLE USA INC.
- BEFORE COMMENCING SHALL NOTIFY AND OBTAIN NECESSARY ADMINISTRATE THOM THE CARRIER AND/OR CROWN CASTLE USA INC.
 BEFORE COMMENCING WORK ON THE AC POWER DISTRIBUTION PANELS.
 THE CONTRACTOR SHALL PROVIDE NECESSARY TAGGING ON THE BREAKERS, CABLES AND DISTRIBUTION PANELS IN ACCORDANCE
 WITH THE APPLICABLE CODES AND STANDARDS TO SAFEGUARD LIFE AND PROPERTY.

 INSTALL LAMICOID LABEL ON THE METER CENTER TO SHOW "AT&T".
- ALL EMPTY/SPARE CONDUITS THAT ARE INSTALLED ARE TO HAVE A METERED MULE TAPE PULL CORD INSTALLED.

CONDUCTOR COLOR CODE							
SYSTEM	CONDUCTOR	COLOR					
	A PHASE	BLACK					
120/240V, 1Ø	B PHASE	RED					
120/2404, 16	NEUTRAL	WHITE					
	GROUND	GREEN					
	A PHASE	BLACK					
	B PHASE	RED					
120/208V, 3Ø	C PHASE	BLUE					
	NEUTRAL	WHITE					
	GROUND	GREEN					
	A PHASE	BROWN					
	B PHASE	ORANGE OR PURPLE					
277/480V, 3Ø	C PHASE	YELLOW					
	NEUTRAL	GREY					
	GROUND	GREEN					
DC VOLTAGE	POS (+)	RED**					
DC VOLIAGE	NEG (-)	BLACK**					

* SEE NEC 210.5(C)(1) AND (2)

APWA UNIFORM COLOR CODE:

WHITE PROPOSED EXCAVATION TEMPORARY SURVEY MARKINGS ELECTRIC POWER LINES, CABLES, CONDUIT, AND LIGHTING CABLES YELLOW GAS, OIL, STEAM, PETROLEUM, OR GASEOUS MATERIALS COMMUNICATION, ALARM OR SIGNAL LINES, CABLES, OR CONDUIT AND TRAFFIC LOOPS

POTABLE WATER RECLAIMED WATER, IRRIGATION, AND SLURRY LINES

SEWERS AND DRAIN LINES

WALLINGFORD/ I-91/ X14/ S

AT&T SITE NUMBER: CT5111

BU #: **828915**

575 MOROSGO DRIVE ATLANTA, GA 30324-3300

3 CORPORATE PARK DRIVE, SUITE 101

CLIFTON PARK, NY 12065

CROWN

316 WOODHOUSE AVENUE WALLINGFORD, CT 06492

EXISTING 148'-0" MONOPOLE

ISSUED FOR:					
REV	DATE	DRWN	DESCRIPTION	DES./QA	
Α	05/11/20	MLC	PRELIMINARY	RO	
В	06/04/20	RO	PRELIMINARY		
С	2/22/21	JTS	PRELIMINARY	RMC	
0	3/31/21	JTS	CONSTRUCTION	MTJ	
1	5/13/21	GEH	CONSTRUCTION	GEH	



B&T ENGINEERING, INC. PEC.0001564 Expires 2/10/22


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SHEET NUMBER:

REVISION:

ABBREVIATIONS

EXISTING FACILITY INTERFACE FRAME GEN GPS GSM LTE MGB MW GENERATOR GLOBAL POSITIONING SYSTEM GLOBAL SYSTEM FOR MOBILE LONG TERM EVOLUTION MASTER GROUND BAR MICROWAVE GENERATOR (N) NEC NEW NATIONAL ELECTRIC CODE (P) PROPOSED POWER PLANT QTY RECT RECTIFIER RADIO BASE STATION REMOTE ELECTRIC TIL REMOTE ELECTRIC TILLT
RADIO FREQUENCY DATA SHEET
REMOTE RADIO HEAD
REMOTE RADIO UNIT
SMART INTEGRATED DEVICE TOWER MOUNTED AMPLIFIER UMTS W P UNIVERSAL MOBILE TELECOMMUNICATIONS SYSTEM



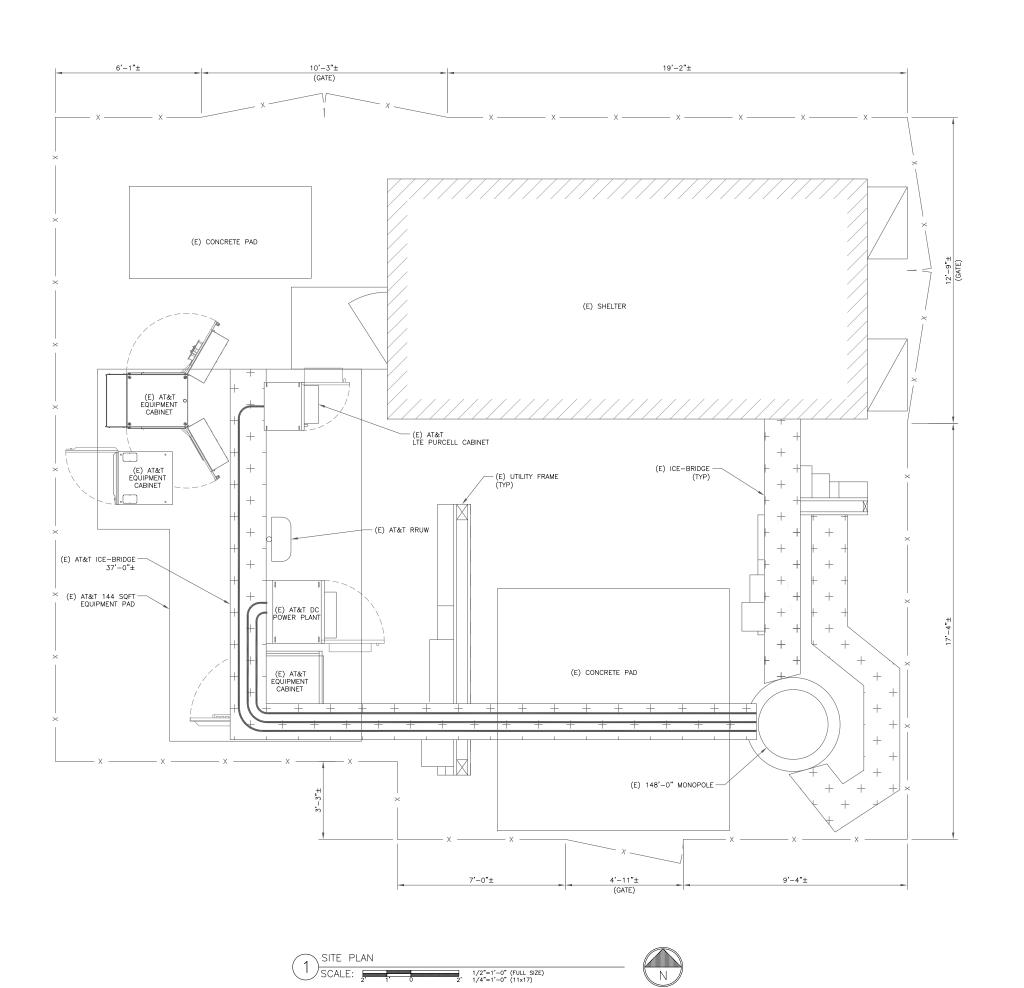



AT&T SITE NUMBER: **CT5111**

BU #: **828915** WALLINGFORD/ I-91/ X14/ S

316 WOODHOUSE AVENUE WALLINGFORD, CT 06492

EXISTING 148'-0" MONOPOLE

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Α	05/11/20	MLC	PRELIMINARY	RO			
В	06/04/20	RO	PRELIMINARY	**			
С	2/22/21	JTS	PRELIMINARY	RMC			
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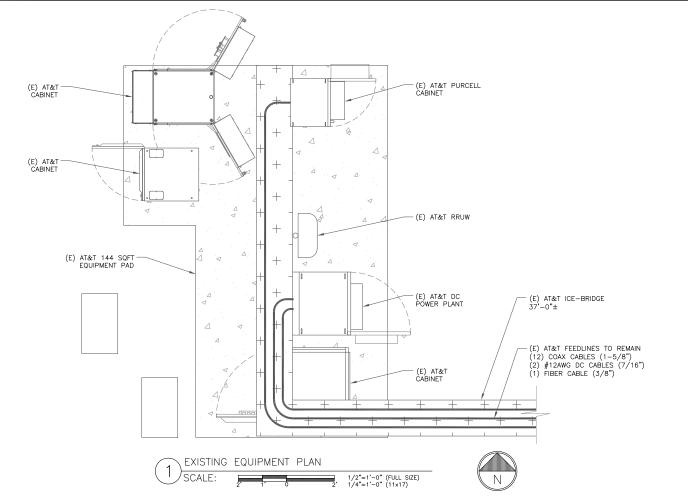


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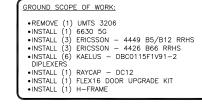



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316 WOODHOUSE AVENUE WALLINGFORD, CT 06492

EXISTING 148'-0" MONOPOLE





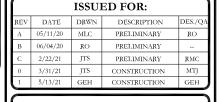



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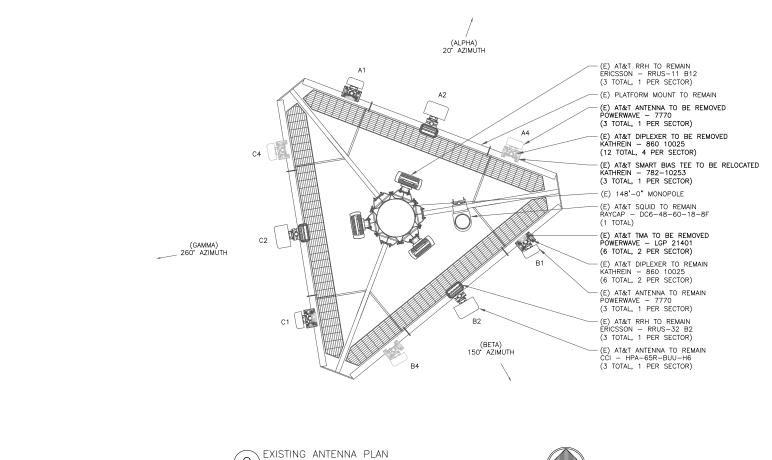
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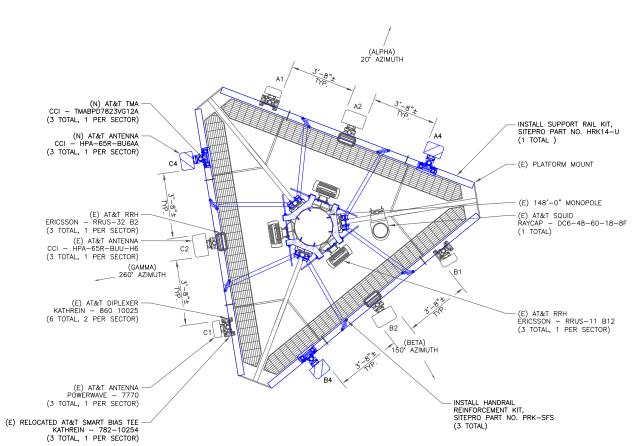
SHEET NUMBER:





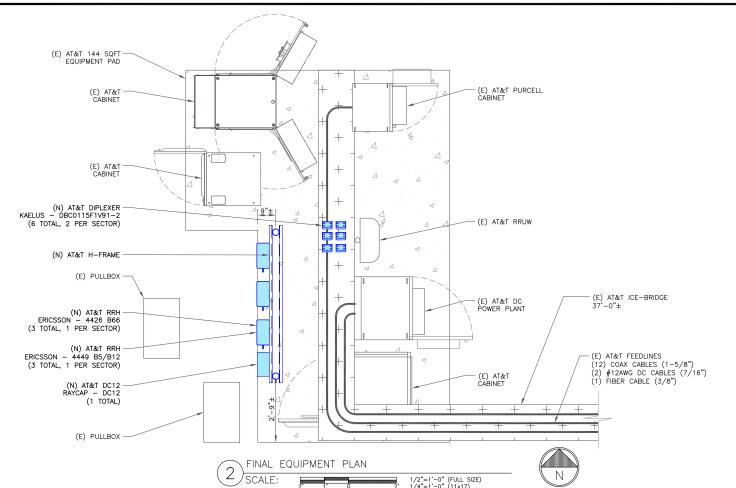

3/8"=1'-0" (FULL SIZE) 2' 3/16"=1'-0" (11x17)

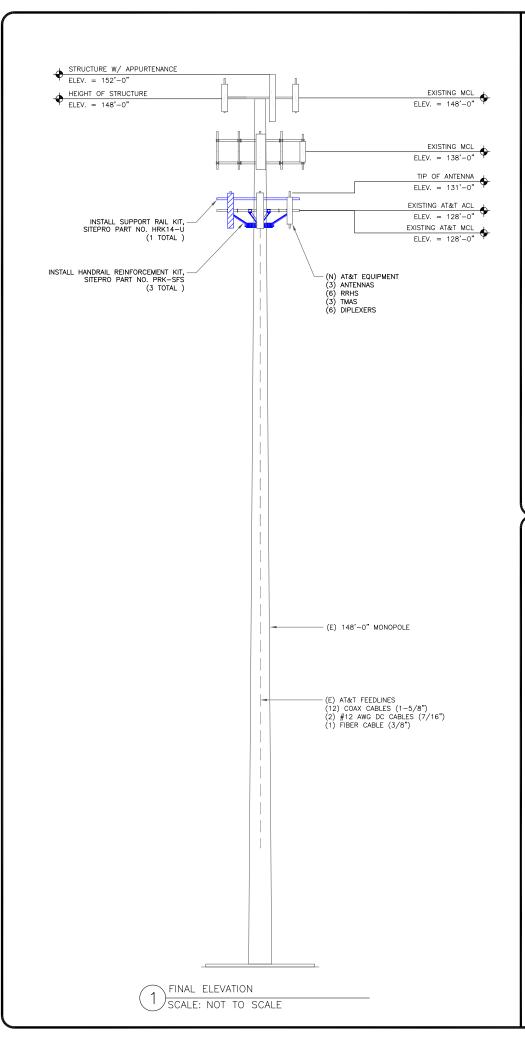

SCALE: 2 1 0

(2) SCALE:

"LOOK UP" - CROWN CASTLE USA INC. SAFETY CLIMB REQUIREMENT:

THE INTEGRITY OF THE SAFETY CLIMB AND ALL COMPONENTS OF THE CLIMBING FACILITY SHALL BE CONSIDERED DURING ALL STAGES OF DESIGN, INSTALLATION, AND INSPECTION. TOWER MODIFICATION, MOUNT REINFORCEMENTS, AND/OR EQUIPMENT INSTALLATIONS SHALL NOT COMPROMISE THE INTEGRITY OR FUNCTIONAL USE OF THE SAFETY CLIMB OR ANY COMPONENTS OF THE CLIMBING FACILITY ON THE STRUCTURE. THIS SHALL INCLUDE, BUT NOT BE LIMITED TO: PINCHING OF THE WIRE ROPE, BENDING OF THE WIRE ROPE FROM ITS SUPPORTS, DIRECT CONTACT OR CLOSE PROXIMITY TO THE WIRE ROPE WHICH MAY CAUSE FRICTIONAL WEAR, IMPACT TO THE ANCHORAGE POINTS IN ANY WAY, OR TO IMPEDE/BLOCK ITS INTENDED USE. ANY WAY, OR TO IMPEDE/BLOCK ITS INTENDED USE. ANY WEAR, IMPACT TO THE ANCHRAGE POINTS IN ANY WAY, OR TO IMPEDE/BLOCK ITS INTENDED USE. ANY COMPROMISED SAFETY CLIMB, INCLUDING EXISTING CONDITIONS MUST BE TAGGED OUT AND REPORTED TO YOUR CROWN CASTLE USA INC. POC OR CALL THE NOC TO GENERATE A SAFETY CLIMB MAINTENANCE AND CONTRACTOR NOTICE TICKET.

NOTES:

- REFERENCE C-3 FOR FINAL EQUIPMENT

- REFERENCE C-3 FOR FINAL EQUIPMENT SCHEDULE. REFERENCE C-4 FOR NEW EQUIPMENT SPECIFICATIONS. CONTRACTOR TO VERIFY ALL ANTENNA TIP HEIGHTS DO NOT EXCEED BEACON BASE HEIGHT.

Ν

- REFERENCE C-3 FOR FINAL EQUIPMENT
- REFERENCE C-4 FOR NEW EQUIPMENT
- REFERENCE C-4 FOR NEW EQUIPMENT SPECIFICATIONS.
 CONTRACTOR TO VERIFY ALL ANTENNA TIP HEIGHTS DO NOT EXCEED BEACON BASE HEIGHT. 3'-0" MINIMUM DISTANCE REQUIRED BETWEEN LTE ANTENNAS ON SAME SECTOR.

- LIE ANIENNAS ON SAME SECTOR.
 6'-O" MINIMUM DISTANCE REQUIRED BETWEEN
 700BC & 700DE ANTENNAS ON SAME SECTOR.
 4'-O" MINIMUM DISTANCE REQUIRED BETWEEN
 LIE 700 ANTENNAS ON OPPOSING SECTORS.
 ALL ANTENNA MEASUREMENT DISTANCES MUST BE
- EDGE TO EDGE (RELOCATE ANTENNAS AS NEEDED).
- A" MINIMUM DISTANCE REQUIRED BETWEEN ANTENNA & RADIO. SEE GENERIC EXAMPLE DETAIL ON SHEET C-4.





AT&T SITE NUMBER: CT5111

BU #: **828915** WALLINGFORD/ I-91/ X14/ S

316 WOODHOUSE AVENUE WALLINGFORD, CT 06492

EXISTING 148'-0" MONOPOLE

ISSUED FOR:						
REV	DATE	DRWN	DESCRIPTION	DES./QA		
A	05/11/20	MLC	PRELIMINARY	RO		
В	06/04/20	RO	PRELIMINARY			
С	2/22/21	JTS	PRELIMINARY	RMC		
0	3/31/21	JTS	CONSTRUCTION	MTJ		
1	5/13/21	GEH	CONSTRUCTION	GEH		



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SHEET NUMBER:

						FI	NAL AN	TENNA	AND F	EED	LINE SCH	EDULE						
POS.	TECH	STATUS	AZIMUTH	ANTENNA TYPE	ANTENNA RAI CENTER	MECHANICAL DOWNTILT	ELECTRICAL DOWNTILT	MAIN COAX SIZE	MAIN COAX LENGTH	COAX QTY	TMA QTY AND MODEL	SURGE PROTECTION	DC/FIBER CABLES	RRHs QTY & MODEL	LOCATION		DIPLEXER ON GROUND	RET CABLE
ALPHA	SECTOR																	
A1	UMTS	EXISTING	20*	POWERWAVE 7770	128'-0"	0*	4*	1 5/8"	150'-0"	2	-			_	_	Υ	N	Y
A2	LTE	EXISTING	20°	CCI HPA-65R-BUU-H6	128'-0"	0,	10°/6°/6°	_	-	_	-	_	_	(1) RRUS-11 B12 (1) RRUS-32 B2	TOWER	_	_	Y
А3	_	_	_	_	_	_	_	_	_	_	_			_	_	_	_	-
A4	LTE	NEW	20°	CCI HPA-65R-BU6AA	128'-0"	0,	6°/6°/6°	1 5/8"	150'-0"	2	(1) TMABPD7823VG12A			(1) 4449 B5/B12 (1) 4426 B26	TOWER	Υ	N	Y
BETA S	ECTOR																	
B1	UMTS	EXISTING	20*	POWERWAVE 7770	128'-0"	0,	2*	1 5/8"	150'-0"	2	_			_	-	Υ	N	Y
B2	LTE	EXISTING	20°	CCI HPA-65R-BUU-H6	128'-0"	0,	3°/2°/2°	_	_	_	-	-DC6-48-60-18-8F	(1) 3/8" FIBER	(1) RRUS-11 B12 (1) RRUS-32 B2	TOWER	_	_	Y
В3	-	_	_	_	_	_	_	_	_	_	-	7 DC0-46-60-16-6F	(2) 7/16" DC LINES	_	_	-	_	-
В4	LTE	NEW	20°	CCI HPA-65R-BU6AA	128'-0"	0.	2*/2*/2*	1 5/8"	150'-0"	2	(1) TMABPD7823VG12A	-		(1) 4449 B5/B12 (1) 4426 B26	TOWER	Y	N	Y
GAMMA	SECTOR																	
C1	UMTS	EXISTING	20°	POWERWAVE 7770	128'-0"	2*	4°	1 5/8"	150'-0"	2	-			-	-	Υ	N	Y
C2	LTE	EXISTING	20°	CCI HPA-65R-BUU-H6	128'-0"	0,	10°/6°/6°	_	-	_	-	_	_	(1) RRUS-11 B12 (1) RRUS-32 B2	TOWER	_	_	Y
С3	_	_	_	_	_	_			-	_	-		_	_	-	_	_	-
C4	LTE	NEW	20°	CCI HPA-65R-BU6AA	128'-0"	0,	6°/6°/6°	1 5/8"	150'-0"	2	(1) TMABPD7823VG12A			(1) 4449 B5/B12 (1) 4426 B26	TOWER	Υ	N	Υ

NOTE: BOLD DENOTES NEW EQUIPMENT





AT&T SITE NUMBER: **CT5111**

BU #: **828915 Wallingford/ I-91/ X14/ S**

316 WOODHOUSE AVENUE WALLINGFORD, CT 06492

EXISTING 148'-0" MONOPOLE

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REV	DATE	DRWN	DESCRIPTION	DES./QA			
Α	05/11/20	MLC	PRELIMINARY	RO			
В	06/04/20	RO	PRELIMINARY				
С	2/22/21	JTS	PRELIMINARY	RMC			
0	3/31/21	JTS	CONSTRUCTION	MTJ			
1	5/13/21	GEH	CONSTRUCTION	GEH			




B&T ENGINEERING, INC. PEC.0001564 Expires 2/10/22

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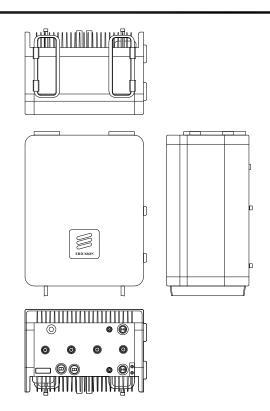
C-3

revision:




CCI ANTENNAS — HPA-65R-BU6AA WEIGHT (WITHOUT MOUNTING HARDWARE): 54.5 LBS SIZE (HxWXD): 71.20x11.70x8.40 IN. MOUNTING HARDWARE P/N: MBK-01 RATED WIND VELOCITY: 150.0 MPH

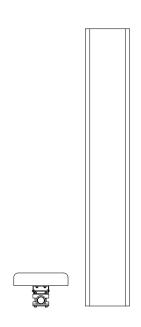
CCI - HPA-65R-BU6AA SCALE: NOT TO SCALE



ERICSSON — RADIO 4449 B5/B12 WEIGHT: 70.0 LBS SIZE (HxWxD): 18.0x13.2x9.4 IN.

2 ERICSSON - RADIO 4449 B5/B12 SCALE: NOT TO SCALE

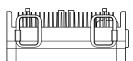

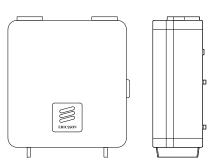



ERICSSON - RADIO 4426 B66 WEIGHT: 60.0 LBS SIZE (HxWxD): 14.9x13.2x5.8 IN.

SCALE: NOT TO SCALE






AT&T SITE NUMBER: **CT5111**


BU #: **828915 Wallingford/ I-91/ X14/ S**

316 WOODHOUSE AVENUE WALLINGFORD, CT 06492


EXISTING 148'-0" MONOPOLE

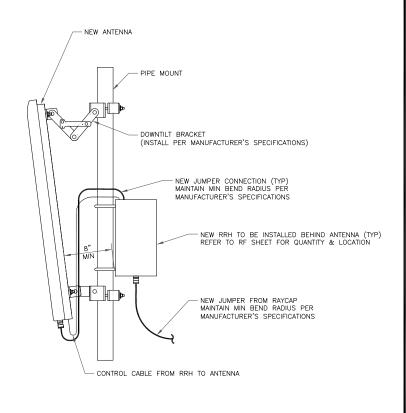

GENERIC ANTENNA MOUNTING ELEVATION
SCALE: NOT TO SCALE

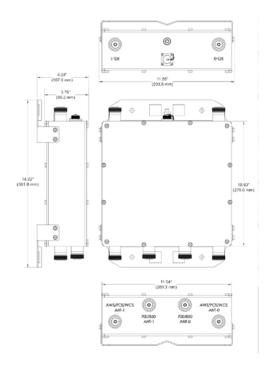

CCI - TMABPD7823VG12A SCALE: NOT TO SCALE

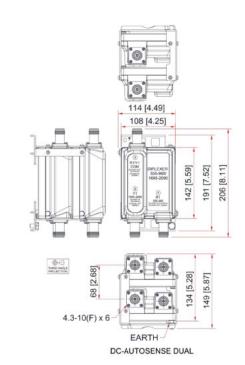

KAELUS - DBC0115F1V91-2
SCALE: NOT TO SCALE

ISSUED FOR:							
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SHEET NUMBER:

revision:

NOTES:


- ERICSSON VIA AT&T SUPPLIES THE RRH. SUBCONTRACTOR SHALL SUPPLY ALL OTHER MATERIALS AND INSTALL ALL MOUNTING HARDWARE. ERICSSON INSTALLS RRH AND MAKES CABLE TERMINATIONS.
- A SUPPORT FOR A SINGLE RRH SHALL HAVE A MINIMUM OF TWO ANCHORS/FASTENERS FOR EACH UNISTRUT CHANNEL.
- 3. INSTALL ANCHORS/FASTENERS A MAXIMUM OF
- INSTALL ANCHORS/FASTENERS A MAXIMUM OF 2'-0" ON CENTERS.

 WOOD STUDS 1/4"ø LAG BOLT W/
 1" EMBEDMENT IN WOOD


 CONCRETE 1/4"ø HILTI KWIK BOLT III
 W/ 1-1/2" EMBEDMENT OR
 EQUIVALENT


 THROUGH BOLT 1/4"ø A36/A307
 THREADED ROD W/ NUTS AND WASHERS

 MASONRY 1/2"ø HILTI HY20 W/6"
 EMBEDMENT ANCHORS AND UNISTRUT
 CHANNEL SHALL HAVE HOT-DIPPED
 GALVANIZED FINISH.
- MOUNT RRH TO UNISTRUT WITH 3/8"
 UNISTRUT BOLTING HARDWARE AND SPRING NUTS. TYPICAL FOUR PER BRACKET. SUBCONTRACTOR SHALL SUPPLY.
- 5. NO PAINTING OF THE RRH OR SOLAR SHIELD IS ALLOWED.

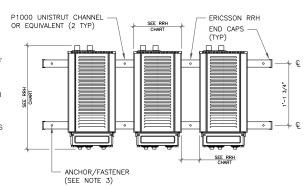

RRH MOUNTING DETAIL (1) SCALE: NOT TO SCALE

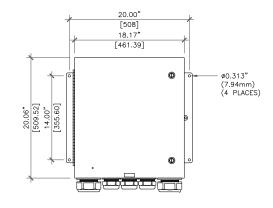

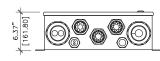

SURGE UNIT DETAIL (DC12-48-60-0-25E)
SCALE: N.T.S.





AT&T SITE NUMBER: CT5111

BU #: **828915** |WALLINGFORD/ I-91/ X14/ S

316 WOODHOUSE AVENUE WALLINGFORD, CT 06492

EXISTING 148'-0" MONOPOLE


ISSUED FOR:						
REV	DATE	DRWN	DESCRIPTION	DES./QA		
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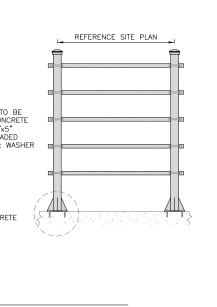



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SHEET NUMBER:





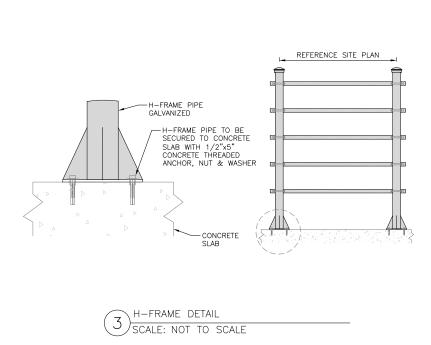

GROUNDING PLAN LEGEND:

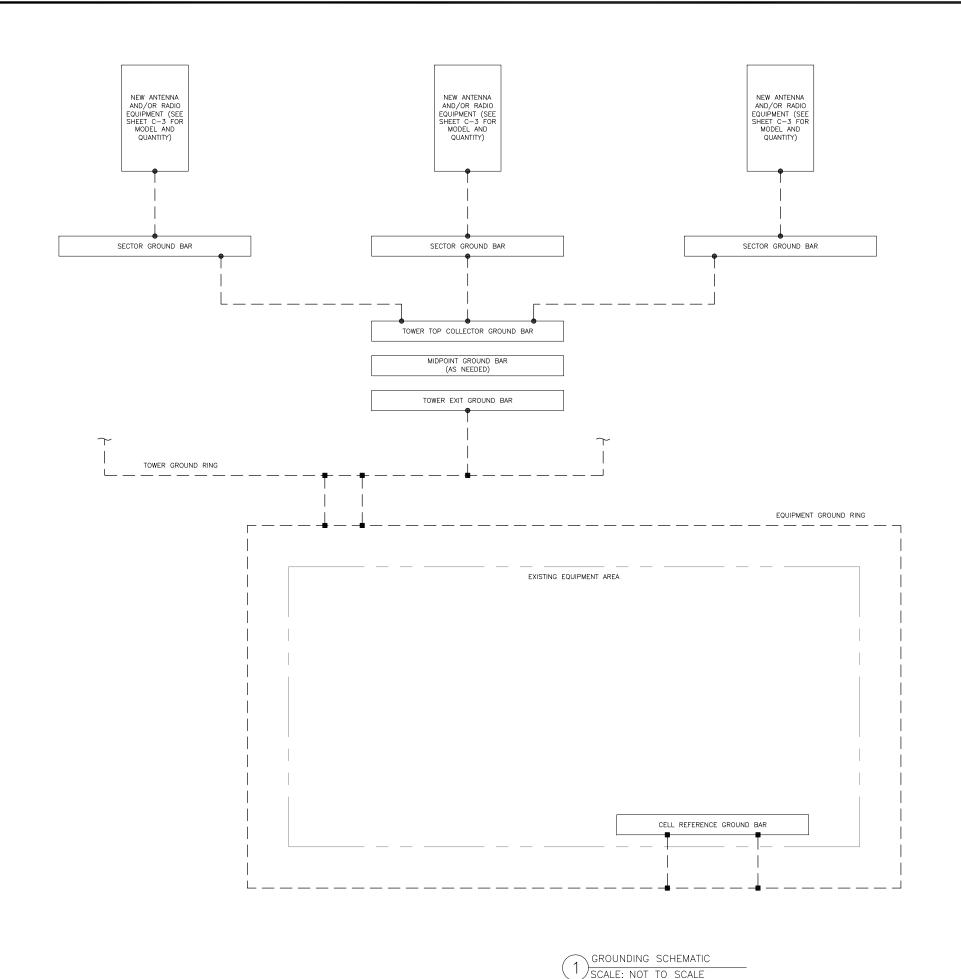--- GROUND WIRE

© COPPER GROUND ROD

■ EXOTHERMIC WELD MECHANICAL CONNECTION

S GROUND ROD W/ TEST WELL

CELL REFERENCE GROUND BAR: POINT OF GROUND REFERENCE FOR ALL COMMUNICATIONS EQUIPMENT FRAMES. ALL BONDS ARE MADE WITH #2 STRANDED GREEN INSULATED COPPER CONDUCTORS. BOND TO GROUND RING WITH (2) #2 SOLID TINNED COPPER CONDUITS (ATT—TP—76416 7.6.7).

HATCH PLATE GROUND BAR: BOND TO THE INTERIOR GROUND RING WITH (2) #2 STRANDED GREEN INSULATED COPPER CONDUCTORS. WHEN A RESULT OF A REPORT OF A RESULT OF A RESULT

EXTERIOR CABLE ENTRY PORT GROUND BARS: LOCATED AT THE ENTRANCE TO THE CELL SITE BUILDING. BOND TO GROUND RING WITH A #2 SOLID TINNED COPPER CONDUCTORS WITH AN EXOTHERMIC WELD AND INSPECTION SLEEVE (ATT-TP-76416 7.6.7.2).

DURING ALL DC POWER SYSTEM CHANGES INCLUDING DC SYSTEM CHANGE OUTS, RECTIFIER REPLACEMENTS OR ADDITIONS, BREAKER DISTRIBUTION CHANGES, BATTERY ADDITIONS, BATTERY REPLACEMENTS AND INSTALLATIONS OR CHANGES TO DC CONVERTER SYSTEMS IT SHALL BE REQUIRED THAT SERVICES CONTRACTORS VERIFY ALL DC POWER SYSTEMS ARE EQUIPPED WITH MASTER DC SYSTEM RETURN GROUND CONDUCTOR FROM THE DC POWER SYSTEM COMMON RETURN BUS DIRECTLY CONNECTED TO THE CELL SITE REFERENCE GROUND BAR PER TP76300 SECTION H 6 AND TP76416 FIGURE 7-11 REQUIREMENTS.



575 MOROSGO DRIVE ATLANTA, GA 30324-3300



AT&T SITE NUMBER: **CT5111**

BU #: **828915** |WALLINGFORD/ I-91/ X14/ S

316 WOODHOUSE AVENUE WALLINGFORD, CT 06492

EXISTING 148'-0" MONOPOLE

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06/04/20	RO	PRELIMINARY					
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3/31/21	JTS	CONSTRUCTION	MTJ				
5/13/21	GEH	CONSTRUCTION	GEH				
	05/11/20 06/04/20 2/22/21 3/31/21	DATE DRWN 05/11/20 MLC 06/04/20 RO 2/22/21 JTS 3/31/21 JTS	DATE DRWN DESCRIPTION 05/11/20 MLC PRELIMINARY 06/04/20 RO PRELIMINARY 2/22/21 JTS PRELIMINARY 3/31/21 JTS CONSTRUCTION				




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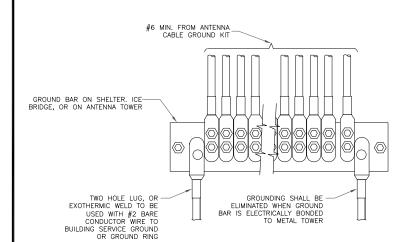
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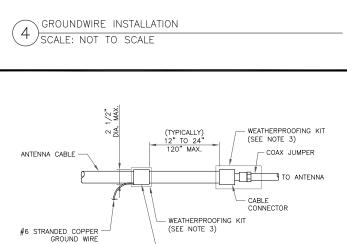
SHEET NUMBER:

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- DOUBLING UP "OR STACKING" OF CONNECTIONS IS NOT PERMITTED.
 EXTERIOR ANTIOXIDANT JOINT COMPOUND TO BE USED ON ALL EXTERIOR CONNECTIONS.
 GROUND BAR SHALL NOT BE ISOLATED FROM TOWER. MOUNT DIRECTLY TO ANTENNA MOUNT STEEL.
- ANTENNA SECTOR GROUND BAR DETAIL (1) SCALE: NOT TO SCALE



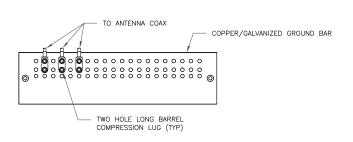


(GROUND TO GROUND BAR) SEE NOTES 1 & 2

- DO NOT INSTALL CABLE GROUND KIT AT A BEND AND ALWAYS DIRECT GROUND WIRE DOWN TO GROUND BAR.
 GROUNDING KIT SHALL BE TYPE AND PART NUMBER AS SUPPLIED OR RECOMMENDED BY CABLE MANUFACTURER.
- 3. WEATHER PROOFING SHALL BE TWO-PART TAPE KIT, COLD SHRINK SHALL NOT BE


- CABLE GROUND KIT

CABLE GROUND KIT CONNECTION (6) SCALE: NOT TO SCALE

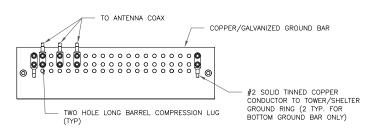


- EXTERIOR ANTIOXIDANT JOINT COMPOUND TO BE USED ON ALL EXTERIOR CONNECTIONS.
 GROUND BAR SHALL NOT BE ISOLATED FROM TOWER. MOUNT DIRECTLY TO TOWER STEEL (TOWER ONLY).
 GROUND BAR SHALL BE ISOLATED FROM BUILDING OR SHELTER.

TOWER/SHELTER GROUND BAR DETAIL (2) SCALE: NOT TO SCALE

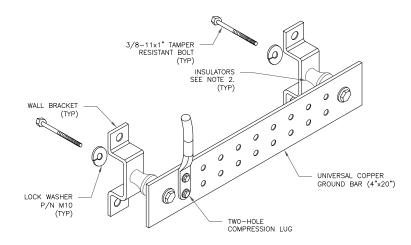


- 1. DOWN LEAD (HOME RUN) CONDUCTORS ARE <u>NOT</u> TO BE INSTALLED ON CROWN CASTLE USA INC. TOWER, PER THE GROUNDING DOWN CONDUCTOR POLICY QAS-STD-10091. NO MODIFICATION OR DRILLING TO TOWER STEEL IS ALLOWED IN ANY FORM OR FASHION, CAD-WELDING ON THE TOWER AND/OR IN THE AIR ARE NOT PERMITTED.
- 2. OMIT INSULATOR WHEN MOUNTING TO TOWER STEEL OR PLATFORM STEEL USE INSULATORS WHEN ATTACHING TO BUILDING OR SHELTERS.
- GROUND BAR DETAIL (5)SCALE: NOT TO SCALE

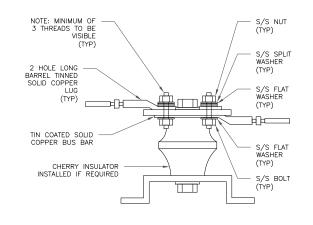



LUG DETAIL 7 SCALE: NOT TO SCALE

WIRE SIZE	BURNDY LUG	BOLT SIZE
#6 GREEN INSULATED	YA6C-2TC38	3/8" - 16 NC SS 2 BOLT
#2 SOLID TINNED	YA3C-2TC38	3/8" - 16 NC SS 2 BOLT
#2 STRANDED	YA2C-2TC38	3/8" - 16 NC SS 2 BOLT
#2/0 STRANDED	YA26-2TC38	3/8" - 16 NC SS 2 BOLT
#4/0 STRANDED	YA28-2N	1/2" - 16 NC SS 2 BOLT

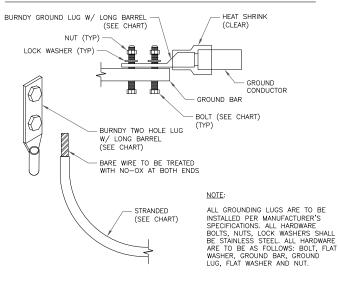


MECHANICAL LUG CONNECTION SCALE: NOT TO SCALE

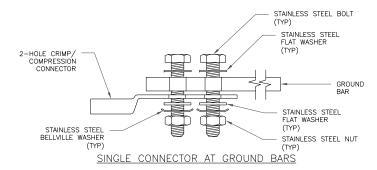

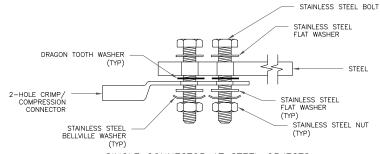

SINGLE CONNECTOR AT STEEL OBJECTS

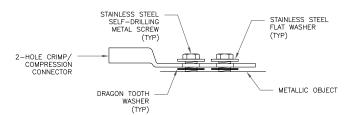

SINGLE CONNECTOR AT METALLIC/STEEL OBJECTS

HARDWARE DETAIL FOR EXTERIOR CONNECTIONS SCALE: NOT TO SCALE





AT&T SITE NUMBER: CT5111

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316 WOODHOUSE AVENUE WALLINGFORD, CT 06492

EXISTING 148'-0" MONOPOLE

4				
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Diagram - Sector A Diagram File Name - CT5111_Descope_A_B_G_Rev.1.vsd

Atoll Site Name - CT5111 Location Name - WALLINGFORD-POND Market - CONNECTICUT Market Cluster - NEW ENGLAND
HILL

Comments: "Important Note: For detailed radio to antenna wiring refer to the latest field notice - Antenna_Radio Connection Drawings Playbook v6.0_Ericsson"

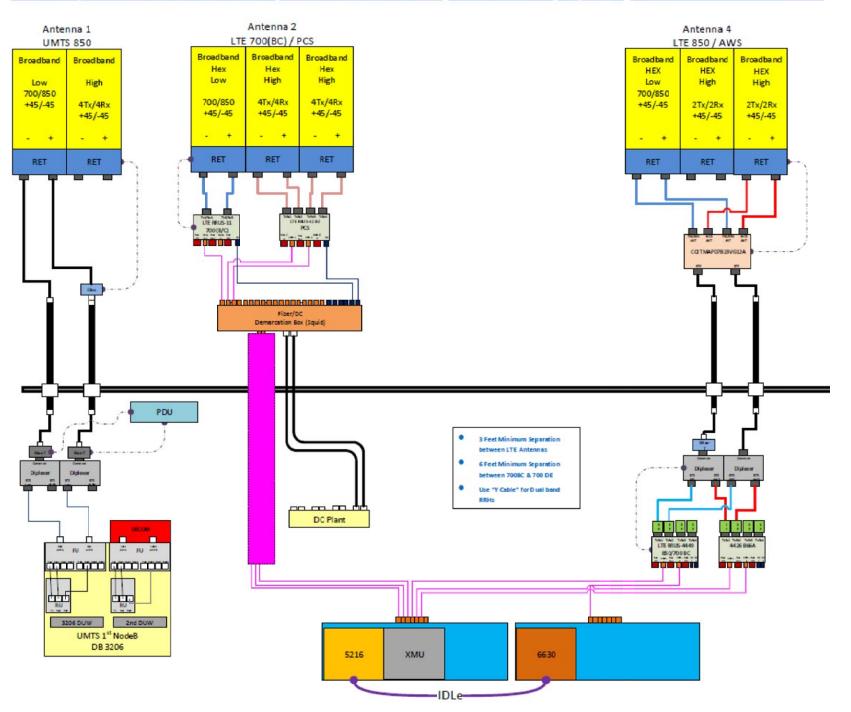


Diagram - Sector B Diagram File Name - CT5111_Descope_A_B_G_Rev.1.vsd

Atoll Site Name - CT5111 Location Name - WALLINGFORD-POND HILL CONNECTICUT Market Cluster - NEW ENGLAND

Comments: "Important Note: For detailed radio to antenna wiring refer to the latest field notice - Antenna_Radio Connection Drawings Playbook v6.0_Ericsson"

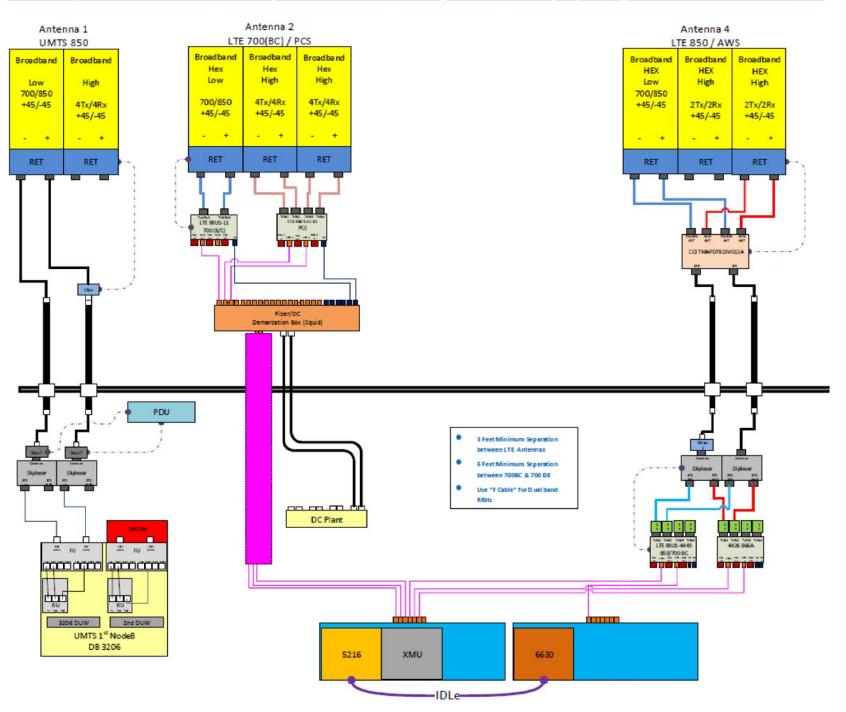


Diagram - Sector C Diagram File Name - CT5111_Descope_A_B_G_Rev.1.vsd

WALLINGFORD-POND
Atoll Site Name - CT5111 Location Name - WALLINGFORD-POND Market - CONNECTICUT Market Cluster - NEW ENGLAND

Comments: "Important Note: For detailed radio to antenna wiring refer to the latest field notice - Antenna_Radio Connection Drawings Playbook v6.0_Ericsson"

