

Northeast Site Solutions
Denise Sabo
420 Main Street #2, Sturbridge, MA 01566
203-435-3640
Denise@northeastsitesolutions.com

May 12, 2022

Members of the Siting Council Connecticut Siting Council Ten Franklin Square New Britain, CT 06051

RE: Notice of Exempt Modification

1605 Durham Road, Wallingford, CT 06492

Latitude: 41.469562 Longitude: 72.742225

T-Mobile Site#: CT11287A NHP

Dear Ms. Bachman:

T-Mobile currently maintains three (3) antennas at the 152-foot mount on the existing 162-foot monopole located at 1605 Durham Road in Wallingford. The property is owned by Tilcon Mineral, Inc. and the tower is owned by SBA. T-Mobile now intends to add a 48kw generator on a new 4' X 2' concrete pad within existing compound.

Planned Modifications:

Ground work only-Install New:

- (1) GENERAC RD 48KW AC DIESEL GENERATOR 233-gallon double walled self-contained tank with fuel sensor. Requires two (2) 12-minute run cycles bi-weekly.
- (1) 4'x2" Concrete pad



This facility was approved by the Town of Wallingford on December 13, 1999. Please see attached.

Please accept this letter as notification pursuant to Regulations of Connecticut State Agencies §16-50j-73, for construction that constitutes an exempt modification pursuant to R.C.S.A. § 16-50j-72(b)(2). In accordance with R.C.S.A. § 16.50j-73, a copy of this letter is being sent to the Town of Wallingford's Mayor, William W. Dickinson, Jr., and Zoning Enforcement Officer, Amy Torre, as well as the property owner and tower owner.

The planned modifications to the facility fall squarely within those activities explicitly provided for in R.C.S;A. § 16-50j-72(b)(2).

- 1. The proposed modifications will not result in an increase in the height of the existing structure.
- 2. The proposed modifications will not require the extension of the site boundary.
- 3. The proposed modifications will not increase noise levels at the facility by six decibels or more, or to levels that exceed state and local criteria.
- 4. The operation of the replacement antennas will not increase radio frequency emissions at the facility to a level at or above the Federal Communications Commission safety standard.
- 5. The proposed modifications will not cause a change or alteration in the physical or environmental characteristics of the site.
- 6. The existing structure and its foundation can support the proposed loading.

For the foregoing reasons, T-Mobile respectfully submits that the proposed modifications to the above referenced telecommunications facility constitute an exempt modification under R.C.S.A. § 16-50j-72(b)(2).

Sincerely,

Denise Sabo

Mobile: 203-435-3640 Fax: 413-521-0558

Office: 420 Main Street, Unit 2, Sturbridge MA 01566

Email: Denise@northeastsitesolutions.com



Attachments cc: William W. Dickinson, Mayor Wallingford Town Hall 45 South Main Street Wallingford, CT 06492

Amy Torre, Zoning Enforcement Officer Wallingford Town Hall 45 South Main Street Wallingford, CT 06492

Tilcon Mineral, Inc., as property owner PO Box 32411 Harford, CT 06150

SBA Communications, as tower owner 134 Flanders Rd, Suite 125 Westborough, MA 01581

Exhibit A



Town of Wallingford, Connecticut

WILLIAM E. AUSTIN

WALLINGFORD TOWN HALL 45 SOUTH MAIN STREET WALLINGFORD, CT 06492 TELEPHONE (203) 294-2090

CERTIFIED LETTER

#Z 483 770 392

December 16, 1999

Scanned

Ms. Esther McNany SBA, Inc./Sprint PCS 125 Shaw Street New London, CT 06335

RE:

Special Permit #418-99

1605 Durham Road

Dear Ms. McNany:

Enclosed is a Legal Notice of Action taken by the Planning and Zoning Commission at their meeting held on December 13, 1999, on the above-referenced application.

Your application for:

A 165 ft. telecommunications tower

has been approved with the conditions listed on the enclosed Zoning Permit. A Special Permit is also enclosed.

A \$10.00 fee is required for the filing of each Special Permit on the Land Records. Please make your check payable to the "Town Clerk" and forward to this office. Also forward to this office two (2) copies of your final plans.

Should you have any questions regarding this matter, please contact this office.

Sincerely,

Thomas M. Talbot

Assistant Town Planner

Enclosures

TMT:ss



Town of Wallingford, Connecticut


#	418-99	
#	410-99	

ZONING PERMIT

DATE: December 16, 1999	*
SSUED TO:	
NAMESBA, Inc./Sprint PCS	
ADDRESS 125 Shaw Street - New London, G	CT 06335
SSUED FOR:165 ft. telecommunications tower	er
OCATION OF 1605 Durham Road	
CONDITIONS OF PERMIT:	
Comments of the Assistant Manager of the Elect	ric Division, dated 11/24/99.
2. *Posting of \$1,000.00 sedimentation and erosion	
Color of proposed facility to be battleship gr	ay
4. No landscaping required as per recommendation	of the Town Planner.
5. Telecommunications tower to be constructed to	support at least four (4) other cell
locations.	
7	
В	
9.	
10.	
11.	
12.	
ALL WORK CONNECTED WITH A SITE PLAN APPROVAL SHALL BE COMPLI	TIED WITHIN FIVE TEARS AFTER SAID APPROVAL.
	MALL THISEOPH PLANNING AND ZONTING MMISSION

* BUILDING PERMIT WILL NOT BE ISSUED UNTIL CONDITIONS ARE MET.

Exhibit B

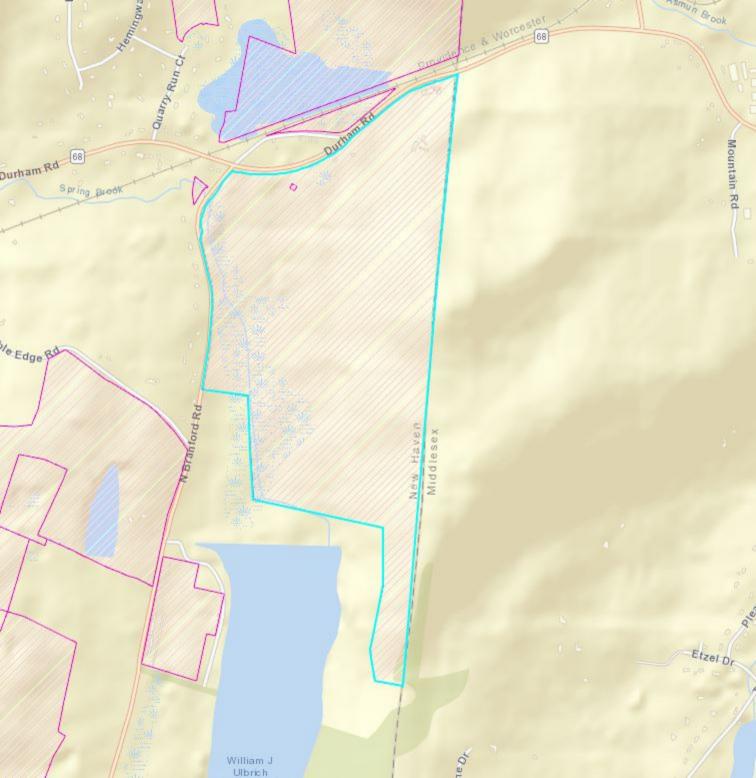

Dranarty	Location: 1	600 DURHAN	A RD		M	IAP ID: 98//3	11			Bldg N	lame:							e: 4100	
		OU DUNIAN	Acco	unt #2001050	00		Bld	lg#: 1 o	f 8	Sec #:	1 of	1 C	ard 1	l of	1	Prin	t Dat	e: 07/03/201	9 12:52
	D: 16164	MAKER	TOPO.	UTILI		STRT./ROAD		LOCATIO	N			CURRE	NT ASS	SESSME	VT		12		
THEON	CURRENT O	INC	2 Above Stree			Paved		ıburban		De	scription			praised Vo		Assessed Valu		(1	40
TILCON	VIINERALS	IIIC .	7 Swampy							ND LA		3-		1,504		1,053,	400 200	614 WALLING	
	FORD AVE		8 Ledge							IND BL	DG DD	3-3-3-		1,337	,600	936.	100	WALLING	FUKD, CI
PO BOX 3	310903	121 0002	o Leage	CI.	IPPI FMF	NTAL DATA				UTL LA		4-			,000	140.			
NEWING Additional	TON, CT 06	131-0903	Other ID:	203002010	I I DEMI	P/Z MAP#		All of the second		0 1 2 2.									
Additional	I O WHEIST		Census:	1760		ENG MAP#			12										
			Old MBLU			Easement			e 1								,	VITCI	ION
			TC MAP #			Town Line?	ILI		-				- 18		6			A TO	LOIN
			TC MAP#			IND PARKS			7										
			Record Lot GIS ID: 98/3			ASSOC PID#							Total	3,603		2,522			
	DECORD	OF OUNED		RK-VOI/P	IGE SAL	E DATE q/u	v/i S	ALE PRICE	E V.C.			PR	EVIOL	IS ASSES	SMEN	TS (HISTO			
TH CON	MINERALS	OF OWNERS	SHIF	507/608		07/30/1981	77 2		0	Yr. Co		ssessed Value	Yr.		Assesse		Yr. C		ssed Value
TILCON	MINERALS	INC		5077 000						2018 3	-1	1,053,	100 2017	3-1 3-2		1,053,400 2 393,200 2	016	3-1 3-2	1,053,400 393,200
											-2 -3		200 2017 100 2017			936,100 2	016	3-3	936,100
											-1		000 2017			140,000 2	016	4-1	140,000
				90.0						To	tal:	2,522,	700	Total:		2,522,700		otal:	2,522,700
ore legisles in		EXEMPT	IONS			OT	HER A	4SSESSMI	ENTS				signatu	re acknov	vledges	a visit by a	Data	Collector o	r Assessor
Year	Type Descr			Amount	Code D	escription		Number	An	iount	Comm.	Int.							
									İ			webst Book		ADDI	AICEI	VALUE S	TIMA	IARY	
												ESCHERA!		Mary Street of Hos	CALLED THE STATE OF	TALUES	U17117.	DIKI.	101 400
			T . 1		-									g. Value					181,400
NAME OF TAXABLE PARTY.	NAME OF TAXABLE	1611, 1721, 1831, 1	Total:	SSESSING N	EIGHBO	RHOOD								(B) Value					9,900
NDI	HD/SUB	NR.	HD Name		dex Name		acing			Batch		Appra	sed OB	(L) Valu	e (Bldg)			1,209,300
	13/A	IVD	IID Itanic	5557.1.				,				Appra	sed Lar	d Value (Bldg)				1,704,900
				N	OTES							Specia	Land Y	Value					(
COURT	JUDGEMEN	T 1/21/04		1	0120							-			Value				3,603,600
	CV-02-04648													ed Parcel	value				2,002,000
			P. P. DEDMIT									Valuat	ion Met	thod:					•
		PMENT BLDO																	
The contract of the contract o		E ASSESSED A										Adjust	ment:						
PERMIT	22849-NEW	TANKS & PU	MPS ASSESSED									Net To	tal Anr	raised P	arcel V	alue			3,603,600
AS PERS	SONAL PRO	PERTY										1100 10	- TAP					ODY	uen Zantan Eustan
er selftso				BUILDING	PERMIT	RECORD			a pactic							CHANGE I		DRY	se/Result
Permit	ID Issue	Date Type	Description		Amount	Insp. Date	% Con		Comp.	Commer		1- 00/1	Date 1/2015	<i>Type</i> 07		7 KC	<i>Cd.</i> 19	Man Correc	tion-No Valu
2284	9 06/17/	2008 CM	Commercial			04/08/2009	100 100		2009	storage Machin	tanks &	dations 01/0	4/2015 4/2011	07		DT	40	No change	
21442			Commercial Commercial		135,000 100,000		100		2005	New Ea	ninment	Room (105/2	0/2010	03		DT		Field Review	
19378 17813					26,200	09/28/2005	100	09/28/	2005	Truck S	cale/100	0 gal Ser 11/2	5/2009	03 02		TH DH		Measur+Lis	iteu ck - No Measi
1756		/2004 CM	Commercial		53,488	06/28/2004	100 100		/2004 /2004	New Blo	ig-Test L	ab 15x2 04/0 mpletion	8/2009	02			05	l ci mic one	
1756					18.900	06/28/2004 07/25/2003	100		/2003	Footing	s for Con	iveyor							
1662	1 06/11/	2003 CN	Commercial							ECTIO	N7	OFFICE LEADING			ACCEPTANCE.				
							LINE	VALUAT	ION SI	ST.	Vingeria			B) [043865[9]		SAG	li l		
B Use		Jse		II.	Un Pri		or SA	Acre Disc C. F			dj.	Notes- Adj		Specia	Pricing			j. Unit Price	
# Code	Description Description		One D Front Dep	0th Units 43,560			00 C		1.00	C50 0.	.75						.00	2.07	90,20 393,80
1 4100) SAND&GR) SAND&GR	AVL M96 R	U40	10.92	AC 120	.200.00 1.00	00 0	1.0000	0.40	C50 0.	.75						.00	36,060.00 4,000.00	1,020,90
1 4100	SAND&GR	AVL M96 R	U40	255.22	AC 10		00 0	1.0000 1.0000	0.40 1.00	0	.00 .00 3500	SO FT					.00	200,000.00	200,00
1 4310	TEL REL T	W M96 R	U40	1.00 3,500				1.0000	1.00	0	.00 CEL	L SITE ARI	CA				.00	0.00	
1 4310	TEL REL T	T AA TATAO		3,500	J.	2.00													
					e 5	- 1										27			- 4
	1.00						لـــلــ	200									Otal 1	Land Value:	1,704,90
			Total Card Land		TOO ACID-	rcel Total Land	A PAGE	75777 AC											

State Use: 4100 Bldg Name: MAP ID: 98//3// Property Location: 1600 DURHAM RD Print Date: 07/03/2019 12:52 Sec #: 1 of 1 Card 1 of 1 1 of 8 Account #20010500 Bldg #: Vision ID: 16164 CONSTRUCTION DETAIL (CONTINUED) CONSTRUCTION DETAIL Cd. Ch. Description Element Cd. Ch. Description Element BAS 414 Warehouse Style Ind/Comm Model 96 14 Grade 30 Stories BAS MIXED USE Occupancy Percentage Code Description Exterior Wall 1 Pre-finsh Metl 4100 SAND&GRAVL M96 100 Exterior Wall 2 Gable Roof Structure 03 Roof Cover 01 Metal/Tin Interior Wall 1 01 Minim/Masonry COST/MARKET VALUATION Interior Wall 2 38.49 Adj. Base Rate: 03 Concr-Finished Interior Floor 1 274,840 Interior Floor 2 0.00 Net Other Adi: Heating Fuel 02 Oil 274,840 Replace Cost 140 03 Hot Air-no Duc Heating Type AYB 1979 01 None AC Type Dep Code Remodel Rating 4100 SAND&GRAVL M96 Bldg Use Year Remodeled Total Rooms Dep % 00 Total Bedrms Functional Obslnc Total Baths External Obslnc Cost Trend Factor Condition Heat/Min Heat/AC % Complete Frame Type 05 Steel Overall % Cond 181,400 Baths/Plumbing 02 Average Apprais Val Ceil & Min WL Dep % Ovr Ceiling/Wall 04 Dep Ovr Comment Rooms/Prtns 02 Average Misc Imp Ovr 28 Wall Height Misc Imp Ovr Comment % Comn Wall Cost to Cure Ovr Cost to Cure Ovr Comment OB-OUTBUILDING & YARD ITEMS(L) / XF-BUILDING EXTRA FEATURES(B) Sub Sub Descript L/B Units Unit Price Yr Gde Dp Rt Cnd %Cnd Apr Value Code Description 1990 C 1969 C 4,800 30.00 50 50 50 50 50 FGR1 Garage-Avg 320 A 2,400 Paving-Conc 1,344 3.50 PAV2 218,100 RR Spur Scales-Elec 5,255 83.00 2009 C RR1 2009 C 216,000 450 960.00 SCL2 2009 C 96,000 Scales-Elec 200 960.00 SCL2 96,000 2009 C Scales-Elec 200 960.00 SCL2 576,000 1.200 960.00 2009 C SCL2 Scales-Elec 100 9,900 MEZ2 Mezz Finished 1.000 15.00 1981 **BUILDING SUB-AREA SUMMARY SECTION** Unit Cost Undeprec. Value Eff. Area Description Living Area Gross Area Code 38.49 274,840 7,140 7,140 7,140 First Floor BAS 274.840 7.140 7.140 Til Gross I iv/I ease Area. 7.140

Exhibit C

DURHAM/RT 68

ZONING/SITE ACQ.: DATE: **PROJECT MANAGER:** DATE: 1605 DURHAM ROAD **CONSTRUCTION:** DATE: **OPERATIONS:** DATE: WALLINGFORD, CT 06492 NEW HAVEN COUNTY **RF ENGINEERING: TOWER OWNER:** DATE: DATE:

SITE NO.: CT11287A

SITE TYPE: 162'± MONOPOLE

PROJECT TYPE: NATIONAL HARDENING PROJECT

DESCRIPTION

TITLE SHEET

GENERAL NOTES

GENERATOR DETAILS

COMPOUND & EQUIPMENT PLANS

GENERATOR SPECIFICATIONS 1

GENERATOR SPECIFICATIONS 2

ELECTRIC & GROUNDING DETAILS

| GN-1 |

A-2

-MOBILE TECHNICIAN SITE SAFETY NOTES

SPECIAL RESTRICTIONS **LOCATION** SECTOR A: ACCESS BY CERTIFIED CLIMBER SECTOR B: ACCESS BY CERTIFIED CLIMBER SECTOR C: ACCESS BY CERTIFIED CLIMBER SECTOR D: ACCESS BY CERTIFIED CLIMBER GPS/LMU: UNRESTRICTED RADIO CABINETS: UNRESTRICTED

PPC DISCONNECT: UNRESTRICTED MAIN CIRCUIT D/C: UNRESTRICTED NIU/T DEMARC: UNRESTRICTED OTHER/SPECIAL: NONE

GENERAL NOTES

APPROVALS

- LAWS, ORDINANCES, RULES, REGULATIONS AND LAWFUL ORDERS OF ANY PUBLIC AUTHORITY, MUNICIPAL AND UTILITY COMPANY SPECIFICATIONS, AND LOCAL AND STATE JURISDICTIONAL CODES BEARING ON THE PERFORMANCE OF THE WORK. THE WORK PERFORMED ON THE PROJECT AND THE MATERIALS INSTALLED SHALL BE IN STRICT ACCORDANCE WITH ALL APPLICABLE CODES, REGULATIONS, AND ORDINANCES.
- THE ARCHITECT/ENGINEER HAVE MADE EVERY EFFORT TO SET FORTH IN THE CONSTRUCTION AND CONTRACT DOCUMENTS THE COMPLETE SCOPE OF WORK. THE CONTRACTOR BIDDING THE JOB IS NEVERTHELESS CAUTIONED THAT MINOR OMISSIONS OR ERRORS IN THE DRAWINGS AND OR SPECIFICATIONS SHALL NOT EXCUSE SAID CONTRACTOR FROM COMPLETING THE PROJECT AND IMPROVEMENTS IN ACCORDANCE WITH THE INTENT OF THESE DOCUMENTS.
- THE CONTRACTOR OR BIDDER SHALL BEAR THE RESPONSIBILITY OF NOTIFYING (IN WRITING) THE OMNIPOINT REPRESENTATIVE OF ANY CONFLICTS, ERRORS, OR OMISSIONS PRIOR TO THE SUBMISSION OF CONTRACTOR'S PROPOSAL OR PERFORMANCE OF WORK. IN THE EVENT OF DISCREPANCIES THE CONTRACTOR SHALL PRICE THE MORE COSTLY OR EXTENSIVE WORK, UNLESS DIRECTED IN WRITING OTHERWISE.
- THE SCOPE OF WORK SHALL INCLUDE FURNISHING ALL MATERIALS, EQUIPMENT, LABOR AND ALL OTHER MATERIALS AND LABOR DEEMED NECESSARY TO COMPLETE THE WORK/PROJECT AS DESCRIBED
- THE CONTRACTOR SHALL VISIT THE JOB SITE PRIOR TO THE SUBMISSION OF BIDS OR PERFORMING WORK TO FAMILIARIZE HIMSELF WITH THE FIELD CONDITIONS AND TO VERIFY THAT THE PROJECT CAN BE CONSTRUCTED IN ACCORDANCE WITH THE CONTRACT DOCUMENTS.
- THE CONTRACTOR SHALL OBTAIN AUTHORIZATION TO PROCEED WITH CONSTRUCTION PRIOR TO STARTING WORK ON ANY ITEM NOT CLEARLY DEFINED BY THE CONSTRUCTION DRAWINGS/CONTRACT DOCUMENTS.
- THE CONTRACTOR SHALL INSTALL ALL EQUIPMENT AND MATERIALS ACCORDING TO THE MANUFACTURER'S/VENDOR'S SPECIFICATIONS UNLESS NOTED OTHERWISE OR WHERE LOCAL CODES OR ORDINANCES TAKE PRECEDENCE.
- THE CONTRACTOR SHALL PROVIDE A FULL SET OF CONSTRUCTION DOCUMENTS AT THE SITE UPDATED WITH THE LATEST REVISIONS AND ADDENDUMS OR CLARIFICATIONS AVAILABLE FOR THE USE BY ALL PERSONNEL INVOLVED WITH THE PROJECT.
- THE CONTRACTOR SHALL SUPERVISE AND DIRECT THE PROJECT DESCRIBED HEREIN. THE CONTRACTOR SHALL BE SOLELY RESPONSIBLE FOR ALL CONSTRUCTION MEANS, METHODS, TECHNIQUES, SEQUENCES AND PROCEDURES AND FOR COORDINATING ALL PORTIONS OF THE WORK UNDER THE CONTRACT.
- THE CONTRACTOR IS RESPONSIBLE FOR PROVIDING ALL NECESSARY CONSTRUCTION CONTROL SURVEYS, ESTABLISHING AND MAINTAINING ALL LINES AND GRADES REQUIRED TO CONSTRUCT ALL IMPROVEMENTS AS SHOWN HEREIN.
- THE CONTRACTOR SHALL BE RESPONSIBLE FOR OBTAINING ALL PERMITS AND INSPECTIONS WHICH MAY BE REQUIRED FOR THE WORK BY THE ARCHITECT/ENGINEER. THE STATE, COUNTY OR LOCAL GOVERNMENT AUTHORITY.
- THE CONTRACTOR SHALL MAKE NECESSARY PROVISIONS TO PROTECT EXISTING IMPROVEMENTS, EASEMENTS, PAVING, CURBING, ETC. DURING CONSTRUCTION. UPON COMPLETION OF WORK, THE CONTRACTOR

- 13. THE CONTRACTOR SHALL KEEP THE GENERAL WORK AREA CLEAN AND HAZARD FREE DURING CONSTRUCTION AND DISPOSE OF ALL DIRT, DEBRIS, RUBBISH AND REMOVE EQUIPMENT NOT SPECIFIED AS REMAINING ON THE PROPERTY. PREMISES SHALL BE LEFT IN CLEAN CONDITION AND FREE FROM PAINT SPOTS, DUST, OR SMUDGES OF
- 14. THE CONTRACTOR SHALL COMPLY WITH ALL OSHA REQUIREMENTS AS THEY APPLY TO THIS PROJECT.
- 15. THE CONTRACTOR SHALL NOTIFY THE PROJECT OWNER'S REPRESENTATIVE WHERE A CONFLICT OCCURS ON ANY OF THE CONTRACT DOCUMENTS. THE CONTRACTOR IS NOT TO ORDER MATERIAL OR CONSTRUCT ANY PORTION OF THE WORK THAT IS IN CONFLICT UNTIL CONFLICT IS RESOLVED BY THE LESSEE/LICENSEE
- 16. THE CONTRACTOR SHALL VERIFY ALL DIMENSIONS, ELEVATIONS, PROPERTY LINES, ETC. ON THE JOB.
- 17. ALL UNDERGROUND UTILITY INFORMATION WAS DETERMINED FROM SURFACE INVESTIGATIONS AND EXISTING PLANS OF RECORD. THE CONTRACTOR SHALL LOCATE ALL UNDERGROUND UTILITIES IN THE FIELD PRIOR TO ANY SITE WORK.

AT LEAST 72 HOURS PRIOR TO DIGGING, THE CONTRACTOR IS REQUIRED TO CALL DIG SAFE AT 811



VICINITY MAP

SCALE: 1" = 1000'-0"

DIRECTIONS

TURN LEFT ONTO S WASHINGTON ST. TURN RIGHT ONTO MA-123 E. TURN LEFT TO MERGE ONTO I-495 N TOWARD MANSFIELD/MARLBORO. MERGE ONTO I-495 N. TAKE EXIT 58 TOWARD I-90 W. KEEP LEFT AT THE FORK AND FOLLOW SIGNS FOR I-90 W/SPRINGFIELD/ALBANY AND MERGE ONTO I-90 W. USE THE RIGHT 2 LANES TO TAKE EXIT 78 TOWARD I-84. CONTINUE ONTO I-84. TAKE EXIT 57 ON THE LEFT FOR CT-15 S TOWARD I-91 S/CHARTER OAK BRIDGE/N.Y. CITY. CONTINUE ONTO CT-15 S. CONTINUE ONTO CT-15 S/US-5 S. TAKE EXIT 86 FOR I-91 S TOWARD NEW HAVEN/N.Y. CITY. TAKE EXIT 15 FOR CT-68 TOWARD DURHAM/YALESVILLE. USE THE LEFT 2 LANES TO TURN LEFT ONTO CT-68 E. SITE WILL BE ON THE RIGHT HAND SIDE.

PROJECT SUMMARY SHEET INDEX

REV.

NO.

SCOPE OF WORK

• 1 GENERATOR

THIS IS AN UNMANNED AND RESTRICTED ACCESS TELECOMMUNICATION FACILITY, AND IS NOT FOR HUMAN HABITATION. IT WILL BE USED FOR THE TRANSMISSION OF RADIO SIGNAL

CONTRACTOR SHALL VERIFY ALL PLANS, EXISTING DIMENSIONS, AND CONDITIONS ON JOB

SITE. CONTRACTOR SHALL IMMEDIATELY NOTIFY THE ARCHITECT/ENGINEER IN WRITING OF ANY DISCREPANCIES BEFORE PROCEEDING WITH THE WORK. FAILURE TO NOTIFY THE

ARCHITECT/ENGINEER PLACE THE RESPONSIBILITY ON THE CONTRACTOR TO CORRECT THE

STRUCTURAL CODE: TIA/EIA-222-G STRUCTURAL STANDARDS FOR ANTENNA SUPPORTING STRUCTURES AND ANTENNAS.

CT11287A

NEW CONSTRUCTION WILL CONFORM TO ALL APPLICABLE CODES AND ORDINANCES.

FOR THE PURPOSE OF PROVIDING PUBLIC CELLULAR SERVICE.

POTABLE WATER OR SANITARY SERVICE IS NOT REQUIRED.

BUILDING CODE: 2018 CONNECTICUT STATE BUILDING CODE

ELECTRICAL CODE: 2017 NATIONAL ELECTRICAL CODE

DISCREPANCIES AT THE CONTRACTOR'S EXPENSE.

NO OUTDOOR STORAGE OR ANY SOLID WASTE RECEPTACLES REQUIRED.

ADA COMPLIANCE NOT REQUIRED.

SITE NUMBER:

SITE CONTROL POINT:

• 2 20A-1P BREAKERS

1 AUTOMATIC TRANSFER SWITCH

REMOVE:

NONE

SITE NOTES

2	SBA SITE NUMBER:	CT01698-S
	SBA SITE NAME:	DURHAM
2	SITE ADDRESS:	1605 DURHAM ROAD WALLINGFORD, CT 06492
2	PROPERTY OWNER	SBA PROPERTIES, INC.
2	THOI EITH OWNER.	ATTN: TAX DEPARTMENT
2		8501 CONGRESS AVENUE BOCA RATON, FL 33487
2	TOWER OWNER:	SBA PROPERTIES, LLC 8501 CONGRESS AVENUE
2		BOCA RATON, FL 33487 PHONE: 561-226-9523
	COUNTY:	NEW HAVEN COUNTY
	ZONING DISTRICT:	I-40 (INDUSTRIAL DISTRICT)
	STRUCTURE TYPE:	MONOPOLE
	STRUCTURE HEIGHT:	162'±
	APPLICANT:	T-MOBILE NORTHEAST LLC 15 COMMERCE WAY, SUITE B NORTON, MA 02766
	ARCHITECT:	CHAPPELL ENGINEERING ASSOCIATES, LLC. 201 BOSTON POST ROAD WEST, SUITE 101 MARLBOROUGH, MA 01752
	STRUCTURAL ENGINEER:	CHAPPELL ENGINEERING ASSOCIATES, LLC. 201 BOSTON POST ROAD WEST, SUITE 101
	2 2 2 2 2	SBA SITE NUMBER: SBA SITE NAME: SITE ADDRESS: PROPERTY OWNER: TOWER OWNER: COUNTY: ZONING DISTRICT: STRUCTURE TYPE: STRUCTURE HEIGHT: APPLICANT: ARCHITECT:

DO NOT SCALE DRAWINGS

CONTRACTOR SHALL VERIFY ALL PLANS AND EXISTING DIMENSIONS AND CONDITIONS ON THE JOB SITE AND SHALL IMMEDIATELY NOTIFY THE PROJECT OWNER'S REPRESENTATIVE IN WRITING OF DISCREPANCIES BEFORE PROCEEDING WITH THE WORK OR BE RESPONSIBLE FOR SAME

SPECIAL ZONING NOTE BASED ON INFORMATION PROVIDED BY T-MOBILE REGULATORY COMPLIANCE PROFESSIONALS AND LEGAL COUNSEL, THIS TELECOMMUNICATIONS EQUIPMENT DEPLOYMENT IS CONSIDERED AN <u>ELIGIBLE FACILITY</u> UNDER THE MIDDLE CLASS TAX RELIEF AND JOB CREATION ACT OF 2012, 47 USC 1455(A), SECTION 6409(A), AND IS SUBJECT TO AN ELIGIBLE FACILITY REQUEST, EXPEDITED REVIEW, AND

LIMITED/PARTIAL ZONING PRE-EMPTION FOR LOCAL DISCRETIONARY PERMITS

(VARIANCE, SPECIAL PERMIT, SITE PLAN REVIEW, OR ADMINISTRATIVE REVIEW).

MARLBOROUGH, MA 01752

LATITUDE: N.41.469562° N.41°28'10.42"

LONGITUDE W.72.742225° W.72°44'32.01"

T-MOBILE NORTHEAST LLC


15 COMMERCE WAY, SUITE B NORTON, MA 02766 (508) 286-2700



SBA COMMUNICATIONS CORP.
134 FLANDERS ROAD, SUITE 125 WESTBOROUGH, MA 01581



R.K. EXECUTIVE CENTRE 201 BOSTON POST ROAD WEST, SUITE 101 MARLBOROUGH, MA 01752 (508) 481-7400 www.chappellengineering.com

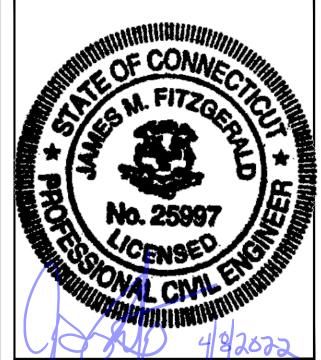

CHECKED BY:

APPROVED BY:

	SUBMITTALS				
REV.	DATE	DESCRIPTION	BY		
2		CONSTRUCTION REVISED	NWC		
1	03/29/22	ISSUED FOR CONSTRUCTION	NWC		

SITE NUMBER: CT11287A

0 | 03/28/22 ISSUED FOR REVIEW

SITE ADDRESS: 1605 DURHAM ROAD

WALLINGFORD, CT 06492

SHEET TITLE

TITLE SHEET

SHEET NUMBER

GENERAL NOTES:

- 1. FOR THE PURPOSE OF CONSTRUCTION DRAWINGS, THE FOLLOWING DEFINITIONS SHALL APPLY: CONTRACTOR - T-MOBILE SUBCONTRACTOR - GENERAL CONTRACTOR (CONSTRUCTION)
 - OWNER T-MOBILE OEM - ORIGINAL EQUIPMENT MANUFACTURER
- 2. PRIOR TO THE SUBMISSION OF BIDS, THE BIDDING SUBCONTRACTOR SHALL VISIT THE CELL SITE TO FAMILIARIZE WITH THE EXISTING CONDITIONS AND TO CONFIRM THAT THE WORK CAN BE ACCOMPLISHED AS SHOWN ON THE CONSTRUCTION DRAWINGS. ANY DISCREPANCY FOUND SHALL BE BROUGHT TO THE ATTENTION OF CONTRACTOR.
- 3. ALL MATERIALS FURNISHED AND INSTALLED SHALL BE IN STRICT ACCORDANCE WITH ALL APPLICABLE CODES, REGULATIONS, AND ORDINANCES. SUBCONTRACTOR SHALL ISSUE ALL APPROPRIATE NOTICES AND COMPLY WITH ALL LAWS, ORDINANCES, RULES, REGULATIONS, AND LAWFUL ORDERS OF ANY PUBLIC AUTHORITY REGARDING THE PERFORMANCE OF THE WORK.
- 4. ALL WORK CARRIED OUT SHALL COMPLY WITH ALL APPLICABLE MUNICIPAL AND UTILITY COMPANY SPECIFICATIONS AND LOCAL, STATE AND FEDERAL JURISDICTIONAL CODES, ORDINANCES AND APPLICABLE REGULATIONS.
- 5. DRAWINGS PROVIDED HERE ARE NOT TO BE SCALED AND ARE INTENDED TO SHOW OUTLINE ONLY.
- 6. UNLESS NOTED OTHERWISE, THE WORK SHALL INCLUDE FURNISHING MATERIALS, EQUIPMENT, APPURTENANCES, AND LABOR NECESSARY TO COMPLETE ALL INSTALLATIONS AS INDICATED ON THE DRAWINGS.
- 7. THE SUBCONTRACTOR SHALL INSTALL ALL EQUIPMENT AND MATERIALS IN ACCORDANCE WITH MANUFACTURER'S RECOMMENDATIONS UNLESS SPECIFICALLY STATED OTHERWISE.
- 8. IF THE SPECIFIED EQUIPMENT CANNOT BE INSTALLED AS SHOWN ON THESE DRAWINGS, THE SUBCONTRACTOR SHALL PROPOSE AN ALTERNATIVE INSTALLATION FOR APPROVAL BY THE CONTRACTOR.
- 9. SUBCONTRACTOR SHALL DETERMINE ACTUAL ROUTING OF CONDUIT, POWER, T1 CABLES AND GROUNDING CABLES AS SHOWN ON THE POWER, GROUNDING AND TELCO PLAN DRAWING. SUBCONTRACTOR SHALL UTILIZE EXISTING TRAYS AND/OR SHALL ADD NEW TRAYS AS NECESSARY, SUBCONTRACTOR SHALL CONFIRM THE ACTUAL ROUTING WITH THE CONTRACTOR AND/OR LANDLORD PRIOR TO CONSTRUCTION.
- 10. THE SUBCONTRACTOR SHALL PROTECT EXISTING IMPROVEMENTS, PAVEMENTS, CURBS, LANDSCAPING AND STRUCTURES. ANY DAMAGED PART SHALL BE REPAIRED AT SUBCONTRACTOR'S EXPENSE TO THE SATISFACTION OF THE OWNER.
- 11. SUBCONTRACTOR SHALL LEGALLY AND PROPERLY DISPOSE OF ALL SCRAP MATERIALS SUCH AS COAXIAL CABLES AND OTHER ITEMS REMOVED FROM THE EXISTING FACILITY.
- 12. SUBCONTRACTOR SHALL LEAVE PREMISES IN CLEAN CONDITION AND RETURN DISTURBED AREAS TO ORIGINAL CONDITIONS.
- 13. THE SUBCONTRACTOR SHALL SUPERVISE AND DIRECT THE PROJECT DESCRIBED HEREIN. THE SUBCONTRACTOR SHALL BE SOLELY RESPONSIBLE FOR ALL CONSTRUCTION MEANS, METHODS, TECHNIQUES, SEQUENCES, AND PROCEDURES FOR COORDINATING ALL PORTIONS OF THE WORK UNDER THE CONTRACT.
- 14. SUBCONTRACTOR SHALL NOTIFY CHAPPELL ENGINEERING ASSOCIATES, LLC 48 HOURS IN ADVANCE OF POURING CONCRETE OR BACKFILLING TRENCHES, SEALING ROOF AND WALL PENETRATIONS AND POST DOWNS, FINISHING NEW WALLS OR FINAL ELECTRICAL CONNECTIONS FOR ENGINEERING REVIEW.
- 15. CONSTRUCTION SHALL COMPLY WITH ALL T-MOBILE STANDARDS AND SPECIFICATIONS.
- 16. SUBCONTRACTOR SHALL VERIFY ALL EXISTING DIMENSIONS AND CONDITIONS PRIOR TO COMMENCING ANY WORK. ALL DIMENSIONS OF EXISTING CONSTRUCTION SHOWN ON THE DRAWINGS MUST BE VERIFIED. SUBCONTRACTOR SHALL NOTIFY THE CONTRACTOR OF ANY DISCREPANCIES PRIOR TO ORDERING MATERIAL OR PROCEEDING WITH CONSTRUCTION.
- 17. THE EXISTING CELL SITES ARE IN FULL COMMERCIAL OPERATION. ANY CONSTRUCTION WORK BY SUBCONTRACTOR SHALL NOT DISRUPT THE EXISTING NORMAL OPERATION. ANY WORK ON EXISTING EQUIPMENT MUST BE COORDINATED WITH CONTRACTOR. ALSO, WORK SHOULD BE SCHEDULED FOR AN APPROPRIATE MAINTENANCE WINDOW USUALLY IN LOW TRAFFIC PERIODS AFTER MIDNIGHT.
- 18. IF THE EXISTING CELL SITE IS ACTIVE, ALL SAFETY PRECAUTIONS MUST BE TAKEN WHEN WORKING AROUND HIGH LEVELS OF ELECTROMAGNETIC RADIATION. EQUIPMENT SHOULD BE SHUTDOWN PRIOR TO PERFORMING ANY WORK THAT COULD EXPOSE THE WORKERS TO DANGER. PERSONAL RF EXPOSURE MONITORS ARE TO BE WORN TO ALERT OF ANY DANGEROUS EXPOSURE LEVELS.

SITE WORK GENERAL NOTES:

- 1. THE SUBCONTRACTOR SHALL CONTACT UTILITY LOCATING SERVICES PRIOR TO THE START OF CONSTRUCTION.
- 2. ALL EXISTING ACTIVE SEWER, WATER, GAS, ELECTRIC, AND OTHER UTILITIES WHERE ENCOUNTERED IN THE WORK, SHALL BE PROTECTED AT ALL TIMES, AND WHERE REQUIRED FOR THE PROPER EXECUTION OF THE WORK, SHALL BE RELOCATED AS DIRECTED BY ENGINEERS. EXTREME CAUTION SHOULD BE USED BY THE SUBCONTRACTOR WHEN EXCAVATING OR DRILLING PIERS AROUND OR NEAR UTILITIES. SUBCONTRACTOR SHALL PROVIDE SAFETY TRAINING FOR THE WORKING CREW. THIS WILL INCLUDE BUT NOT BE LIMITED TO A) FALL PROTECTION B) CONFINED SPACE C) FLECTRICAL SAFETY D) TRENCHING AND EXCAVATION.
- 3. ALL SITE WORK SHALL BE AS INDICATED ON THE DRAWINGS AND PROJECT SPECIFICATIONS.
- 4. IF NECESSARY, RUBBISH, STUMPS, DEBRIS, STICKS, STONES AND OTHER REFUSE SHALL BE REMOVED FROM THE SITE AND DISPOSED OF LEGALLY.
- 5. THE SITE SHALL BE GRADED TO CAUSE SURFACE WATER TO FLOW AWAY FROM THE BTS EQUIPMENT AND TOWER AREAS.
- 6. NO FILL OR EMBANKMENT MATERIAL SHALL BE PLACED ON FROZEN GROUND. FROZEN MATERIALS, SNOW OR ICE SHALL NOT BE PLACED IN ANY FILL OR EMBANKMENT.
- 7. THE SUB GRADE SHALL BE COMPACTED AND BROUGHT TO A SMOOTH UNIFORM GRADE PRIOR TO FINISHED SURFACE APPLICATION.
- 8. ALL EXISTING INACTIVE SEWER, WATER, GAS, ELECTRIC AND OTHER UTILITIES, WHICH INTERFERE WITH THE EXECUTION OF THE WORK, SHALL BE REMOVED AND/OR CAPPED, PLUGGED OR OTHERWISE DISCONTINUED AT POINTS WHICH WILL NOT INTERFERE WITH THE EXECUTION OF THE WORK, SUBJECT TO THE APPROVAL OF ENGINEERING, OWNER AND/OR LOCAL UTILITIES.
- 9. THE AREAS OF THE OWNERS PROPERTY DISTURBED BY THE WORK AND NOT COVERED BY THE TOWER. EQUIPMENT OR DRIVEWAY, SHALL BE GRADED TO A UNIFORM SLOPE AND STABILIZED TO PREVENT EROSION AS SPECIFIED IN THE PROJECT SPECIFICATIONS.
- 10. SUBCONTRACTOR SHALL MINIMIZE DISTURBANCE TO EXISTING SITE DURING CONSTRUCTION. EROSION CONTROL MEASURES, IF REQUIRED DURING CONSTRUCTION, SHALL BE IN CONFORMANCE WITH THE LOCAL GUIDELINES FOR EROSION AND SEDIMENT CONTROL.
- 11. THE SUBCONTRACTOR SHALL PROVIDE SITE SIGNAGE IN ACCORDANCE WITH THE T-MOBILE SPECIFICATION FOR SITE SIGNAGE.

CONCRETE AND REINFORCING STEEL NOTES:

1. ALL CONCRETE WORK SHALL BE IN ACCORDANCE WITH THE ACI 301, ACI 318, ACI 336, ASTM A184, ASTM A185 AND THE DESIGN AND CONSTRUCTION SPECIFICATION FOR CAST-IN-PLACE CONCRETE.

2. ALL CONCRETE SHALL HAVE A MINIMUM COMPRESSIVE STRENGTH OF 3000 PSI AT 28 DAYS, UNLESS NOTED OTHERWISE. A HIGHER STRENGTH (400PSI) MAY BE USED. ALL CONCRETE WORK SHALL BE IN ACCORDANCE WITH THE ACI 381 CODE

3. REINFORCING STEEL SHALL CONFORM TO ASTM A 615, GRADE 60, DEFORMED UNLESS NOTED OTHERWISE. WELDED WIRE FABRIC SHALL CONFORM TO ASTM A 185 WELDED STEEL WIRE FABRIC UNLESS NOTED OTHERWISE. SPLICES SHALL BE CLASS "B" AND ALL HOOKS SHALL BE STANDARD, UNO.

4. THE FOLLOWING MINIMUM CONCRETE COVER SHALL BE PROVIDED FOR REINFORCING STEEL UNLESS SHOWN OTHERWISE ON DRAWINGS:

- CONCRETE CAST AGAINST EARTH.......3 IN. CONCRETE EXPOSED TO EARTH OR WEATHER:
- #6 AND LARGER2 IN. CONCRETE NOT EXPOSED TO EARTH OR WEATHER
- OR NOT CAST AGAINST THE GROUND:
- SLAB AND WALL BEAMS AND COLUMNS
- 5. A CHAMFER 34" SHALL BE PROVIDED AT ALL EXPOSED EDGES OF CONCRETE, UNO, IN ACCORDANCE WITH ACI 301 SECTION
- 6. INSTALLATION OF CONCRETE EXPANSION/WEDGE ANCHORS SHALL BE PER MANUFACTURER'S WRITTEN RECOMMENDED PROCEDURE. THE ANCHOR BOLT, DOWEL OR ROD SHALL CONFORM TO THE MANUFACTURERS RECOMMENDATION FOR EMBEDMENT DEPTH OR AS SHOWN ON THE DRAWINGS. NO REBAR SHALL BE CUT WITHOUT PRIOR CONTRACTOR APPROVAL WHEN DRILLING HOLES IN CONCRETE. SPECIAL INSPECTIONS, REQUIRED BY GOVERNING CODES, SHALL BE PERFORMED IN ORDER TO MAINTAIN MANUFACTURER'S MAXIMUM ALLOWABLE LOADS. ALL EXPANSION/WEDGE ANCHORS SHALL BE STAINLESS STEEL OR HOT DIPPED GALVANIZED. EXPANSION BOLTS SHALL BE PROVIDED BY SIMPSON OR APPROVED EQUAL.
- 7. CONCRETE CYLINDER TIES ARE NOT REQUIRED FOR SLAB ON GRADE WHEN CONCRETE IS LESS THAN 50 CUBIC YARDS (IBC1905.6.2.3) IN THAT EVENT THE FOLLOWING RECORDS SHALL BE PROVIDED BY THE CONCRETE SUPPLIER;
- (A) RESULTS OF CONCRETE CYLINDER TEST PERFORMED AT THE SUPPLIERS PLANT.
- (B) CERTIFICATION OF MINIMUM COMPRESSIVE STRENGTH FOR THE CONCRETE GRADE SUPPLIED. FOR GREATER THAN 50 CUBIC YARDS THE GC SHALL PERFORM THE CONCRETE CYLINDER TEST.
- 8. AS AN ALTERNATIVE TO ITEM 7. TEST CYLINDERS SHALL BE TAKEN INITIALLY AND THEREAFTER FOR EVERY 50 YARDS OF CONCRETE FROM EACH DIFFERENT BATCH PLANT.
- 9. EQUIPMENT SHALL NOT BE PLACED ON NEW PADS FOR SEVEN DAYS AFTER PAD IS POURED, UNLESS IT IS VERIFIED BY CYLINDER TESTS THAT COMPRESSIVE STRENGTH HAS BEEN ATTAINED.

STRUCTURAL STEEL NOTES:

1. ALL STEEL WORK SHALL BE PAINTED OR GALVANIZED IN ACCORDANCE WITH THE DRAWINGS AND T-MOBILE SPECIFICATIONS UNLESS OTHERWISE NOTED. STRUCTURAL STEEL SHALL BE ASTM-A-36 UNLESS OTHERWISE NOTED ON THE SITE SPECIFIC DRAWINGS. STEEL DESIGN, INSTALLATION AND BOLTING SHALL BE IN ACCORDANCE WITH THE AMERICAN INSTITUTE OF STEEL CONSTRUCTION (AISC) "MANUAL OF STEEL CONSTRUCTION".

- 2. ALL WELDING SHALL BE PERFORMED USING E70XX ELECTRODES AND WELDING SHALL CONFORM TO AISC AND AWS D1.1 WHERE FILLET WELD SIZES ARE NOT SHOWN, PROVIDE THE MINIMUM SIZE PER TABLE J2.4 IN THE AISC "MANUAL OF STEEL CONSTRUCTION", 9TH EDITION. PAINTED SURFACES SHALL BE TOUCHED UP.
- 3. BOLTED CONNECTIONS SHALL USE BEARING TYPE ASTM A325 BOLTS (3/4"0) AND SHALL HAVE MINIMUM OF TWO BOLTS UNLESS NOTED OTHERWISE. ALL BOLTS SHALL BE GALVANIZED OR STAINLESS STEEL.
- 4. NON-STRUCTURAL CONNECTIONS FOR STEEL GRATING MAY USE %" DIA. ASTM A 307 BOLTS (GALV) UNLESS NOTED OTHERWISE.
- 5. CONTRACTOR SHALL SUBMIT SHOP DRAWINGS FOR ENGINEER REVIEW & APPROVAL ON PROJECTS REQUIRING STRUCTURAL
- 6. ALL STRUCTURAL STEEL WORK SHALL BE DONE IN ACCORDANCE WITH AISC SPECIFICATIONS.

SOIL COMPACTION NOTES FOR SLAB ON GRADE:

- 1. EXCAVATE AS REQUIRED TO REMOVE VEGETATION AND TOPSOIL TO EXPOSE NATURAL SUBGRADE AND PLACE CRUSHED STONE AS REQUIRED.
- 2. COMPACTION CERTIFICATION: AN INSPECTION AND WRITTEN CERTIFICATION BY A QUALIFIED GEOTECHNICAL TECHNICIAN OR ENGINEER IS ACCEPTABLE.
- 3. AS AN ALTERNATE TO INSPECTION AND WRITTEN CERTIFICATION, THE "UNDISTURBED SOIL" BASE SHALL BE COMPACTED WITH "COMPACTION EQUIPMENT". LISTED BELOW, TO AT LEAST 90% MODIFIED PROCTOR MAXIMUM DENSITY PER ASTM D 1557 METHOD C.
- 4. COMPACTED SUBBASE SHALL BE UNIFORM AND LEVELED. PROVIDE 6" MINIMUM CRUSHED STONE OR GRAVEL COMPACTED IN 3" LIFTS ABOVE COMPACTED SOIL. GRAVEL SHALL BE NATURAL OR CRUSHED WITH 100% PASSING #1 SIEVE.
- 5. AS AN ALTERNATE TO ITEMS 2 AND 3, THE SUBGRADE SOILS WITH 5 PASSES OR A MEDIUM SIZED VIBRATORY PLATE COMPACTOR (SUCH AS BOMAG BPR 30/38) OR HAND-OPERATED SINGLE DRUM VIBRATORY ROLLER (SUCH AS BOMAG BW 55E). AND SOFT AREAS THAT ARE ENCOUNTERED SHOULD BE REMOVED AND REPLACED WITH A WELL-GRADED GRANULAR FILL AND COMPACTED AS STATED ABOVE.

COMPACTION EQUIPMENT:

1. HAND OPERATED DOUBLE DRUN, VIBRATORY ROLLER, VIBRATORY PLATE COMPACTOR OR JUMPING JACK COMPACTOR.

CONSTRUCTION NOTES:

1. FIELD VERIFICATION:

SUBCONTRACTOR SHALL FIELD VERIFY SCOPE OF WORK, T-MOBILE ANTENNA PLATFORM LOCATION AND UTILITY TRENCHWORK.

- 2. COORDINATION OF WORK:
- SUBCONTRACTOR SHALL COORDINATE RF WORK AND PROCEDURES WITH CONTRACTOR.

3. CABLE LADDER RACK:

SUBCONTRACTOR SHALL FURNISH AND INSTALL CABLE LADDER RACK, CABLE TRAY AND/OR ICE BRIDGE, AND CONDUIT AS REQUIRED TO SUPPORT CABLES TO THE NEW BTS LOCATION.

ELECTRICAL INSTALLATION NOTES:

1. WIRING, RACEWAY, AND SUPPORT METHODS AND MATERIALS SHALL COMPLY WITH THE REQUIREMENTS OF THE NEC AND TELCORDIA.

2. SUBCONTRACTOR SHALL MODIFY OR INSTALL CABLE TRAY SYSTEM AS REQUIRED TO SUPPORT RF AND TRANSPORT CABLING TO THE NEW BTS EQUIPMENT. SUBCONTRACTOR SHALL SUBMIT MODIFICATIONS TO CONTRACTOR FOR APPROVAL.

- 3. ALL CIRCUITS SHALL BE SEGREGATED AND MAINTAIN MINIMUM CABLE SEPARATION AS REQUIRED BY THE NEC AND
- 4. CABLES SHALL NOT BE ROUTED THROUGH LADDER-STYLE CABLE TRAY RUNGS.
- 5. EACH END OF EVERY POWER, GROUNDING, AND T1 CONDUCTOR AND CABLE SHALL BE LABELED WITH COLOR-CODED INSULATION OR ELECTRICAL TAPE (3M BRAND, 1/2 INCH PLASTIC ELECTRICAL TAPE WITH UV PROTECTION, OR EQUAL). THE IDENTIFICATION METHOD SHALL CONFORM WITH NEC AND OSHA, AND MATCH INSTALLATION REQUIREMENTS.
- 6. POWER PHASE CONDUCTORS (I.E., HOTS) SHALL BE LABELED WITH COLOR-CODED INSULATION OR ELECTRICAL TAPE (3M BRAND, ½ INCH PLASTIC ELECTRICAL TAPE WITH UV PROTECTION, OR EQUAL). PHASE CONDUCTOR COLOR CODES SHALL CONFORM WITH THE NEC AND OSHA.
- 7. ALL ELECTRICAL COMPONENTS SHALL BE CLEARLY LABELED WITH ENGRAVED LAMACOID PLASTIC LABELS. ALL EQUIPMENT SHALL BE LABELED WITH THEIR VOLTAGE RATING, PHASE CONFIGURATION, WIRE CONFIGURATION, POWER OR AMPACITY RATING, AND BRANCH CIRCUIT ID NUMBERS (I.E., PANELBOARD AND CIRCUIT ID'S).
- 8. PANELBOARDS (ID NUMBERS) AND INTERNAL CIRCUIT BREAKERS (CIRCUIT ID NUMBERS) SHALL BE CLEARLY LABELED WITH ENGRAVED LAMACOID PLASTIC LABELS.
- 9. ALL TIE WRAPS SHALL BE CUT FLUSH WITH APPROVED CUTTING TOOL TO REMOVE SHARP EDGES.

10. POWER, CONTROL, AND EQUIPMENT GROUND WIRING IN TUBING OR CONDUIT SHALL BE SINGLE CONDUCTOR (#34 AWG OR LARGER), 600 V, OIL RESISTANT THHN OR THWN-2, CLASS B STRANDED COPPER CABLE RATED FOR 90 °C (WET AND DRY) OPERATION; LISTED OR LABELED FOR THE LOCATION AND RACEWAY SYSTEM USED, UNLESS OTHERWISE

11. SUPPLEMENTAL EQUIPMENT GROUND WIRING LOCATED INDOORS SHALL BE SINGLE CONDUCTOR (#6 AWG OR LARGER), 600 V, OIL RESISTANT THHN OR THWN-2 GREEN INSULATION, CLASS B STRANDED COPPER CABLE RATED FOR 90 °C (WET AND DRY) OPERATION; LISTED OR LABELED FOR THE LOCATION AND RACEWAY SYSTEM USED, UNLESS OTHERWISE SPECIFIED.

12. SUPPLEMENTAL EQUIPMENT GROUND WIRING LOCATED OUTDOORS, OR BELOW GRADE, SHALL BE SINGLE CONDUCTOR #2 AWG SOLID TINNED COPPER CABLE, UNLESS OTHERWISE SPECIFIED.

13. POWER AND CONTROL WIRING, NOT IN TUBING OR CONDUIT, SHALL BE MULTI-CONDUCTOR, TYPE TC CABLE (#34 AWG OR LARGER), 600 V, OIL RESISTANT THHN OR THWN-2, CLASS B STRANDED COPPER CABLE RATED FOR 90 °C (WET AND DRY) OPERATION; WITH OUTER JACKET; LISTED OR LABELED FOR THE LOCATION USED, UNLESS OTHERWISE SPECIFIED.

14. ALL POWER AND GROUNDING CONNECTIONS SHALL BE CRIMP-STYLE, COMPRESSION WIRE LUGS AND WIRENUTS BY HARGER (OR EQUAL). LUGS AND WIRENUTS SHALL BE RATED FOR OPERATION AT NO LESS THAN 75°C (90°C IF AVAILABLE).

15. RACEWAY AND CABLE TRAY SHALL BE LISTED OR LABELED FOR ELECTRICAL USE IN ACCORDANCE WITH NEMA, UL, ANSI/IEEE AND NEC.

16. NEW RACEWAY OR CABLE TRAY WILL MATCH THE EXISTING INSTALLATION WHERE POSSIBLE.

17. ELECTRICAL METALLIC TUBING (EMT) OR RIGID NONMETALLIC CONDUIT (I.E., RIGID PVC SCHEDULE 40 OR RIGID PVC SCHEDULE 80 FOR LOCATIONS SUBJECT TO PHYSICAL DAMAGE) SHALL BE USED FOR EXPOSED INDOOR LOCATIONS.

18. ELECTRICAL METALLIC TUBING (EMT), ELECTRICAL NONMETALLIC TUBING (ENT), OR RIGID NONMETALLIC CONDUIT (RIGID PVC, SCHEDULE 40) SHALL BE USED FOR CONCEALED INDOOR LOCATIONS.

19. GALVANIZED STEEL INTERMEDIATE METALLIC CONDUIT (IMC) SHALL BE USED FOR OUTDOOR LOCATIONS ABOVE

20. RIGID NONMETALLIC CONDUIT (I.E., RIGID PVC SCHEDULE 40 OR RIGID PVC SCHEDULE 80) SHALL BE USED UNDERGROUND: DIRECT BURIED, IN AREAS OF OCCASIONAL LIGHT VEHICLE TRAFFIC OR ENCASED IN REINFORCED CONCRETE IN AREAS OF HEAVY VEHICLE TRAFFIC.

21. LIQUID-TIGHT FLEXIBLE METALLIC CONDUIT (LIQUID-TITE FLEX) SHALL BE USED INDOORS AND OUTDOORS. WHERE VIBRATION OCCURS OR FLEXIBILITY IS NEFDED.

22. CONDUIT AND TUBING FITTINGS SHALL BE THREADED OR COMPRESSION—TYPE AND APPROVED FOR THE LOCATION USED. SETSCREW FITTINGS ARE NOT ACCEPTABLE.

23. CABINETS. BOXES AND WIREWAYS SHALL BE LISTED OR LABELED FOR ELECTRICAL USE IN ACCORDANCE WITH NEMA.

UL, ANSI/IEEE AND NEC. 24. CABINETS. BOXES AND WIREWAYS TO MATCH THE EXISTING INSTALLATION WHERE POSSIBLE.

NOT BLOCKED.

25. WIREWAYS SHALL BE EPOXY—COATED (GRAY) AND INCLUDE A HINGED COVER, DESIGNED TO SWING OPEN DOWNWARD: SHALL BE PANDUIT TYPE E (OR EQUAL): AND RATED NEMA 1 (OR BETTER) INDOORS, OR NEMA 3R (OR BETTER) OUTDOORS.

26. EQUIPMENT CABINETS, TERMINAL BOXES, JUNCTION BOXES, AND PULL BOXES SHALL BE GALVANIZED OR EPOXY-COATED SHEET STEEL, SHALL MEET OR EXCEED UL 50, AND RATED NEMA 1 (OR BETTER) INDOORS, OR NEMA 3R (OR BETTER) OUTDOORS.

27. METAL RECEPTACLE, SWITCH, AND DEVICE BOXES SHALL BE GALVANIZED, EPOXY-COATED, OR NON-CORRODING; SHALL MEET OR EXCEED UL 514A AND NEMA OS 1; AND RATED NEMA 1 (OR BETTER) INDOORS, OR WEATHER PROTECTED (WP OR BETTER) OUTDOORS.

28. NONMETALLIC RECEPTACLE, SWITCH, AND DEVICE BOXES SHALL MEET OR EXCEED NEMA OS 2; AND RATED NEMA 1 (OR BETTER) INDOORS, OR WEATHER PROTECTED (WP OR BETTER) OUTDOORS.

29. THE SUBCONTRACTOR SHALL NOTIFY AND OBTAIN NECESSARY AUTHORIZATION FROM THE CONTRACTOR BEFORE COMMENCING WORK ON THE AC POWER DISTRIBUTION PANELS.

30. THE SUBCONTRACTOR SHALL PROVIDE NECESSARY TAGGING ON THE BREAKERS, CABLES AND DISTRIBUTION PANELS IN ACCORDANCE WITH THE APPLICABLE CODES AND STANDARDS TO SAFEGUARD AGAINST LIFE AND PROPERTY.

31. ALL ELECTRICAL WORK SHALL BE PERFORMED IN ACCORDANCE WITH THE PROJECT SPECIFICATIONS, NEC AND ALL APPLICABLE LOCAL CODES.

32. CONDUIT ROUTINGS ARE SCHEMATIC. SUBCONTRACTOR SHALL INSTALL CONDUITS SO THAT ACCESS TO EQUIPMENT IS

T-MOBILE NORTHEAST LLC


15 COMMERCE WAY, SUITE B NORTON, MA 02766 (508) 286-2700



SBA COMMUNICATIONS CORP. 134 FLANDERS ROAD, SUITE 125 WESTBOROUGH, MA 01581 (508) 251-0720



R.K. EXECUTIVE CENTRE 201 BOSTON POST ROAD WEST, SUITE 101 MARLBOROUGH, MA 01752 (508) 481-7400 www.chappellengineering.com

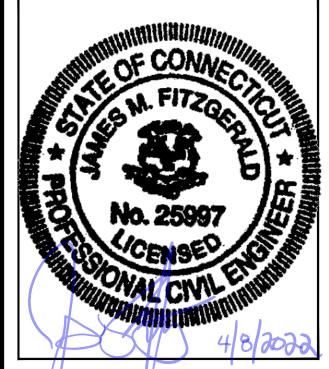

_			
	CHE	CKED BY:	JMT
	APF	PROVED BY:	JMT

	SUBMITTALS					
REV.	DATE	DESCRIPTION	BY			
2	04/08/22	CONSTRUCTION REVISED	NWC			
	03/29/22	ISSUED FOR CONSTRUCTION				

0 | 03/28/22 | ISSUED FOR REVIEW

SITE NUMBER: CT11287A


SITE ADDRESS: 1605 DURHAM ROAD WALLINGFORD, CT 06492


SHEET TITLE

GENERAL NOTES

SHEET NUMBER

GN-1

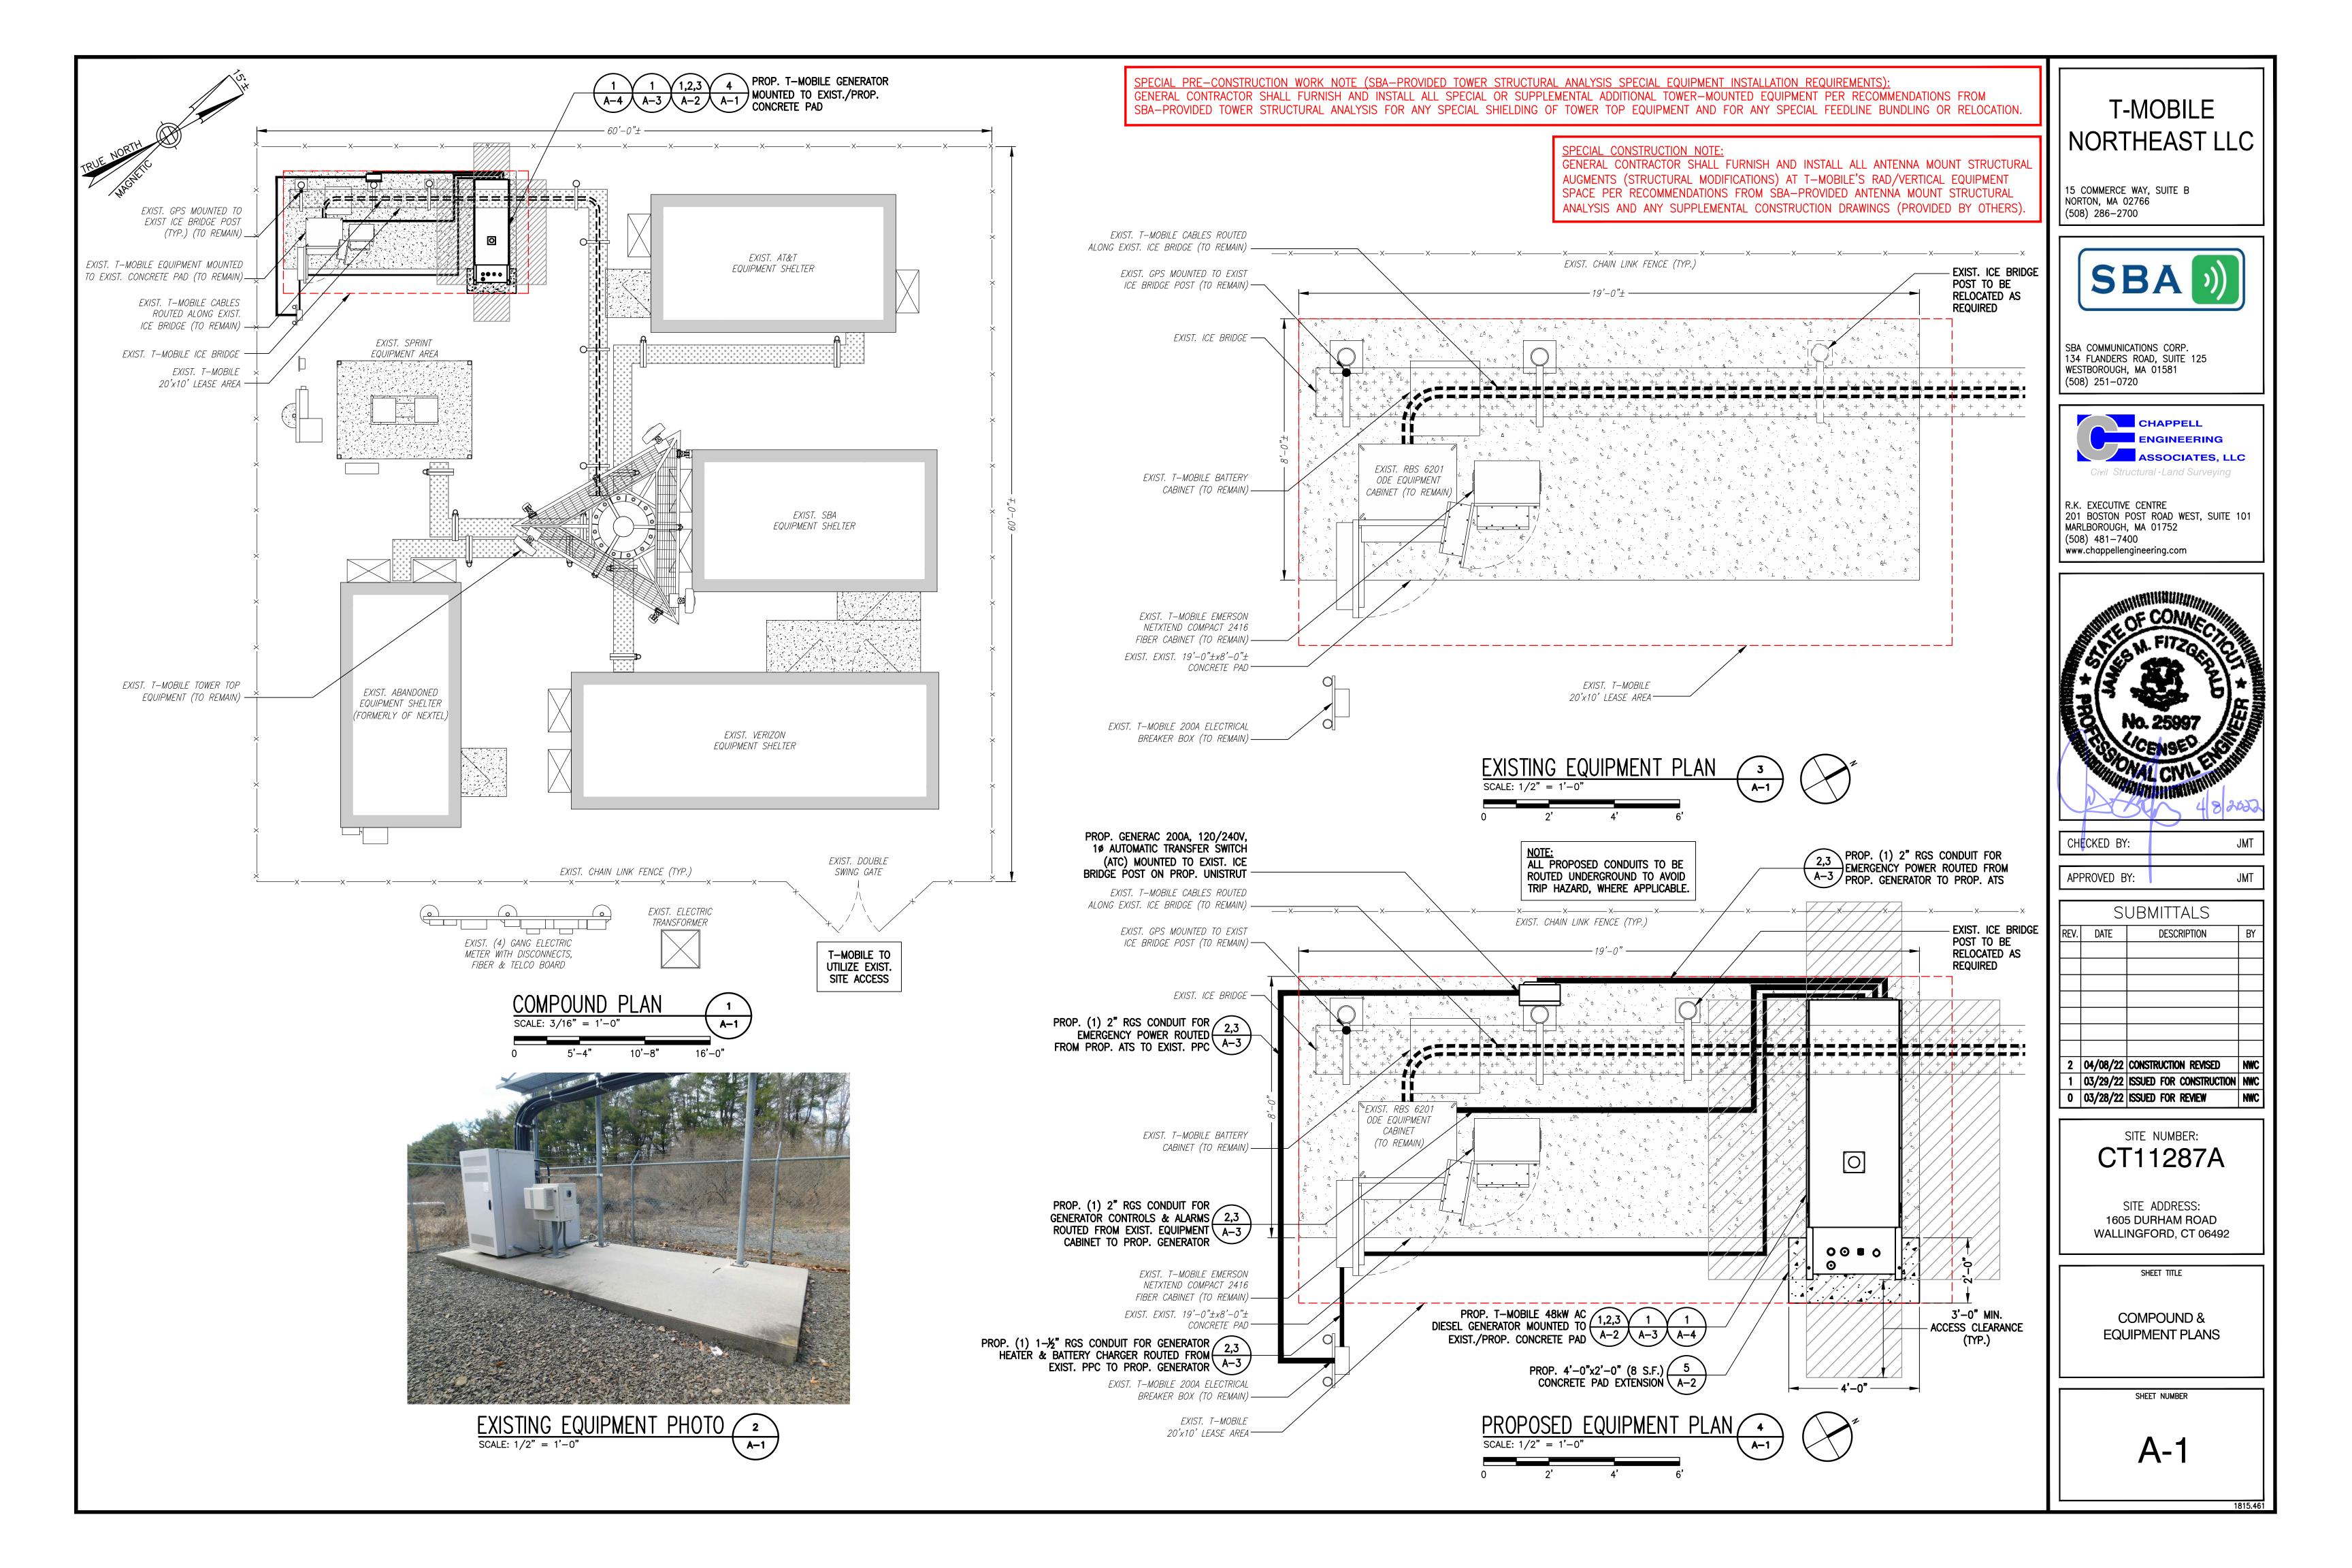

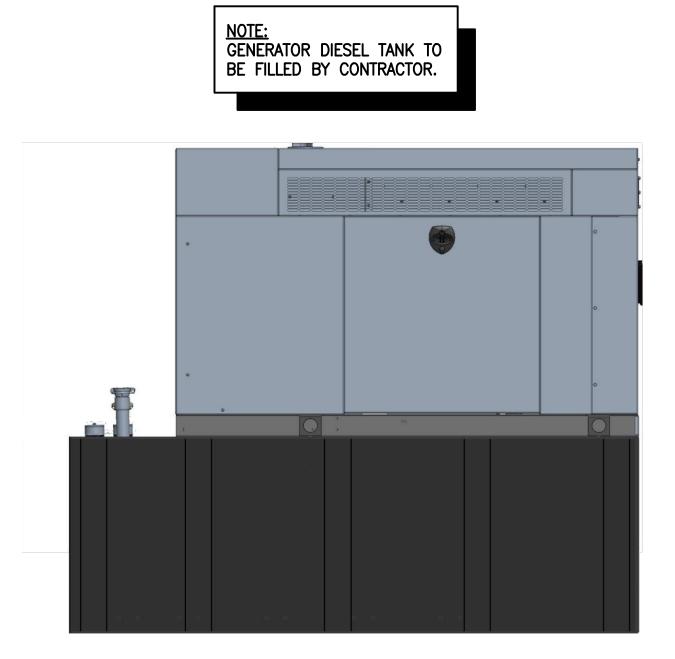


GENERAC RD048 48kW AC DIESEL GENERATOR

DIMENSIONS: 103.4"L x 35.0"W x 90.0"H WEIGHT: 2,954 lbs QUANTITY: TOTAL OF 1

GENERATOR DETAIL

SCALE: N.T.S.

1
A-2

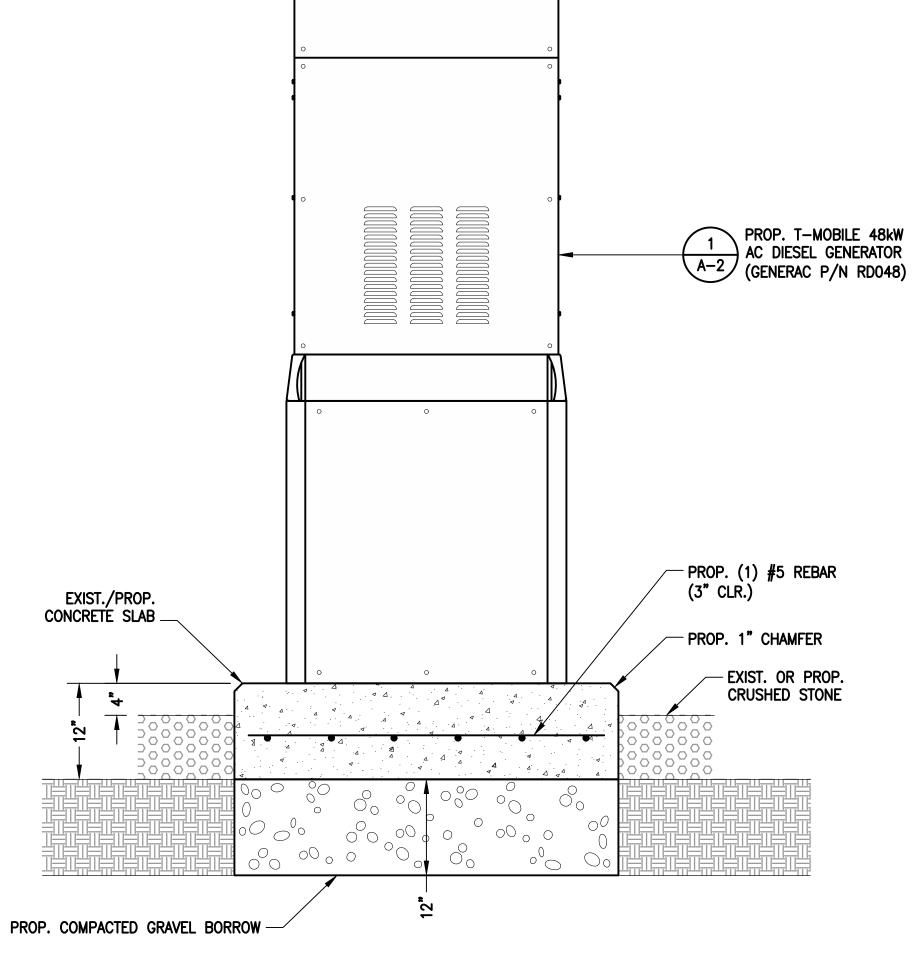




EXIST. 19'–0"±x8'–0"± CONCRETE PAD


> — DRILL EXIST. CONC. PAD FOR PROP. #5 REBAR DOWELS ◎ 1'-3" O.C. (6" MIN. EMBED.) (3" CLR.)

> > - PROP. (1) #5 REBAR (3" CLR.)

A-2

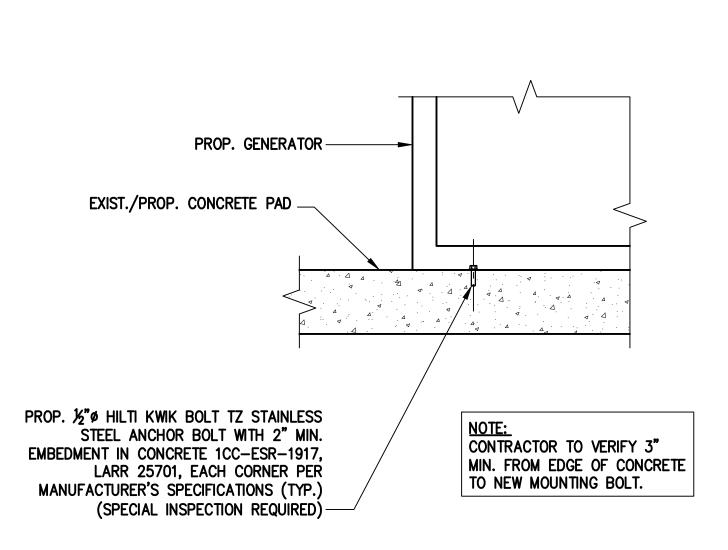




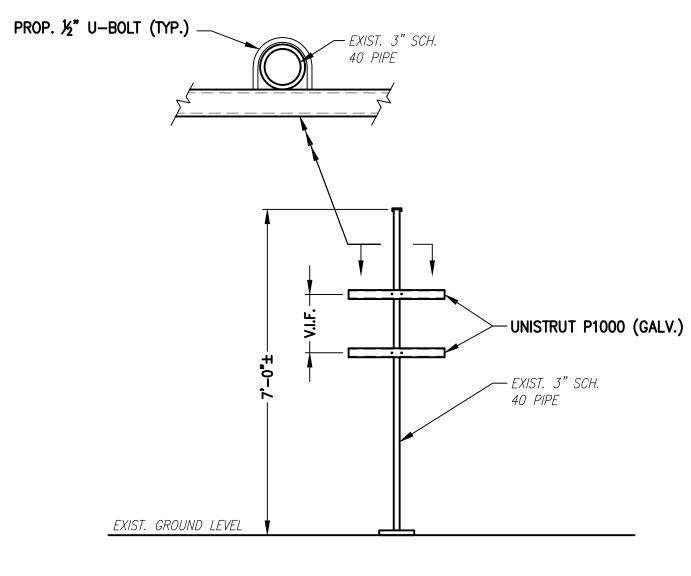

A-2

H-FRAME DETAIL

SCALE: N.T.S.

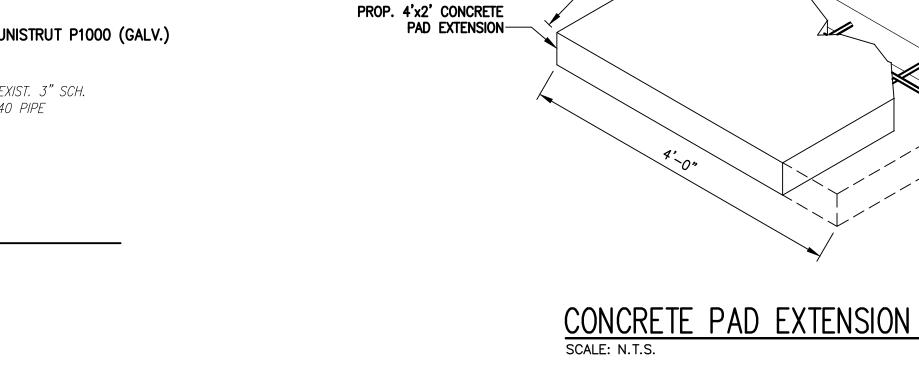






SBA COMMUNICATIONS CORP. 134 FLANDERS ROAD, SUITE 125 WESTBOROUGH, MA 01581 (508) 251-0720



R.K. EXECUTIVE CENTRE
201 BOSTON POST ROAD WEST, SUITE 101
MARLBOROUGH, MA 01752
(508) 481-7400
www.chappellengineering.com

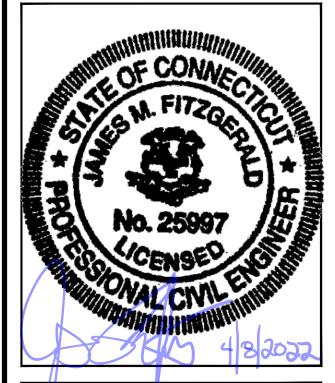

CHECKED BY:	JMT
V	
APPROVED BY:	JMT

_				
Ī		SI	UBMITTALS	
ŀ	REV.	DATE	DESCRIPTION	BY
ŀ				
ŀ				
ŀ				
ŀ				
İ	2		CONSTRUCTION REVISED	NWC
	1	03/29/22	ISSUED FOR CONSTRUCTION	NWC
Ī	0	03/28/22	ISSUED FOR REVIEW	NWC

SITE NUMBER: CT11287A

SITE ADDRESS: 1605 DURHAM ROAD WALLINGFORD, CT 06492


SHEET TITLE

GENERATOR DETAILS

SHEET NUMBER

A-2

815.461

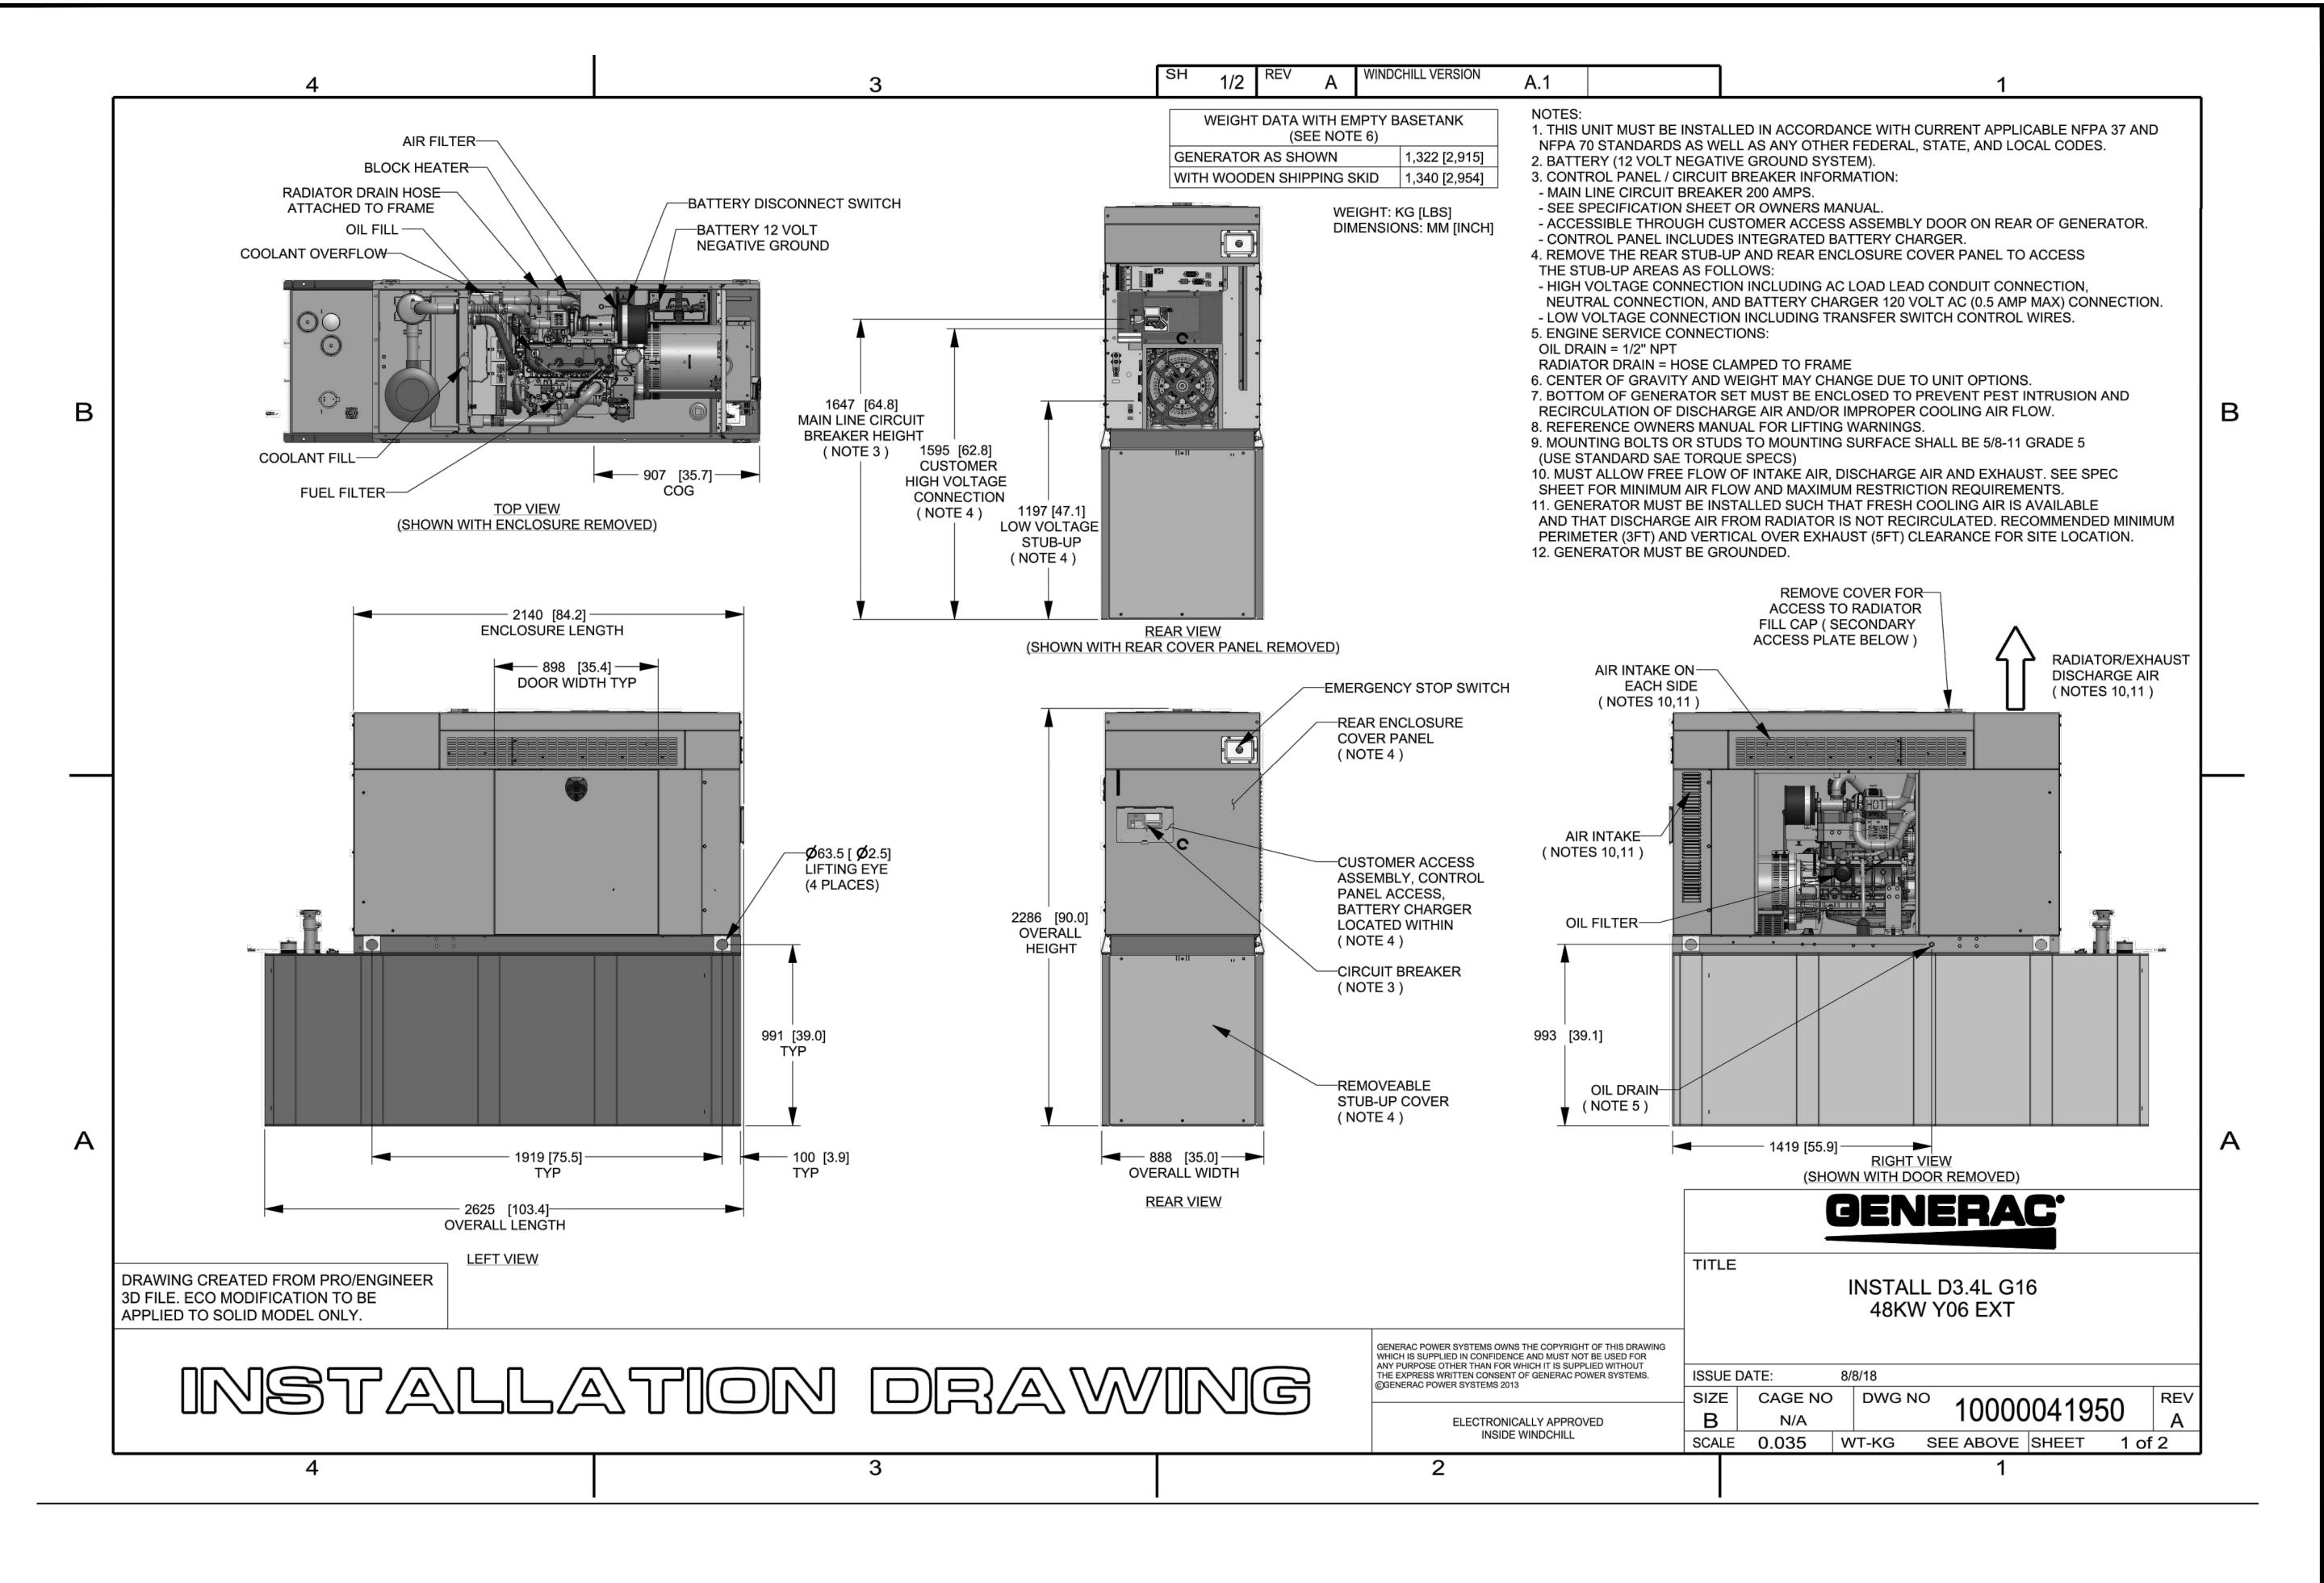

T-MOBILE NORTHEAST LLC


15 COMMERCE WAY, SUITE B NORTON, MA 02766 (508) 286-2700



SBA COMMUNICATIONS CORP. 134 FLANDERS ROAD, SUITE 125 WESTBOROUGH, MA 01581 (508) 251-0720



R.K. EXECUTIVE CENTRE
201 BOSTON POST ROAD WEST, SUITE 101
MARLBOROUGH, MA 01752
(508) 481-7400
www.chappellengineering.com

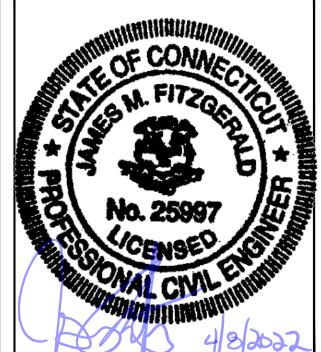

CHECKED BY: JMT

APPROVED BY: JMT

	SUBMITTALS				
REV.	DATE	DESCRIPTION	BY		
		2201			
	04 /00 /00				
2	04/08/22	CONSTRUCTION REVISED	NWC		
1	03/29/22	ISSUED FOR CONSTRUCTION	NWC		

SITE NUMBER: CT11287A

0 03/28/22 ISSUED FOR REVIEW

SITE ADDRESS: 1605 DURHAM ROAD WALLINGFORD, CT 06492

SHEET TITLE


GENERATOR
SPECIFICATIONS 1

SHEET NUMBER

A-3

GENERATOR SPECIFICATIONS



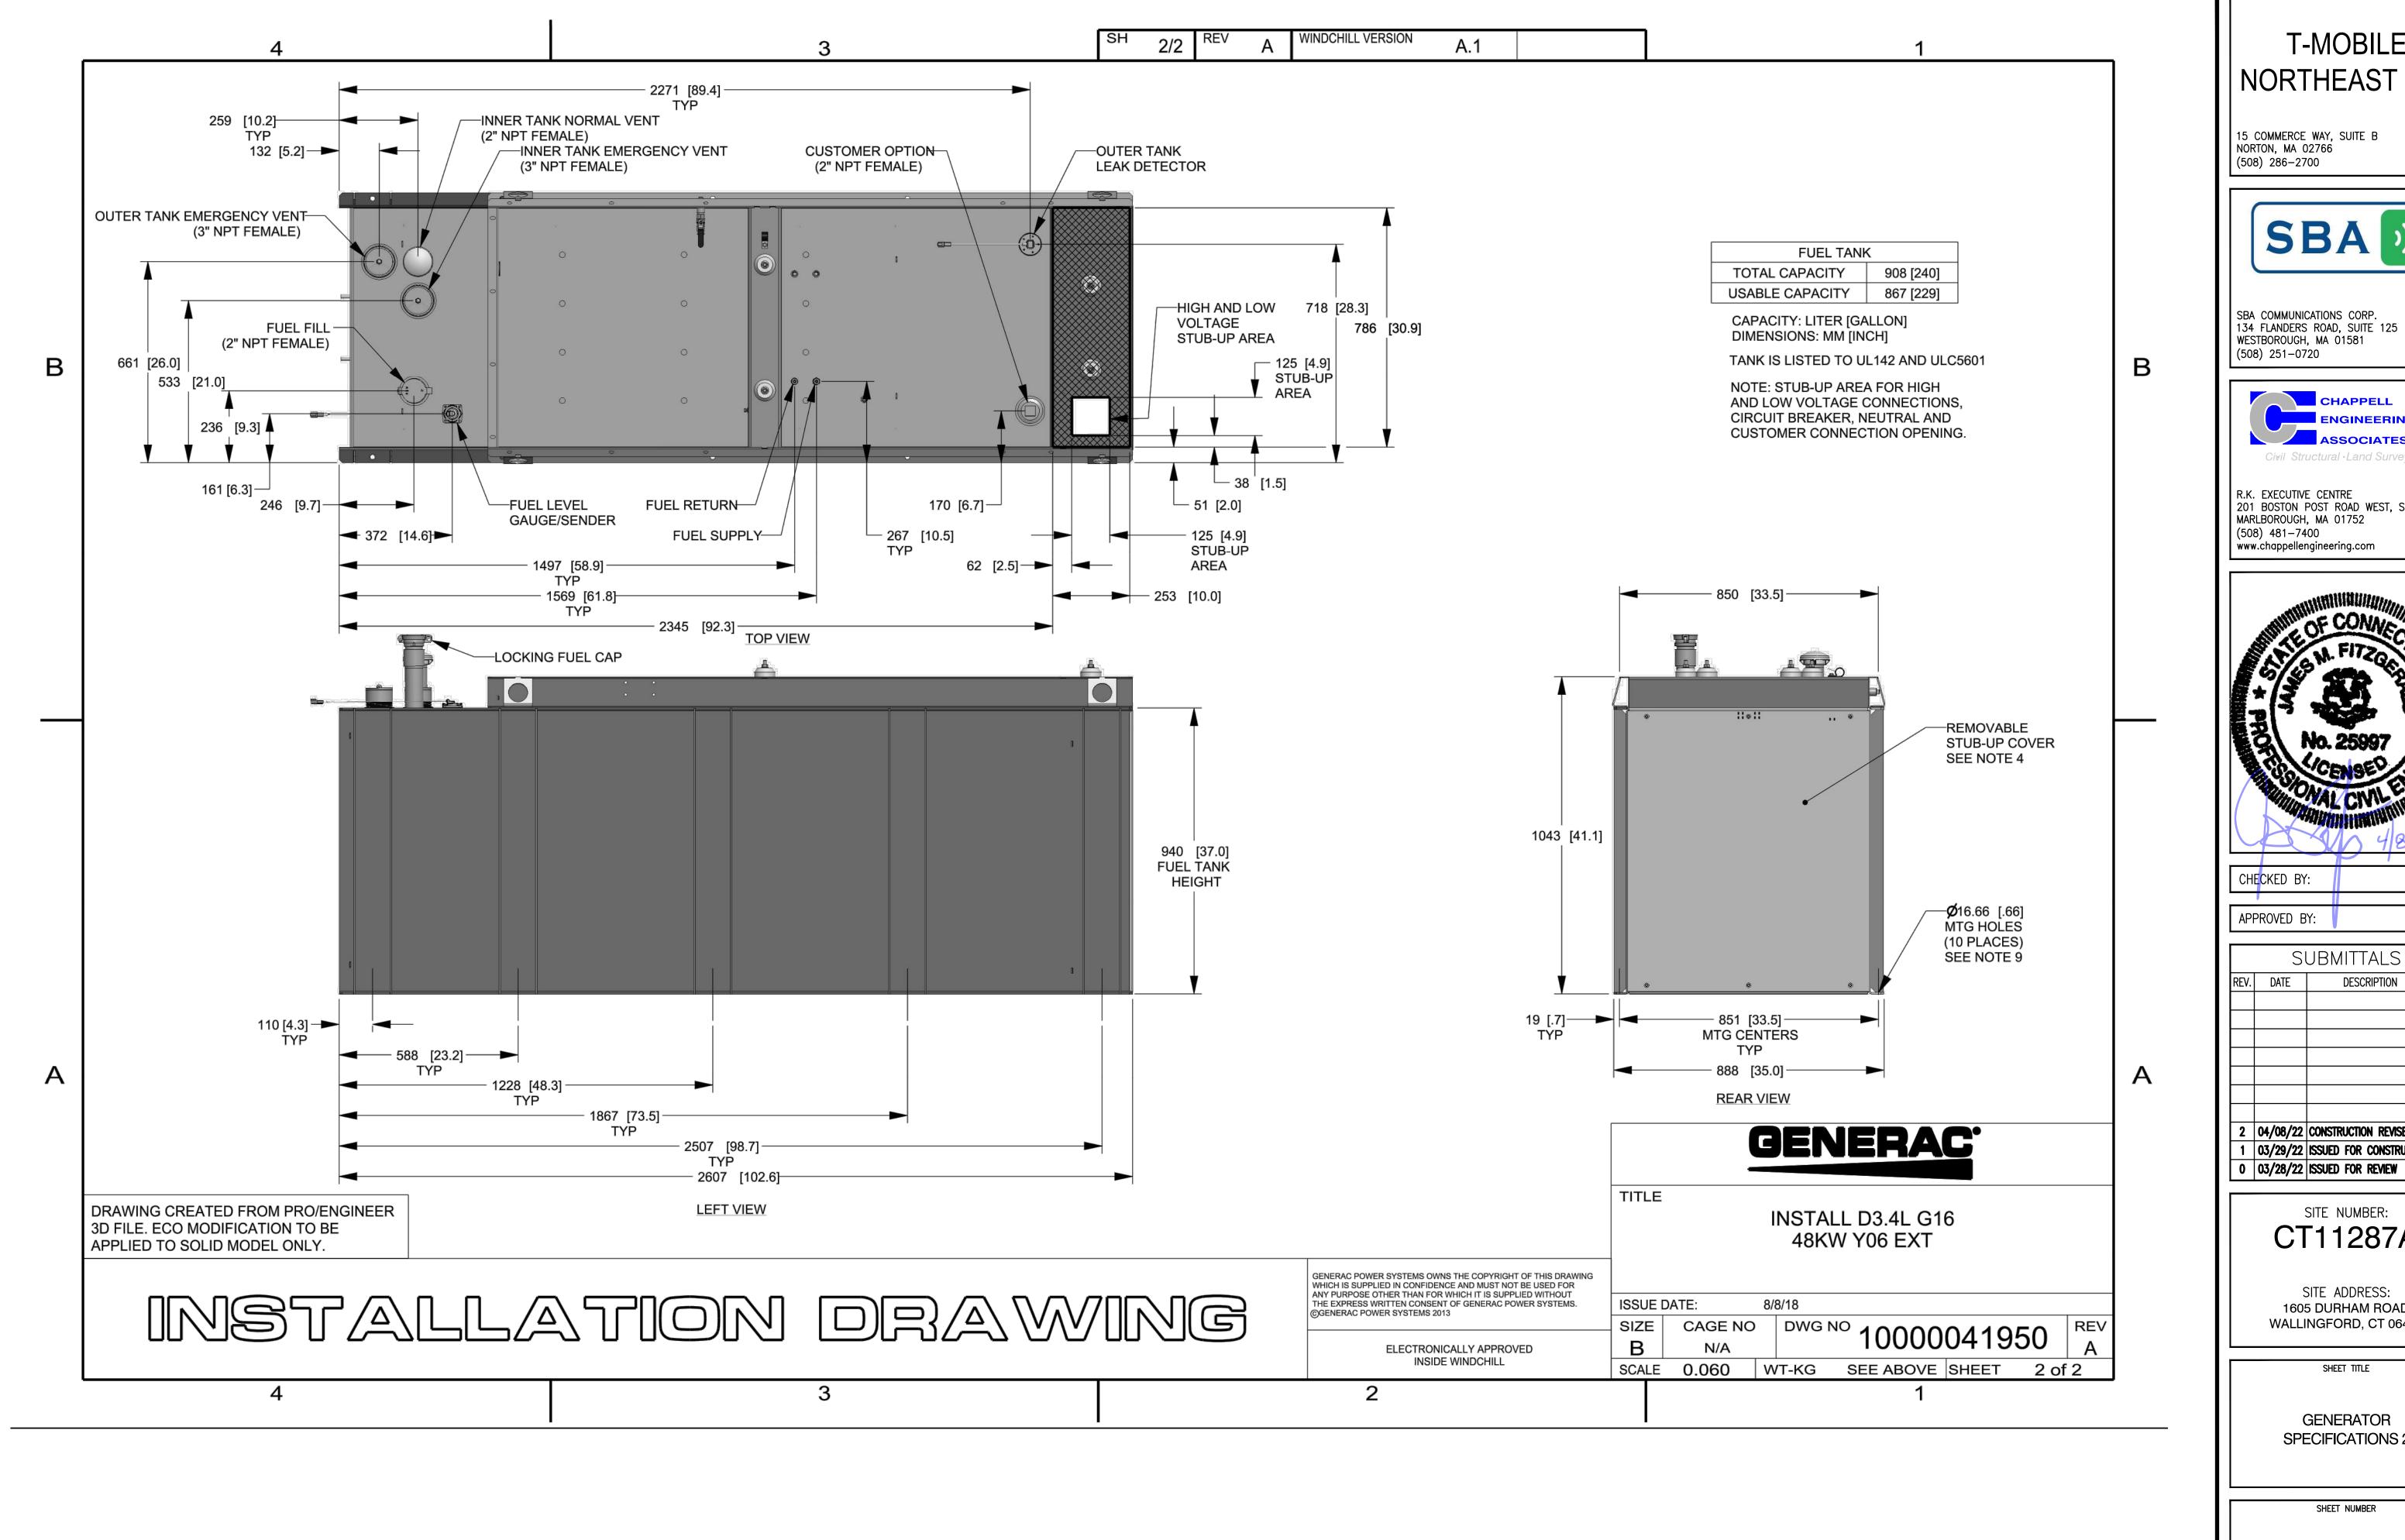

T-MOBILE NORTHEAST LLC


15 COMMERCE WAY, SUITE B NORTON, MA 02766



SBA COMMUNICATIONS CORP. 134 FLANDERS ROAD, SUITE 125 WESTBOROUGH, MA 01581



R.K. EXECUTIVE CENTRE 201 BOSTON POST ROAD WEST, SUITE 101 MARLBOROUGH, MA 01752 (508) 481-7400 www.chappellengineering.com

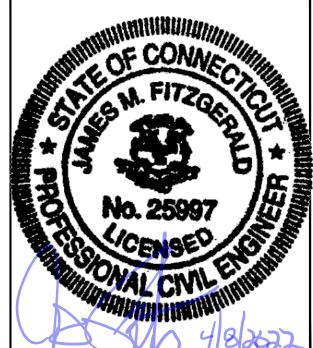

CHECKED BY: APPROVED BY:

	SUBMITTALS				
REV.	DATE	DESCRIPTION	BY		
2		CONSTRUCTION REVISED	NWC		
1	03/29/22	ISSUED FOR CONSTRUCTION	NWC		

SITE NUMBER: CT11287A

SITE ADDRESS: 1605 DURHAM ROAD WALLINGFORD, CT 06492

GENERATOR SPECIFICATIONS 2

SHEET NUMBER

A-4

GENERATOR SPECIFICATIONS
SCALE: N.T.S.








EXISTING POWER PANEL PHOTO

SCALE: NOT TO SCALE


E-1

NOTE:
CUT BACK (E) MAIN POWER CONDUIT, AS REQUIRED, & RECOONECT TO (P) ATS.

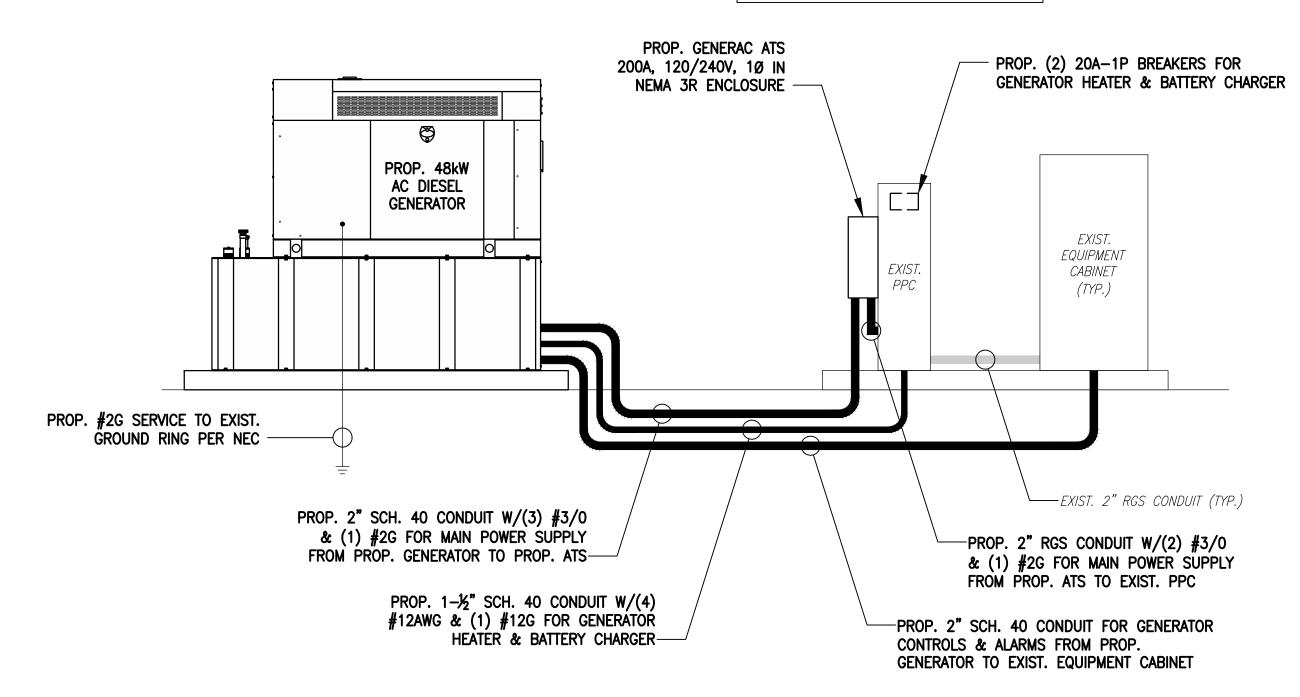

ONE-LINE POWER DIAGRAM
SCALE: NOT TO SCALE

E-1

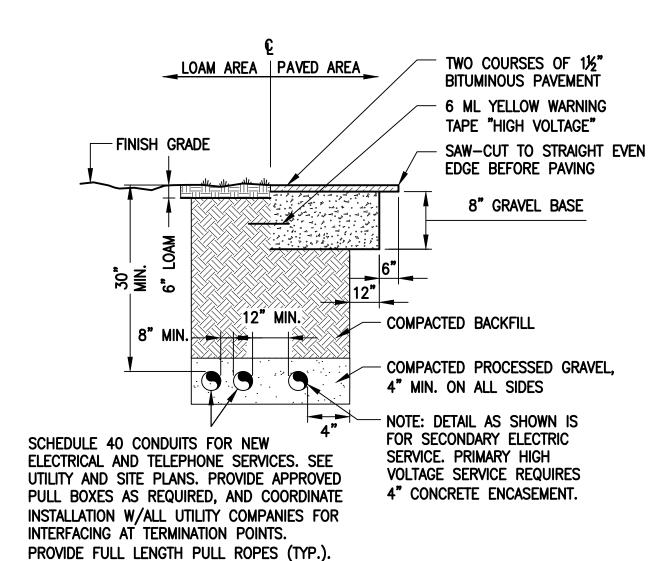


BURIED CONDUIT DETAIL


SCALE: NOT TO SCALE

SCALE: NOT TO SCALE

RIGID STEEL CONDUIT PLUG RIGID STEEL CONDUIT COUPLING GRADE RIGID STEEL TO PVC SCHEDULE 40 SIZE AS PVC ADAPTOR TYPICAL CONDUIT STUB—UP DETAIL SCALE: NONE RIGID STEEL CONDUIT STUB—UP DETAIL 4 E-1

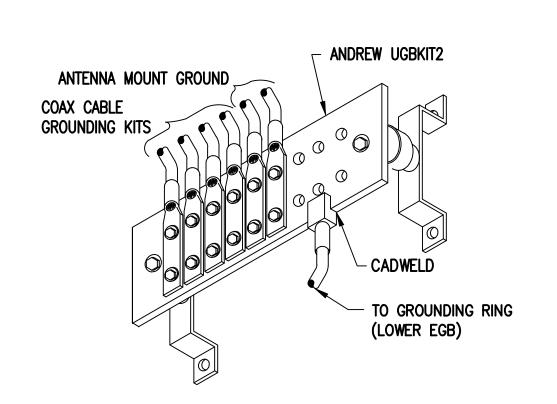



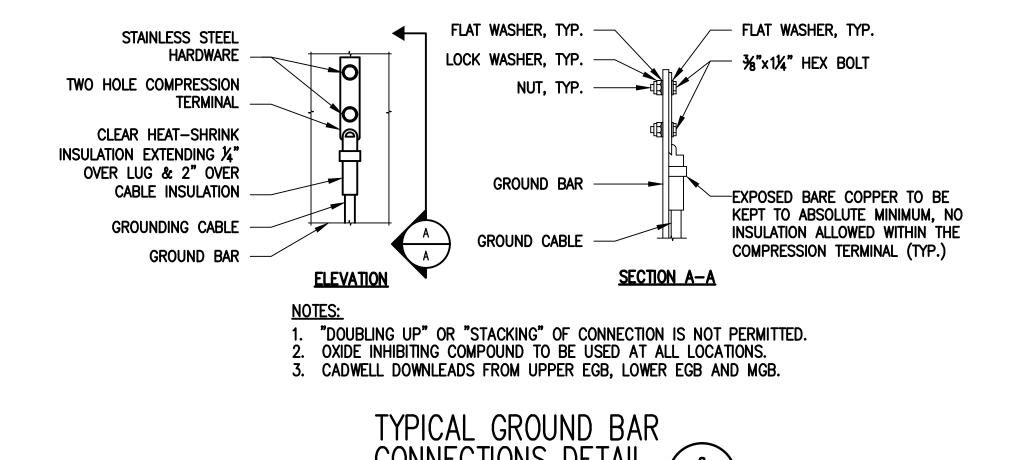

ELECTRICAL AND GROUNDING NOTES

- 1. ALL ELECTRICAL WORK SHALL CONFORM TO THE REQUIREMENTS OF THE NATIONAL ELECTRICAL CODE (NEC) AS WELL AS APPLICABLE STATE AND LOCAL CODES.
- 2. ALL ELECTRICAL ITEMS SHALL BE U.L. APPROVED OR LISTED AND PROCURED PER SPECIFICATION REQUIREMENTS.
- 3. THE ELECTRICAL WORK INCLUDES ALL LABOR AND MATERIAL DESCRIBED BY DRAWINGS AND SPECIFICATION INCLUDING INCIDENTAL WORK TO PROVIDE COMPLETE OPERATING AND APPROVED ELECTRICAL SYSTEM.
- 4. GENERAL CONTRACTOR SHALL PAY FEES FOR PERMITS, AND IS RESPONSIBLE FOR OBTAINING SAID PERMITS AND COORDINATION OF INSPECTIONS.
- 5. ELECTRICAL AND TELCO WIRING OUTSIDE A BUILDING AND EXPOSED TO WEATHER SHALL BE IN WATER TIGHT GALVANIZED RIGID STEEL CONDUITS OR SCHEDULE 80 PVC (AS PERMITTED BY CODE) AND WHERE REQUIRED IN LIQUID TIGHT FLEXIBLE METAL OR NONMETALLIC CONDUITS.
- 6. BURIED CONDUIT SHALL BE SCHEDULE 40 PVC.
- 7. ELECTRICAL WIRING SHALL BE COPPER WITH TYPE XHHW, THWN, OR THININSULATION.
- 8. RUN ELECTRICAL CONDUIT OR CABLE BETWEEN ELECTRICAL UTILITY DEMARCATION POINT AND PROJECT OWNER CELL SITE PPC AS INDICATED ON THIS DRAWING. PROVIDE FULL LENGTH PULL ROPE. COORDINATE INSTALLATION WITH UTILITY COMPANY.
- 9. RUN TELCO CONDUIT OR CABLE BETWEEN TELEPHONE UTILITY DEMARCATION POINT AND PROJECT OWNER CELL SITE TELCO CABINET AND BTS CABINET AS INDICATED ON THIS DRAWING PROVIDE FULL LENGTH PULL ROPE IN INSTALLED TELCO CONDUIT. PROVIDE GREENLEE CONDUIT MEASURING TAPE AT EACH END.
- 10. WHERE CONDUIT BETWEEN BTS AND PROJECT OWNER CELL SITE PPC AND BETWEEN BTS AND PROJECT OWNER CELL SITE TELCO SERVICE CABINET ARE UNDERGROUND USE PVC, SCHEDULE 40 CONDUIT. ABOVE THE GROUND PORTION OF THESE CONDUITS SHALL BE PVC CONDUIT.
- 11. ALL EQUIPMENT LOCATED OUTSIDE SHALL HAVE NEMA 3R ENCLOSURE.
- 12. PPC SUPPLIED BY PROJECT OWNER.
- 13. GROUNDING SHALL COMPLY WITH NEC ART. 250. ADDITIONALLY, GROUNDING, BONDING AND LIGHTNING PROTECTION SHALL BE DONE IN ACCORDANCE WITH "T-MOBILE BTS SITE GROUNDING STANDARDS".
- 14. GROUND COAXIAL CABLE SHIELDS MINIMUM AT BOTH ENDS USING MANUFACTURERS COAX CABLE GROUNDING KITS SUPPLIED BY PROJECT
- 15. USE #6 COPPER STRANDED WIRE WITH GREEN COLOR INSULATION FOR ABOVE GRADE GROUNDING (UNLESS OTHERWISE SPECIFIED) AND #2 SOLID TINNED BARE COPPER WIRE FOR BELOW GRADE GROUNDING AS INDICATED ON THE DRAWING.
- 16. ALL GROUND CONNECTIONS TO BE BURNDY HYGROUND COMPRESSION TYPE CONNECTORS OR CADWELD EXOTHERMIC WELD. DO NOT ALLOW BARE COPPER WIRE TO BE IN CONTACT WITH GALVANIZED STEEL.
- 17. ROUTE GROUNDING CONDUCTORS ALONG THE SHORTEST AND STRAIGHTEST PATH POSSIBLE, EXCEPT AS OTHERWISE INDICATED. GROUNDING LEADS SHOULD NEVER BE BENT AT RIGHT ANGLE. ALWAYS MAKE AT LEAST 12" RADIUS BENDS. #6 WIRE CAN BE BENT AT 6" RADIUS WHEN NECESSARY. BOND ANY METAL OBJECTS WITHIN 6 FEET OF PROJECT OWNER EQUIPMENT OR CABINET TO MASTER GROUND BAR OR GROUNDING
- 18. CONNECTIONS TO GROUND BARS SHALL BE MADE WITH TWO HOLE COMPRESSION TYPE COPPER LUGS. APPLY OXIDE INHIBITING COMPOUND TO
- ALL LOCATIONS.

 19. APPLY OXIDE INHIBITING COMPOUND TO ALL COMPRESSION TYPE GROUND CONNECTIONS.
- 20. CONTRACTOR SHALL PROVIDE AND INSTALL OMNI DIRECTIONAL ELECTRONIC MARKER SYSTEM (EMS) BALLS OVER EACH GROUND ROD AND BONDING POINT BETWEEN EXIST. TOWER/ MONOPOLE GROUNDING RING AND EQUIPMENT GROUNDING RING.
- 21. CONTRACTOR SHALL TEST COMPLETED GROUND SYSTEM AND RECORD RESULTS FOR PROJECT CLOSE—OUT DOCUMENTATION. 5 OHMNS MINIMUM
- 22. CONTRACTOR SHALL CONDUCT ANTENNA, COAX, AND LNA RETURN-LOSS AND DISTANCE- TO-FAULT MEASUREMENTS (SWEEP TESTS) AND RECORD RESULTS FOR PROJECT CLOSE OUT.

T-MOBILE NORTHEAST LLC


15 COMMERCE WAY, SUITE B NORTON, MA 02766 (508) 286-2700



SBA COMMUNICATIONS CORP.
134 FLANDERS ROAD, SUITE 125
WESTBOROUGH, MA 01581
(508) 251-0720



R.K. EXECUTIVE CENTRE
201 BOSTON POST ROAD WEST, SUITE 101
MARLBOROUGH, MA 01752
(508) 481-7400
www.chappellengineering.com

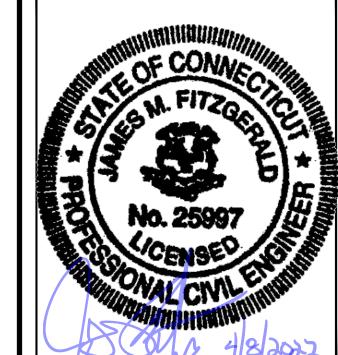

	19000
CHECKED BY:	JMT
APPROVED BY:	JMT

	SI	UBMITTALS	
REV.	DATE	DESCRIPTION	BY
2		CONSTRUCTION REVISED	NWC
1		ISSUED FOR CONSTRUCTION	NWC
0	03/28/22	ISSUED FOR REVIEW	NWC

SITE NUMBER: CT11287A

SITE ADDRESS: 1605 DURHAM ROAD WALLINGFORD, CT 06492

SHEET TITLE

ELECTRIC & GROUNDING DETAILS

SHEET NUMBER

E-

1815.4

Exhibit D

EPA Certified Stationary Emergency



Standby Power Rating 48 kW, 60 kVA, 60 Hz







Image used for illustration purposes only

Codes and Standards

Not all codes and standards apply to all configurations. Contact factory for details.



UL2200, UL508, UL489, UL142



CSA 22.2





BS5514 and DIN 6271



SAE J1349



NFPA 37, 70, 99



ISO 3046, 8528, 9001



NEMA ICS1, ICS10, MG1, 250, ICS6, AB1



an National Standards Institute ANSI/IEEE C62.41

Powering Ahead

For over 50 years, Generac has led the industry with innovative design and superior manufacturing.

Generac ensures superior quality by designing and manufacturing most of its generator components, including alternators, enclosures and base tanks, control systems and communications software.

Generac's gensets utilize a wide variety of options, configurations and arrangements, allowing us to meet the standby power needs of practically every application.

Generac searched globally to ensure the most reliable engines power our generators. We choose only engines that have already been proven in heavy-duty industrial application under adverse conditions.

Generac is committed to ensuring our customers' service support continues after their generator purchase.

RD048 | 3.4L | 48 kW

INDUSTRIAL DIESEL GENERATOR SET

EPA Certified Stationary Emergency

Standard Features

ENGINE SYSTEM

- Cold Weather Kit
- Oil Drain Extension
- Fan Guard
- Stainless Steel Flexible Exhaust Connection
- · Factory Filled Oil & Coolant

Fuel System

Primary Fuel Filter

Cooling System

- Closed Coolant Recovery System
- Factory-Installed Radiator
- 50/50 Ethylene Glycol Antifreeze
- Radiator Drain Extension
- Can Operate at up to 122°F (50°C) Ambient Temperature

Electrical System

- Battery Charging Alternator
- Battery Cables
- Battery Tray
- Rubber-Booted Engine Electrical Connections
- Solenoid Activated Starter Motor
- Smart Battery Charger

ALTERNATOR SYSTEM

- Class H Insulation Material
- 2/3 Pitch
- Skewed Stator
- Sealed Bearings
- Low Temperature Rise (<120°C)
- Low THD (<5%)

GENERATOR SET

GENERAC

Sound Attenuated Aluminum Enclosure

INDUSTRIAL

- Internal Genset Vibration Isolation
- · Separation of Circuits High/Low Voltage
- Wrapped Exhaust Piping
- Standard Factory Testing
- 5 Year Limited Warranty
- Ready to Accept Full Load in <10 Seconds
- E-Stop

TANKS

- 48 Hour Run Time Tank
- UL 142 Listed Tank

CONTROL SYSTEM



Evolution ™ Controller

- Two-Line Plain Text LCD Display
- Programmable Start Delay Between 10-30 seconds
- 10 second Engine Start Sequence
- 5 second Engine Warm Up
- 1 minute Engine Cool-Down
- Starter Lock-Out
- Smart Battery Charger
- Automatic Voltage Regulation with Over and Under Protection
- Automatic Low Oil Pressure Shutdown
- Overspeed Shutdown
- High Temperature Shutdown

- Overcrank Protection
- · Safety Fused
- · Failure to Transfer Protection
- Low Battery Protection
- 50 Even Run Log
- Future Set Capable Exerciser
- Incorrect Wiring Protection
- Internal Fault Protection
- Common External Fault Capability
- · Governor Failure Protection

Optional Shipped Loose and Field Install Kits

GENERATOR SET

- O Paint Kit
- O Scheduled Maintance Kit

CONTROL SYSTEM

○ Mobile Link TM and Adapter Kit

TANKS

- O Spill Box
- O 90% Fuel Alarm
- Tank Risers
- O Spill Box Drainback Kit
- Vent Extension Support Kit
- 5 Day Run Time Tank
- Overfill Prevention Valve
- O Fuel Fill Drop Tube
- Lockable Fuel Cap

RD048 | 3.4L | 48 kW

INDUSTRIAL DIESEL GENERATOR SET

EPA Certified Stationary Emergency



APPLICATION AND ENGINEERING DATA

ENGINE SPECIFICATIONS

General

Make	Generac
Cylinder #	4
Туре	In-Line
Displacement - in ³ (L)	3.4 (207.48)
Bore - in (mm)	3.86 (98)
Stroke - in (mm)	4.45 (113)
Compression Ratio	18.5:1
Intake Air Method	Turbocharged/Aftercooled

Cast Iron OHV

Aluminum

Engine Governing

Cylinder Head

Piston Type

Governor	Electronic
Frequency Regulation (Steady State)	±0.25%

Lubrication System

Oil Pump Type	Gear
Oil Filter Type	Full Flow Spin-On Canister
Crankcase Capacity with Filters- qt (L)	7.4 (7.0)

Cooling System

Cooling System Type	Closed Recovery
Fan Type	Pusher
Fan Speed- rpm	2,029
Fan Diameter - in (mm)	22 (559)

Fuel System

Fuel Type	Ultra Low Sulfur Diesel Fuel
Fuel Specification	ASTM
Fuel Pump Type	Mechanical Engine Driven Gear
Injector Type	Mechanical
Fuel Supply Lin (mm/in)	7.94/0.31 (ID)
Fuel Return Line (mm/in)	7.94/0.31 (ID)
Fuel Filtering (microns)	25

Engine Electrical System

System Voltage	12 VDC
Battery Charger Alternator	Standard
Battery Size	Group 27F
Battery Voltage	12 VDC
Ground Polarity	Negative

ALTERNATOR SPECIFICATIONS

Standard Model	Generac
Poles	4
Field Type	Rotating
Insulation Class - Rotor	Н
Insulation Class - Stator	Н
Total Harmonic Distortion	<5%
Telephone Interference Factor (TIF)	<50

Standard Excitation	Direct
Bearings	Single Sealed
Coupling	Flexible Disc
Prototype Short Circuit Test	Yes
Voltage Regulator Type	Full Digital
Number of Sensed Phases	2
Regulation Accuracy (Steady State)	±1.0%

RD048 | 3.4L | 48 kW

INDUSTRIAL DIESEL GENERATOR SET

EPA Certified Stationary Emergency



OPERATING DATA

POWER RATINGS

Standby

Single-Phase 120/480 VAC @0.1pf

48 kW

Amps: 200

MOTOR STARTING CAPABILITIES (SKVA)

sKVA vs. Voltage Dip at 30%

120/240 V, Single-Phase at 0.4pf	189
----------------------------------	-----

FUEL CONSUMPTION RATES*

Percent Load	Diesel gal/hr (L/hr)
25%	1.35 (5.11)
50%	2.15 (8.14)
75%	3.06 (11.58)
100%	3.98 (15.07)

^{*} Fuel supply installation must accommodate fuel consumption rates at 100% load.

COOLING

		Standby
Air Flow (Radiator and Alternator)	ft³/min (m³/min)	2824 (80)
Coolant System Capacity	gal (L)	2.8 (10.6)
Heat Rejection to Coolant	BTU/hr (MJ/hr)	135,900 (143.4)
Temperature Deration	3% for every 5°C above 25°C or 1	.7% for every 5°F over 77°F
Altitude Deration	1% for every 100 m above 915 or 3% fo	r every 1000 ft over 3000 ft
Maximum Radiator Backpressure	in H ₂ O (kPa)	0.50 (0.12)

COMBUSTION AIR REQUIREMENTS

	Standby
Flow at Rated Power ft ³ /min (m ³ /min)	190 (5.38)


ENGINE			EXHAUST		
		Standby			Standby
Rated Engine Speed	rpm	1,800	Exhaust Flow (Rated Output)	ft³/min (m³/min)	448 (12.7)
Horsepower at rated kW	HP	85	Exhaust Temp (Rated Output - Post Silencer)	°F (°C)	1120 (604.4)

Deration – Operational characteristics consider maximum ambient conditions. Derate factors may apply under atypical site conditions.

Please consult a Generac Power Systems Industrial Dealer for additional details. All performance ratings in accordance with ISO3046, BS5514, ISO8528 and DIN6271 standards. Standby - See Bulletin 0187500SSB



DIMENSIONS AND WEIGHTS*

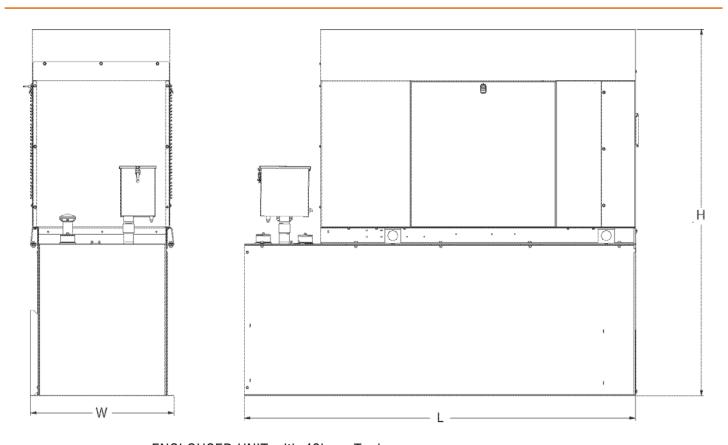

ENCLOUSED UNIT with 48hour Tank


L x W x H in (mm)	95.4 (2,422) x 35.0 (880) x 89.3 (2,269)
Sound output in dB(A) at 23ft with generator operating at normal Load	65

* All measurements are approximate and for estimation purposes only.

YOUR FACTORY RECOGNIZED GENERAC INDUSTRIAL DEALER					

Specification characteristics may change without notice. Dimensions and weights are for preliminary purposes only. Please consult a Generac Power Systems Industrial Dealer for detailed installation drawings.

Exhibit E

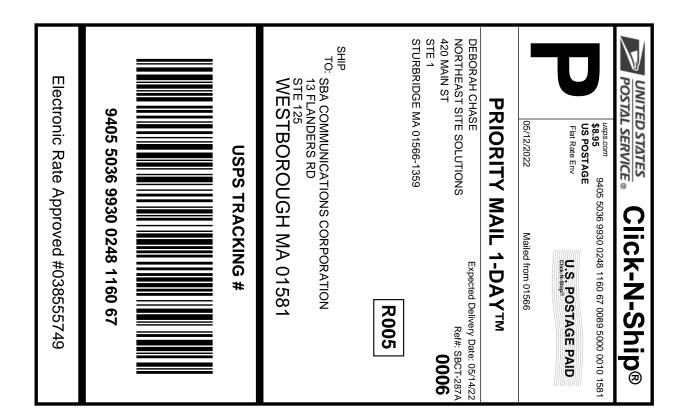



Instructions

- 1. Each Click-N-Ship® label is unique. Labels are to be used as printed and used only once. DO NOT PHOTO **COPY OR ALTER LABEL.**
- 2. Place your label so it does not wrap around the edge of the package.
- 3. Adhere your label to the package. A self-adhesive label is recommended. If tape or glue is used, DO NOT TAPE OVER BARCODE. Be sure all edges are secure.
- 4. To mail your package with PC Postage®, you may schedule a Package Pickup online, hand to your letter carrier, take to a Post Office™, or drop in a USPS collection box.
- 5. Mail your package on the "Ship Date" you selected when creating this label.

Click-N-Ship® Label Record

USPS TRACKING #: 9405 5036 9930 0248 1160 67

563434053 05/12/2022 Trans. #: Print Date: Ship Date: 05/12/2022 Delivery Date: 05/14/2022 Priority Mail® Postage: Total:

\$8.95 \$8.95

Ref#: SBCT-287A

From: DEBORAH CHASE

NORTHEAST SITE SOLUTIONS

420 MAIN ST

STE 1

STURBRIDGE MA 01566-1359


SBA COMMUNICATIONS CORPORATION

13 FLANDERS RD

STE 125

WESTBOROUGH MA 01581

Retail Pricing Priority Mail rates apply. There is no fee for USPS Tracking® service on Priority Mail service with use of this electronic rate shipping label. Refunds for unused postage paid labels can be requested online 30 days from the print date.

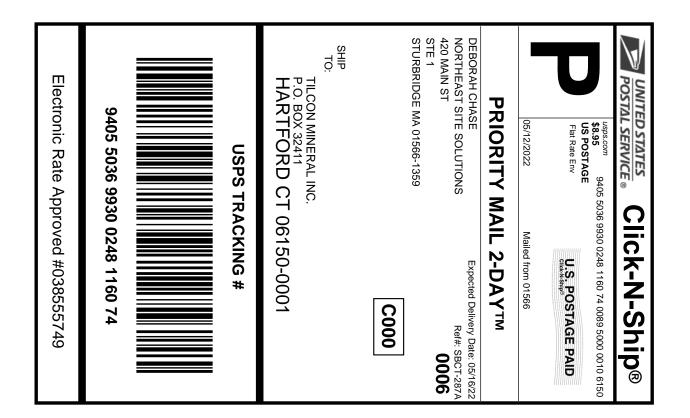



Instructions

- 1. Each Click-N-Ship® label is unique. Labels are to be used as printed and used only once. DO NOT PHOTO **COPY OR ALTER LABEL.**
- 2. Place your label so it does not wrap around the edge of the package.
- 3. Adhere your label to the package. A self-adhesive label is recommended. If tape or glue is used, DO NOT TAPE OVER BARCODE. Be sure all edges are secure.
- 4. To mail your package with PC Postage®, you may schedule a Package Pickup online, hand to your letter carrier, take to a Post Office™, or drop in a USPS collection box.
- 5. Mail your package on the "Ship Date" you selected when creating this label.

Click-N-Ship® Label Record

USPS TRACKING #: 9405 5036 9930 0248 1160 74

563434053 05/12/2022 Trans. #: Print Date: Ship Date: 05/12/2022 Delivery Date: 05/16/2022 Priority Mail® Postage: \$8.95 \$8.95 Total:

Ref#: SBCT-287A From: DEBORAH CHASE

NORTHEAST SITE SOLUTIONS

420 MAIN ST

STE 1

STURBRIDGE MA 01566-1359

TILCON MINERAL INC.

P.O. BOX 32411

HARTFORD CT 06150-0001

* Retail Pricing Priority Mail rates apply. There is no fee for USPS Tracking® service on Priority Mail service with use of this electronic rate shipping label. Refunds for unused postage paid labels can be requested online 30 days from the print date.





Instructions

- 1. Each Click-N-Ship® label is unique. Labels are to be used as printed and used only once. DO NOT PHOTO **COPY OR ALTER LABEL.**
- 2. Place your label so it does not wrap around the edge of the package.
- 3. Adhere your label to the package. A self-adhesive label is recommended. If tape or glue is used, DO NOT TAPE OVER BARCODE. Be sure all edges are secure.
- 4. To mail your package with PC Postage®, you may schedule a Package Pickup online, hand to your letter carrier, take to a Post Office™, or drop in a USPS collection box.
- 5. Mail your package on the "Ship Date" you selected when creating this label.

Click-N-Ship® Label Record

USPS TRACKING #: 9405 5036 9930 0248 1160 81

563434053 05/12/2022 Trans. #: Print Date: Ship Date: 05/12/2022 Delivery Date: 05/16/2022 Priority Mail® Postage: Total:

\$8.95 \$8.95

Ref#: SBCT-287A

From: DEBORAH CHASE

NORTHEAST SITE SOLUTIONS

420 MAIN ST


STE 1

STURBRIDGE MA 01566-1359

AMY TORRE 45 S MAIN ST

WALLINGFORD CT 06492-4201

* Retail Pricing Priority Mail rates apply. There is no fee for USPS Tracking® service on Priority Mail service with use of this electronic rate shipping label. Refunds for unused postage paid labels can be requested online 30 days from the print date.

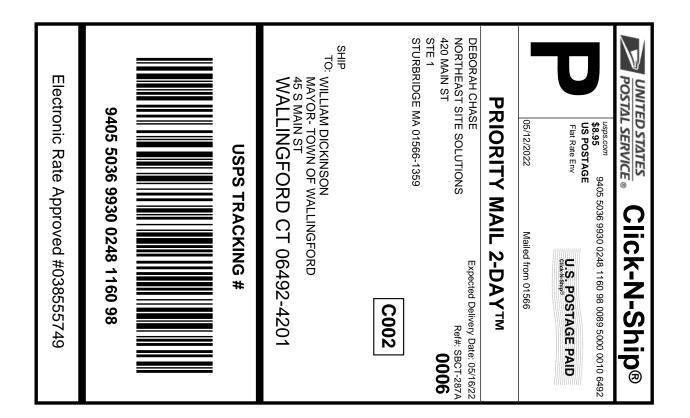



Instructions

- 1. Each Click-N-Ship® label is unique. Labels are to be used as printed and used only once. DO NOT PHOTO **COPY OR ALTER LABEL.**
- 2. Place your label so it does not wrap around the edge of the package.
- 3. Adhere your label to the package. A self-adhesive label is recommended. If tape or glue is used, DO NOT TAPE OVER BARCODE. Be sure all edges are secure.
- 4. To mail your package with PC Postage®, you may schedule a Package Pickup online, hand to your letter carrier, take to a Post Office™, or drop in a USPS collection box.
- 5. Mail your package on the "Ship Date" you selected when creating this label.

Click-N-Ship® Label Record

USPS TRACKING #: 9405 5036 9930 0248 1160 98

563434053 05/12/2022 Trans. #: Print Date: Ship Date: 05/12/2022 Delivery Date: 05/16/2022

Priority Mail® Postage: Total:

\$8.95 \$8.95

Ref#: SBCT-287A

From: DEBORAH CHASE

NORTHEAST SITE SOLUTIONS

420 MAIN ST

STE 1

STURBRIDGE MA 01566-1359

WILLIAM DICKINSON

MAYOR- TOWN OF WALLINGFORD

45 S MAIN ST

WALLINGFORD CT 06492-4201

Retail Pricing Priority Mail rates apply. There is no fee for USPS Tracking® service on Priority Mail service with use of this electronic rate shipping label. Refunds for unused postage paid labels can be requested online 30 days from the print date.

CTU2874 SBA-TMO



FARMINGTON 210 MAIN ST FARMINGTON, CT 06032-9998 (800)275-8777

03:26 PM 05/16/2022 Qty Unit Price Product Price \$0.00 Prepaid Mail 1 Westborough, MA 01581 Weight: 0 lb 2.00 oz Acceptance Date: Mon 05/16/2022 Tracking #: 9405 5036 9930 0248 1160 67 \$0.00 Prepaid Mail Hartford, CT 06150 Weight: O 1b 4.00 oz Acceptance Date: Mon 05/16/2022 Tracking #: 9405 5036 9930 0248 1160 74 \$0.00 Prepaid Mail Wallingford, CT 06492 Weight: 0 lb 3.90 oz Acceptance Date: Mon 05/16/2022 Tracking #: 9405 5036 9930 0248 1160 81 \$0.00 Prepaid Mail Wallingford, CT 05492 Weight: 0 lb 4.00 oz Acceptance Date: Mon 05/16/2022 Tracking #: 9405 5036 9930 0248 1160 98 Grand Total:

Every household in the U.S. is now eligible to receive a second set of 4 free test kits.

Go to www.covidtests.gov

Preview your Mail Track your Packages Sign up for FREE @ https://informeddelivery.usps.com