

Via FedEx and Email
Tracking #: 774090165054

November 13, 2023

Connecticut Siting Council Attn: Melanie A. Bachman 10 Franklin Square New Britain, CT 06051

RE: Notice of Exempt Modification

Facility Address: 89 Dr. Nott Road, North Franklin, CT 06254

Facility Coordinates: 41.597657, - 72.144996

Dear Ms. Bachman,

American Tower Corporation (ATC) currently maintains an existing Cellular Tower Facility (300' Guyed Tower) at 89 Dr. Nott Road, North Franklin, CT 06254. The property is owned by Victoria Penske. ATC intends to install an 80 kW Diesel Generator within the leased and fenced ground space of the facility. The purpose of this generator installation is to allow for shared back up emergency power option for current and future wireless carrier tenants.

The Cellular Tower Facility was originally approved by the Town of Franklin in 1999. The zoning department was not able to locate the original approval for the tower.

The planned modifications to the facility fall squarely within those activities explicitly provided for in R.C.S.A @ 16-50j-72(b)(2).

- 1. The proposed modifications will not result in an increase in the height of the existing structure.
- 2. The proposed modifications will not require the extension of the site boundary.
- 3. The proposed modifications will not increase noise levels at the facility by six decibels or more, or to levels that exceed state and local criteria.
- 4. The operation of the generator back up power facility will not increase radio frequency emissions at the facility to the level at or above the Federal Communications Commission safety standard.
- 5. The proposed modifications will not cause a change or alteration in the physical or environmental characteristics of the site.







6. The existing structure and its foundation can support the proposed loading if the tower will be re-enforced to support them. <<< NOTE – This condition is N/A. The proposed Generator is based on the ground, and not associated or loaded onto the tower or foundation.

Because this proposed generator is with the existing, approved compound space, and the applicant is NOT requesting an expansion of the ground space beyond approved dimensions, please accept this letter as notification pursuant to Regulations of Connecticut State Agencies @16-50j-73, for construction that constitutes and exempt modification pursuant to R.C.S.A. @16-50j-72(b)(2). In accordance with R.C.S.A. @16-50j-73, a copy of this letter is being sent to Charles Grant as First Selectman of the Town of Franklin, Doug Colter as the Building Inspector & Mark Waters as the Fire Marshall of the Town of Franklin, Sherry Pollard Land Use Administrator of the Town of Franklin, Victoria Penske as the underlying property owner, and American Tower Corporation as tower owner.

If you have any questions, please contact me at <u>eguereca@airosmithdevelopment.com</u> or (801) 645-5407.

Sincerely,

Elizabeth Guereca

Elizabeth Guereca Airosmith Development - *Authorized Agent for ATC* 318 West Ave, Saratoga Springs, NY 12866 (801) 645-5407 mobile eguereca@airosmithdevelopment.com

Enclosed: Check of \$625.00 for Filing Fees

(3) Copies of Exempt Modification Notification and Supporting Documentation

cc: Charles Grant – First Selectman, Town of Franklin (*Via FedEx*)

Doug Colter – Building Inspector, Town of Franklin (*Via FedEx*) Mark Waters – Fire Marshall, Town of Franklin (Via FedEx)

Sherry Pollard – Land Use Administrator, Town of Franklin (*Via FedEx*)

Victoria Penske – Property Owner (*Via FedEx*)

American Tower Corporation – Tower Owner (Via Email)







LETTER OF AUTHORIZATION FOR PERMITTING

Licensee Name: T-MOBILE NORTHEAST LLC D/B/A T-MOBILE ATC Site Name: FRANKLIN CT ATC Site #:6310 Project #14146235 Site Address: 89 DOCTOR NOTT RD NORTH FRANKLIN, CT

Applicant Representative: Airosmith LLC

I, Margaret Robinson, Vice President, UST Legal for American Tower*, owner/operator of the tower facility located at the address identified above (the "Tower Facility"), do hereby authorize T-MOBILE NORTHEAST LLC D/B/A T-MOBILE, Airosmith LLC its successors and assigns, and/or their agent, (collectively, the "Licensee") to act as American Tower's non-exclusive agent for the sole purpose of filing and consummating any land-use, building, or electrical permit application(s) as may be required by the applicable permitting authorities for T-MOBILE NORTHEAST LLC D/B/A T-MOBILE 's telecommunications' installation on the Tower Facility.

I understand that these applications may be approved with conditions. The above authorization is limited to the acceptance by Licensee only of conditions related to Licensee's installation and any such conditions of approval or modifications will be Licensee's sole responsibility.

Signature:

Print Name: Margaret Robinson

Vice President, UST Legal

American Tower*

Commonwealth of MASSACHUSETTS County of Middlesex

This instrument was acknowledged before me by Margaret Robinson, Vice President, UST Legal for American Tower*, personally known to me (or proved to me based on satisfactory evidence of identification) to be the person whose name is signed on the preceding or attached document and acknowledged to me that they signed it voluntarily for its stated purpose.

WITNESS my hand and official seal, this 28th day of September 2023

NOTARY SEAL

MELISSA ANN METZLER
Notary Public
Commenwealth of Massachusetts
My Commission Expires March 14, 2025

My Commission Expires: March 14, 2025

^{*} American Tower is defined as American Tower Corporation and any of its affiliates or subsidiaries.

The Assessor's office is responsible for the maintenance of records on the ownership of properties.

Assessments are computed at 70% of the estimated market value of real property at the time of the last revaluation which was 2018.



Information on the Property Records for the Municipality of Franklin was last updated on





Parcel Information

Location:	89 DR NOTT RD	Property Use:	Residential	Primary Use:	Residential
Unique ID:	S1080900	Map Block Lot:	36 8	Acres:	44.1600
490 Acres:	0.00	Zone:	R080	Volume / Page:	103/ 226
Developers Map / Lot:		Census:			

Value Information


	Appraised Value	Assessed Value
Land	138,500	96,940
Buildings	221,367	154,960
Detached Outbuildings	293,995	205,800
Total	653,862	457,700

Owner's Information

Owner's Data					
PENSKE AITCHISON VICTORIA L ETAL					
PO BOX 1128					
BETHLEHEM, PA 18016					

Building 1



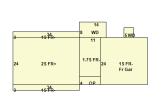

Building Use:	Single Family	Style:	Colonial	Living Area:	2,786
Stories:	2.00	Construction:	Wood Frame	Year Built:	1986
Total Rooms:	8	Bedrooms:	3	Full Baths:	2
Half Baths:	1	Fireplaces:	0	Heating:	Hot Water
Fuel:	Oil	Cooling Percent:	0	Basement Area:	816
Basement Finished Area:	0	Basement Garages:	0	Roof Material:	Asphalt
Siding:	Clapboards	Units:			

Special Features

Attached Components

Туре:	Year Built:	Area:
Wood Deck	1986	112
Wood Deck	1986	25
Attatched Frame Garage	1986	576
Open Porch	1986	44

Detached Outbuildings

Туре:	Year Built:	Length:	Width:	Area:
Barn w/Loft	1986	0.00	0.00	768
Barn w/Loft	2007	30.00	60.00	1,800
Pole Barn	2000	0.00	0.00	7,200

Туре:	Year Built:	Length:	Width:	Area:
Canopy	1986	0.00	0.00	345
Farm Utility Storage Shed	2000	0.00	0.00	408
Farm Utility Storage Shed	1999	0.00	0.00	200
Farm Utility Storage Shed	1999	0.00	0.00	480
6 Ft Chain Fence	0000	1,000.00	0.00	1,000
Detached 1 Story Garage	1986	0.00	0.00	925
Site Value	1986	0.00	0.00	1
Lean To Shed	1986	0.00	0.00	288
Cell Tower	1999	0.00	0.00	1

Owner History - Sales


Owner Name	Volume	Page	Sale Date	Deed Type	Sale Price
PENSKE AITCHISON VICTORIA L ETAL	0103	0226	05/27/2020	Warranty Deed	\$653,862
HIDDEN BROOK FARMS LLC	0091	0719	08/29/2013		\$650,000
SHAKUN THOMAS J	0091	0030	05/14/2013		\$0
SHAKUN THOMAS J AND	0084	0530	01/14/2010		\$0
SHAKUN THOMAS J	0066	0180	01/16/2003		\$0
SHAKUN THOMAS J AND DOROTHY M	0032	0115			\$0

Building Permits

Permit Number	Permit Type	Date Opened	Reason
803-23	Roof	09/05/2023	4200 SF METAL ROOF
600-22	Electrical	06/16/2022	INSTALL CONDUITS AND WIRING 125 AMP SERVICE
206-22	Electrical	02/15/2022	200 AMP SERVICE FOR AT&T WALK UP CABINET

Permit Number	Permit Type	Date Opened	Reason
1210-21	Other	12/14/2021	REMOVE 6 ANT 12 RRH INSTALL 6 ANT
1207-21	Other	12/09/2021	REPLACE 9 ANTENNAS
810-21	Other	08/10/2021	INSTALLATION OF WALK-IN CABINET AND GENERATOR ON PLATFORM PLUS NEW ANTENNA AND MOUNTS ON TOWER
708-21	Roof	07/20/2021	METAL ROOF OVER EXIST SHED REPLACE 6 WINDOWS
806-16	Residential	08/09/2016	SEE PERMIT
1013-13	Electrical	10/08/2013	CHANGING SERVICE TO 200 HSE 100 AMP APT
1105-07	Residential	10/01/2007	TANK RM GAS HEATER.
111106		11/21/2006	30 X 60
2009	Residential	07/31/2000	BARN
2100		01/18/2000	ST POL ANT + 12x34 SHED
6799		06/09/1999	EQP SHEDS
1759	Residential	01/11/1999	AMERICAN TOWER

Information Published With Permission From The Assessor

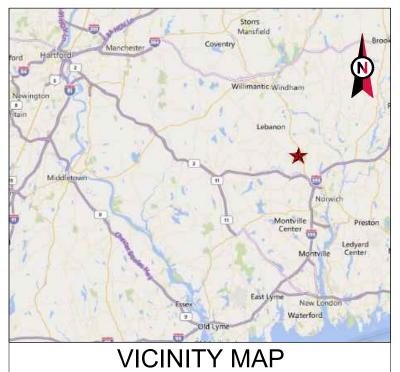

001101111105 0005



ATC SITE NAME:FRANKLIN CT

SITE NUMBER: 6310

DD0 1507 01 11 41 41 DV

SITE ADDRESS: 89 DR. NOTT ROAD

NORTH FRANKLIN, CT 06254



LOCATION MAP

OLIEET INDEX

SHARED GENERATOR PROGRAM ANCHOR TENANT

COMPLIANCE CODE	PROJECT SUMMARY	PROJECT DESCRIPTION	ION SHEET INDEX				
ALL WORK SHALL BE PERFORMED AND MATERIALS INSTALLED IN ACCORDANCE WITH THE CURRENT EDITIONS OF THE	SITE ADDRESS:	THE PROPOSED PROJECT INSTALLS A CONCRETE PAD, AN OPTIONAL STANDBY GENERATOR SYSTEM. AUTOMATIC TRANSFER	SHEET NO:	DESCRIPTION:	REV:	DATE:	BY:
FOLLOWING CODES AS ADOPTED BY THE LOCAL GOVERNMENT AUTHORITIES. NOTHING IN THESE PLANS IS TO BE CONSTRUED TO PERMIT WORK NOT CONFORMING TO THESE CODES	89 DR. NOTT ROAD NORTH FRANKLIN, CT 06254	SWITCH, GENERATOR AUXILIARY POWER DISTRIBUTION, AND REMOTE MONITORING COMMUNICATIONS CIRCUITRY FOR A	G-001	TITLE SHEET	1	10/24/23	SLL
	COUNTY: NEW LONDON	COMMUNICATION TOWER TENANT.	G-002	GENERAL NOTES	0	08/21/23	SLL
1. 2022 INTERNATIONAL BUILDING CODE (IBC)	GEOGRAPHIC COORDINATES:		C-101	SITE PLAN	0	08/21/23	SLL
2. 2020 NATIONAL ELECTRIC CODE (NEC) 3. 2020 LOCAL BUILDING CODE	LATITUDE: 41.59765776 LONGITUDE: -72.1449966		C-501	CONCRETE PAD DETAILS	0	08/21/23	SLL
4. CITY/COUNTY ORDINANCES	GROUND ELEVATION: 499' AMSL		C-502	CIVIL DETAILS	0	08/21/23	SLL
	ZONING INFORMATION:	PROJECT NOTES	E-601	ELECTRICAL ONE-LINE AND WIRING DETAILS	0	08/21/23	SLL
	JURISDICTION: TOWN OF FRANKLIN	THE FACILITY IS UNMANNED.	R-601	SUPPLEMENTAL			
	PARCEL NUMBER: S1080900	A TECHNICIAN WILL VISIT THE SITE APPROXIMATELY ONCE A MONTH FOR ROUTINE INSPECTION AND MAINTENANCE.	R-602	SUPPLEMENTAL			
		THE PROJECT WILL NOT RESULT IN ANY SIGNIFICANT LAND DISTURBANCE OR EFFECT OF STORM WATER DRAINAGE.	R-603	SUPPLEMENTAL			
	PROJECT TEAM	NO SANITARY SEWER, POTABLE WATER OR TRASH DISPOSAL IS REQUIRED.					
	ATC REGIONAL NETWORK DEVELOPMENT PROJECT MANAGER:	HANDICAP ACCESS IS NOT REQUIRED. THE PROJECT DEPICTED IN THESE PLANS QUALIFIES AS					
	WILLIAM MCELWAINE (412) 867-5637	AN ELIGIBLE FACILITIES REQUEST ENTITLED TO EXPEDITED REVIEW UNDER 47 U.S.C. § 1455(A) AS A					
	ATC NETWORK OPERATIONS CENTER:	MODIFICATION OF AN EXISTING WIRELESS TOWER THAT INVOLVES THE COLLOCATION, REMOVAL, AND/OR					
UTILITY COMPANIES	(877) 518-6937	REPLACEMENT OF TRANSMISSION EQUIPMENT THAT IS NOT A SUBSTANTIAL CHANGE UNDER CFR § 1.61000 (B)(7).					
POWER COMPANY: PSNH PHONE: (888) 270-6624	TOWER OWNER:						
TELEPHONE COMPANY: UNKNOWN	AMERICAN TOWER 10 PRESIDENTIAL WAY	PROJECT LOCATION DIRECTIONS					
PHONE: N/A	WOBURN, MA 01801						
	PROPERTY OWNER:						
1 11 11	PENSKE AITCHISON VICTORIA L ETAL PO BOX 1128	395 SOUTH TO 608 WEST. FOLLOW TO 32 NORTH TO LEFT ON					
	BETHLEHEM, PA 18016 ENGINEERED BY:	POUND HILL RD. LEFT ON DR. NOTT RD. SITE IS BEHIND FARM.					
Karamatana balaw	ATC TOWER SERVICES						
Know what's below. Call before you dig.	3500 REGENCY PARKWAY SUITE 100 CARY, NC 27518						
Sain sololo you dig.	3, 2.0.0						



A.T. ENGINEERING SERVICES LLC 3500 REGENCY PARKWAY SUITE 100 CARY, NC 27518 PHONE: (919) 468-0112

PEC.0001553

THESE DRAWINGS AND/OR THE ACCOMPANYING SPECIFICATION AS INSTRUMENTS OR SERVICE ARE THE EXCLUSIVE PROPERTY OF AMERICAN TOWER. THEIR USE AND PUBLICATION SHALL BE RESTRICTED TO THE ORIGINAL SITE FOR WHICH THEY ARE PREPARED. ANY USE OR DISCLOSURE OTHER THAN THAT WHICH RELATES TO AMERICAN TOWER OR THE SPECIFIED CARRIER IS STRICTLY PROHIBITED. TITLE TO THESE DOCUMENTS SHALL REMAIN THE PROPERTY OF AMERICAN TOWER WHETHER OR NOT THE PROJECT IS EXECUTED. NEITHER THE ARCHITECT NOR THE ENGINEER WILL BE PROVIDING ON-SITE CONSTRUCTION REVIEW OF THIS PROJECT. CONTRACTOR(S) MUST VERIEY ALL DIMENSIONS AND ADVISE AMERICAN TOWER OF ANY DISCREPANCIES. ANY PRIOR ISSUANCE OF THIS DRAWING IS SUPERSEDED BY THE LATEST VERSION ON FILE WITH AMERICAN TOWER.

I	REV	. DESCRIPTION	BY	DATE
I	\triangle	FOR CONSTRUCTION	SLL	08/21/23
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ATC SITE NUMBER: 6310

ATC SITE NAME: FRANKLIN CT

SITE ADDRESS: 89 DR. NOTT ROAD NORTH FRANKLIN, CT 06254

SEAL



T··Mobile

DRAWN BY:	SLL
DATE DRAWN:	08/21/23
ATC JOB NO:	14146235_M4

TITLE SHEET

SHEET NUMBER

G-001

REVISION:

GENERAL CONSTRUCTION NOTES:

- ALL WORK SHALL CONFORM TO ALL CURRENT APPLICABLE FEDERAL, STATE, AND LOCAL CODES, INCLUDING ANSI/EIA/TIA-222. AND COMPLY WITH ATC CONSTRUCTION SPECIFICATIONS.
- CONTRACTOR SHALL CONTACT LOCAL 811 FOR IDENTIFICATION OF UNDERGROUND UTILITIES
 PRIOR TO START OF CONSTRUCTION.
- 3. CONTRACTOR SHALL BE RESPONSIBLE FOR COORDINATING ALL REQUIRED INSPECTIONS.
- 4. ALL DIMENSIONS TO, OF, AND ON EXISTING BUILDINGS, DRAINAGE STRUCTURES, AND SITE IMPROVEMENTS SHALL BE VERIFIED IN FIELD BY CONTRACTOR WITH ALL DISCREPANCIES REPORTED TO THE ENGINEER.
- 5. DO NOT CHANGE SIZE OR SPACING OF STRUCTURAL ELEMENTS.
- 6. DETAILS SHOWN ARE TYPICAL; SIMILAR DETAILS APPLY TO SIMILAR CONDITIONS UNLESS OTHERWISE NOTED.
- THESE DRAWINGS DO NOT INCLUDE NECESSARY COMPONENTS FOR CONSTRUCTION SAFETY
 WHICH SHALL BE THE SOLE RESPONSIBILITY OF THE CONTRACTOR.
- CONTRACTOR SHALL BRACE STRUCTURES UNTIL ALL STRUCTURAL ELEMENTS NEEDED FOR STABILITY ARE INSTALLED. THESE ELEMENTS ARE AS FOLLOWS: LATERAL BRACING, ANCHOR BOLTS, FTC.
- CONTRACTOR SHALL DETERMINE EXACT LOCATION OF EXISTING UTILITIES, GROUNDS DRAINS, DRAIN PIPES, VENTS, ETC. BEFORE COMMENCING WORK.
- INCORRECTLY FABRICATED, DAMAGED, OR OTHERWISE MISFITTING OR NONCONFORMING MATERIALS OR CONDITIONS SHALL BE REPORTED TO THE ATC CM PRIOR TO REMEDIAL OR CORRECTIVE ACTION. ANY SUCH REMEDIAL ACTION SHALL REQUIRE WRITTEN APPROVAL BY THE ATC CM PRIOR TO PROCEEDING.
- 11. EACH CONTRACTOR SHALL COOPERATE WITH THE ATC CM, AND COORDINATE HIS WORK WITH THE WORK OF OTHERS.
- 12. CONTRACTOR SHALL REPAIR ANY DAMAGE CAUSED BY CONSTRUCTION OF THIS PROJECT TO MATCH EXISTING PRE-CONSTRUCTION CONDITIONS TO THE SATISFACTION OF THE ATC CONSTRUCTION MANAGER
- 13. ALL CABLE/CONDUIT ENTRY/EXIT PORTS SHALL BE WEATHERPROOFED DURING INSTALLATION USING A SILICONE SEALANT.
- 14. WHERE EXISTING CONDITIONS DO NOT MATCH THOSE SHOWN IN THIS PLAN SET, CONTRACTOR SHALL NOTIFY THE ATC CONSTRUCTION MANAGER IMMEDIATELY.
- 15. CONTRACTOR SHALL ENSURE ALL SUBCONTRACTORS ARE PROVIDED WITH A COMPLETE AND CURRENT SET OF DRAWINGS AND SPECIFICATIONS FOR THIS PROJECT.
- CONTRACTOR SHALL REMOVE ALL RUBBISH AND DEBRIS FROM THE SITE AT THE END OF EACH DAY.
- 17. CONTRACTOR SHALL COORDINATE WORK SCHEDULE WITH LANDLORD AND TAKE PRECAUTIONS TO MINIMIZE IMPACT AND DISRUPTION OF OTHER OCCUPANTS OF THE FACILITY.
- CONTRACTOR SHALL FURNISH ATC WITH A PDF MARKED UP AS-BUILT SET OF DRAWINGS UPON COMPLETION OF WORK.
- 19. PRIOR TO SUBMISSION OF BID, CONTRACTOR SHALL COORDINATE WITH ATC CM TO DETERMINE WHAT, IF ANY, ITEMS WILL BE PROVIDED. ALL ITEMS NOT PROVIDED SHALL BE PROVIDED AND INSTALLED BY THE CONTRACTOR. CONTRACTOR WILL INSTALL ALL ITEMS PROVIDED.
- 20. PRIOR TO SUBMISSION OF BID, CONTRACTOR SHALL COORDINATE WITH ATC CONSTRUCTION MANAGER TO DETERMINE IF ANY PERMITS WILL BE OBTAINED BY ATC. ALL REQUIRED PERMITS NOT OBTAINED BY ATC MUST BE OBTAINED, AND PAID FOR, BY THE CONTRACTOR.
- 21. CONTRACTOR SHALL INSTALL ALL SITE SIGNAGE IN ACCORDANCE WITH ATC SPECIFICATIONS AND REQUIREMENTS.
- 22. CONTRACTOR SHALL SUBMIT ALL SHOP DRAWINGS TO ATC FOR REVIEW AND APPROVAL PRIOR TO FABRICATION.
- 23. ALL EQUIPMENT SHALL BE INSTALLED ACCORDING TO MANUFACTURER'S SPECIFICATIONS AND LOCATED ACCORDING TO ATC SPECIFICATIONS, AND AS SHOWN IN THESE PLANS.
- 24. THE CONTRACTOR SHALL SUPERVISE AND DIRECT THE PROJECT DESCRIBED HEREIN. THE CONTRACTOR SHALL BE SOLELY RESPONSIBLE FOR ALL THE CONSTRUCTION MEANS, METHODS, TECHNIQUES, SEQUENCES AND PROCEDURES AND FOR COORDINATING ALL PORTIONS OF THE WORK UNDER THE CONTRACT.
- 25. CONTRACTOR SHALL NOTIFY ATC CM A MINIMUM OF 48 HOURS IN ADVANCE OF POURING CONCRETE OR BACKFILLING ANY UNDERGROUND UTILITIES, FOUNDATIONS OR SEALING ANY WALL, FLOOR OR ROOF PENETRATIONS FOR ENGINEERING REVIEW AND APPROVAL.
- 26. CONTRACTOR SHALL BE RESPONSIBLE FOR SITE SAFETY INCLUDING COMPLIANCE WITH ALL APPLICABLE OSHA STANDARDS AND RECOMMENDATIONS AND SHALL PROVIDE ALL NECESSARY SAFETY DEVICES INCLUDING PPE AND PPM AND CONSTRUCTION DEVICES SUCH AS WELDING AND FIRE PREVENTION, TEMPORARY SHORING, SCAFFOLDING, TRENCH BOXES/SLOPING, BARRIERS, ETC.
- 27. THE CONTRACTOR SHALL PROTECT AT HIS OWN EXPENSE, ALL EXISTING FACILITIES AND SUCH OF HIS NEW WORK LIABLE TO INJURY DURING THE CONSTRUCTION PERIOD. ANY DAMAGE CAUSED BY NEGLECT ON THE PART OF THIS CONTRACTOR OR HIS REPRESENTATIVES, OR BY THE ELEMENTS DUE TO NEGLECT ON THE PART OF THIS CONTRACTOR OR HIS

- REPRESENTATIVES, EITHER TO THE EXISTING WORK, OR TO HIS WORK OR THE WORK OF ANY OTHER CONTRACTOR. SHALL BE REPAIRED AT HIS EXPENSE TO THE OWNER'S SATISFACTION.
- 28. ALL WORK SHALL BE INSTALLED IN A FIRST CLASS, NEAT AND WORKMANLIKE MANNER BY MECHANICS SKILLED IN THE TRADE INVOLVED. THE QUALITY OF WORKMANSHIP SHALL BE SUBJECT TO THE APPROVAL OF THE ATC CM. ANY WORK FOUND BY THE ATC CM TO BE OF INFERIOR QUALITY AND/OR WORKMANSHIP SHALL BE REPLACED AND/OR REWORKED AT CONTRACTOR EXPENSE UNTIL APPROVAL IS OBTAINED.
- 29. IN ORDER TO ESTABLISH STANDARDS OF QUALITY AND PERFORMANCE, ALL TYPES OF MATERIALS LISTED HEREINAFTER BY MANUFACTURER'S NAMES AND/OR MANUFACTURER'S CATALOG NUMBER SHALL BE PROVIDED BY THESE MANUFACTURERS AS SPECIFIED.

CONCRETE AND REINFORCING STEEL NOTES:

- DESIGN AND CONSTRUCTION OF ALL CONCRETE ELEMENTS SHALL CONFORM TO THE LATEST EDITIONS OF ALL APPLICABLE CODES INCLUDING: ACI 301 "SPECIFICATIONS FOR STRUCTURAL CONCRETE FOR BUILDINGS", ACI 117 "SPECIFICATIONS FOR TOLERANCES FOR CONCRETE CONSTRUCTION AND MATERIALS", AND ACI 318 "BUILDING CODE REQUIREMENTS FOR REINFORCED CONCRETE"
- 2. MIX DESIGN SHALL BE APPROVED BY ATC CM PRIOR TO PLACING CONCRETE.
- CONCRETE SHALL BE NORMAL WEIGHT, 6 % AIR ENTRAINED (+/- 1.5%) WITH A SLUMP RANGE OF 3-5" AND HAVE A MINIMUM 28-DAY COMPRESSIVE STRENGTH OF 4500 PSI UNLESS OTHERWISE NOTED.
- 4. THE FOLLOWING MATERIALS SHALL BE USED:

PORTLAND CEMENT: ASTM C150, TYPE 2

REINFORCEMENT: ASTM A185, PLAIN STEEL WELDED WIRE FABRIC

REINFORCEMENT BARS: ASTM A615, GRADE 60, DEFORMED

NORMAL WEIGHT AGGREGATE: ASTM C33
WATER: ASTM C 94/C 94M

ADMIXTURES:

-WATER-REDUCING AGENT: ASTM C 494/C 494M, TYPE A

-AIR-ENTERING AGENT: ASTM C 260/C 260M

-SUPERPLASTICIZER: ASTM C494, TYPE F OR TYPE G

-RETARDING: ASTM C 494/C 494M, TYPE B

- 5. MINIMUM CONCRETE COVER FOR REINFORCING STEEL SHALL BE NO LESS THAN 3".
- A 3/4" CHAMFER SHALL BE PROVIDED AT ALL EXPOSED EDGES OF CONCRETE IN ACCORDANCE WITH ACI 301 SECTION 4.2.4, UNLESS NOTED OTHERWISE.
- 7. INSTALLATION OF CONCRETE EXPANSION/WEDGE ANCHOR SHALL BE PER MANUFACTURER'S WRITTEN RECOMMENDED PROCEDURE. THE ANCHOR BOLT, DOWEL, OR ROD SHALL CONFORM TO MANUFACTURER'S RECOMMENDATION FOR EMBEDMENT DEPTH OR AS SHOWN ON THE DRAWINGS. NO REBAR SHALL BE CUT WITHOUT PRIOR ATC CM APPROVAL WHEN DRILLING HOLES IN CONCRETE.
- ADMIXTURES SHALL CONFORM TO THE APPROPRIATE ASTM STANDARD AS REFERENCED IN "METHOD 1" OF ACI 301.
- DO NOT WELD OR TACK WELD REINFORCING STEEL.
- ALL DOWELS, ANCHOR BOLTS, EMBEDDED STEEL, ELECTRICAL CONDUITS, PIPE SLEEVES, GROUNDS AND ALL OTHER EMBEDDED ITEMS AND FORMED DETAILS SHALL BE IN PLACE BEFORE START OF CONCRETE PLACEMENT.
- 11. REINFORCEMENT SHALL BE COLD BENT WHENEVER BENDING IS REQUIRED.
- 12. DO NOT PLACE CONCRETE IN WATER, ICE, OR ON FROZEN GROUND.
- 13. DO NOT ALLOW REINFORCEMENT, CONCRETE OR SUBBASE TO FREEZE DURING CONCRETE CURING AND SETTING PERIOD, OR FOR A MINIMUM OF 3 DAYS AFTER PLACEMENT.
- 14. FOR COLD-WEATHER(ACI 306) AND HOT-WEATHER(ACI 301M) CONCRETE PLACEMENT, CONFORM TO APPLICABLE ACI CODES AND RECOMMENDATIONS. IN EITHER CASE, MATERIALS CONTAINING CHLORIDE, CALCIUM, SALTS, ETC. SHALL NOT BE USED. PROTECT FRESH CONCRETE FROM WEATHER FOR 7 DAYS, MINIMUM.
- 15. ALL CONCRETE SHALL HAVE A "SMOOTH FORM FINISH."
- 16. UNLESS OTHERWISE NOTED:
 - ALL REINFORCING STEEL SHALL BE DEFORMED BARS CONFORMING TO ASTM A615/A 615M/A-996, GRADE 60.
 - B. WELDED WIRE FABRIC SHALL CONFORM TO ASTM A185.
- 17. SPLICING OF REINFORCEMENT IS PERMITTED ONLY AT LOCATIONS SHOWN IN THE CONTRACT DRAWINGS OR AS ACCEPTED BY THE ENGINEER. UNLESS OTHERWISE SHOWN OR NOTED REINFORCING STEEL SHALL BE SPLICED TO DEVELOP ITS FULL TENSILE CAPACITY (CLASS A) IN ACCORDANCE WITH ACI 318.
- 18. REINFORCING BAR DEVELOPMENT LENGTHS, AS COMPUTED IN ACCORDANCE WITH ACI 318, FORM THE BASIS FOR BAR EMBEDMENT LENGTHS AND BAR SPLICED LENGTHS SHOWN IN THE

- DRAWINGS. APPLY APPROPRIATE MODIFICATION FACTORS FOR TOP STEEL, BAR SPACING, COVER AND THE LIKE.
- 19. DETAILING OF REINFORCING STEEL SHALL CONFORM TO "ACI MANUAL OF STANDARD PRACTICE FOR DETAILING REINFORCED CONCRETE STRUCTURES" (ACI 315).
- 10. ALL SLAB CONSTRUCTION SHALL BE CAST MONOLITHICALLY WITHOUT HORIZONTAL CONSTRUCTION JOINTS. UNLESS SHOWN IN THE CONTRACT DRAWINGS.
- LOCATION OF ALL CONSTRUCTION JOINTS ARE SUBJECT TO THE REQUIREMENTS OF THE CONTRACT DOCUMENTS, CONFORMANCE WITH ACI 318, AND ACCEPTANCE OF THE ENGINEER. DRAWINGS SHOWING LOCATION OF DETAILS OF THE PROPOSED CONSTRUCTION JOINTS SHALL BE SUBMITTED WITH REINFORCING STEEL PLACEMENT DRAWINGS.
- 2. SPLICES OF WWF, AT ALL SPLICED EDGES, SHALL BE SUCH THAT THE OVERLAP MEASURED BETWEEN OUTERMOST CROSS WIRES OF EACH FABRIC SHEET IS NOT LESS THAN THE SPACING OF THE CROSS WIRE PLUS 2 INCHES, NOR LESS THAN 6".
- BAR SUPPORTS SHALL BE ALL-GALVINIZED METAL WITH PLASTIC TIPS.
- 4. ALL REINFORCEMENT SHALL BE SECURELY TIED IN PLACE TO PREVENT DISPLACEMENT BY CONSTRUCTION TRAFFIC OR CONCRETE. TIE WIRE SHALL BE OF SUFFICIENT STRENGTH FOR INTENDED PURPOSE. BUT NOT LESS THAN NO. 18 GAUGE.
- SLAB ON GROUND:
 - A. COMPACT SUBGRADE AND ENSURE THERE IS PLACE 6" GRAVEL BENEATH SLAB.
 - B. PROVIDE VAPOR BARRIER BENEATH SLAB ON GROUND.

STRUCTURAL STEEL NOTES:

- STRUCTURAL STEEL SHALL CONFORM TO THE LATEST EDITION OF THE AISC "SPECIFICATION FOR THE DESIGN, FABRICATION AND ERECTION OF STRUCTURAL STEEL FOR BUILDINGS."
- STRUCTURAL STEEL ROLLED SHAPES, PLATES AND BARS SHALL CONFORM TO THE FOLLOWING ASTM DESIGNATIONS:
 - A. ASTM A-572, GRADE 50 ALL W SHAPES, UNLESS NOTED OR A992 OTHERWISE
 - B. ASTM A-36 ALL OTHER ROLLED SHAPES, PLATES AND BARS UNLESS NOTED OTHERWISE.
 - C. ASTM A-500, GRADE B HSS SECTION (SQUARE, RECTANGULAR, AND ROUND)
 - D. ASTM A-325, TYPE SC OR N ALL BOLTS FOR CONNECTING STRUCTURAL MEMBERS
 - E. ASTM F-1554 07 ALL ANCHOR BOLTS, UNLESS NOTED OTHERWISE
- ALL EXPOSED STRUCTURAL STEEL MEMBERS SHALL BE HOT-DIPPED GALVANIZED AFTER FABRICATION PER ASTM A123. EXPOSED STEEL HARDWARE AND ANCHOR BOLTS SHALL BE GAI VANIZED PER ASTM A153 OR B895
- 4. ALL FIELD CUT SURFACES, FIELD DRILLED HOLES AND GROUND SURFACES WHERE EXISTING PAINT OR GALVANIZATION REMOVAL WAS REQUIRED SHALL BE REPAIRED WITH (2) BRUSHED COATS OF ZRC GALVILITE COLD GALVANIZING COMPOUND PER ASTM A780 AND MANUFACTURER'S RECOMMENDATIONS.
- DO NOT DRILL HOLES THROUGH STRUCTURAL STEEL MEMBERS EXCEPT AS SHOWN AND DETAILED ON STRUCTURAL DRAWINGS.
- 6. CONNECTIONS
 - A. ALL WELDING TO BE PERFORMED BY AWS CERTIFIED WELDERS AND CONDUCTED IN ACCORDANCE WITH THE LATEST EDITION OF THE AWS WELDING CODE D1.1.
 - B. ALL WELDS SHALL BE INSPECTED VISUALLY. 25% OF WELDS SHALL BE INSPECTED WITH DYE PENETRANT OR MAGNETIC PARTICLE TO MEET THE ACCEPTANCE CRITERIA OF AWS D1.1. REPAIR ALL WELDS AS NECESSARY.
 - C. INSPECTION SHALL BE PERFORMED BY AN AWS CERTIFIED WELD INSPECTOR.
 - D. IT IS THE CONTRACTORS RESPONSIBILITY TO PROVIDE BURNING/WELDING PERMITS AS REQUIRED BY LOCAL GOVERNING AUTHORITY AND IF REQUIRED SHALL HAVE FIRE DEPARTMENT DETAIL FOR ANY WELDING ACTIVITY.
 - E. ALL ELECTRODES TO BE LOW HYDROGEN, MATCHING FILLER METAL, PER AWS D1.1, UNLESS NOTED OTHERWISE.
 - F. MINIMUM WELD SIZE TO BE 0.1875 INCH FILLET WELDS, UNLESS NOTED OTHERWISE.
 - G. PRIOR TO FIELD WELDING GALVANIZING MATERIAL, CONTRACTOR SHALL GRIND OFF GALVANIZING '%" BEYOND ALL FIELD WELD SURFACES. AFTER WELD AND WELD INSPECTION IS COMPLETE, REPAIR ALL GROUND AND WELDED SURFACES WITH ZRC GALVILITE COLD GALVANIZING COMPOUND PER ASTM A780 AND MANUFACTURERS RECOMMENDATIONS.



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SUITE 100
CARY, NC 27518

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ATC SITE NUMBER:

ATC SITE NAME: FRANKLIN CT

SITE ADDRESS: 89 DR. NOTT ROAD NORTH FRANKLIN. CT 06254

SEAL:



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DRAWN BY: SLL

DATE DRAWN: 08/21/23

ATC JOB NO: 14146235_M4

GENERAL NOTES

SHEET NUMBER:

G-002

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REVISION

SITE PLAN NOTES:

- THIS SITE PLAN REPRESENTS THE BEST PRESENT KNOWLEDGE AVAILABLE TO THE ENGINEER AT THE TIME OF THIS DESIGN. THE CONTRACTOR SHALL VISIT THE SITE PRIOR TO CONSTRUCTION AND VERIFY ALL EXISTING CONDITIONS RELATED TO THE SCOPE OF WORK FOR THIS PROJECT.
- 2. ICE BRIDGE, CABLE LADDER, COAX PORT, AND COAX CABLE ARE SHOWN FOR REFERENCE ONLY. CONTRACTOR SHALL CONFIRM THE EXACT LOCATION OF ALL PROPOSED AND EXISTING EQUIPMENT AND STRUCTURES DEPICTED ON THIS PLAN. BEFORE UTILIZING EXISTING CABLE SUPPORTS, COAX PORTS, INSTALLING NEW PORTS OR ANY OTHER EQUIPMENT, CONTRACTOR SHALL VERIFY ALL ASPECTS OF THE COMPONENTS MEET THE ATC SPECIFICATIONS.
- 3. IT IS THE RESPONSIBILITY OF THE CONTRACTOR TO COORDINATE WITH THE ATC CONSTRUCTION MANAGER AND LOCAL UTILITY COMPANY FOR THE INSTALLATION OF CONDUITS, CONDUCTORS, BREAKERS, DISCONNECTS, OR ANY OTHER EQUIPMENT REQUIRED FOR ELECTRICAL SERVICE. ALL ELECTRICAL WORK SHALL BE PERFORMED IN ACCORDANCE WITH LATEST EDITION OF THE STATE AND NATIONAL CODES, ORDINANCES AND REGULATIONS APPLICABLE TO THIS PROJECT.
- 4. CONTRACTOR SHALL INSURE THAT ALL WORKING SPACE REQUIREMENTS ARE MET PER APPLICABLE CODES AND MANUFACTURER SPECIFICATIONS.
- ABOVE GROUND CONDUITS NEED TO BE SUPPORTED/FASTENED PER NEC 344, NEC 352, AND PER ATC CONSTRUCTION SPECIFICATIONS.
- 6. THE FOLLOWING SIGNS SHALL BE INSTALLED AT TENANT SERVICE MAIN DISCONNECT PER NEC 702.7.
- 6.1. "CAUTION: TWO SOURCES OF SUPPLY STANDBY GENERATOR LOCATED OUTDOORS"
- 6.2. "WARNING: SHOCK HAZARD EXISTS IF GROUNDING ELECTRODE CONDUCTOR OR BONDING JUMPER CONNECTION IN THIS EQUIPMENT IS REMOVED WHILE ALTERNATE SOURCE IS ENERGIZED"

RODENT CONTROL AROUND GENERATOR ENVELOPE:


- INSTALL ALL PROVIDED SEALS, PLUGS, COVERS, ETC. IN GENERATOR AND FUEL TANK ENVELOPE. SEAL ALL REMAINING OPENINGS (EXCEPT NORMAL VENTING) WITH RODENT FOAM SEALANT. NO OPENING SHALL BE LARGER THAN 1/4 INCH ANY DIMENSION
- 2. SEAL ALL CONDUITS ENTERING GENERATOR STUB UP AREA WITH RODENT RESISTANT CONDUIT SEALANT.
- SEAL ALL CONDUIT ACCESS OPENINGS THROUGH CONCRETE PAD WITH CONCRETE.
- 4. SLOPE GRAVEL BASE AT CONCRETE PAD PERIMETER FROM ABOVE PAD BASE TO EXISTING GRADE LEVEL TYPICAL ALL PERIMETER SIDES.


LEGEND GROUNDING TEST WELL ⊗ ATS AUTOMATIC TRANSFER SWITCH **BOLLARD** CSC CELL SITE CABINET D DISCONNECT **ELECTRICAL** FIBER GEN GENERATOR GENERATOR RECEPTACAL G HH. V HAND HOLE, VAULT ΙB ICE BRIDGE KENTROX BOX LC LIGHTING CONTROL М METER PΒ PULL BOX PΡ POWER POLE TELCO TRN TRANSFORMER CHAINLINK FENCE

APPROXIMATE TRENCH DISTANCES

44' POWER CONDUIT TRENCH

46' ADDITIONAL TRENCHING REQUIRED FOR COMMUNICATIONS EQUIPMENT

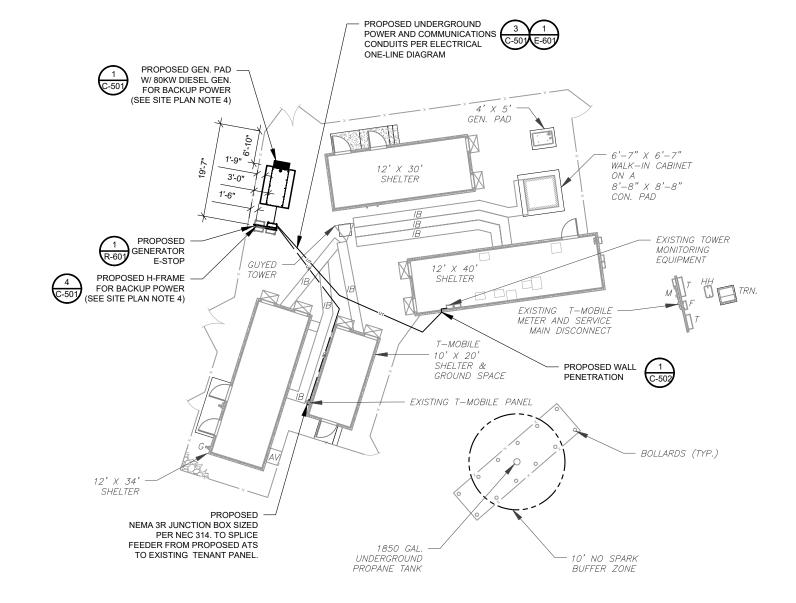

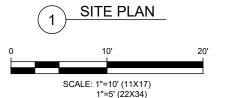



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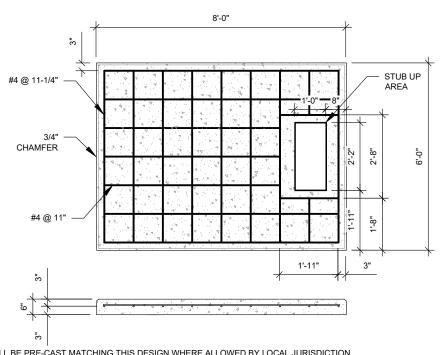
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SITE PLAN

SHEET NUMBER:


C-101

REVISION



- PADS SHALL BE PRE-CAST MATCHING THIS DESIGN WHERE ALLOWED BY LOCAL JURISDICTION.
 PADS SHALL HAVE A MIN 28 DAY COMPRESSIVE STRENGTH AS SPECIFIED ON G-002. CONCRETE AND REINFORCING STEEL NOTES #3
- REFER TO CONCRETE & REINFORCED STEEL NOTES ON SHEET G-002 & ATC CONSTRUCTION SPECIFICATION 033000 FOR
- STUB UP AREA SHALL BE FILLED WITH QUIKRETE, OR APPROVED EQUAL, PRIOR TO FINAL SET OF GENERATOR ON PAD.
- AFTER FINAL SET OF GENERATOR ON PAD, GROUT ALL EXTERIOR OPENINGS AT PAD INTERFACE SO THAT FINISHED MAXIMUM OPENING SHALL BE 1/4 INCH
- 6. GROUT SHALL BE PER ATC CONSTRUCTION SPECIFICATION DIVISION 03, CONCRETE.




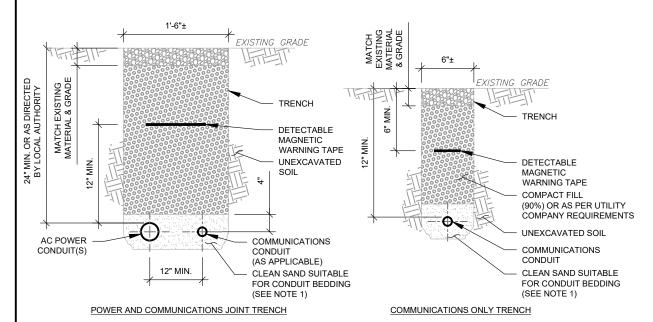

TRENCH NOTES:


PAD NOTES:

- IF FREE OF ORGANIC OR OTHER DELETERIOUS MATERIAL, EXCAVATED MATERIAL MAY BE USED FOR BACKFILL. IF NOT, PROVIDE CLEAN, COMPACTIBLE MATERIAL.
- COMPACT IN 8" LIFTS USING A MECHANICAL PLATE TAMPER, MIN 3 PASSES. REMOVE ANY LARGE ROCKS PRIOR TO BACKFILLING. CONTRACTOR TO VERIFY LOCATION OF EXISTING U/G UTILITIES PRIOR TO DIGGING. SEE ATC CONSTRUCTION SPECIFICATION 312000 SECTION 3.15.
- IF CURRENT AS-BUILT DRAWINGS ARE NOT AVAILABLE CONTRACTOR SHALL HAND DIG U/G TRENCHING.
- CONFIRM SPACING AND DEPTH WITH NEC OR LOCAL CODE REQUIREMENTS

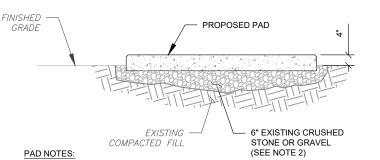


- SUBGRADE AND FILL SHALL CONSIST OF CLEAN SOIL. DELETRIOUS MATERIAL AND ORGANICS SHALL BE REMOVED.
- MECHANICALLY COMPACT FOOTPRINT OF PAD PLUS 2' PERIMETER USING A MECHANICAL PLATE TAMPER, MIN 3 PASSES. SEE ATC CONSTRUCTION SPECIFICATION 312000 ACCESS ROAD AND FARTH WORK
- 3. USE GALVANIZED HILTI EXPANSION ANCHORS OR, APPROVED EQUAL, FOR
- FOR SIZE AND LOCATION OF ANCHORS AND OTHER REQUIREMENT, SEE EQUIPMENT VENDOR DRAWINGS.

GRAVEL PREPARATION SCALE: N.T.S.

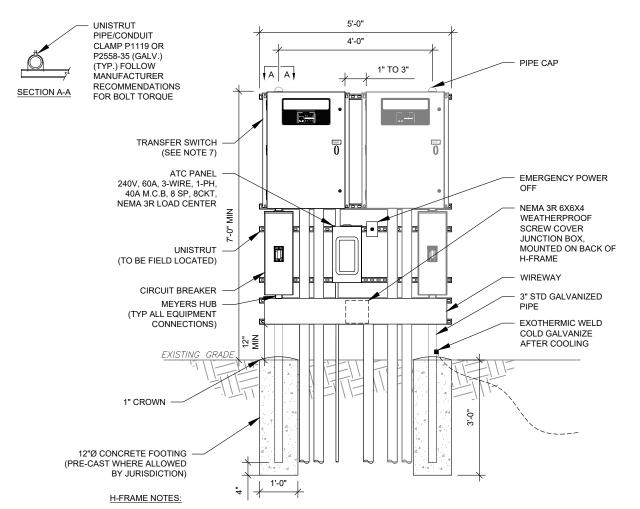

- IF IT IS NECESSARY TO EXTEND THE H-FRAME, AN ADDITIONAL POST SHALL BE REQUIRED.
- PROPOSED UNISTRUTS TO BE FIELD CUT AND SHALL NOT EXTEND MORE THAN 6 INCHES BEYOND THE LAST POST. SPRAY ENDS OF UNISTRUT WITH COLD GALVANIZING SPRAY PAINT, ALLOW TO DRY, THEN COVER WITH RUBBER
- PROTECTIVE CAPS FOR SAFETY.
- UNISTRUT TO BE CUT FLUSH WITH NO SHARP OR JAGGED EDGES.
- ALL PROPOSED HARDWARE TO BE MOUNTED AND GROUNDED PER MANUFACTURERS SPECS
- ALL ITEMS ARE PROPOSED UNLESS OTHERWISE NOTED.
- LAYOUT H-FRAME & PROPOSED EQUIPMENT EXACTLY AS SHOWN TO ALLOW FOR FUTURE EQUIPMENT. ANY DEVIATIONS MUST BE APPROVED BY ATC CM, IN WRITING, NO EXCEPTIONS.
- FOOTINGS SHALL BE ONE OF THE FOLLOWING: USS POLECRETE STABILIZER SYSTEM, PRECAST CONCRETE (WHERE ALLOWED BY JURISDICTION) OR CAST IN PLACE. FOR PRECAST FOOTINGS, CONTRACTORS SHALL THOROUGHLY COMPACT THE PERIMETER (2' MIN) OF FOOTING WITH MECHANICAL PLATE TAMPER.

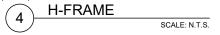



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CONCRETE PAD DETAILS

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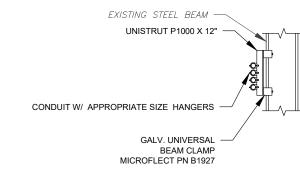
C-501

REVISION



CONDUIT TRENCH DETAILS

SCALE: N.T.S



U.L. SYSTEM NO. W-J-1020 METAL PIPE/CONDUIT THROUGH CONCRETE CONC OR CMU WALL F RATING = 2 HR T RATING = 0 HR

SECTION A-A

TOP VIEW

4" DIA. (OR SMALLER) STEEL PIPE (SCHEDULÉ 40 OR HEAVIER), EMT OR STEEL CONDUIT, RIGIDLY SUPPORTED ON EACH SIDE OF WALL

> MIN.1/2" DEPTH HILTI FS 601 SEALANT MIN. 2-3/4" THICKNESS MINERAL WOOL BATT INSULATION (MIN. 4


PFC DENSITY)

FLOOR OR WALL ASSEMBLY

MIN. 5" THICKNESS LIGHTWEIGHT OR NORMAL WEIGHT CONCRETE OR UL CLASSIFIED CONCRETE BLOCKS. MAX DIA OF OPENINGS IS 8"

CONCRETE/CMU PENETRATION DETAILS

SCALE: NOT TO SCALE

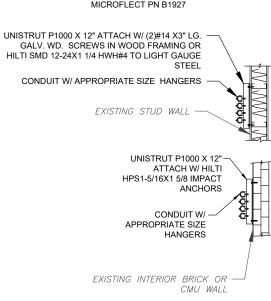

CABLE CONDUIT SUPPORT

SCALE: NOT TO SCALE

GENERATOR PROPOSED 1/2"Ø SIMPSON STRONG-BOLT® 2 WEDGE ANCHOR OR EQUIVALENT W/ OVERSIZED FLAT WASHER. GC TO INSTALL PER ICC# ESR-3037 **PROPOSED** CONCRETE PAD DRILL MINIMUM 1/2"Ø HOLE X 4 1/8" DEEP AT ANCHOR LOCATION

PROPOSED

NOTE:

INSTALL SIMPSON STRONG-TIE® STRONG-BOLT® 2 WEDGE ANCHOR(S) STRICTLY PER INSTALLATION INSTRUCTIONS INCLUDED WITH PRODUCT OR FOUND ONLINE AT WWW.STRONGTIE.COM. PROPER INSTALLATION IS CRITICAL FOR FULL PERFORMANCE.

GENERATOR ANCHORAGE DETAIL SCALE: NOT TO SCALE **AMERICAN TOWER®**

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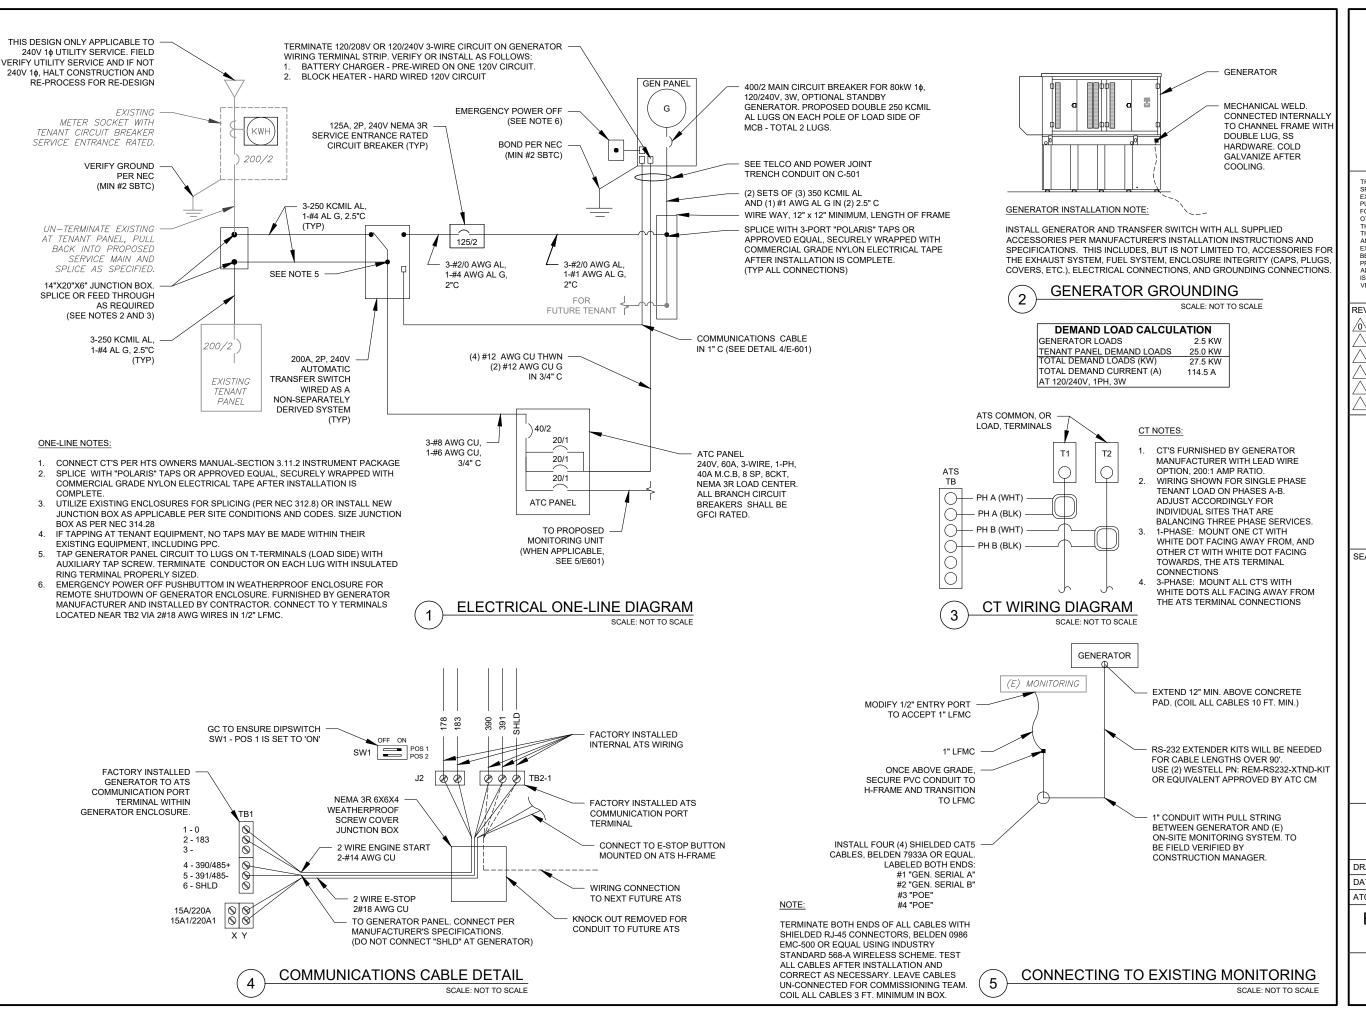
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	DATE DRAWN:	08/21/23
	ATC JOB NO:	14146235_M4

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AMERICAN TOWER

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ELECTRICAL ONE-LINE AND WIRING DETAILS


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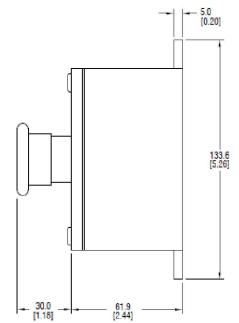
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REMOTE EMERGENCY STOP SWITCH **SURFACE MOUNT, H-PANEL**







- · MANUFACTURER: PILLA ELECTRICAL PRODUCTS, INC.
- MODEL SG120
- . GENERAC PART NUMBER 061129E
- SURFACE MOUNT, NEMA 4X
- NONMETALLIC BACKBOX

DIMENSIONS: mm[INCHES]

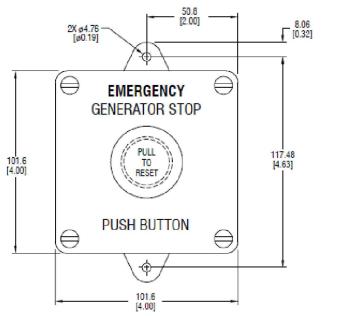GENERAC INDUSTRIAL

REMOTE EMERGENCY STOP SWITCH SURFACE MOUNT, H-PANEL

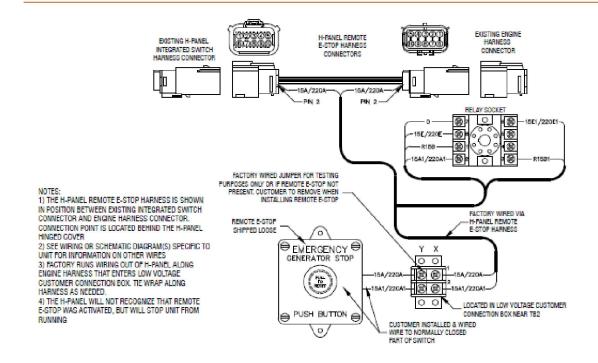

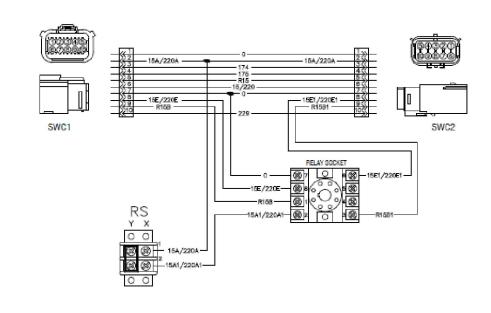

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Part No. 0L6260 Rev A 10/15/15

GENSET CONTROLS

2 OF 2

SUPPLEMENTAL

REVISION:

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SHEET NUMBER:

R-601

E-STOP SWITCH

GENERAC' INDUSTRIAL


INDUSTRIAL DIESEL GENERATOR SET EPA Certified Stationary Emergency

STANDBY POWER RATING

80 kW, 100 kVA, 60 Hz

PRIME POWER RATING*

72 kW, 90 kVA, 60 Hz

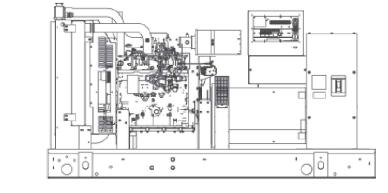



^{*}EPA Certified Prime ratings are not available in the U.S. or its Territories.

Image used for illustration purposes only

CODES AND STANDARDS

Generac products are designed to the following standards:



UL2200, UL508, UL142, UL498



NFPA70, 99, 110, 37



NEC700, 701, 702, 708



ISO9001, 8528, 3046, 7637, Pluses #2b, 4



NEMA ICS10, MG1, 250, ICS6, AB1



POWERING AHEAD

For over 50 years, Generac has led the industry with innovative design and superior manufacturing.

Generac ensures superior quality by designing and manufacturing most of its generator components, including alternators, enclosures and base tanks, control systems and communications software.

Generac's gensets utilize a wide variety of options, configurations and arrangements, allowing us to meet the standby power needs of practically every application.


Generac searched globally to ensure the most reliable engines power our generators. We choose only engines that have already been proven in heavy-duty industrial application under adverse conditions.

Generac is committed to ensuring our customers' service support continues after their generator purchase.

4.5L | 80 kW SD080 INDUSTRIAL DIESEL GENERATOR SET


EPA Certified Stationary Emergency **DIMENSIONS AND WEIGHTS***




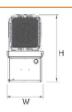





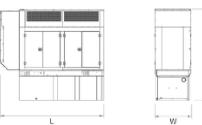

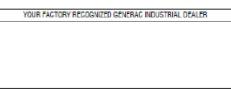

OPEN SET

RUN TIME HOURS	USABLE CAPACITY GAL (L)	L x W x H in (mm)	WT lbs (kg) - Tank & Open Set	
NO TANK	-	93 (2362.2) x 40 (1016) x 49 (1244.6)	2425 (1100)	
13	79 (299)	93 (2362.2) x 40 (1016) x 62 (1574.8)	2947 (1201)	
30	189 (715.4)	93 (2362.2) x 40 (1016) x 74 (1879.6)	3183 (1444)	
48	300 (1135.6)	93 (2362.2) x 40 (1016) x 86 (2184.4)	3407 (1545)	
56	350 (1325)	110 (2794) x 40 (1016) x 86 (2184.4)	NA	
81	510 (1930.5)	117 (2971.8) x 47 (1193.8) x 86 (2184.4)	3790 (1719)	
93	589 (2229.6)	128 (3251.2) x 49 (1244.6) x 86 (2184.4)	4269 (1936)	

GENERAC INDUSTRIAL

STANDARD ENCLOSURE

RUN TIME	USABLE	1 - W - H 5 - 7 - 3	WT lbs (kg) - Enclosure Only		
HOURS	GAPACITY GAL (L)	LxWxHin (mm)	Steel	Aluminum	
NO TANK	i=	112 (2844.8) x 41 (1041.4) x 56 (1422.4)			
13	79 (299)	112 (2844.8) x 41 (1041.4) x 69 (1752.6)	425 (193)		
30	189 (715.4)	112 (2844.8) x 41 (1041.4)x 81 (2057.4)		155 (70)	
48	300 (1135.6)	112 (2844.8) x 41 (1041.4) x 93 (2362.2)			
56	350 (1325)	112 (2844.8) x 41 (1041.4) x 93 (2362.2)			
81	510 (1930.5)	117 (2971.8) x 47 (1193.8) x 93 (2362.2)			
93	589 (2229.6)	128 (3251.2) x 49 (1244.6) x 93 (2362.2)			

LEVEL 1 ACOUSTIC ENCLOSURE

RUN TIME HOURS	USABLE CAPACITY LxWxHin (mm) GAL (L)	1-10-112-7-3	WT lbs (kg) - Enclosure Only	
		LxWxHin (mm)	Steel	Aluminum
NO TANK	-	130 (3302) x 41 (1041.4) x 56 (1422.4)	_	
13	79 (299)	130 (3302) x 41 (1041.4) x 69 (1752.6)		
30	189 (715.4)	130 (3302) x 41 (1041.4) x 81 (2057.4)		
48	300 (1135.6)	130 (3302) x 41 (1041.4) x 93 (2362.2)	450 (204)	285 (129)
56	350 (1325)	130 (3302) x 41 (1041.4) x 93 (2362.2)		
81	510 (1930.5)	130 (3302) x 47 (1193.8) x 93 (2362.2)		
93	589 (2229.6)	130 (3302) x 49 (1244.6) x 93 (2362.2)	_	

LEVEL 2 ACOUSTIC ENCLOSURE

RUN TIME	USABLE CAPACITY GAL (L)	L x W x H in (mm)	WT lbs (kg) -	Enclosure Only
HOURS			Steel	Aluminum
NO TANK	-	112 (2844.8) x 41 (1041.4) x 69 (1752.6)		
13	79 (299)	112 (2844.8) x 41 (1041.4) x 82 (2082.8)		
30	189 (715.4)	112 (2844.8) x 41 (1041.4) x 94 (2387.6)		
48	300 (1135.6)	112 (2844.8) x 41 (1041.4) x 106 (2692.4)	625 (284)	395 (180)
56	350 (1325)	112 (2844.8) x 41 (1041.4) x 106 (2692.4)		
81	510 (1930.5)	117 (2971.8) x 47 (1193.8) x 106 (2692.4)	<u>-</u> ′	
93	589 (2229.6)	128 (3251.2) x 49 (1244.6) x 106 (2692.4)		

"All measurements are approximate and for estimation purposes only. Sound dBA can be found on the sound data sheet. Enclosure Only weight is added to Tank & Open Set weight to determine total weight.

Specification characteristics may change without notice. Dimensions and weights are for preliminary purposes only. Please consult a General Power Systems Industrial Dealer for detailed installation drawings.

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Part No OK5092

SUPPLEMENTAL


SHEET NUMBER:

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GENERATOR

^{**}Certain options or customization may not hold certification valid.



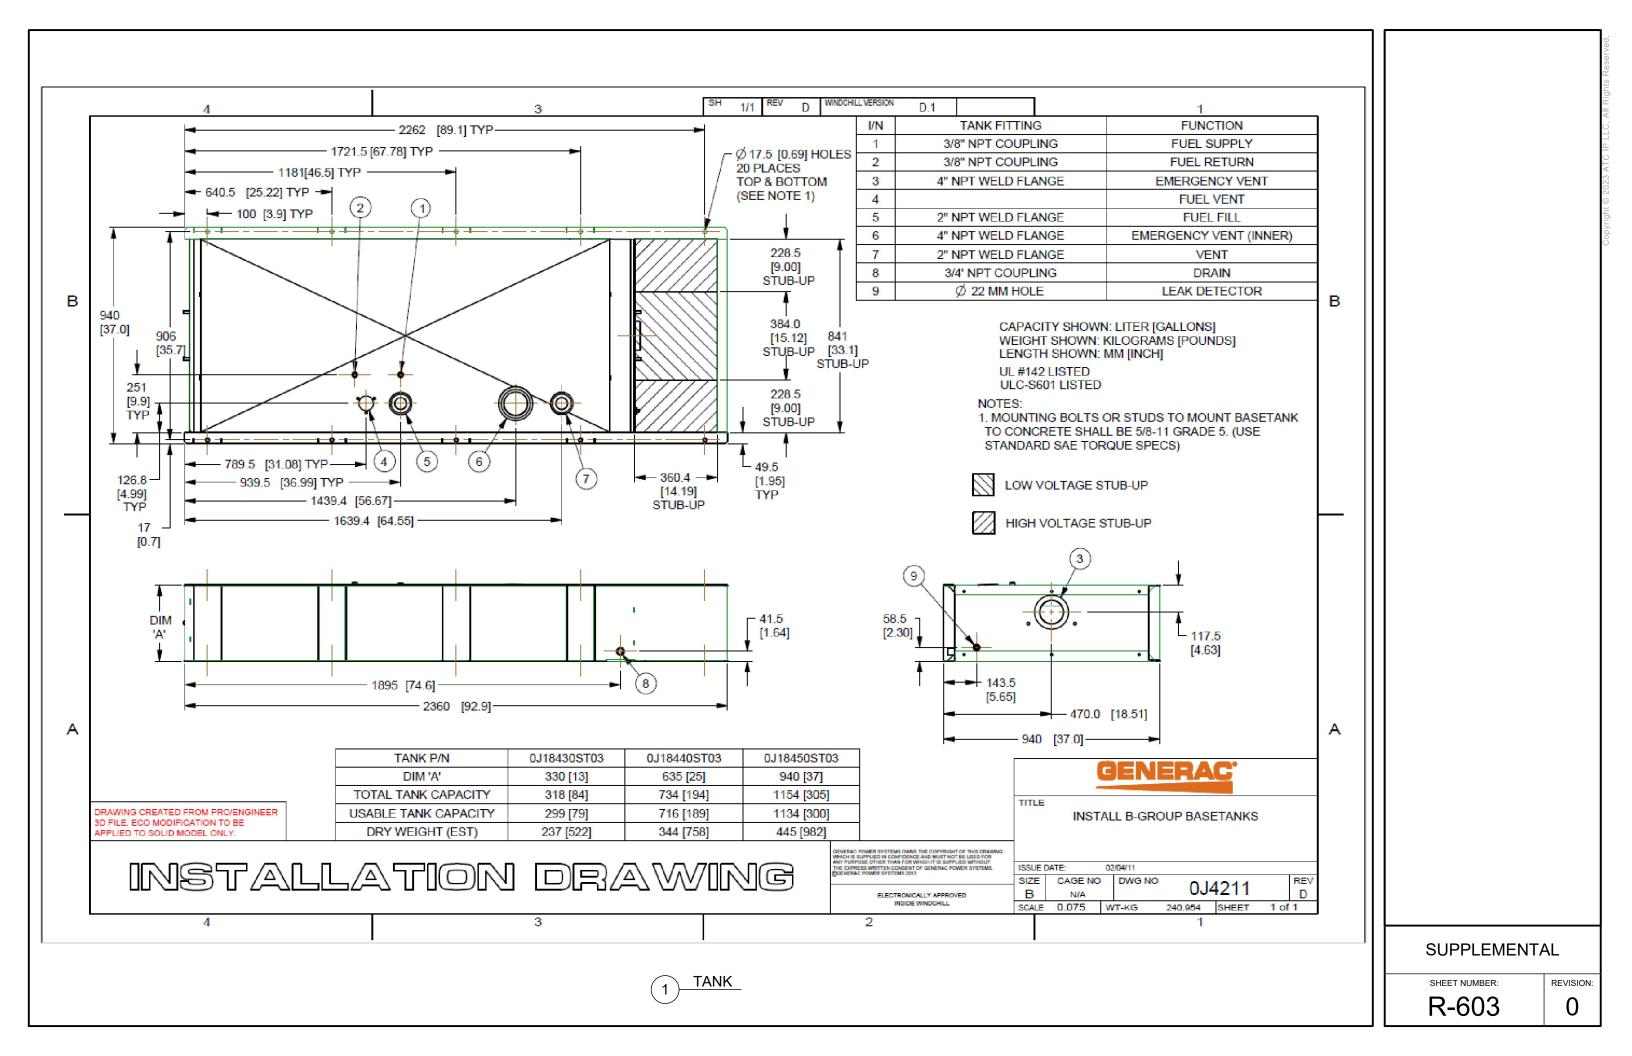

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To: Elizabeth Guereca

Subject: FedEx Shipment 774009676168: Your package has been delivered



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318 West Ave

SARATOGA SPRINGS, NY, US, 12866

TO Town of Franklin

Charles Grant

7 Meetinghouse Hill Rd. FRANKLIN, CT, US, 06254

REFERENCE ATC Gen East - CSC

SHIPPER REFERENCE ATC Gen East - CSC

SHIP DATE Tue 11/07/2023 04:30 PM

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DESTINATION FRANKLIN, CT, US, 06254

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Doug Colter

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318 West Ave

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TO Town of Franklin

Mark Waters

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SHIPPER REFERENCE ATC Gen East - CSC

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To: Elizabeth Guereca

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TO Town of Franklin

Sherry Pollard

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Attachments: DeliveryPicture.jpeg



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TO Victoria Penske

PO Box 1128

BETHLEHEM, PA, US, 18016

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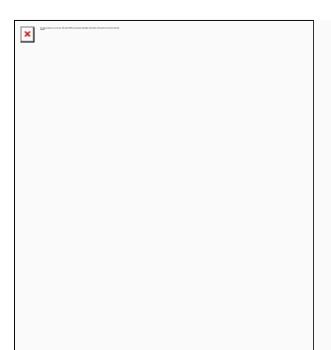
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NUMBER OF PIECES 1

TOTAL SHIPMENT WEIGHT 3.00 LB

SERVICE TYPE FedEx 2Day



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