

STATE OF CONNECTICUT CONNECTICUT SITING COUNCIL Ten Franklin Square, New Britain, CT 06051 Phone: (860) 827-2935 Fax: (860) 827-2950 E-Mail: <u>siting.council@ct.gov</u> Web Site: www.ct.gov/csc

VIA ELECTRONIC MAIL

June 16, 2020

Anne Marie Zsamba Real Estate Specialist Crown Castle 3 Corporate Park Drive, Suite 101 Clifton Park, NY 12065

RE: **EM-T-MOBILE-045-200604** – T-Mobile notice of intent to modify an existing telecommunications facility located at 93 Roxbury Road, East Lyme, Connecticut.

Dear Ms. Zsamba:

The Connecticut Siting Council (Council) is in receipt of your correspondence of June 15, 2020 submitted in response to the Council's June 9, 2020 notification of an incomplete request for exempt modification with regard to the above-referenced matter.

The submission renders the request for exempt modification complete and the Council will process the request in accordance with the Federal Communications Commission 60-day timeframe.

Thank you for your attention and cooperation.

Sincerely,

s/Melanie A. Bachman

Melanie A. Bachman Executive Director

MAB/IN/emr

From: Zsamba, Anne Marie <AnneMarie.Zsamba@crowncastle.com>
Sent: Monday, June 15, 2020 11:13 AM
To: Robidoux, Evan <Evan.Robidoux@ct.gov>
Cc: CSC-DL Siting Council <Siting.Council@ct.gov>
Subject: RE: Council Incomplete Letter for EM-T-MOBILE-045-200604 (Roxbury Road, East Lyme)

Please see the attached correspondence.

Thank you!

ANNE MARIE ZSAMBA

Site Acquisition Specialist T: (201) 236-9224 M: (518) 350-3639 F: (724) 416-6112

CROWN CASTLE

3 Corporate Park Drive, Suite 101 Clifton Park, NY 12065 <u>CrownCastle.com</u>

CC CROWN CASTLE

Crown Castle 3 Corporate Park Drive, Suite 101 Clifton Park, NY 12065

June 15, 2020

Melanie A. Bachman Acting Executive Director Connecticut Siting Council 10 Franklin Square New Britain, CT 06051

RE: Response to Incomplete Notice for T-Mobile: EM-T-MOBILE-045-200604 806384 - T-Mobile Site ID: CT11037B 93 Roxbury Road, East Lyme, CT 06357 Latitude: 41° 20' 8.35" / Longitude: -72° 13' 18.28"

Dear Ms. Bachman:


In response to the Council's Notice dated June 9, 2020 wherein T-Mobile's exempt modification filing was marked as incomplete, enclosed please find updated construction drawings which reflect the 2018 Connecticut State Building Code. We believe this now renders our submission complete. Thank you kindly.

Sincerely,


Anne Marie Zsamba


Anne Marie Zsamba Site Acquisition Specialist 3 Corporate Park Drive, Suite 101 Clifton Park, NY 12065 (201) 236-9224 AnneMarie.Zsamba@crowncastle.com

The Foundation for a Wireless World. CrownCastle.com

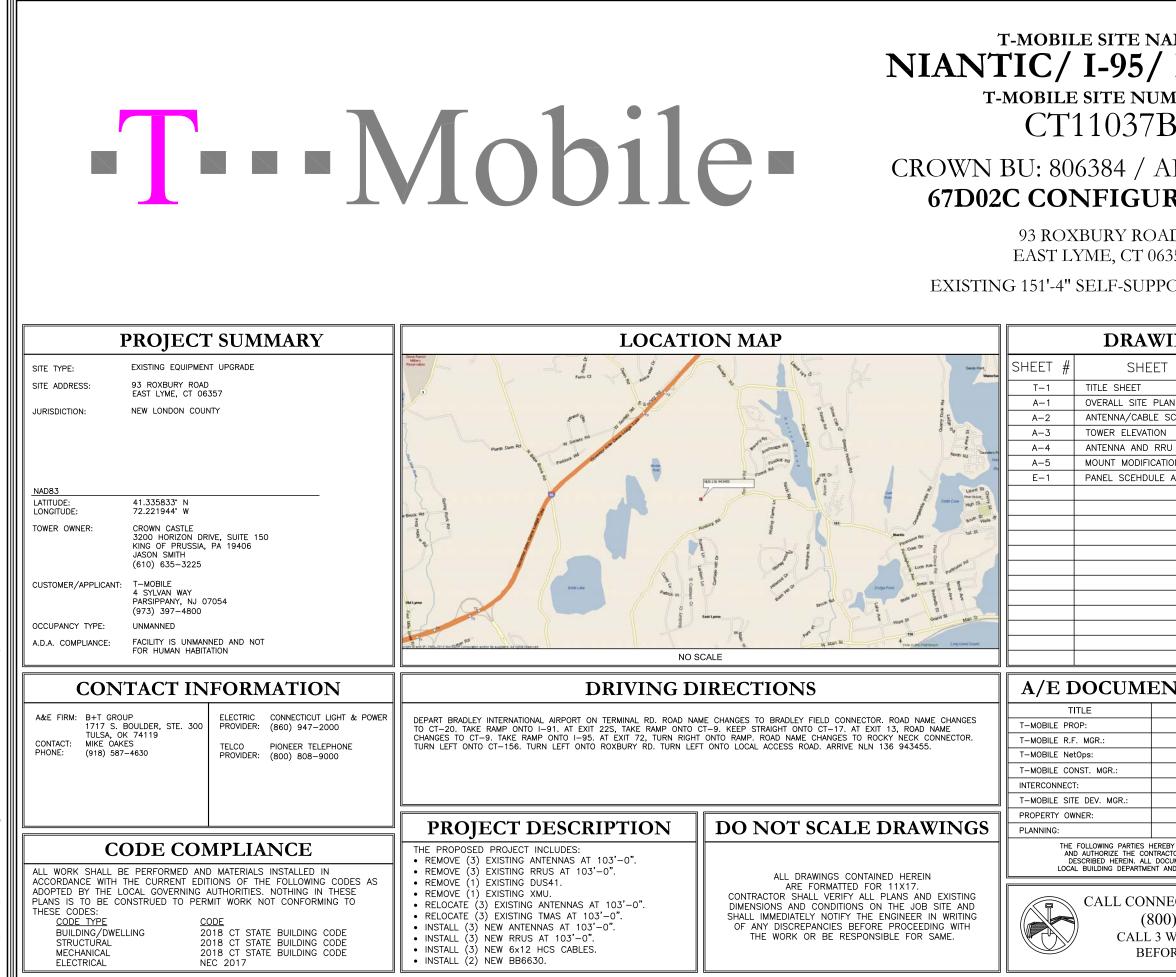


	رار ار ا					
ME: RT 156_1 MBER:	B+T GRP					
3 APP#: 479797						
RATION						
. D 357	• T •••Mobile•					
ORT TOWER						
ING INDEX	6_1 ower					
DESCRIPTION REV. #	CT11037B BU #: 806384 NIANTIC/ 1-95/ RT 156_1 93 ROXBURY ROAD EAST LYME, CT 06357 EAST LYME, CT 06357					
N 2 SCHEDULE AND AZIMUTH PLANS 2 2	11037 11037 1-95/ 1-95/ ME, C					
U DETAILS 2 ON 0 AND ONE-LINE DIAGRAM 2	CT'11037B BU #: 806384 NTIC/ 1-95/ RT 1 93 ROXBURY ROAD EAST LYME, CT 06357 IG 151'4" SELF-SUPPORT					
	NIAN					
	PROJECT NO: 137085.002.01					
	CHECKED BY: RMC ISSUED FOR:					
	REV DATE DRWN DESCRIPTION 0 7/29/19 JDP CONSTRUCTION 1 9/25/19 JJD CONSTRUCTION 2 6/12/20 GEH CONSTRUCTION					
NT REVIEW STATUS	B&T ENGINEERING, INC. PEC.0001564 Expires 2/10/21					
BY APPROVE AND ACCEPT THESE DOCUMENTS TOR TO PROCEED WITH THE CONSTRUCTION JUMENTS ARE SUBJECT TO REVIEW BY THE ND MAY IMPOSE CHANGES OR MODIFICATIONS.	* 31627 * 31627 * 1/2/20					
ECTICUT ONE CALL 0) 922-4455 WORKING DAYS DRE YOU DIG!	IT IS A VIOLATION OF LAW FOR ANY PERSON, UNLESS THEY ARE ACTING UNDER THE DIRECTION OF A LICENSED PROFESSIONAL ENGINEER, TO ALIER THIS DOCUMENT. SHEET NUMBER: T-1					

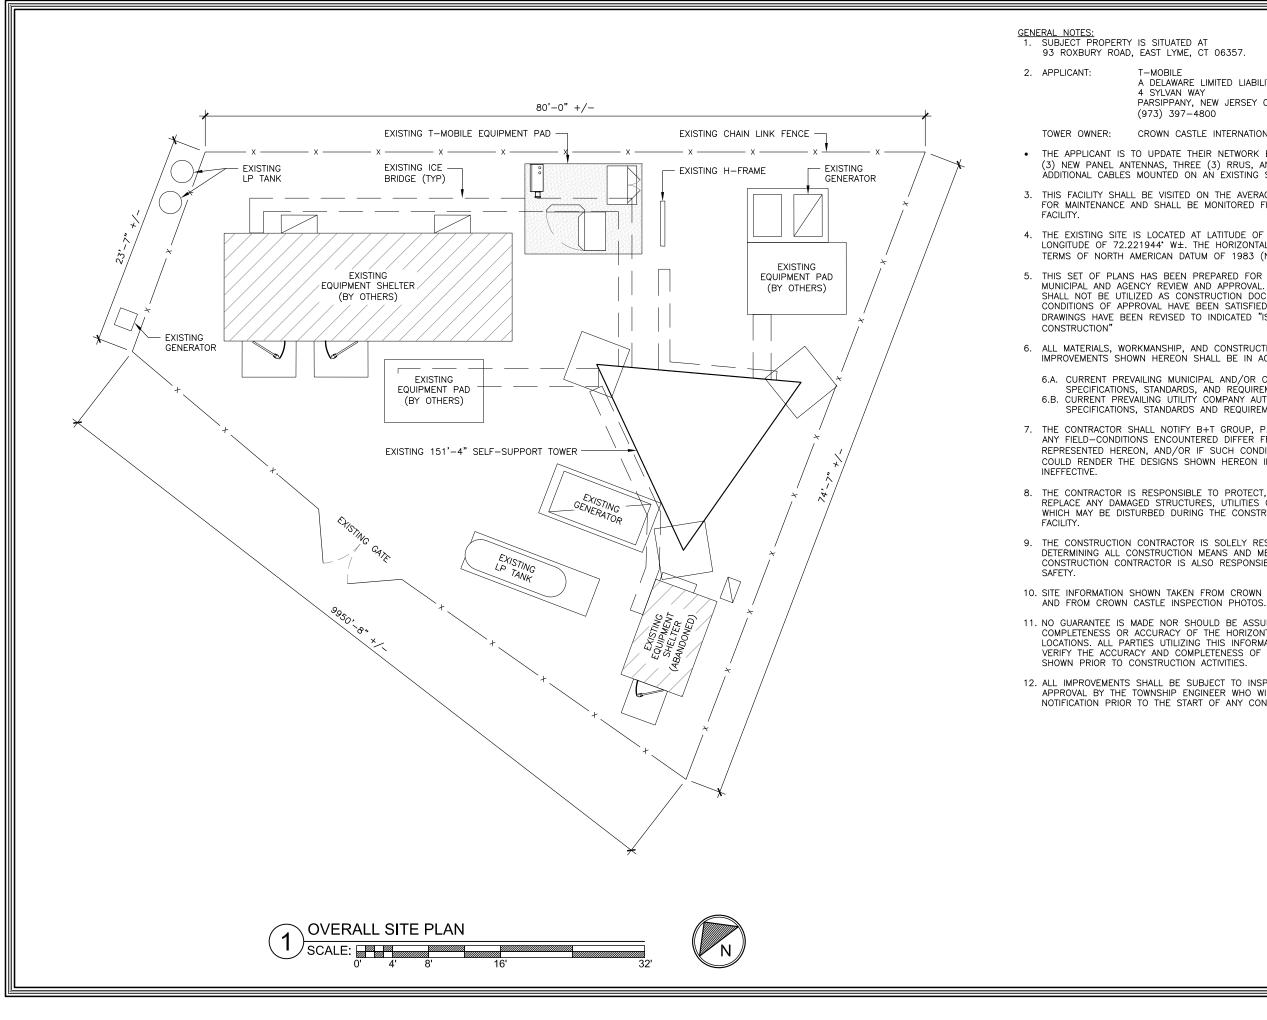


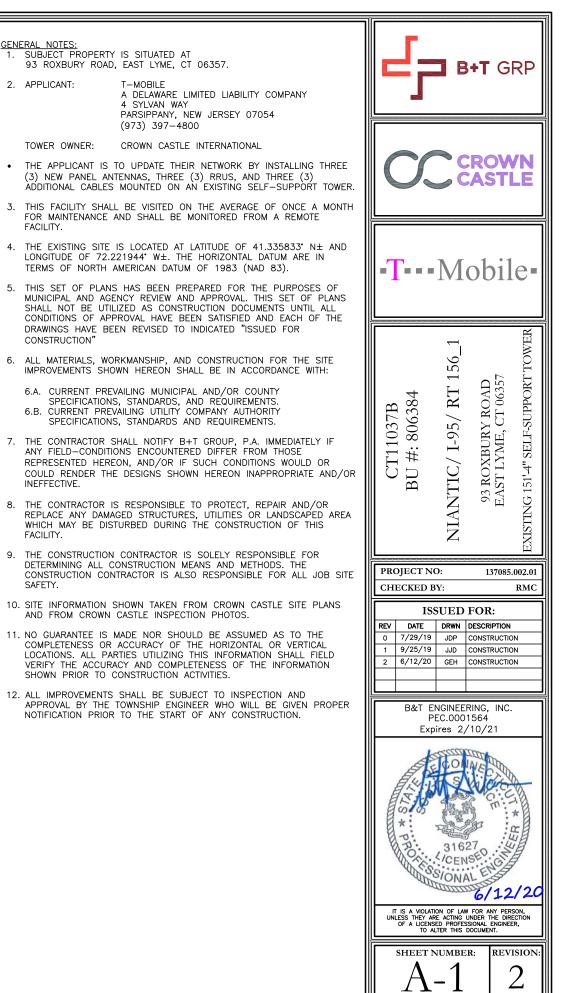

LEGEND							
	EXISTING/DEMOLITION NOTES		INSTALLATION NOTES				
	EXISTING ERICSSON AIR21 KRC118023-1_B2A_B4P ANTENNA TO REMAIN (TOTAL OF 3)	1	INSTALL RFS APXVAARR24_43-U-NA20 (8 FT) ANTENNAS ON EXISTING MOUNT. PROVIDE NEW 2 7/8" OD SCH.40 PIPE MAST (LENGTH TO BE V.I.F) (TYP. OF 1 PER SECTOR, TOTAL OF 3)				
B	EXISTING TMA TO REMAIN (TOTAL OF 3)	2	INSTALL RADIO 4449 B12/B71 (TYP. OF 1 PER SECTOR, TOTAL OF 3)				
\odot	EXISTING ANDREW LNX-6515DS-A1M ANTENNA TO BE REMOVED (TOTAL OF 3)	3	INSTALL (3) 6×12 HCS FIBER. RUN FROM EQUIPMENT TO ANTENNAS FOLLOWING EXISTING ROUTING				
D	EXISTING RRUS11 B12 RADIO TO BE REMOVED (TOTAL OF 3)	4	INSTALL (2) NEW BB6630 IN EXISTING 6131 CABINET				
(E)	EXISTING ERICSSON AIR21 KRC118023-1_B2P_B4A ANTENNA TO REMAIN (TOTAL OF 3)						
F	EXISTING 9X18 HCS FIBER TO REMAIN (TOTAL OF 1)						
(6)	EXISTING 1 5/8" COAX TO REMAIN (TOTAL OF 6)						
$\langle H \rangle$	REMOVE (1) EXISTING DUS41 FROM EXISTING 6131 CABINET						
	REMOVE (1) EXISTING XMU FROM EXISTING 6131 CABINET						

			AN	TENNA /	AND C	ABLE S	SCHEDULE				
SECTOR	POSITION	EXISTING ANTENNAS	PROPOSED ANTENNA CONFIGURATION		E-TILT	M-TILT	ANTENNA CENTERLINE	TMA/RRU	CABLES	JUMPER TYPE	CABLE LENGTH
30° — ALPHA	A1	RFS APXVAARR24_43-U-NA20	LTE	B71 B12	2 / 2	0.	103'–0"	0/1	(1) 6x12 HCS FIBER	DC/FIBER & 1/2" COAX	153'—0"
	A2	ERICSSON AIR21 KRC118023-1_B2A_B4P	UMTS GSM	RU22	2•/2•	0*		1/0	(1) 9x18 HCS FIBER(1) 6X12 HCS FIBER	DC/FIBER	153'-0"
	A3	ERICSSON AIR21 KRC118023-1_B2P_B4A	LTE	B2 B4	2•	0°		0/0	(2) 1 5/8" COAX (1) 6x12 HCS FIBER	DC/FIBER	153'-0"
	B1	RFS APXVAARR24_43-U-NA20	LTE	B71 B12	2°/2°	0.		0/1	SHARED FIBER	DC/FIBER & 1/2" COAX	153'-0"
150° – BETA	B2	ERICSSON AIR21 KRC118023-1_B2A_B4P	UMTS GSM	RU22	4°/4°	0°	103'-0"	1/0	SHARED FIBER	DC/FIBER	153'-0"
	В3	ERICSSON AIR21 KRC118023-1_B2P_B4A	LTE	B2 B4	2*	0°		0/0	(2) 1 5/8" COAX SHARED FIBER	DC/FIBER	153'-0"
270° — GAMMA	C1	RFS APXVAARR24_43-U-NA20	LTE	B71 B12	2°/2°	0.		0/1	SHARED FIBER	DC/FIBER & 1/2" COAX	153'–0"
	C1	ERICSSON AIR21 KRC118023-1_B2A_B4P	UMTS GSM	RU22	2•/2•	0°	103'-0"	1/0	SHARED FIBER	DC/FIBER	153'-0"
	C2	ERICSSON AIR21 KRC118023-1_B2P_B4A	LTE	B2 B4	2°	0°		0/0	(2) 1 5/8" COAX SHARED FIBER	DC/FIBER	153'-0"

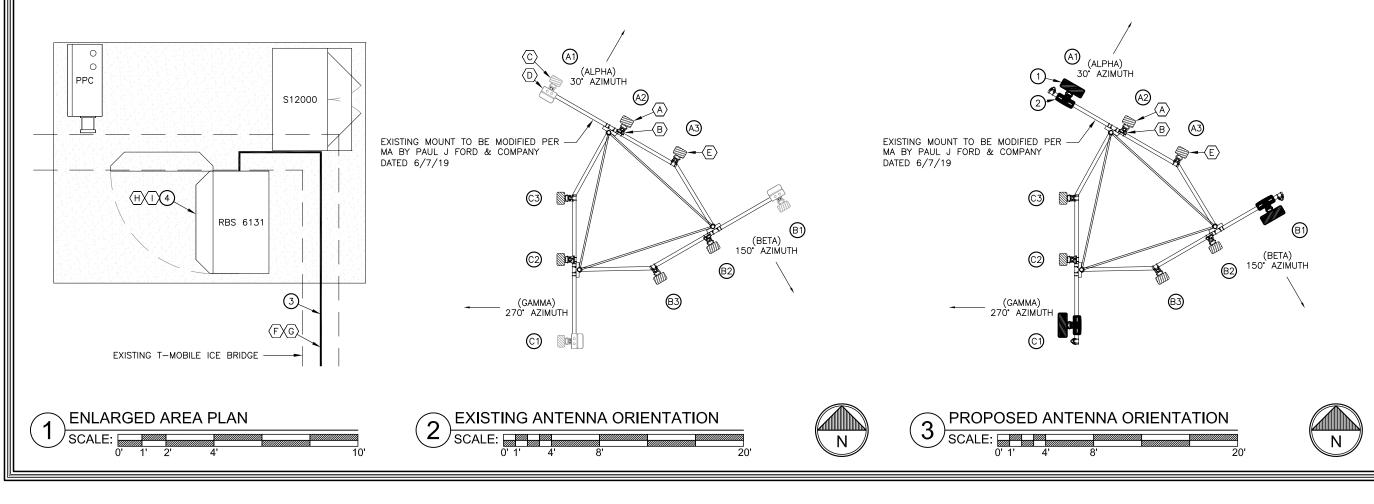

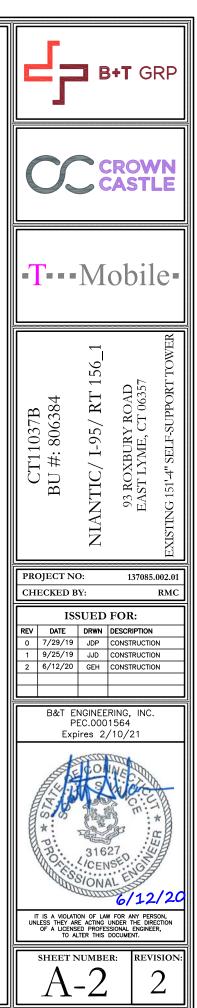


	LEGEND							
	EXISTING/DEMOLITION NOTES		INSTALLATION NOTES					
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F	EXISTING 9X18 HCS FIBER TO REMAIN (TOTAL OF 1)							
(6)	EXISTING 1 5/8" COAX TO REMAIN (TOTAL OF 6)							


EXISTING MOUNT TO BE MODIFIED PER MOUNT ANALYSIS BY PAUL J. FORD & COMPANY DATED 6/7/19.

STRUCTURAL ANALYSIS NOTE:
REFER TO STRUCTURAL ANALYSIS OR STRUCTURAL LETTER FOR APPROVAL OF ADDITIONAL NEW APPURTENANCES.
LEGEND:

EXISTING

_____ FUTURE

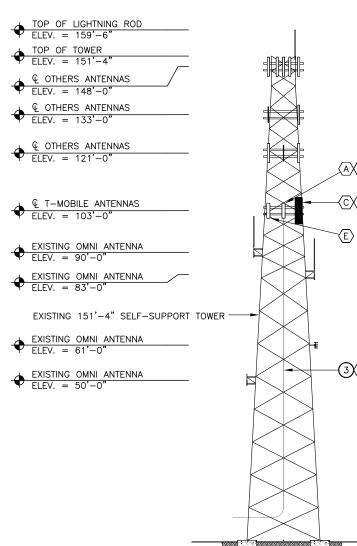

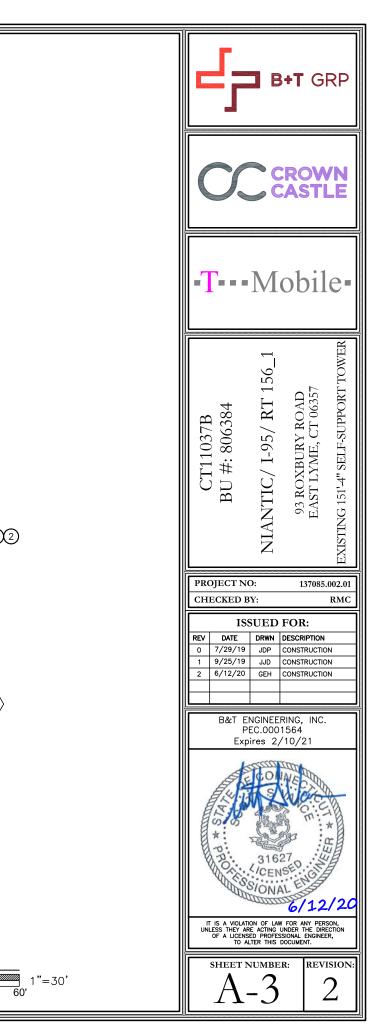


(A)(B)

-CDD2


- **3** F/G


45'

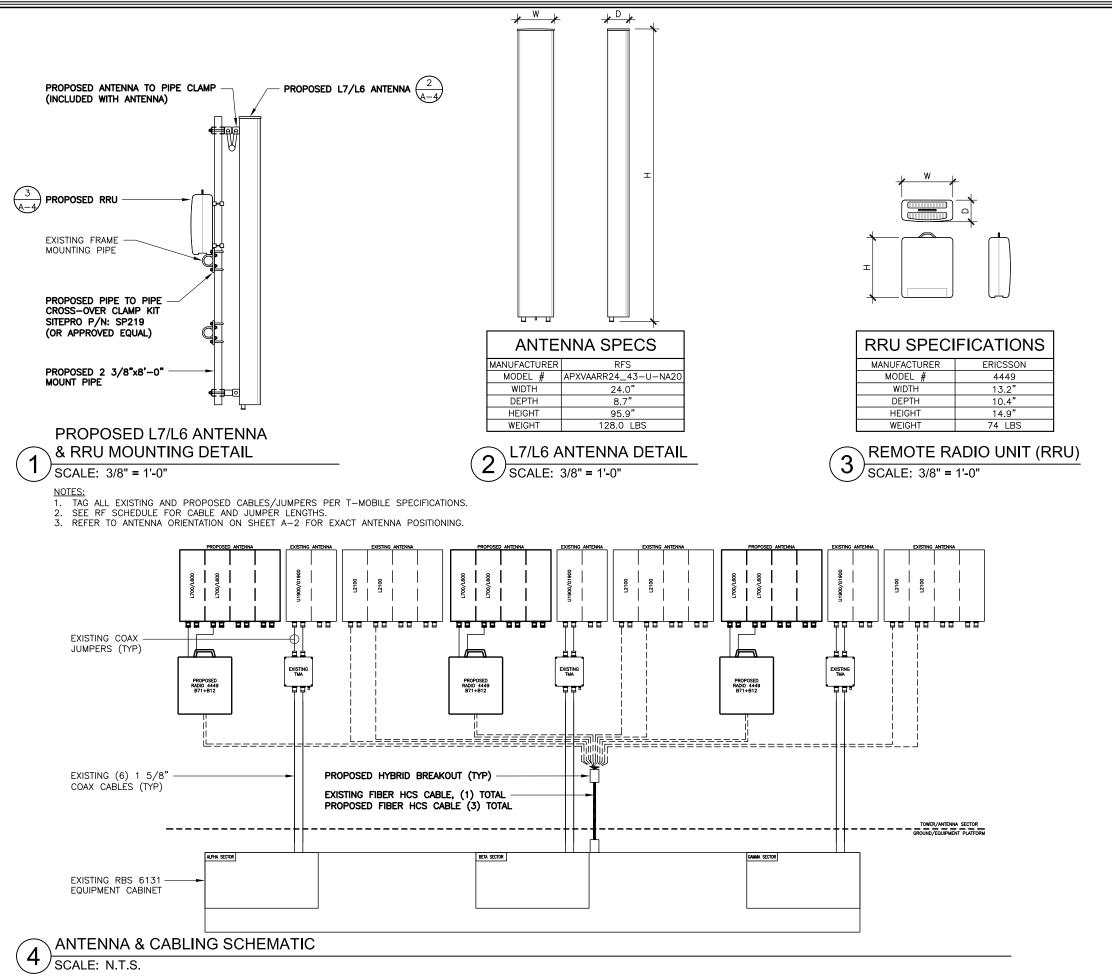

7085_806384_NLN 136 943455.dwg — Sheet:A-4 — User: rcarson — Jun 12, 2020 ·



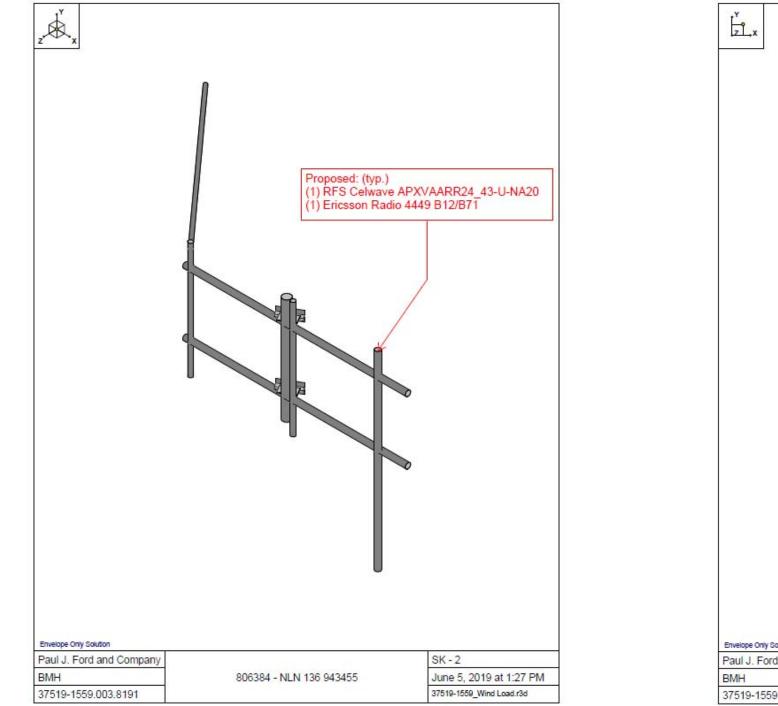

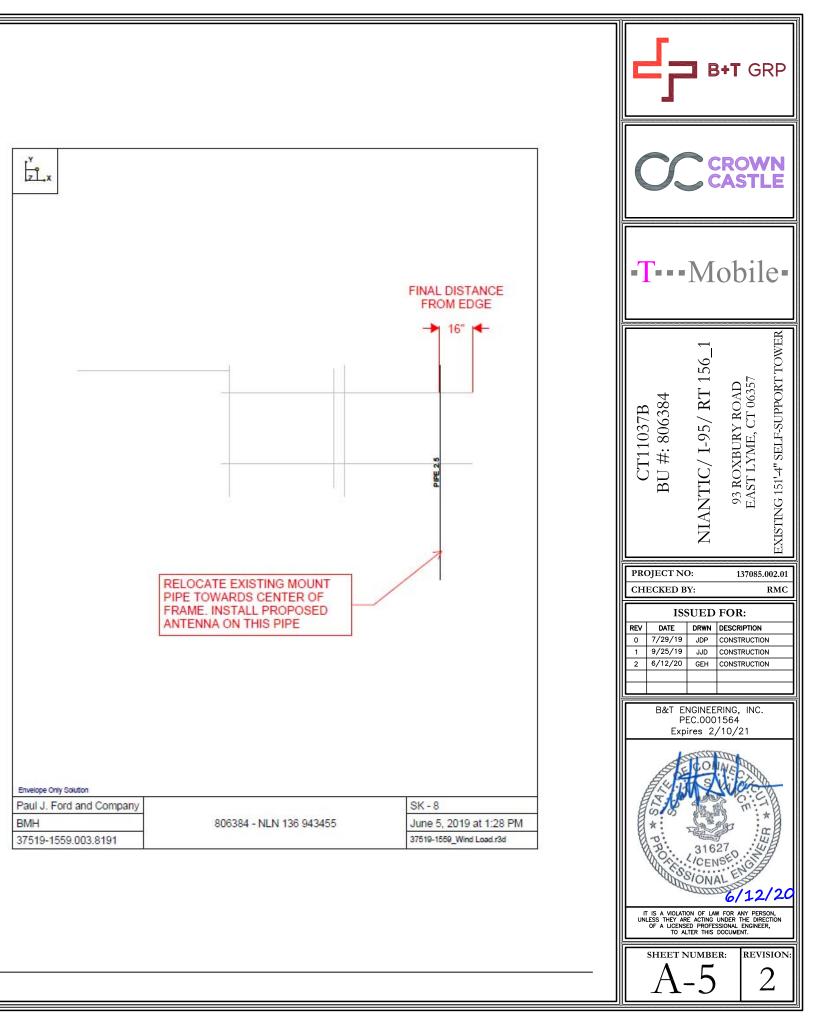

MOUNT MODIFICATION 1

SCALE: N.T.S.

FINAL PANEL SCHEDULE									
LOAD	POLES AMPS	AMPS	BUS		AMPS	POLES	LOAD		
LOND	TOLLS		L1	L2		FOLES		LOND	
GFCI	1	20A	1	7	60A	2		SURGE	
RBS 6131	2	100A	2	8	OUA	2	BTS		
KB3 8151	2	TUUA	3	9	50A	2			
			4	10	JUA	2		ЫЗ	
RATED VOLTAGE: ■120/240 □ 1	PHASE, C	3 WIRE	BRANC	H POI	LES: ■12		30 🗆 42	APPROVED MF'RS	
RATED AMPS: □100 ■200 □400 □	CABINET: ■SURFACE □FLUSH					NEMA □1 ■3R □4X			
□ MAIN LUGS ONLY MAIN 200 AMPS ■ BREAKER	HINGED DOOR					■ KEYED DOOR LATCH			
□FUSED ■CIRCUIT BREAKER BRANCH DEVICE	D TO BE GFCI BREAKERS FULL NEUTRAL BUS GROUND BAR								
ALL BREAKERS MUST BE RATED TO INTERRUPT A SHORT CIRCUIT ISC OF 10,000 AMPS SYMMETRICAL									

FINAL PANEL DESIGN AND CALCULATIONS FOR WIRE SIZE WERE BASED OFF OF EXISTING PHOTOS

FINAL T-MOBILE PANEL DETAIL 1

SCALE: N.T.S.

