

April 14, 2023

Attorney Melanie Bachman Acting Executive Director Connecticut Siting Council Ten Franklin Square New Britain, CT 06501

EM-T-MOBILE-020-220907 T-Mobile Site ID CTHA560B 87 Monce Road, Burlington, CT Notice of Compliance with Conditions and Construction Completion

Dear Attorney Bachman:

The T-Mobile site referenced above was approved by The Connecticut Siting Council (Council) on December 6, 2021 as an Exempt Modification. T-Mobile is now requesting the close out of the approval and hereby acknowledges the following conditions were met:

- 1. Prior to T-Mobile's antenna installation, antenna mount modifications shall be installed in accordance with the Mount Analysis prepared by American Tower Corporation dated June 16, 2022 and stamped and signed by Esha Kaushal Modi;
- 2. Within 45 days following completion of equipment installation, T-Mobile shall provide documentation certified by a Professional Engineer that its installation complied with the recommendations of the Mount Analysis;
- 3. Any deviation from the proposed modification as specified in this notice and supporting materials submitted to the Council shall render this acknowledgement invalid;
- 4. Any material changes to this modification as proposed shall require the filing of a new notice with the Council;
- 5. The Council shall be notified in writing at least two weeks prior to the commencement of site construction activities;



- 6. Within 45 days after completion of construction, the Council shall be notified in writing that construction has been completed;
- 7. Deployment of any 5G services must comply with FCC and FAA guidance relative to air navigation, as applicable;
- 8. Any nonfunctioning antenna and associated antenna mounting equipment, or other equipment at this facility owned and operated by T-Mobile shall be removed within 60 days of the date the antenna or equipment ceased to function;
- 9. The validity of this action shall expire one year from the date of this letter; and
- 10. The applicant may file a request for an extension of time beyond the one year deadline provided that such request is submitted to the Council not less than 60 days prior to the expiration.

The attached PE Closeout Letter dated April 10, 2023 provides evidence of compliance with the conditions outlined by the Council. In addition, T-Mobile hereby notifies the Council that construction of the acknowledged modifications was completed as of February 22, 2023.

Sincerely,

Victoria Masse

Victoria Masse Zoning and Permitting Northeast Site Solutions



April 10, 2023

To: Town of Burlington, CT – Building Department 200 Spielman Highway Burlington, CT 06013

Re: ATC Site Name: BURLINGTON 2 ATC Site Number: 209185 T-Mobile Site Number: CTHA560B ATC Site Address: 87 MONCE ROAD BURLINGTON, CT 6013

To whom it may concern,

T-Mobile installed at the telecommunications facility at the above location. We have reviewed the provided construction photos and As-Built Drawings and have provided comments on the installation in the following summary. The installation was found to be in compliance with the issued construction drawings and applicable building codes.

Equipment Removed:

• (6) Antennas, (3) RRU's, (1) Control Cable

Equipment Installed:

• (6) Antennas, (3) RRU's, (1) Hybrid Cable, Mount Modifications, (1) BB 6648, (1) PSU 4813 Discrepancy Note:

None Noted

Please contact the engineer of record at <u>AE@americantower.com</u> with any questions regarding this matter.

Thank you, American Tower Corporation






Photo	Description
DTREECTION 41. 73915 W ACCOUNT WAS AND	Description: Antenna Tape Drop: • Installation at RAD 100' <u>Note:</u> Construction drawings depict a RAD of 100' <u>Recommendation:</u> No Action Required
DRECTION 26 deed(T) 07.90780*W 00	 <u>Description</u>: Installation of Equipment: Installation of 2 Antennas, 1 RRU, and mount modifications Alpha Sector <u>Recommendation</u>: No Action Required
DIECTION 142 Geg(T) 072.0979°W 072.0970°W 072.0900°W 072.0900°W 072.0900°W 072.0900°W 072.0900°W 072.0900°W 072.0900°W 0700°W 070000	 <u>Description</u>: Installation of Equipment: Installation of 2 Antennas, 1 RRU, and mount modifications Beta Sector <u>Recommendation</u>: No Action Required



Photo	Description
DIRECTION 220 deg(T) 072.90785 0 072.90785 0 0 0 0 0 0 0 0 0 0 0 0 0 0 0 0 0 0 0	 <u>Description</u>: Installation of Equipment: Installation of 2 Antennas, 1 RRU, and mount modifications Gamma Sector <u>Recommendation</u>: No Action Required
	 <u>Description:</u> Installation of Equipment: (1) BB 6648, (1) PSU 4813 <u>Recommendation:</u> No Action Required



Stamped Construction Drawings

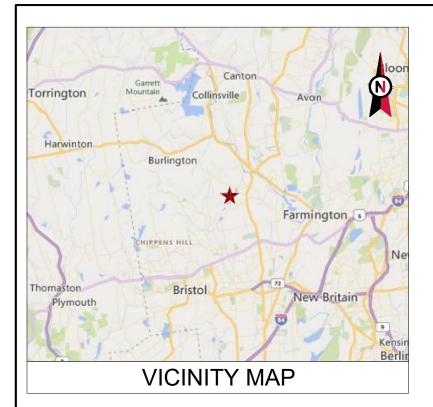



AMERICAN TOWER®

ATC SITE NAME: BURLINGTON 2 ATC SITE NUMBER: 209185 T-MOBILE SITE NAME: CTHA560B T-MOBILE SITE NUMBER: CTHA560B SITE ADDRESS: 87 MONCE ROAD BURLINGTON, CT 6013



T-MOBILE L600 AMENDMENT PLAN 67E97DB2 MUAC CONFIGURATION

COMPLIANCE CODE	PROJECT S	SUMMARY	PROJECT DESCRIPTION		SHEET INDEX			
ALL WORK SHALL BE PERFORMED AND MATERIALS INSTALLED IN ACCORDANCE WITH THE CURRENT EDITIONS OF THE	SITE ADD		THE PROPOSED PROJECT INCLUDES MODIFYING GROUND BASED AND TOWER MOUNTED EQUIPMENT AS INDICATED PER BELOW:	SHEET NO:	DESCRIPTION:	REV:	DATE:	BY:
FOLLOWING CODES AS ADOPTED BY THE LOCAL GOVERNMENT AUTHORITIES. NOTHING IN THESE PLANS IS	87 MONCI BURLINGTO		TOWER WORK: REMOVE (6) ANTENNA(s), (3) RRU(s), AND (1) .78" 8 AWG 6 CONTROL	G-001	TITLE SHEET	0	07/07/22	AP
TO BE CONSTRUED TO PERMIT WORK NOT CONFORMING TO THESE CODES.	COUNTY: H.	ARTFORD	CABLE(s)	G-002	GENERAL NOTES	0	07/07/22	AP
1. INTERNATIONAL BUILDING CODE (IBC)	GEOGRAPHIC C	OORDINATES:	INSTALL MOUNT MODIFICATION(s), (6) ANTENNA(s), (3) RRU(s), AND (1) 1.99" HYBRID TRUNK 6/24 4AWG CABLE(s)	C-101	DETAILED SITE PLAN	0	07/07/22	AP
2. NATIONAL ELECTRIC CODE (NEC) 3. LOCAL BUILDING CODE	LATITUDE: 4		EXISTING (3) ANTENNA(s), (3) RRU(s), AND (2) 1.4" HYBRID 6X12 HCS	C-201	TOWER ELEVATION	0	07/07/22	AP
4. CITY/COUNTY ORDINANCES	LONGITUDE: - GROUND ELEVAT		CABLE(s) TO REMAIN	C-401	ANTENNA INFORMATION & SCHEDULE	0	07/07/22	AP
			<u>GROUND WORK:</u> INSTALL (1) BB 6648 AND (1) PSU 4813	C-501	CONSTRUCTION DETAILS	0	07/07/22	AP
			EXISTING (1) RBS 6102 MU AC CABINET AND (1) HFC CABINET TO	E-501	GROUNDING DETAILS	0	07/07/22	AP
				R-601	SUPPLEMENTAL			
				R-602	SUPPLEMENTAL			
	PROJEC	T TEAM	1. THE FACILITY IS UNMANNED. 2. A TECHNICIAN WILL VISIT THE SITE APPROXIMATELY ONCE A	R-603	SUPPLEMENTAL			
	TOWER OWNER:	APPLICANT:	MONTH FOR ROUTINE INSPECTION AND MAINTENANCE. 3. THE PROJECT WILL NOT RESULT IN ANY SIGNIFICANT LAND	R-604	SUPPLEMENTAL			
	AMERICAN TOWER	T-MOBILE	DISTURBANCE OR EFFECT OF STORM WATER DRAINAGE. 4. NO SANITARY SEWER, POTABLE WATER OR TRASH DISPOSAL IS REQUIRED. 5. HANDICAP ACCESS IS NOT REQUIRED. 6. THE PROJECT DEPICTED IN THESE PLANS QUALIFIES AS AN ELIGIBLE FACILITIES REQUEST ENTITLED TO EXPEDITED REVIEW UNDER 171 SC & 1456 (A) AS A MODIFICATION OF AN					
	10 PRESIDENTIAL WAY WOBURN, MA 01801							
	ENGINEER:							
	ATC TOWER SERVICES, LLC		REVIEW UNDER 47 U.S.C. § 1455(A) AS A MODIFICATION OF AN EXISTING WIRELESS TOWER THAT INVOLVES THE					
UTILITY COMPANIES	3500 REGENCY PKWY STE 100 CARY, NC 27518		COLLOCATION, REMOVAL, AND/OR REPLACEMENT OF TRANSMISSION EQUIPMENT THAT IS NOT A SUBSTANTIAL CHANGE UNDER CFR § 1.61000 (B)(7).					
POWER COMPANY: UNKNOWN PHONE: N/A	PROPERTY OWNER: TOWN OF BURLINGTON		PROJECT LOCATION DIRECTIONS					
TELEPHONE COMPANY: UNKNOWN PHONE: N/A	87 MONCE ROAD BURLINGTON, CT 6013		HEAD NORTH TOWARD BRADLEY INTERNATIONAL AIRPORT. SLIGHT LEFT ONTO BRADLEY INTERNATIONAL AIRPORT. CONTINUE STRAIGHT. KEEP RIGHT TO CONTINUE TOWARD BRADLEY INTERNATIONAL AIRPORT CON. CONTINUE ONTO BRADLEY INTERNATIONAL AIRPORT CON. TAKE THE CT-20 W EXIT TOWARD E GRANBY/GRANBY. CONTINUE ONTO CT-20 W. USE THE LEFT					
811.			2 LANES TO TURN LEFT ONTO INTERNATIONAL DR. AT THE TRAFFIC CIRCLE, TAKE THE 1ST EXIT ONTO SEYMOUR RD. CONTINUE ONTO STATE HWY 540. TURN LEFT ONTO CT-189 S. TURN RIGHT ONTO ELM ST. ELM ST TURNS SLIGHTLY LEFT AND BECOMES CT-315 WITARIFFVILLE RD. TURN LEFT ONTO QUARRY RD. MERGE ONTO TERRY'S PLAIN RD. CONTINUE STRAIGHT ONTO E WEATOGUE ST. TURN RIGHT ONTO CT-168 W. TURN LEFT ONTO NOR RD. CONTINUE ONTO CONTINUE ONTO CT-180 W. TURN LEFT ONTO NOR RD. CONTINUE ONTO					
Know what's below. Call before you dig.			CT-10 S. TURN RIGHT ONTO OLD FARMS RD. SLIGHT LEFT ONTO THOMPSON RD. TURN LEFT ONTO CT-167 S. TURN RIGHT TO STAY ON CT-167 S. TURN RIGHT ONTO CT-4 W. TURN LEFT ONTO CT-177 S. TURN RIGHT ONTO WEBSTER ST. TURN LEFT ONTO RIVER RD. TURN RIGHT ONTO BURLINGTON RD. CONTINUE ONTO GEORGE WASHINGTON TURNPIKE. SLIGHT LEFT ONTO BURLINGTON RD. CONTINUE ONTO GEORGE WASHINGTON TURNPIKE. SLIGHT LEFT ONTO BURLINGTON RD. CONTINUE ONTO REVER RIGHT.					



AMERICAN TOWER®
A.T. ENGINEERING SERVICE, PLLC 3500 REGENCY PARKWAY
SUITE 100 CARY, NC 27518
PHONE: (919) 468-0112 COA: PEC.0001553
THE USE AND PUBLICATION OF THESE DRAWINGS SHALL BE RESTRICTED TO THE ORIGINAL SITE FOR WHICH THEY ARE PREPARED. ANY USE OR DISCLOSURE OTHER THAN THAT WHICH RELATES TO AMERICAN TOWER OR THE SPECIFIED CARRIER IS STRICTLY PROHIBITED. NEITHER THE ARCHITECT NOR THE ENGINEER WILL BE PROVIDING ON-SITE CONSTRUCTION REVIEW OF THIS PROJECT. CONTRACTOR(S) MUST VERIFY ALL DIMENSIONS AND ADVISE AMERICAN TOWER OR THE SPECIFIED CARRIER OF ANY DISCREPANCIES. ANY PRIOR ISSUANCE OF THIS DRAWING IS SUPERSEDED BY THE LATEST VERSION.
REV. DESCRIPTION BY DATE
Image: Marcine Construction AP 07/07/22
<u>^</u>
$\bigwedge^{\bigtriangleup}$
ATC SITE NUMBER: 209185
ATC SITE NAME: BURLINGTON 2
T-MOBILE SITE NAME: CTHA560B
SITE ADDRESS: 87 MONCE ROAD BURLINGTON, CT 6013
SEAL:
Trong Mobile ATC JOB NO: 14097402_D1 CUSTOMER ID: CTHA560B
CUSTOMER #: CTHA560B
TITLE SHEET
SHEET NUMBER: REVISION:
G-001 0

GENERAL CONSTRUCTION NOTES:

- OWNER FURNISHED MATERIALS, T-MOBILE "THE COMPANY" WILL PROVIDE AND THE CONTRACTOR WILL INSTALL
 - A. BTS EQUIPMENT FRAME (PLATFORM) AND ICEBRIDGE SHELTER (GROUND BUILD/CO-LOCATE ONLY)
 - AC/TELCO INTERFACE BOX (PPC)

 - D. TOWERS, MONOPOLES TOWER LIGHTING
 - GENERATORS & LIQUID PROPANE TANK
 - ANTENNA STANDARD BRACKETS, FRAMES AND PIPES FOR MOUNTING
- ANTENNAS (INSTALLED BY OTHERS)
- TRANSMISSION LINE TRANSMISSION LINE JUMPERS
- TRANSMISSION LINE CONNECTORS WITH WEATHERPROOFING KITS
- TRANSMISSION LINE GROUND KITS
- HANGERS HOISTING GRIPS
- O. BTS EQUIPMENT
- 2 THE CONTRACTOR IS RESPONSIBLE TO PROVIDE ALL OTHER MATERIALS FOR THE COMPLETE INSTALLATION OF THE SITE INCLUDING, BUT NOT LIMITED TO, SUCH MATERIALS AS FENCING, STRUCTURAL STEEL SUPPORTING SUB-FRAME FOR PLATFORM, ROOFING LABOR AND MATERIALS, GROUNDING RINGS, GROUNDING WIRES COPPER-CLAD OR XIT CHEMICAL GROUND ROD(S), BUSS BARS, TRANSFORMERS AND DISCONNECT SWITCHES WHERE APPLICABLE, TEMPORARY ELECTRICAL POWER, CONDUIT, LANDSCAPING COMPOUND STONE, CRANES, CORE DRILLING, SLEEPERS AND RUBBER MATTING, REBAR, CONCRETE CAISSONS, PADS AND/OR AUGER MOUNTS, MISCELLANEOUS FASTENERS, CABLE TRAYS, NON-STANDARD ANTENNA FRAMES AND ALL OTHER MATERIAL AND LABOR REQUIRED TO COMPLETE THE JOB ACCORDING TO THE DRAWINGS AND SPECIFICATIONS. IT IS THE POSITION OF T-MOBILE TO APPLY FOR PERMITTING AND CONTRACTOR RESPONSIBLE FOR PICKUP AND PAYMENT OF REQUIRED PERMITS
- ALL WORK SHALL CONFORM TO ALL CURRENT APPLICABLE FEDERAL, STATE, AND LOCAL CODES, INCLUDING ANSI/EIA/TIA-222, AND COMPLY WITH ATC CONSTRUCTION SPECIFICATIONS
- CONTRACTOR SHALL CONTACT LOCAL 811 FOR IDENTIFICATION OF UNDERGROUND UTILITIES PRIOR TO START OF CONSTRUCTION
- CONTRACTOR SHALL BE RESPONSIBLE FOR COORDINATING ALL REQUIRED INSPECTIONS.
- ALL DIMENSIONS TO, OF, AND ON EXISTING BUILDINGS, DRAINAGE STRUCTURES, AND SITE IMPROVEMENTS SHALL BE VERIFIED IN FIELD BY CONTRACTOR WITH ALL DISCREPANCIES REPORTED TO THE ENGINEER.
- DO NOT CHANGE SIZE OR SPACING OF STRUCTURAL ELEMENTS 7
- 8 DETAILS SHOWN ARE TYPICAL: SIMILAR DETAILS APPLY TO SIMILAR CONDITIONS UNLESS
- THESE DRAWINGS DO NOT INCLUDE NECESSARY COMPONENTS FOR CONSTRUCTION 9. SAFETY WHICH SHALL BE THE SOLE RESPONSIBILITY OF THE CONTRACTOR.
- CONTRACTOR SHALL BRACE STRUCTURES UNTIL ALL STRUCTURAL ELEMENTS NEEDED 10. FOR STABILITY ARE INSTALLED. THESE ELEMENTS ARE AS FOLLOWS: LATERAL BRACING, ANCHOR BOLTS, ETC.
- CONTRACTOR SHALL DETERMINE EXACT LOCATION OF EXISTING UTILITIES. GROUNDS 11. DRAINS, DRAIN PIPES, VENTS, ETC, BEFORE COMMENCING WORK
- INCORRECTLY FABRICATED, DAMAGED, OR OTHERWISE MISFITTING OR NONCONFORMING MATERIALS OR CONDITIONS SHALL BE REPORTED TO THE T-MOBILE 12. 1. REP PRIOR TO REMEDIAL OR CORRECTIVE ACTION. ANY SUCH REMEDIAL ACTION SHALL REQUIRE WRITTEN APPROVAL BY THE T-MOBILE REP PRIOR TO PROCEEDING.
- EACH CONTRACTOR SHALL COOPERATE WITH THE T-MOBILE REP, AND COORDINATE HIS WORK WITH THE WORK OF OTHERS. 13.
- CONTRACTOR SHALL REPAIR ANY DAMAGE CAUSED BY CONSTRUCTION OF THIS 14. PROJECT TO MATCH EXISTING PRE-CONSTRUCTION CONDITIONS TO THE SATISFACTION OF THE T-MOBILE CONSTRUCTION MANAGER
- ALL CABLE/CONDUIT ENTRY/EXIT PORTS SHALL BE WEATHERPROOFED DURING 15. INSTALLATION LISING A SILICONE SEALANT
- WHERE EXISTING CONDITIONS DO NOT MATCH THOSE SHOWN IN THIS PLAN SET. 16. CONTRACTOR SHALL NOTIFY THE T-MOBILE REP AND ENGINEER OF RECORD IMMEDIATELY
- 17. CONTRACTOR SHALL ENSURE ALL SUBCONTRACTORS ARE PROVIDED WITH A COMPLETE AND CURRENT SET OF DRAWINGS AND SPECIFICATIONS FOR THIS PROJECT
- CONTRACTOR SHALL REMOVE ALL RUBBISH AND DEBRIS FROM THE SITE AT THE END OF 18. EACH DAY.
- CONTRACTOR SHALL COORDINATE WORK SCHEDULE WITH AMERICAN TOWER 19. CORPORATION (ATC) AND TAKE PRECAUTIONS TO MINIMIZE IMPACT AND DISRUPTION OF OTHER OCCUPANTS OF THE FACILITY.
- CONTRACTOR SHALL FURNISH T-MOBILE AND AMERICAN TOWER CORPORATION (ATC) 20. VITH A PDF MARKED UP AS-BUILT SET OF DRAWINGS UPON COMPLETION OF WOR
- PRIOR TO SUBMISSION OF BID, CONTRACTOR SHALL COORDINATE WITH T-MOBILE REP 2. 21. TO DETERMINE WHAT, IF ANY, ITEMS WILL BE PROVIDED. ALL ITEMS NOT PROVIDED SHALL BE PROVIDED AND INSTALLED BY THE CONTRACTOR. CONTRACTOR WILL INSTALL ALL ITEMS PROVIDED.

- 22. PRIOR TO SUBMISSION OF BID, CONTRACTOR SHALL COORDINATE WITH T-MOBILE REP TO DETERMINE IF ANY PERMITS WILL BE OBTAINED BY CONTRACTOR. ALL REQUIRED PERMITS NOT OBTAINED BY T-MOBILE MUST BE OBTAINED, AND PAID FOR, BY THE CONTRACTOR
- CONTRACTOR SHALL INSTALL ALL SITE SIGNAGE IN ACCORDANCE WITH T-MOBILE SPECIFICATIONS AND REQUIREMENTS.
- ICE BRIDGE (CABLE TRAY WITH COVER) (GROUND BUILD/CO-LOCATE ONLY, GC TO FURNISH AND INSTALL FOR ROOFTOP INSTALLATION) 24. CONTRACTOR SHALL SUBMIT ALL SHOP DRAWINGS TO T-MOBILE FOR REVIEW AND APPROVAL PRIOR TO FABRICATION.
 - ALL EQUIPMENT SHALL BE INSTALLED ACCORDING TO MANUFACTURER'S SPECIFICATIONS AND LOCATED ACCORDING TO T-MOBILE SPECIFICATIONS, AND AS SHOWN IN THESE PLANS
 - 26. THE CONTRACTOR SHALL SUPERVISE AND DIRECT THE PROJECT DESCRIBED HEREIN THE CONTRACTOR SHALL BE SOLELY RESPONSIBLE FOR ALL THE CONSTRUCTION MEANS, METHODS, TECHNIQUES, SEQUENCES AND PROCEDURES AND FOR COORDINATING ALL PORTIONS OF THE WORK UNDER THE CONTRACT.
 - CONTRACTOR SHALL NOTIFY T-MOBILE REP A MINIMUM OF 48 HOURS IN ADVANCE OF POURING CONCRETE OR BACKFILLING ANY UNDERGROUND UTILITIES, FOUNDATIONS OR 27. SEALING ANY WALL, FLOOR OR ROOF PENETRATIONS FOR ENGINEERING REVIEW AND
 - CONTRACTOR SHALL BE RESPONSIBLE FOR SITE SAFETY INCLUDING COMPLIANCE WITH 28. ALL APPLICABLE OSHA STANDARDS AND RECOMMENDATIONS AND SHALL PROVIDE ALL NECESSARY SAFETY DEVICES INCLUDING PPE AND PPM AND CONSTRUCTION DEVICES SUCH AS WELDING AND FIRE PREVENTION, TEMPORARY SHORING, SCAFFOLDING, TRENCH BOXES/SLOPING, BARRIERS, ETC.
 - THE CONTRACTOR SHALL PROTECT AT HIS OWN EXPENSE ALL EXISTING FACILITIES AND SUCH OF HIS NEW WORK LIABLE TO INJURY DURING THE CONSTRUCTION PERIOD. ANY DAMAGE CAUSED BY NEGLECT ON THE PART OF THIS CONTRACTOR OR HIS REPRESENTATIVES, OR BY THE ELEMENTS DUE TO NEGLECT ON THE PART OF THIS CONTRACTOR OR HIS REPRESENTATIVES, EITHER TO THE EXISTING WORK, OR TO HIS WORK OR THE WORK OF ANY OTHER CONTRACTOR, SHALL BE REPAIRED AT HIS EXPENSE TO THE OWNER'S SATISFACTION.
 - 30. ALL WORK SHALL BE INSTALLED IN A FIRST CLASS, NEAT AND WORKMANLIKE MANNER BY MECHANICS SKILLED IN THE TRADE INVOLVED. THE QUALITY OF WORKMANSHIP SHALL BE SUBJECT TO THE APPROVAL OF THE T-MOBILE REP. ANY WORK FOUND BY THE T-MOBILE REP TO BE OF INFERIOR QUALITY AND/OR WORKMANSHIP SHALL BE REPLACED AND/OR REWORKED AT CONTRACTOR EXPENSE UNTIL APPROVAL IS OBTAINED
 - 31. IN ORDER TO ESTABLISH STANDARDS OF QUALITY AND PERFORMANCE, ALL TYPES OF MATERIALS LISTED HEREINAFTER BY MANUFACTURER'S NAMES AND/OR MANUFACTURER'S CATALOG NUMBER SHALL BE PROVIDED BY THESE MANUFACTURERS AS SPECIFIED.
 - T-MOBILE FURNISHED EQUIPMENT SHALL BE PICKED-UP AT THE T-MOBILE WAREHOUSE. 32. NO LATER THAN 48HR AFTER BEING NOTIFIED INSURED, STORED, UNCRATE, PROTEC AND INSTALLED BY THE CONTRACTOR WITH ALL APPURTENANCES REQUIRED TO PLACE THE EQUIPMENT IN OPERATION, READY FOR USE. THE CONTRACTOR SHALL BE RESPONSIBLE FOR THE EQUIPMENT AFTER PICKING IT UP.
 - T-MOBILE OR HIS ARCHITECT/ENGINEER RESERVES THE RIGHT TO REJECT ANY 33. EQUIPMENT OR MATERIALS WHICH. IN HIS OWN OPINION ARE NOT IN COMPLIANCE WITH THE CONTRACT DOCUMENTS, EITHER BEFORE OR AFTER INSTALLATION AND THE EQUIPMENT SHALL BE REPLACED WITH EQUIPMENT CONFORMING TO THE REQUIREMENTS OF THE CONTRACT DOCUMENTS BY THE CONTRACTOR AT NO COST TO T-MOBILE OR THEIR ARCHITECT/ENGINEER

SPECIAL CONSTRUCTION ANTENNA INSTALLATION NOTES:

WORK INCLUDED:

29.

- ANTENNA AND COAXIAL CABLES ARE FURNISHED BY T-MOBILE UNDER A SEPARATE CONTRACT. THE CONTRACTOR SHALL ASSIST ANTENNA INSTALLATION CONTRACTOR IN TERMS OF COORDINATION AND SITE ACCESS ERECTION SUBCONTRACTOR SHALL BE RESPONSIBLE FOR THE PROTECTION OF PERSONNEL
- B. INSTALL ANTENNAS AS INDICATED ON DRAWINGS AND T-MOBILE SPECIFICATIONS
- C. INSTALL GALVANIZED STEEL ANTENNA MOUNTS AS INDICATED ON DRAWINGS.
- D. INSTALL FURNISHED GALVANIZED STEEL OR ALUMINUM WAVEGUIDE
- E. CONTRACTOR SHALL PROVIDE FOUR (4) SETS OF SWEEP TESTS USING ANRITZU-PACKARD 8713B RF SCALAR NETWORK ANALYZER. SUBMIT FREQUENCY DOMAIN REFLECTOMETER(FDR) TESTS RESULTS TO THE PROJECT MANAGER. SWEEP TESTS SHALL BE AS PER ATTACHED RFS "MINIMUM FIELD TESTING RECOMMENDED FOR ANTENNA AND HELIAX COAXIAL CABLE SYSTEMS" DATED 10/5/93. TESTING SHALL BE PERFORMED BY AN INDEPENDENT TESTING SERVICE AND BE BOUND AND SUBMITTED WITHIN ONE WEEK OF WORK COMPLETION.
- INSTALL COAXIAL CABLES AND TERMINATING BETWEEN ANTENNAS AND F. EQUIPMENT PER MANUFACTURER'S RECOMMENDATIONS, WEATHERPROOF ALL CONNECTIONS BETWEEN THE ANTENNA AND EQUIPMENT PER MANUFACTURER'S REQUIREMENTS. TERMINATE ALL COAXIAL CABLE THREE (3) FEET IN EXCESS OF ENTRY PORT LOCATION UNLESS OTHERWISE STATED.
- G. ANTENNA AND COAXIAL CABLE GROUNDING:

ALL EXTERIOR #6 GREEN GROUND WIRE "DAISY CHAIN" CONNECTIONS ARE TO BE WEATHER SEALED WITH RFS CONNECTORS/SPLICE WEATHERPROOFING KIT #221213 OR EQUAL

3. ALL COAXIAL CABLE GROUNDING KITS ARE TO BE INSTALLED ON STRAIGHT RUNS OF

COAXIAL CABLE (NOT WITHIN BENDS)


AMERICAN TOWER®
A.T. ENGINEERING SERVICE, PLLC
3500 REGENCY PARKWAY SUITE 100
CARY, NC 27518 PHONE: (919) 468-0112
COA: PEC.0001553
THE USE AND PUBLICATION OF THESE DRAWINGS SHALL BE RESTRICTED TO THE ORIGINAL SITE FOR WHICH THEY ARE PREPARED. ANY USE OR DISCLOSURE OTHER THAN THAT WHICH RELATES TO AMERICAN TOWER OR THE SPECIFIED CARRIER IS STRICTLY PROHIBITED. NEITHER THE ARCHITECT NOR THE ENGINEER WILL BE PROVIDING ON-SITE CONSTRUCTION REVIEW OF THIS PROJECT. CONTRACTOR(S) MUST VERIFY ALL DIMENSIONS AND ADVISE AMERICAN TOWER OR THE SPECIFIED CARRIER OF ANY DISCREPANCIES. ANY PRIOR ISSUANCE OF THIS DRAWING IS SUPERSEDED BY THE LATEST VERSION.
REV. DESCRIPTION BY DATE
☆
ATC SITE NAME: BURLINGTON 2
T-MOBILE SITE NAME: CTHA560B
SITE ADDRESS: 87 MONCE ROAD BURLINGTON, CT 6013
SEAL:
T · · Mobile·
ATC JOB NO: 14097402_D1 CUSTOMER ID: CTHA560B
CUSTOMER #: CTHA560B
GENERAL NOTES
SHEET NUMBER: REVISION:
G-002 0

ALL DISCREPANCIES FROM WHAT IS SHOWN ON THESE CONSTRUCTION DRAWINGS SHALL BE COMMUNICATED TO ATC ENGINEERING IMMEDIATELY FOR CORRECTION OR RE-DESIGN FAILURE TO COMMUNICATE DIRECTLY WITH ATC ENGINEERING OR ANY CHANGES FROM THE DESIGN CONDUCTED WITHOUT PRIOR APPROVAL FROM ATC ENGINEERING SHALL BE THE SOLE **RESPONSIBILITY OF THE GENERAL CONTRACTOR.**


SITE PLAN NOTES:

- THIS SITE PLAN REPRESENTS THE BEST PRESENT KNOWLEDGE AVAILABLE TO THE ENGINEER AT THE TIME OF THIS DESIGN THE CONTRACTOR SHALL VISIT THE SITE PRIOR TO CONSTRUCTION AND VERIFY ALL EXISTING CONDITIONS RELATED TO THE SCOPE OF WORK FOR THIS PROJECT
- ICE BRIDGE, CABLE LADDER, COAX PORT, AND 2. COAX CABLE ARE SHOWN FOR REFERENCE ONLY. CONTRACTOR SHALL CONFIRM THE EXACT LOCATION OF ALL PROPOSED AND EXISTING EQUIPMENT AND STRUCTURES DEPICTED ON THIS PLAN. BEFORE UTILIZING EXISTING CABLE SUPPORTS, COAX PORTS, INSTALLING NEW PORTS OR ANY OTHER EQUIPMENT, CONTRACTOR SHALL VERIFY ALL ASPECTS OF THE COMPONENTS MEET THE ATC SPECIFICATIONS.
- NO ELECTRICAL SCOPE IS INCLUDED IN THIS 3. PROJECT.

	LEGEND
S ATS B CSC D E F GEN G HH, V IB K LC M PB PP T TRN	GROUNDING TEST WELL AUTOMATIC TRANSFER SWITCH BOLLARD CELL SITE CABINET DISCONNECT ELECTRICAL FIBER GENERATOR GENERATOR RECEPTACAL HAND HOLE, VAULT ICE BRIDGE KENTROX BOX LIGHTING CONTROL METER PULL BOX POWER POLE TELCO TRANSFORMER CHAINLINK FENCE

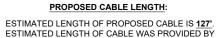


- CUSTOMER OR CALCULATED BY ADDING THE RAD CENTER AND THE DISTANCE FROM THE SHELTER ENTRY PLATE TO THE TOWER (ALONG THE ICE BRIDGE) AND A SAFETY FACTOR MEASUREMENT OF 15% (OF THE TWO PREVIOUS VALUES), CDS DEFER TO GREATEST CABLE LENGTH.
- ROUTE PROPOSED CABLES ALONG SAME PATH AS EXISTING CABLES AND IN ACCORDANCE WITH STRUCTURAL ANALYSIS. IF ADEQUATE SPACE EXISTS, ROUTE CABLES THROUGH ENTRY PORT HOLE, UP INSIDE OF MONOPOLE, AND THROUGH EXIT PORT HOLE. IF ROUTING OUTSIDE THE MONOPOLE, ATTACH CABLES USING STAND-OFF ADAPTERS MOUNTED TO TOWER USING STAINLESS STEEL BANDING. ADEQUATELY SECURE CABLES USING EITHER APPROPRIATELY SIZED STAINLESS STEEL SNAP-INS OR MOUNTING HARDWARE AND BRACKETS AS SPECIFIED BY CABLE MANUFACTURER.

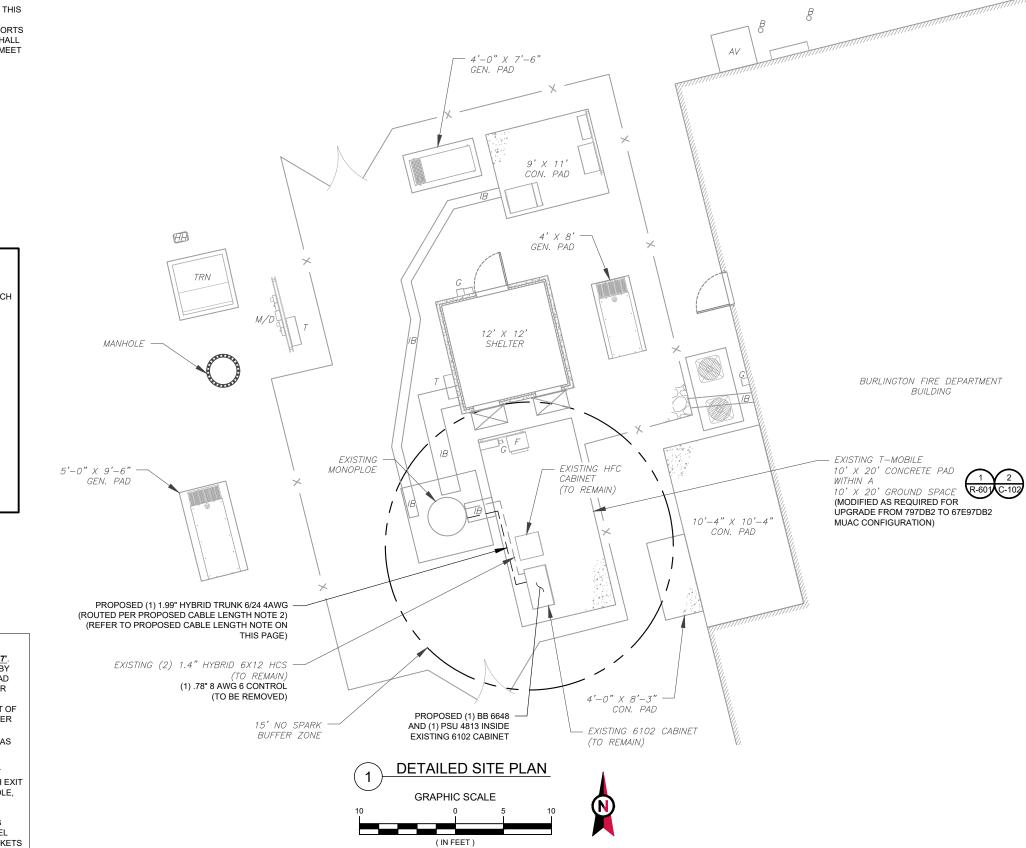

1 UNIT = 10 FEET




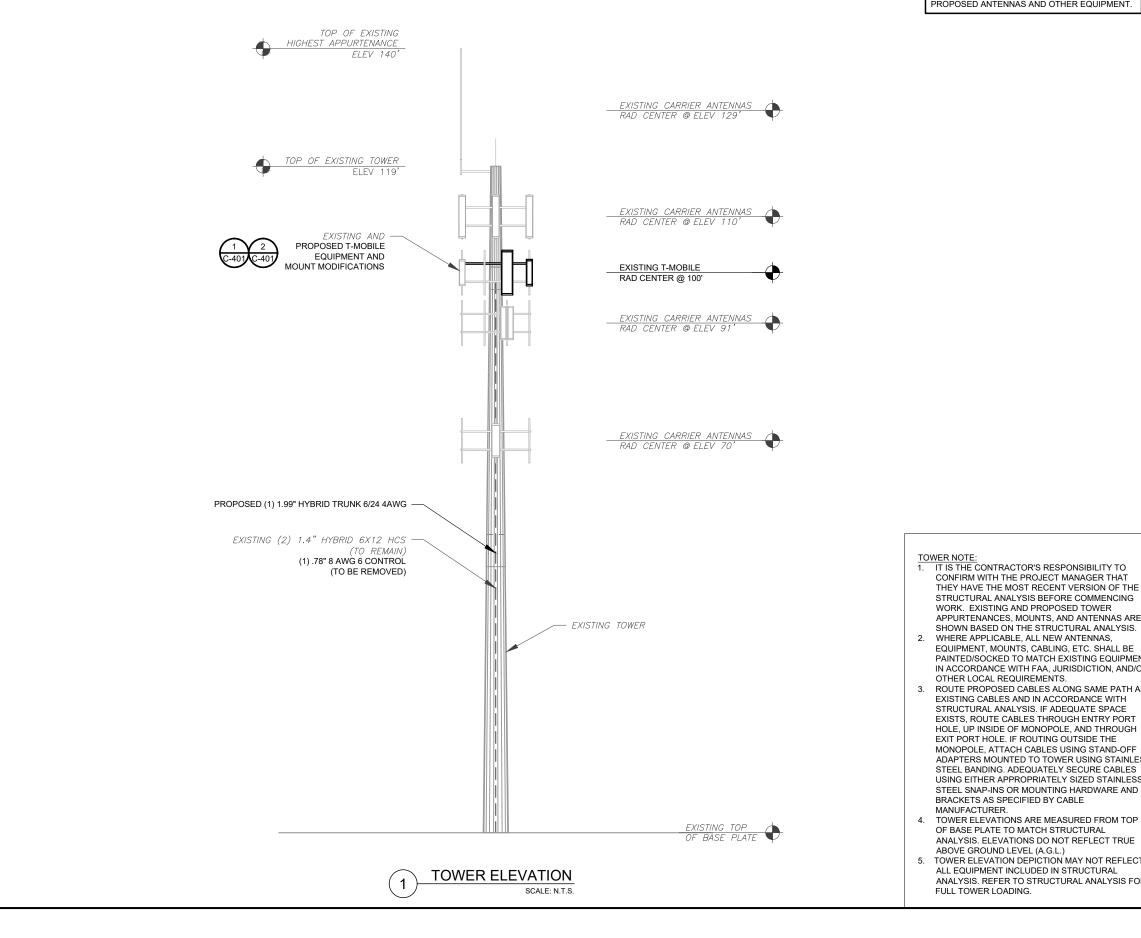


PER MOUNT ANALYSIS COMPLETED BY ATC. DATED 06/16/22, THE EXISTING MOUNT MUST BE MODIFIED TO ADEQUATELY SUPPORT THE PROPOSED LOADING. THE MOUNT MODIFICATION PROPOSED IN THE MOUNT ANALYSIS, INCLUDED AT THE END OF THIS PLAN SET, MUST BE INSTALLED PRIOR TO THE INSTALLATION OF THE PROPOSED ANTENNAS AND OTHER EQUIPMENT.

WORK. EXISTING AND PROPOSED TOWER APPURTENANCES, MOUNTS, AND ANTENNAS ARE SHOWN BASED ON THE STRUCTURAL ANALYSIS. 2. WHERE APPLICABLE, ALL NEW ANTENNAS, EQUIPMENT, MOUNTS, CABLING, ETC. SHALL BE PAINTED/SOCKED TO MATCH EXISTING EQUIPMENT IN ACCORDANCE WITH FAA, JURISDICTION, AND/OR OTHER LOCAL REQUIREMENTS. 3. ROUTE PROPOSED CABLES ALONG SAME PATH AS EXISTING CABLES AND IN ACCORDANCE WITH STRUCTURAL ANALYSIS. IF ADEQUATE SPACE EXISTS, ROUTE CABLES THROUGH ENTRY PORT HOLE, UP INSIDE OF MONOPOLE, AND THROUGH EXIT PORT HOLE. IF ROUTING OUTSIDE THE MONOPOLE, ATTACH CABLES USING STAND-OFF ADAPTERS MOUNTED TO TOWER USING STAINLESS STEEL BANDING. ADEQUATELY SECURE CABLES USING EITHER APPROPRIATELY SIZED STAINLESS STEEL SNAP-INS OR MOUNTING HARDWARE AND BRACKETS AS SPECIFIED BY CABLE MANUFACTURER. TOWER ELEVATIONS ARE MEASURED FROM TOP OF BASE PLATE TO MATCH STRUCTURAL ANALYSIS. ELEVATIONS DO NOT REFLECT TRUE ABOVE GROUND LEVEL (A.G.L.) TOWER ELEVATION DEPICTION MAY NOT REFLECT

ALL EQUIPMENT INCLUDED IN STRUCTURAL ANALYSIS. REFER TO STRUCTURAL ANALYSIS FOR FULL TOWER LOADING.

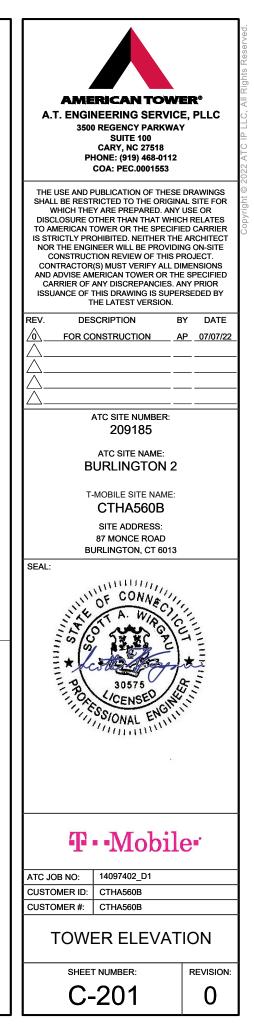

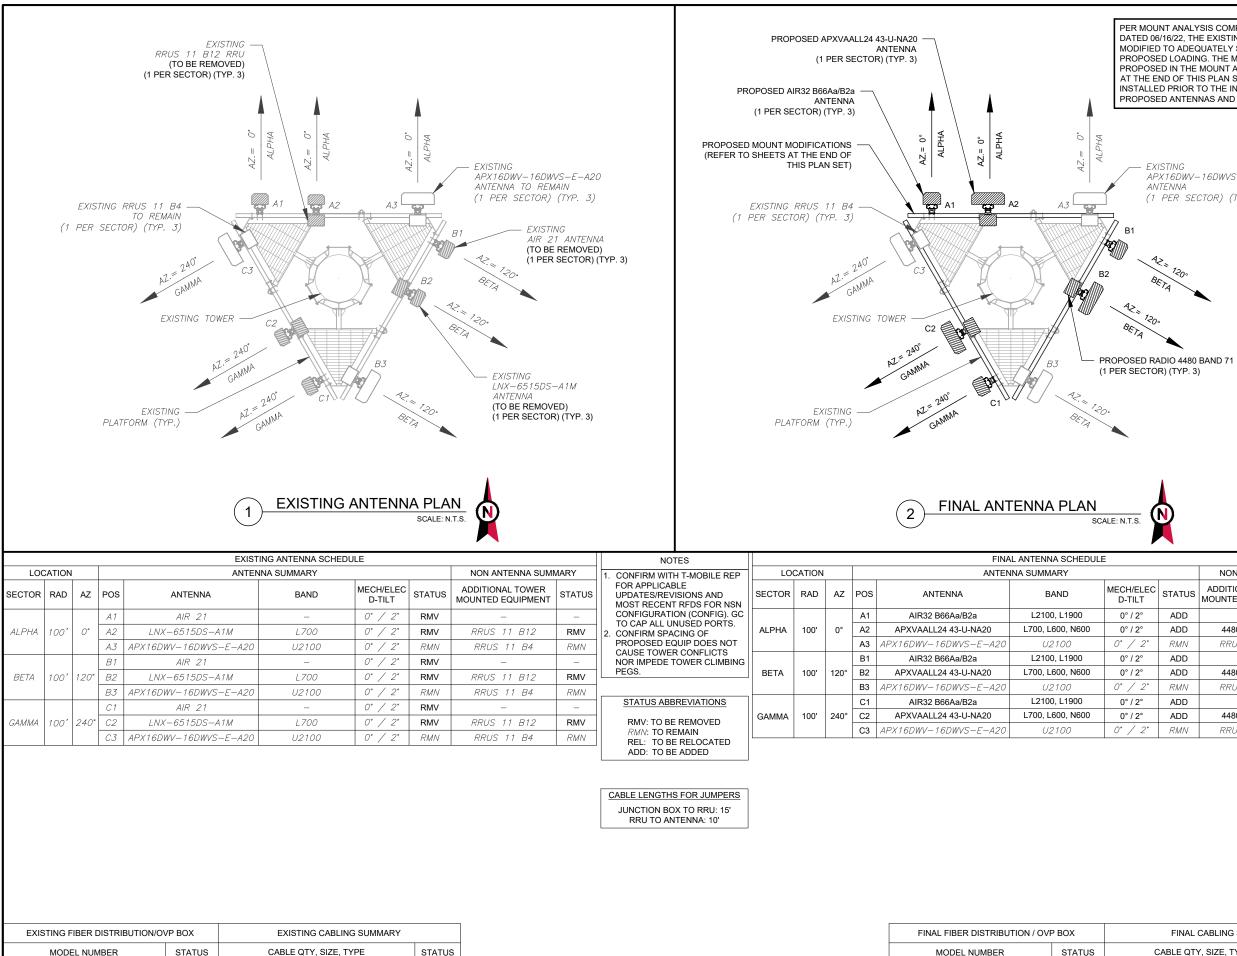

STATUS MODEL NUMBER STATUS (2) 1.4" HYBRID 6X12 HCS RMN _ (1) .78" 8 AWG 6 CONTROL RMV

EQUIPMENT SCHEDULES 3


FINAL FIBER DISTRIBUTION / OVP BOX		FINAL CABLING SUMMARY	
MODEL NUMBER	STATUS	CABLE QTY, SIZE, TYPE	STATUS
-	-	(2) 1.4" HYBRID 6X12 HCS	RMN
-	-	(1) 1.99" HYBRID TRUNK 6/24 4AWG	ADD


PER MOUNT ANALYSIS COMPLETED BY ATC, DATED 06/16/22, THE EXISTING MOUNT MUST BE MODIFIED TO ADEQUATELY SUPPORT THE PROPOSED LOADING. THE MOUNT MODIFICATION PROPOSED IN THE MOUNT ANALYSIS, INCLUDED AT THE END OF THIS PLAN SET, MUST BE INSTALLED PRIOR TO THE INSTALLATION OF THE PROPOSED ANTENNAS AND OTHER EQUIPMENT.

> APX16DWV-16DWVS-E-A20 (1 PER SECTOR) (TYP. 3)





	NON ANTENNA SUN	IMARY
ATUS	ADDITIONAL TOWER MOUNTED EQUIPMENT	STATUS
٩DD	-	-
٩DD	4480 BAND 71	ADD
RMN	RRUS 11 B4	RMN
٩DD	-	-
٩DD	4480 BAND 71	ADD
RMN	RRUS 11 B4	RMN
٩DD	-	-
٩DD	4480 BAND 71	ADD
RMN	RRUS 11 B4	RMN

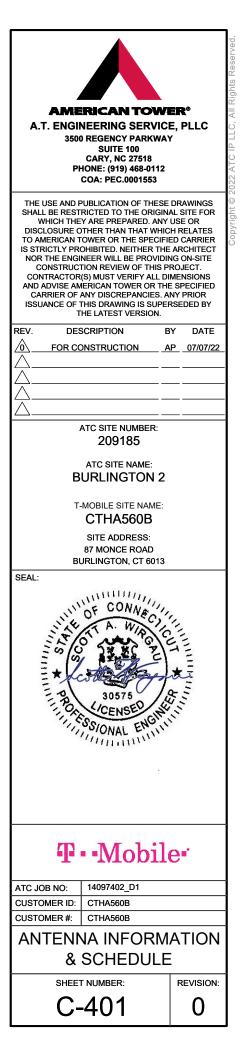


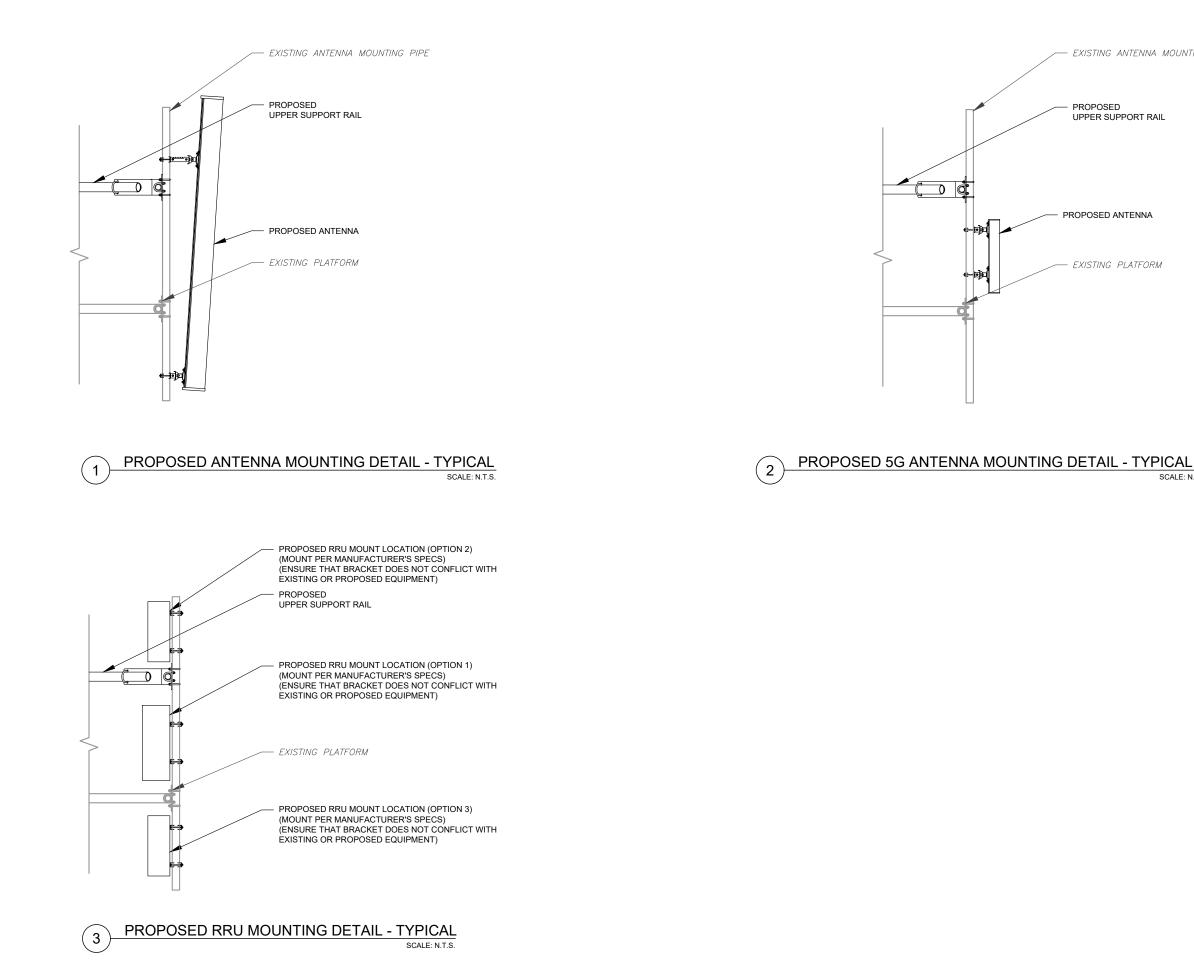

SCALE: N.T.S.

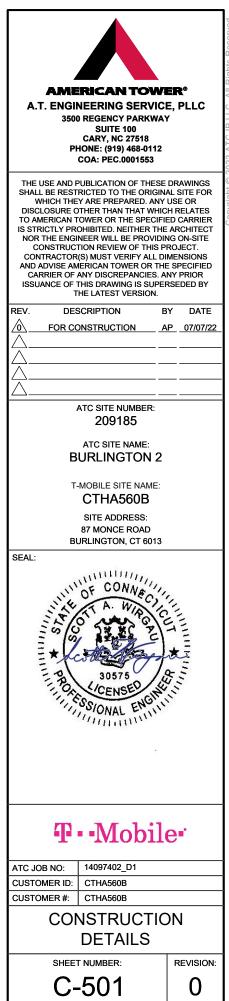

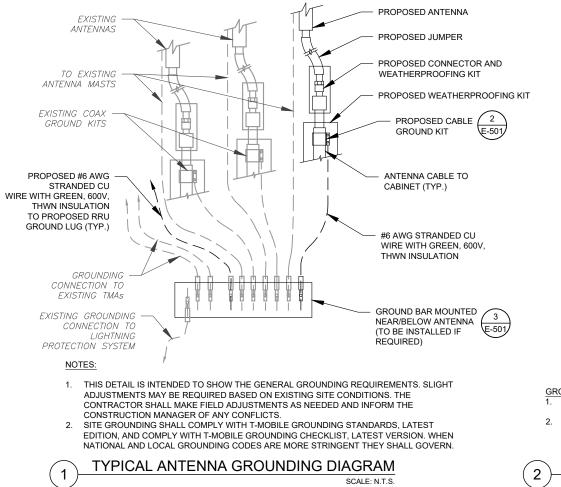


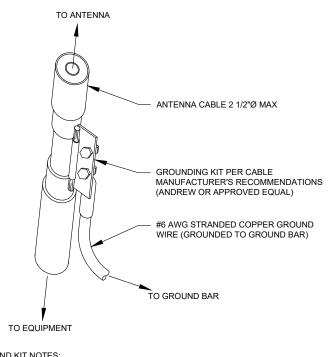

GROUND KIT NOTES: 1. DO NOT INSTALL CABLE GROUND KIT AT A BEND AND ALWAYS DIRECT GROUND WIRE DOWN TO GROUND BAR.

 CONTRACTOR SHALL PROVIDE WEATHERPROOFING KIT (ANDREW PART NUMBER 221213) AND INSTALL/TAPE PER MANUFACTURER'S SPECIFICATIONS.


2 CABLE GROUND KIT CONNECTION DETAIL SCALE: N.T.S.

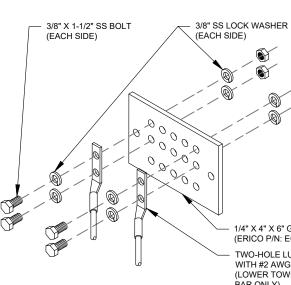

GROUND BAR NOTES:

- 1. GROUND BAR KITS COME WITH ALL HARDWARE, NUTS, BOLTS, WASHERS, ETC. EXCEPT THE STRUCTURAL MOUNTING MEMBER(S).
- 2. GROUND BAR TO BE BONDED DIRECTLY TO TOWER.



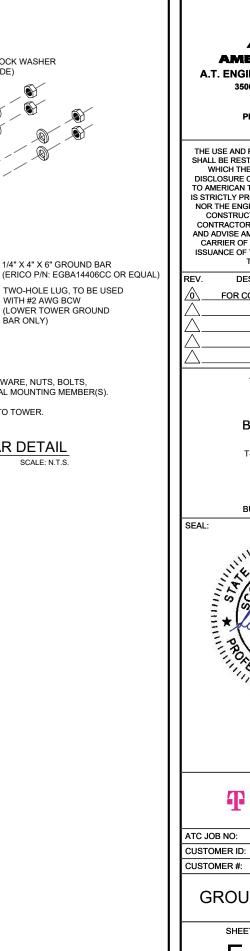




				67D5998C_1xAIR+1QP+10P.PNG
				Mid-Band Quad Passive Antenna L21 L21 L21 L21 L21 L21 L21 L21 L21 L21
	Proposed RAN Equip	ment		ዋዋዋዋ ዋዋ
	Template: 67E97DB2 M	IUAC		
Enclosure	1	2		עם, הביים, יייייייי
Enclosure Type	(RBS 6102 MU AC)	Ancillary Equipment (Ericsson)	PCS/AWS Di	iplexer Radio
Baseband	DUW30 (U2100) L1900 BB 5216 L2100 L1900 BB 6648 L700 L600 N600			
Hybrid Cable System		Ericsson 6x12 HCS *Select AWG & Length* (x 2) (Hybrid Trunk 6/24 4AWG 50m)	Radio 4424 B25	L19 ກິນ ກິນ
Multiplexer	XMU		G	SM 원 원 원
RAN Scope of Work	:			
Antenna Swap from Adding 4480s Radio Ericsson - AIR32 K	et 6102. ¹ band(L7/L6/N6). ids . Adding one 6x24 50m Hybrid. Andrew - LNX-6515DS-A1M to RFS - APXVAALL24_43-U-NA20 ² at the antenna for low band RD901146-1_B66A_B2A and RFS - APX16DWV-16DWV-S-E-A20 antenna remair of site remain same. CABINET CONFIGUE			Cabinet Radio B4 9x18
			Notes:	


ANTENNA CONFIGURATION

(2)

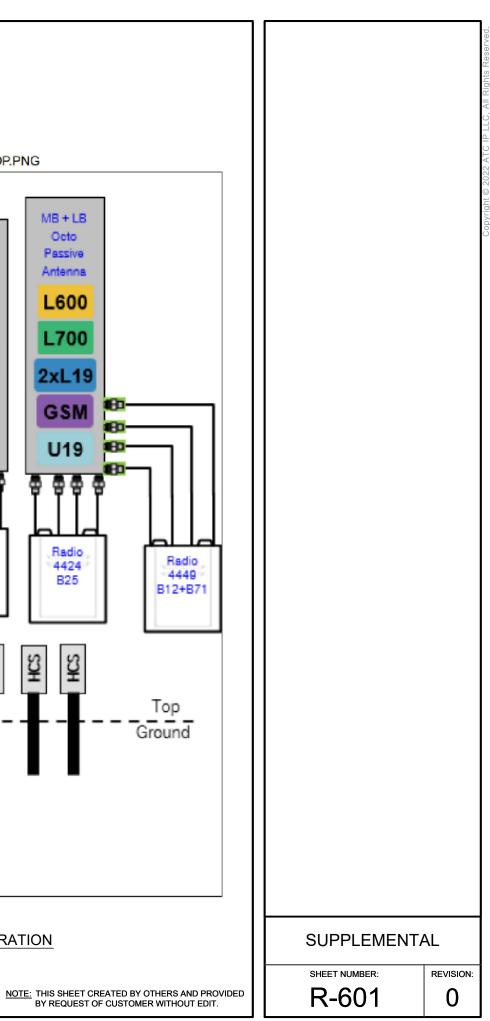



MANUFACTURER:	ERICSSON
MODEL:	BASEBAND 6648
DIMENSIONS:	1.75" x 17.25" x 13.85" (H" x W" x D")
WEIGHT:	16.54 LBS


MANUFACTURER:	ERICSSON	NEEDED INSTALL KIT (PICK 1)
MODEL:	PSU 48 13	34133 PSU4813 INSTALL KIT FOR RBS61XX
WEIGHT:	17.1 LBS	34134 PSU4813 INSTALL KIT FOR PBC6200
DIMENSIONS:	19"x 1.7"x 14.3"	34135 PSU4813 INSTALL KIT FOR 6X60/RBS6230

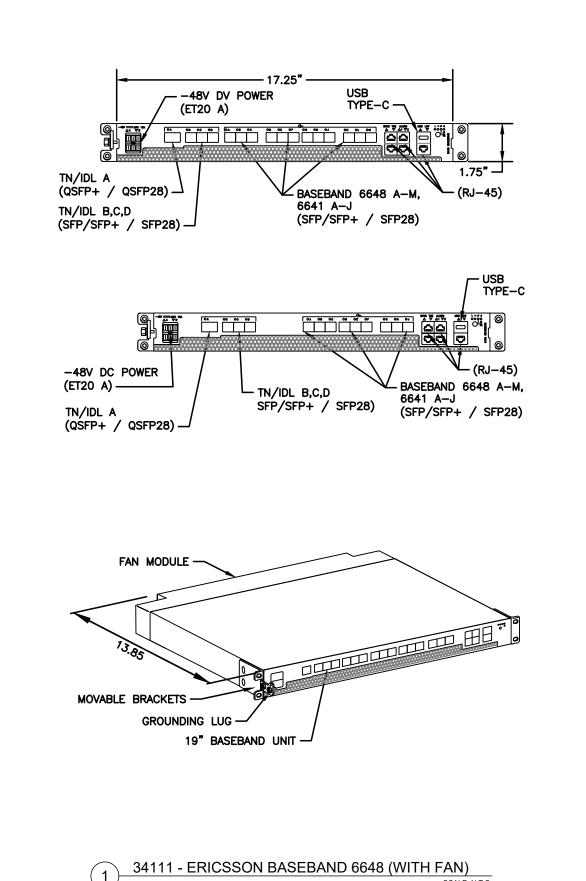

SCALE: N.T.S.

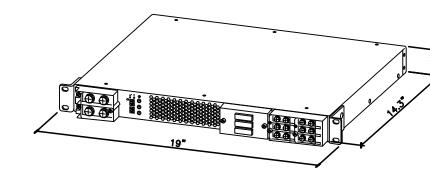

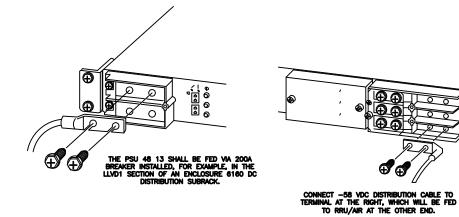

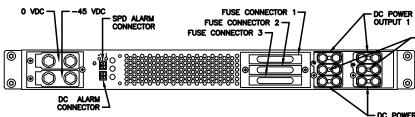

SKU# 34132 - PSU 48 13 2

T CREATED BY OTHERS AND PROVIDED
ST OF CUSTOMER WITHOUT EDIT.



DC POWER OUTPUT 2









SUPPLEMENTAL SHEET NUMBER:

R-602

REVISION:

0

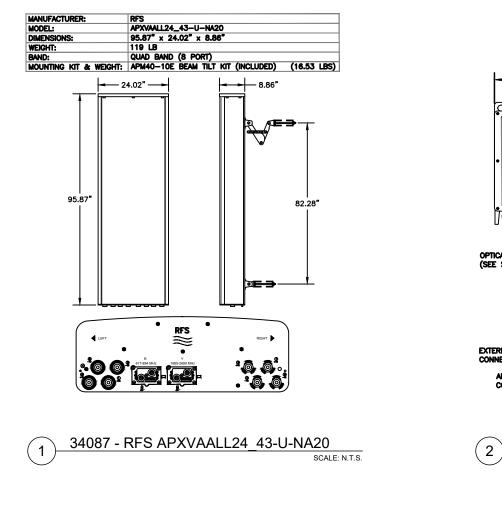

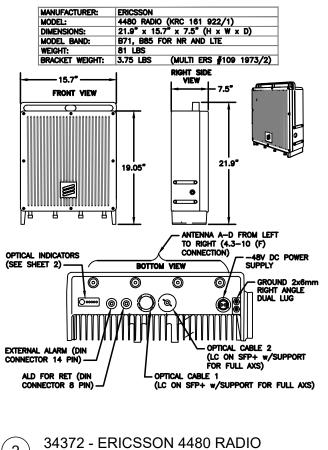

SCALE: N.T.S.



REVISION: 0

SUPPLEMENTAL



AMERICAN TOWER®

CORPORATION

Mount Analysis Report

ATC Site Name	: Burlington 2, CT
ATC Site Number	: 209185
Engineering Number	: 14097402_C8_01
Mount Elevation	: 101.5 ft
Carrier	: T-Mobile
Carrier Site Name	: CTHA560B
Carrier Site Number	: CTHA560B
Site Location	: 87 Monce Road
	Burlington, CT 6013-2542
	•
	41.73912732, -72.90781103
County	: Hartford
Date	: June 16, 2022
Max Usage	: 48%
Result	: Contingent Pass
Dropprod By	Povioured Pur
Prepared By:	Reviewed By:

A.T. Engineering Service, PLLC - 3500 Regency Parkway, Suite 100 - Cary, NC 27518 - 919.468.0112 Office - 919.466.5414 Fax - www.americantower.com

Prepared By: Michael Ellis Structural Engineer I



Authorized by "EOR" 16 Jun 2022 04:34:45

COA: PEC.0001553

MOUNT ANALYSIS

1



Eng. Numbe

Introduction

The purpose of this report is to summarize results of the mount analysis performed for T-

Supporting Documents

Mount Modification	Site Pro 1 HRK12, dated July 13, 2014
Radio Frequency Data Sheet	RFDS ID #CTHA560B, dated May 31, 2022
Reference Photos	Site photos from 2021

<u>Analysis</u>

This mount was analyzed using American Tower Corporation's Mount Analysis Program a

Basic Wind Speed:	116 mph (3-Second Gust)	
Basic Wind Speed w/ Ice:	50 mph (3-Second Gust) w/ 1.50" radial ice concurrer	
Codes:	ANSI/TIA-222-H	
Exposure Category:	С	
Risk Category:	П	
Topographic Factor Procedure:	Method 2	
Feature:	Flat	
Crest Height (H):	0 ft	
Crest Length (L):	0 ft	
Spectral Response:	Ss = 0.184, S1 = 0.054	
Site Class:	D - Stiff Soil - Default	
Live Loads:	Lm = 500 lbs	
* Based on experience, it has been determined	l that the Lv load cases will not control over Lm load cases in platform moun	

* Based on experience, it has been determined that the LV load cases will not control over Lm load cases in platform moun Therefore, these load cases have been excluded from this analysis.

Conclusion

Based on the analysis results, the antenna mount meets the requirements per the applica above provided the modifications listed below are completed:

- Install Site Pro 1 HRK12 handrail reinforcement kit (or similar) as requested by T-MO
- A handrail kit was modeled due to the Carrier's proposed Mount Type. The mount ge before this addition was not assessed.

If you have any questions or require additional information, please contact American T Engineering@americantower.com. Please include the American Tower site name, site engineering number in the subject line for any questions.

A.T. Engineering Service, PLLC - 3500 Regency Parkway, Suite 100 - Cary, NC 27518 - 919.468.0112 Office - 919.466.5414 Fax - www

NOTE: THIS SHEET WAS CREATED BY OTHERS AND PROVIDED WITHOUT EDIT. PLEASE REFERENCE THE MOUNT ANA ANALYSIS CALCULATIONS AND DETAILS. SUPPLEMENT CONSTRUCTION DRAWINGS ARE FOR REFERENCE ONI VERYIFY THEY HAVE THE MOST RECENT MOUNT ANAL

ber 14097402_C8_01 June 16, 2022 Page 1	
-Mobile at 101.5 ft.	
and RISA-3D	
ent	
unt analyses.	
cable codes listed	
OBILE. geometry	
Tower via email at e number, and	
w.americantower.com	
ED AT THE REQUEST OF THE CUSTOMER	SI
IALYSIS REPORT FOR COMPLETE MOUNT ITAL PAGES INCLUDED IN THE NLY. GENERAL CONTRACTOR IS TO ALYSIS PRIOR TO CONTRUCTION.	sh F

SUPPLEMENTAL



