



STATE OF CONNECTICUT

CONNECTICUT SITING COUNCIL

Ten Franklin Square, New Britain, CT 06051

Phone: (860) 827-2935 Fax: (860) 827-2950

E-Mail: siting.council@ct.gov

Internet: ct.gov/csc

Daniel F. Caruso

Chairman

June 29, 2010

Thomas J. Regan, Esq.
Brown Rudnick LLP
CityPlace I, 185 Asylum Street
Hartford, CT 06103

RE: **EM-T-MOBILE-004-100611** – Omnipoint Communications, as subsidiary of T-Mobile USA, Inc. notice of intent to modify an existing telecommunications facility located 81 Montevideo Road, Avon, Connecticut.

Dear Attorney Regan:

The Connecticut Siting Council (Council) hereby acknowledges your notice to modify this existing telecommunications facility, pursuant to Section 16-50j-73 of the Regulations of Connecticut State Agencies.

The proposed modifications are to be implemented as specified here and in your notice dated June 11, 2010, including the placement of all necessary equipment and shelters within the tower compound. The modifications are in compliance with the exception criteria in Section 16-50j-72 (b) of the Regulations of Connecticut State Agencies as changes to an existing facility site that would not increase tower height, extend the boundaries of the tower site, increase noise levels at the tower site boundary by six decibels, and increase the total radio frequencies electromagnetic radiation power density measured at the tower site boundary to or above the standard adopted by the State Department of Environmental Protection pursuant to General Statutes § 22a-162. This facility has also been carefully modeled to ensure that radio frequency emissions are conservatively below State and federal standards applicable to the frequencies now used on this tower.

This decision is under the exclusive jurisdiction of the Council. Please be advised that the validity of this action shall expire one year from the date of this letter. Any additional change to this facility will require explicit notice to this agency pursuant to Regulations of Connecticut State Agencies Section 16-50j-73. Such notice shall include all relevant information regarding the proposed change with cumulative worst-case modeling of radio frequency exposure at the closest point of uncontrolled access to the tower base, consistent with Federal Communications Commission, Office of Engineering and Technology, Bulletin 65. Any deviation from this format may result in the Council implementing enforcement proceedings pursuant to General Statutes § 16-50u including, without limitation, imposition of expenses resulting from such failure and of civil penalties in an amount not less than one thousand dollars per day for each day of construction or operation in material violation.

Thank you for your attention and cooperation.

Very truly yours,

S. Derek Phelps
Executive Director

SDP/CDM/laf

- c: The Honorable Mark W. Zacchio, Chairman Town Council, Town of Avon
Brandon Robertson, Town Manager, Town of Avon
Steven V. Kushner, Town Planner, Town of Avon
Maria Scotti, Message Center Management

RECEIVED
JUN 11 2010

In re:

T-Mobile USA, Inc. Notice to Make an Exempt
 Modification to an Existing Facility at 81
 Montevideo Road, Avon, Connecticut.

CONNECTICUT
 SITING COUNCIL

: EXEMPT MODIFICATION

: June 11, 2010

ORIGINAL

NOTICE OF EXEMPT MODIFICATION

Pursuant to Conn. Agencies Regs. §§ 16-50j-73 and 16-50j-72(b), T-Mobile USA, Inc. (“T-Mobile”) hereby gives notice to the Connecticut Siting Council (“Council”) and the Town of Avon of T-Mobile’s intent to make an exempt modification to the existing lattice tower (the “Tower”) located at 81 Montevideo Road in Avon, Connecticut. Specifically, T-Mobile plans to upgrade its wireless system in Connecticut by implementing its Universal Mobile Telecommunications System (“UMTS”). UMTS is a third-generation (“3G”) technology that utilizes a code division multiple access (“CDMA”) base to allow for fast and large data transfers. To accomplish this upgrade, T-Mobile must modify its antenna and equipment configurations at many of its existing sites.

Once the UMTS upgrade is complete, T-Mobile will operate on a more unified communication system, allowing international wireless telephones to function world-wide. Furthermore, UMTS will enhance GPS navigation capabilities and provide emergency responders with more advanced tracking capabilities. The proposed UMTS technology is compatible with the existing second-generation (“2G”) Global System for Mobile Communication (“GSM”) currently on the Tower and the proposed upgrade is expected to enhance the existing 2G system. In order to accomplish the upgrade at this site, T-Mobile plans to add UMTS technology and install associated equipment at the base of the Tower.

Under the Council’s regulations (Conn. Agencies Regs. § 16-50j-72(b)), T-Mobile’s plans do not constitute a modification subject to the Council’s review because T-Mobile will not

change the height of the Tower, will not extend the boundaries of the compound, will not increase the noise levels at the site, and will not increase the total radio frequency electromagnetic radiation power density at the site to levels above applicable standards.

The Tower is a 150-foot lattice tower located at 81 Montevideo Road in Avon, Connecticut (latitude 41° 48' 11" N, longitude 72° 48' 04.75" W). The Tower is owned by Message Center Management. Currently, T-Mobile has 6 GSM panel antennas and Tower Mounted Amplifiers ("TMA") located on the Tower with a centerline of 136 feet. A site plan with Tower specifications is attached.

T-Mobile plans to add 1 UMTS dual pole antenna and 1 Twin AWS TMA to the existing frame on the gamma sector of the Tower. T-Mobile will also add 2 1-5/8" coax cables. The proposed antenna and TMA will have the same centerline as the existing antennas – 136 feet. To confirm the Tower can support these changes, T-Mobile commissioned Armor Tower to perform a structural analysis of the Tower (attached). According to the structural analysis, dated April 22, 2010, the Tower is "... adequate ... to support the proposed antenna loading" (Page 1, Structural Analysis).

In addition, T-Mobile proposes to mount its UMTS equipment cabinet to the wall of the existing equipment room. T-Mobile also plans to install a remote radio unit ("RRU") alongside the UMTS cabinet inside the existing equipment room. Hence, no increase in the boundaries of the site is necessary.

Therefore, excluding brief, minor, construction-related noise during the addition of the antenna and the installation of the equipment cabinet, T-Mobile's changes to the Tower will not increase noise levels at the site.

The proposed antenna and TMA will not adversely impact the health and safety of the surrounding community or the people working on the Tower. The total radio frequency exposure measured around the Tower will be well below the National Council on Radiation

Protection and Measurements' ("NCRP") standard adopted by the Federal Communications Commission ("FCC"). The worst-case power density analysis measured at the base of the Tower indicates that T-Mobile's antenna will emit 5.53% of the NCRP's standard for maximum permissible exposure. A cumulative power density analysis indicates that together, all of the antennas on the Tower will emit only 9.48% of the NCRP's standard for maximum permissible exposure. Therefore, the power density levels will be well below the FCC mandated radio frequency exposure limits in all locations around the Tower, even with extremely conservative assumptions. The power density analysis is attached.

In conclusion, T-Mobile's proposed plan to add a UMTS antenna, TMA, coax cables and associated equipment cabinets does not constitute a modification subject to the Council's jurisdiction because T-Mobile will not increase the height of the Tower, will not extend the boundaries of the site, will not increase the noise levels at the site, and the total radio frequency electromagnetic radiation power density will stay within all applicable standards. *See Conn. Agencies Regs. § 16-50j-72.*

T-Mobile USA, Inc.

By: Thomas J. Regan

Thomas J. Regan
Brown Rudnick LLP
185 Asylum Street, CityPlace I
Hartford, CT 06103-3402
Email - tregan@brownrudnick.com
Phone - 860.509.6522 /Fax - 860.509.6501

Certificate of Service

This is to certify that on this 11th day of June 2010, the foregoing Notice of Exempt
Modification was sent, via first class mail, to the following:

Town of Avon
Mark W. Zacchio, Chairman
Avon Town Council
60 West Main Street
Avon, CT 06001

By: Thomas J. Regan
Thomas J. Regan

40273439 v1 - MERCIECM - 025064/0016

PROJECT DESCRIPTION:

T-Mobile is proposing to install telecommunications equipment at this existing site that complies with all local, state and federal laws, ordinances, rules, regulations, codes, standards, and requirements of T-Mobile, FCC, and CT Department of Energy and Public Utilities. The equipment will consist of one (1) (1) new dual pole, split base, 100-ft. tall, 4-unit panel antenna to be added. (2) new 100-ft. tall, 4-unit panel antenna to be added. (3) new 100-ft. tall, 4-unit panel antenna to be added. (4) new 100-ft. tall, 4-unit panel antenna to be added. (5) new 100-ft. tall, 4-unit panel antenna to be added.

AVON TOWER

81 MONTEVIDEO ROAD


AVON, CT 06001

SITE NUMBER: CT11284A

SITE TYPE: CO-LOCATION ON LATTICE TOWER

GENERAL NOTES

- THE CONTRACTOR SHALL GIVE ALL NOTICES AND COPY, WITH ALL LAWS, ORDINANCES, RULES, REGULATIONS, INSTRUCTIONS, INDUSTRIAL AND UTILITY COMPANY SPECIFICATIONS, AND LOCAL, STATE, AND JURISDICTIONAL CODES BEARING ON THE PERFORMANCE OF THE WORK, THE WORK PERFORMED ON THE PROJECT, AND THE MATERIALS USED THEREIN, SHALL BE IN STRICT ACCORDANCE WITH ALL APPLICABLE CODES, REGULATIONS, AND ORDINANCES.
- THE ARCHITECT/ENGINEER HAVE MADE EVERY EFFORT TO FEE FOR FORTH IN THE CONTRACT DOCUMENTS AND THE CONTRACTOR AGREES TO DO NOTHING THAT CAUSES CAUTIONED THAT MAJOR OMISSIONS OR ERRORS IN THE DRAWINGS AND/OR SPECIFICATIONS SHALL NOT EXCUSE BAD CONTRACTOR FROM COMPLETING THE PROJECT AND IMPROVEMENTS IN ACCORDANCE WITH THE INTENT OF THESE DOCUMENTS.
- THE CONTRACTOR OR BUILDER SHALL BEAR THE COSTS OF ANY EXPENSES INCURRED BY THE PROJECT OWNER'S REPRESENTATIVE IN PREPARING THE CONTRACT DOCUMENTS, DRAWINGS, AND SPECIFICATIONS, PROVIDED, HOWEVER, THAT THE CONTRACTOR SHALL BE REIMBURSED FOR THE EXPENSES INCURRED IN THE EVENT OF DISCREPANCIES THAT CONTRACTOR SHALL PRICE THE MORE COSTLY OR EXTENSIVE WORK, UNLESS DIRECTED IN WRITING OTHERWISE.
- THE SCOPE OF WORK SHALL INCLUDE FURNISHING ALL MATERIALS, EQUIPMENT, LABOR AND ALL OTHER MATERIALS AND LABOR REQUIRED FOR THE PROJECT, PROVIDED, HOWEVER, THAT THE CONTRACTOR SHALL NOT BE REQUIRED TO ASSEMBLE, ERECTOR, OR PERFORM ANY WORK, UNLESS DIRECTED IN WRITING OTHERWISE.
- THE CONTRACTOR SHALL VISIT THE JOB SITE PRIOR TO THE SUBMISSION OF BIDS OR PERFORMING WORK TO FAMILIARIZE HIMSELF WITH THE FIELD CONDITIONS AND IN ACCORDANCE WITH THE CONTRACT DOCUMENTS.
- THE CONTRACTOR SHALL OBTAIN AUTHORIZATION FROM THE PROJECT OWNERS REPRESENTATIVE TO PROCEED WITH CONSTRUCTION PRIOR TO STARTING THE WORK AND MAY NOT COMMENCE THE WORK UNTIL THE CONTRACTOR HAS RECEIVED CONTRACT DOCUMENTS.
- THE CONTRACTOR SHALL INSTALL ALL EQUIPMENT AND MATERIALS ACCORDING TO THE MANUFACTURER'S/ VENDOR'S SPECIFICATIONS UNLESS NOTED OTHERWISE OR WHERE LOCAL CODES OR ORDINANCES TAKE PRIORITY.
- THE CONTRACTOR SHALL PROVIDE A FULL SET OF CONTRACT DOCUMENTS AT THE TIME OF BIDDING OR SUBMITTING BIDS, PROVIDED, HOWEVER, THAT THE CONTRACT DOCUMENTS SHALL NOT BE MADE AVAILABLE FOR THE USE BY ALL PERSONNEL INVOLVED WITH THE PROJECT.
- THE CONTRACTOR SHALL SUPERVISE AND DIRECT THE PROJECT DESCRIBED HEREIN. THE CONTRACTOR SHALL BE SOLELY RESPONSIBLE FOR ALL CONSTRUCTION PROCEDURES, METHODS, TECHNIQUES, SEQUENCES AND PROGRAMMES AND FOR CoORDINATING ALL PARTS OF THE WORK ORDER BY THE CONTRACT.

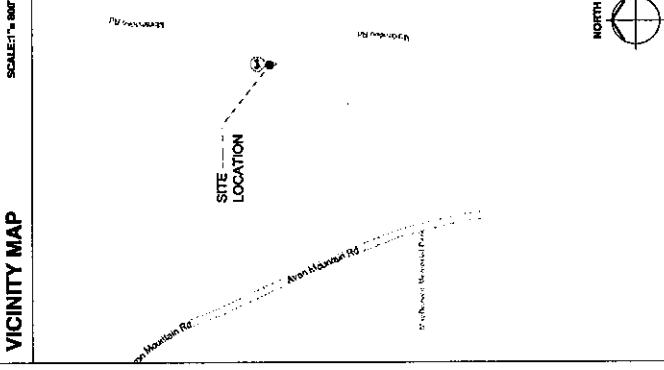

PROJECT SUMMARY

SITE NUMBER:	CT11284A
SITE NAME:	AVON TOWER
SITE ADDRESS:	81 MONTEVIDEO ROAD AVON, CT 06001
ASSESSOR'S PARCEL NO.:	MAP: #15/LOT: 3180081
SITE TYPE:	COLLOCATION
PROPERTY OWNER:	MONTEVIDEO LLC 40 NODON STREET HARTFORD, CT 06105
APPLICANT, LESSEE/LICENCISEE:	ATLANTIC GROUP, INC. 1264 CENTER ST., SUITE 200 MENTON, CT 06051 (860) 965-3700
PROJECT OWNER:	LISA LIN NIECKEMBERG TRANSCEND WIRELESS, LLC 10 INDUSTRIAL AVE MAYNARD, MA 01754 (978) 750-8000
PROJECT MANAGER:	BROWN RUDICK LLP THOMAS J. EGAN CITYPLACE I, 15TH FLOOR 115 ASYLUM ST. HARTFORD, CT 06103-4402 (860) 256-4600
ZONING REPRESENTATIVE:	CONNECTICUT LIGHT & POWER ON NORTH EAST UTILITIES (860) 547-3000
A/E:	ATATRUS CONSULT (203) 559-4600
CALL BEFORE YOU DIG:	1. THE CONTRACTOR SHALL NOTIFY THE PROJECT OWNERS REPRESENTATIVE IN WRITING OF ANY CHANGES THAT OCCUR IN THE CONTRACT DOCUMENTS AND THE CONTRACTOR SHALL BE REIMBURSED FOR THE EXPENSES INCURRED IN THE EVENT OF DISCREPANCIES THAT CONTRACTOR SHALL PRICE THE MORE COSTLY OR EXTENSIVE WORK, UNLESS DIRECTED IN WRITING OTHERWISE.
CHECKED BY:	SK
SUBMITTALS	A. 04/17/10 ISSUED FOR REVIEW B. 04/22/10 REVISED FOR COMMENTS

CODE REFERENCES

CONNECTICUT STATE BUILDING CODE
2006 INTERNATIONAL BUILDING CODE
2006 INTERNATIONAL ELECTRICAL CODE
2006 INTERNATIONAL MECHANICAL CODE
2006 INTERNATIONAL PLUMBING CODE
2006 CONNECTICUT SUPPLEMENT
2006 NATIONAL ELECTRICAL CODE
CONNECTICUT STATE FIRE SAFETY CODE
2006 INTERNATIONAL FIRE CODE

DO NOT SCALE DRAWINGS

CONTRACTOR SHALL VERIFY ALL PLANS AND EXISTING DIMENSIONS AND CONDITIONS ON THE JOB SITE AND SHALL IMMEDIATELY NOTIFY THE PROJECT OWNERS REPRESENTATIVE OF ANY CHANGES THAT OCCUR IN THE CONTRACT DOCUMENTS AND THE CONTRACTOR SHALL BE REIMBURSED FOR THE EXPENSES INCURRED IN THE EVENT OF DISCREPANCIES THAT CONTRACTOR SHALL PRICE THE MORE COSTLY OR EXTENSIVE WORK, UNLESS DIRECTED IN WRITING OTHERWISE.

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- THE CONTRACTOR SHALL SUPERVISE AND DIRECT THE PROJECT DESCRIBED HEREIN. THE CONTRACTOR SHALL BE SOLELY RESPONSIBLE FOR ALL CONSTRUCTION PROCEDURES, METHODS, TECHNIQUES, SEQUENCES AND PROGRAMMES AND FOR CoORDINATING ALL PARTS OF THE WORK ORDER BY THE CONTRACT.
- THE CONTRACTOR SHALL PROVIDE A FULL SET OF CONTRACT DOCUMENTS AT THE TIME OF BIDDING OR SUBMITTING BIDS, PROVIDED, HOWEVER, THAT THE CONTRACT DOCUMENTS SHALL NOT BE MADE AVAILABLE FOR THE USE BY ALL PERSONNEL INVOLVED WITH THE PROJECT.
- THE CONTRACTOR SHALL INSTALL ALL EQUIPMENT AND MATERIALS ACCORDING TO THE MANUFACTURER'S/ VENDOR'S SPECIFICATIONS UNLESS NOTED OTHERWISE OR WHERE LOCAL CODES OR ORDINANCES TAKE PRIORITY.

TITLE SHEET

81 MONTEVIDEO ROAD
AVON, CT 06001
SHEET NUMBER:
01


SITE DIRECTIONS

FROM BLOOMFIELD OFFICE:
HEAD SOUTHWEST ON COTTAGE RD. TURN RIGHT ON GRIFFIN RD. TURN SLIGHTLY LEFT AND BECOME WOODLAND AVE. TURN LEFT AT PETERS RD. TURN LEFT AT WOODLAND AVE. TURN RIGHT AT WOODMAN AVE. TURN LEFT AT COASTAL DR. TURN LEFT TO FOLLOW CT 102 SOUTH. TURN LEFT ON AVON MOUNTAIN AVE. TURN LEFT ON 84A. TURN RIGHT AT MONTEVIDEO RD. DESTINATION WILL BE ON THE LEFT. BY MONTEVIDEO RD. AVON, CT 06001

<p>TRANSCEND WIRELESS, LLC 1000 Corporate Park Drive, Suite 200 Office: 860-673-0000 Fax: 860-673-0022</p> <p>T-MOBILE NORTHEAST, LLC 1000 Corporate Park Drive, Suite 200 Office: 860-673-0000 Fax: 860-673-0022</p>	<p>ATLANTIS GROUP 1240 Charter Street, Suite 200 New Haven, CT 06511 Office: 860-542-0000 Fax: 860-542-0022</p>		<p>APPROVALS</p> <p>LANDLORD _____ R.F. _____ LEASING _____ ZONING _____ CONSTRUCTION _____ A/E _____</p>	<p>DRAWN BY: OC CHECKED BY: SK</p> <p>SUBMITTALS</p> <p>A QJ/6/10 ISSUED FOR REVIEW 0 QJ/2/10 REVISED PER COMMENTS</p>	<p>This document is the designated project drawing for construction work on the property. Without written consent of the architect, it is prohibited to duplicate, copy or alter any part of this drawing. Any changes must be made by the architect or engineer who originally designed the project. Alterations by others are specifically prohibited.</p> <p>CT11284A AVON TOWER 81 MONTVERDE ROAD AVON, CT 06001</p> <p>SHEET TITLE: COMPOUND PLAN & EQUIPMENT ROOM PLAN</p> <p>SHEET NUMBER: 03</p>
<p>EQUIPMENT ROOM PLAN</p> <p>SCALE: 1'-0" = 10'-0" (1:172) SCALE: 1'-0" = 2'-0" (24:48)</p> <p>2 0 5 10 15 2 4 6</p> <p>COMPOND PLAN</p> <p>SCALE: 1'-0" = 10'-0" (1:172) SCALE: 1'-0" = 5'-0" (24:48)</p> <p>5 0 0 5 10 15 0 5 10 15</p> <p>ANTENNA AZIMUTHS: SECTOR GANMA: 200°</p>					

TRANSCEND WIRELESS, LLC
10 INDIA ST., SUITE 1A
MILITARY RD, DEDHAM,
MA 02041-3025
(508) 864-0046
FAX: (508) 864-0046

T-MOBILE NORTHEAST, LLC
10 GREENFIELD SOUTH

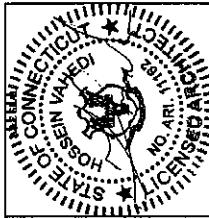

APPROVALS	
LANDLORD	_____
LEASING	_____
R.F.	_____
ZONING	_____
CONSTRUCTION	_____
A/E	_____


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CT11284A
AVON TOWER


81 MONTEVIEJO ROAD AVON, CT 06001	SHEET TITLE:	ANTENNA DETAILS	SHEET NUMBER: 06
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This technical drawing illustrates the proposed antenna mounting pipe assembly. It features a horizontal rectangular pipe supported by two vertical brackets. A bracket on the left is labeled "PROPOSED DOWNLIT BRACKET" and includes a dimension of "12". A bracket on the right is labeled "EXISTING DOWNLIT BRACKET". A vertical pipe labeled "PROPOSED ANTENNA MOUNTING PIPE" is shown extending from the top of the main pipe. A horizontal pipe labeled "EXISTING ANTENNA MOUNTING PIPE" is shown extending from the side of the main pipe. A small rectangular component labeled "PROPOSED TMA" is attached to the side of the main pipe. The drawing also includes a dimension "12" for the distance between the centers of the two support brackets.

**Mounting Assembly
(All Antennas)**




TWIN TMA DETAIL

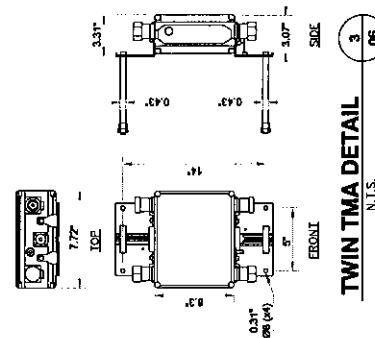

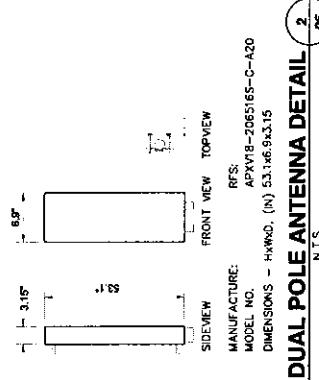
DUAL POLE ANTENNA DETAIL 2

MANUFACTURE:	RFS;
MODEL NO.	APXV8-2065/6S-C-A20
DIMENSIONS	HxWxD, (In) 5.3 x 6.9 x 3.15
N.T.S.	

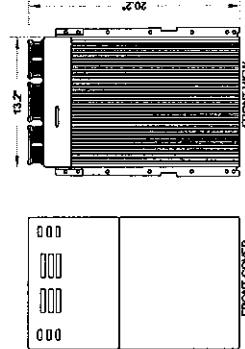

RRU 22 XX40 DETAIL

<p>TRANSCEND WIRELESS, LLC 10 Industrial Ave Office Park Building Facilities Building Phone:</p>	<p>T-MOBILE NORTHEAST, LLC 10 Industrial Ave Office Park Building Facilities Building Phone:</p>	<p>ATLANTIS GROUP 1200 Center Street Suite 203 Newtown Center, MA 01850 Office: (413) 873-0000 Fax: (413) 873-0001</p>	<p>STATE OF CONNECTICUT LICENSED AND SEEN VALID NO. ARI-11111111 EXPIRES 11/11/2011</p>	<p>APPROVALS</p> <p>LANDLORD _____ LEASING _____ R.F. _____ ZONING _____ CONSTRUCTION _____ A/E _____</p>	<p>DRAWN BY: GC CHECKED BY: SM</p>														
<p>NEW POWER SERVICE ATTACHED TO EQUIPMENT ROOM WALL ROUTED FROM (E) POWER PANEL TO NEW ERICSSON PRC-02 BATTERY CABINET</p> <p>NEW REMOTE RADIO UNIT (RRU) ON WALL (GAMMA SECTOR ONLY)</p> <p>(P) TELCO SERVICE Routed along ceiling from TELCO DEMARC in THE ATTIC TO ON (E) PLATE BACKBOARD</p> <p>(P) ERICSSON RBS 3618 UNITS CABINET</p> <p>(E) T-MOBILE POWER PANEL</p> <p>(E) TELCO DEMARC INSIDE THE ATTIC</p> <p>(2) NEW COAX ENTRY PORTS ADJACENT TO (E) LOUVER</p> <p>(E) COAX ENTRY PORT</p> <p>(E) LOUVER</p> <p>(E) T-MOBILE DEMARC IN THE ATTIC</p> <p>NEW 2" TELCO SERVICE FROM (E) TELCO DEMARC IN THE ATTIC TO NEW UNITS CABINET VIA NEW J-BOX</p> <p>NEW ERICSSON RBS 3618 UNITS CABINET ATTACHED TO EQUIPMENT ROOM WALL</p> <p>(1) NEW ERICSSON PRC-02 BATTERY BACK-UP CABINET ATTACHED TO (E) WALL</p> <p>(E) CABINET</p> <p>(E) DOOR</p> <p>NOTE: POWER CONDUIT FROM (E) POWER PANEL NEED TO BE ROUTED OVER TO NEW PRC-02 BATTERY CABINET LOCATION FIRST, THEN CABLEING WILL BE FEED FROM THE PRC-02 BATTERY CABINET TO RBS 3618 CABINET. TELCO CONDUIT NEW 2" CONDUIT WILL BE RUN FROM (E) DEMARCATION POINT IN ATTIC TO J-BOX FIRST, THEN NIPPLE OVER TO THE RRU SITE CABINET.</p>																			
<p>SUBMITTALS</p> <table border="1"> <tr> <td>A 04/07/10</td> <td>ISSUED FOR REVIEW</td> </tr> <tr> <td>B 04/22/10</td> <td>REVISED PER COMMENTS</td> </tr> <tr> <td colspan="2"> </td> </tr> </table> <p>This drawing shows the location of equipment room for use in connection with the construction of a building or structure. It is strictly prohibited that vehicles and other mobile equipment be parked in or near the area shown unless specifically authorized by regulatory and administrative regulations. It is specifically prohibited</p>						A 04/07/10	ISSUED FOR REVIEW	B 04/22/10	REVISED PER COMMENTS										
A 04/07/10	ISSUED FOR REVIEW																		
B 04/22/10	REVISED PER COMMENTS																		
<p>UTILITY LAYOUT EQUIPMENT ROOM</p> <p>1 07</p> <p>SCALE: 1" = 4'-0" (1:1=7) 2 2 0 2 4 6</p> <p>CT11284-A AVON TOWER 81 MONTEVIDEO ROAD AVON, CT 06001</p> <p>SHEET TITLE: UTILITY PLAN</p> <p>SHEET NUMBER: 07</p>																			

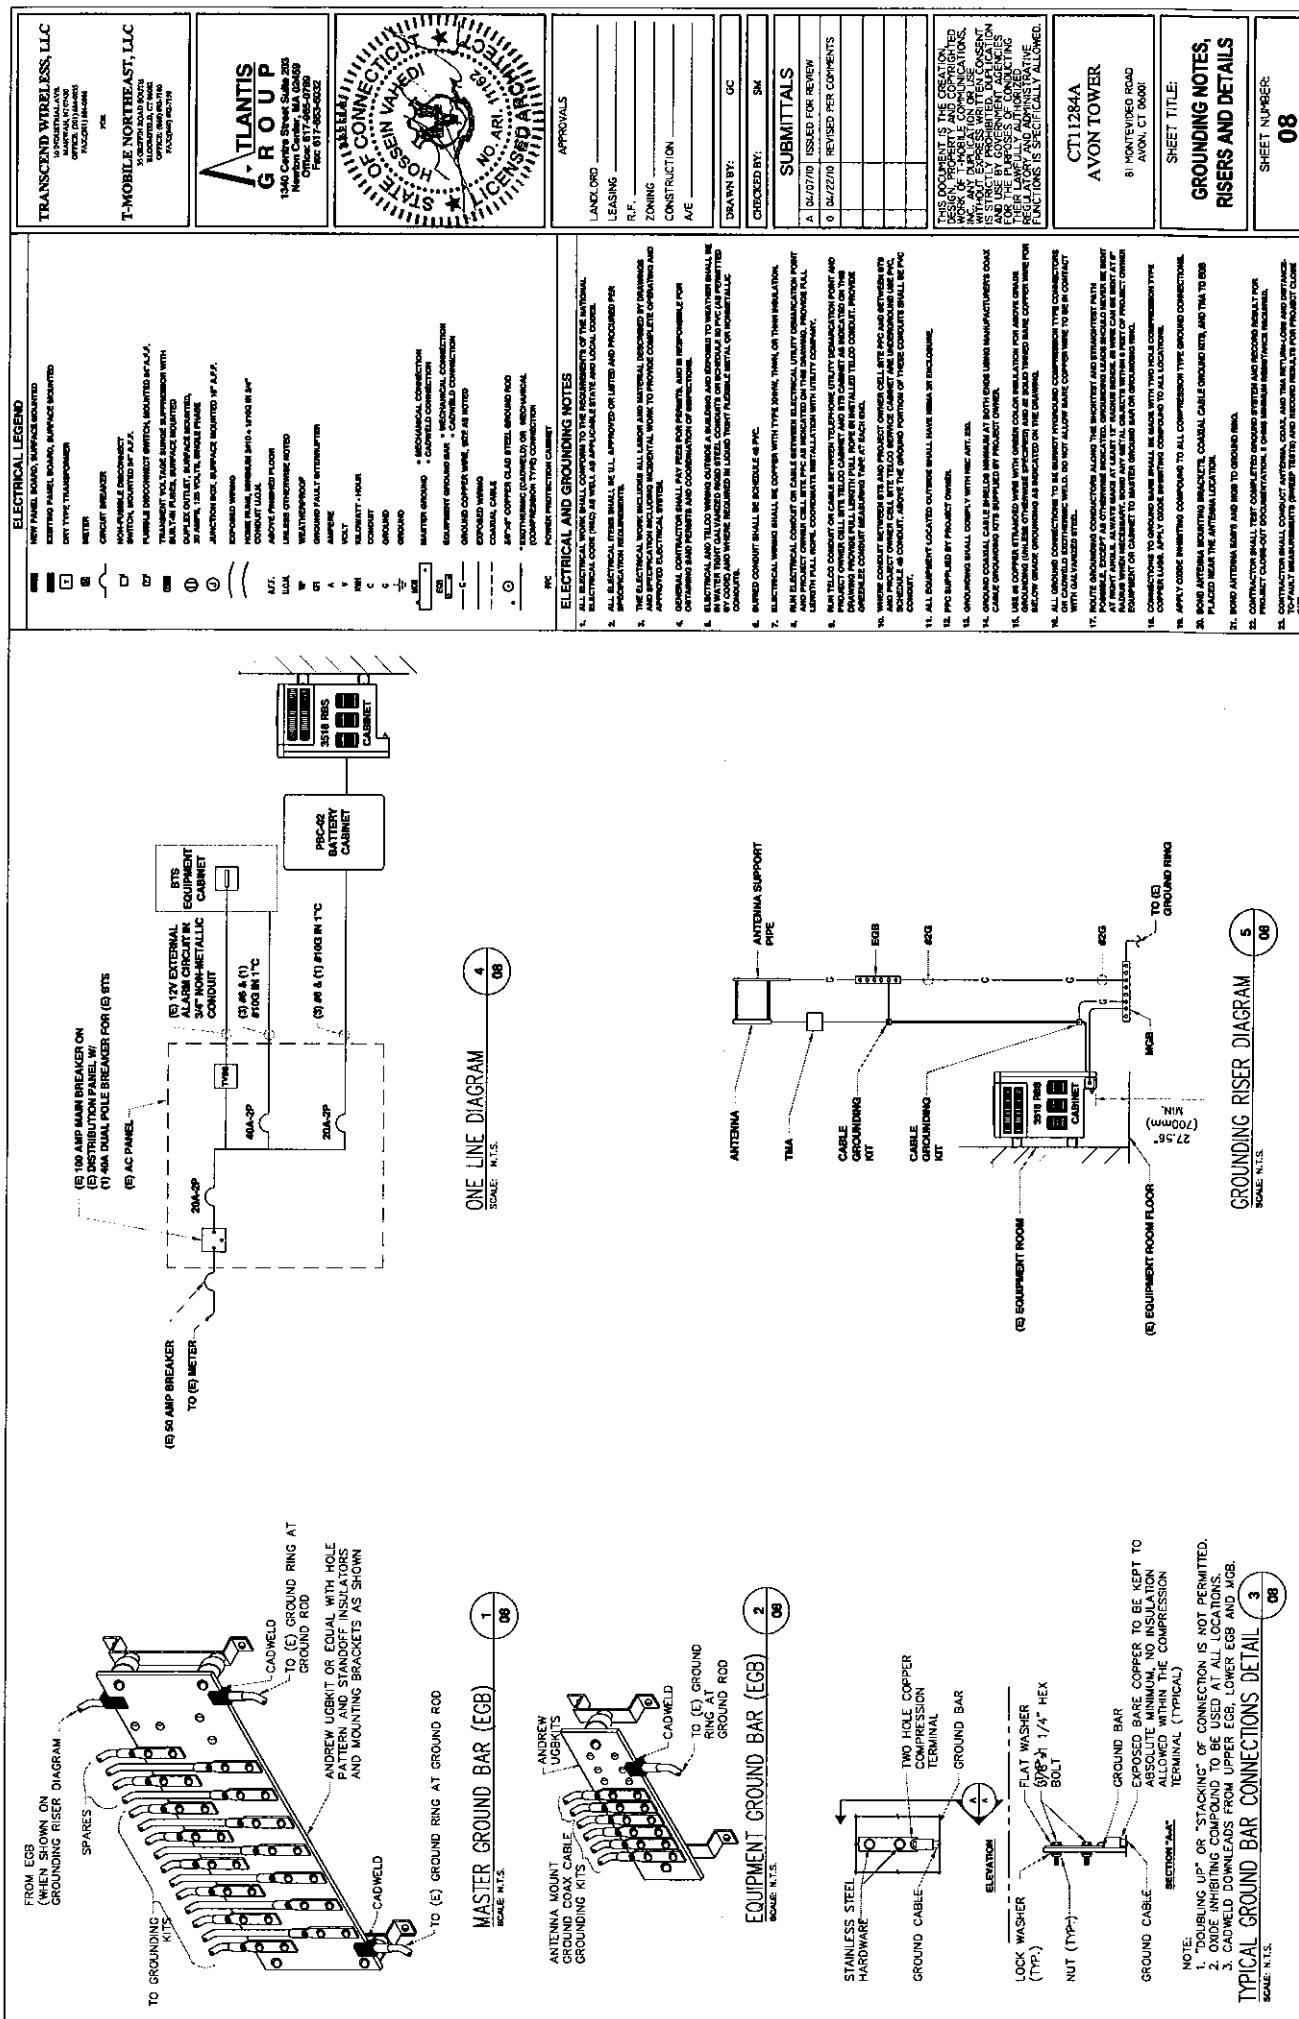

April 22, 2010

Mr. Hans Fiedler
T-Mobile USA
35 Griffin Road South
Bloomfield, CT 06002



RE: T-Mobile – CT11284A – Avon Tower
81 Montevideo Road, Avon, CT

Dear Mr. Fiedler:

We have completed the structural assessment of the subject tower and **have found it to be adequate within the scope of this analysis to support the proposed antenna loading**. This assessment is based on the Valmont tower drawings dated November 30, 2007, the lease exhibit dated March 1, 2010, and the existing antenna loading sheet dated September 22, 2008. Proposed antenna loading is per comments by JPT dated April 21, 2010.

The tower is a 150' Valmont self-supporting tower. From 0' to 90' the tower members consist of truss legs with bolted angle bracing. Above 90' the tower members consist of solid rod legs with welded solid rod bracing. Tower face dimensions range from 5'-0" at the top to 14'-0" at the base. Foundation capacities were predicated on supplied as-built details.

T-Mobile proposes to add (1) APXV18-206516S-C-A20 dual pole UMTS antenna, (1) Twin AWS TMA, (2) 1-5/8" coax @ 136' on an existing antenna frame. Proposed feed lines are to be added next to the existing T-Mobile feed lines. No reserved loading was considered in this assessment.

Our assessment of this tower is that it is acceptably loaded. The wind area added to the tower is minimal. The design loading is greater than the loading with the proposed antenna.

No conclusions, expressed or implied, shall indicate that Armor Tower has made an evaluation of the original design, materials, fabrication, or potential erection deficiencies. Any information contrary to that assumed for the purpose of preparing this analysis could alter the findings and conclusions stated.

We appreciate the opportunity to provide our services to Atlantis Group and T-Mobile. If you have any questions concerning this assessment, please contact us.

Sincerely,

Jeff Triezenberg, P.E.
ARMOR TOWER, INC.

Connecticut Market

T-Mobile

Worst Case Power Density

Site: CT11284A
 Site Address: 81 Montevideo Road
 Town: Avon
 Tower Height: 140 ft.
 Tower Style: Guyed Tower

GSM Data		UMTS Data			
Base Station TX output	20 W	Base Station TX output	40 W		
Number of channels	8	Number of channels	2		
Antenna Model	APXV18-206516L	Antenna Model	APXV18-206516L		
Cable Size	1 5/8	Cable Size	1 5/8		
Cable Length	160 ft.	Cable Length	160 ft.		
Antenna Height	136 ft.	Antenna Height	136 ft.		
Ground Reflection	1.6	Ground Reflection	1.6		
Frequency	1945.0 MHz	Frequency	2.1 GHz		
Jumper & Connector loss	4.50 dB	Jumper & Connector loss	1.50 dB		
Antenna Gain	17.6 dBi	Antenna Gain	17.6 dBi		
Cable Loss per foot	0.0116 dB	Cable Loss per foot	0.0116 dB		
Total Cable Loss	1.8560 dB	Total Cable Loss	1.8560 dB		
Total Attenuation	6.3560 dB	Total Attenuation	3.3560 dB		
Total EIRP per Channel	54.25 dBm	Total EIRP per Channel	60.26 dBm		
(In Watts)	266.34 W	(In Watts)	1062.82 W		
Total EIRP per Sector	63.29 dBm	Total EIRP per Sector	63.27 dBm		
(In Watts)	2130.69 W	(In Watts)	2125.64 W		
nsg	11.2440	nsg	14.2440		
Power Density (S) = 0.027660 mW/cm^2		Power Density (S) = 0.027595 mW/cm^2			
T-Mobile Worst Case % MPE = 5.5255%					
Equation Used: $S = \frac{(1000(grf)^2(Power) * 10^{(nsg/10)})}{4\pi(R)^2}$					
<small>Office of Engineering and Technology (OET) Bulletin 65, Edition 97-01, August 1997</small>					

Co-Location Total

Carrier	% of Standard
Verizon	
Cingular	
Sprint	3.9500 %
AT&T Wireless	
Pocket	
MetroPCS	
Nextel	
Other Antenna Systems	
Total Excluding T-Mobile	3.9500 %
T-Mobile	5.5255
Total % MPE for Site	9.4755%

Last updated	Town	Address	Latitude	Longitude	User	Owner	Trvr Type
05/07/10	Avon	81 Montevideo Road	41-48-11	72-48-04.75	T-Mobile	Message Center Mgmt	ss1
	Avon	81 Montevideo Road	41-48-11	72-48-04.75	Sprint	Message Center Mgmt	ss1
	Avon	81 Montevideo Road	41-48-11	72-48-04.75	Verizon	Message Center Mgmt	ss1

Ant Height	Twr Height	Elev.	Antennas	Equip. Bldg.
147.00	150.00	747	3 panel antennas	bldg
86.00	150.00	747	panel antenna	bldg
	150.00	747		

Comments	Action Date
various users at various heights; replace existing guyed lattice with new self-supporting lattice tower	10/16/07
various users at various heights; replace existing guyed lattice with new self-supporting lattice tower	10/16/07
replace diesel generator with propane generator	01/12/10


THOMAS J. REGAN
Direct Dial: (860) 509-6522
tregan@brownrudnick.com

CityPlace I
185 Asylum
Street
Hartford
Connecticut
06103
tel 860.509.6500
fax 860.509.6501

Via Hand Delivery

June 11, 2010

ORIGINAL

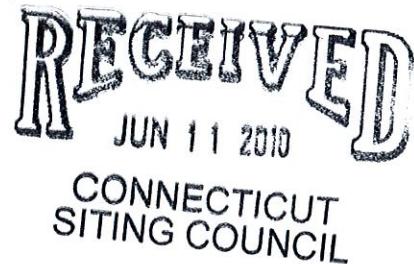

Daniel F. Caruso, Chairman
Connecticut Siting Council
10 Franklin Square
New Britain, CT 06051

RE: T-Mobile USA, Inc. – Notice of Exempt Modification

Dear Mr. Caruso:

On behalf of T-Mobile USA, Inc., enclosed for filing you will find an original and five (5) copies of a "Notice of Exempt Modification" regarding a site located at 81 Montevideo Road, Avon. The \$625.00 filing fee is also enclosed.

I would appreciate it if you could please date stamp the copy of this transmittal letter and return it to the courier delivering this package.

If you have any questions, please feel free to contact me.

Very truly yours,

BROWN RUDNICK LLP

By: _____
Thomas J. Regan

Enclosures

cc/encl: Mark W. Zacchio, Chairman Avon Town Council

40274052 v1 - REGANTJ - 025064/0016



STATE OF CONNECTICUT

CONNECTICUT SITING COUNCIL

Ten Franklin Square, New Britain, CT 06051

Phone: (860) 827-2935 Fax: (860) 827-2950

E-Mail: siting.council@ct.gov

Internet: ct.gov/csc

Daniel F. Caruso
Chairman

June 14, 2010

The Honorable Mark W. Zacchio
Chairman Town Council
Town of Avon
60 West Main Street
Avon, CT 06001-3743

RE: **EM-T-MOBILE-004-100611** – Omnipoint Communications, as subsidiary of T-Mobile USA, Inc. notice of intent to modify an existing telecommunications facility located 81 Montevideo Road, Avon, Connecticut.

Dear Chairman Town Council Zacchio:

The Connecticut Siting Council (Council) received this request to modify an existing telecommunications facility, pursuant to Regulations of Connecticut State Agencies Section 16-50j-72.

If you have any questions or comments regarding this proposal, please call me or inform the Council by June 28, 2010.

Thank you for your cooperation and consideration.

Very truly yours,

S. Derek Phelps
Executive Director

SDP/jbw

Enclosure: Notice of Intent

c: Brandon Robertson, Town Manager, Town of Avon
Steven V. Kushner, Town Planner, Town of Avon