


ATTACHMENT 4

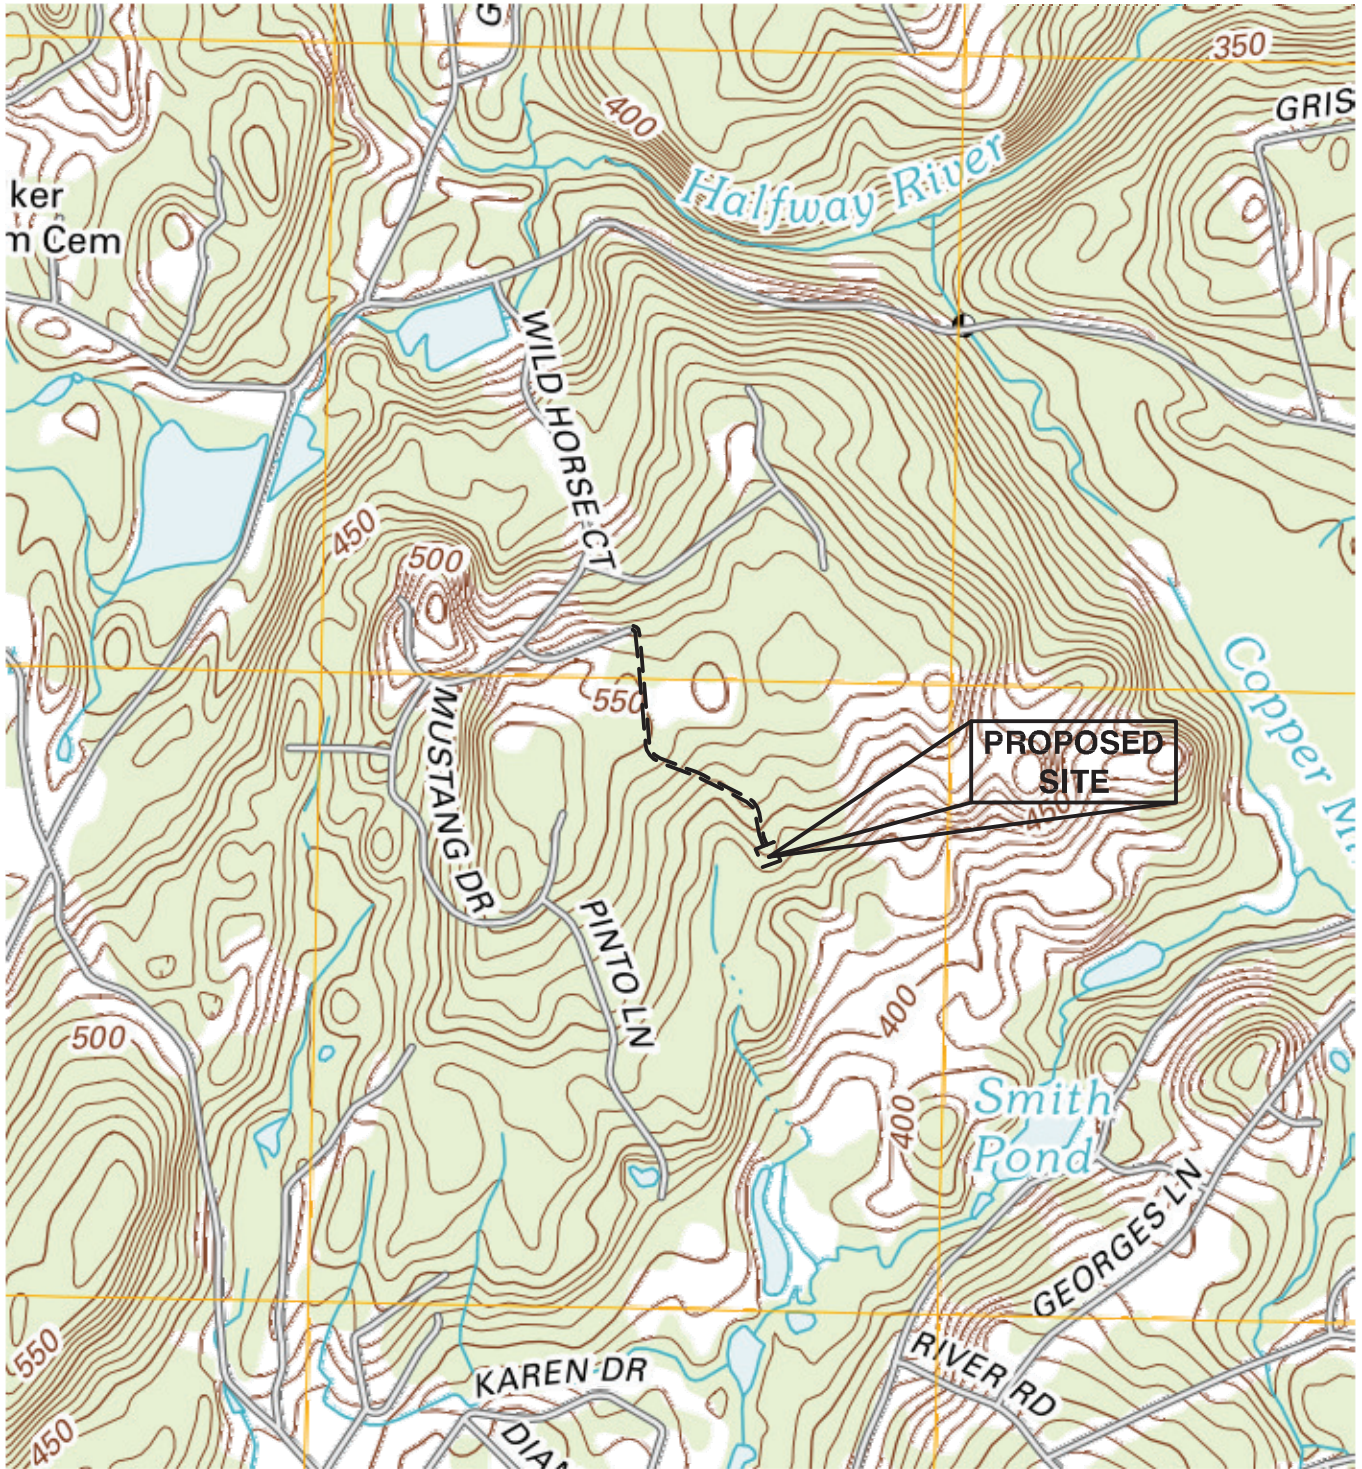

USGS MAP

SCALE: 1"=1000'

ProTerra
DESIGN GROUP, LLC

1 Short Street, Suite 3 Ph: (413)320-4918
Northampton, MA 01060 Fax: (413)320-4917

LOCATION PLANS

SITE NAME: MONROE CT
 SITE NUMBER: S1200
 ADDRESS: 30 COBBLERS HILL COURT
 MONROE, CT 06468

DATE: 7/12/13

REVISION: 0

JOB NO.:13-014

SHEET: M-2



AERIAL PHOTO

SCALE: 1"=1000'

ProTerra
DESIGN GROUP, LLC

1 Short Street, Suite 3 Ph:(413)320-4918
Northampton, MA 01060 Fax:(413)320-4917

LOCATION PLANS

SITE NAME: MONROE CT
 SITE NUMBER: S1200
 ADDRESS: 30 COBBLERS HILL COURT
 MONROE, CT 06468

DATE: 7/12/13

REVISION: 0

JOB NO.:13-014

SHEET: M-1



SITE NAME: MONROE CT
SITE NUMBER: S1200
ADDRESS: 30 COBBLERS HILL COURT
MONROE, CT 06468

CSC APPLICATION

ProTerra
 DESIGN GROUP, LLC

1 Short Street
 Suite 3
 Northampton, MA 01060
 Ph: (413)320-4918
 Fax: (413)320-4917



CLIENT:



27 Northwestern Drive
 Salem, NH 03079

NO.	DATE	REVISIONS
A	7/12/13	ISSUED FOR REVIEW
0	7/23/13	CSC TECH REPORT REVIEW
1	5/23/14	CSC APPLICATION

DRAWING INDEX		
SHEET	DESCRIPTION	REVISION
T-1	TITLE SHEET	1
C-1	ABUTTERS MAP	2
C-2 TO C-5	EXISTING CONDITIONS MAP	2
A-1	PARTIAL PLOT PLAN	1
A-2	COMPOUND PLAN & ELEVATION	1
P-1 TO P-4	DRIVEWAY PLAN & PROFILES	1
D-1 TO D-2	DETAILS	1
EC-1	EROSION CONTROL PLAN	1
EC-2	EROSION CONTROL DETAILS	1

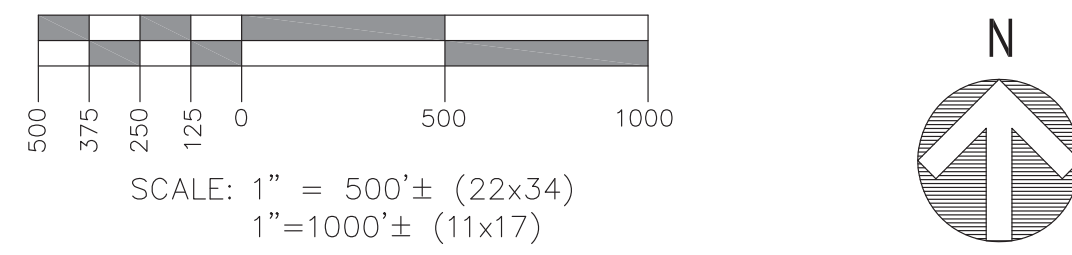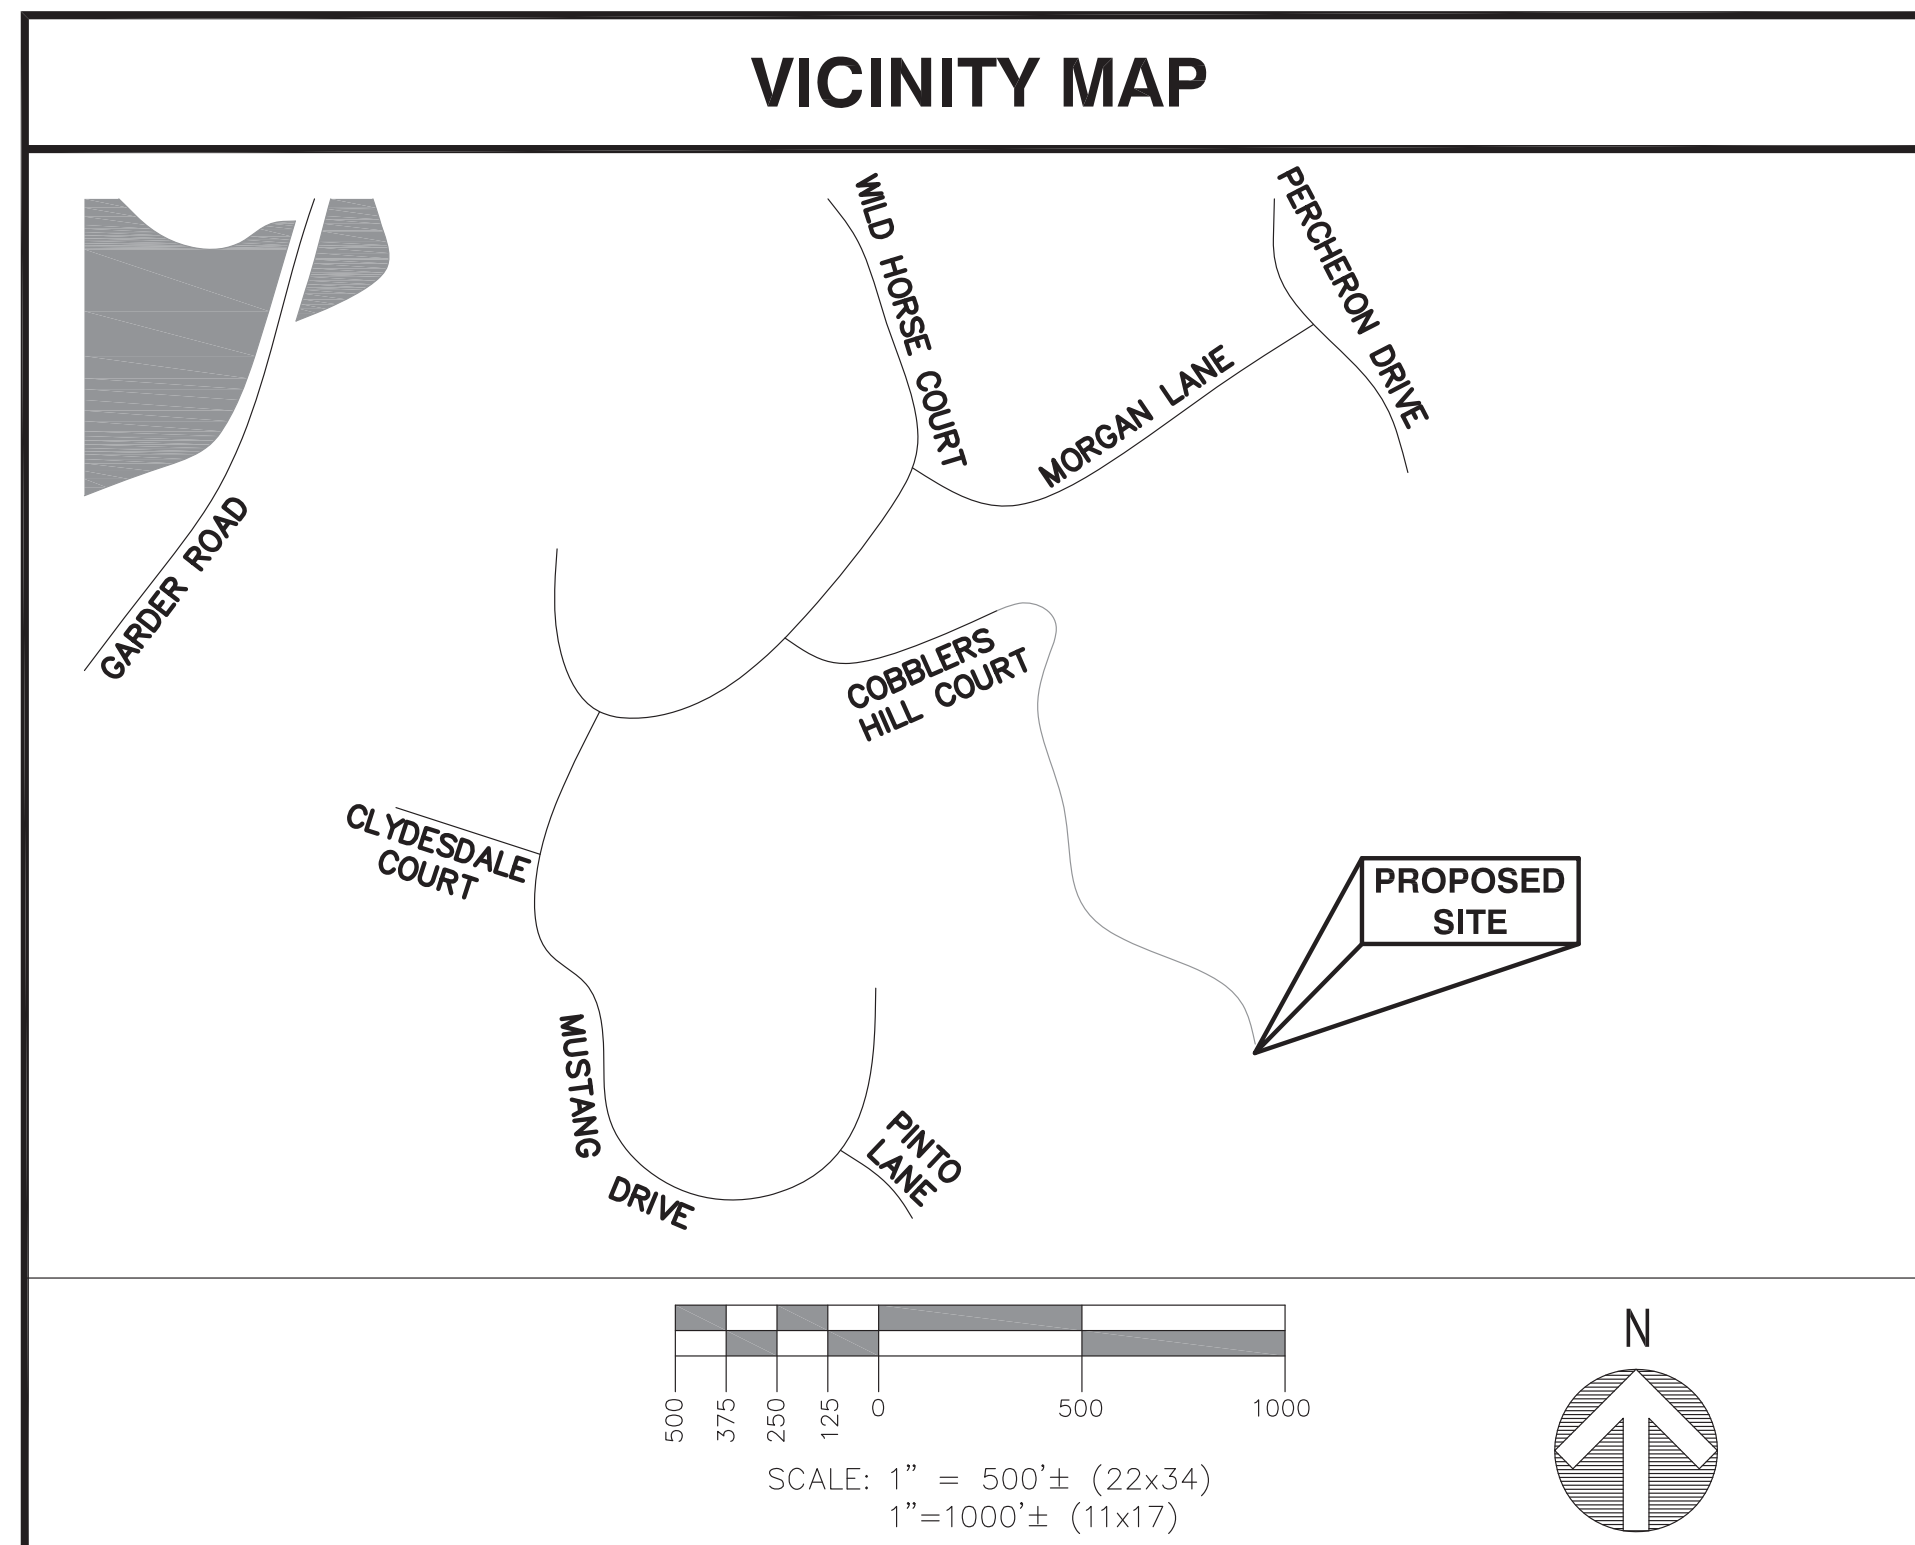

DRIVING DIRECTIONS

HEAD NORTHEAST ON ENTERPRISE DR TOWARD CAPITAL BLVD. TURN LEFT ONTO CAPITAL BLVD. TURN LEFT ONTO WEST ST. TURN LEFT TO MERGE ONTO I-91 S TOWARD NEW HAVEN. TAKE EXIT 18 TO MERGE ONTO I-691 W TOWARD MERIDEN/WATERBURY. TAKE EXIT 1 ON THE LEFT FOR I-84 W TOWARD WATERBURY/DANBURY. MERGE ONTO I-84. TAKE EXIT 11 TOWARD CT-34/DERBY/NEW HAVEN. TURN RIGHT ONTO WASSERMAN WAY. TURN RIGHT ONTO CT-34 E/BERKSHIRE RD. TURN RIGHT ONTO HIGH ROCK RD. TURN LEFT ONTO HAMMERTOWN RD. TAKE THE 1ST RIGHT ONTO WILD HORSE CT. TAKE THE 2ND LEFT ONTO COBBLERS HILL CT


PROJECT INFORMATION	
SITE TYPE:	RAW LAND
SCOPE OF WORK:	PROPOSED 162' TALL MONOPINE AND AT&T EQUIPMENT WITHIN 75'x75' FENCED COMPOUND WITH NEW 1634' DRIVEWAY.
SITE NAME:	MONROE CT
SITE NUMBER:	S1200
SITE ADDRESS:	30 COBBLERS HILL COURT MONROE, CT 06468
ASSESSOR'S TAX ID#:	MAP 107, PARCEL 8.02
ZONING DISTRICT:	RESIDENTIAL & FARMING DISTRICT D (RD)
LATITUDE:	41° 21' 18.93" N
LONGITUDE:	73° 13' 20.16" W
GROUND ELEVATION:	489'
DATUM:	NAD83/NAVD88
PROPERTY OWNER:	QUARRY RIDGE ASSOCIATES, LLC DAVID BIENASHKI 203 TURKEY ROOST ROAD MONROE, CT 06468
APPLICANT:	NEW CINGULAR WIRELESS PCS, LLC ("AT&T") 500 ENTERPRISE DRIVE ROCKY HILL, CT 06067
SURVEYOR:	NORTHEAST SURVEY CONSULTANTS 116 PLEASANT STREET; SUITE 302 PO BOX 109 EASTHAMPTON, MA 01027
ENGINEER:	PROTERRA DESIGN GROUP, LLC 1 SHORT STREET; SUITE 3 NORTHAMPTON, MA 01060

GENERAL NOTES

- CONTRACTOR SHALL VERIFY ALL PLANS AND EXISTING DIMENSIONS AND CONDITIONS ON THE JOB SITE AND SHALL IMMEDIATELY NOTIFY THE ENGINEER & AT&T REPRESENTATIVE IN WRITING OF DISCREPANCIES BEFORE PROCEEDING WITH THE WORK OR BE RESPONSIBLE FOR SAME.
- THESE PLANS ARE FOR CSC APPLICATION PURPOSES ONLY. NOT FOR CONSTRUCTION.
- ALL UNDERGROUND UTILITY INFORMATION WAS DETERMINED FROM SURFACE INVESTIGATIONS AND EXISTING PLANS OF RECORD. THE CONTRACTOR SHALL LOCATE ALL UNDERGROUND UTILITIES IN THE FIELD PRIOR TO ANY SITE WORK. CALL DIG-SAFE (888) 344-7233 72-HOURS PRIOR TO ANY EXCAVATION.
- THIS SHEET SET WAS ORIGINALLY PRINTED TO ANSI D (22"x34") WITH 1" MARGINS. PRINTING TO ANSI B (11"x17") WILL RESULT IN A HALF-SCALE (1:2) SHEET SET WITH 1/2" MARGINS. CONFIRM ALL SCALED DISTANCES WITH GRAPHICAL SCALES SHOWN HEREIN.

TITLE: **SITE NAME: MONROE CT**
SITE NUMBER: S1200
ADDRESS: 30 COBBLERS HILL COURT
MONROE, CT 06468

APPLICANT: **NEW CINGULAR WIRELESS PCS, LLC ("AT&T")**
500 ENTERPRISE DRIVE
ROCKY HILL, CT 06067

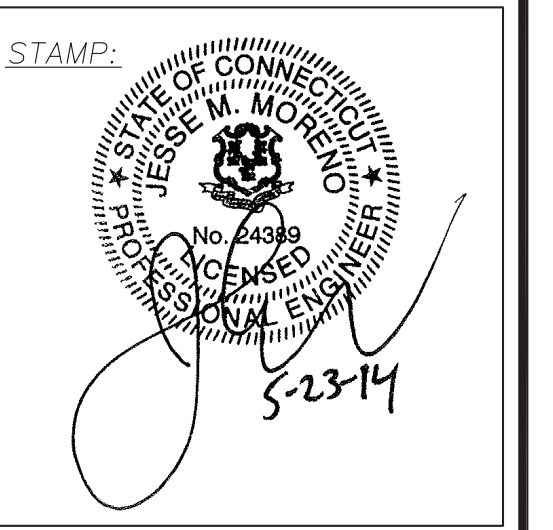

DATE: 7/12/13
 DRAWN: MJV
 CHECK: JMM/TEJ
 SCALE: SEE PLAN
 JOB NO.: 13-014
 SHEET TITLE:

TITLE SHEET

T-1

LEGEND

- N/F - NOW OR FORMERLY
- 42-345 - ASSESSOR'S MAP-LOT
- ⊙ - TOWER CONTROL POINT
- CBF - CONCRETE BOUND FOUND
- IPF - IRON PIPE FOUND
- LOCUS BOUNDARY
- - - ABUTTERS LINE
- - - ZONING LINE

LINE	BEARING	DISTANCE
L1	N72°01'43"E	22.07'
L2	N71°57'28"E	20.50'
L3	S74°29'57"E	11.13'
L4	N73°22'25"E	12.75'
L5	S53°57'36"E	19.51'
L6	N88°11'15"E	39.85'
L7	S88°02'40"E	44.69'

SURVEY NOTES

1. THIS SURVEY HAS BEEN PREPARED PURSUANT TO THE REGULATIONS OF CONNECTICUT STATE AGENCIES SECTIONS 20-300B-1 THROUGH 20-300B-20 AND THE "STANDARDS FOR SURVEYS AND MAPS IN THE STATE OF CONNECTICUT" AS ADOPTED BY THE CONNECTICUT ASSOCIATION OF LAND SURVEYORS INC. ON SEPTEMBER 26, 1997.

TYPE OF SURVEY: IMPROVEMENT LOCATION SURVEY

BOUNDARY SURVEY CATEGORY: DEPENDENT RESURVEY

CLASS OF ACCURACY: HORIZONTAL CLASS D
VERTICAL CLASS V-2

PURPOSE OF SURVEY: PROPOSED CELLULAR MONOPOLE

2. PROPERTY LINE SHOWN HERON ARE FROM RECORD DEEDS, PLOTS, AND TAX MAPS AS OVERLAIN ON ANY MONUMENTATION OR OTHER EVIDENCE THAT MAY HAVE BEEN LOCATED DURING THE TOPOGRAPHIC SURVEY. A PROPERTY LINE SURVEY WAS NOT PERFORMED BY PROTERRA DESIGN GROUP, LLC OR ITS AFFILIATES AND SUBCONTRACTORS AND AS A RESULT THE PROPERTY LINES SHOWN ARE APPROXIMATE AND DO NOT PRESENT A PROPERTY/BOUNDARY OPINION.

3. BASE MAP PREPARED BY NORTHEAST SURVEY CONSULTANTS, PC ON JULY, 11, 2013.

4. HORIZONTAL DATUM IS GRID NORTH AS DETERMINED BY THE CONNECTICUT STATE PLANE COORDINATE SYSTEM AND IS BASED UPON GPS OBSERVATIONS TAKEN AT THE TIME OF SURVEY.

5. ALL UNDERGROUND UTILITY INFORMATION WAS DETERMINED FROM SURFACE INVESTIGATIONS AND/OR EXISTING PLANS OF RECORD. THE CONTRACTOR SHALL LOCATE ALL UNDERGROUND UTILITIES IN THE FIELD PRIOR TO ANY SITE WORK. CALL THE FOLLOWING FOR ALL PRE-CONSTRUCTION NOTIFICATION 72-HOURS PRIOR TO ANY EXCAVATION ACTIVITY: CALL BEFORE YOU DIG: 1-800-922-4455

6. THE SURVEY PLAN IS SUBJECT TO ANY STATEMENT OF FACTS THAT AN UP-TO-DATE ABSTRACT OF TITLE WOULD DISCLOSE.

7. SUBJECT TO ALL RIGHTS, EASEMENTS, COVENANTS, OR RESTRICTIONS OF RECORD.

8. THE LOCUS PARCEL AS SHOWN IS LOCATED IN THE TOWN OF MONROE ZONE "RD" RESIDENTIAL AND FARMING DISTRICT D (2 ACRE).

9. LATITUDE/LONGITUDE/ELEVATIONS WERE OBTAINED UTILIZING CORS BASE STATIONS. LATITUDE/LONGITUDE ARE REFERENCE TO NAD83 CONNECTICUT ZONE COORDINATES SHOWN. IF ANY ARE EXPRESSED IN U.S. SURVEY FEET, ELEVATIONS ARE REFERENCED TO NAVD88. TOP OF STRUCTURE HEIGHT, IF ANY, IS DETERMINED BY VERTICAL ANGLE OR BY ACTUAL LOCATION INFORMATION BASED UPON A FAA 1A CERTIFICATION ACCURACY LEVEL AS DEFINED:

HORIZONTAL ±20 FEET/6m
VERTICAL ± 3 FEET/1m

10. THE PROJECT AREA IS LOCATED IN FLOOD ZONE "X" (UNSHADED, AREAS DETERMINED TO BE OUTSIDE THE 0.2% ANNUAL CHANCE FLOODPLAIN) AS SHOWN ON FLOOD INSURANCE RATE MAP FOR THE TOWN OF MONROE; COMMUNITY PANEL NUMBER 09001C 0276F, DATED SEPTEMBER 6, 2010.

LOCUS DEED & OWNER OF RECORD

1. THE LOCUS PARCEL IS SHOWN AS LOT 8.01 ON THE TOWN OF MONROE TAX ASSESSOR'S MAP NO. 107.

PROPERTY OWNER:	QUARRY RIDGE ASSOCIATES LLC DAVID BIENASHKI 203 TURKEY ROOST RD. MONROE CT. 06468
LOCUS DEED REF.:	DEED BOOK 1156, PAGE 191
PLAN REFERENCE:	MAP-2796 "DATA ACCUMULATION PLAN DEPICTING EXISTING CONDITIONS PREPARED FOR QUARRY RIDGE ASSOCIATES, LLC" TURKEY ROOST ROAD, MONROE CONNECTICUT PREP. BY SPATH-BJORKLUND ASSOCIATES, INC DATED 05-02-2008
	MAP-2958 "DATA ACCUMULATION PLAN PREPARED FOR QUARRY RIDGE ASSOCIATES, LLC" COBBLERS HILL COURT/TURKEY ROOST ROAD, MONROE CONNECTICUT PREP. BY SPATH-BJORKLUND ASSOCIATES, INC DATED 05-02-2008

THIS DOCUMENT AND COPIES THEREOF ARE VALID ONLY IF THEY BEAR THE LIVE SIGNATURE AND EMBOSSED SEAL OF THE DESIGNATED PROFESSIONAL. UNAUTHORIZED ALTERATIONS RENDER ANY DECLARATION NULL AND VOID.

TO THE BEST OF MY KNOWLEDGE AND BELIEF, THIS MAP IS SUBSTANTIALLY CORRECT AS NOTED HEREON.

Charles G. Gidman
CHARLES G. GIDMAN, P.L.S. #70103

1 Short Street
Suite 3
Northampton, MA 01060
Ph: (413)320-4918
Fax: (413)320-4917

CLIENT:




27 Northwestern Drive
Salem, NH 03079

NO.	DATE	REVISIONS
0	07/12/13	ISSUED FOR REVIEW
1	07/18/13	ADDITIONAL TOPOGRAPHY
2	08/20/13	ADD MAILING ADDRESSES


SITE NAME: MONROE CT
SITE: S1200
ADDRESS: 30 COBBLERS HILL COURT
MONROE, CT 06468

NEW CIRCULAR WIRELESS PCS, LLC
("AT&T")
500 ENTERPRISE DRIVE
ROCKY HILL, CT 06067

at&t

APPLICANT: 


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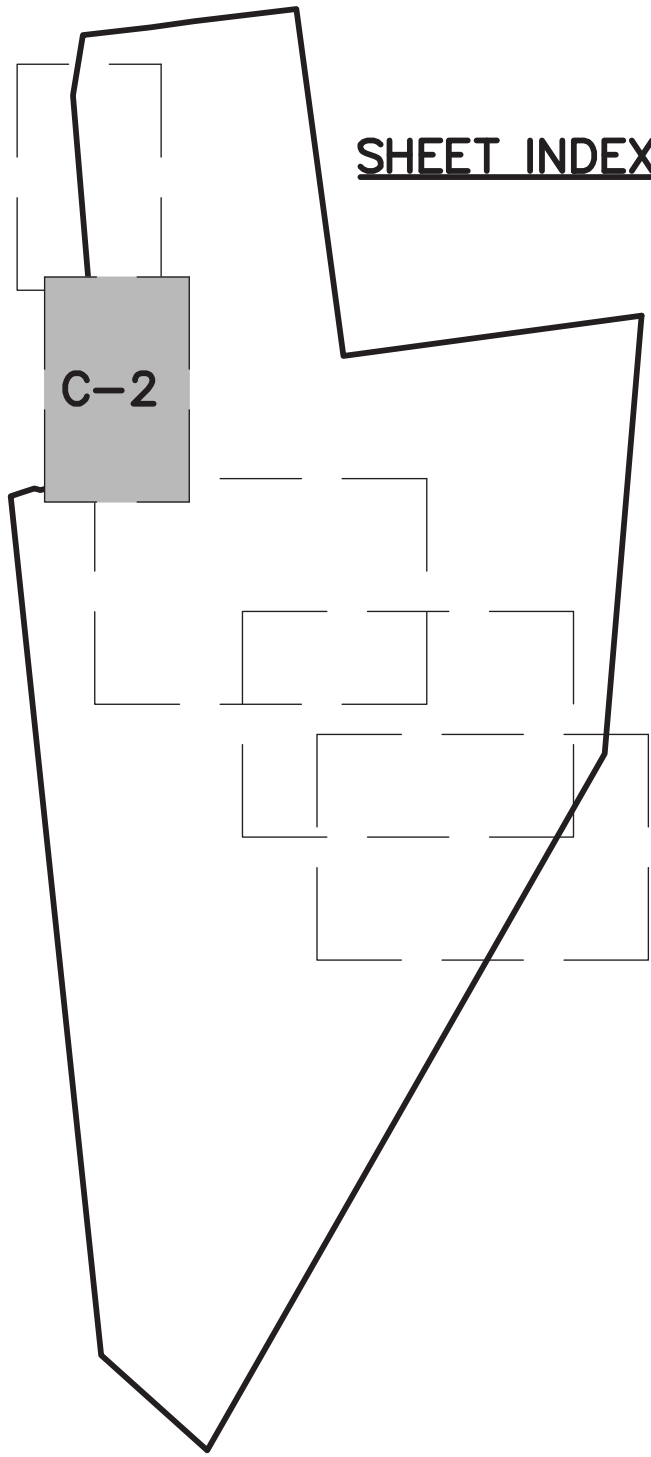
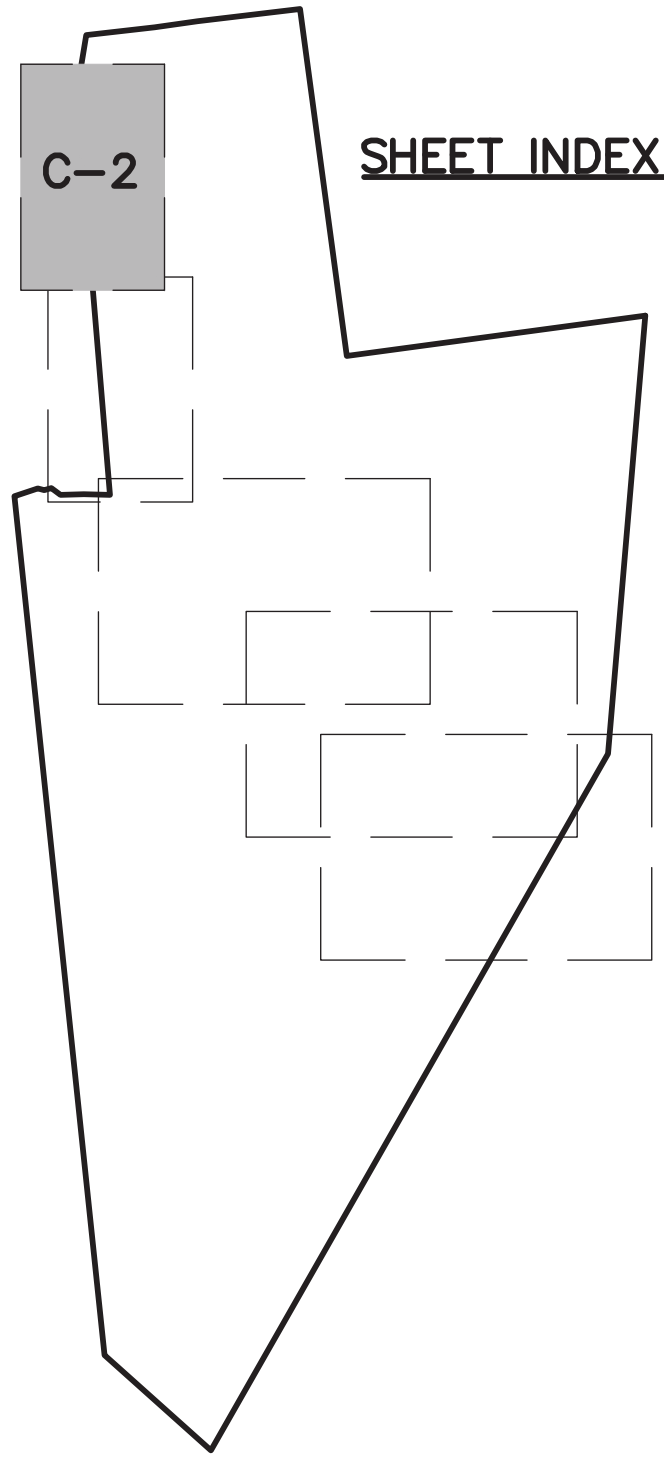
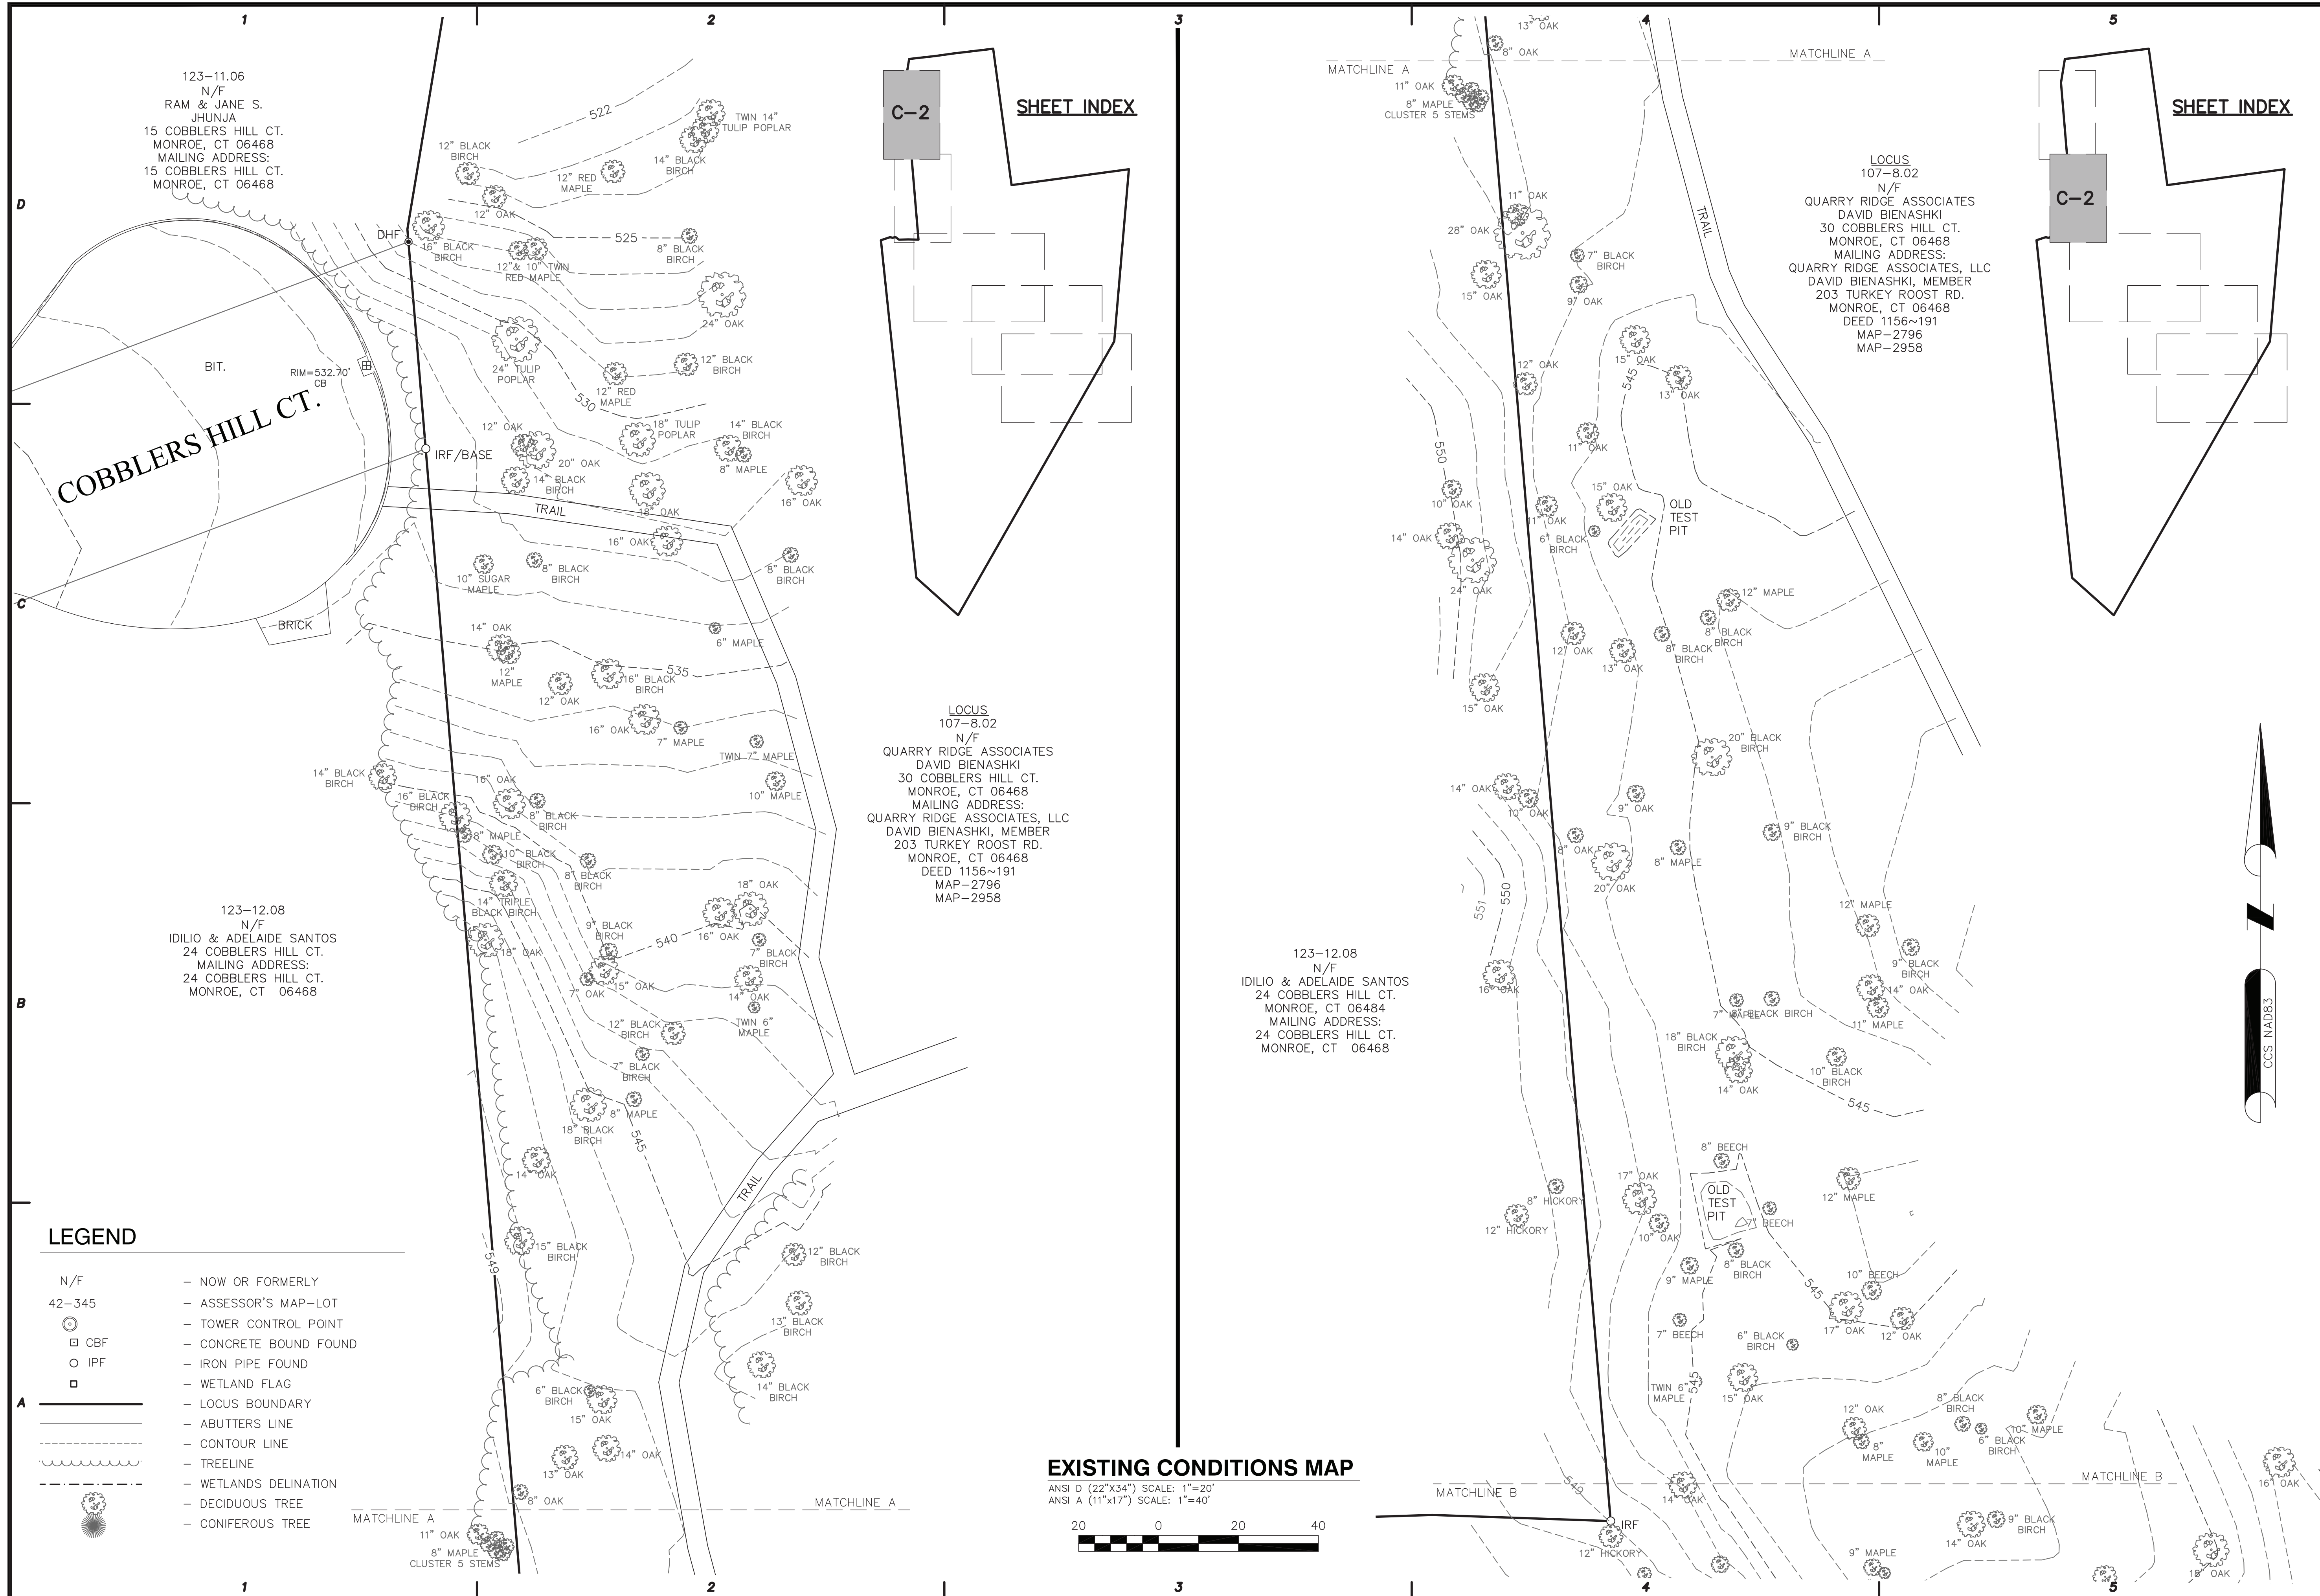


DATE: 07/18/2013
DRAWN: JED
CHECK: CGG
SCALE: 1" = 150'
JOB NO.: 13-094.1

ABUTTERS MAP

ANSI D (22"x34") SCALE: 1"=150'
ANSI A (11"x17") SCALE: 1"=300'



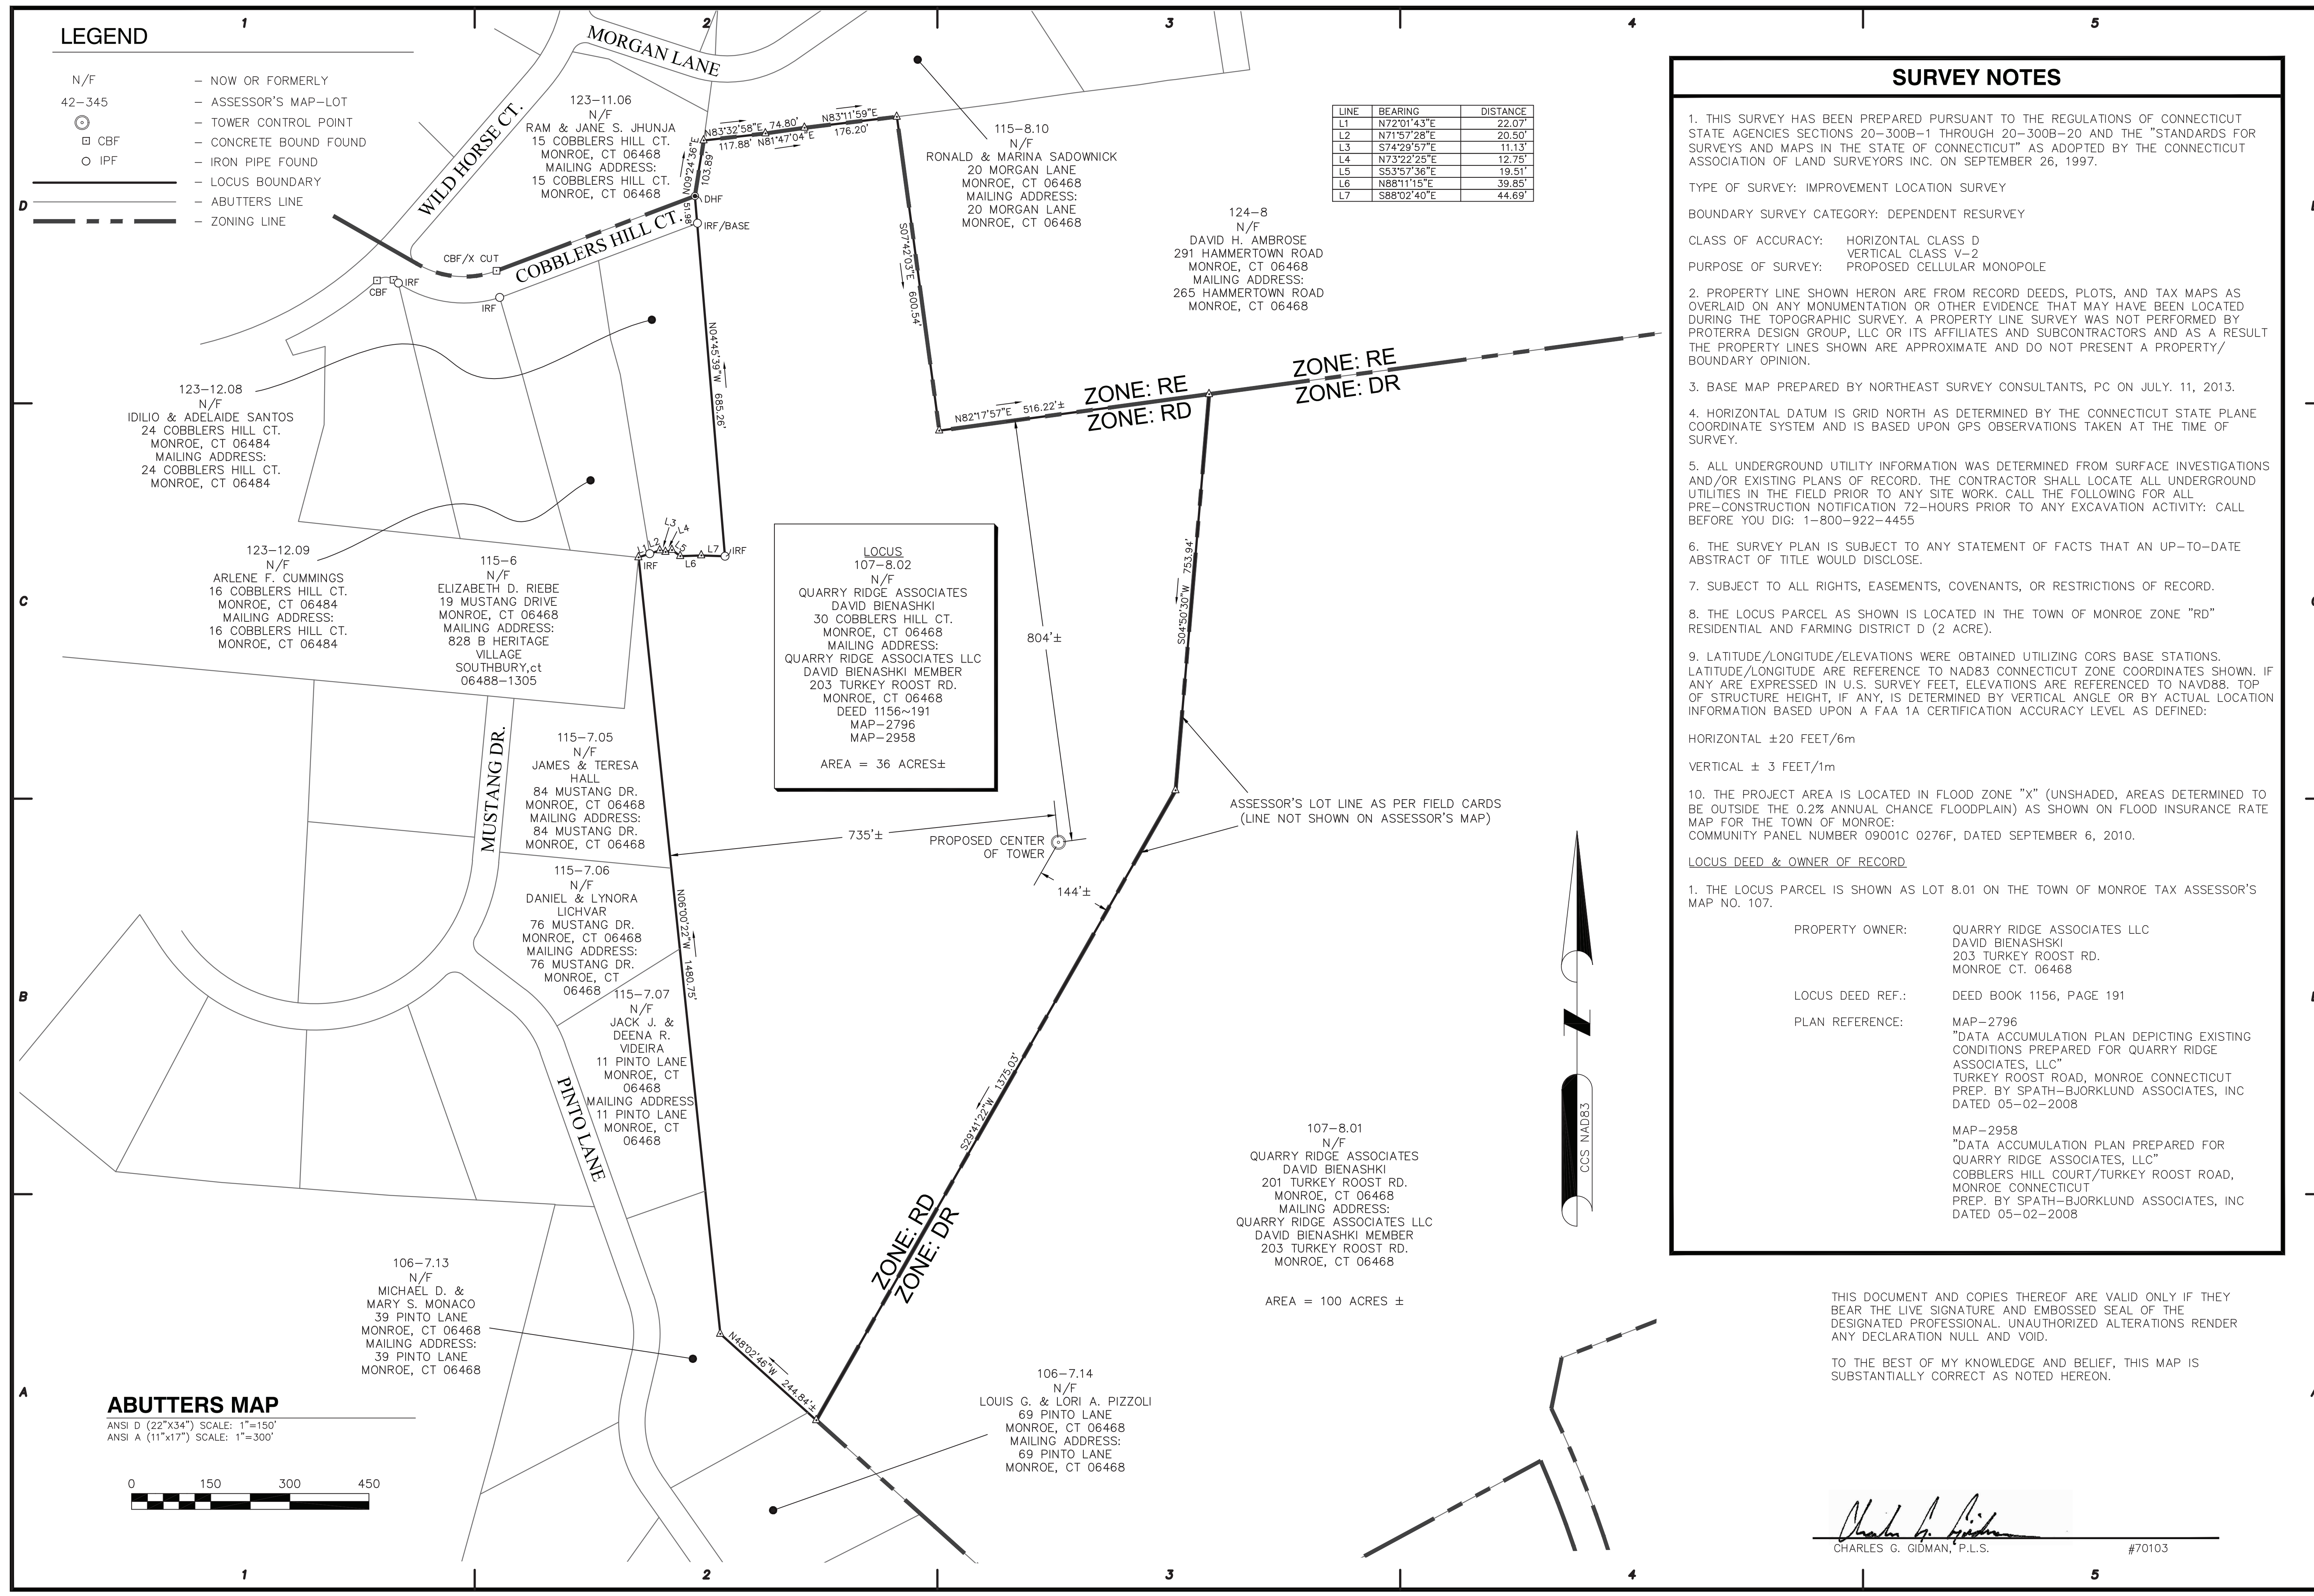

LEGEND

- N/F — NOW OR FORMERLY
- 42-345 — ASSESSOR'S MAP-LOT
- ⊙ — TOWER CONTROL POINT
- ⊠ — CONCRETE BOUND FOUND
- — IRON PIPE FOUND
- ◻ — WETLAND FLAG
- — LOCUS BOUNDARY
- — ABUTTERS LINE
- - - — CONTOUR LINE
- ~ ~ ~ — TREELINE
- - - — WETLANDS DELINATION
- — DECIDUOUS TREE
- — CONIFEROUS TREE

EXISTING CONDITIONS MAP

ANSI D (22"x34") SCALE: 1"=20'
ANSI A (11"x17") SCALE: 1"=40'



ProTerra
DESIGN GROUP, LLC

1 Short Street
Suite 3
Northampton, MA 01060
Ph: (413)320-4918
Fax: (413)320-4917

CLIENT:



27 Northwestern Drive
Salem, NH 03079

NO.	DATE	REVISIONS
0	07/12/13	ISSUED FOR REVIEW
1	07/18/13	ADDITIONAL TOPOGRAPHY

SITE NAME: MONROE CT
SITE: S1200
ADDRESS: 30 COBBLERS HILL COURT
MONROE, CT 06468

APPLICANT: **at&t**
NEW CINCULAR
WIRELESS PCS, LLC
("AT&T")
500 ENTERPRISE DRIVE
ROCKY HILL, CT 06067

STAMP:



DATE: 07/18/2013
DRAWN: JED
CHECK: CGG
SCALE: 1" = 20'
JOB NO.: 13-094.1

SHEET TITLE:
EXISTING CONDITIONS MAP


C-2

CGCS NAD83



LEGEND

- N/F — NOW OR FORMERLY
- 42-345 — ASSESSOR'S MAP-LOT
- ⊙ — TOWER CONTROL POINT
- ⊠ — CONCRETE BOUND FOUND
- — IRON PIPE FOUND
- ◻ — WETLAND FLAG
- — LOCUS BOUNDARY
- — ABUTTERS LINE
- - - - - CONTOUR LINE
- ~~~~~ TREELINE
- ~~~~~ WETLANDS DELINATION
- — DECIDUOUS TREE
- ◐ — CONIFEROUS TREE

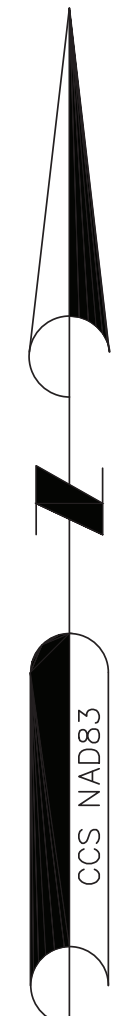

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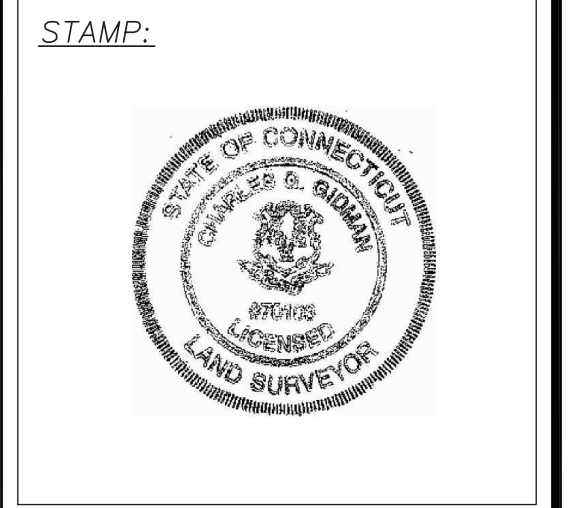


27 Northwestern Drive
Salem, NH 03079

NO.	DATE	REVISIONS
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1	07/18/13	ADDITIONAL TOPOGRAPHY

SITE NAME: MONROE CT
SITE: S1200
ADDRESS: 30 COBBLEERS HILL COURT
MONROE, CT 06468


APPLICANT:
NEW CINCULAR
WIRELESS PCS, LLC
("AT&T")
500 ENTERPRISE DRIVE
ROCKY HILL, CT 06067



DATE: 07/18/2013
DRAWN: JED
CHECK: CGG
SCALE: 1" = 20'
JOB NO.: 13-094.1

SHEET TITLE:
EXISTING
CONDITIONS MAP
C-3

SHEET INDEX

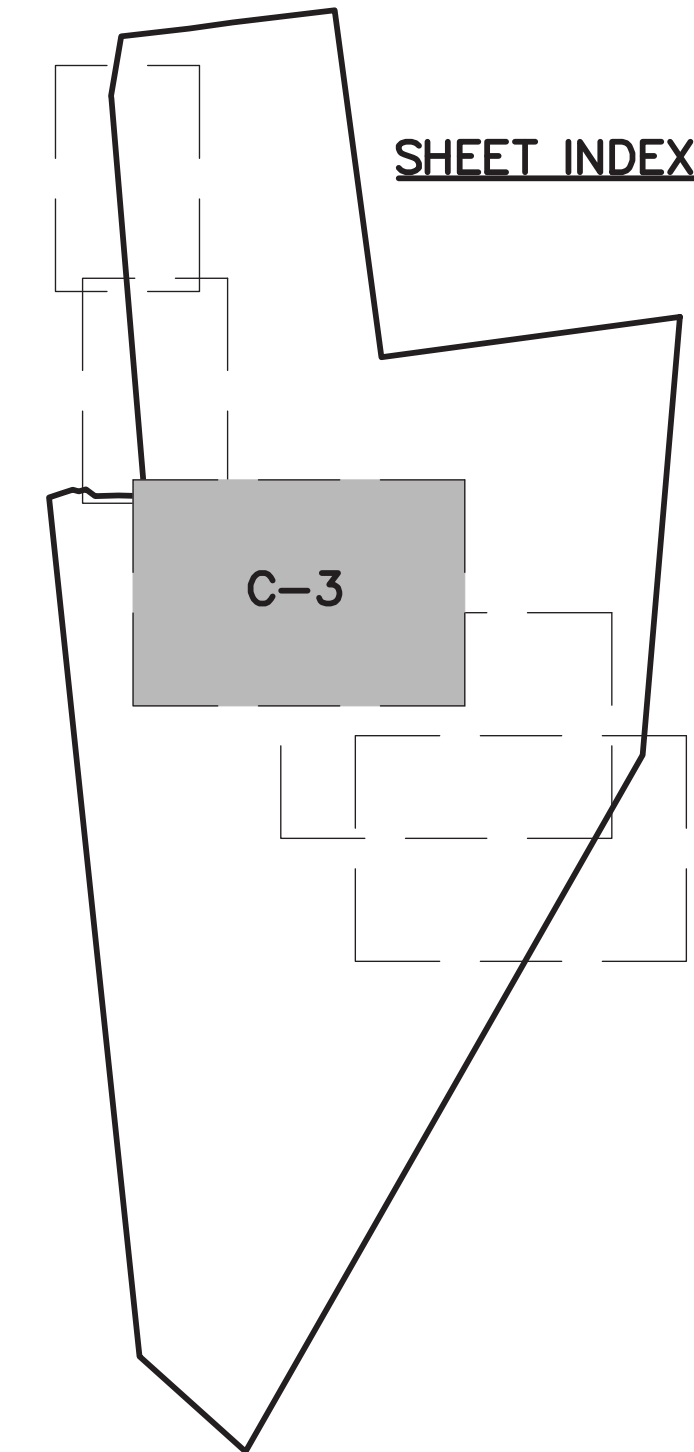

LOCUS
107-8.02
N/F
QUARRY RIDGE ASSOCIATES
DAVID BIENASHKI
30 COBBLEERS HILL CT.
MONROE, CT 06468
MAILING ADDRESS:
QUARRY RIDGE ASSOCIATES, LLC
DAVID BIENASHKI, MEMBER
203 TURKEY ROOST RD.
MONROE, CT 06468
DEED 1156~191
MAP-2796
MAP-2958

EXISTING CONDITIONS MAP

ANSI D (22"x34") SCALE: 1"=20'
ANSI A (11"x17") SCALE: 1"=40'



LEGEND

- N/F - NOW OR FORMERLY
- 42-345 - ASSESSOR'S MAP-LOT
- ⊙ - TOWER CONTROL POINT
- ⊠ - CONCRETE BOUND FOUND
- - IRON PIPE FOUND
- ⊡ - WETLAND FLAG
- - LOCUS BOUNDARY
- - ABUTTERS LINE
- - - - - CONTOUR LINE
- ~ ~ ~ ~ ~ TREELINE
- - - - - WETLANDS DELINEATION
- ☀ - DECIDUOUS TREE
- ☀ - CONIFEROUS TREE

SHEET INDEX

C-4

EXISTING CONDITIONS MAP

ANSI D (22"x34") SCALE: 1"=20'
ANSI A (11"x17") SCALE: 1"=40'



PROPOSED CENTER OF TOWER
LAT: 41°21'18.93"
LON: 73°13'20.16"
N: 690523.63'
E: 870343.03'
GROUND EL: 489'±

LOCUS
107-8.02
N/F
QUARRY RIDGE ASSOCIATES
DAVID BIENASHKI
30 COBBLERS HILL CT.
MONROE, CT 06468
MAILING ADDRESS:
QUARRY RIDGE ASSOCIATES, LLC
DAVID BIENASHKI, MEMBER
203 TURKEY ROOST RD.
MONROE, CT 06468
DEED 1156~191
MAP-2796
MAP-2958

CONTROL ROD A
N: 690568.49'
E: 870395.39'
EL: 485.81'

ProTerra
DESIGN GROUP, LLC

1 Short Street
Suite 3
Northampton, MA 01060
Ph: (413)320-4918
Fax: (413)320-4917

CLIENT:




27 Northwestern Drive
Salem, NH 03079

NO.	DATE	REVISIONS
0	07/12/13	ISSUED FOR REVIEW
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SITE NAME: MONROE CT
SITE: S1200
ADDRESS: 30 COBBLERS HILL COURT
MONROE, CT 06468


APPLICANT:
NEW CINCULAR
WIRELESS PCS, LLC
("AT&T")
500 ENTERPRISE DRIVE
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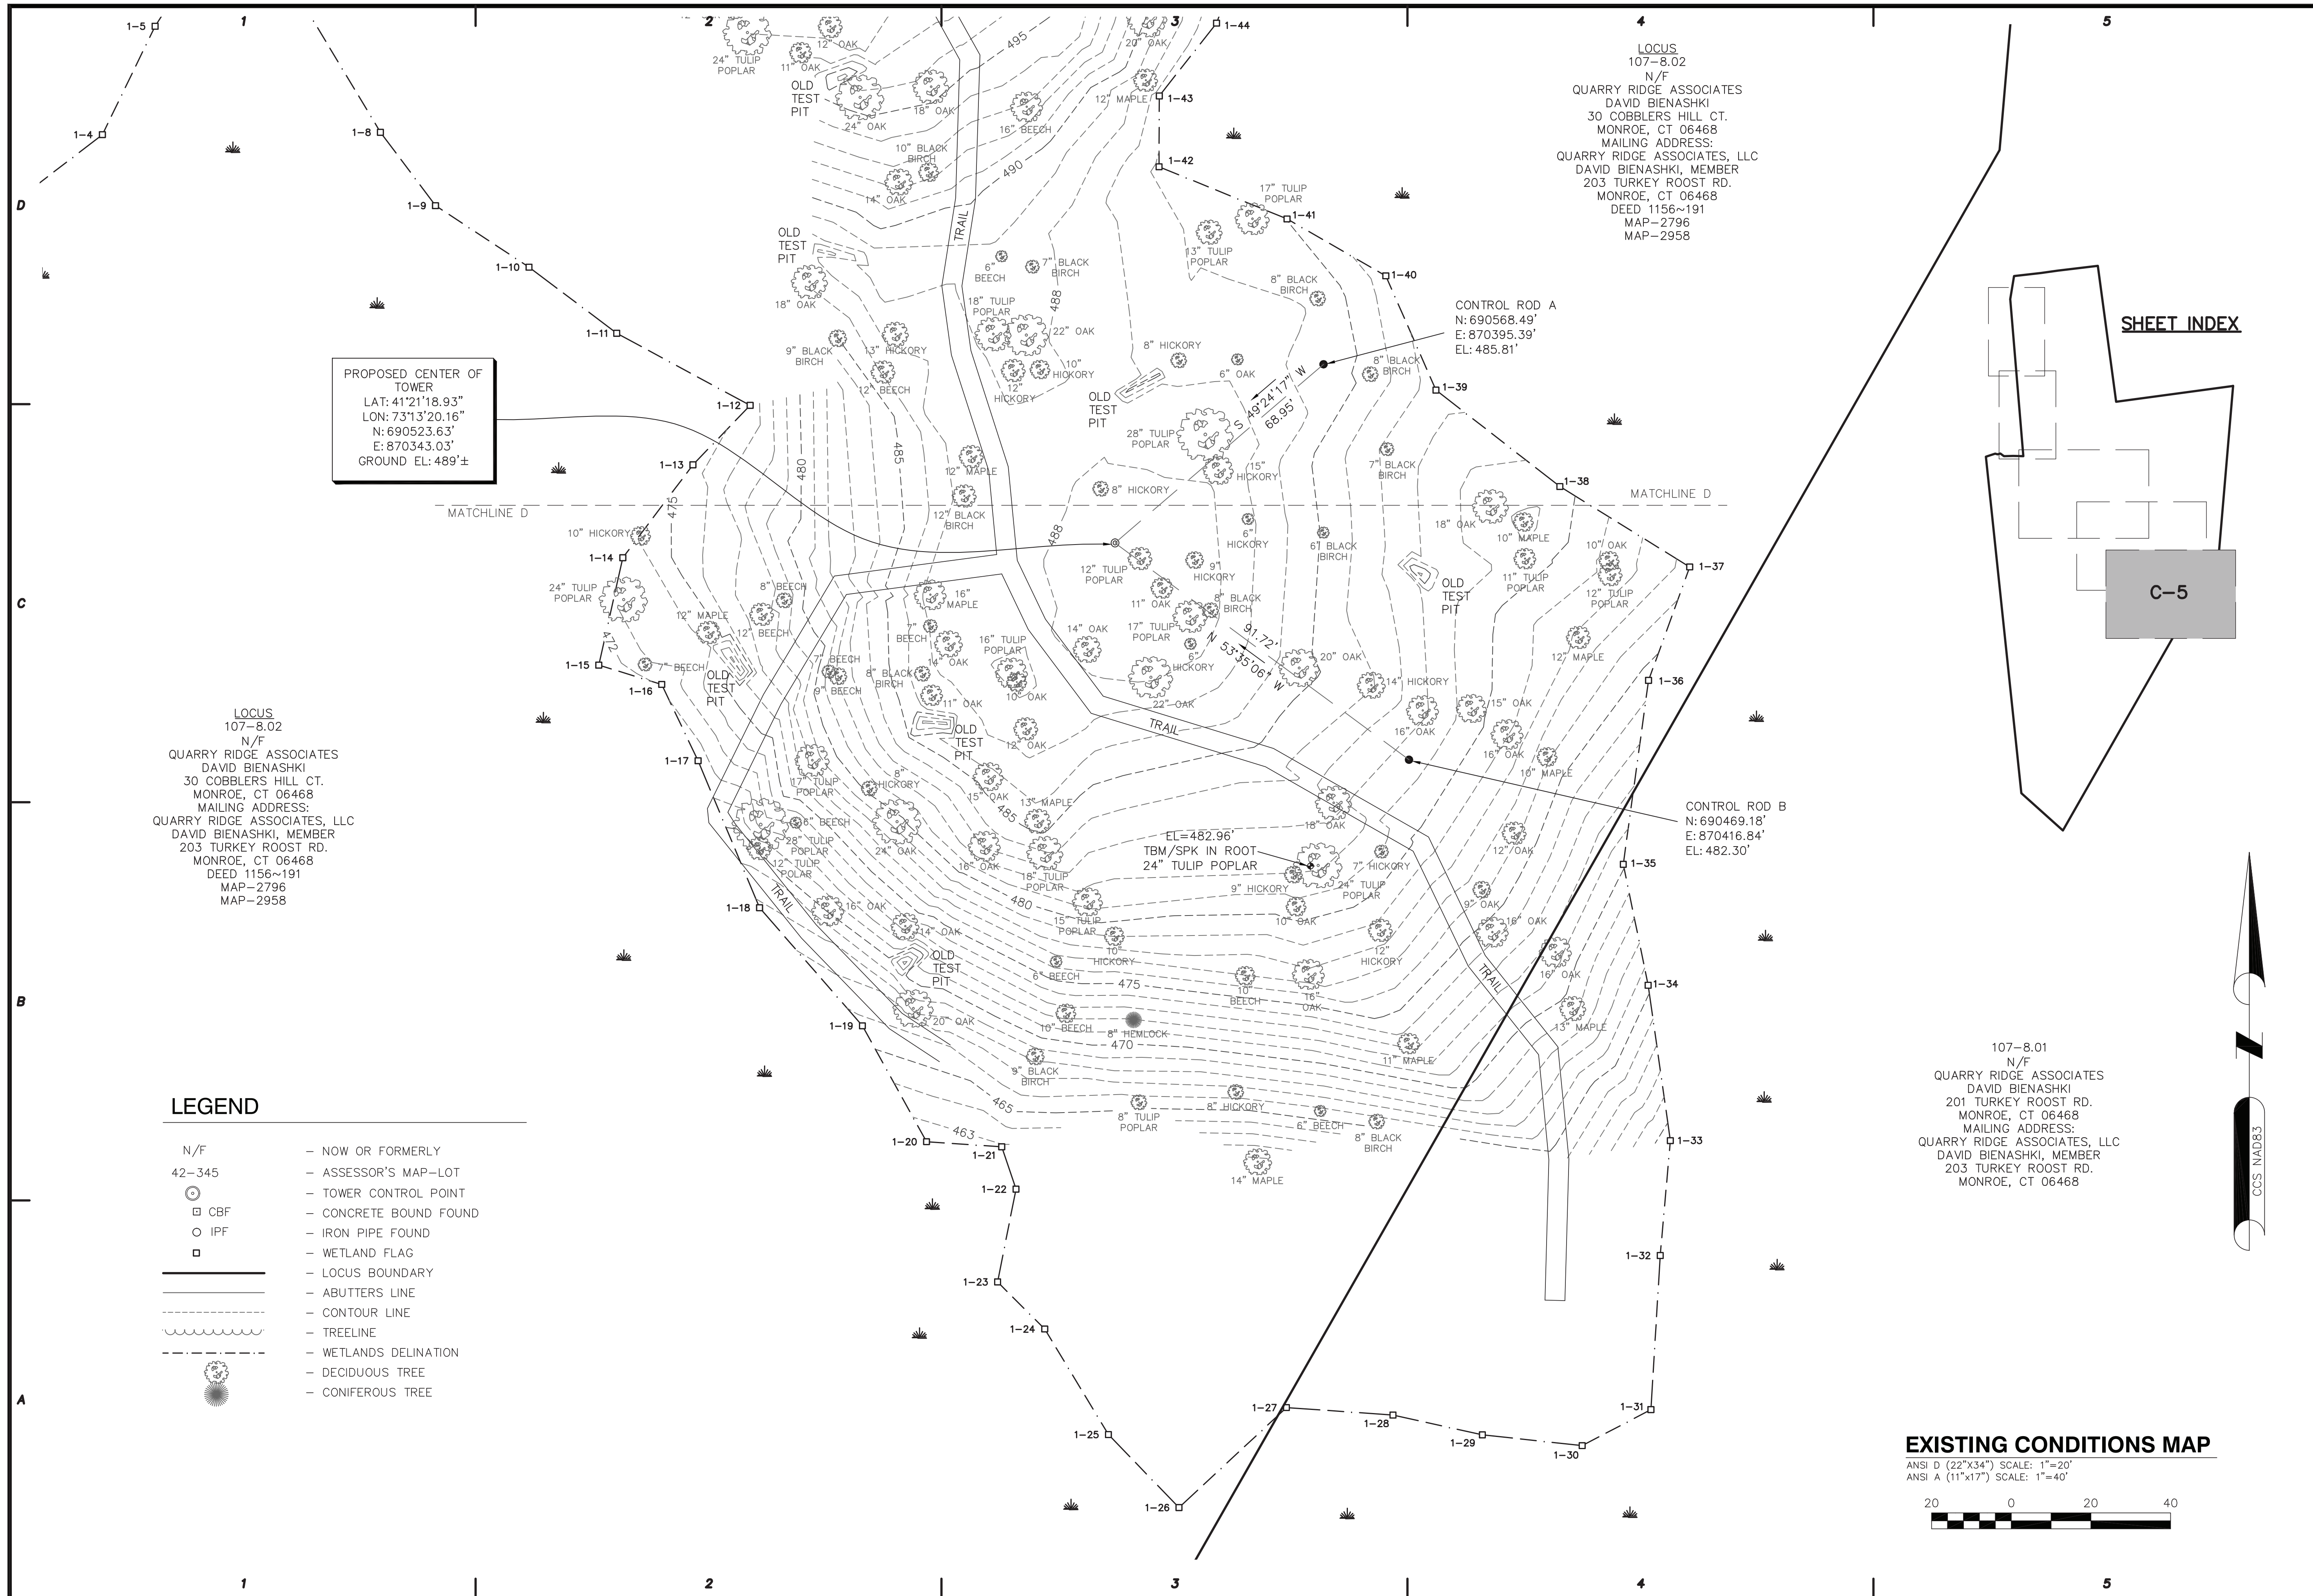
at&t



DATE: 07/18/2013
DRAWN: JED
CHECK: CGG
SCALE: 1" = 20'
JOB NO.: 13-094.1

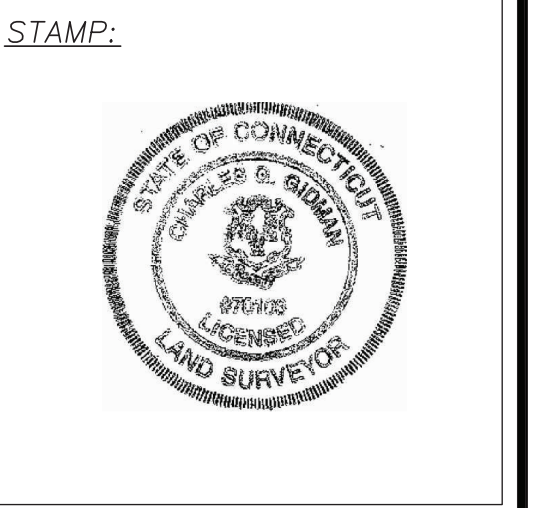SHEET TITLE:
EXISTING CONDITIONS MAP
C-4



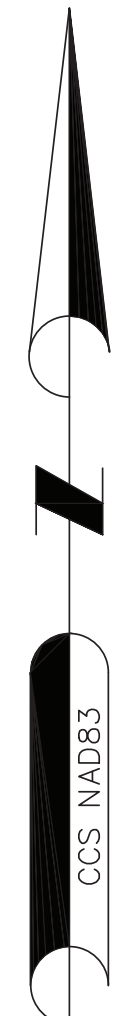

PROPOSED CENTER OF TOWER
 LAT: 41°21'18.93"
 LON: 73°13'20.16"
 N: 690523.63'
 E: 870343.03'
 GROUND EL: 489'±

LOCUS
 107-8.02
 N/F
 QUARRY RIDGE ASSOCIATES
 DAVID BIENASHKI
 30 COBBLEERS HILL CT.
 MONROE, CT 06468
 MAILING ADDRESS:
 QUARRY RIDGE ASSOCIATES, LLC
 DAVID BIENASHKI, MEMBER
 203 TURKEY ROOST RD.
 MONROE, CT 06468
 DEED 1156~191
 MAP-2796
 MAP-2958

LOCUS
 107-8.02
 N/F
 QUARRY RIDGE ASSOCIATES
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 30 COBBLEERS HILL CT.
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 203 TURKEY ROOST RD.
 MONROE, CT 06468
 DEED 1156~191
 MAP-2796
 MAP-2958

CONTROL ROD A
 N: 690568.49'
 E: 870395.39'
 EL: 485.81'

CONTROL ROD B
 N: 690469.18'
 E: 870416.84'
 EL: 482.30'

SHEET INDEX

C-5

LEGEND

- N/F - NOW OR FORMERLY
- 42-345 - ASSESSOR'S MAP-LOT
- ⊙ - TOWER CONTROL POINT
- CBF - CONCRETE BOUND FOUND
- IPF - IRON PIPE FOUND
- - WETLAND FLAG
- LOCUS BOUNDARY
- ABUTTERS LINE
- CONTOUR LINE
- TREELINE
- WETLANDS DELINATION
- DECIDUOUS TREE
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EXISTING CONDITIONS MAP

ANSI D (22"x34") SCALE: 1"=20'
 ANSI A (11"x17") SCALE: 1"=40'

ProTerra
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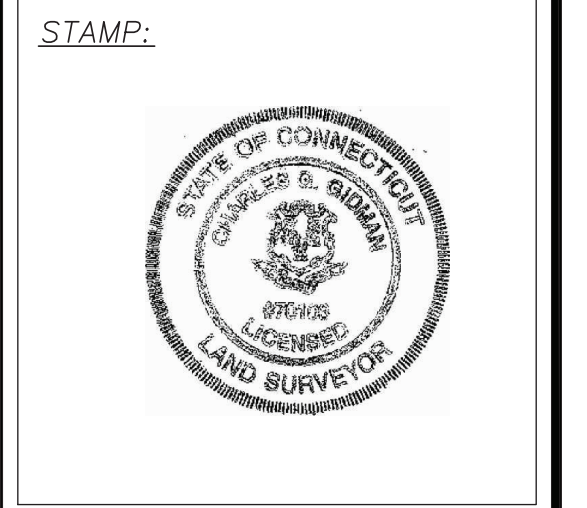
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NO.	DATE	REVISIONS
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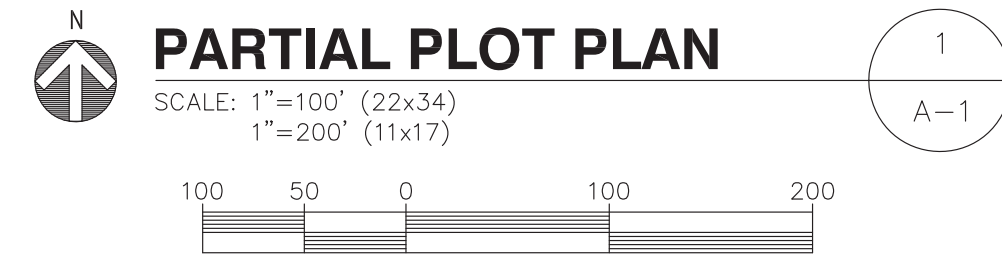
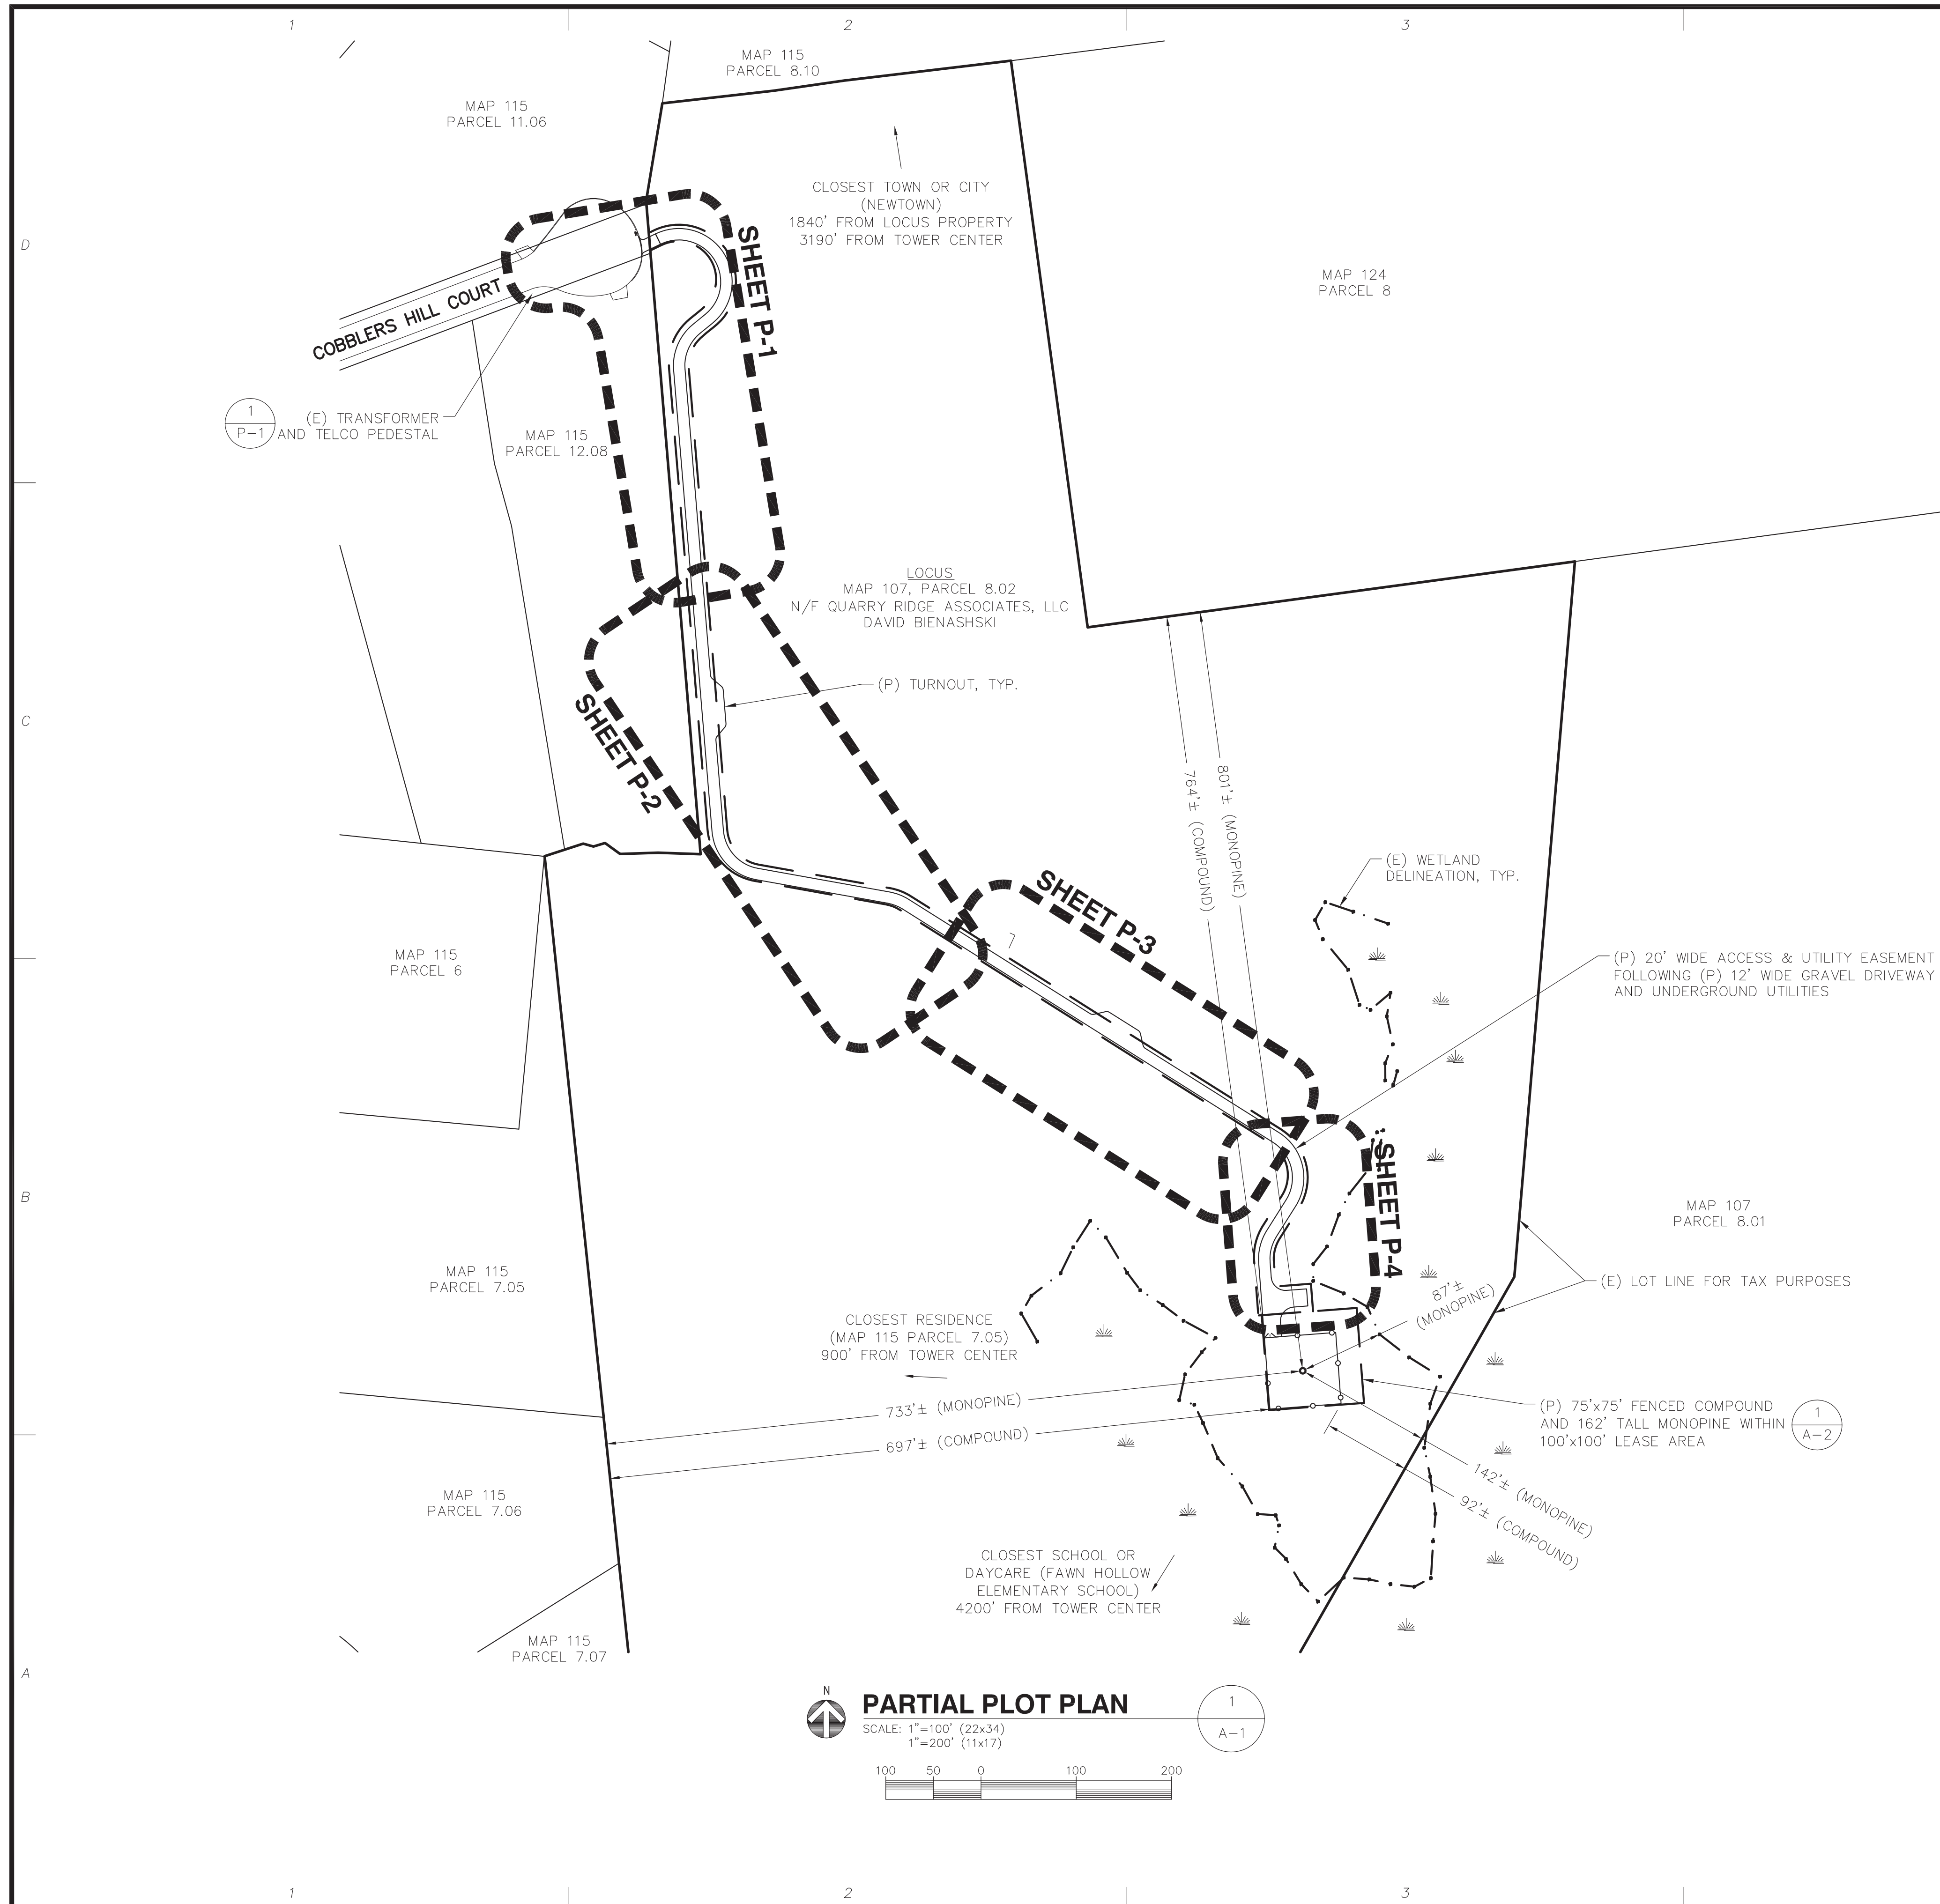
APPLICANT:
 NEW CIRCULAR
 WIRELESS PCS, LLC
 ("AT&T")
 500 ENTERPRISE DRIVE
 ROCKY HILL, CT 06067

at&t



DATE: 07/18/2013
 DRAWN: JED
 CHECK: CGG
 SCALE: 1" = 20'
 JOB NO.: 12-094.1

SHEET TITLE:
EXISTING CONDITIONS MAP
C-5



CSC DIMENSIONS

ZONING DISTRICT:	RESIDENTIAL & FARMING DISTRICT D (RD)
ASSESSORS ID:	MAP 107, PARCEL 8.02
(P) USE:	WIRELESS COMMUNICATIONS FACILITY
MONOPOLE HEIGHT	162'±
EXISTING SITE ACCESS LENGTH	NONE
PROPOSED SITE ACCESS LENGTH	16.34'±
NUMBER OF TREES OVER 6" DBH TO BE REMOVED	164
NUMBER OF RESIDENCES WITHIN 1000 FEET	3
CLOSEST TOWN OR CITY TO LOCUS PARCEL	1840' (NEWTOWN)
FOLLOWING DISTANCES FROM TOWER CENTER	
NEAREST WETLANDS	89'± TO WETLAND FLAG 1-39
NORTHERN PROPERTY BOUNDARY	803'±
SOUTHERN PROPERTY BOUNDARY	1131'±
WESTERN PROPERTY BOUNDARY	735'±
EASTERN PROPERTY BOUNDARY	144'±
CLOSEST SCHOOL OR DAYCARE	4200'± (FAWN HOLLOW ELEM. SCHOOL)
CLOSEST TOWN OR CITY	3190'± (NEWTOWN)

DISTURBANCE SUMMARY

LOCATION	AREA (SF)
FENCED COMPOUND - TREE CLEARING	7980
FENCED COMPOUND - GRAVEL SURFACE & DRAINAGE STRUCTURES	5625
FENCED COMPOUND - LOAM & SEED	2355
DRIVEWAY - TREE CLEARING	59,600
DRIVEWAY - GRAVEL SURFACE & DRAINAGE STRUCTURES	28,300
DRIVEWAY - LOAM & SEED	32,000
TOTAL EARTH DISTURBANCE	68,250

AT COMPLETION OF CONSTRUCTION, **33,925 SF** WILL BE COVERED WITH NEW GRAVEL DRIVEWAY, DRAINAGE STRUCTURES, AND WITHIN THE FENCED AREA. **34,355 SF** WILL BE LOAMED & SEEDED AND ALLOWED TO RETURN TO A NATURAL CONDITION.

GENERAL NOTES

1. THE TYPE, DIMENSIONS, MOUNTING HARDWARE, AND POSITIONS OF ALL PROJECT OWNER'S EQUIPMENT ARE SHOWN IN ILLUSTRATIVE FASHION. THESE DRAWINGS ARE NOT INTENDED FOR CONSTRUCTION. ACTUAL HARDWARE DETAILS AND FINAL LOCATIONS MAY DIFFER SLIGHTLY FROM WHAT IS SHOWN.
2. THE PROJECT OWNER'S PCS FACILITY IS AN UNMANNED PRIVATE AND SECURED EQUIPMENT INSTALLATION. IT IS ONLY ACCESSED BY TRAINED TECHNICIANS FOR PERIODIC ROUTINE MAINTENANCE AND THEREFORE DOES NOT REQUIRE ANY WATER OR SANITARY SEWER SERVICE. THE FACILITY IS NOT GOVERNED BY REGULATIONS REQUIRING PUBLIC ACCESS PER ADA REQUIREMENTS.
3. THE DESIGN OF THE TOWER, FOUNDATION AND ANTENNA MOUNTING HARDWARE WILL MEET THE ANSI/EIA/TIA-222-F STANDARDS FOR STRUCTURAL STEEL ANTENNA SUPPORTING STRUCTURES AND STATE BUILDING CODE REQUIREMENTS. DETAILED CONSTRUCTION DRAWINGS AND STRUCTURAL CALCULATIONS WILL BE PREPARED BY A REGISTERED PROFESSIONAL ENGINEER AND SUBMITTED WITH A BUILDING PERMIT APPLICATION FOR REVIEW AND APPROVAL BY THE LOCAL BUILDING CODE ENFORCEMENT OFFICIAL.
4. ONCE THE FACILITY BECOMES FULLY OPERATIONAL, NORMAL AND ROUTINE MAINTENANCE BY TOWER OWNER'S AND CARRIER'S TECHNICIANS WILL BE PERFORMED. THE ESTIMATED VEHICULAR TRAFFIC GENERATED BY THESE VISITS IS PREDICTED TO BE LESS THAN THE TYPICAL TRAFFIC GENERATED BY A SINGLE-FAMILY DWELLING.

CLIENT:




27 Northwestern Drive
Salem, NH 03079

NO.	DATE	REVISIONS
A	7/12/13	ISSUED FOR REVIEW
0	7/23/13	CSC TECH REPORT REVIEW
1	5/23/14	CSC APPLICATION

SITE NAME: MONROE CT
SITE NUMBER: S1200
ADDRESS: 30 COBBLERS HILL COURT
MONROE, CT 06468



NEW CIRCULAR WIRELESS PCS LLC ("AT&T")
 500 ENTERPRISE DRIVE
 ROCKY HILL, CT 06007

APPLICANT:

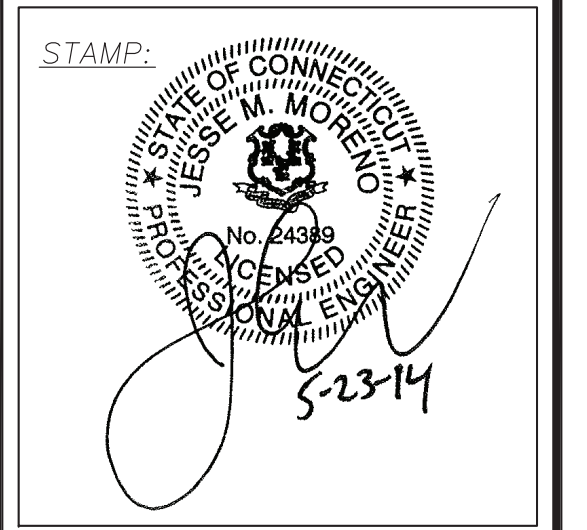

DATE: 7/12/13
 DRAWN: MJV
 CHECK: JMM/TEJ
 SCALE: SEE PLAN
 JOB NO.: 13-014

SHEET TITLE:
PARTIAL PLOT PLAN
A-1

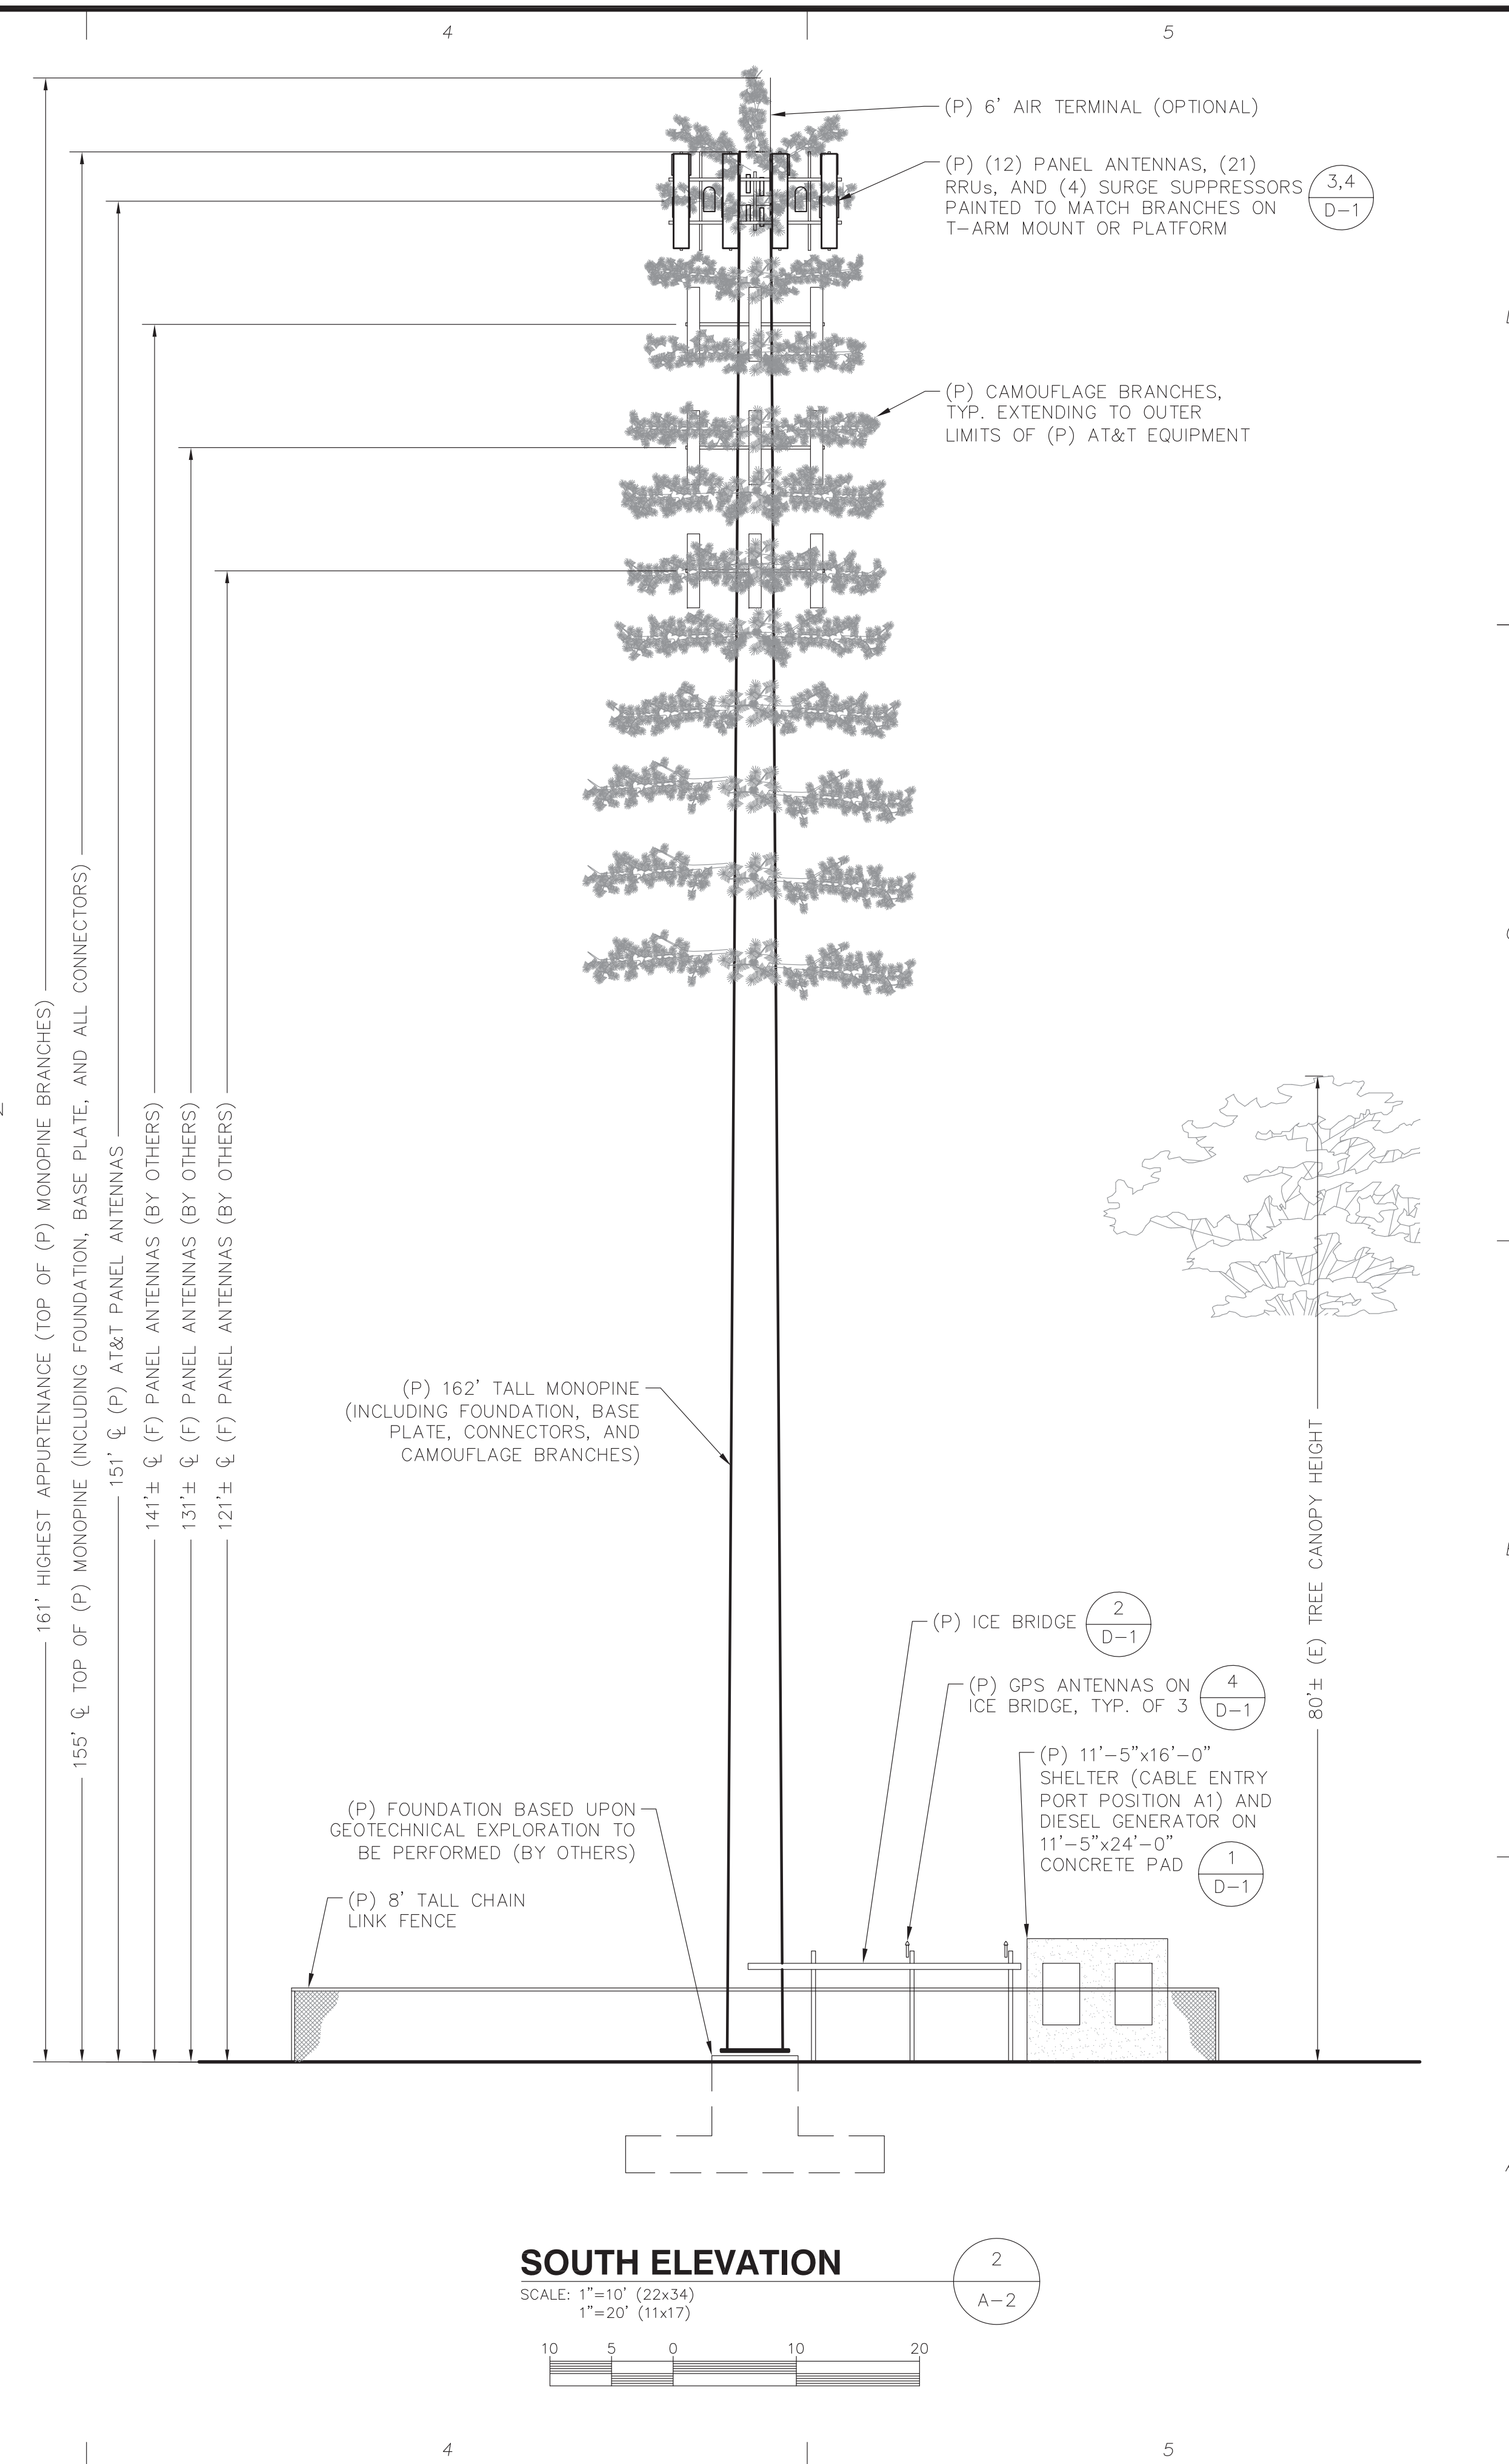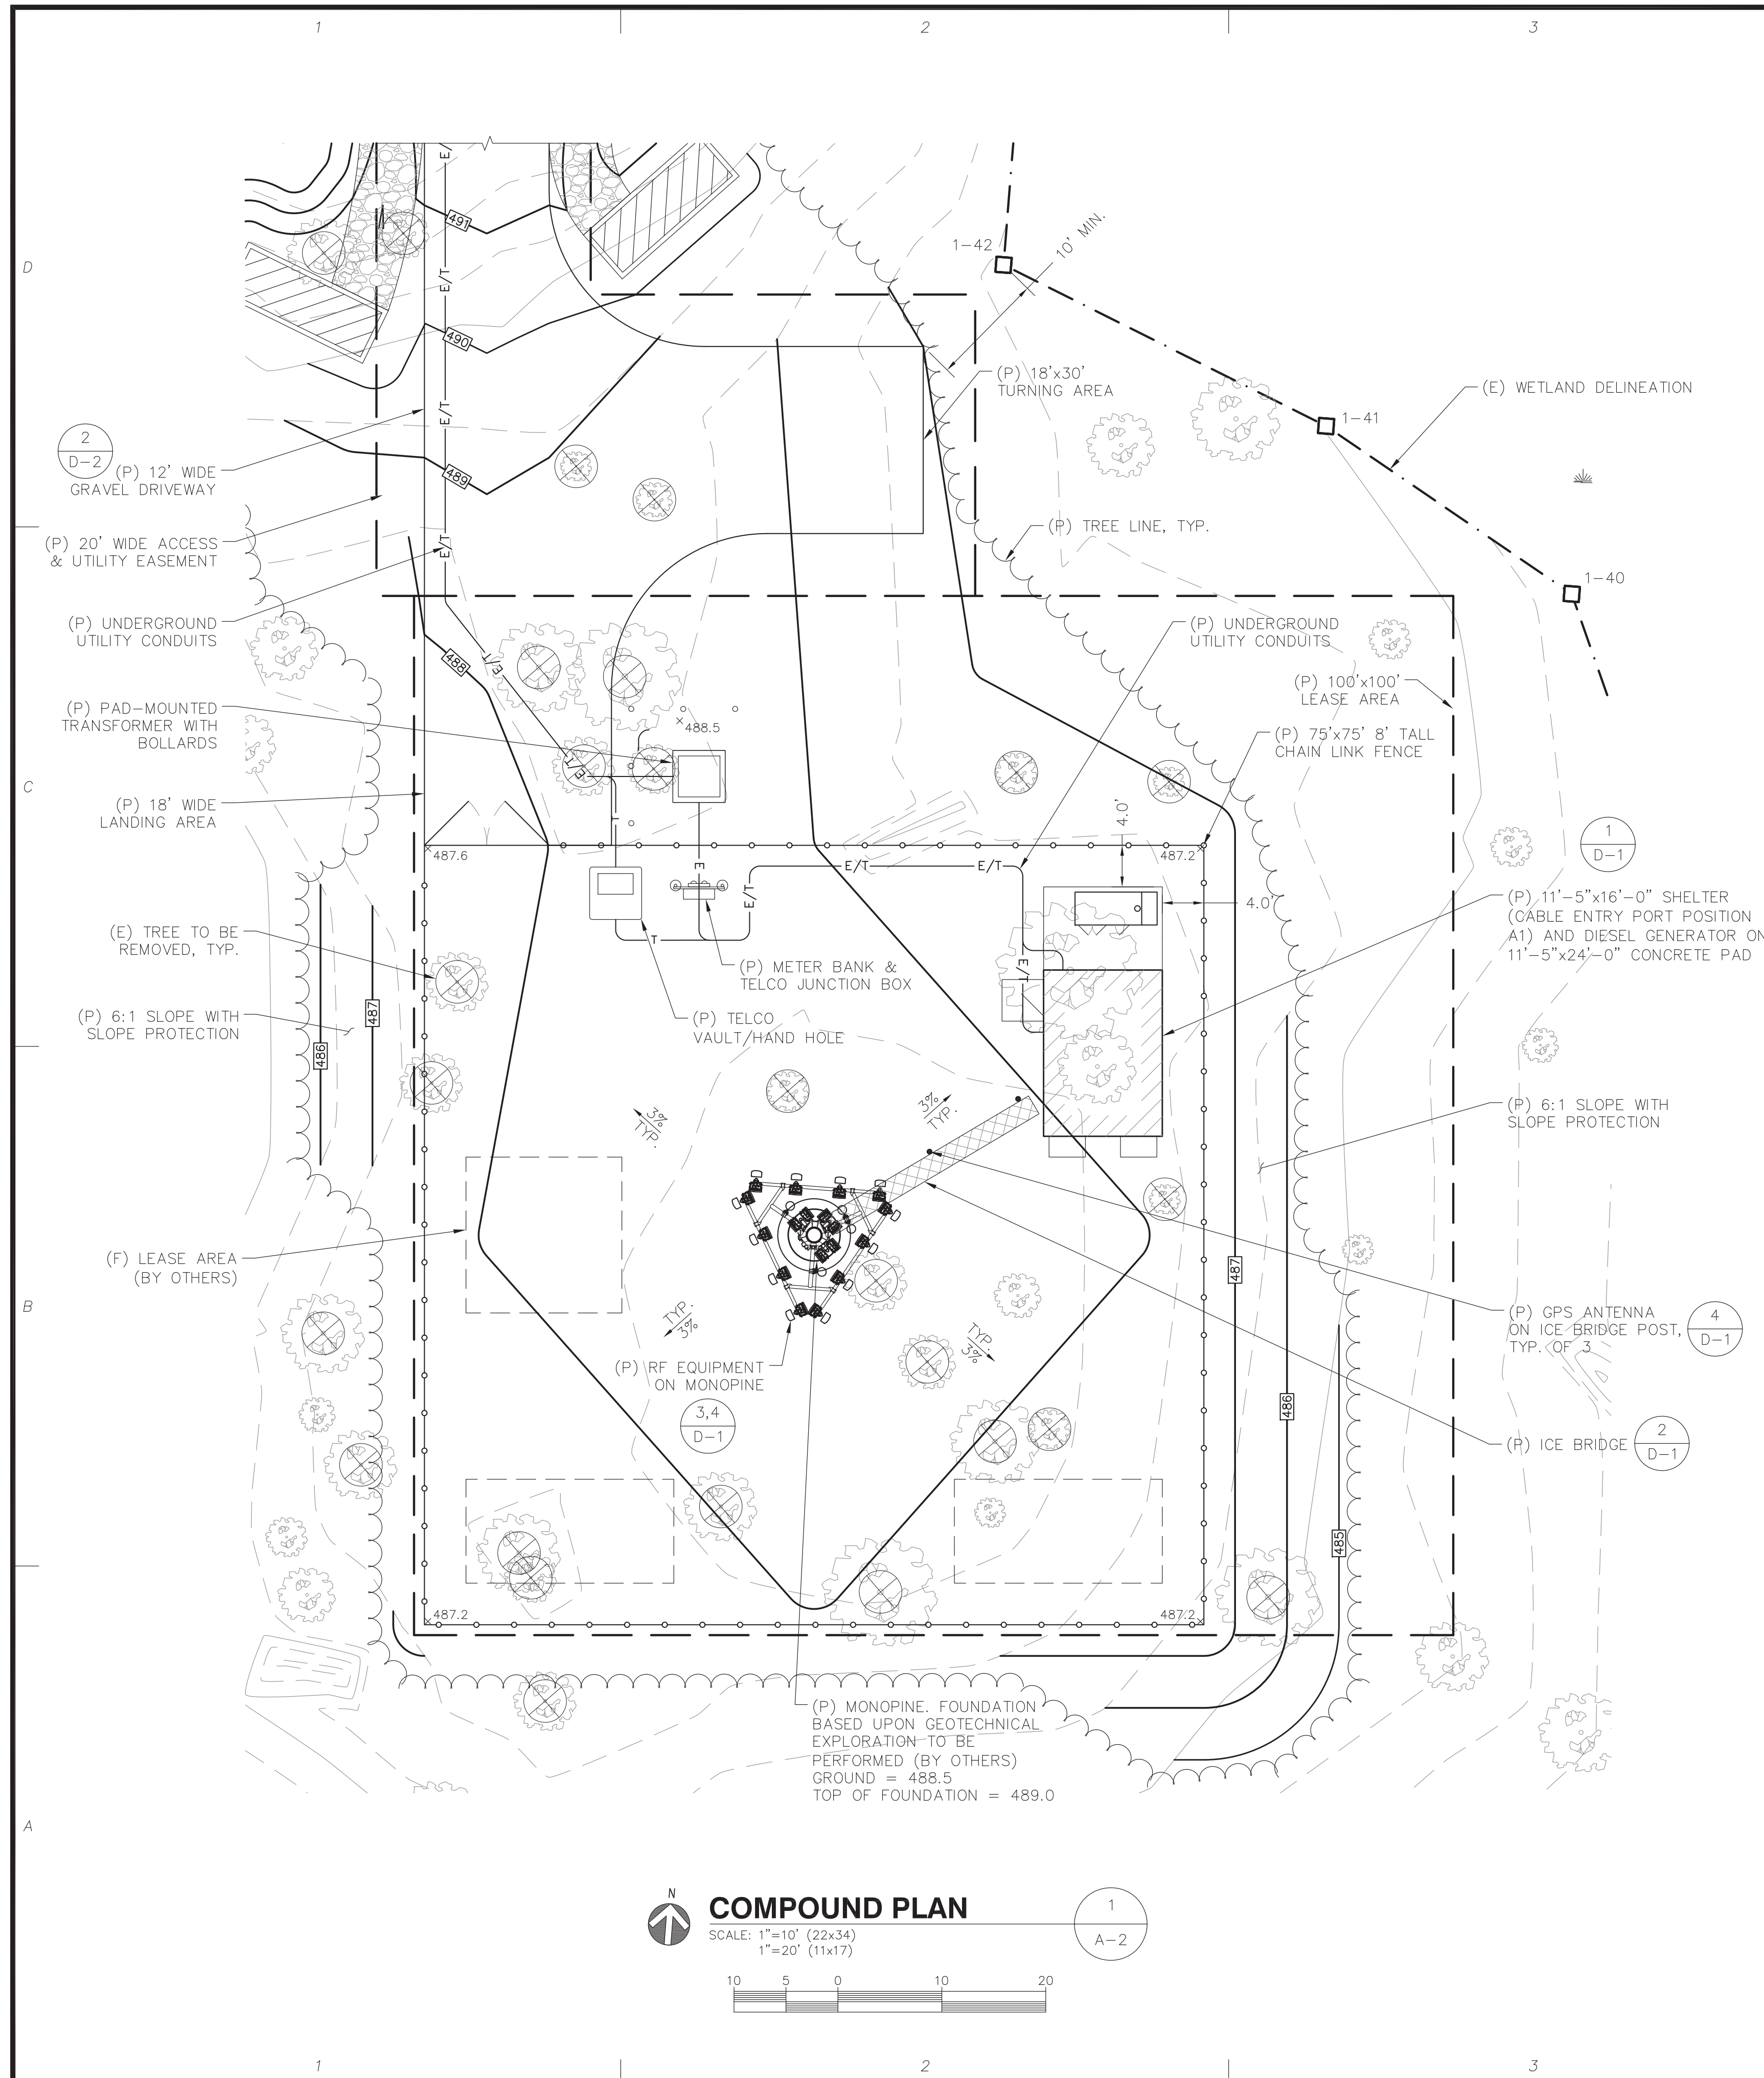

CLIENT:

27 Northwestern Drive
 Salem, NH 03079

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SITE NUMBER: S1200
ADDRESS: 30 COBBLEERS HILL COURT
MONROE, CT 06468

APPLICANT:
NEW CINCULAR WIRELESS
PCS, LLC ("AT&T")
500 ENTERPRISE DRIVE
ROCKY HILL, CT 06067

STAMP:

5-23-14

DATE: 7/12/13
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 CHECK: JMM/TEJ
 SCALE: SEE PLAN
 JOB NO.: 13-014

CLIENT:




27 Northwestern Drive
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MONROE, CT 06468

APPLICANT:
NEW CIRCULAR WIRELESS
PCS, LLC ("AT&T")
500 ENTERPRISE DRIVE
ROCKY HILL, CT 06067



at&t



DATE: 7/12/13
DRAWN: MJV
CHECK: JMM/TEJ
SCALE: SEE PLAN
JOB NO.: 13-014

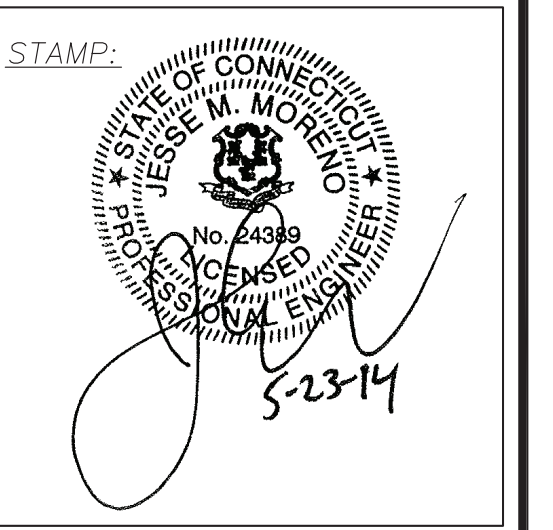SHEET TITLE:
DRIVEWAY PLAN
& PROFILE

P-1

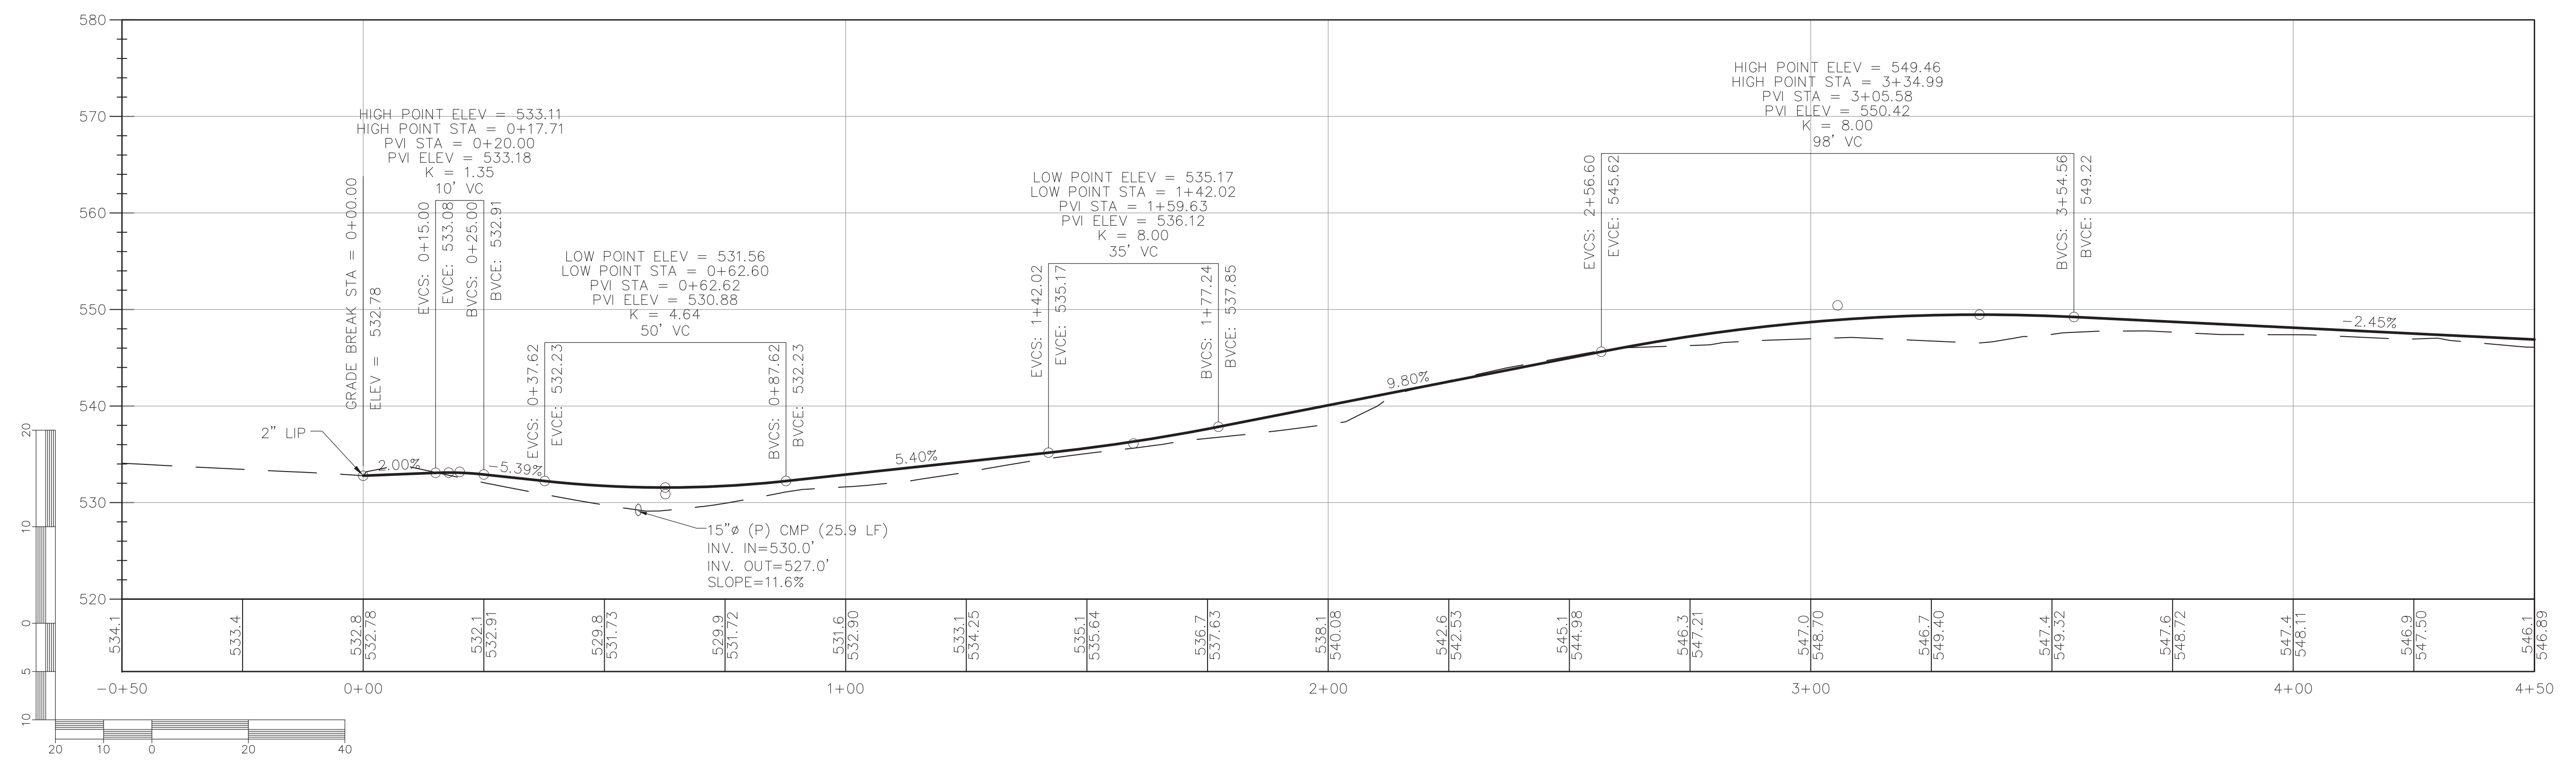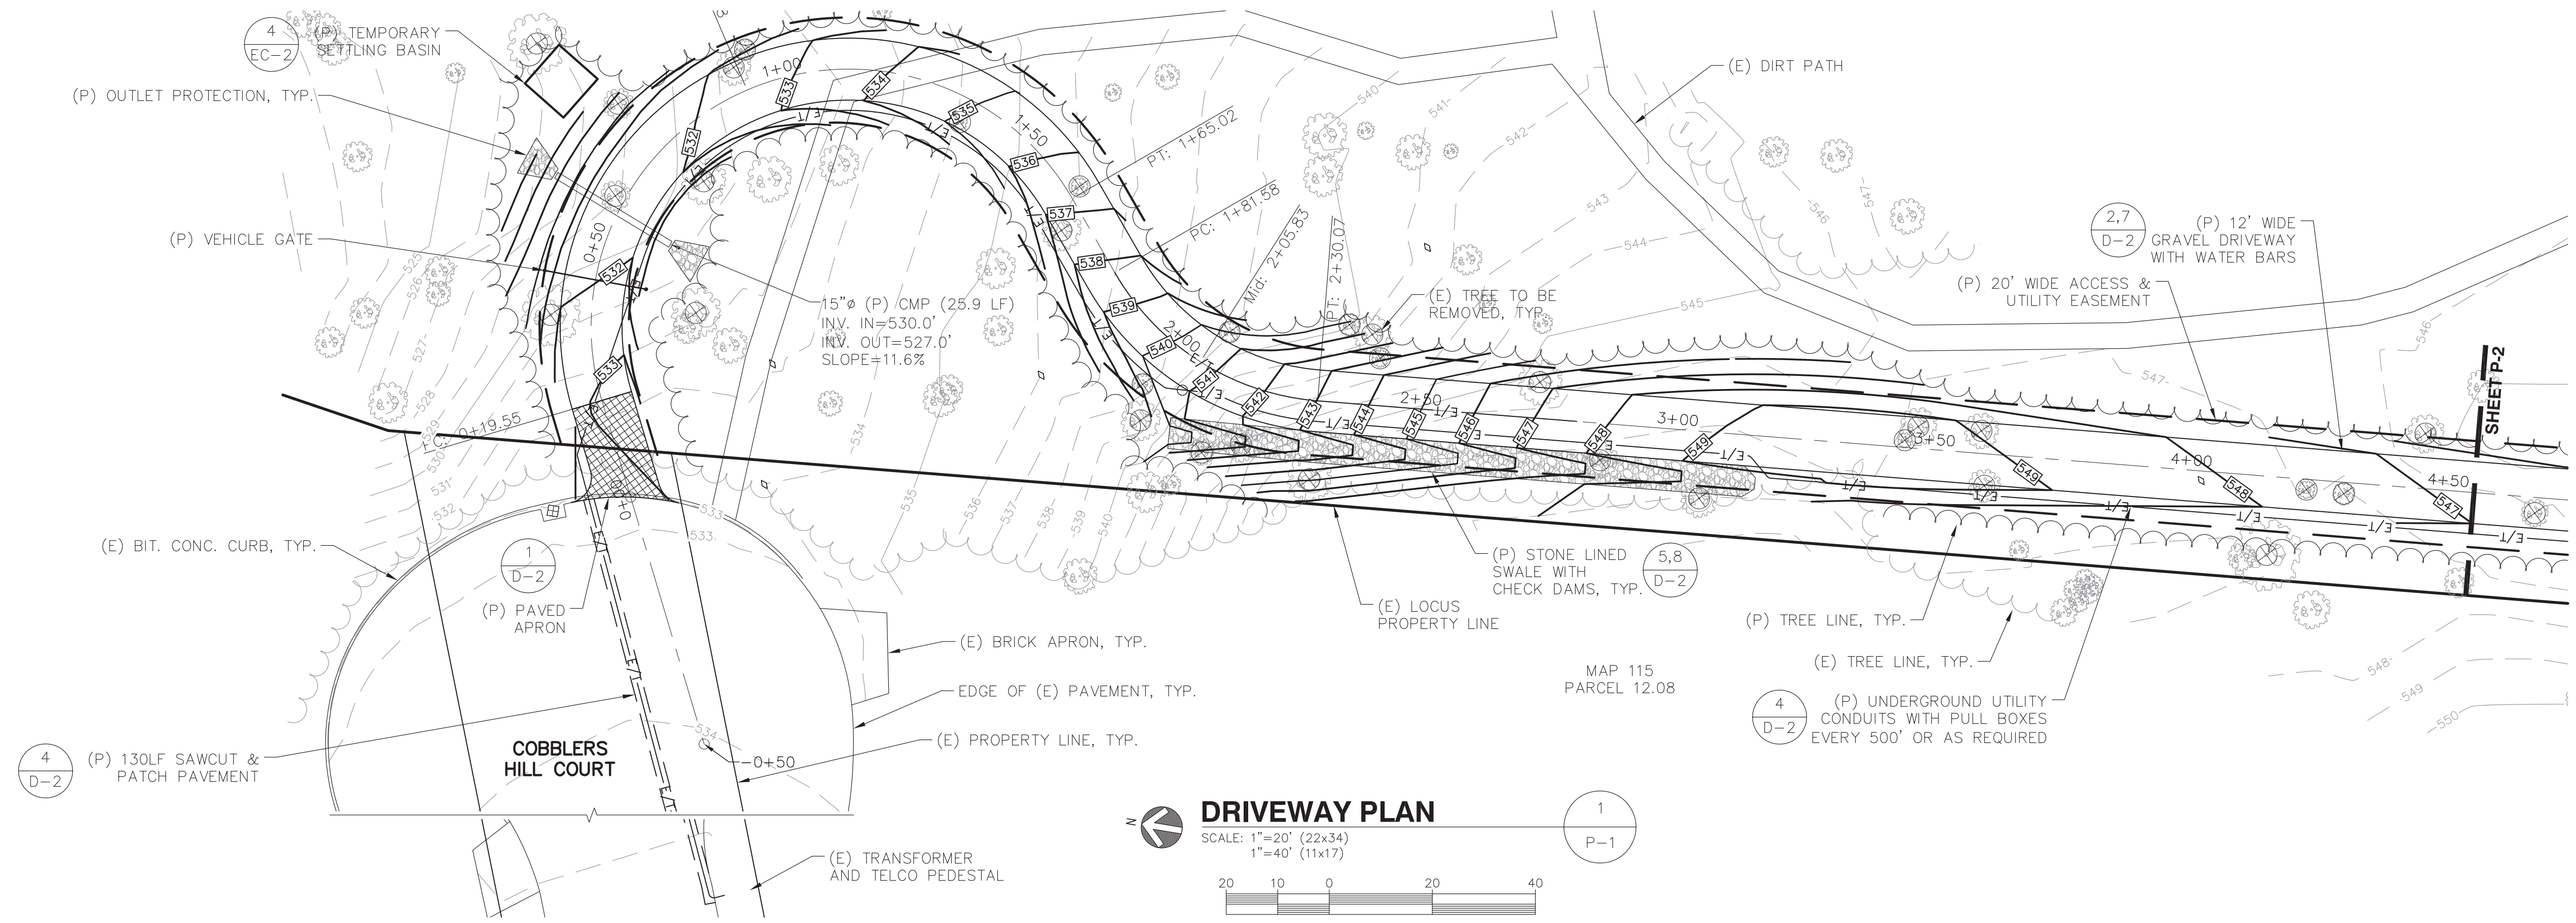

CLIENT:




27 Northwestern Drive
Salem, NH 03079

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MONROE, CT 06468



APPLICANT:
NEW CINCULAR WIRELESS
PCS, LLC ("AT&T")
500 ENTERPRISE DRIVE
ROCKY HILL, CT 06067


at&t

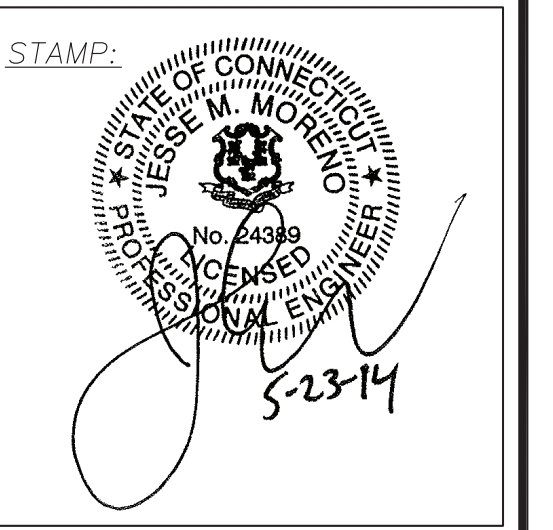


DATE: 7/12/13
DRAWN: MJV
CHECK: JMM/TEJ
SCALE: SEE PLAN
JOB NO.: 13-014

SHEET TITLE:
DRIVEWAY PLAN & PROFILE
P-2

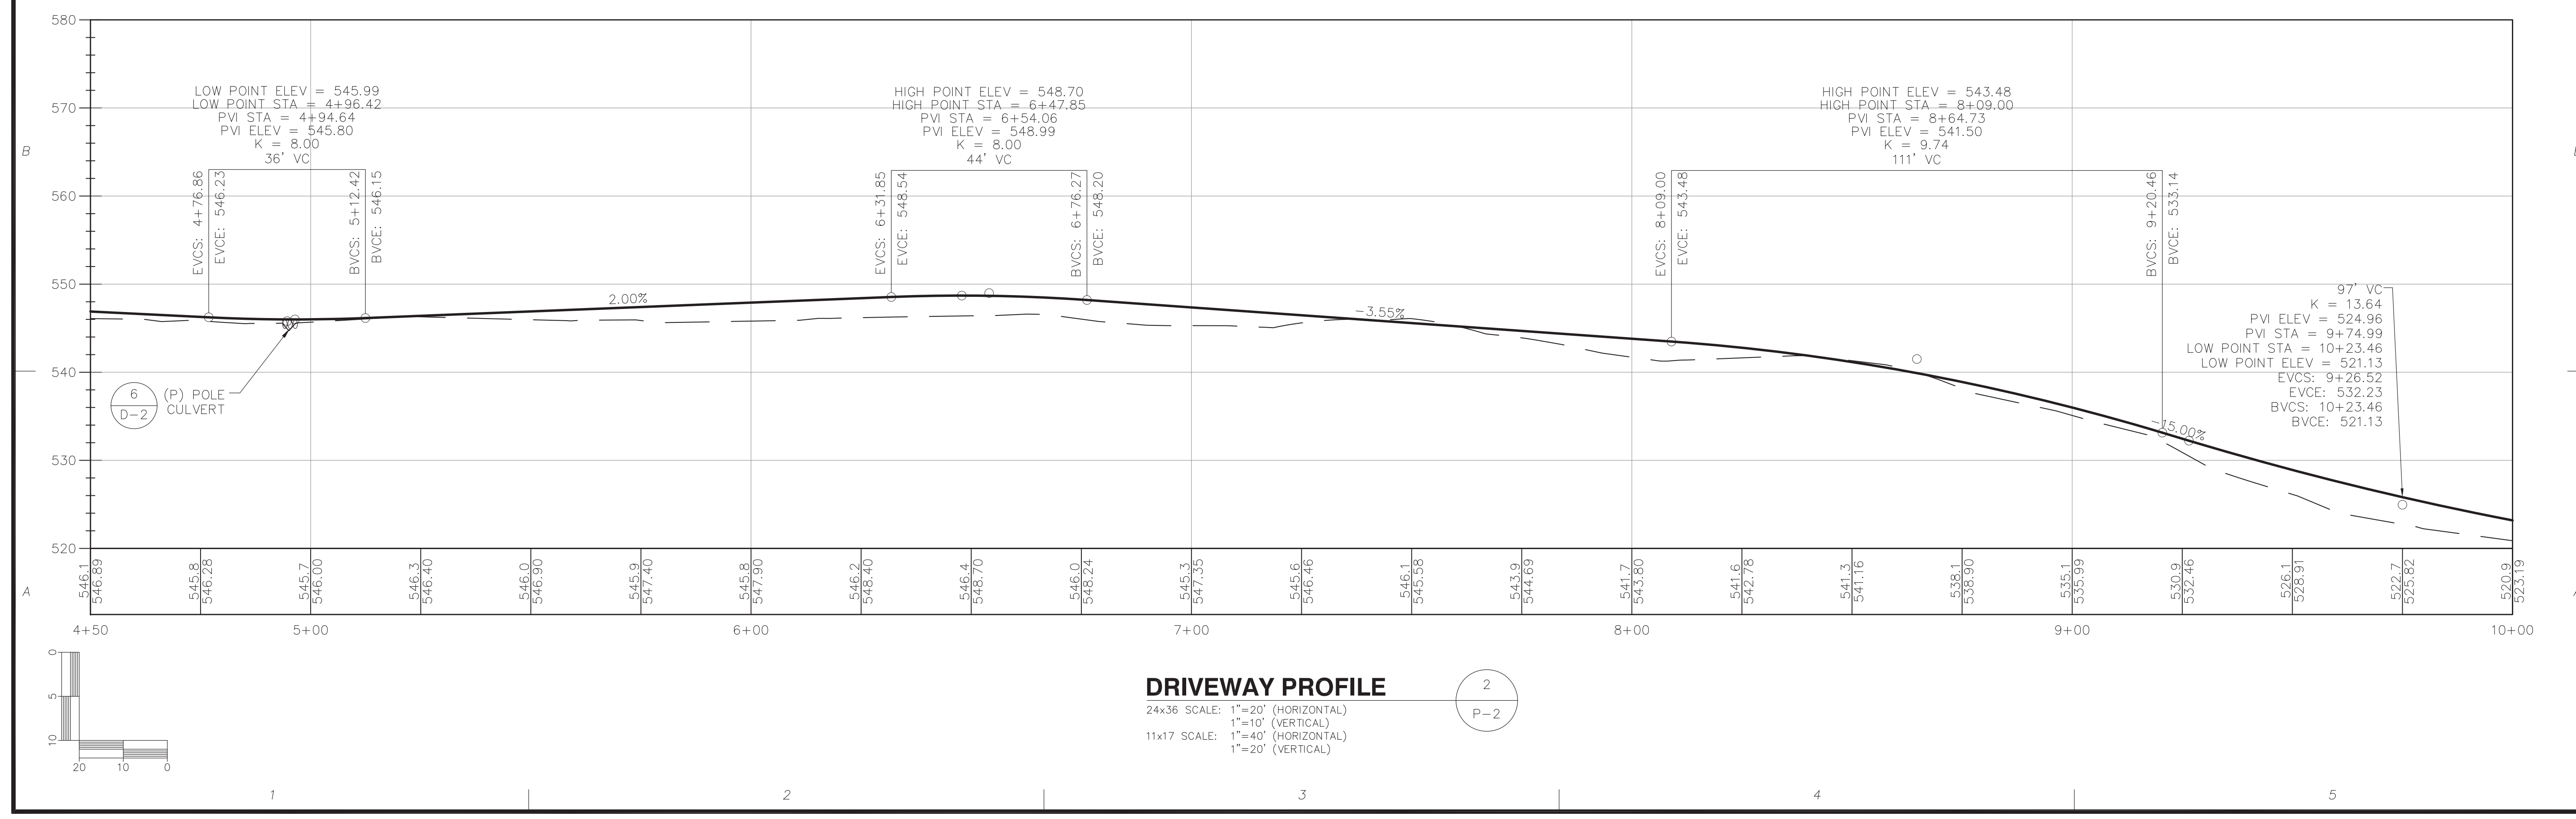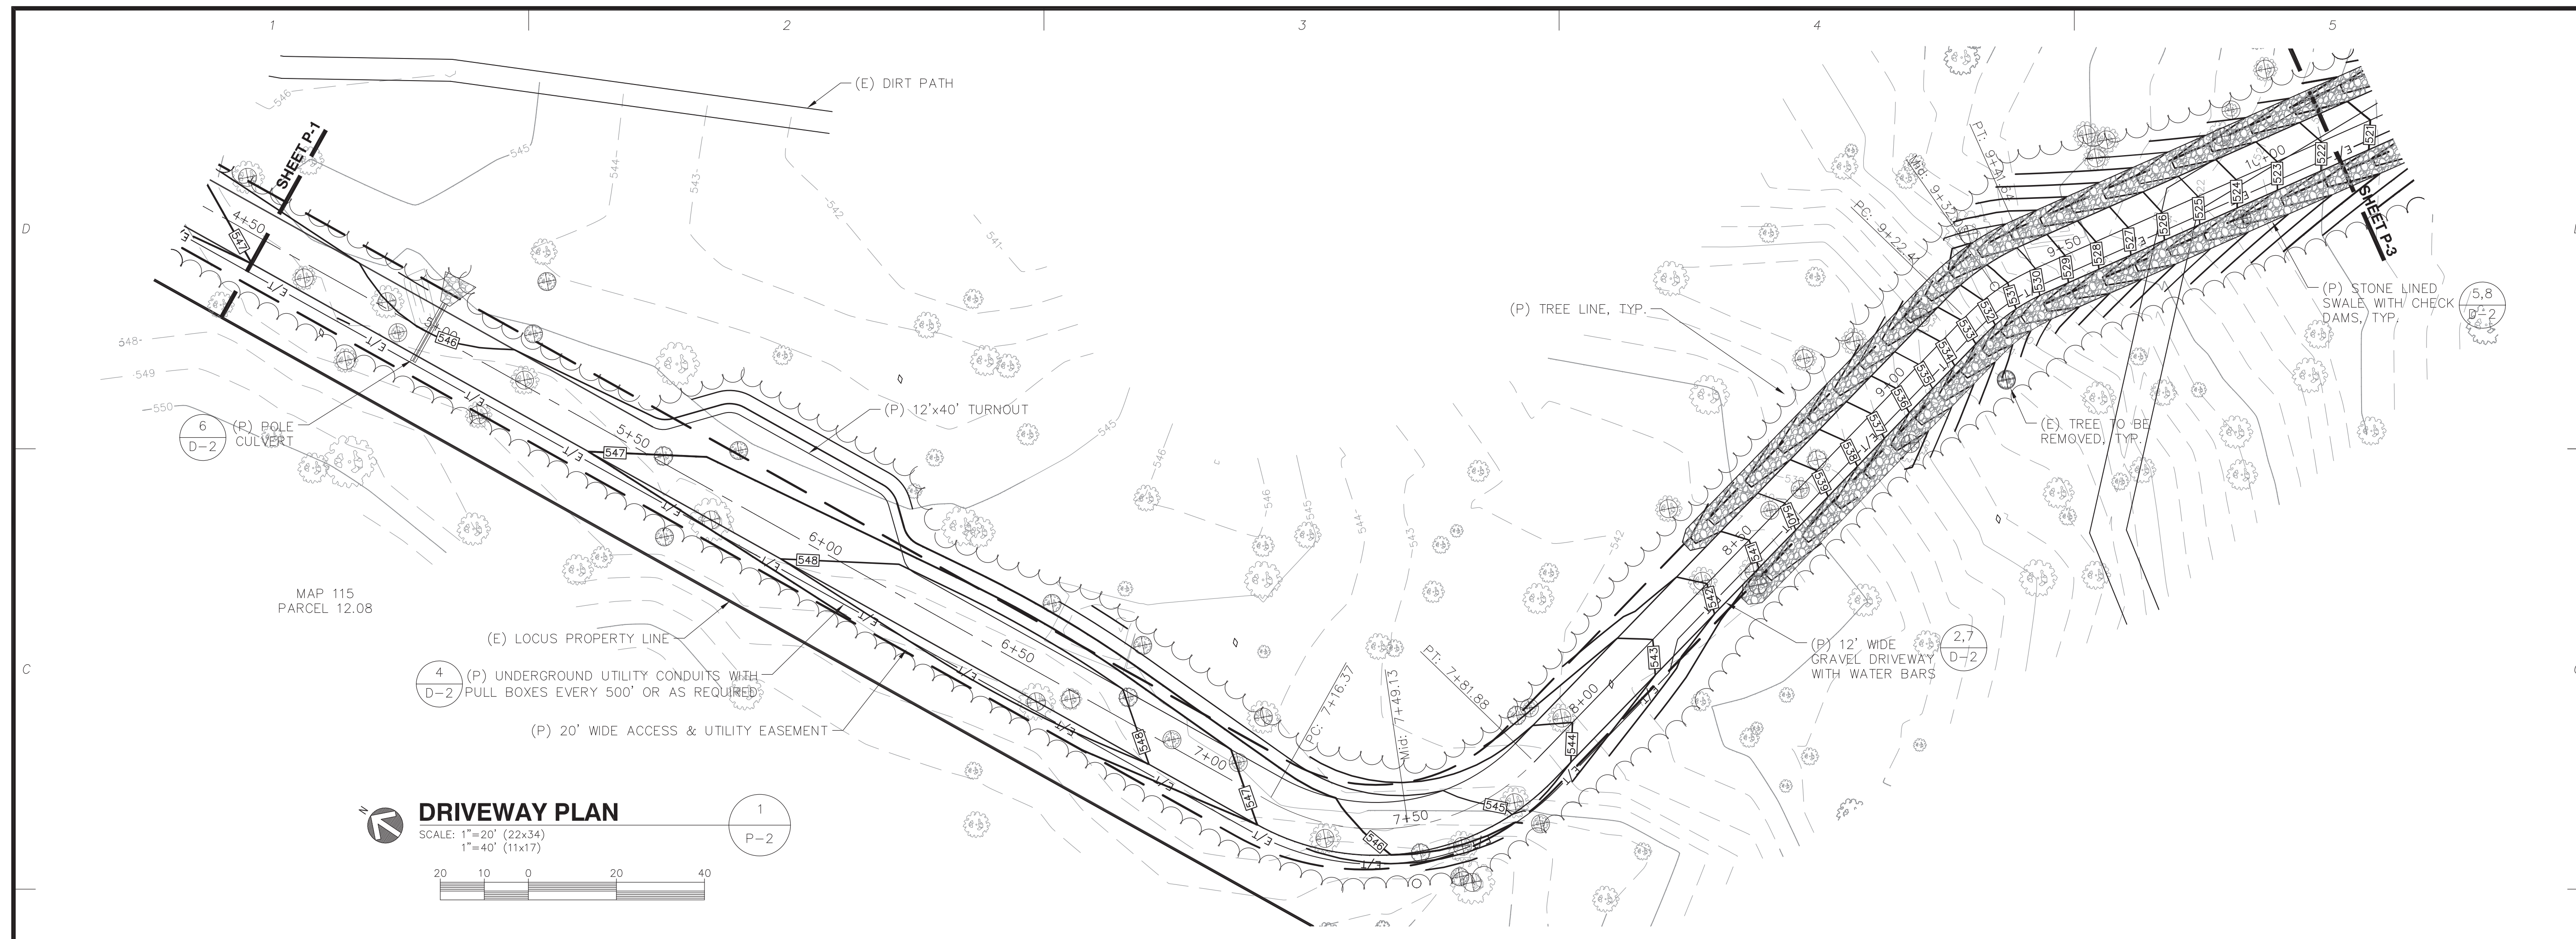

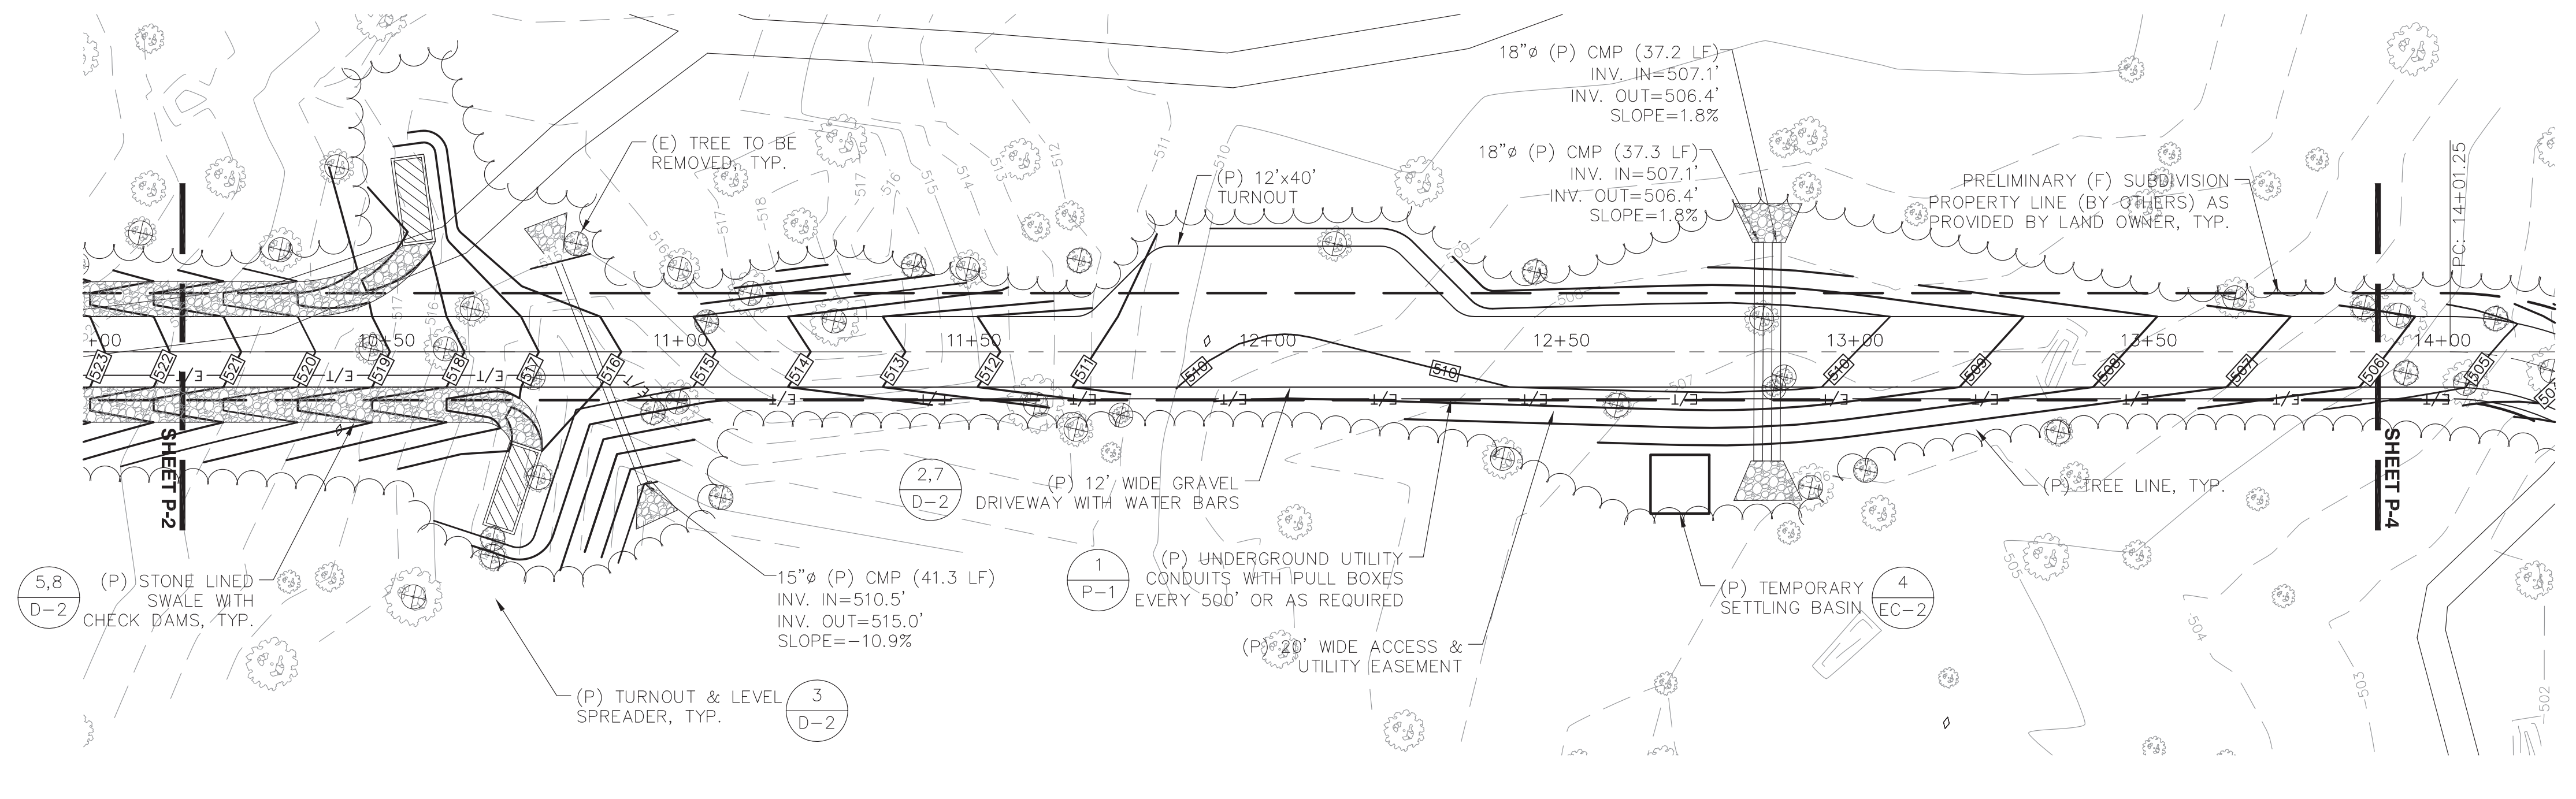

DRIVEWAY PLAN
 SCALE: 1"=20' (22x34)
 1"=40' (11x17)

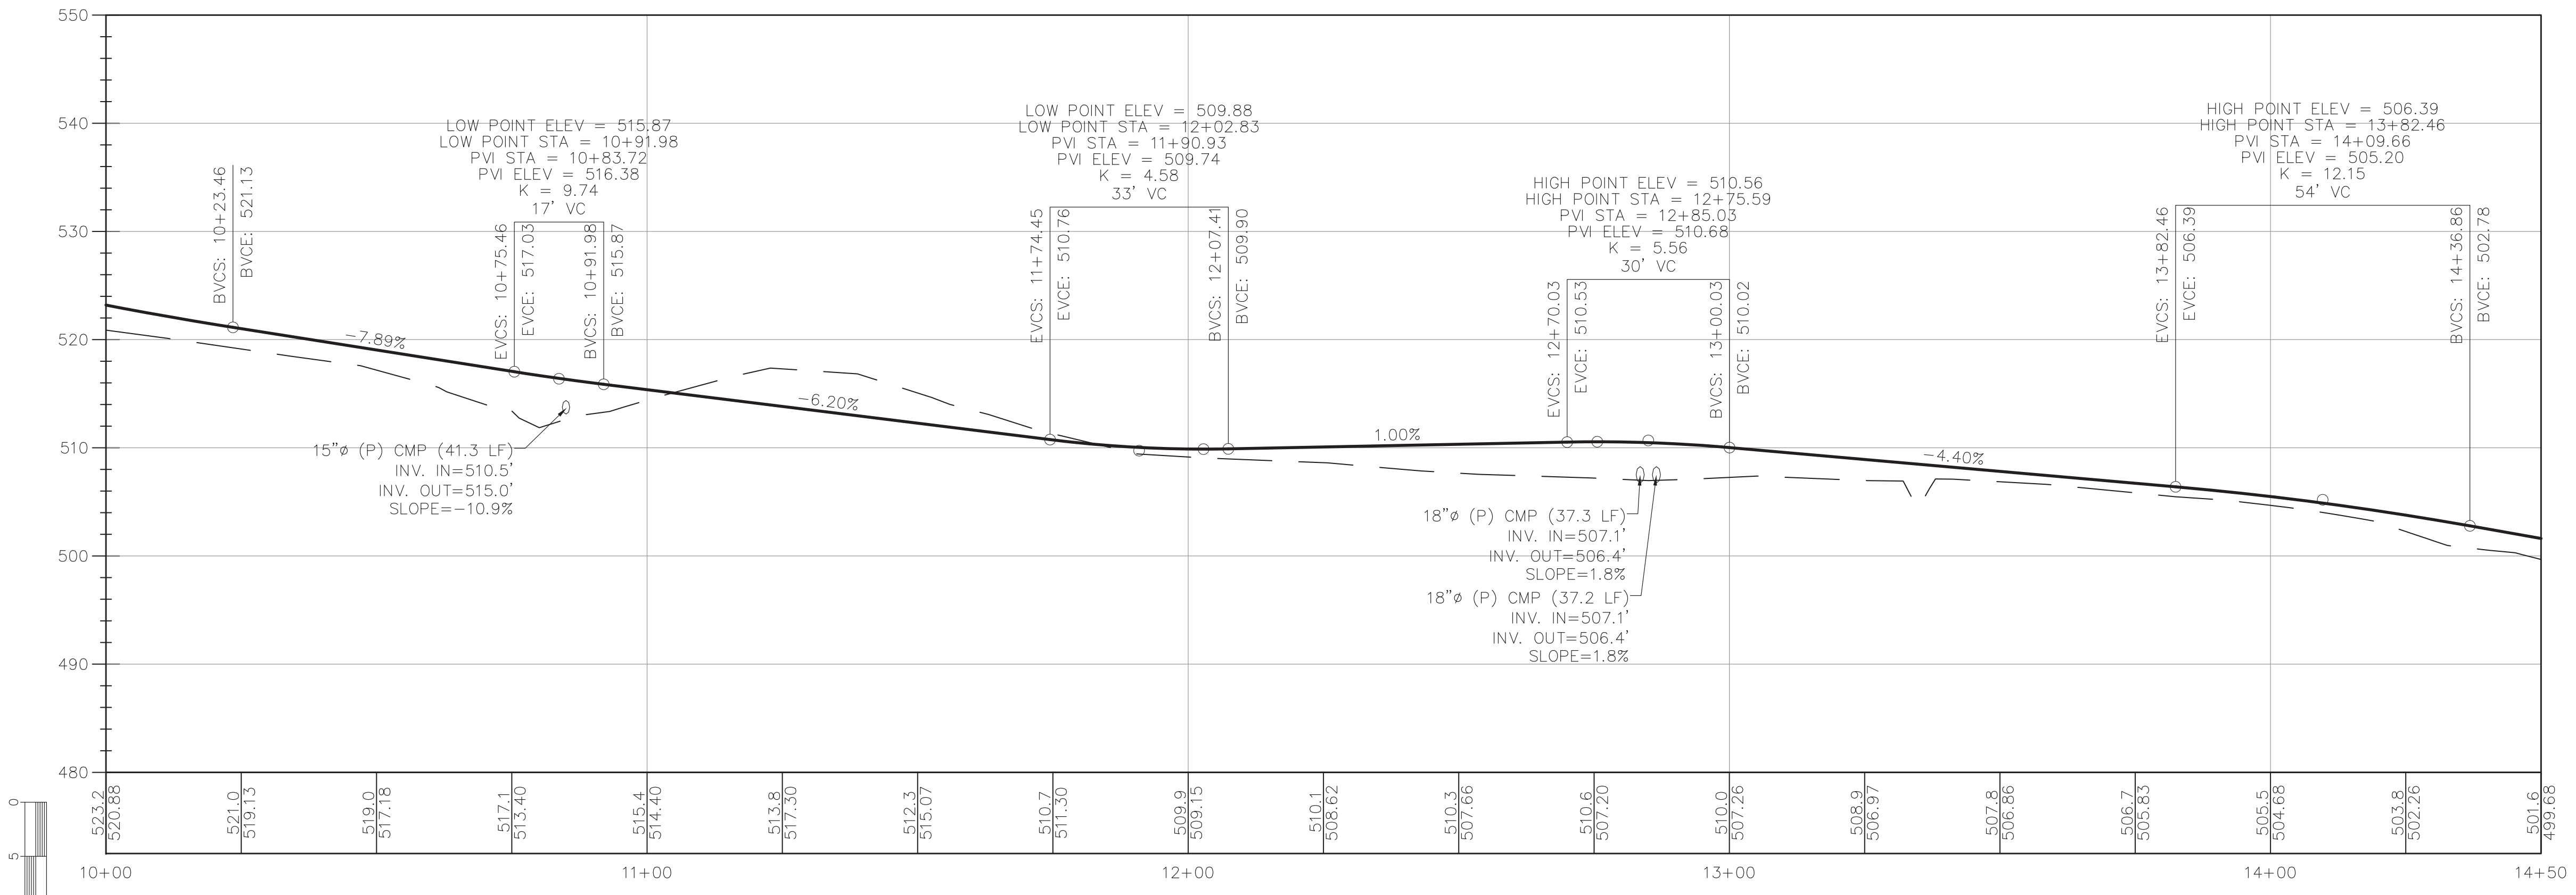

DRIVEWAY PROFILE
 24x36 SCALE: 1"=20' (HORIZONTAL)
 1"=10' (VERTICAL)
 11x17 SCALE: 1"=40' (HORIZONTAL)
 1"=20' (VERTICAL)

CLIENT:




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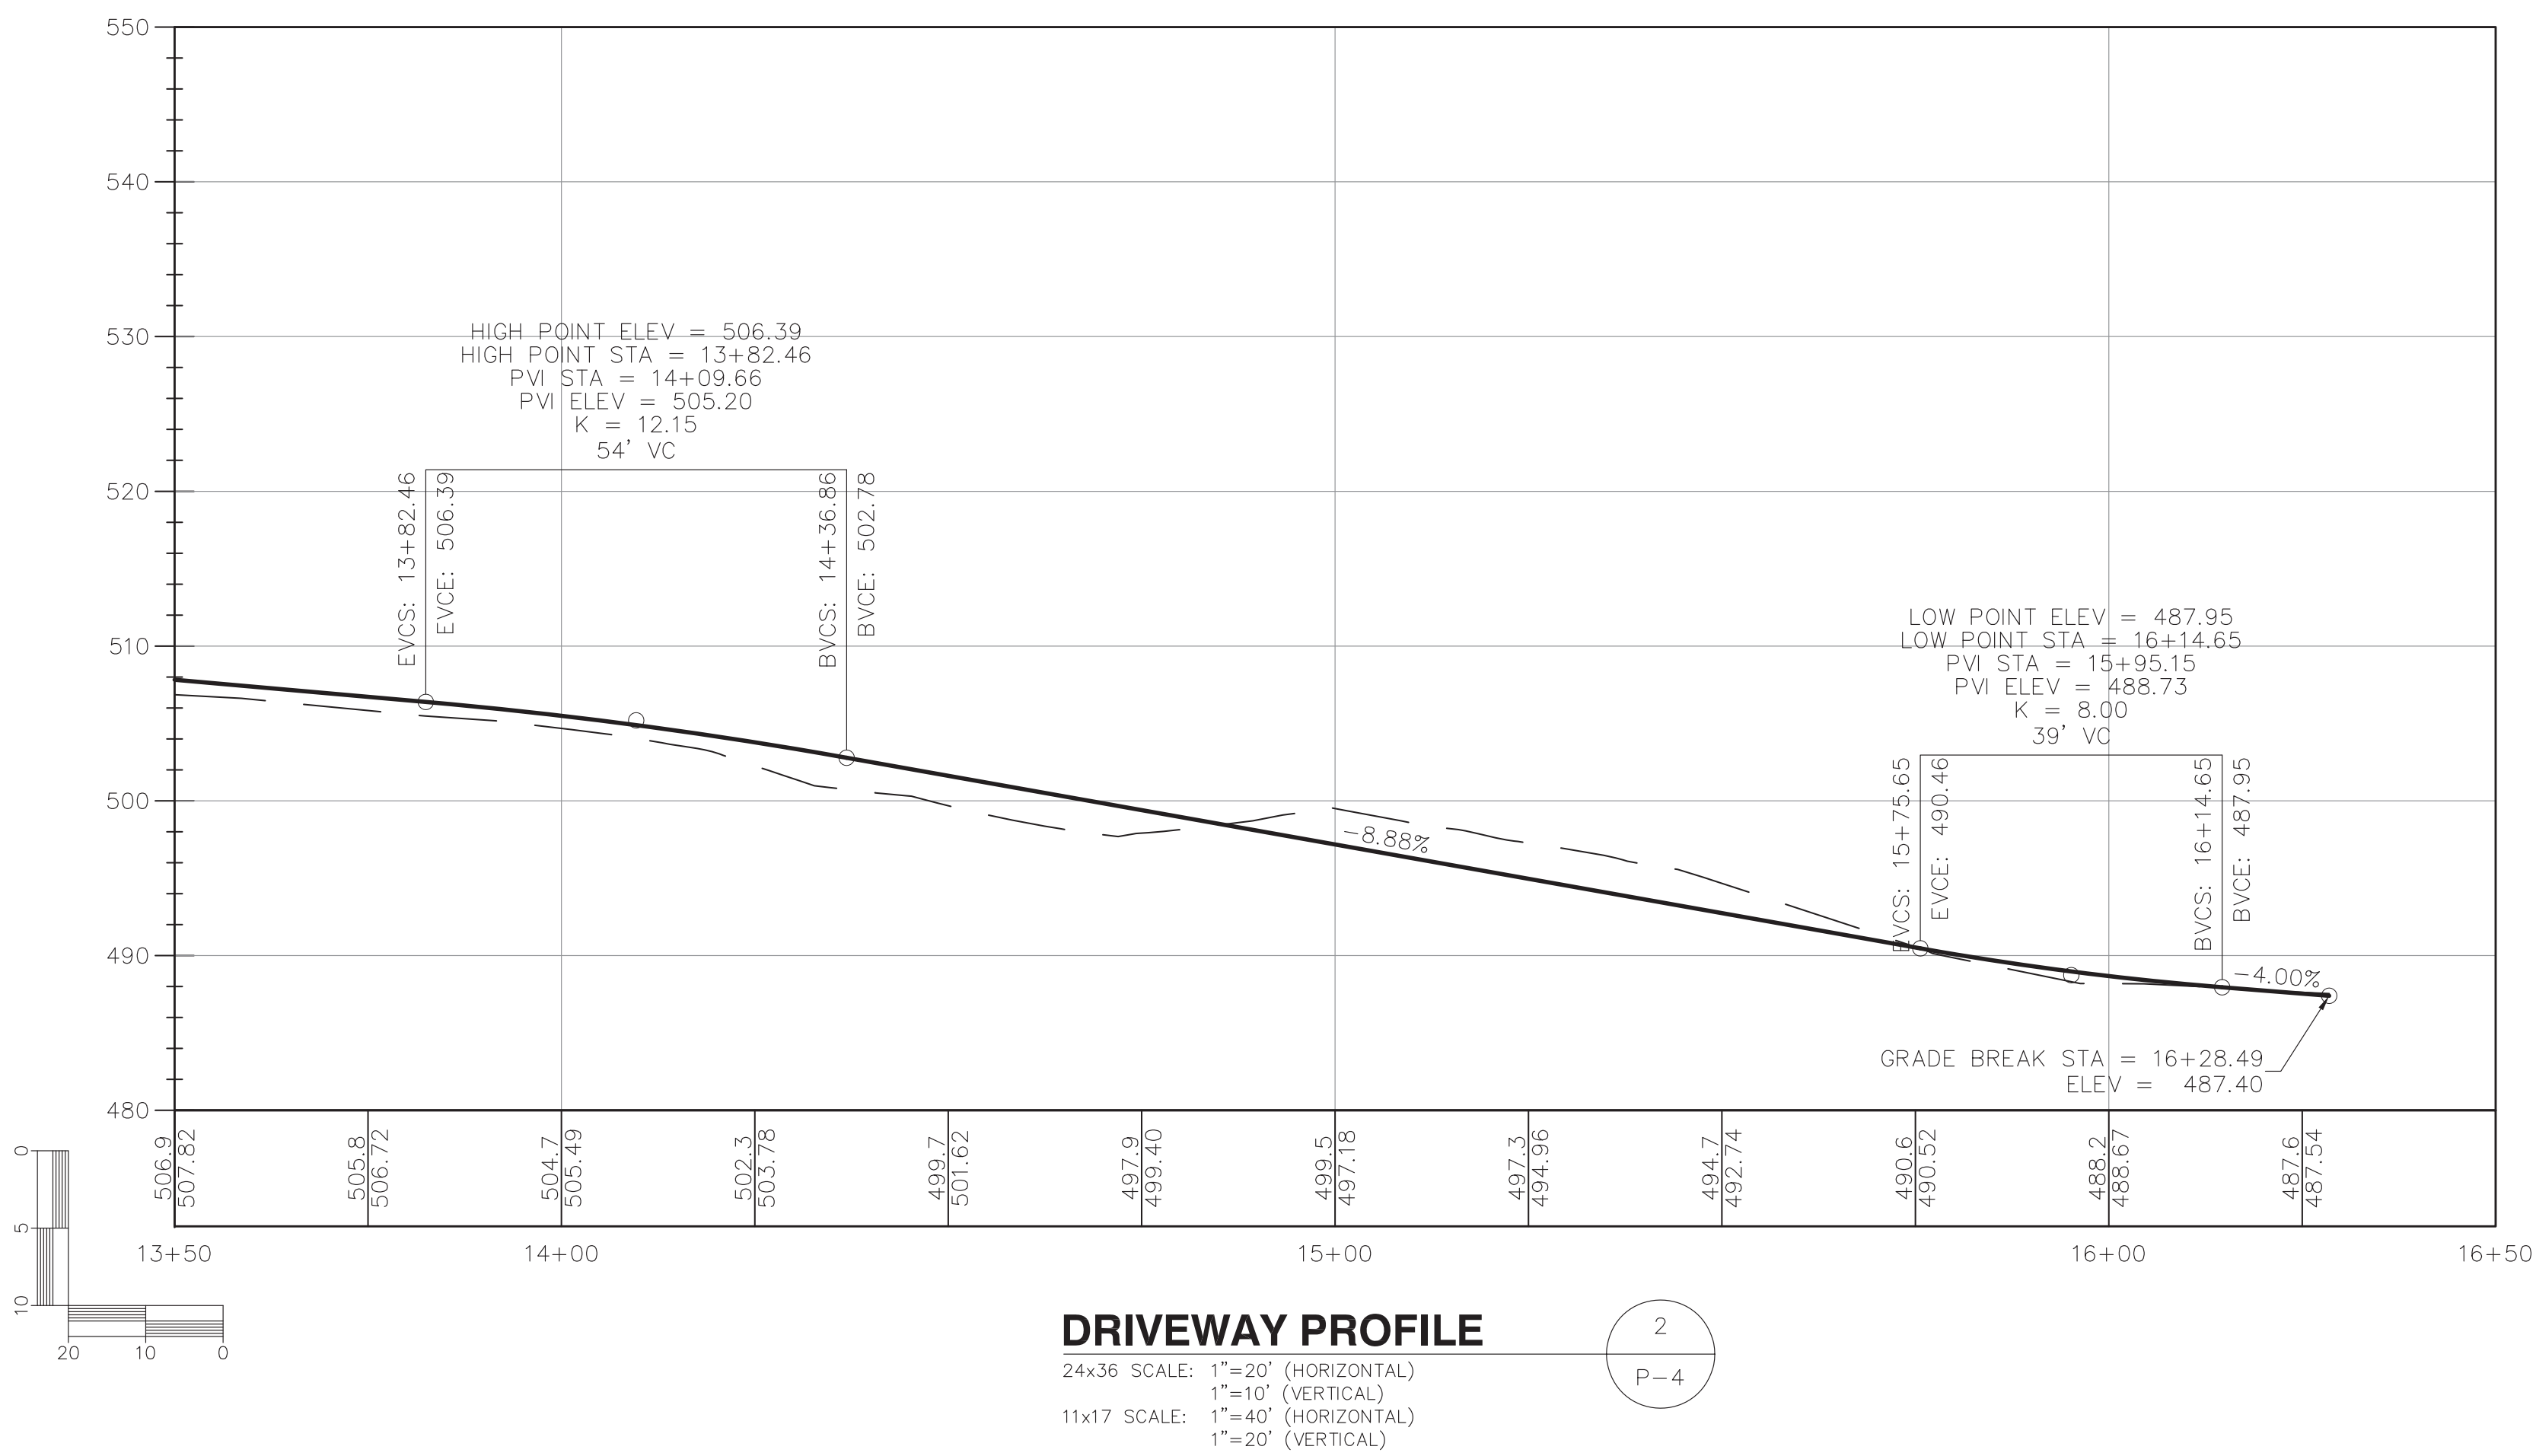
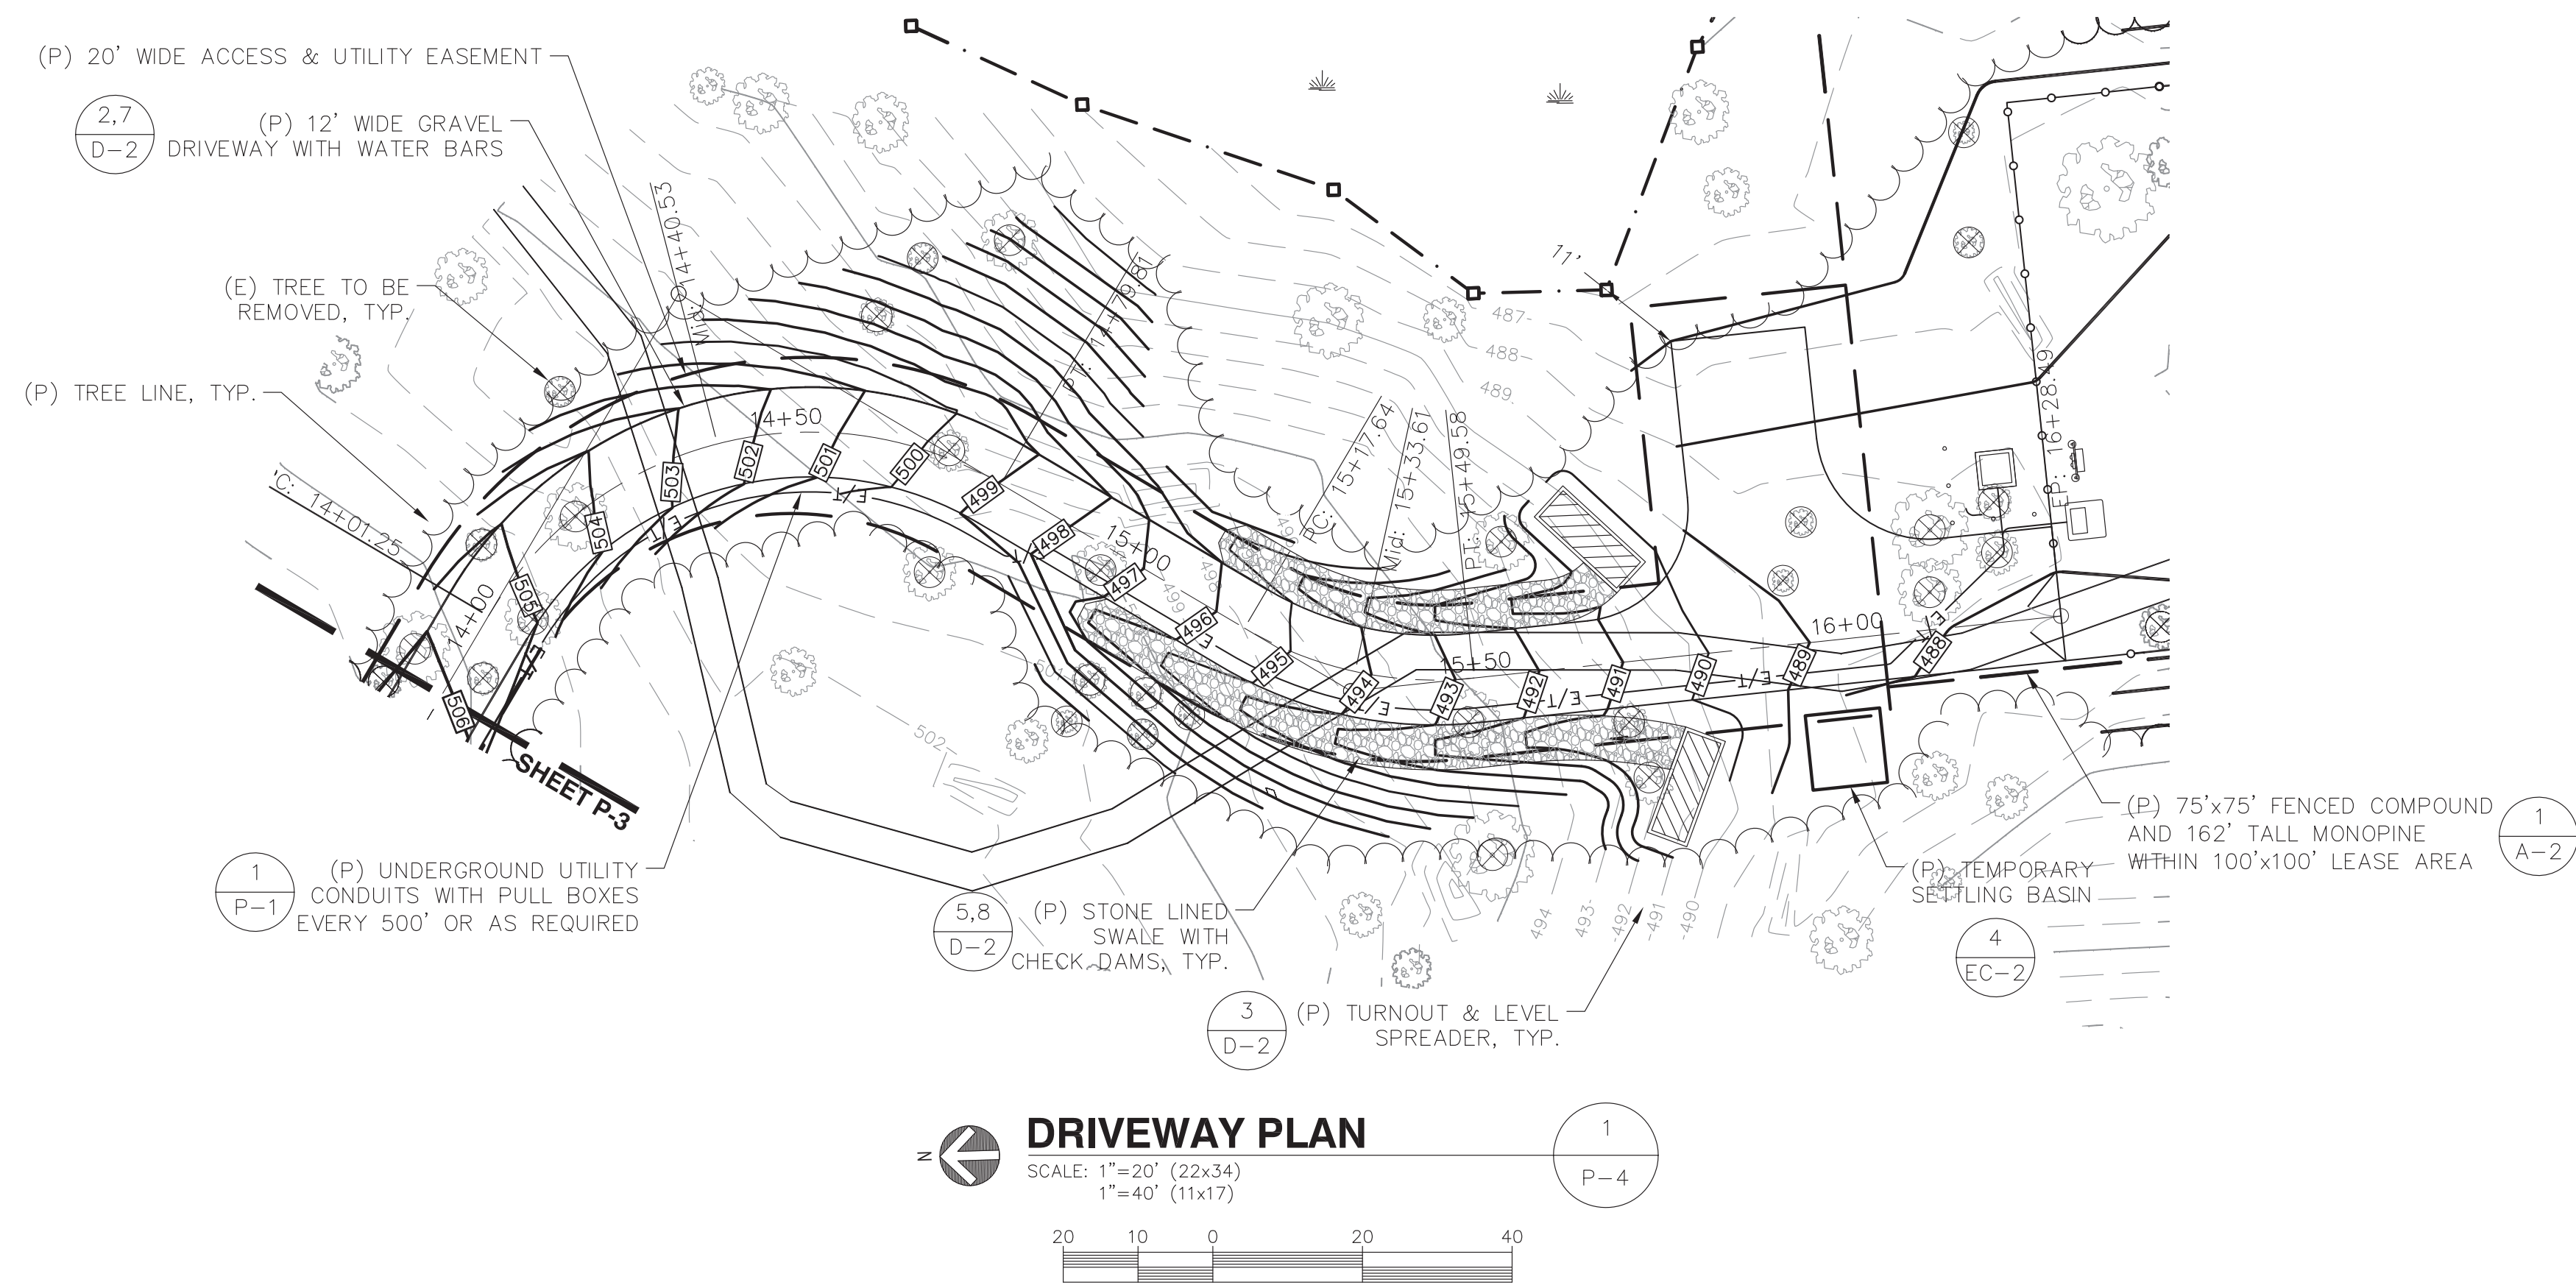
APPLICANT:
 NEW CINCULAR WIRELESS
 PCS, LLC ("AT&T")
 500 ENTERPRISE DRIVE
 ROCKY HILL, CT 06067

at&t



DATE: 7/12/13
 DRAWN: MJV
 CHECK: JMM/TEJ
 SCALE: SEE PLAN
 JOB NO.: 13-014

SHEET TITLE:
DRIVEWAY PLAN & PROFILE
P-3

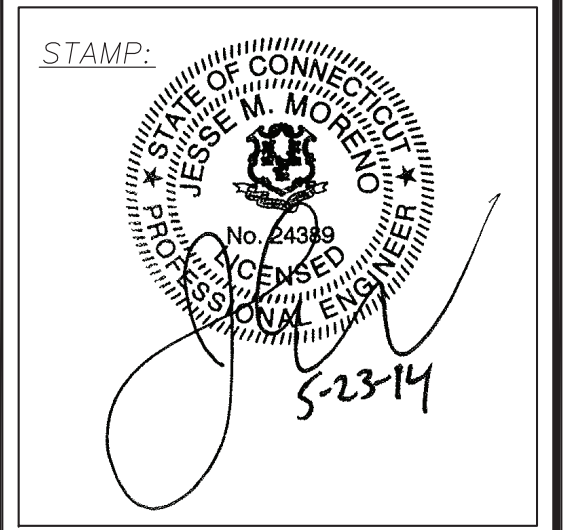

CLIENT:




27 Northwestern Drive
 Salem, NH 03079

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MONROE, CT 06468

NEW CIRCULAR WIRELESS PCS, LLC ("AT&T")
 500 ENTERPRISE DRIVE
 ROCKY HILL, CT 06067

APPLICANT: **at&t**

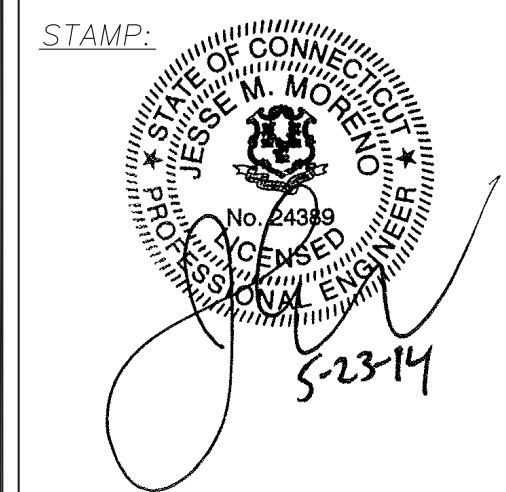

DATE: 7/12/13

DRAWN: MJV

CHECK: JMM/TEJ

SCALE: SEE PLAN

JOB NO.: 13-014

SHEET TITLE:

DRIVEWAY PLAN & PROFILE

P-4

CLIENT:




27 Northwestern Drive
Salem, NH 03079


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500 ENTERPRISE DRIVE
ROCKY HILL, CT 06067

APPLICANT: 

STAMP:


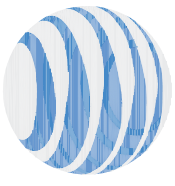


5-23-14

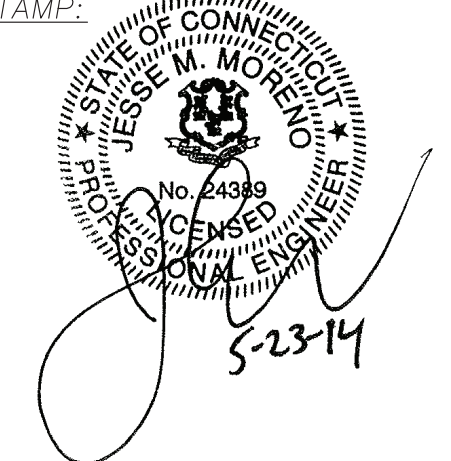DATE: 7/12/13
DRAWN: MJV
CHECK: JMM/TEJ
SCALE: SEE PLAN
JOB NO.: 13-014
SHEET TITLE:

DETAILS

D-1

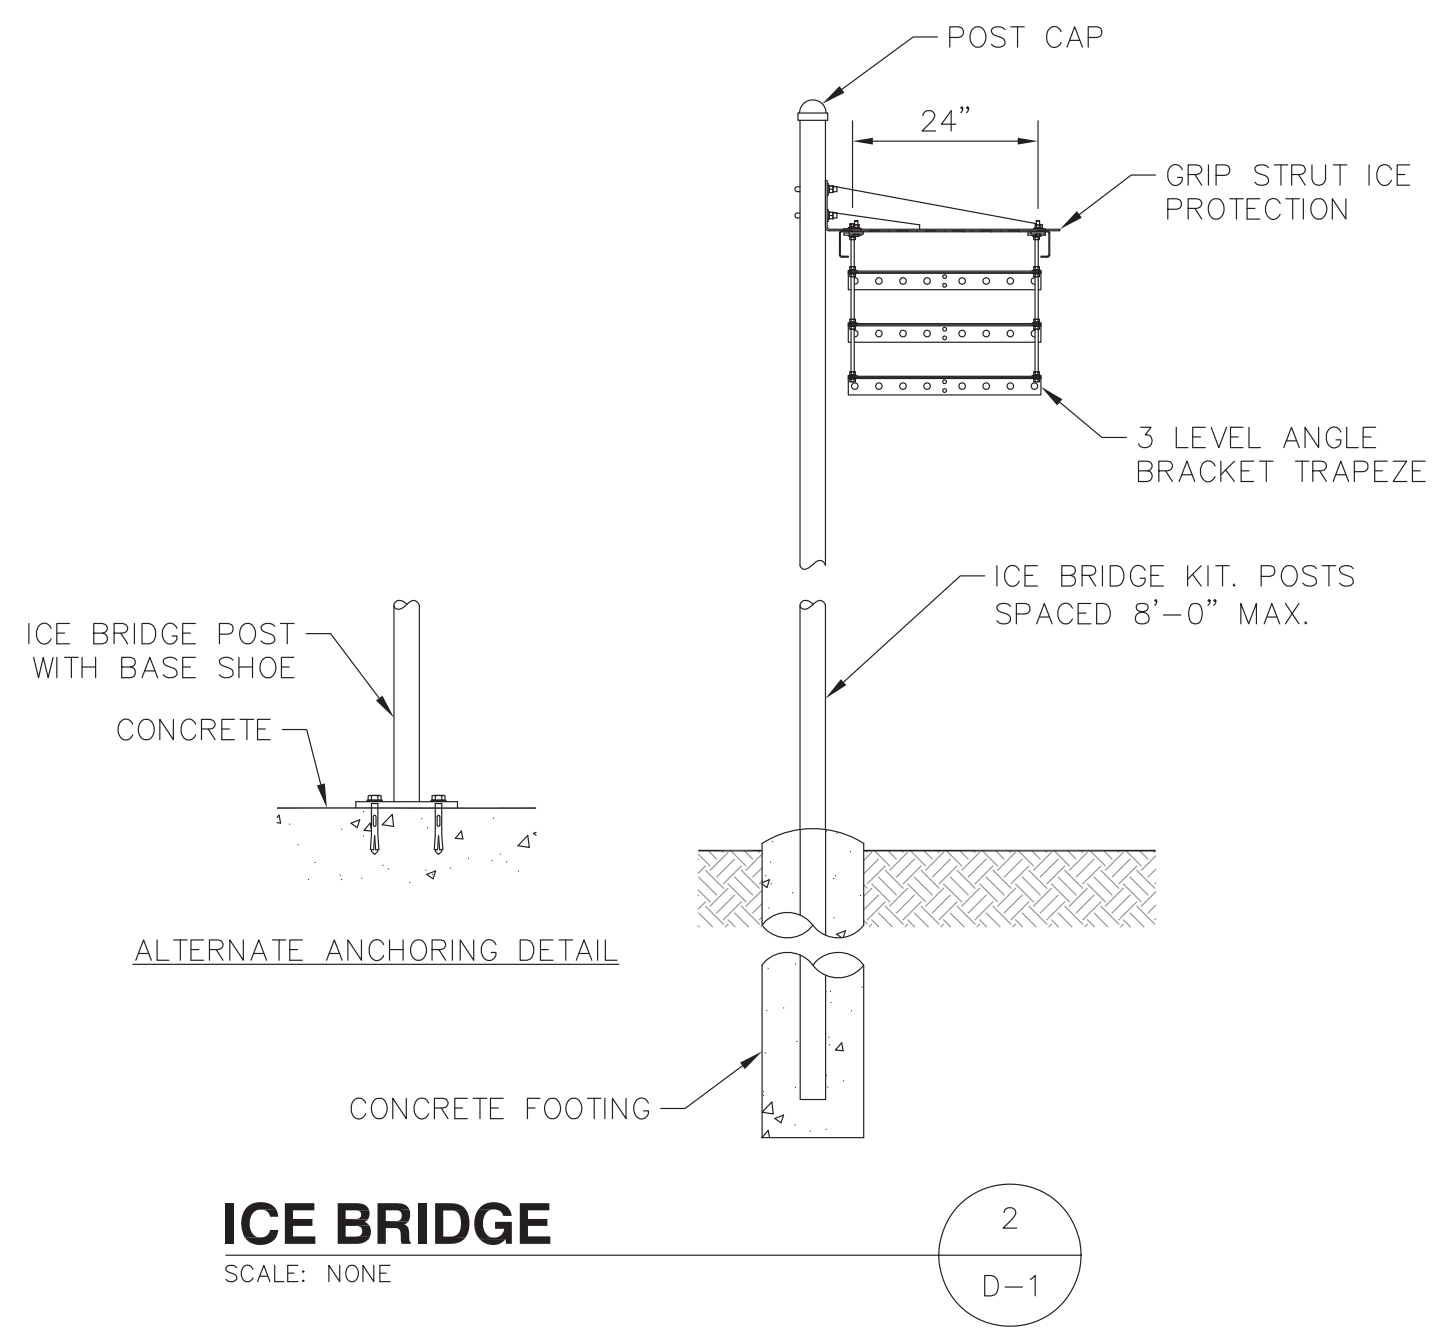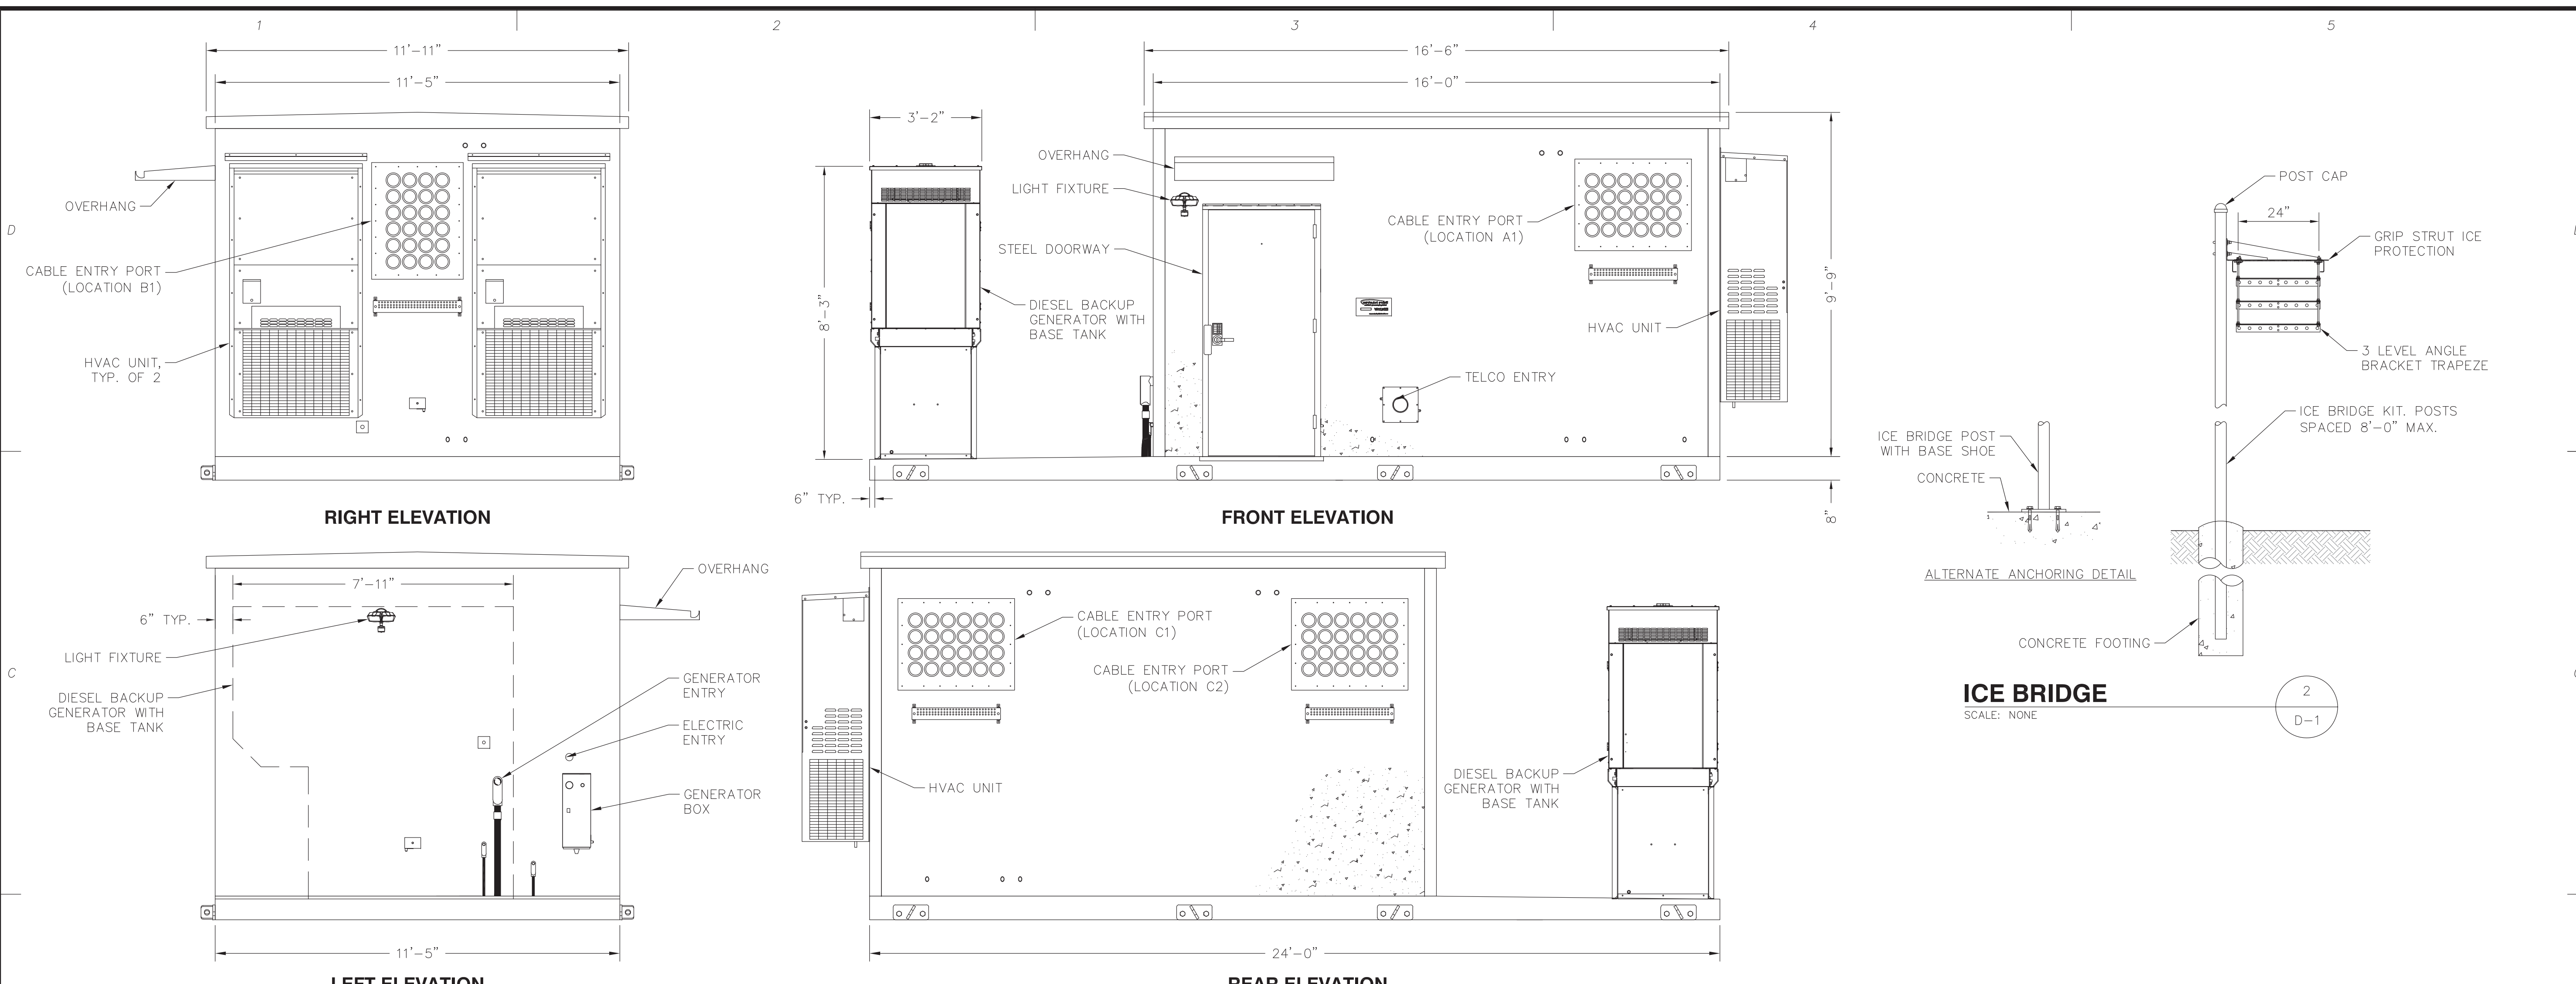


"11'-5" X 16'-0" CONCRETE SHELTER" FOR AT&T WIRELESS SERVICES BY CELLIXION SHOWN. VERIFY MAKE AND MODEL WITH CONSTRUCTION MANAGER PRIOR TO COMMENCEMENT OF CONSTRUCTION


PREFABRICATED SHELTER
SCALE: NONE

ITEM	QUANTITY	MAKE & MODEL	DIMENSIONS
PANEL ANTENNA	12	CCI HPA-65R-BUU-H8	92.4" x 14.8" x 7.4"
SURGE SUPPRESSOR	3	RAYCAP DC6-48-60-18-8F	25" x 11"Ø
REMOTE RADIO UNIT	3	ERICSSON RRUS-32	26.7" x 12.1" x 6.7"
REMOTE RADIO UNIT	3	ERICSSON RRUS-E2	20.4" x 18.5" x 7.5"
REMOTE RADIO UNIT	6	ERICSSON RRUS-12	20.4" x 18.5" x 7.5"
REMOTE RADIO UNIT	9	ERICSSON RRUS-11	19.7" x 17.0" x 7.2"
A2 UNIT	6	ERICSSON A2	16.4" x 15.2" x 3.4"


BASED UPON RFDS V02 REVISED THROUGH DECEMBER 9, 2013

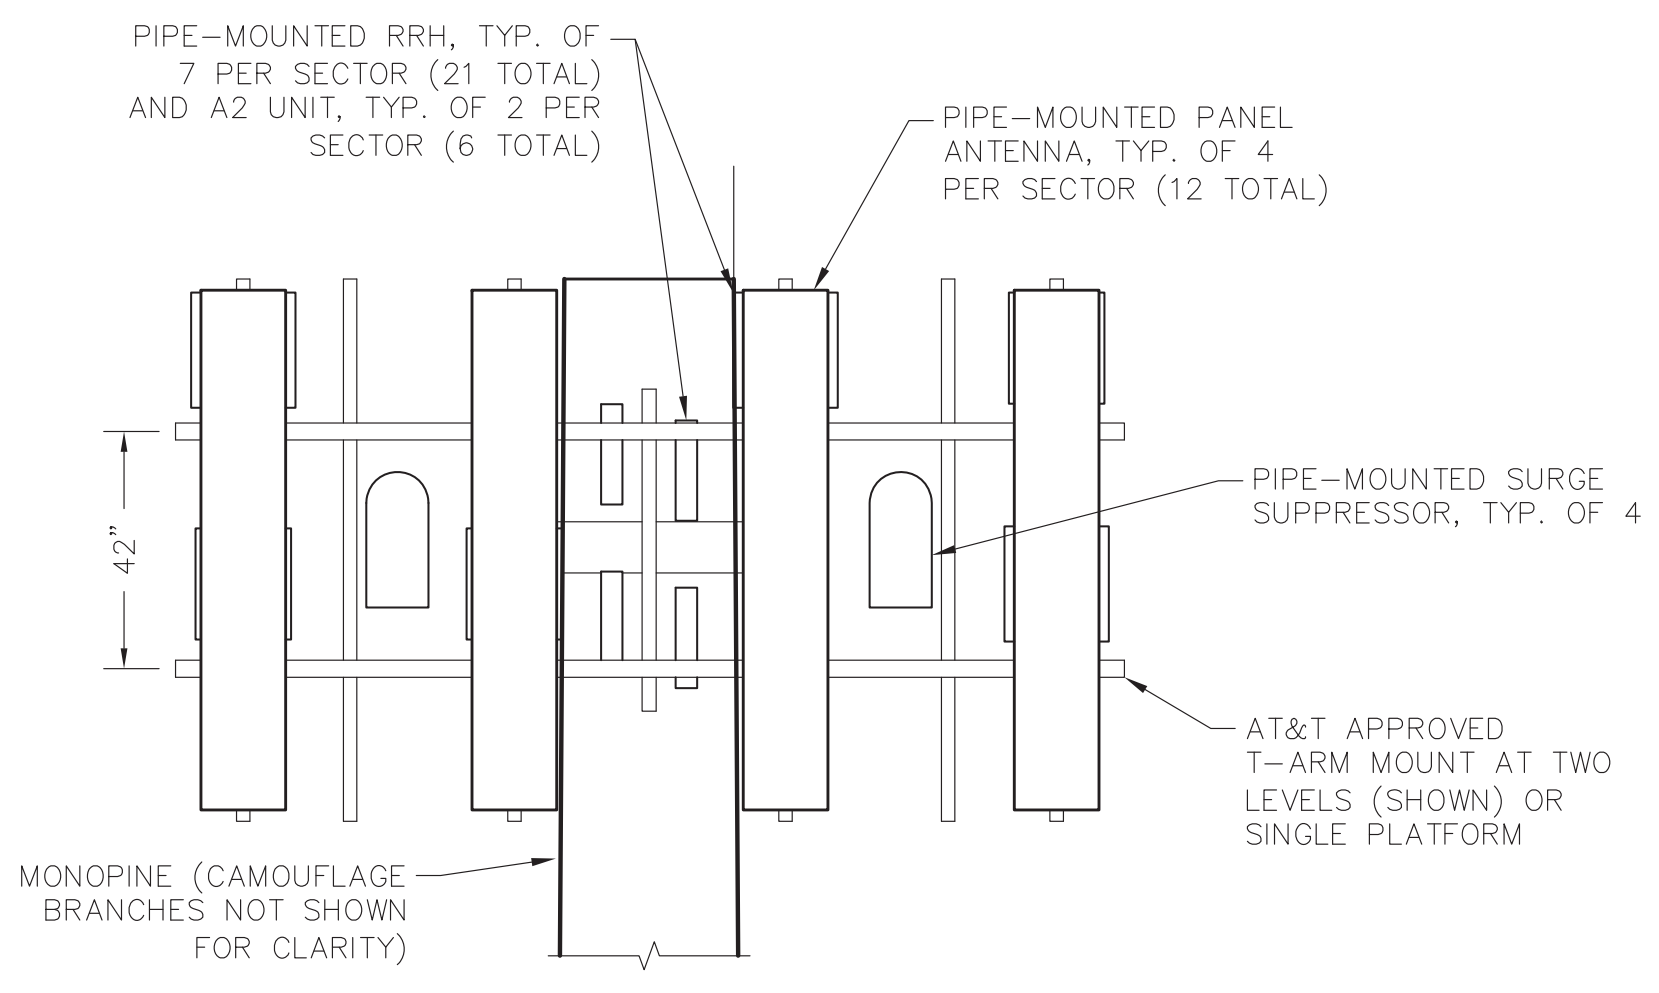


RF EQUIPMENT ELEVATION
SCALE: 1"=3'

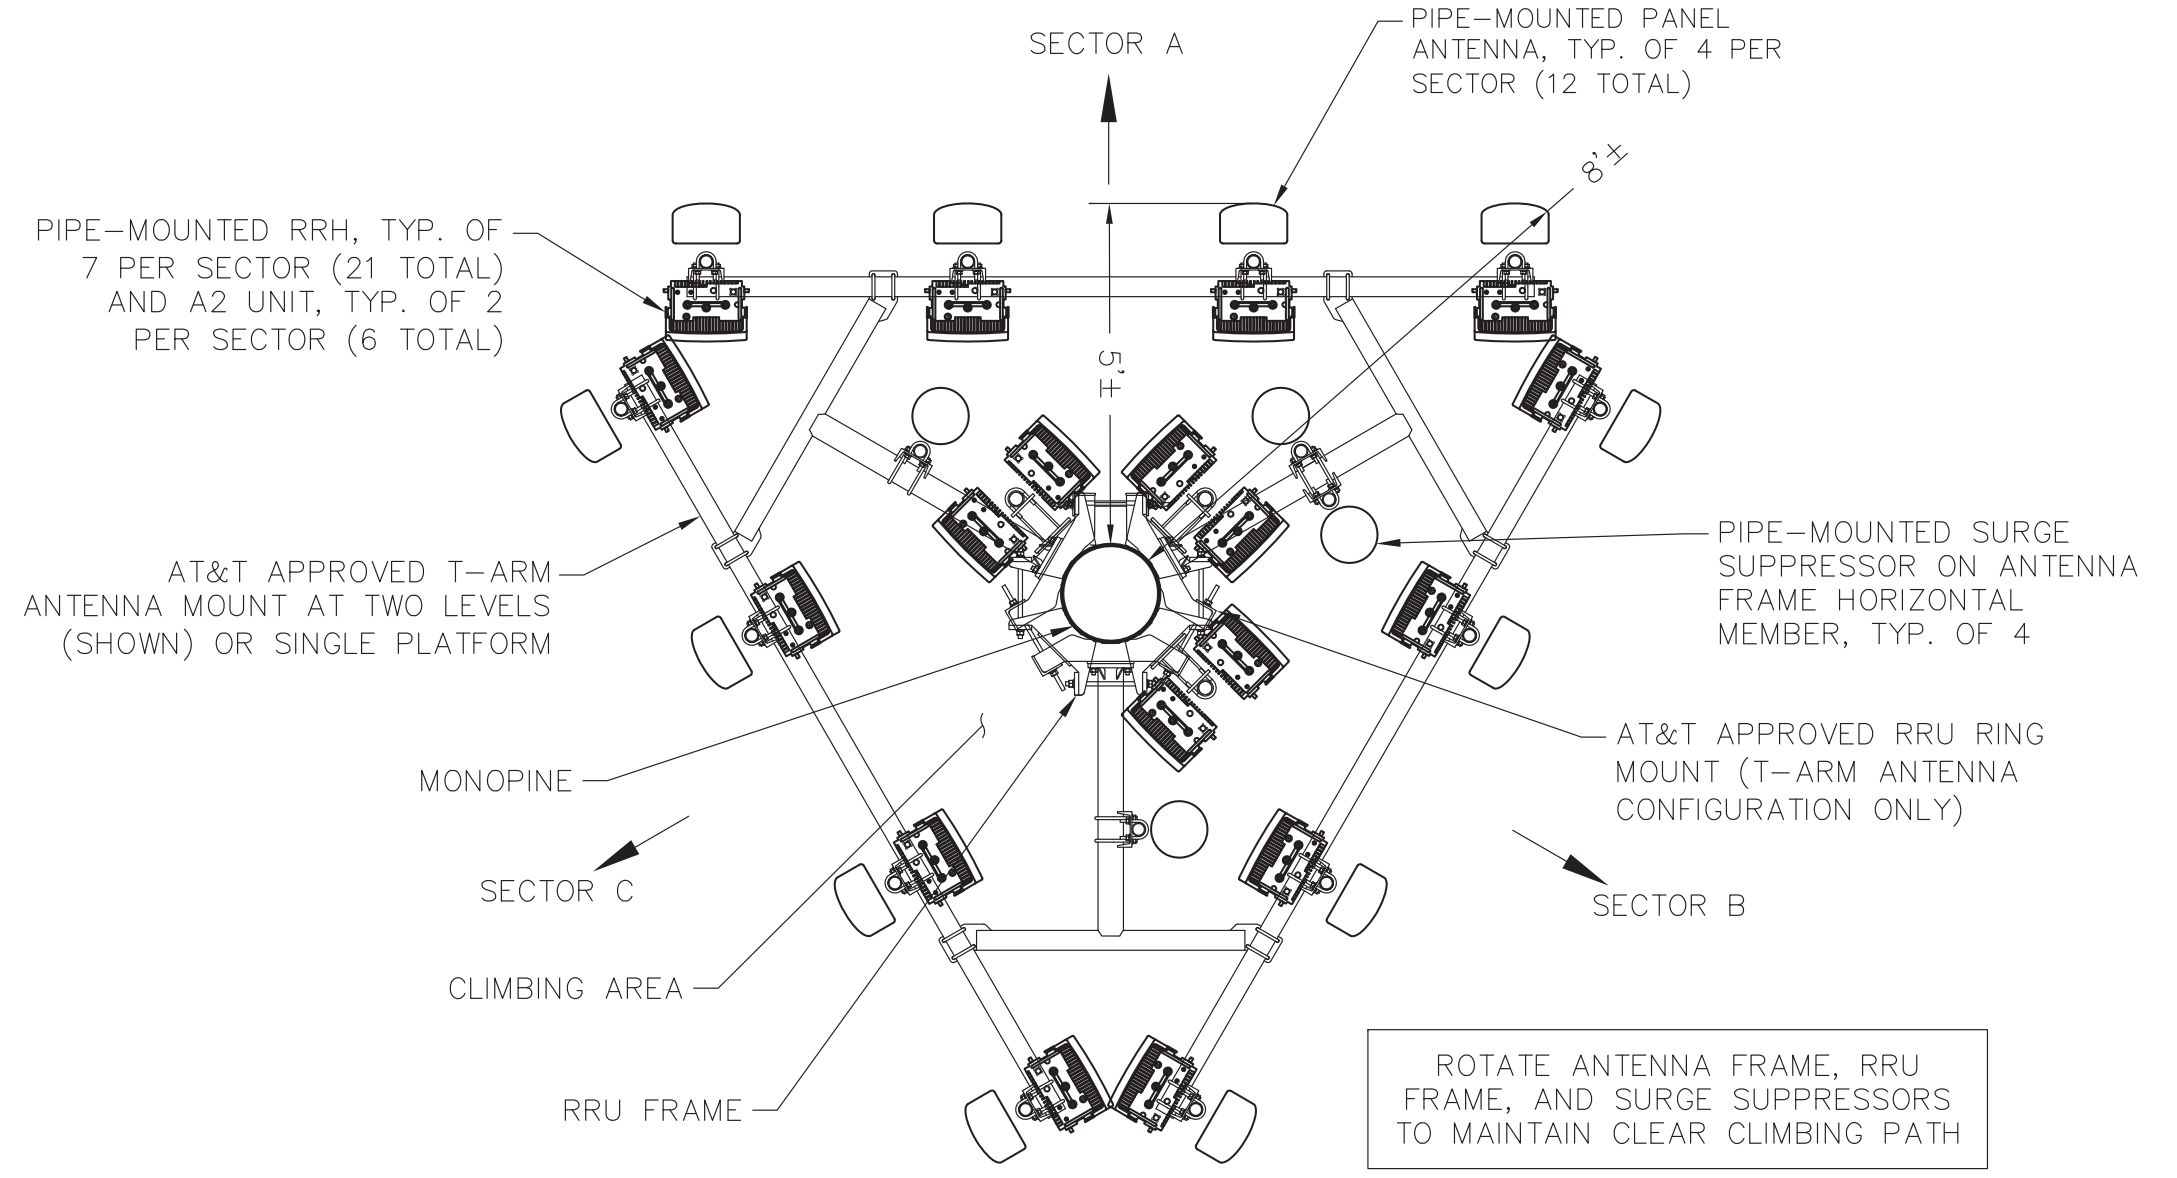

RF EQUIPMENT PLANS
SCALE: 1"=3'


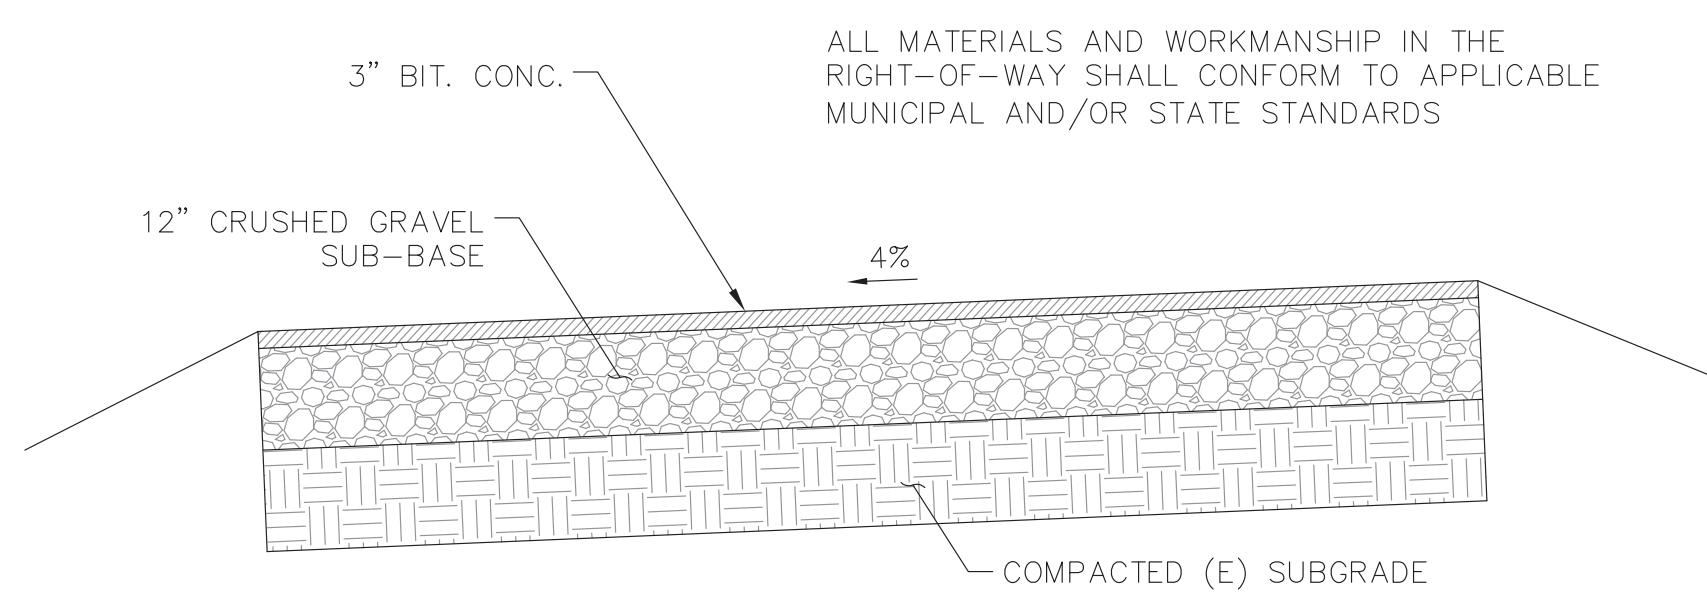


PAVED APRON
SCALE: NONE

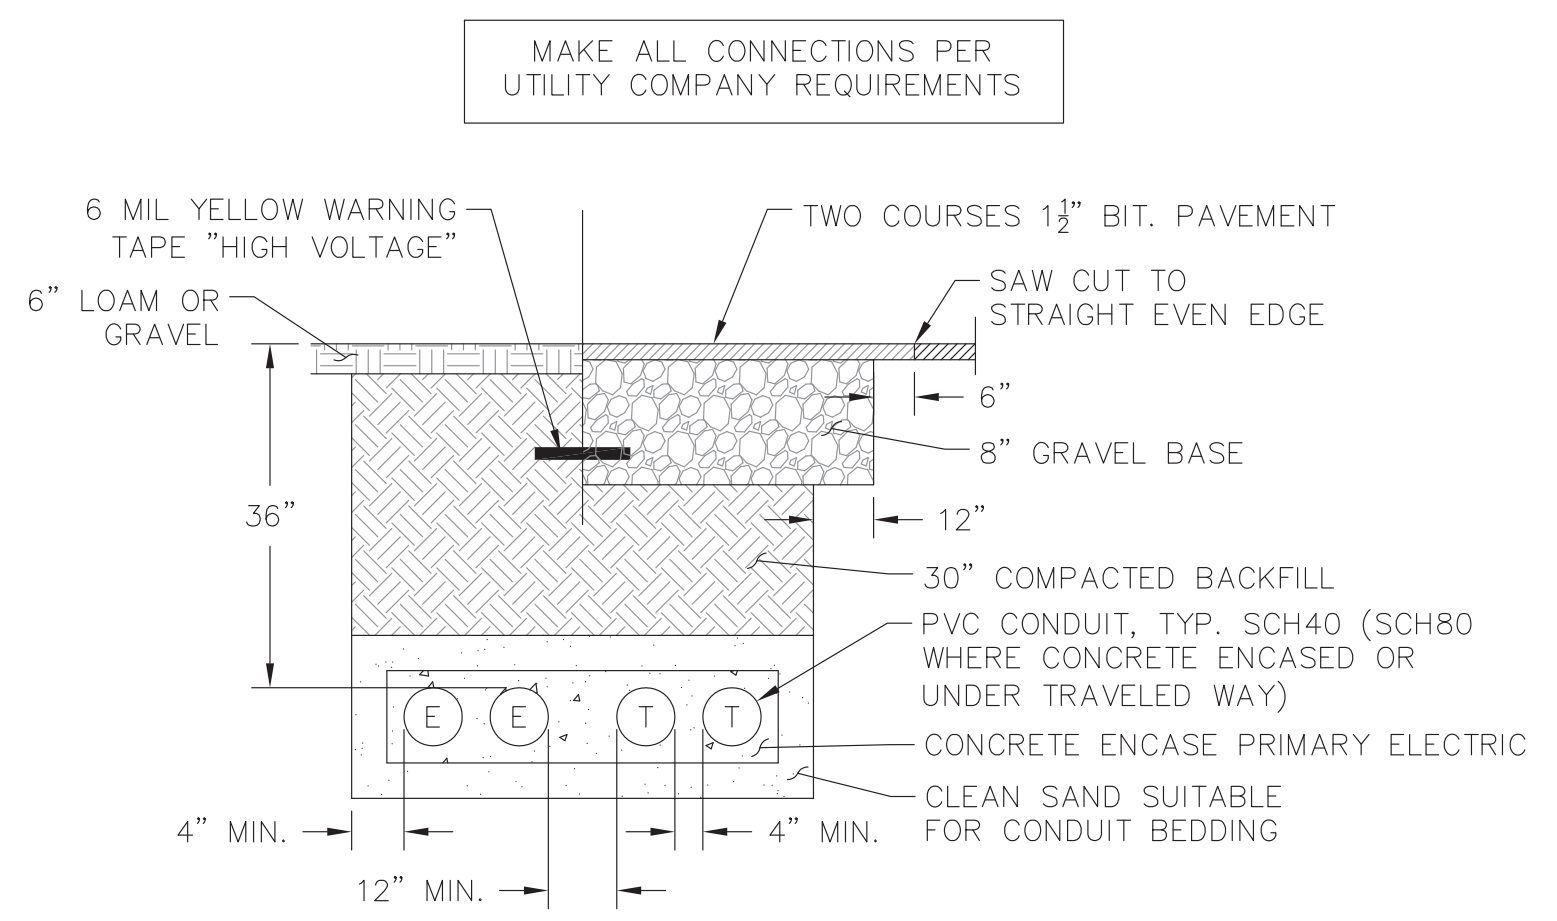


BURIED CONDUIT SECTION
SCALE: NONE

SPACING NEEDED BETWEEN WATER BARS	
SLOPE	DIVERSION SPACING (feet)
< 1%	400
1-2%	245
2-5%	125
5-10%	125
10-15%	78
>15%	58

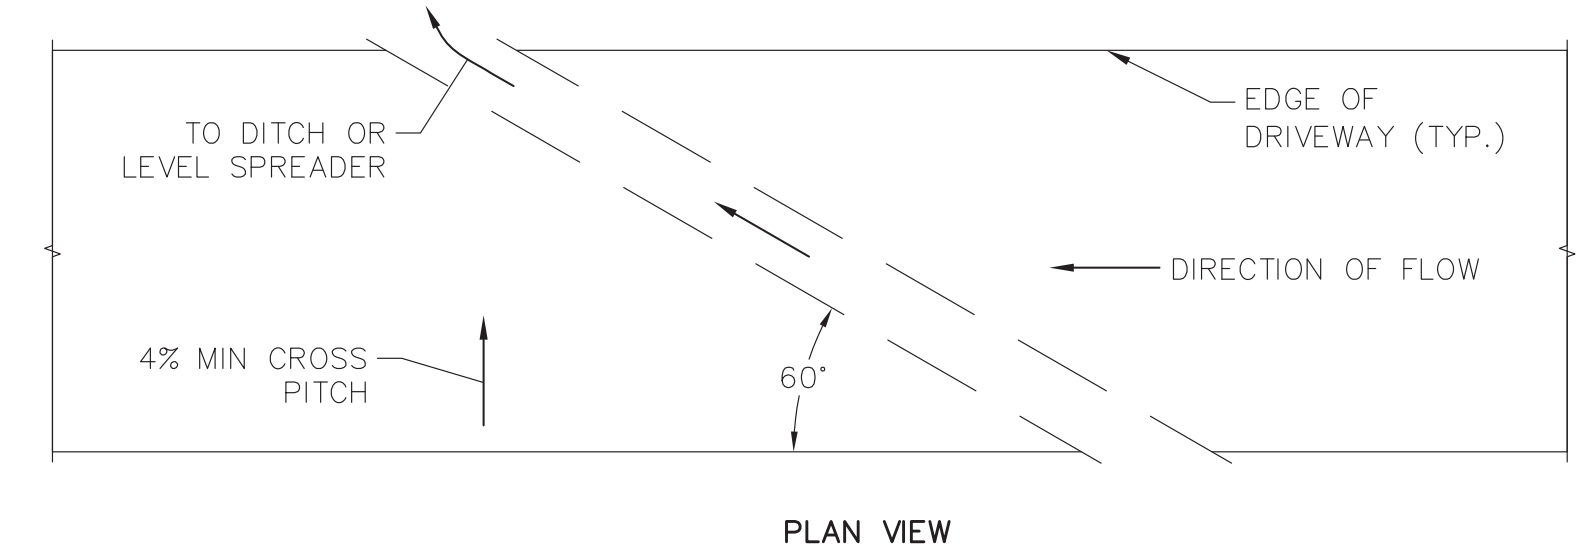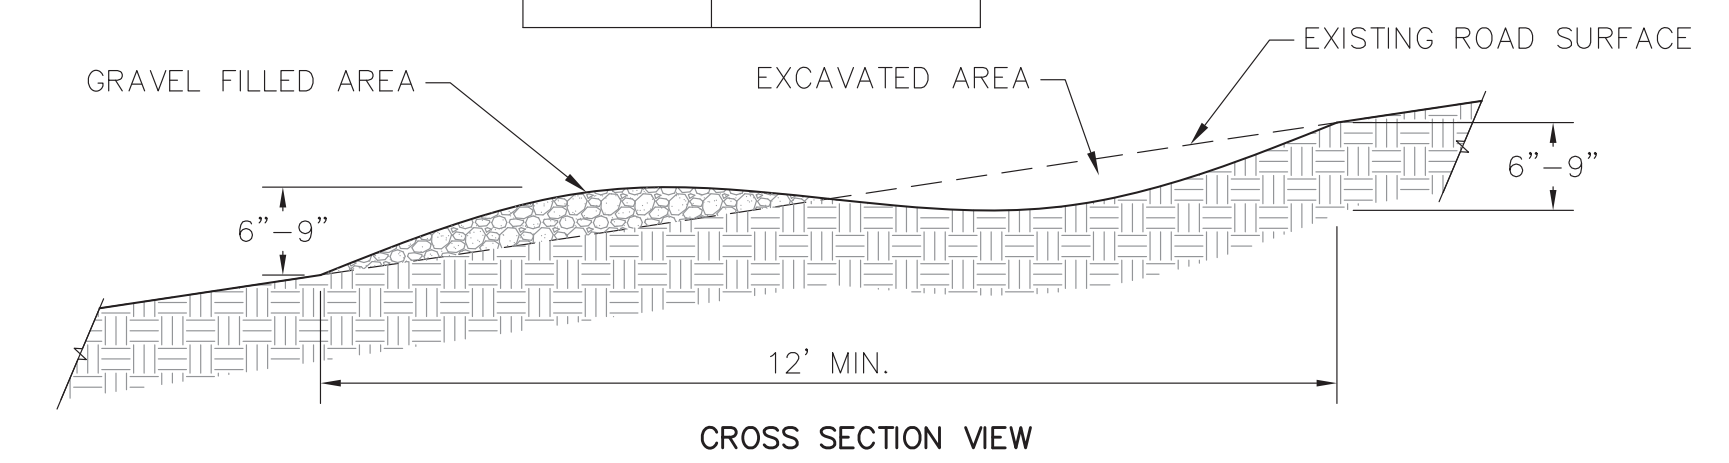


WATER BAR
SCALE: NONE


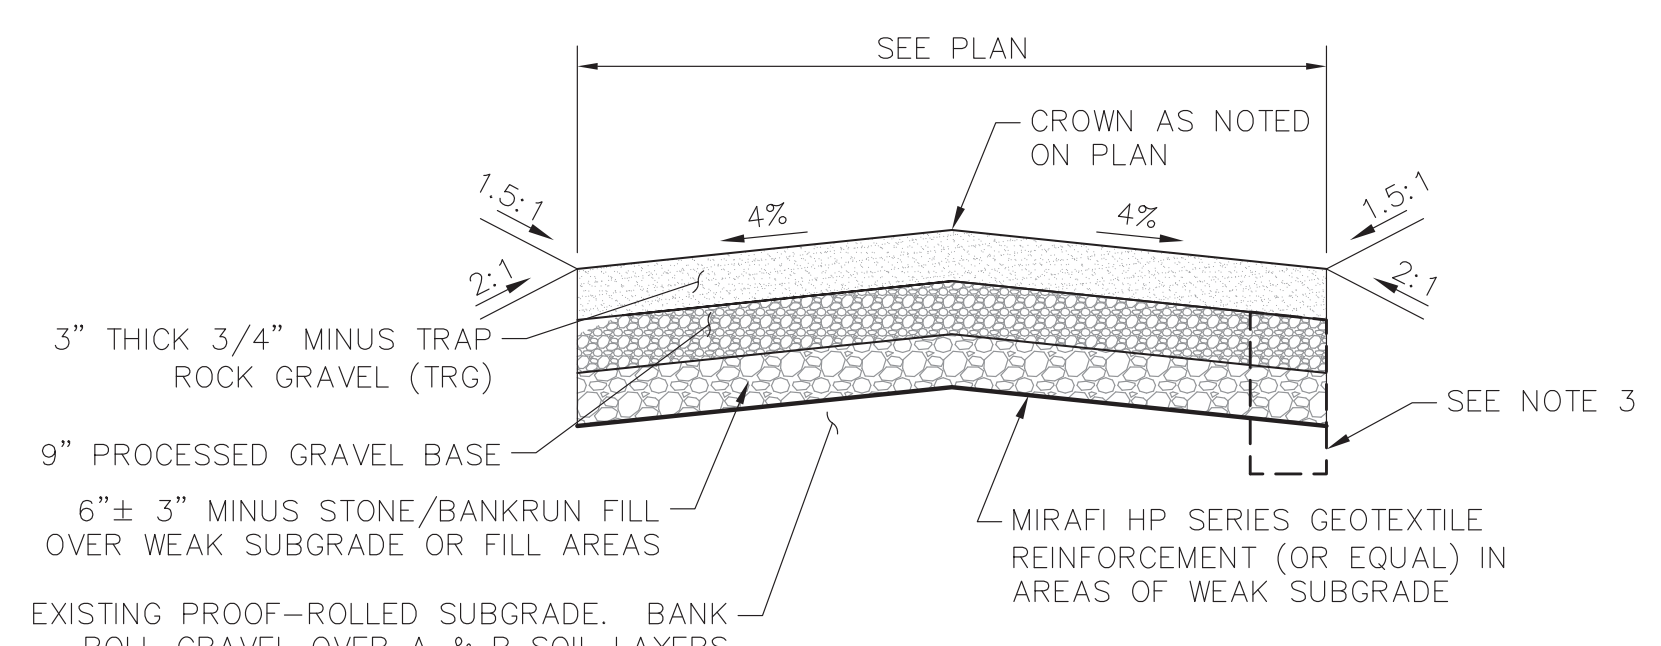


DRIVEWAY SECTION
SCALE: NONE


- NOTES:
- ALL GRANULAR MATERIALS SHALL BE COMPACTED TO 95±% MAXIMUM DRY DENSITY BY STD. PROCTOR METHOD
 - ALL CUT AND FILL SLOPES TO BE COVERED WITH JUTE MESH EROSION CONTROL BLANKETS AND/OR HYDROSEEDED WITH NEW ENGLAND ROADSIDE MATRIX MIX AT 35LBS PER ACRE OR EQUAL.
 - THE REQUIREMENT FOR INSTALLATION OF SUBDRAINS SHALL BE DETERMINED BY THE ENGINEER BASED ON FIELD CONDITIONS AT THE TIME OF CONSTRUCTION. SUBDRAINS SHALL BE OUTLETTED TO DAYLIGHT AS APPROVED BY THE ENGINEER.

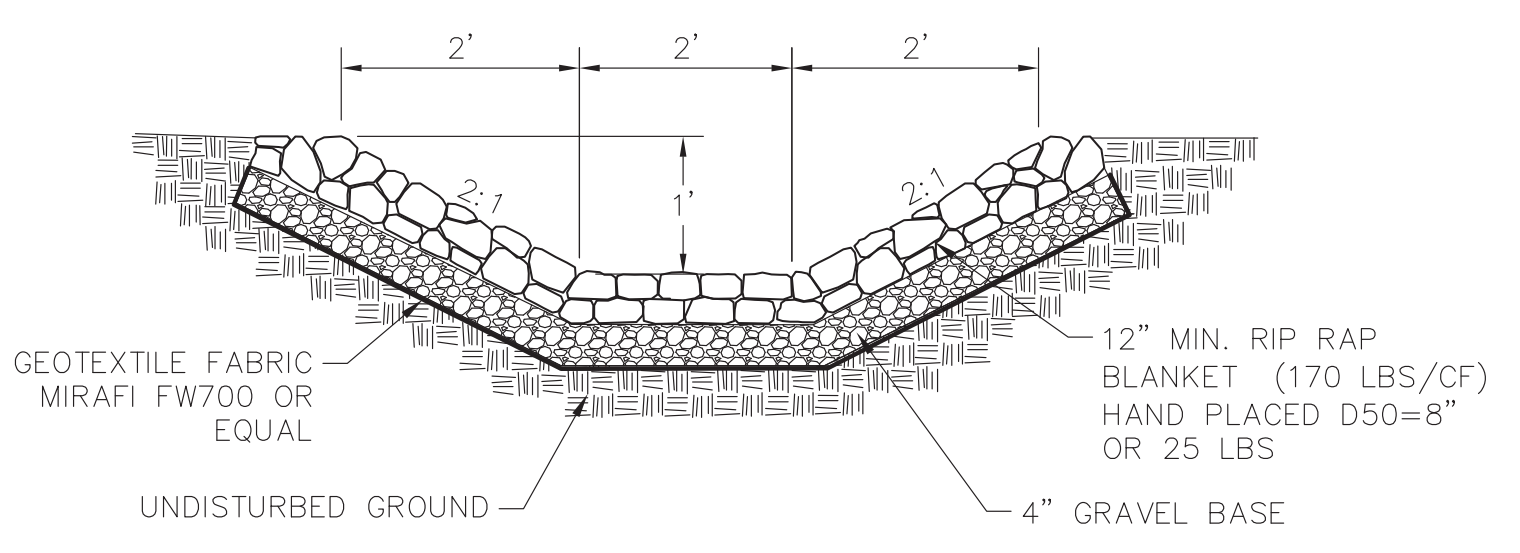

STONE LINED SWALE
SCALE: NONE

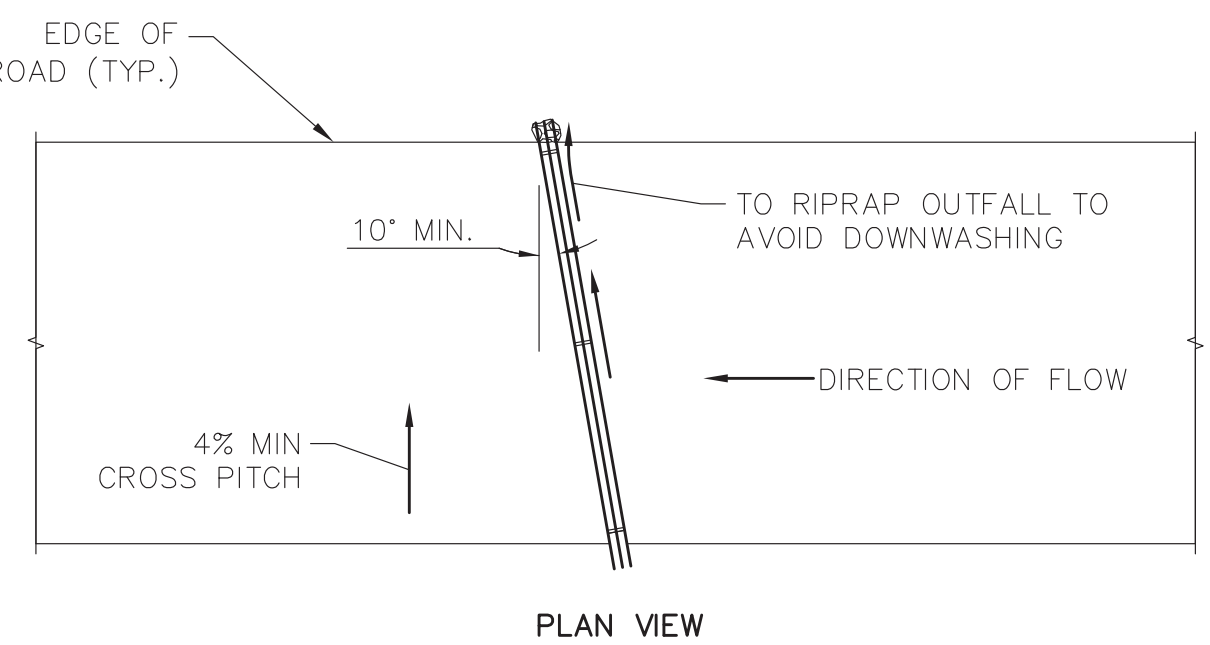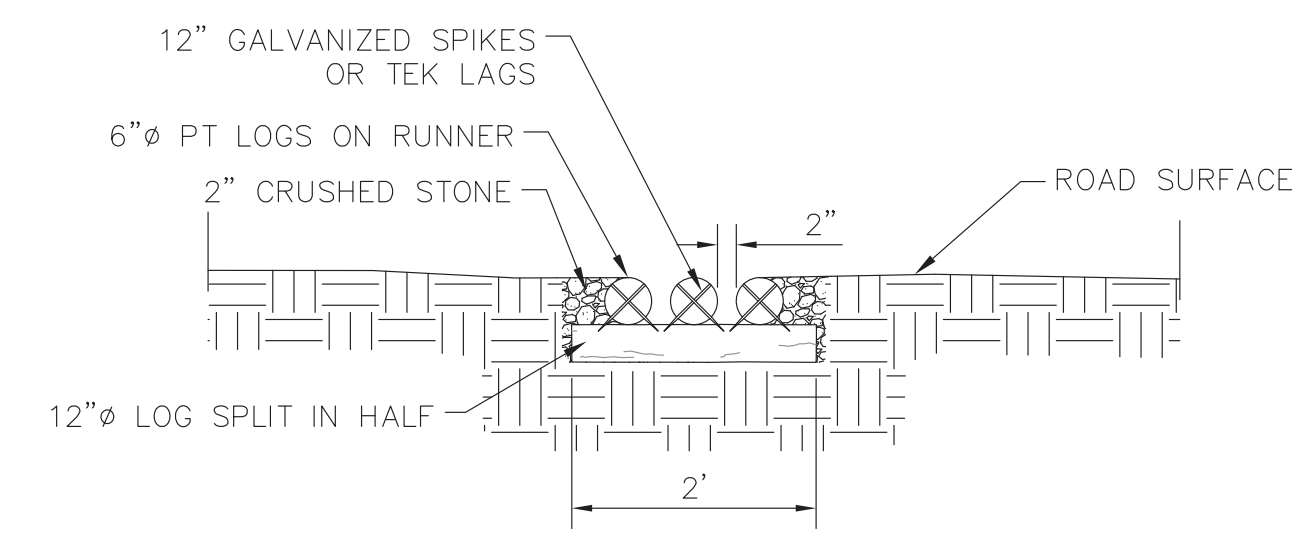


POLE CULVERT
SCALE: NONE

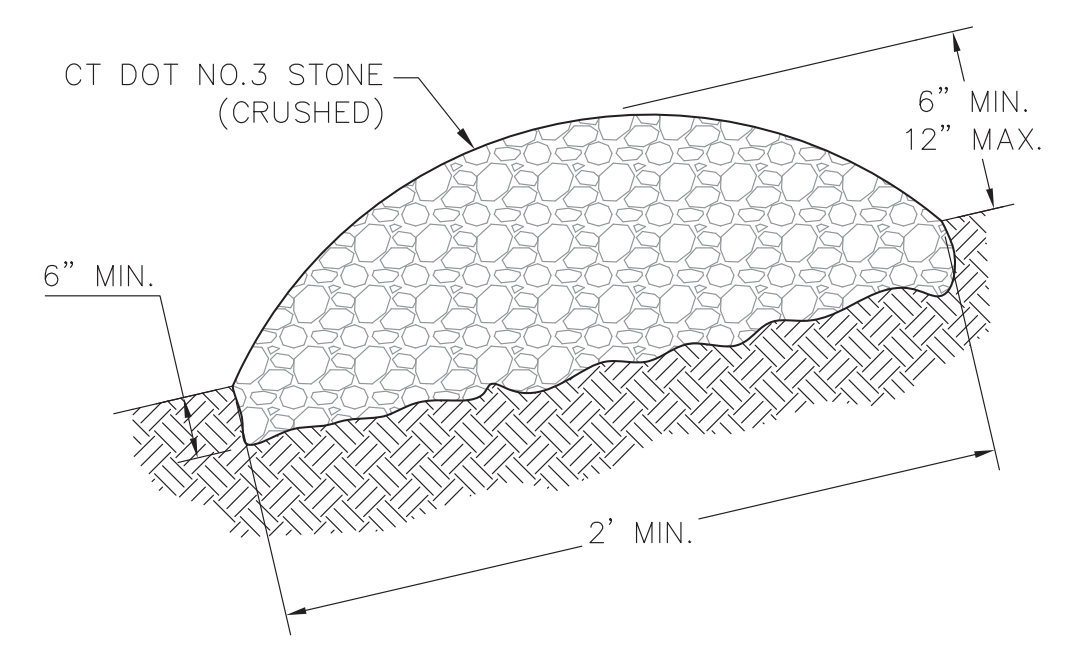

INSTALL IN STONE CHECK DAMS AT INTERVALS SUCH THAT BOTTOM OF CHECK DAM IS AT SAME ELEVATION AS TOP OF NEXT DOWNHILL CHECK DAM (NOT TO EXCEED 75 FEET)

RIP RAP CHECK DAM
SCALE: NONE

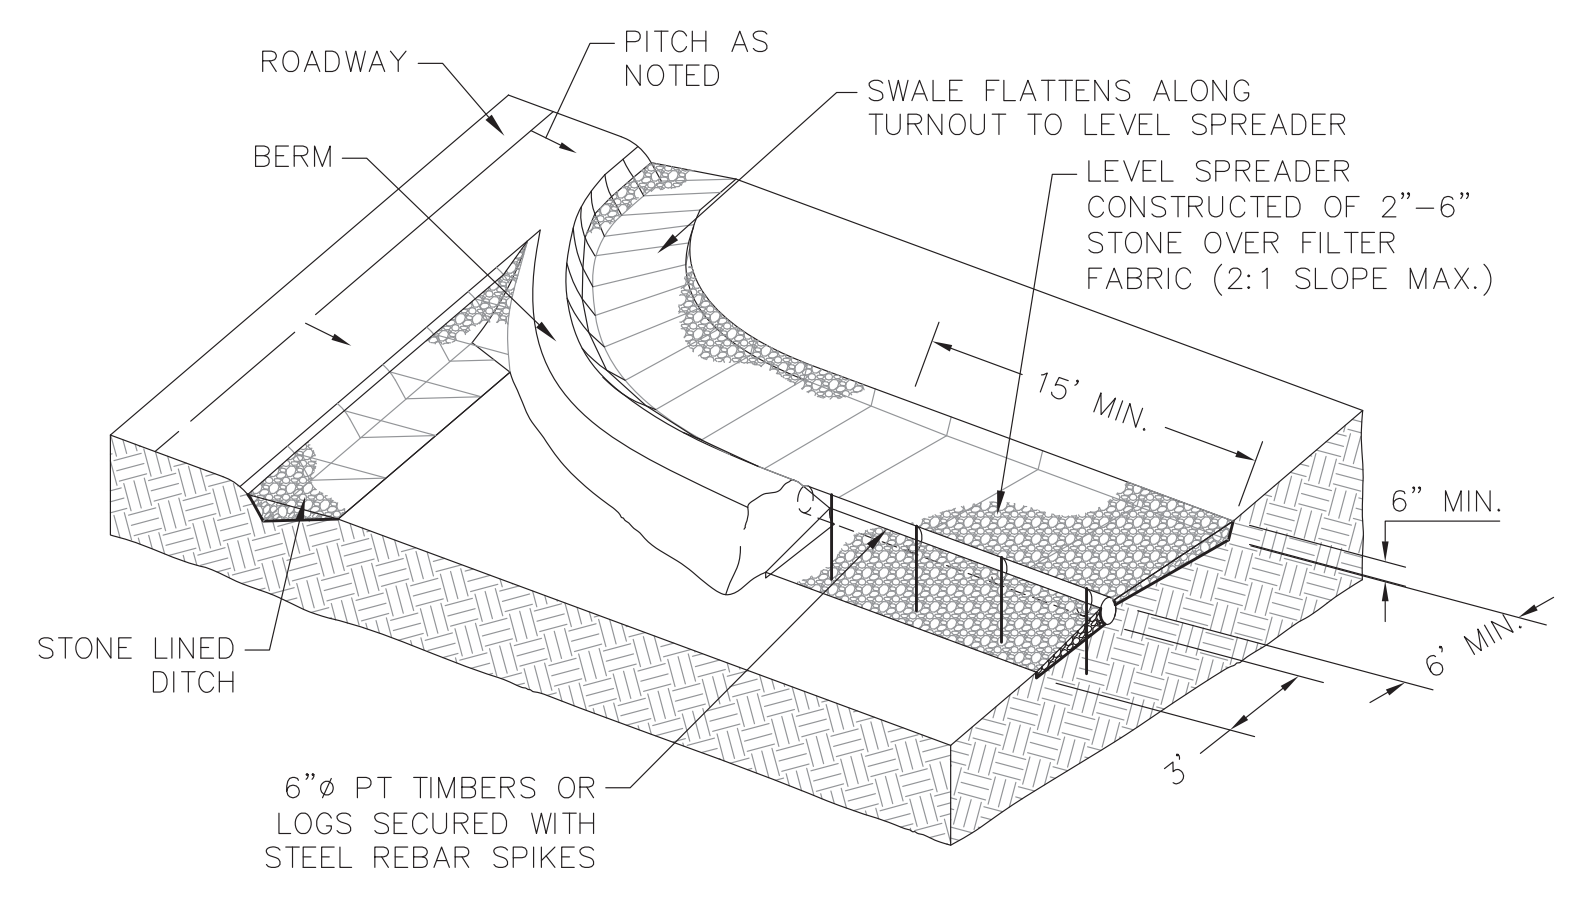

DITCH TURNOUT
SCALE: NONE

CLIENT:

27 Northwestern Drive
Salem, NH 03079

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SITE NUMBER: S1200
ADDRESS: 30 COBBLERS HILL COURT
MONROE, CT 06468

NEW CIRCULAR WIRELESS PCS, LLC ("at&t")
500 ENTERPRISE DRIVE
ROCKY HILL, CT 06067

at&t

STAMP:

5-23-14

DATE: 7/12/13
DRAWN: MJV
CHECK: JMM/TEJ
SCALE: SEE PLAN
JOB NO.: 13-014

CLIENT:




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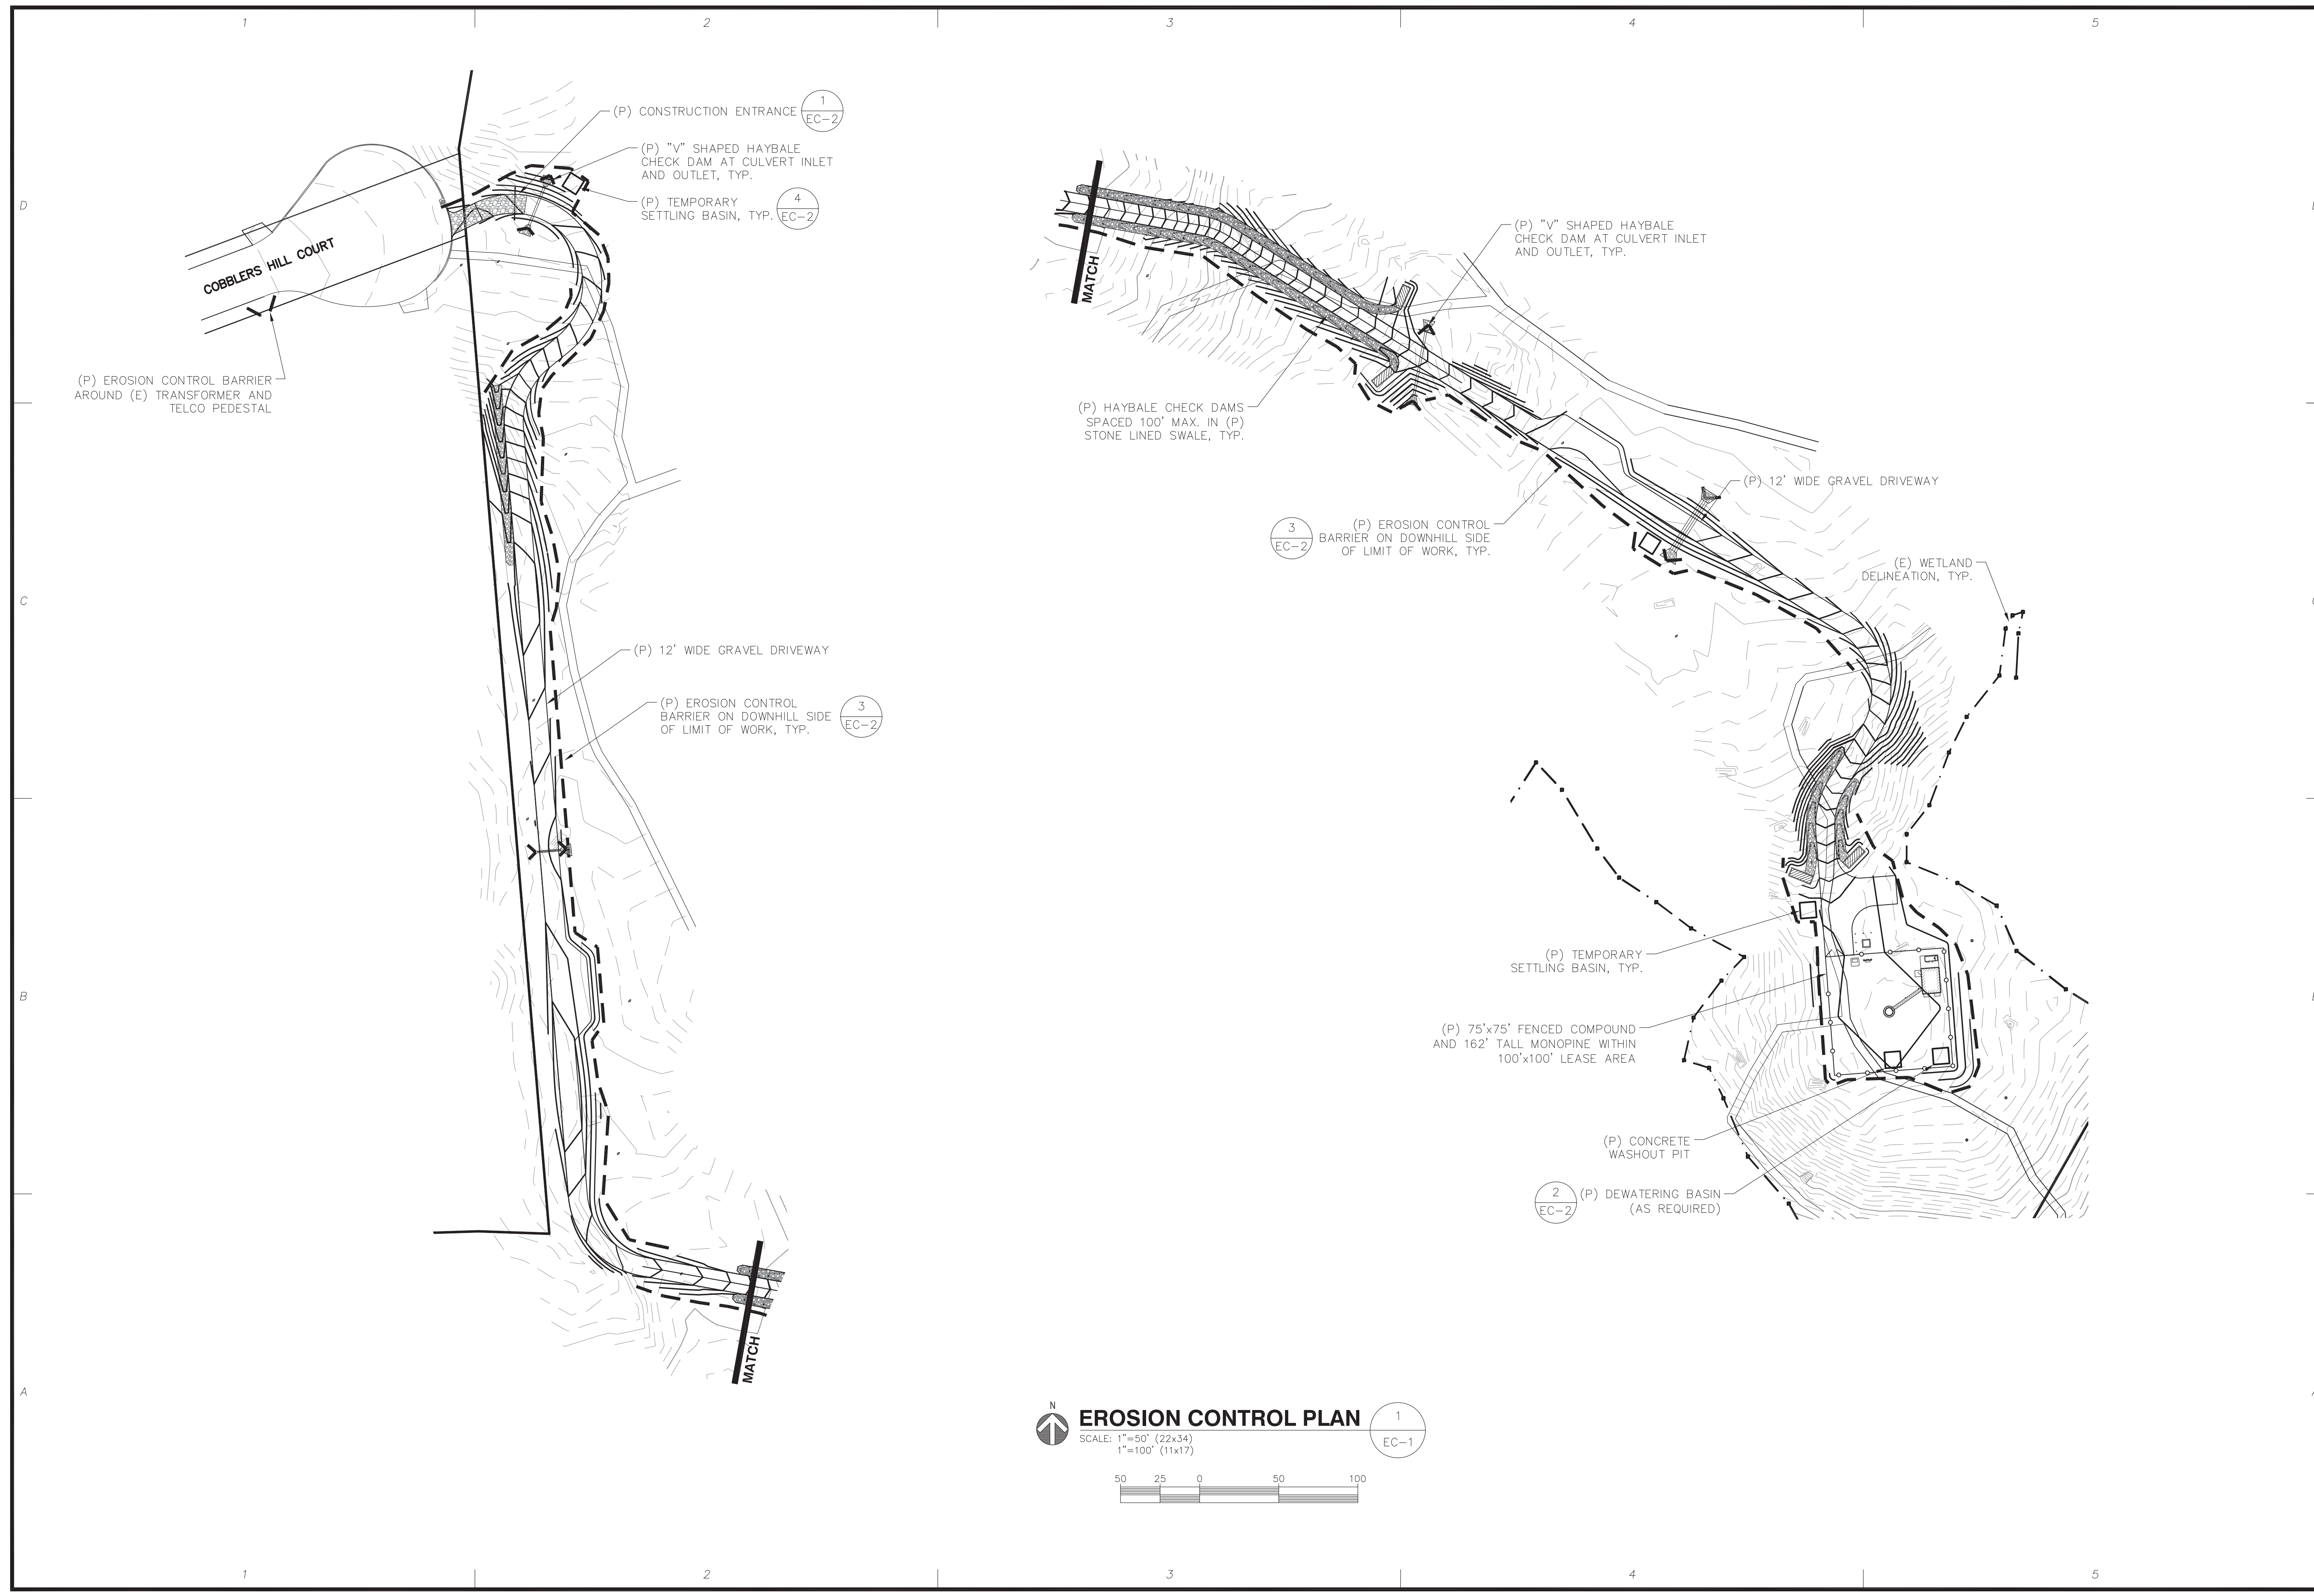
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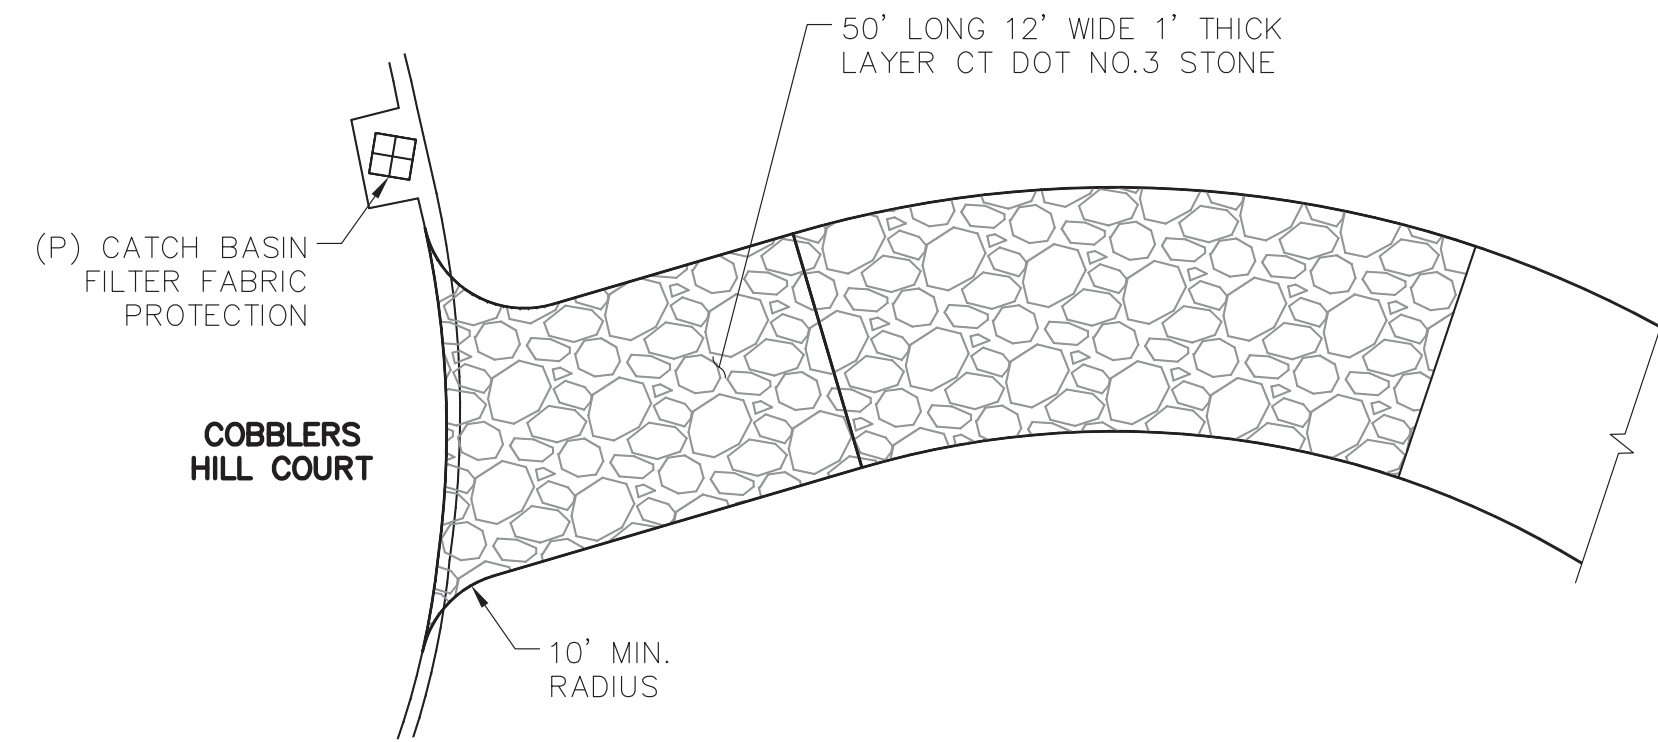
DATE: 7/12/13
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CHECK: JMM/TEJ
SCALE: SEE PLAN
JOB NO.: 13-014

SHEET TITLE:
EROSION CONTROL PLAN
EC-1




EROSION CONTROL PLAN 1
EC-1

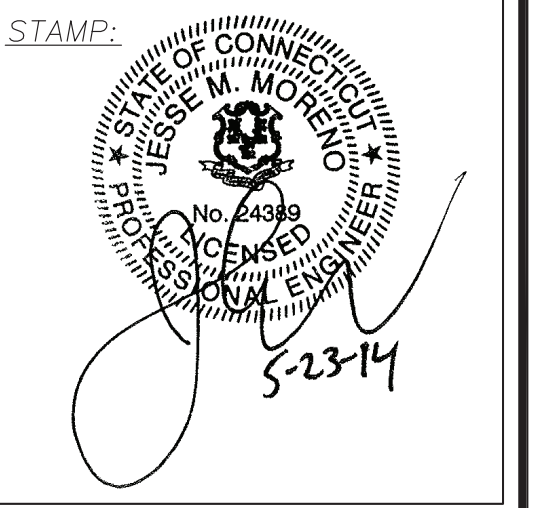SCALE: 1"=50' (22x34)
1"=100' (11x17)




1. AGGREGATE CONSTRUCTION ENTRANCE SHALL BE INSTALLED PRIOR TO COMMENCEMENT OF EARTH MOVING OPERATIONS.
2. CONSTRUCTION ENTRANCE TO BE MAINTAINED UNTIL REMOVED.
3. PAVED APRON SHALL BE INSTALLED AFTER REMOVAL OF CONSTRUCTION ENTRANCE
4. CATCH BASIN PROTECTION SHALL BE CHECKED FOR SEDIMENT BUILD-UP WEEKLY AND AFTER MAJOR RUN-OFF EVENTS. CLEAN AS NECESSARY.

CONSTRUCTION ENTRANCE 1
SCALE: 1"=10' (22x34)
1"=20' (11x17) EC-2

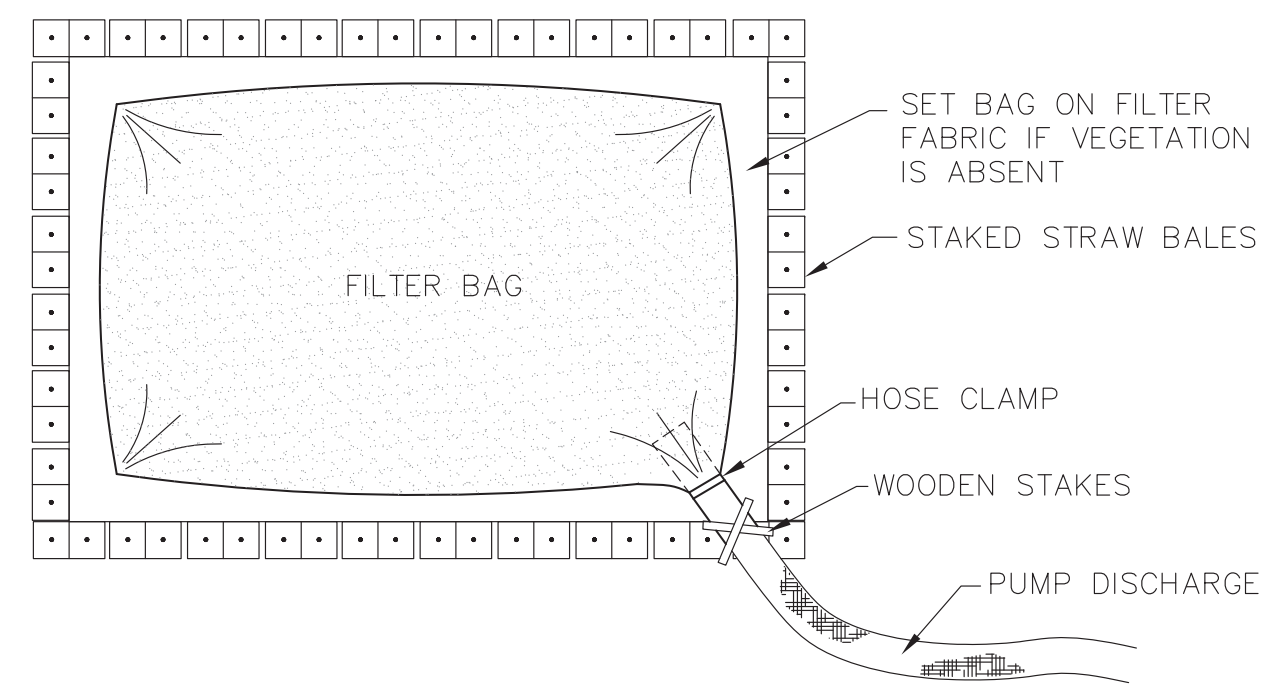


- NOTES:
1. ENSURE DISCHARGE AREA IS COVERED BY STABLE VEGETATION.
 2. USE DIFFUSER NOZZLE OR LOW DISCHARGE RATE TO PREVENT SCOURING.
 3. TO BE PLACED AT AN UPLAND LOCATION THAT WILL ALLOW WATER TO DRAIN TO THE GROUND.
 4. SIZE OF STRAW BALE ENCLOSURE TO BE 10'x10' ADJUSTED TO WATER VOLUME.
 5. ADDITIONAL HAYBALES MAY BE USED TO INCREASE RETENTION & FILTERING.


DEWATERING BASIN 2
SCALE: NONE EC-2

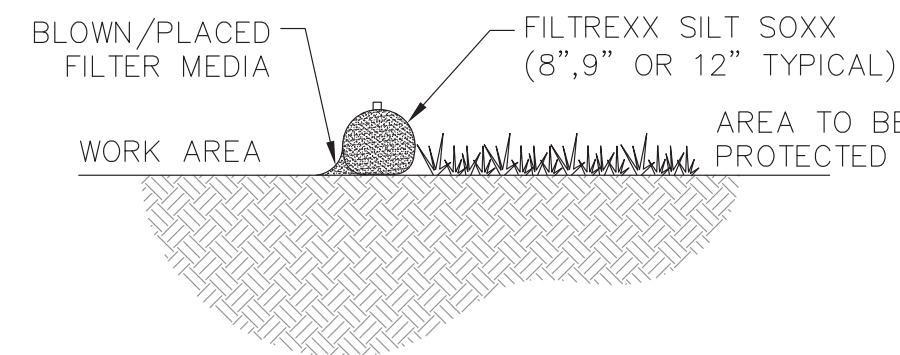

- NOTES:
1. USE SILT SOXX WHERE CONDITIONS DO NOT ALLOW STAKES TO BE DRIVEN.
 2. STRAW BALES TO BE TIED W/BIODEGRADABLE TWINE.
 3. SILT SOXX FILL TO MEET FILTREXX SPECIFICATIONS AND APPLICATION REQUIREMENTS.
 4. SILT SOXX COMPOST MATERIAL TO BE DISPERSED ON SITE, AS DETERMINED BY ENGINEER.

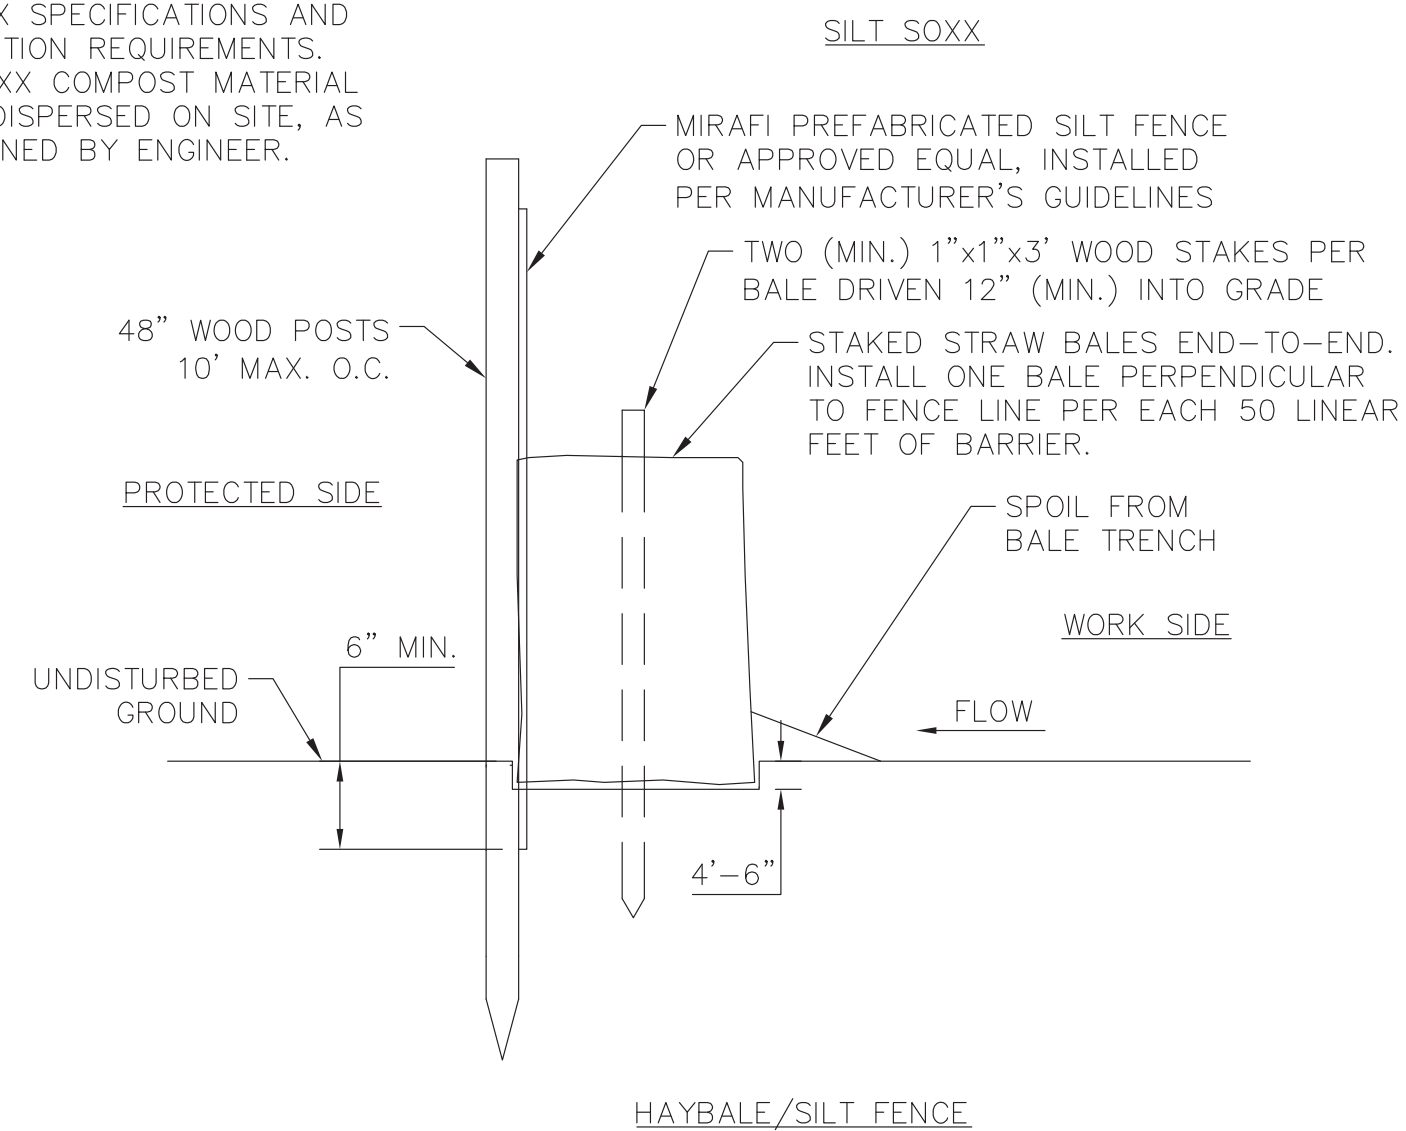

EROSION CONTROL BARRIER 3
SCALE: NONE EC-2

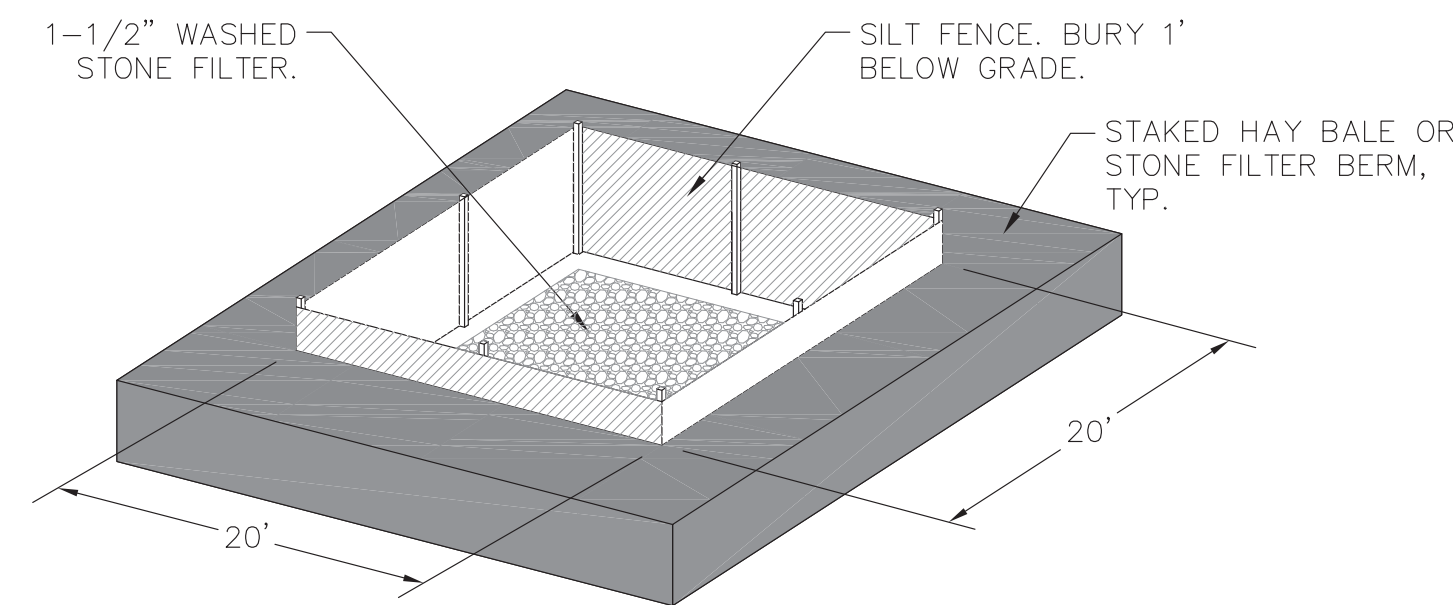

NOTE: DEWATERING BASIN TO BE INSTALLED IN UPLAND AREA >25 FEET FROM RESOURCE AREAS

SETTLING BASIN 4
SCALE: NONE EC-2

EROSION CONTROL NOTES

1. APPLICANT PROPOSES TO MODIFY AN EXISTING CELLULAR TELECOMMUNICATIONS FACILITY. WORK INCLUDES MODIFICATIONS INSIDE THE FENCED COMPOUND AND ADDITIONAL OF A TEMPORARY LATTICE TOWER.
2. TEMPORARY SILT FENCE EROSION CONTROL BARRIER AND SNOW FENCE LIMIT OF WORK BARRIER SHALL BE MAINTAINED THROUGHOUT SITE CONSTRUCTION. STOCK PILE ON SITE 100 FT. OF SILT FENCE FOR EMERGENCY USE. TEMPORARY EROSION BARRIERS SHALL REMAIN IN PLACE UNTIL PERMANENT VEGETATIVE GROUND COVER IS ESTABLISHED.
3. THE CONTRACTOR SHALL CHIP ALL BRUSH AND SLASH CUTTINGS ON SITE AND STOCKPILE THE CHIPS TO BE USED ON ALL UNSTABLE, DISTURBED AREAS DURING CONSTRUCTION AS TEMPORARY STABILIZATION MULCH. NO BURNING WILL BE ALLOWED ON SITE.
4. TEMPORARY STABILIZATION MUST BE PROVIDED TO ANY DISTURBED EARTH THAT IS OPENED UP IN ANY ONE LOCATION FOR MORE THAN 14 DAYS. CHIPS FROM LAND CLEARING, EROSION CONTROL BLANKETS, OR FAST GROWING RYE GRASSES (WINTER OR ANNUAL RYE) MAY BE USED FOR TEMPORARY STABILIZATION AS REQUIRED.
5. STRIPPED TOPSOIL SHALL BE STOCKPILED AND PROTECTED WITH STRAW MULCH. ALL STOCKPILES SHALL HAVE AN APPROVED SILTATION BARRIER TOTALLY SURROUNDING THE PILE. THE PILE SHALL BE IN AN APPROVED UPLAND AREA A MINIMUM OF TWENTY-FIVE FEET FROM ALL RESOURCE AREAS.
6. THE PHASING AND SEQUENCING OF THE WORK FOR THE SITE PREPARATION FOR THE TELECOMMUNICATIONS EQUIPMENT INSTALLATION CONSISTS OF INSTALLING TEMPORARY EROSION AND SEDIMENTATION CONTROL BARRIERS; CLEARING AND ROUGH GRADING AS NEEDED; EXCAVATION FOR UTILITIES; BACK FILL UTILITY TRENCHES; INSTALLATION OF TOWER; INSTALL EQUIPMENT ON TOWER AND IN COMPOUND; GROUNDING AND LIGHTNING PROTECTION; EQUIPMENT TESTING; FINAL GRADING AND STABILIZATION OF DISTURBED AREAS; LOAM AND SEED DISTURBED AREAS OUTSIDE COMPOUND; FINAL CLEANUP. THE ESTIMATED TIME FOR COMPLETION OF THE WORK IS APPROXIMATELY TWENTY (20) WEEKS.
7. THE COMPOUND ENCLOSURE IS SURFACED WITH CRUSHED STONE UNDERLAIN BY A WEED-BLOCK SYNTHETIC FILTER FABRIC. DRAINAGE PATTERNS, RUNOFF VOLUMES AND PEAK FLOW RATES WILL NOT BE SIGNIFICANTLY ALTERED BY THE PROPOSED CONSTRUCTION.
8. ALL DISTURBED AREAS OUTSIDE THE LIMITS OF THE FENCED COMPOUND AND ROADWAY SHALL BE PERMANENTLY ESTABLISHED WITH A NATIVE VEGETATIVE GROUND COVER AT THE CONCLUSION OF CONSTRUCTION. GRADED AREAS SHALL BE PROTECTED WITH STRAW MULCH UNTIL A GOOD VEGETATIVE COVER IS ESTABLISHED.
9. THE TOTAL IMPACT AREA OF THE DISTURBED CONSTRUCTION SITE IS BOUNDED BY THE "LIMIT OF WORK" AS SHOWN HEREON. THE MAXIMUM AREA OF DISTURBANCE WITHIN THE LIMIT OF WORK IS APPROXIMATELY **68,250 SQUARE FEET (1.57 ACRES)**. THE PROJECT IMPACT AREA IS OVER THE EXEMPTION THRESHOLD OF 1 ACRE AS NOTED IN §3(g) OF THE "GENERAL PERMIT FOR DISCHARGE OF STORMWATER AND DEWATERING WASTEWATERS FROM CONSTRUCTION ACTIVITIES" PRODUCED BY THE CONNECTICUT DEPARTMENT OF ENERGY & ENVIRONMENTAL PROTECTION EFFECTIVE OCTOBER 1, 2013. A STORMWATER GENERAL PERMIT IS REQUIRED PRIOR TO COMMENCEMENT OF CONSTRUCTION.
10. ALL EROSION & SEDIMENTATION CONTROL RECOMMENDATIONS OUTLINED IN THE CONNECTICUT STORMWATER QUALITY MANUAL SHALL BE FOLLOWED.
11. THE PROJECT OWNER'S GENERAL CONTRACTOR SHALL CONDUCT ALL SITE DEVELOPMENT WORK IN A MANNER THAT DOES NOT EXCEED THE LIMITS OF WORK SHOWN ON THE PLANS. ADDITIONALLY, THE PROJECT OWNER'S GENERAL CONTRACTOR SHALL CONDUCT ALL CONSTRUCTION ACTIVITIES IN A MANNER THAT DOES NOT RESULT IN STORM WATER DISCHARGES WITH AN ADVERSE IMPACT ON ANY RESOURCE AREAS OR DOWNSTREAM PROPERTIES.
12. UPON COMPLETION OF THE PROJECT, THE CONTRACTOR SHALL REMOVE ALL ACCUMULATED SILT FROM BEHIND SILTATION BARRIERS AND DISPOSE OF SILT EVENLY IN UPLAND AREAS. REMOVE ALL EROSION CONTROL DEVICES WHEN A GOOD VEGETATIVE COVER IS ESTABLISHED.

ProTerra
DESIGN GROUP, LLC

1 Short Street
Suite 3
Northampton, MA 01060
Ph: (413)320-4918
Fax: (413)320-4917

CLIENT:




27 Northwestern Drive
Salem, NH 03079

NO.	DATE	REVISIONS	ISSUED FOR REVIEW	CSC TECH REPORT REVIEW	CSC APPLICATION
A	7/12/13				
0	7/23/13				
1	5/23/14				

SITE NAME: MONROE CT
SITE NUMBER: S1200
ADDRESS: 30 COBBLERS HILL COURT
MONROE, CT 06468

NEW CIRCULAR WIRELESS PCS, LLC ("at&t")
500 ENTERPRISE DRIVE
ROCKY HILL, CT 06067

at&t

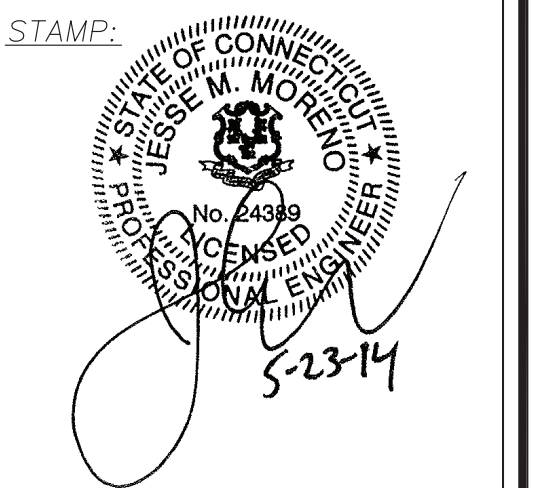

DATE: 7/12/13
DRAWN: MJV
CHECK: JMM/TEJ
SCALE: SEE PLAN
JOB NO.: 13-014

SHEET TITLE:
EROSION CONTROL DETAILS

EC-2

Site Number: S1200

Site Name: Monroe, CT

Site Address: 30 Cobblers Hill Court; Monroe, CT

Assessor's ID: Map 107, Parcel 8.02

Access distances:

New site access road: 1634'±

Distance to Nearest Wetlands (From CL Tower):

89'± to nearest wetlands at Wetland Flag 1-39

Distance to Property Lines (From CL Tower):

803'± to the northern property boundary

1131'± to the southern property boundary

735'± to the western property boundary

144'± to the eastern property boundary

Residence Information:

There are three (3) known existing residence structures within 1,000' of the tower.

Map 115 Parcel 7.05 (84 Mustang Drive) is 900'± to the west.

Map 115 Parcel 7.06 (76 Mustang Drive) is 940'± to the west.

Map 115 Parcel 7.07 (11 Pinto Lane) is 900'± to the southwest.

School/Daycare Information:

The closest school or daycare is the Fawn Hollow Elementary School located 4200'± (0.8± miles) to the southwest

Tree Removal Count:

See Tree Inventory Letter

Distance to Nearest Town (Must notify town if less than 2,500'):

The nearest town to the proposed tower is Newtown, CT. The town boundary is 3190'± to the north.

The nearest town to the locus parcel is Newtown, CT. The town boundary is 1840'± to the north.

May 23, 2014

New Cingular Wireless PCS, LLC
dba AT&T Mobility
500 Enterprise Drive
Rocky Hill, CT 06067


**RE: Tree Inventory
Site S1200 (Monroe CT)
30 Cobblers Hill Court
Monroe, CT**

A site survey was completed at the subject site in July of 2013 by Northeast Survey Consultants. A requirement of the survey involved determining the location of all trees within the topographic survey area with a diameter at breast height of 6" or larger. There are approximately 164 trees proposed to be removed within the areas of the proposed compound and driveway as shown in the permitting plan set.

If you have any questions or need further information, please do not hesitate to call.

Sincerely,
ProTerra Design Group, LLC


Jesse Moreno, PE
Managing Partner

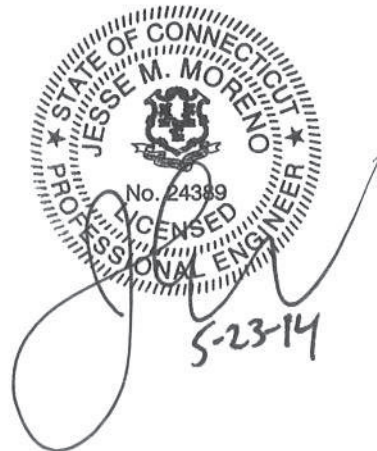

NORTHEAST SURVEY CONSULTANTS PC

116 PLEASANT STREET, SUITE 302, PO BOX 109, EASTHAMPTON, MA 01027 (413) 203-5144

1-A CERTIFICATION

Client: AT&T Mobility
d/b/a New Cingular Wireless PCS, LLC
500 Enterprise Drive
Rocky Hill, CT

Site Number: S1200
Site Name: Monroe CT
Site Address: 30 Cobblers Hill Court, Monroe, CT

Type of Survey: GPS Survey Ground Survey

Horizontal Datum: NAD83 - expressed in degrees of Latitude and Longitude
Vertical Datum: NAVD88 - expressed in feet Above Mean Sea Level (AMSL)

Structure Type: Self-Support Tower Monopole Tower Guyed Tower
 Wood Pole Water Tank Smoke Stack
 Roof Top Church Steeple Temporary Site
 Silo Monopine

Center of Structure: Latitude 41° 21' 18.93" N
Longitude 73° 13' 20.16" W

Ground Elevation at Existing Structure:	489' (AMSL)	0' (AGL)
Tip of Proposed AT&T Antennas:	644' (AMSL)	155' (AGL)
Tip of Proposed AT&T RRU's:	645' (AMSL)	156' (AGL)
Top of Proposed Structure (Pole):	644' (AMSL)	155' (AGL)
Overall Height of Proposed Structure (Branches):	651' (AMSL)	162' (AGL)

Certification: I certify that the latitude and the longitude are accurate to within +/- 20 feet horizontally, and that the ground elevation is accurate to within +/- 3 feet vertically. The horizontal coordinates are based upon the North American Datum of 1983 (NAD 83) and are expressed in degrees of Latitude and Longitude. The elevations are based on the North American Vertical Datum of 1988 and are expressed in feet Above Mean Sea Level (AMSL).

Signature: 
Charles G. Gidman, RPLS

Date: July 10, 2013



TOWAIR Determination Results

*** NOTICE ***

TOWAIR's findings are not definitive or binding, and we cannot guarantee that the data in TOWAIR are fully current and accurate. In some instances, TOWAIR may yield results that differ from application of the criteria set out in 47 C.F.R. Section 17.7 and 14 C.F.R. Section 77.13. A positive finding by TOWAIR recommending notification should be given considerable weight. On the other hand, a finding by TOWAIR recommending either for or against notification is not conclusive. It is the responsibility of each ASR participant to exercise due diligence to determine if it must coordinate its structure with the FAA. TOWAIR is only one tool designed to assist ASR participants in exercising this due diligence, and further investigation may be necessary to determine if FAA coordination is appropriate.

DETERMINATION Results

Structure does not require registration. There are no airports within 8 kilometers (5 miles) of the coordinates you provided.

Your Specifications

NAD83 Coordinates

Latitude	41-21-18.7 north
Longitude	073-13-20.6 west

Measurements (Meters)

Overall Structure Height (AGL)	50.3
Support Structure Height (AGL)	50.3
Site Elevation (AMSL)	152.1

Structure Type

MTOWER - Monopole

Tower Construction Notifications

Notify Tribes and Historic Preservation Officers of your plans to build a tower.

CLOSE WINDOW