

KENNETH C. BALDWIN

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Hartford, CT 06103-3597  
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kbaldwin@rc.com  
Direct (860) 275-8345

Also admitted in Massachusetts

February 20, 2014

**Via Certified Mail Return Receipt Requested**

«Name\_and\_Address»

**Re: Cellco Partnership d/b/a Verizon Wireless  
Proposed Telecommunications Facility  
60 Commerce Drive, Trumbull, Connecticut**

Dear «Salutation»:

Cellco Partnership d/b/a Verizon Wireless (“Cellco”) will be submitting an application to the Connecticut Siting Council (“Council”) on or about February 26, 2014, for approval of the construction of a telecommunications tower and related facility at 60 Commerce Drive in the Town of Trumbull, Connecticut.

The facility would consist of a new 80-foot tower in the northerly portion of an approximately 14-acre parcel at 60 Commerce Drive. Cellco’s radio equipment and an emergency back-up generator would be installed inside a 12’ x 30’ shelter located near the base of the tower. Access to the facility would extend from Commerce Drive along existing paved driveways and parking areas, a distance of approximately 1,365 feet then over a short 100-foot gravel driveway extension to the cell site.

Site plan drawings for the proposed facility are attached for your review. The location and other features of the proposed facilities are subject to change under the provisions of Connecticut General Statutes § 16-50g et seq.

State law provides that owners of record of property which abuts a parcel on which a facility is proposed to be located must receive notice of the submission of this application. This notice is directed to you either because you may be an abutting land owner or as a courtesy notice.

February 20, 2014  
Page 2

If you have any questions concerning the application, please direct them to either the Connecticut Siting Council or me. My address and telephone number are listed above. The Siting Council may be reached at its New Britain, Connecticut office at (860) 827-2935.

Very truly yours,

A handwritten signature in black ink, appearing to read "Kenneth C. Baldwin", with a long horizontal flourish extending to the right.

Kenneth C. Baldwin

KCB/kmd  
Attachment

Cellco Partnership

d.b.a. **verizon** wireless  
**WIRELESS COMMUNICATIONS FACILITY**

TRUMBULL SE 4  
 60 COMMERCE DRIVE  
 TRUMBULL, CT 06611

**SITE DIRECTIONS**

FROM: 60 EAST RIVER ROAD, TRUMBULL, CONNECTICUT

TO: 60 COMMERCE DRIVE, TRUMBULL, CONNECTICUT

1. Head N on STATE ROUTE 15 (RTE 15) toward NEW HAVEN / NEW YORK CITY.
2. Turn right onto US-3 SOUTH-15 S toward NEW HAVEN / NEW YORK CITY.
3. Merge onto I-95 S and take Exit 14 toward NEW HAVEN / NEW YORK CITY.
4. Merge onto CT-8 N and take Exit 52 toward WATERBURY.
5. Turn right onto STATE ROUTE 15 (RTE 15) toward WATERBURY.
6. Turn right onto STATE ROUTE 15 (RTE 15) toward WATERBURY.
7. Turn right onto STATE ROUTE 15 (RTE 15) toward WATERBURY.
8. Turn right onto STATE ROUTE 15 (RTE 15) toward WATERBURY.
9. Turn right onto STATE ROUTE 15 (RTE 15) toward WATERBURY.
10. Turn the 1st LEFT onto COMMERCE DRIVE.


**GENERAL NOTES**

1. PROPOSED ANTENNA LOCATIONS AND HEIGHTS PROVIDED BY CELLSITE PARTNERSHIP.

**SITE INFORMATION**

THE SCOPE OF WORK SHALL INCLUDE:

1. THE CONSTRUCTION OF A 24.5' TALL FENCED WIRELESS COMMUNICATIONS COMPOUND WITHIN A 2.4 AC. LOTS AREA.
2. CONSTRUCTION OF ONE ANTENNA AND PROPOSED TO BE LOCATED AT A COORDINATE ELEVATION OF 807'-07" A.S.L. ON A 80'-07" PROPOSED STEEL MONOPOLE TOWER.
3. TOTAL ACCESS DRIVE LENGTH IS 1,485'± OFF OF COMMERCE DRIVE VIA AN EXISTING ACCESS DRIVE.
4. TOWER AND TOWER UTILITY SHALL BE ROUTED UNDERGROUND FROM EXISTING RESPECTIVE UNDERGROUND UTILITY LOCATIONS TO THE PROPOSED TOWER. FINAL LOCATIONS AND UTILITY LOCATIONS TO PROPOSED BACKLOGS WILL BE DETERMINED BY LOCAL UTILITY COMPANIES. UTILITIES WILL BE ROUTED UNDERGROUND UNDER EXISTING DRIVEWAYS AND UNDER EXISTING DRIVEWAYS. TOWER UTILITY SHALL BE LOCATED WITHIN FENCED COMPOUND AREA.
5. FINAL DESIGN FOR TOWER AND ANTENNA HEIGHTS SHALL BE INCLUDED IN THE DASH PLANS.
6. THE PROPOSED WIRELESS FACILITY INSTALLATION WILL BE DESIGNED IN ACCORDANCE WITH THE 2009 INTERNATIONAL BUILDING CODE AS MODIFIED BY THE 2009 CONNECTICUT SUPPLEMENT.
7. THERE WILL NOT BE ANY LIGHTING UNLESS REQUESTED BY THE FCC OR THE FAA.
8. THERE WILL NOT BE ANY SIGNS OR ADVERTISING ON THE ANTENNAS OR EQUIPMENT.

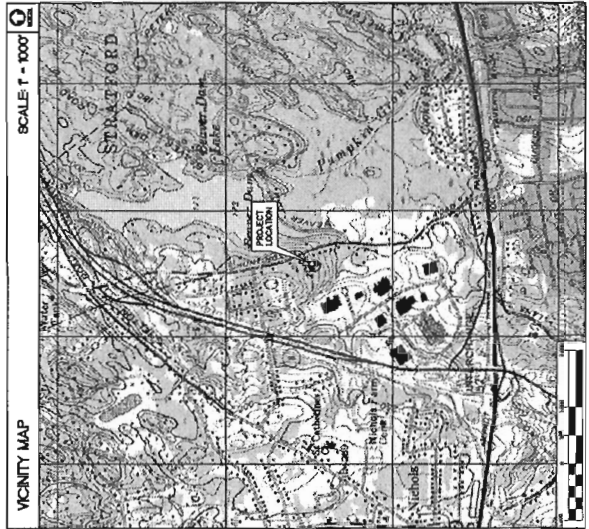

**PROJECT SUMMARY**

SITE NAME: TRUMBULL SE 4  
 SITE ADDRESS: 60 COMMERCE DRIVE, TRUMBULL, CT 06611  
 PROPERTY OWNER: JACOBO DOMESTICO, JR., 1000 W. PALM BLVD., JACKSONVILLE, FL 32224  
 LESSEE/TENANT: CELLSITE PARTNERSHIP, 1000 W. PALM BLVD., JACKSONVILLE, FL 32224  
 CONTRACT PERSON: SURETY CARTER, 400 W. VERIZON WIRELESS, EAST HARTFORD, CT 06108

TOWER COORDINATES: LATITUDE 41°-14'-44.1807" LONGITUDE 72°-08'-44.014" UTM ZONE 18Q UTM EASTING 660108 UTM NORTING 461108

COORDINATES AND ELEVATIONS BASED ON FAA SURVEY DATA. ANTENNA HEIGHTS PROVIDED BY CELLSITE PARTNERSHIP AND ASSOCIATED DATED NOVEMBER 14, 2013.

**SHEET INDEX**

| SHEET NO. | DESCRIPTION   | REV. NO. |
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| C-6       | SHIELDER FENCE PLAN, DETAILS AND NOTES                      | 2        |

d.b.a. Verizon Wireless

www.CellcoPartnership.com  
 1000 W. PALM BLVD., JACKSONVILLE, FL 32224  
 904.488.8714  
 FAX: 904.488.8714

CELLSITES COMMUNICATIONS FACILITY  
**TRUMBULL SE 4**  
 60 COMMERCE DRIVE  
 TRUMBULL, CT 06611

PROFESSIONAL ENGINEER SEAL

DATE: 07/26/14  
 SCALE: AS NOTED  
 JOB NO.: 130301000

TITLE SHEET

**T-1**

Sheet No. 1 of 1

DATE: 01/26/14  
SCALE: AS NOTED  
JOB NO. 13200-000


90 COMMERCIAL DRIVE  
TRUMBULL, CT 06611

Collo Partnership d/b/a Verizon Wireless  
d.a. Verizon Wireless




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|------|----------|-----|----------|-------------|
| REV. | DATE     | BY  | CHK'D BY | DESCRIPTION |
| 1    | 02/12/14 | TAM | DWG      | REVISIONS   |
| 2    | 02/17/14 | TAM | DWG      | REVISIONS   |
| 3    | 02/17/14 | TAM | DWG      | REVISIONS   |

SITE LOCATION PLAN

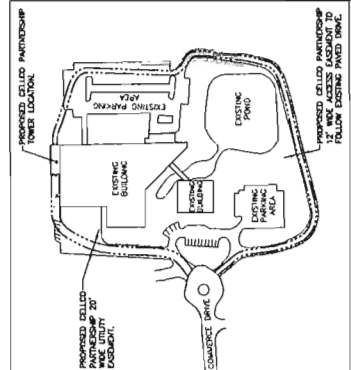

MUNICIPALITY NOTIFICATION LIMIT MAP

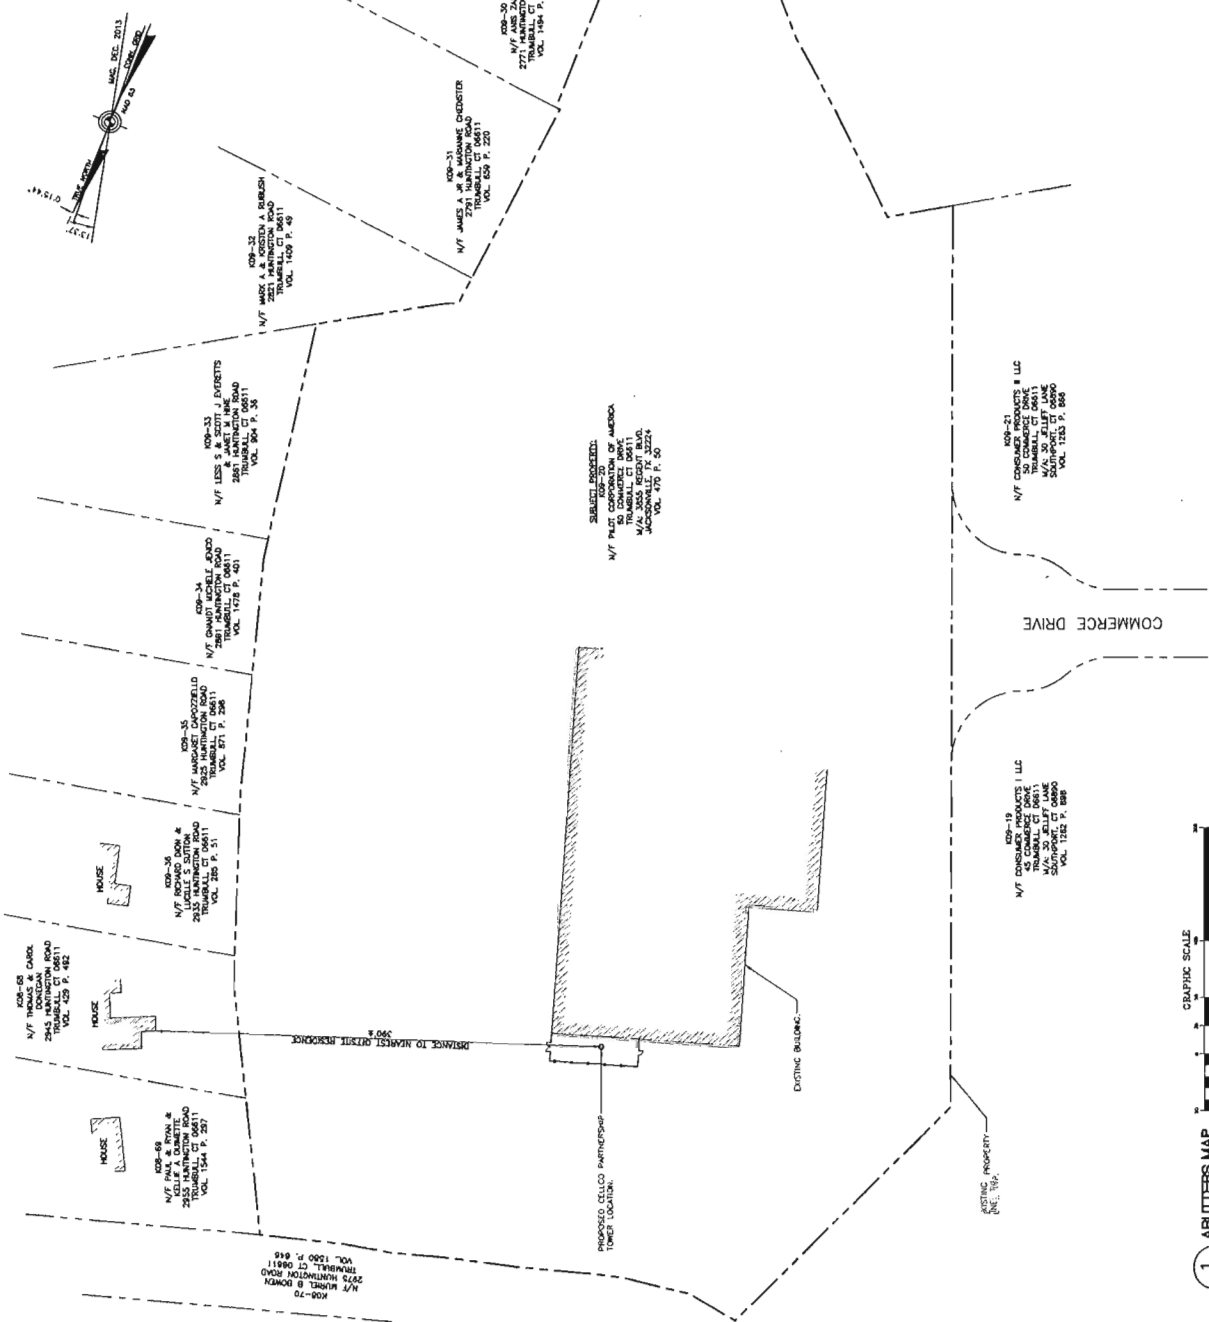

GRAPHIC SCALE  
1" = 20' (38 FEET)  
1 inch = 20 feet

1 ABUTTERS MAP C-1  
SCALE: 1"=20'



| REV. | DATE     | BY | CHKD BY | DESCRIPTION              |
|------|----------|----|---------|--------------------------|
| 1    | 02/27/14 | ML | ML      | ISSUED FOR PERMIT REVIEW |
| 2    | 02/17/14 | ML | ML      | REVISED DSD              |



d/b/a Verizon Wireless  
 Calco Partnership

www.Centex.com  
 Centex  
 12000 Old Branch Road  
 Newark, CT 06458  
 (203) 466-4540  
 Fax: (203) 466-4540




Calco Partnership d/b/a Verizon Wireless  
 WALKER COMMUNICATIONS FACILITY  
 TRUMBULL SE 4  
 90 COMMERCE DRIVE  
 TRUMBULL, CT 06611

DATE: 02/27/14  
 SHEET: 41 OF 41  
 JOB NO.: 150000000

COMPOUND PLAN, ELEVATION AND ANTENNA MOUNTING CONFIG

**C-2**


Sheet No. 5 of 8

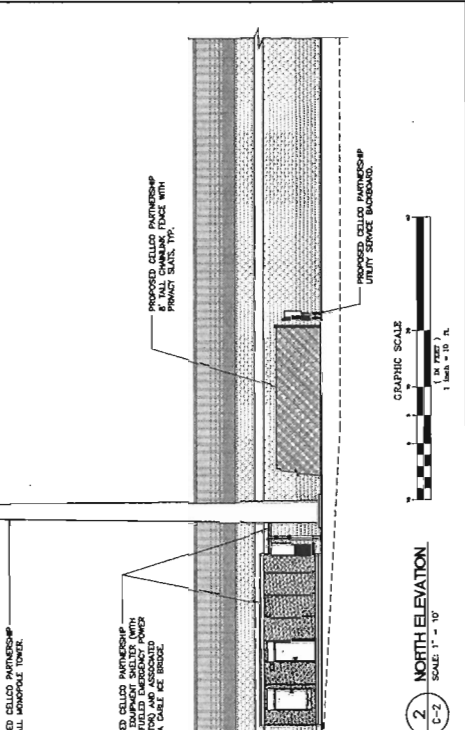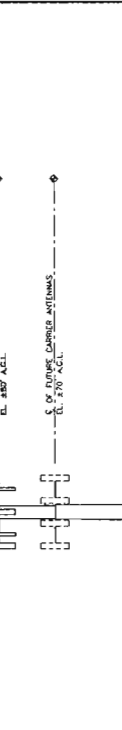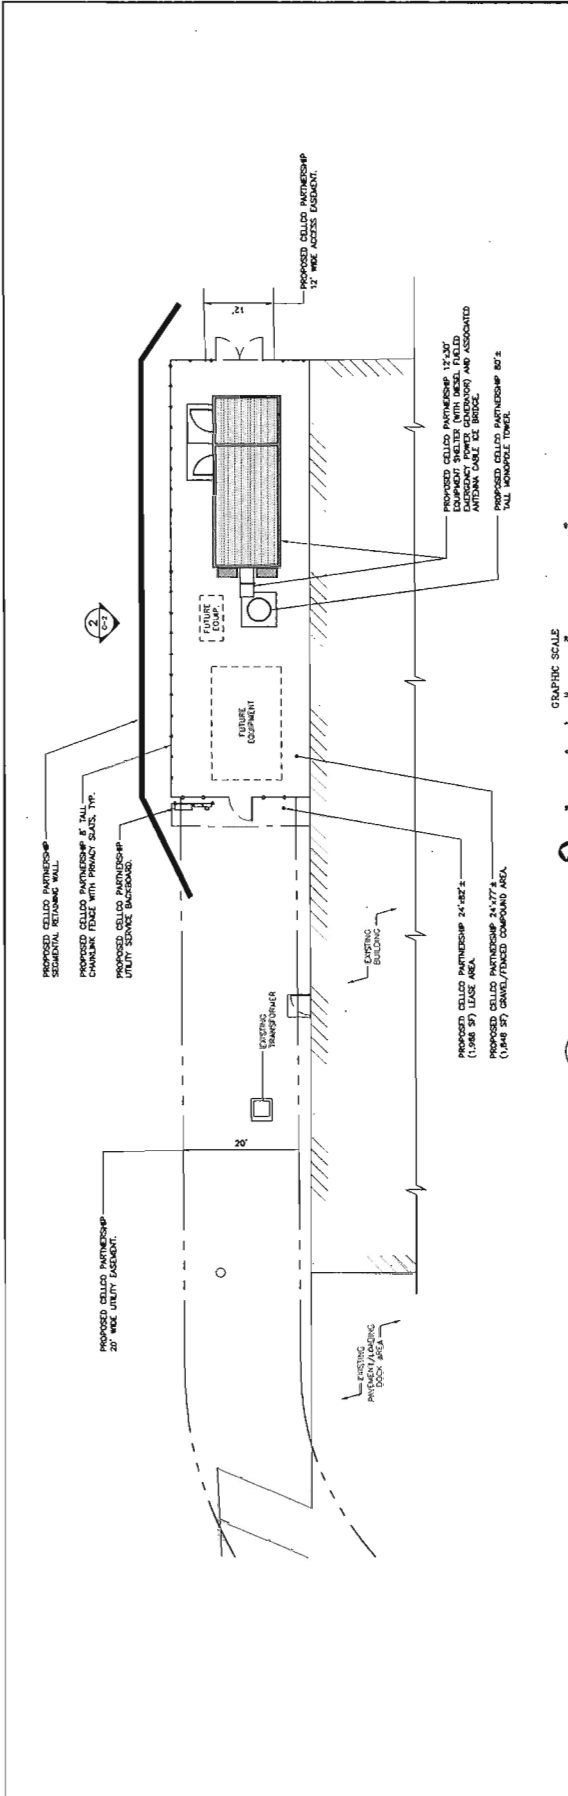

**1** COMPOUND PLAN  
 SCALE: 1" = 10'  
 GRAPHIC SCALE  
 1 inch = 10 ft.

**2** NORTH ELEVATION  
 SCALE: 1" = 10'  
 GRAPHIC SCALE  
 1 inch = 10 ft.

**3** ANTENNA MOUNTING CONFIGURATION  
 40' TO SCALE

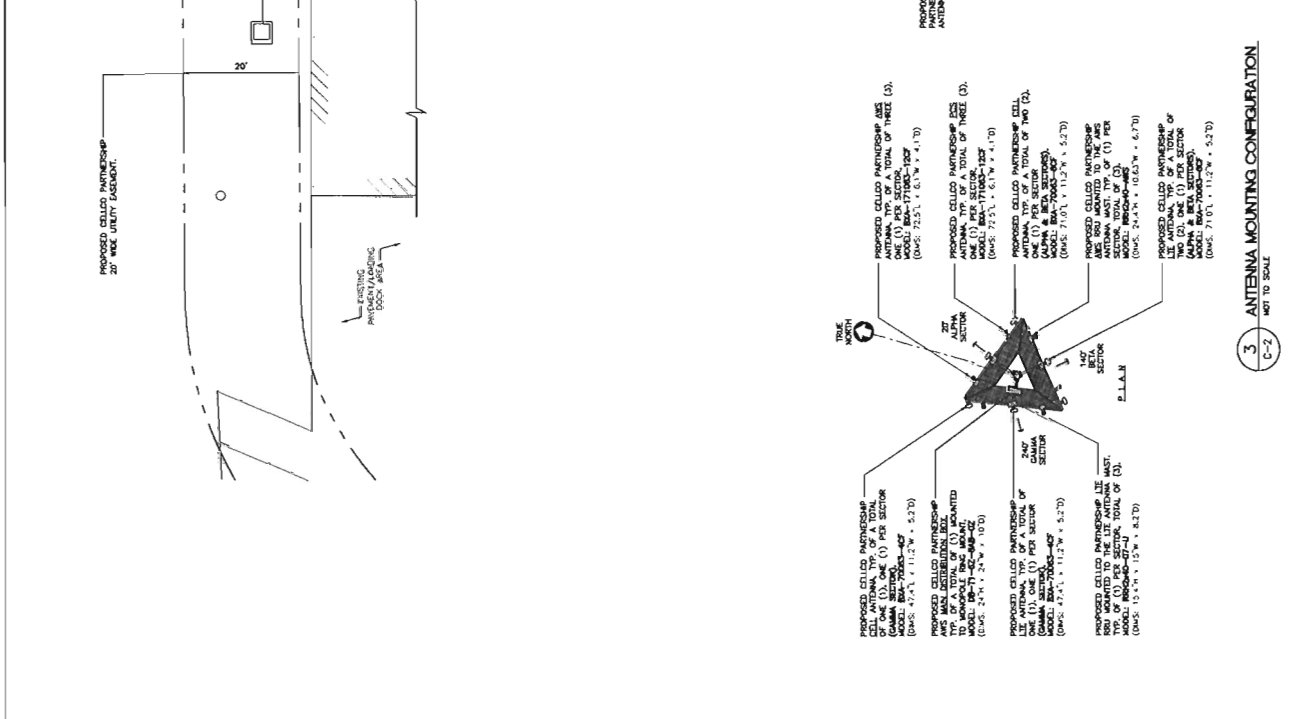

**1** PROPOSED CELLO PARTNERSHIP 50' x 10' FULL ADJUSTABLE TOWER  
 SCALE: 1" = 10'

**2** PROPOSED CELLO PARTNERSHIP 12'x30' EQUIPMENT RACKS  
 SCALE: 1" = 10'

**3** ANTENNA MOUNTING CONFIGURATION  
 40' TO SCALE

**GENERAL CONSTRUCTION / PRE-CONSTRUCTION NOTES**

1. PRIOR TO COMMENCEMENT OF ANY CONSTRUCTION ACTIVITIES, A MANDATORY ON-SITE PRE-CONSTRUCTION MEETING SHALL BE CONDUCTED WITH THE TOWN ENGINEER, THE TOWN SUPERVISOR, THE TOWN PLANNING DEPARTMENT, THE PROJECT DESIGNER AND SIMULATION CONTROL, CONSTRUCTION MONITOR AND THE ENGINEER OF RECORD.
2. THE CONSTRUCTION PROPERTY LINE ADJACENT TO THE PROPOSED ACCESS DRIVE IS SHOWN IN FIELD. THE CONSTRUCTOR SHALL BE RESPONSIBLE FOR OBTAINING THE CORRECT PROPERTY LINE AND THE PERIOD OF CONSTRUCTION ACTIVITIES SHALL BE CONFINED TO THE SUBJECT PROPERTY.

**GENERAL CONSTRUCTION SEQUENCE**

- THIS IS A GENERAL CONSTRUCTION SEQUENCE OUTLINE SOME ITEMS OF WHICH MAY NOT APPLY TO PARTICULAR SITES.
1. CUT AND STAMP AREAS OF PROPOSED CONSTRUCTION.
  2. INSTALL TEMPORARY SEDIMENT AND EROSION CONTROL MEASURES AS REQUIRED.
  3. REMOVE AND STOCKPILE TOPSOIL. STOCKPILE SHALL BE STORED TO PREVENT EROSION.
  4. CONSTRUCT CLOSED DRAINAGE SYSTEM, PRECEPT GLENNET BULBS AND CATCH BASINS WITH SEDIMENTATION BARBERS.
  5. CONSTRUCT ROADWAYS AND POSITION SITE GRADING, PLACING HAY BALES AND SILTATION FENCES AS REQUIRED TO CONTROL SOIL EROSION.
  6. INSTALL UNDERGROUND UTILITIES.
  7. BEGIN TEMPORARY AND PERMANENT STORMING AND WELDRING. ALL CUT AND FILL SLOPES SHALL BE SEEDED OR MULCHED IMMEDIATELY AFTER THEIR CONSTRUCTION. NO AREA SHALL BE LEFT UNPROTECTED FOR A TIME PERIOD OF MORE THAN 30 DAYS.
  8. DAZE OR AS REQUIRED, CONSTRUCT INSPECT AND IF NECESSARY, RECONSTRUCT TEMPORARY BERM, DRAIN, DITCHES, SILT FENCES AND SEDIMENT TRAPS INCLUDING WELDRING AND SEEDING.
  9. BEGIN DRAINAGE FOR AND CONSTRUCTION OF TOWERS AND PLATFORMS.
  10. FINISH PAVING ALL ROADWAYS, DRIVEWAYS AND PARKING AREAS.
  11. COMPLETE PERMANENT SEEDING AND LANDSCAPING.
  12. NO FILL SHALL BE DEPOSITED TO ANY RETAINERS UNTIL A HEALTHY STAND OF GRASS HAS BEEN ESTABLISHED IN REPOSED AREAS.
  13. AFTER GRASS HAS BEEN FULLY DEVELOPED IN ALL SEEDING AREAS, REMOVE ALL TEMPORARY EROSION CONTROL MEASURES.

**SOIL EROSION AND SEDIMENT CONTROL SEQUENCE**


1. ALL SOIL EROSION AND SEDIMENT CONTROL MEASURES, SUCH AS CONSTRUCTION ENTRANCE / EXIT TRACKING PAD, SILTATION FENCE AND SILTATION FENCE / HAY BALE SHALL BE IN PLACE PRIOR TO ANY GRADING ACTIVITY. CONSTRUCTION SHALL BE COMPLETED AND/OR WORK SHALL BE STABILIZED.
2. THE ENTRANCE TO THE PROJECT SITE IS TO BE PROTECTED BY STONE AND TRACKING PAD OF ASTM C-33, SIZE NO. 2, OR 3, OR D.O.T. 7, CRUSHED GRAVEL. THE STONE AND TRACKING PAD IS TO BE MAINTAINED AT ALL TIMES DURING THE CONSTRUCTION PERIOD.
3. THE 2' OR 3' OR D.O.T. 7, CRUSHED GRAVEL SHALL BE MAINTAINED BY STONE AND TRACKING PADS OF ASTA C-33, SIZE NO. 2, OR 3, OR D.O.T. 7, CRUSHED GRAVEL. THE STONE AND TRACKING PAD IS TO BE MAINTAINED AT ALL TIMES DURING THE CONSTRUCTION PERIOD.
4. LAND DISTURBANCE WILL BE KEPT TO A MINIMUM AND RESTORATION WILL BE SCHEDULED AS SOON AS PRACTICAL.
5. ALL SOIL EROSION AND SEDIMENT CONTROL MEASURES SHALL BE DONE AS SETBACK COMMENSURATE WITH THE CONSTRUCTION SCHEDULES FOR EROSION AND SEDIMENT CONTROL INCLUDING THE LATEST DATE FROM THE GENERAL, ON-SITE AND WATER CONSERVATION.
6. ANY ADDITIONAL EROSION/SEDIMENTATION CONTROL MEASURES NECESSARY BY TOWN STAFF DURING CONSTRUCTION, SHALL BE INSTALLED IMMEDIATELY. ALL EROSION CONTROL MEASURES UNTIL ALL DISTURBED AREAS ARE STABILIZED TO THE SATISFACTION OF THE TOWN STAFF.
7. IN ALL AREAS, REMOVAL OF TREES, BUSHES AND OTHER VEGETATION AS WELL AS DISTURBANCE OF THE SOIL IS TO BE MINIMIZED. ANY REMOVAL OF VEGETATION SHALL BE REPLACED AS SOON AS POSSIBLE FOR AS SHORT A TIME AS POSSIBLE.
8. SILTATION FENCE SHALL BE PLACED AS INDICATED BEFORE A CUT SLOPE HAS BEEN CREATED. SEDIMENT DEPOSITS SHALL BE REMOVED IMMEDIATELY. SLOPES SHALL BE PROTECTED BY SILTATION FENCE AND TRACKING PADS. TRACKING PADS AND SILTATION FENCES SHALL BE MAINTAINED AT ALL TIMES DURING CONSTRUCTION. TRACKING PADS SHALL BE MAINTAINED AT ALL TIMES DURING CONSTRUCTION. TRACKING PADS SHALL BE MAINTAINED AT ALL TIMES DURING CONSTRUCTION. TRACKING PADS SHALL BE MAINTAINED AT ALL TIMES DURING CONSTRUCTION.
9. SMALL DISCHARGE AREA WILL BE PROTECTED WITH RMP SPLASH PAD/ ENERGY DISSIPATER.
10. ALL FILL AREAS SHALL BE COMPACTED SUFFICIENTLY FOR THEIR INTENDED PURPOSE AND AS REQUIRED TO REDUCE SLIPPING, EROSION OR EXCESS SATURATION.
11. THE SOIL SHALL NOT BE PLACED WHILE IN A PROVED OR MOIST CONDITION WHEN THE SUBGRADE IS EXCESSIVELY MOIST. A COMPACTOR THAT WILL OPERATE IN DRY CONDITION IS PREFERRED TO PREVENT SOILING OR PROPOSED SEEDING OR SEEDING.
12. AFTER CONSTRUCTION IS COMPLETE AND GROUND IS STABLE, REMOVE SLEETS IN THE RMP RMP ENERGY DISSIPATERS, REMOVE OTHER EROSION AND SEDIMENT DEVICES.

**CONSTRUCTION SPECIFICATIONS - SILT FENCE**

1. THE EXISTING FABRIC SHALL MEET THE DESIGN CRITERIA FOR SILT FENCES.
2. THE FABRIC SHALL BE EMBEDDED A MINIMUM OF 8 INCHES INTO THE GROUND AND THE SOIL COMPACTED OVER THE FABRIC.
3. WOODEN WIRE FENCE SHALL BE FASTENED SECURELY TO THE FENCE POSTS WITH WIRE TIES OR STAPLES.
4. THE TOP, MID-SECTION AND BOTTOM SECTION TO THE WOODEN WIRE FENCE WITH TIES SPACED EVERY 24 INCHES AT 4 INCHES.
5. WHEN TWO SECTIONS OF FILTER CLOTH ADJOIN EACH OTHER, THEY SHALL BE OVERLAPPED BY 6 INCHES, TOLDED, AND STAPLED.
6. FENCE POSTS SHALL BE A MINIMUM OF 36 INCHES LONG AND ORDER A MINIMUM OF 16 INCHES INTO THE GROUND. FENCE POSTS SHALL BE OF SOUND QUALITY HARDWOOD AND SHALL HAVE A MINIMUM CROSS SECTIONAL AREA OF 3.0 SQUARE INCHES.
7. MAINTENANCE SHALL BE PERFORMED AS NEEDED TO PREVENT BUILD UP IN THE SILT FENCE DUE TO DEPOSITION OF SEDIMENT.


**MAINTENANCE - SILT FENCE**

1. SILT FENCES SHALL BE INSPECTED IMMEDIATELY AFTER EACH BARREL AND AT LEAST DAILY DURING PROLONGED RAINFALL. ANY REPAIRS THAT ARE REQUIRED SHALL BE MADE IMMEDIATELY.
2. IF THE FABRIC ON A SILT FENCE SHOULD DECOMPOSE OR BECOME INEFFECTIVE DURING THE EXPECTED LIFE OF THE FENCE, THE FABRIC SHALL BE REPLACED IMMEDIATELY.
3. SEDIMENT DEPOSITS SHALL BE REMOVED IMMEDIATELY. BEFORE THE DEPOSITS SHOULD BE REMOVED WHEN THEY REACHED APPROXIMATELY ONE-HALF THE HEIGHT OF THE BARREL.
4. SEDIMENT DEPOSITS THAT ARE ROOVED OR LEFT IN PLACE AFTER THE FABRIC HAS BEEN REMOVED SHALL BE GRADED TO CONFORM WITH THE EXISTING TEMPORARY AND VEGETATED.

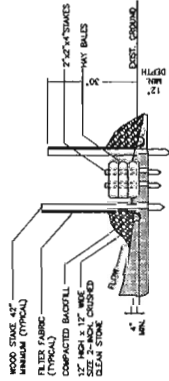


**SILTATION FENCE/HAY BALE SILTATION FENCE SANDWICH EROSION CONTROL**  
NOT TO SCALE

|   |  |  |  |
|---|--|--|--|
|   |  | City of Verona<br>Planning Department<br>1000 Verona Drive<br>Verona, NJ 07093<br>908-231-1234 |  |
| PROJECT: TRUMBULL SE 4<br>SHEET: 01/20/14 |  | CLIENT: Colco Partnership d/b/a Verizon Wireless<br>PROJECT NO.: 15209-000                     |  |
| DATE: 01/20/14<br>SCALE: AS SHOWN         |  | SITE CONSTRUCTION<br>EROSION CONTROL<br>NOTES & DETAILS  |  |

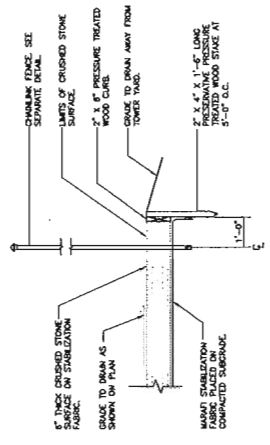


**2 COMPOUND SURFACING DETAIL**  
 C-4 NOT TO SCALE


- WOVEN WIRE FENCE NOTES**
1. GATE POST, CORNER, TERMINAL OR PALL POST 2. 1/2" SCHEDULE 40 TUB. SCHEDULE 40 TUB. GATE UP 18" OR 12 FEET FOR DOUBLE SWING GATE PER ASTM-F1003.
  2. LIKE POST: 2" SCHEDULE 40 PIPE PER ASTM-F1003.
  3. GATE FRAME: 1 1/2" SCHEDULE 40 PIPE PER ASTM-F1003.
  4. TOP RAIL & BRACE RAIL: 1 1/2" SCHEDULE 40 PIPE PER ASTM-F1003.
  5. HANGERS: 12 GA. COIL WIRE SIZE 2" WIDE, CONFORMING TO ASTM-A302.
  6. HANGERS TO AND AT TOWERS: MADE BY 180° BRASS SPUN WIRE 24" DIA. GALV. STEEL.
  7. TOWERS: WIRE: 2 GA. GALVANIZED STEEL.
  8. GATE LATCH: DROP DOWN LOCKABLE FORK LATCH AND LOCK. HOOKED ALIKE FOR ALL SITES IN A GIVEN AREA.
  9. COMPOUND FENCE BEZEL: 8" VERTICAL.
  10. WIRE: PLYMETH PLASTIC TO BE INSTALLED ON ALL FENCE AND GATE SECTIONS. COLOR: GREEN.

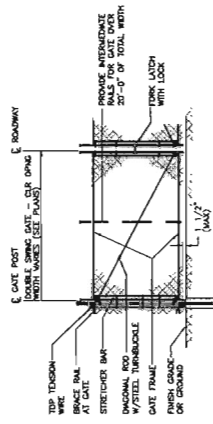


**1A WOVEN WIRE SWING GATE-DOUBLE**  
 C-4 NOT TO SCALE

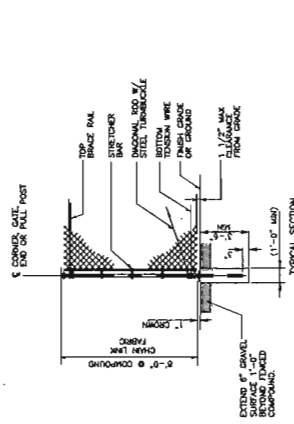

**1 WOVEN WIRE FENCE DETAIL**  
 C-4 NOT TO SCALE

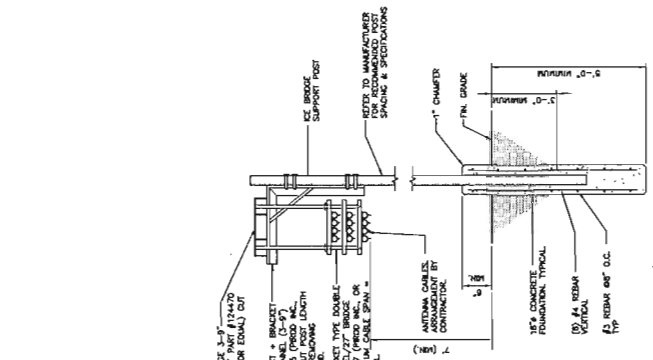


**4 ICE BRIDGE DETAIL**  
 C-4 NOT TO SCALE

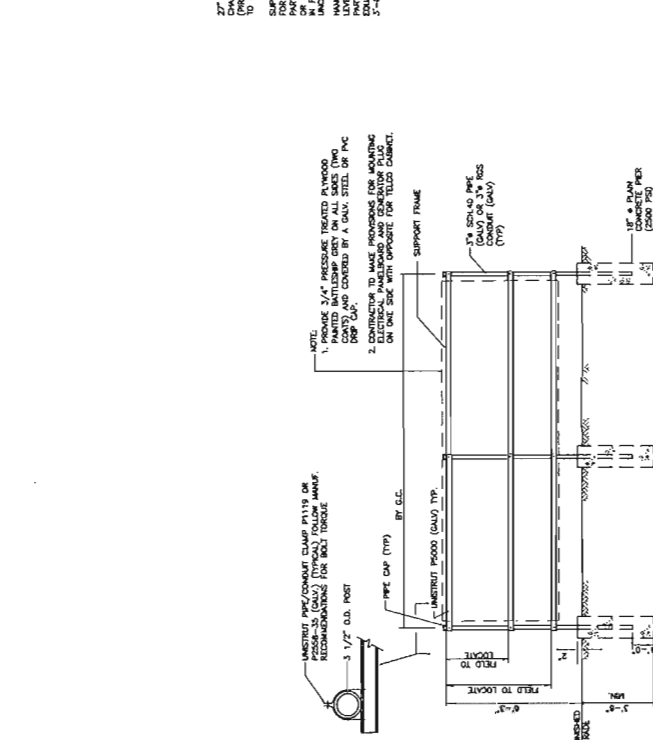


**5 UTILITY SUPPORT FRAME (TYP)**  
 C-4 NOT TO SCALE

- MODULAR RETAINING WALL NOTES**
1. STRIP VEGETATION AND ORGANIC SOIL FROM WALL AND GEOSYNTHETIC ALIGNMENT.
  2. BENCH OUT ALL EXCAVATED SLOPES.
  3. DO NOT OVER EXCAVATE UNLESS DIRECTED BY SITE SOIL ENGINEER TO REMOVE UNSATURABLE SOIL.
  4. EXCAVATION SHALL BE PROTECTED BY SHIELDING OR PROTECTIVE SOILS AS BEING COMPATIBLE FOR THE DESIGN STANDARD AND PARAMETERS.
  5. BASE SHALL CONSIST OF COMPACTED GRANULAR FILL, 6" THICK MIN.
  6. CONTRACTOR MAY OPT FOR A LEAN CONCRETE FND. CONCRETE FND SHALL BE UNREINFORCED, 4" MINIMUM THICKNESS.
  7. MINIMUM LAYERMENT OF WALL BELOW FINISH GRADE SHALL BE 2 COURSES OF BLOCK.
  8. FOLLOW APPLICABLE PROVISIONS OF THE MANUFACTURER'S INSTALLATION INSTRUCTIONS AND WRITTEN DETAILS.
  9. WALL CRUSHED STONE SHALL BE INSTALLED BEHIND THE WALL UP TO 18" FROM THE TOP OF THE WALL.
  10. CRUSHED STONE SHALL NOT EXTEND BELOW FINISHED GRADE IN FRONT OF WALL.
  11. BEHIND WALLS IS COMPACTED. CONTACT FILL IN FRONT OF UNITS AT THE SAME TIME BACKFILL.
  12. COMPACTOR TESTS SHALL BE TAKEN AS THE WALL IS INSTALLED. THE MINIMUM NUMBER OF TESTS SHALL BE 1 PER 1000 SQ. FT. OF WALL AREA.
  13. COMPACTOR SHALL BE TO 80% OF MAXIMUM STANDARD PROCTOR DENSITY (ASTM D-1585).
  14. SEE SHOP DRAWINGS FOR GEOSYNTHETIC TYPE, LENGTH AND LENGTH AS SHOWN ON SHOP DRAWINGS. PALL GEOSYNTHETIC SHALL BE 2' WIDE AND 12" HIGH.
  15. GEOSYNTHETIC SHALL BE PLACED WITH STRONGEST DIRECTION PERPENDICULAR TO WALL. FOLLOW MANUFACTURER'S INSTALLATION INSTRUCTIONS AND WRITTEN DETAILS.
  16. GEOSYNTHETIC SHALL BE PLACED WITH STRONGEST DIRECTION PERPENDICULAR TO WALL. FOLLOW MANUFACTURER'S INSTALLATION INSTRUCTIONS AND WRITTEN DETAILS.
  17. GEOSYNTHETIC SHALL BE PLACED WITH STRONGEST DIRECTION PERPENDICULAR TO WALL. FOLLOW MANUFACTURER'S INSTALLATION INSTRUCTIONS AND WRITTEN DETAILS.
  18. CONTRACTOR MUST CONTACT ENGINEER PRIOR TO PROCEEDING WITH THE CONSTRUCTION OF THE EXCAVATION TO DETERMINE IF SOIL IS SATURATED.
  19. IF WALL LANDING AND REQUIRES FILL IT SHALL BE COMPACTED GRANULAR FILL FROM BOTTOM OF EXCAVATION TO SUITABLE SOIL TO BOTTOM OF WALL.





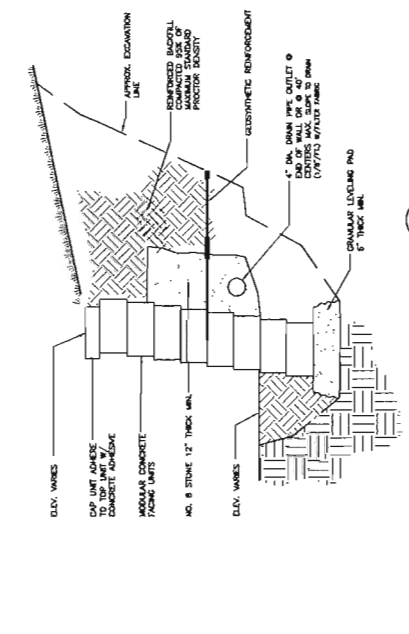


**3 SEGMENTAL RETAINING WALL DETAIL**  
 C-4 NOT TO SCALE



|   |          |  |          |   |  |
|---|----------|--|----------|---|--|
|  |          | CENTEK Engineering<br>10211 4th Street<br>Denver, CO 80231<br>303.440.4848 Fax<br>303.440.4848<br>433 North Lincoln Road<br>Denver, CO 80202<br>www.Centek.com |          | Colco Partnership d/b/a Verizon Wireless<br>WIRELESS COMMUNICATIONS FACILITY<br><b>TRUMBULL SE 4</b><br>90 COMMERCE DRIVE<br>TRUMBULL, CT 06611 |  |
| DATE  | 07/26/14 | SCALE  | AS NOTED | SITE DETAILS AND SHELTER ELEVATIONS<br><b>C-5</b><br>Sheet No. 2 of 8   |  |
| NO.   | 000      | NO.  | 13000000 |   |  |

| REV. | DATE     | BY  | CHKD BY | DESCRIPTION               |
|------|----------|-----|---------|---------------------------|
| 8    | 07/17/14 | MMB | MMB     | REVISED FOR CLIENT REVIEW |
| 7    | 07/17/14 | MMB | MMB     |                           |
| 6    | 07/17/14 | MMB | MMB     |                           |
| 5    | 07/17/14 | MMB | MMB     |                           |
| 4    | 07/17/14 | MMB | MMB     |                           |
| 3    | 07/17/14 | MMB | MMB     |                           |
| 2    | 07/17/14 | MMB | MMB     |                           |
| 1    | 07/17/14 | MMB | MMB     |                           |

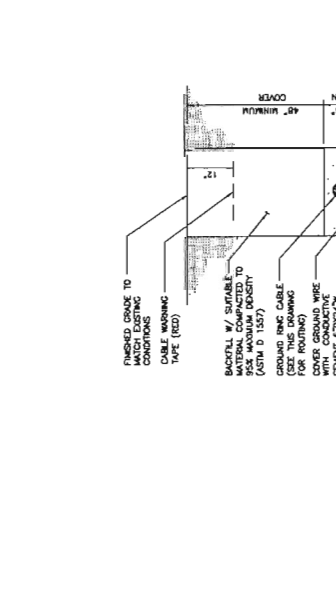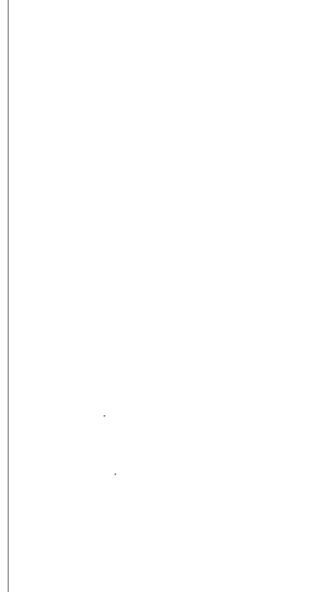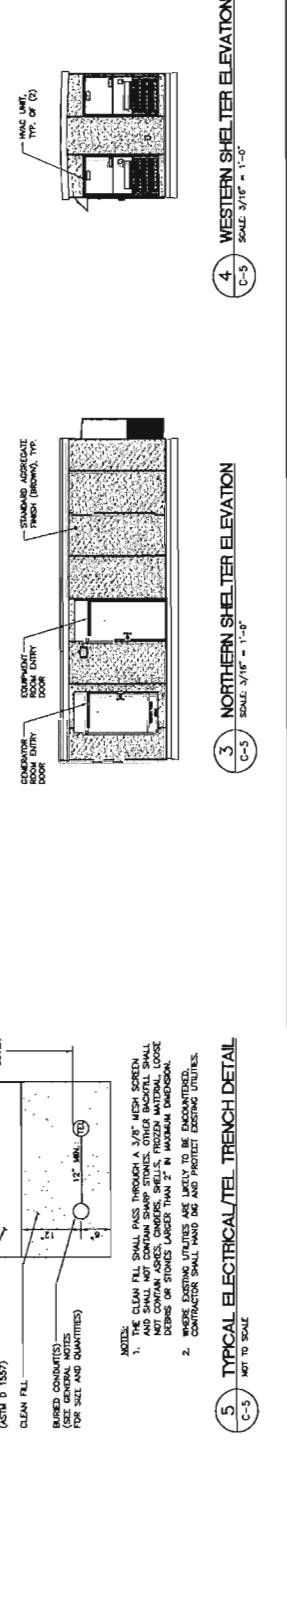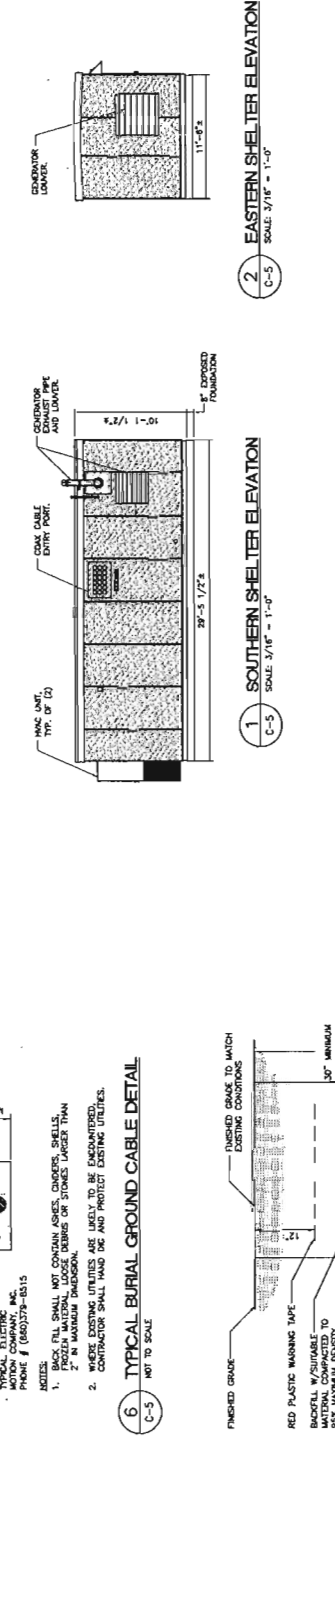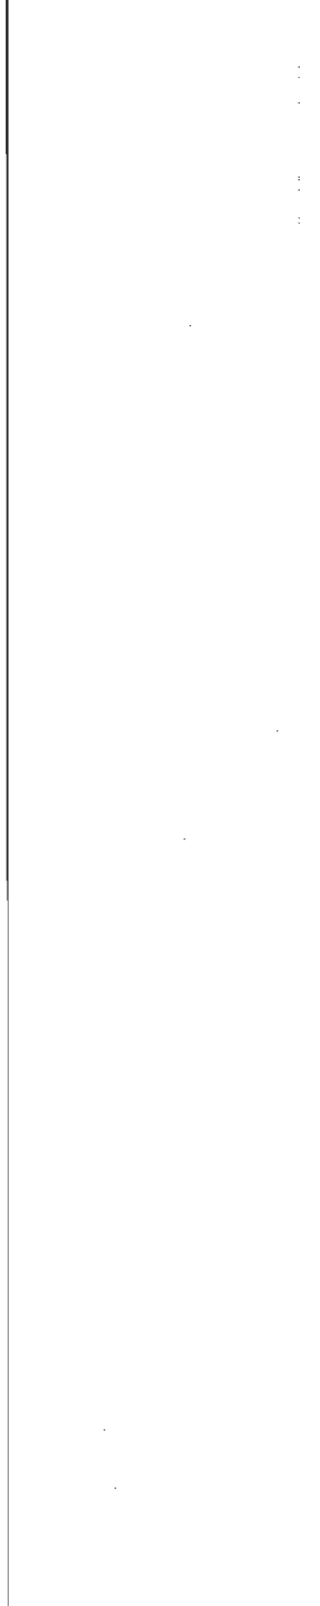

**NOTES:**

- THE CLEAN FILL SHALL PASS THROUGH A 3/8" MESH SCREEN. ALL MATERIALS SHALL BE FREE OF ROCKS, LIMBS, AND OTHER DEBRIS OR STONES LARGER THAN 2" IN MAXIMUM DIMENSION.
- WHERE EXISTING UTILITIES ARE LIKELY TO BE ENCOUNTERED, CONTRACTOR SHALL HAND DIG AND PROTECT EXISTING UTILITIES.

**REVISIONS:**

1. FRESH FILL SHALL NOT CONTAIN ASPES, CHOKES, SHELLS, FROZEN MATERIAL, LOOSE DEBRIS OR STONES LARGER THAN 2" IN MAXIMUM DIMENSION.

2. CONTRACTOR SHALL HAND DIG AND PROTECT EXISTING UTILITIES.

**REVISIONS:**

1. FRESH FILL SHALL NOT CONTAIN ASPES, CHOKES, SHELLS, FROZEN MATERIAL, LOOSE DEBRIS OR STONES LARGER THAN 2" IN MAXIMUM DIMENSION.



2. CONTRACTOR SHALL HAND DIG AND PROTECT EXISTING UTILITIES.

**FOUNDATION NOTES**

- IF ANY FIELD CONDITIONS EXIST WHICH PRECLUDE COMPLIANCE WITH THE DRAWINGS, THE CONTRACTOR SHALL IMMEDIATELY NOTIFY THE ENGINEER AND SHALL NOT PROCEED WITH ANY AFFLICTED WORK.
- CONTRACTOR SHALL VERIFY ALL DIMENSIONS AND LOCATIONS WITH THE MANUFACTURED EQUIPMENT BUILDING SHOP DRAWINGS.
- THE CONTRACTOR SHALL VERIFY AND DOCUMENT THE SIZE AND LOCATION OF ALL OPENINGS, SLEEVES AND ANCHOR BOLTS AS REQUIRED BY ALL NOTES.
- REFER TO DRAWING T1 FOR ADDITIONAL NOTES AND REQUIREMENTS.

**SITE NOTES**

- THE CONTRACTOR SHALL CALL UTILITIES PRIOR TO THE START OF CONSTRUCTION.
- ACTIVE EXISTING UTILITIES, WHERE ENCOUNTERED IN THE WORK, SHALL BE PROTECTED BY THE CONTRACTOR. ANY UTILITIES THAT ARE NOT IDENTIFIED BY THE MANUFACTURED EQUIPMENT BUILDING SHOP DRAWINGS SHALL BE PROTECTED BY THE CONTRACTOR. ANY UNIDENTIFIED UTILITIES PREVIOUS TO THE START OF CONSTRUCTION SHALL BE IDENTIFIED BY THE CONTRACTOR. ANY UNIDENTIFIED UTILITIES SHALL BE PROTECTED BY THE CONTRACTOR. ANY UNIDENTIFIED UTILITIES SHALL BE PROTECTED BY THE CONTRACTOR.
- ALL EXISTING FOUNDATIONS, DRIVEWAYS, STOPS, STAKES AND OTHER SURVEY SHALL BE RECONSTRUCTED AND SHALL BE IDENTIFIED BY THE CONTRACTOR. ANY UNIDENTIFIED UTILITIES SHALL BE PROTECTED BY THE CONTRACTOR.
- PROTECT ALL EXISTING UTILITIES AND SURVEY MARKS FROM DAMAGE. ANY DAMAGE TO EXISTING UTILITIES SHALL BE RECONSTRUCTED AND SHALL BE IDENTIFIED BY THE CONTRACTOR.
- NO FILL OR DEMONSTRATION MATERIAL SHALL BE PLACED ON EXISTING DRIVEWAYS, FROZEN MATERIALS, SHALL OR XE SHALL NOT BE PLACED IN ANY FILL OR DEMONSTRATION.
- WHEREVER GRADE PROX TO FINISHED SURFACE APPLICATION, THE CONTRACTOR SHALL VERIFY AND DOCUMENT THE SIZE AND LOCATION OF ALL OPENINGS, SLEEVES AND ANCHOR BOLTS AS REQUIRED BY ALL NOTES.
- THE AREAS OF THE COMPANIES IDENTIFIED BY THE WORK SHALL BE RETURNED TO THEIR ORIGINAL CONDITION.
- CONTRACTOR SHALL MAINTAIN ACCESS TO EXISTING SITE DURING CONSTRUCTION. ANY OBSTRUCTIONS TO EXISTING ACCESS SHALL BE REMOVED OR BYPASSED WITH THE LOCAL JURISDICTION FOR EXCESS AND SEMI-CONTROL.
- IF ANY FIELD CONDITIONS EXIST WHICH PRECLUDE COMPLIANCE WITH THE DRAWINGS, THE CONTRACTOR SHALL IMMEDIATELY NOTIFY THE ENGINEER AND SHALL NOT PROCEED WITH ANY AFFLICTED WORK.
- CONTRACTOR SHALL VERIFY AND DOCUMENT THE SIZE AND LOCATION OF ALL OPENINGS, SLEEVES AND ANCHOR BOLTS AS REQUIRED BY ALL NOTES.
- MANUFACTURED EQUIPMENT BUILDING SHOP DRAWINGS.
- CONTRACTOR SHALL VERIFY AND DOCUMENT THE SIZE AND LOCATION OF ALL OPENINGS, SLEEVES AND ANCHOR BOLTS AS REQUIRED BY ALL NOTES.

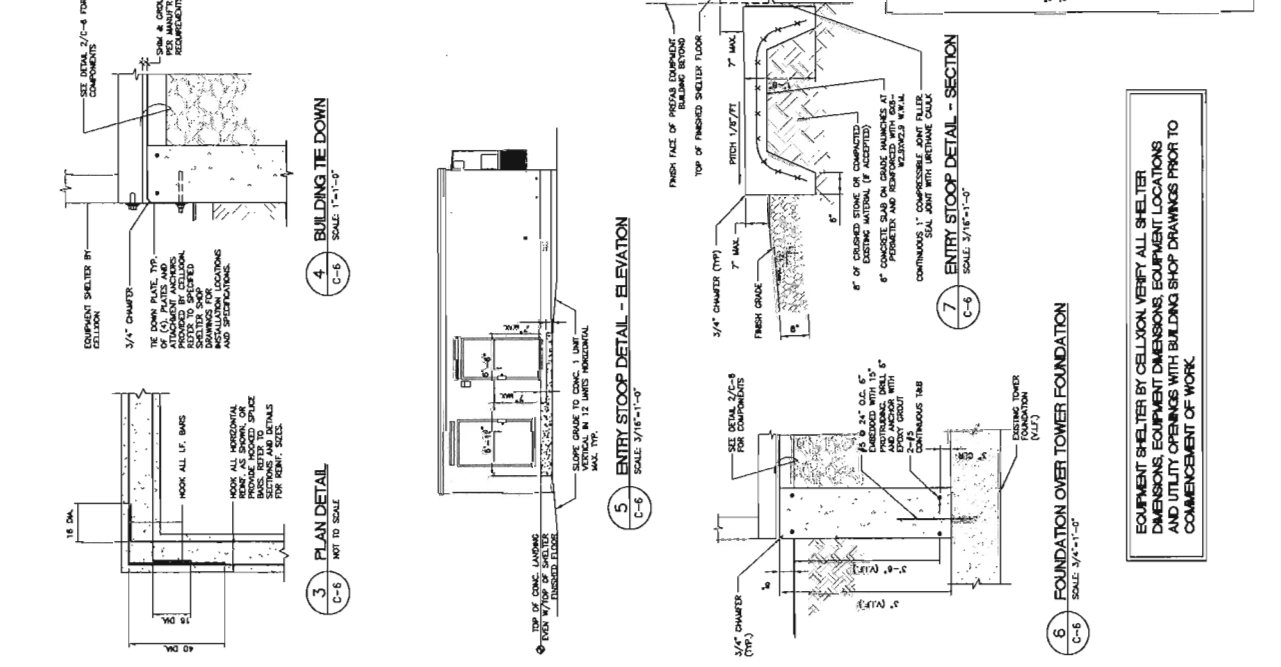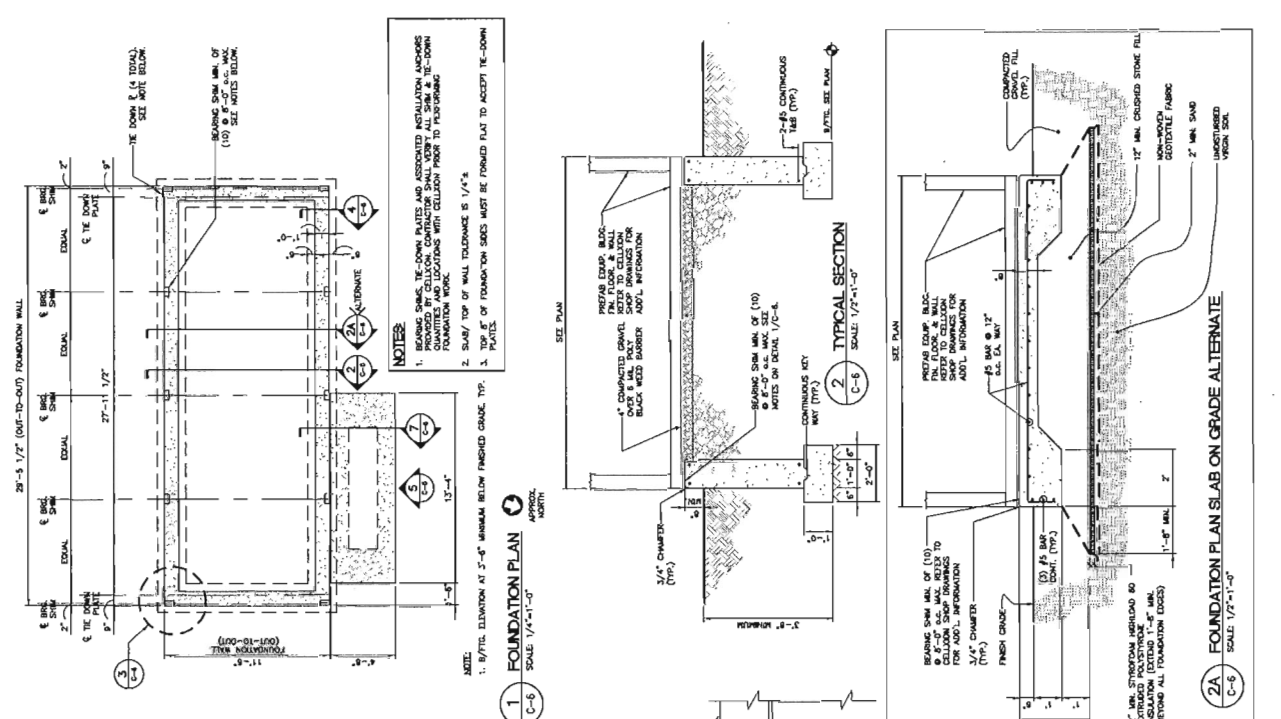

EQUIPMENT SHELTER BY CELLULON VERIFY ALL SHELTER DIMENSIONS, EQUIPMENT LOCATIONS AND UTILITY OPENINGS WITH BUILDING SHOP DRAWINGS PRIOR TO COMMENCEMENT OF WORK.

**ADJACENT PROPERTY OWNERS**

SITE NAME: TRUMBULL SE 4

OWNER NAME: PILOT CORP OF AMERICA

OWNER ADDRESS: 60 COMMERCE DRIVE, TRUMBULL, CONNECTICUT

ASSESSOR'S REFERENCE: MAP: K09 LOT: 00020

THE FOLLOWING INFORMATION WAS COLLECTED FROM THE TAX ASSESSOR'S RECORDS AND LAND RECORDS OF TRUMBULL TOWN HALL. THE INFORMATION IS CURRENT AS OF FEBRUARY 12, 2014.

THE PARCEL IS ZONED I-L3 INDUSTRIAL.


|    | <u>Map/Lot</u> | <u>Property Address</u> | <u>Property Owner</u>   |
|----|----------------|-------------------------|---|
| 1. | K09/424        | 2735 Huntington Road    | Estate of Marion Kulikowski<br>c/o Kathleen J. McGrath, Co-Administrator<br>2740 Huntington Turnpike<br>Stratford, CT 06614 |
| 2. | K09/37         | 55 Merritt Boulevard    | Belmar Corp.<br>Cheeseborough Pond's USA<br>c/o Tracy Albrand<br>75 Merritt Boulevard<br>Trumbull, CT 06611                 |
| 3. | K09/21         | 50 Commerce Drive       | Consumer Products II LLC<br>30 Jelliff Lane<br>Southport, CT 06890  |
| 4. | K09/19         | 45 Commerce Drive       | Consumer Products I LLC<br>30 Jelliff Lane<br>Southport, CT 06890   |
| 5. | K08/70         | 2975 Huntington Road    | Muriel B. Bowen<br>2975 Huntington Road<br>Trumbull, CT 06611   |
| 6. | K08/69         | 2955 Huntington Road    | Paul Ouimette and Kellie A. Ryan<br>Ouimette<br>2955 Huntington Road<br>Trumbull, CT 06611                                  |

|     | <u>Map/Lot</u> | <u>Property Address</u> | <u>Property Owner</u>  |
|-----|----------------|-------------------------|--|
| 7.  | K08/68         | 2945 Huntington Road    | Carol Donegan Thomas<br>2945 Huntington Road<br>Trumbull, CT 06611                       |
| 8.  | K08/36         | 2935 Huntington Road    | Richard Dion and Lucille S. Sutton<br>2935 Huntington Road<br>Trumbull, CT 06611         |
| 9.  | K08/35         | 2925 Huntington Road    | Margaret Capozziello<br>2925 Huntington Road<br>Trumbull, CT 06611                       |
| 10. | K08/34         | 2891 Huntington Road    | Michele Jenco Gnandt<br>2891 Huntington Road<br>Trumbull, CT 06611                       |
| 11. | K08/33         | 2861 Huntington Road    | Janet M. Hine and S. Scott J. Everetts Lee<br>2861 Huntington Road<br>Trumbull, CT 06611 |
| 12. | K09/32         | 2821 Huntington Road    | Mark A. and Kristen A. Rubush<br>2821 Huntington Road<br>Trumbull, CT 06611              |
| 13. | K09/31         | 2791 Huntington Road    | Marianne and James A. Chedister, Jr.<br>2791 Huntington Road<br>Trumbull, CT 06611       |
| 14. | K09/30         | 2771 Huntington Road    | Anis Zaman<br>2771 Huntington Road<br>Trumbull, CT 06611                                 |
| 15. | K09/29         | 2741 Huntington Road    | Wilson J. and Marion J. Bernhardt<br>2741 Huntington Road<br>Trumbull, CT 06611          |

**CERTIFICATION OF SERVICE**

I hereby certify that a copy of the foregoing letter was sent by certified mail, return receipt requested, to each of the parties on the attached list of abutting landowners.

2-20-14  
Date

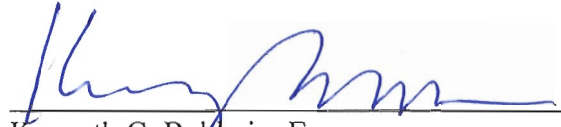  
Kenneth C. Baldwin, Esq.  
Robinson & Cole LLP  
280 Trumbull Street  
Hartford, CT 06103

Attorneys for CELLCO PARTNERSHIP d/b/a  
VERIZON WIRELESS

