

WATERTOWN WEST - SITE B

**Old Baird Road
Watertown, Connecticut**

Description of Proposed Cell Site

Cellco Partnership d/b/a Verizon Wireless
99 East River Drive
East Hartford, CT 06108

TABLE OF CONTENTS

<u>SECTION</u>	<u>PAGE</u>
GENERAL CELL SITE DESCRIPTION	1
U.S.G.S. TOPOGRAPHIC MAP.....	2
AERIAL PHOTOGRAPH	3
SITE EVALUATION REPORT	4
FACILITIES AND EQUIPMENT SPECIFICATION.....	6
ENVIRONMENTAL ASSESSMENT STATEMENT.....	7
PROJECT PLANS.....	9

SITE NAME: WATERTOWN WEST (SITE B) – Old Baird Road, Watertown, CT

GENERAL CELL SITE DESCRIPTION

The proposed Site B cell site would be located within an approximately 13.7 acre parcel on the west side of Old Baird Road approximately 1,200 feet northwest of Hamilton Avenue (the “Site B Property”). The Site B Property is owned by the Town of Watertown. The Site B facility would consist of a 160-foot telecommunications tower. Cellco antennas would be mounted at the top of the tower with their centerline at the 150 foot level. The top of Cellco’s antennas will extend approximately three feet above the top of the tower to an overall height of 153 feet. Cellco’s radio equipment and a propane-fueled back-up generator will be located inside a 12’ x 30’ equipment shelter located near the base of the tower. A 1,000-gallon propane tank will be placed in the northeast corner of the fenced compound. Vehicle access to the site would extend from Old Baird Road along an existing driveway to the Town’s Animal Shelter a distance of approximately 460 feet, then along a new gravel driveway, an additional distance of approximately 290 feet. Utility service would extend from existing service along Old Baird Road.



1,000 500 0 1,000
Feet

Vanasse Hangen Brustlin, Inc.


USGS Topographic Map
Proposed Verizon Wireless
Telecommunications Facility

Two Proposed Verizon Wireless
Candidate Site Locations:
Site A and Site B
Old Baird Road
Watertown, Connecticut



Quadrangle Location

* Note: Site A and Site B are located approximately 400 feet apart

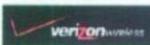



Quadrangle Location

250 125 0 250
Feet

* Note: Site A and Site B are located approximately 400 feet apart

Vanasse Hangen Brustlin, Inc.

USGS Topographic Map
Proposed Verizon Wireless
Telecommunications Facility

Two Proposed Verizon Wireless
Candidate Site Locations:
Site A and Site B
Old Baird Road
Watertown, Connecticut



SITE EVALUATION REPORT

SITE NAME: WATERTOWN WEST (SITE B) – Old Baird Road, Watertown, CT

I. LOCATION

- A. COORDINATES:
- B. GROUND ELEVATION: Approximately 759± feet AMSL
- C. USGS MAP: Woodbury, CT
- D. SITE ADDRESS: Old Baird Road, Watertown, CT
- E. ZONING WITHIN 1/4 MILE OF SITE: Land within 1/4 mile of the cell site is zoned R-70 Residential.

II. DESCRIPTION

- A. SITE SIZE: 13.7 Acre Parcel; 3,000 S.F. Compound Area
- B. LESSOR'S PARCEL: Approximately 0.24 -acres
- C. TOWER TYPE/HEIGHT: 150' Monopole Tower
153' to top of PCS antennas
- D. SITE TOPOGRAPHY AND SURFACE: The topography in the area is generally sloping down from west to east. Clearing and grading of the compound area and access driveway will be required.
- E. SURROUNDING TERRAIN, VEGETATION, WETLANDS, OR WATER: The tower is located in a heavily-wooded portion of the Town parcel. The terrain generally slopes down to the east and south. No wetland areas exist within or near the site compound or the access driveway. The closest wetland or watercourse is located approximately 150 feet northeast of the Site B Facility compound.
- F. LAND USE WITHIN 1/4 MILE OF SITE: The Site B Facility is surrounded by undeveloped residential properties north and east, residential/agricultural uses to the west and the Town's Highway Department Maintenance facility, Solid Waste Transfer Station and Animal Shelter to the south.

III. FACILITIES

- A. POWER COMPANY: Connecticut Light and Power

- B. POWER PROXIMITY TO SITE: Approximately 300 feet to the south.
- C. TELEPHONE COMPANY: AT&T
- D. PHONE SERVICE PROXIMITY: Same as power
- E. VEHICLE ACCESS TO SITE: Vehicle access to the site would extend from Old Baird Road over an existing gravel driveway, a distance of approximately 460 feet, then over a new 12-foot wide gravel driveway to the site compound an additional 290 feet to the site compound.
- F. CLEARING AND FILL REQUIRED: Clearing and grading would be required for construction of the Site B tower, site compound and new access drive. Detailed construction plans would be developed after approval of the site by the Siting Council.

IV. LEGAL

- A. PURCHASE [] LEASE [X]
- B. OWNER: Town of Watertown
- C. ADDRESS: Old Baird Road, Watertown, CT 06795
- D. DEED ON FILE AT: Town of Watertown, CT Land Records

Vol. 1534 Page 89

FACILITIES AND EQUIPMENT SPECIFICATION (NEW TOWER & EQUIPMENT BUILDING)

SITE NAME: WATERTOWN WEST (SITE B) – Old Baird Road, Watertown, CT

I. TOWER SPECIFICATIONS:

II. TOWER LOADING:

A. CELLCO EQUIPMENT:

1. Antennas (12)
Model – LPA-185080/12CF (71.1” x 4.1” x 5.9) PCS antennas
Antenna Centerline 150' AGL
 2. GPS Antenna: Mounted on the top of the equipment shelter
 3. Transmission Lines:
 - a. MFG/Model: Andrews LDF5-50A
 - b. Size: 1 5/8”

III. ENGINEERING ANALYSIS AND CERTIFICATION:

The towers will be designed in accordance with Electronic Industries Association Standard EIA/TIA-222-F “Structural Standards for Steel Antenna Towers and Antenna Support Structures.” The foundation designs would be based on soil conditions at the site. Details for the towers and foundation designs will be provided as a part of the final D&M Plan.

ENVIRONMENTAL ASSESSMENT STATEMENT

SITE NAME: WATERTOWN WEST (SITE B) – Old Baird Road, Watertown, CT

I. PHYSICAL IMPACT

A. WATER FLOW AND QUALITY

No water flow and/or water quality changes are anticipated as a result of the construction or operation of the Site B Facility. There are no lakes, ponds, rivers, streams, wetlands or other regulated bodies of water located in the area to be used for the access drive, tower or equipment shelter. The equipment used will not discharge any pollutants to area surface or groundwater systems.

B. AIR QUALITY

Under ordinary operating conditions, the equipment that would be used at the site would emit no air pollutants of any kind. For limited periods during power outages and periodically for maintenance purposes, minor levels of emissions from the on-site generator would result.

Pursuant to R.C.S.A. § 22a-174-3, the on-site emergency back-up generator proposed as a part of this application would require the issuance of a Connecticut Department of Environmental Protection Air Bureau permit for potential emissions. Cellco would obtain this permit prior to installing the generator at the approved cell site.

C. LAND

Clearing and grading of the tower compound and access drive will be required. The remaining land of the Lessor would remain unchanged by the construction and operation of the cell site.

D. NOISE


The equipment to be in operation at the Site B Facility would emit no noise of any kind, except for operation of the installed heating, air conditioning and ventilation systems and occasional operation of a back-up generator which would be run during power failures and periodically for maintenance purposes. Some noise is anticipated during cell site construction, which is expected to take approximately four to six weeks.

E. POWER DENSITY

The worst-case calculation of power density for Cellco's PCS antennas at the Watertown West Site B Facility would be 2.16% of the Standard.

F. VISIBILITY

See Visual Resource Evaluation Report included as Attachment 11.

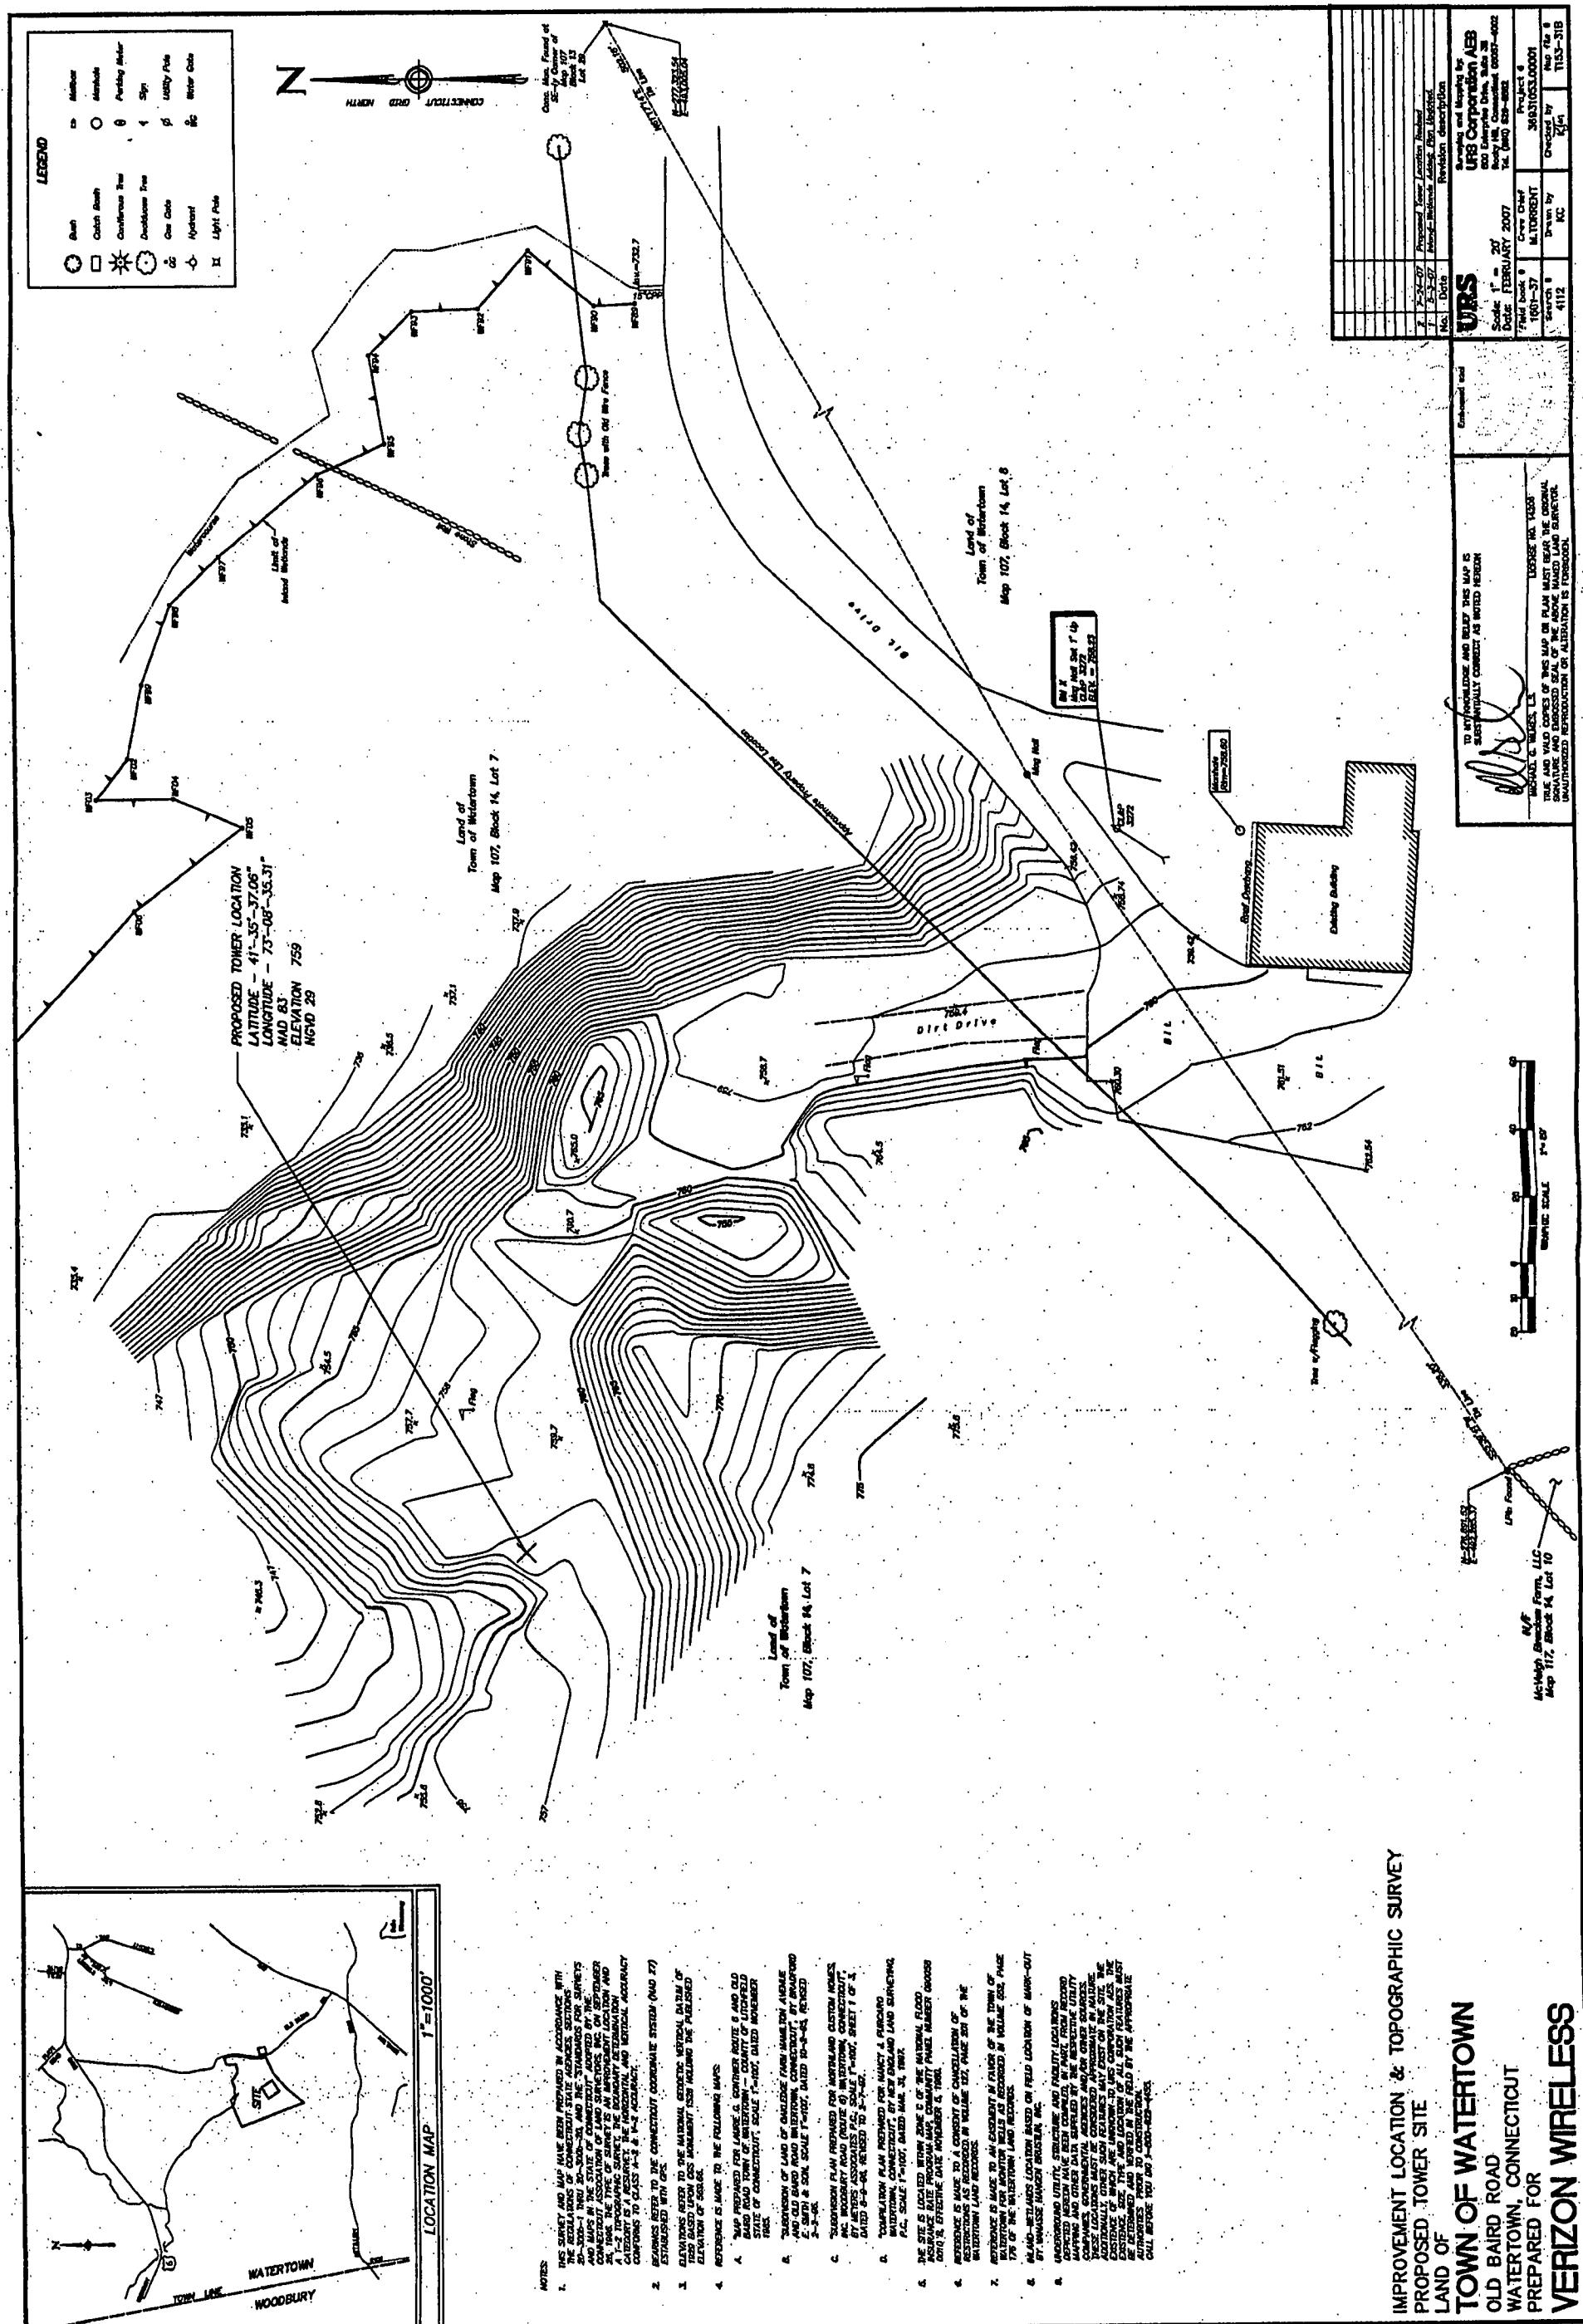

IMPROVEMENT LOCATION & TOPOGRAPHIC SURVEY
PROPOSED TOWER SITE
LAND OF
TOWN OF WATERTOWN
OLD BAIRD ROAD
WATERTOWN, CONNECTICUT
PREPARED FOR
VERIZON WIRELESS

CELCO PARTNERSHIP

verizon wireless

URS CORPORATION AES
500 ENTERPRISE DRIVE
SUITE 3B
ROCKY HILL, CONNECTICUT
1-860-528-8882

PROJECT NO: 36931053
JOB NO: VZ1-228

DRAWN BY: _____ CHECKED BY: _____

ISSUED FOR
05-10-07 REVIEW
07-24-07 REVIEW
09-11-07 REVIEW
09-17-07 SIGN CONTROL APPROVAL

THE INFORMATION CONTAINED
IN THIS SET OF DOCUMENTS
IS PROPRIETARY BY NATURE.
ANY USE OR DISCLOSURE
OTHER THAN THAT WHICH
RELATES TO VERIZON WIRELESS
IS STRICTLY PROHIBITED.


**WATERTOWN
WEST
SITE B**

OLD BAIRD ROAD
WATERTOWN, CONNECTICUT

**SITE PLAN AND
AS NOTED**

SC-1

Z-
SLEW SWIPE

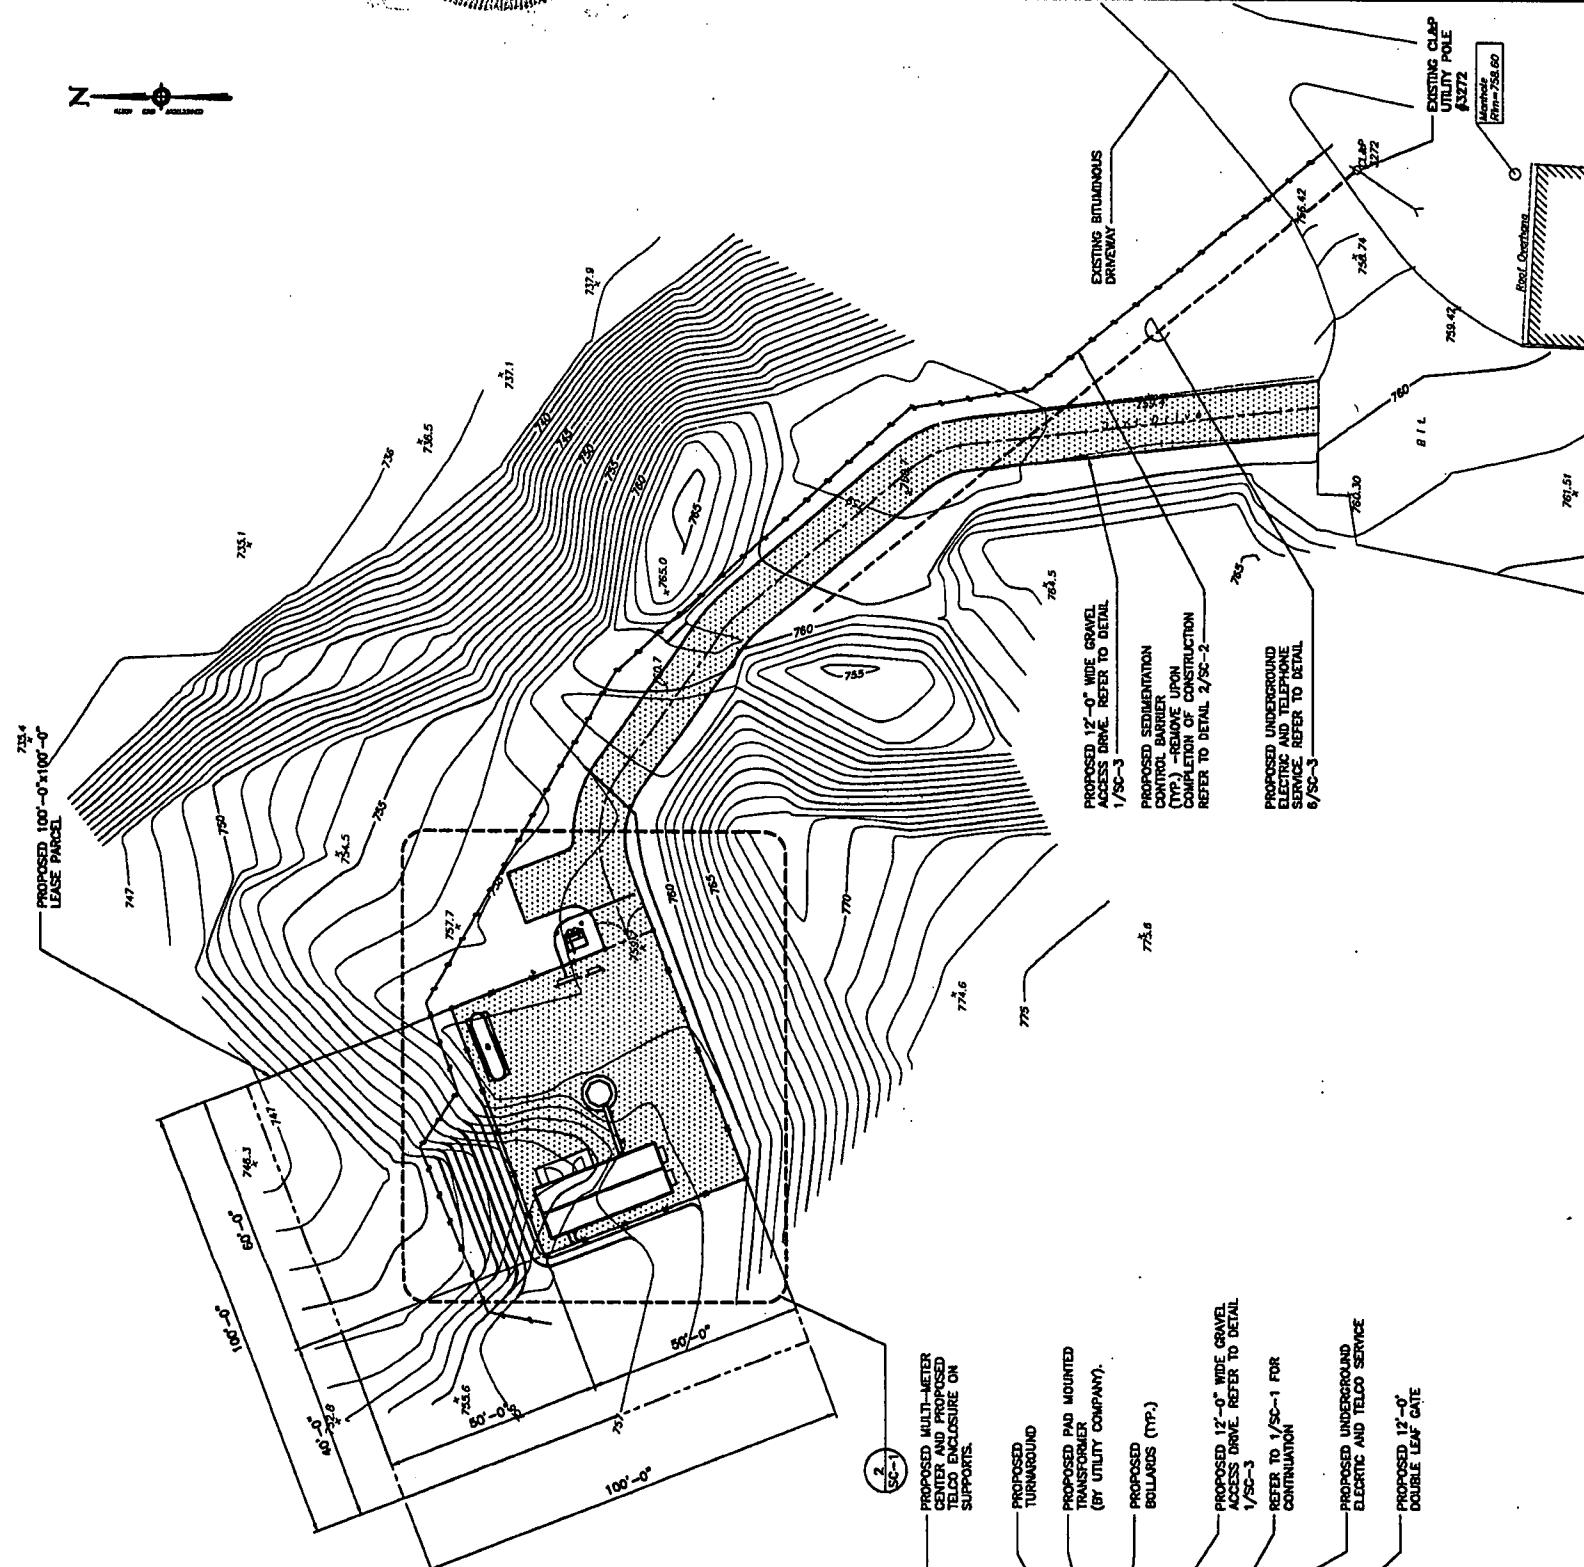

TREE REMOVAL NOTE

O EXISTING TREES TO BE REMOVED TO ALLOW FOR THE CONSTRUCTION OF THE PROPOSED WIRELESS FACILITY.

LEGEND		PROPOSED
DESCRIPTION	EXISTING	
PROPERTY LINE	—	—
LEASE LINE	—	—
CHAIN LINK FENCE	—	—
CONTOUR LINES	—	—
UTILITy POLE	—	—
TREE LINE	—	—
SEDIMENTATION FENCE	—	—
SPOT ELEVATION	X	X

**PROPOSED SEDIMENTATION
CONTROL BARRIER**
**(TYP.) - REMOVE UPON
COMPLETION OF CONSTRUCTION**
REFER TO DETAIL 2/SC-2

**PROPOSED TOWER
STRUCTURE**

**APPROPRIATE LOCATION
OF GENERATOR EXHAUST
LOUVER-REMOVE
PORTION OF FENCING IN
FRONT OF LOUVER**

**PROPOSED CELLO
PARTNERSHIP 12'-0" x 30'-0"
EQUIPMENT BUILDING WITH
PROPANE GENERATOR**

**PROPOSED CELLO
PARTNERSHIP GPS
ACQUERED TO ICE POST**

**PROPOSED CELLO
PARTNERSHIP ICE BRIDGE
ACQUERED TO DEPTH 3,000'**

PROPOSED 80°-0°-50°-0°

2 COMPOUND PLAN
SC-1 SCALE 1" = 10'-0"

928

ANTENNA ORIENTATION KEY

CELLCO PARTNERSHIP
DBA


AE: FRA
URS CORPORATION AES
500 ENTERPRISE DRIVE
SUITE 3B
ROCKY HILL, CONNECTICUT
1-(860)-528-8882



PROJECT NO:	36931053
JOB NO:	VZ1-228
DRAWN BY:	JES
CHECKED BY:	


THE INFORMATION CONTAINED
IN THIS SET OF DOCUMENTS
IS PROPRIETARY BY NATURE.
ANY USE OR DISCLOSURE
OTHER THAN THAT WHICH
RELATES TO VERIZON WIRELESS
IS STRICTLY PROHIBITED.

WATERTOWN
WEST
SITE B
OLD BARD ROAD
WATERTOWN, CONNECTICUT

SCALE: AS NOTED


TOWER
ELEVATION
AND DETAILS

SC-2

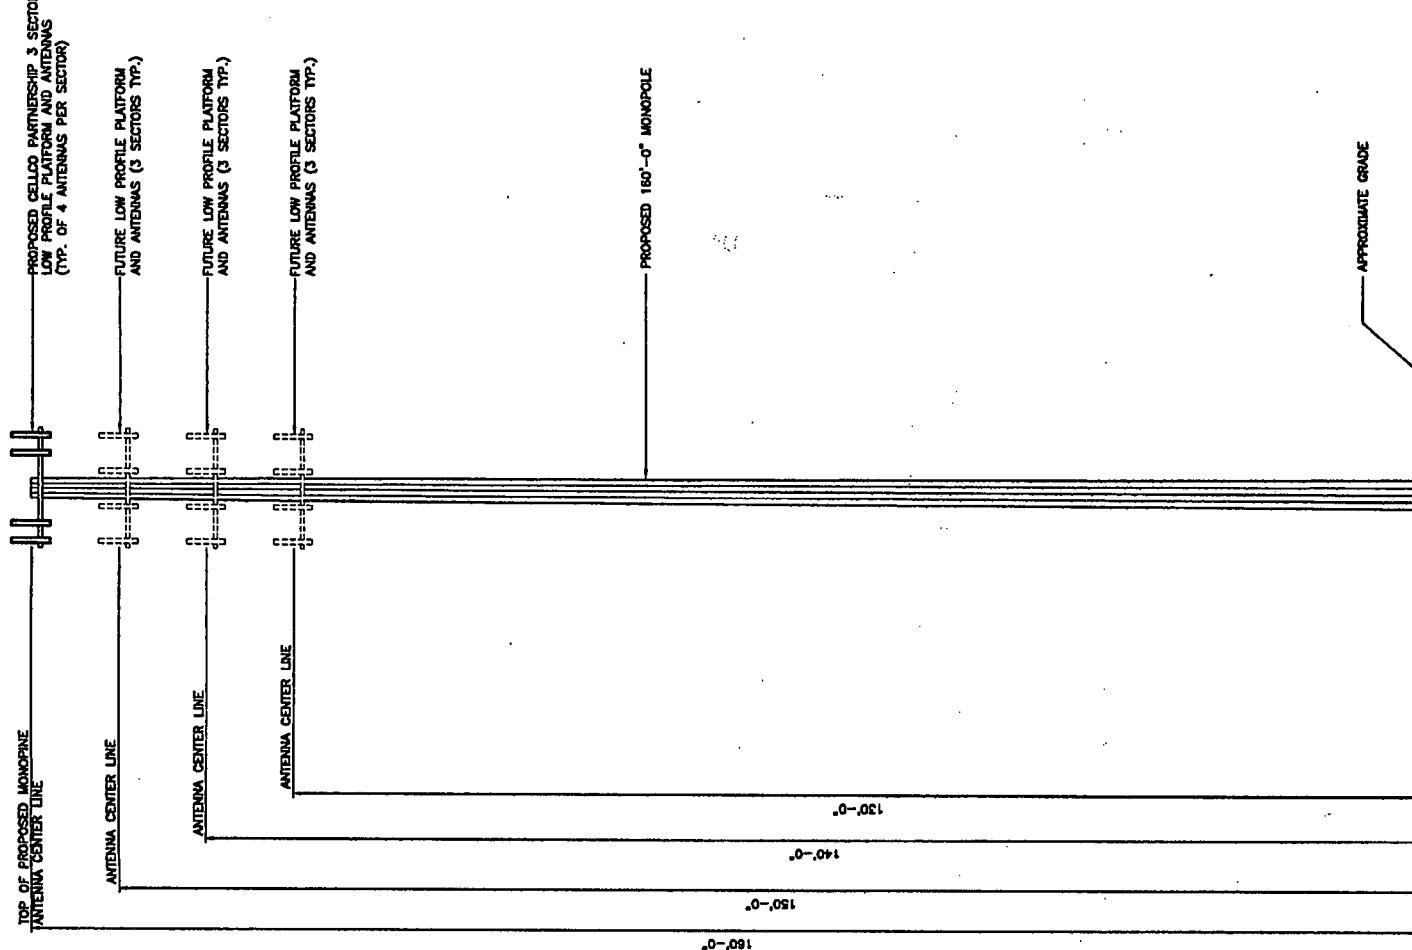


1 TOWER ELEVATION
SC-2 SCALE 1' = 10'-0"

2 SEDIMENTATION CONTROL BARRIER
SC-2 SCALE NTS.

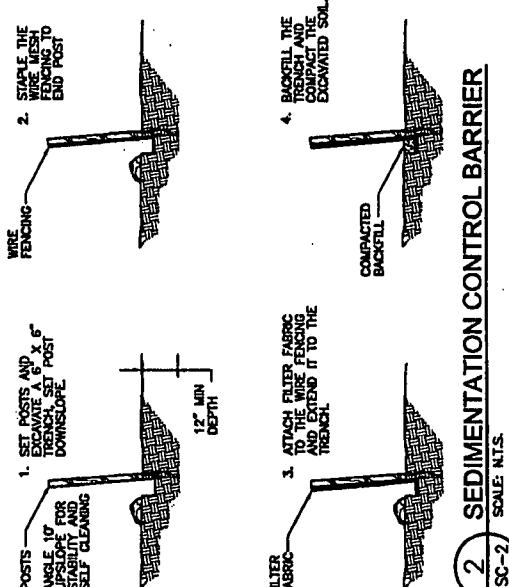


SITE NOTES


- STATE OF CONNECTICUT DEPARTMENT OF TRANSPORTATION**

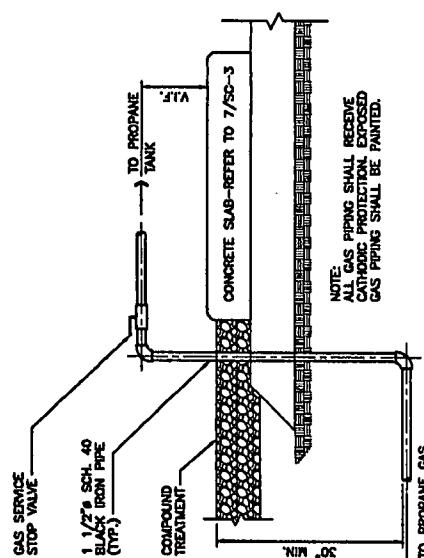

8 TYPICAL PIPING CONNECTION TO GENERATOR

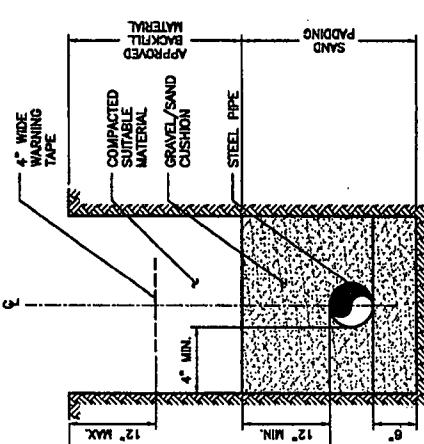

9 TYPICAL BURIED GAS LINE DETAIL

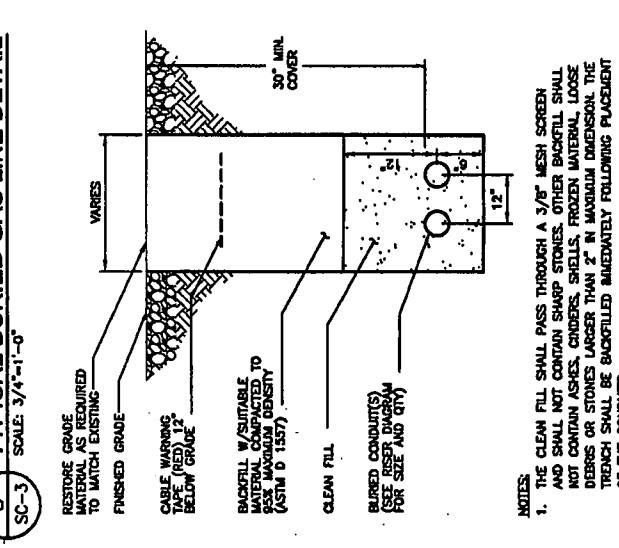

6 TYPICAL UTILITY TRENCH DETAIL

THE CLEAN FILL SHALL PASS THROUGH A $\frac{3}{8}$ " MESH SCREEN AND NOT CONTAIN SHARP STONES. OTHER BACKFILL SHALL NOT CONTAIN ASHES, CINDER, SHELLS, FROZEN MATERIAL, LOOSE DEBRIS OR STONES LARGER THAN 2" IN MAXIMUM DIMENSION. THE TRENCH SHALL BE BACKFILLED IMMEDIATELY FOLLOWING PLACEMENT OF THE CONDUITS.

11

THE FOLLOWING STANDARD SPECIFICATIONS ARE INCORPORATED INTO THE WORK SHOWN HEREIN UNLESS SUPERSEDED BY LOCAL (WATERTOWN) REGULATIONS:

- STATE OF CONNECTICUT DEPARTMENT OF TRANSPORTATION
STANDARD SPECIFICATIONS FOR ROADS, BRIDGES AND IN-COASTAL CONSTRUCTION FORM 816 ENGLISH & METRIC FORMS 816 REVISED
- CHANGES
- SUPPLEMENT FORM 816 JANUARY 2005
- SUPPLEMENT FORM 816 JULY 2005
- DEP BULLETIN 34: CONNECTICUT GUIDELINES FOR SOIL EROSION AND SEDIMENT CONTROL DATED 2002.

CONCRETE

1. ALL CONCRETE WORK SHALL BE IN ACCORDANCE WITH THE ACI 301, ACI 318 AND THE SPECIFICATION CAST-IN-PLACE CONCRETE.
2. ALL CONCRETE SHALL HAVE A MINIMUM COMPRESSIVE STRENGTH OF 3500 PSI AT 28 DAYS, UNLESS NOTED OTHERWISE. CONCRETE SHALL BE AIR ENTRAINED TO 4% (X TO 65) AND SLUMP OF 3" TO 5".
3. REINFORCING STEEL SHALL CONFORM TO ASTM A 615, GRADE 60, DEFORMED OR WIRE FABRIC. REINFORCING STEEL SHALL CONFORM TO ASTM A 115, WELDED WIRE FABRIC, UNLESS NOTED OTHERWISE. SPLICES SHALL BE CLASS B AND ALL HOOKS SHALL BE STANDARD, UNO.
4. THE FOLLOWING MINIMUM CONCRETE COVER SHALL BE PROVIDED FOR REINFORCING STEEL, UNLESS SHOWN OTHERWISE ON DRAWINGS:

CONCRETE CAST AGAINST EARTH.....	3 IN.
CONCRETE EXPOSED TO EARTH OR WEATHER.....	2 IN.
IS AND LARGER & W/WF.....	1 1/2 IN.

CONCRETE NOT EXPOSED TO EARTH OR WEATHER OR NOT CAST AGAINST THE GROUND.....

ALL AREAS DISTURBED BY THE CONSTRUCTION OF IMPROVEMENTS SHOWN HEREON SHALL BE RESTABLISHED TO EXISTING CONDITIONS.

COORDINATION, LAYOUT AND FURNISHING OF CONDUIT, CABLE AND ALL APERTURES REQUIRED FOR PROPER INSTALLATION OF ELECTRICAL AND TELECOMMUNICATION SERVICE SHALL BE SOLELY THE RESPONSIBILITY OF THE CONTRACTOR.

THE EXACT SHELTER FOUNDATION SIZE AND SHELTER FLOOR PENETRATIONS FOR UTILITIES SHALL BE CONFIRMED WITH THE SHELTER SPECIFICATIONS AND PLANS PRIOR TO LAYOUT.

ALL UTILITY WORK SHALL BE IN ACCORDANCE WITH LOCAL UTILITY COMPANY REQUIREMENTS AND SPECIFICATIONS.

THE CONTRACTOR SHALL CONTACT "TALL BEFORE YOU DIG" AT LEAST 48 HOURS PRIOR TO ANY EXCAVATION.

IF ANY FIELD CONDITIONS PRECLUDE COMPLIANCE WITH THE DRAWINGS AND/OR CONDITIONS SPECIFIED, THE CONTRACTOR SHALL IMMEDIATELY NOTIFY THIS CELLULAR CARRIER AND SHALL NOT PROCEED WITH ANY AFFECTED WORK.

THE CONTRACTOR SHALL STABILIZE ALL UTILITY LINE TRENCHES WITHIN FIVE WORKING DAYS AFTER EXCAVATION UNLESS OTHERWISE APPROVED BY THIS CELLULAR CARRIER.

**SLAB AND WALL 3/4 IN.
BEAMS AND COLUMNS 1 1/2 IN.**

5. A CHAMFER 3/4" SHALL BE PROVIDED AT ALL EXPOSED EDGES OF CONCRETE UNO. IN ACCORDANCE WITH ACI 301 SECTION 4.2.4.

6. INSTALLATION OF CONCRETE EXPANSION ANCHOR SHALL BE PER MANUFACTURER'S NINTH RECOMMENDED PROCEDURE THE ANCHOR SCUT, DOWEL OR ROD SHALL CONFORM TO MANUFACTURER'S RECOMMENDATION FOR Embedment Depth OR AS SHOWN ON THE DRAWINGS. NO REBAR SHALL BE CUT WITHOUT PRIOR ENGINEERING APPROVAL WHEN DRILLING HOLES IN CONCRETE.

7. COLD WEATHER CONCRETE PLACING SHALL BE IN ACCORDANCE WITH ACI-305

8. NO FOOTING SHALL BE PLACED ON FROZEN GROUND. UNCURED CONCRETE SHALL BE PROTECTED AGAINST FROST.

9. APPLY NON-SLIP BROOM FINISH IMMEDIATELY AFTER TROWEL FINISHING.

**SOIL BEARING CAPACITY OF 3,000 PSF USED FOR FOUNDATION DESIGN.
GENERAL CONTRACTOR RESPONSIBLE FOR VERIFYING BEARING CAPACITIES.
ALL SURFACES MUST BE FREE OF STANDING WATER PRIOR TO PLACING
CONCRETE.**

**COMPACTED GRANULAR FILL PER CONNECTICUT STATE SPECIFICATION
BT 144-1985, SECTION 2.14.01 THROUGH 2.14.03.**

**CONTACT THE ENGINEER IF GROUND WATER IS ENCOUNTERED AND
DETERMINE IF ADDITIONAL TESTS ARE REQUIRED.**

A vertical cross-section diagram of a soil profile. At the bottom is a thick horizontal line labeled "3' CASTING GRADE". Above it is a thinner horizontal line labeled "4" TOPSOIL". Above that is another thin horizontal line labeled "2' SUBSOIL". At the very top is a thin horizontal line labeled "1'".

ISSUED FOR
15-07-07 REVIEW
07-24-07 REVIEW
09-11-07 REVIEW
09-17-07 SING. OWNER APPROVAL

1 GRAVEL ACCESS DRIVE TYPICAL SECTION

SC-3

6' GRAVEL COMPOUND FINISH - 3/4" GRAVEL THOROUGHLY COMPACTED —

4 GRAVEL COMPOUND DETAIL

SC-3
SCALE 1/2" = 1'-0"

Woven Geotextile Fabric (Muco 2022 or Approved Equal)

12'-0" GRIP STRUT COAX BRIDGE KIT WITH DIRECT BURIAL POSTS - MUROFLECTY B2057-

6'-0"

THE INFORMATION CONTAINED
IN THIS SET OF DOCUMENTS
IS PROPRIETARY BY NATURE.
ANY USE OR DISCLOSURE
OTHER THAN THAT WHICH
RELATES TO VERIZON WIRELESS
IS STRICTLY PROHIBITED.

SITE DETAILS AND NOTES

CONCRETE

12"

NOTE:
1. MAXIMUM 10' SPACING BETWEEN POST SUPPORTS
2. 3 POSTS REQUIRED

SC-3

SC-1 SCALE 1"-1'-0"

ICE BRIDGE DETAIL

SCALE 1 1/2" = 1'-0"

SC-3

2 ICE BRIDGE DETAIL

SC-1 SCALE 1"-1'-0"

3 ICE BRIDGE DETAIL

SCALE 1 1/2" = 1'-0"

SC-3

STAINLESS STEEL SCREW
SNAP IN CABLE HANGER
MICRORECT B1752 SNAP IN HANGER BRACKET Ø 4-0" O.C. MAX

The logo consists of a black checkmark icon positioned above the company name. The name 'CELLCO PARTNERSHIPS' is in a bold, sans-serif font, with 'DBA' in a smaller font below it. To the right of the checkmark, the word 'verizon' is written in its signature script font, with 'wireless' in a smaller sans-serif font directly beneath it.

AES CORPORATION
500 ENTERPRISE DRIVE
SUITE 3B
ROCKY HILL, CONNECTICUT
1-860-529-8832

PROJECT NO:	35931053
JOB NO:	VZ1-228
DRAWN BY:	KAP
CHECKED BY:	
ISSUED FOR	
05-01-07	REVIEW
07-24-07	REVIEW
09-11-07	REVIEW
09-17-07	STING COUNCIL APPROVAL

THE INFORMATION CONTAINED
IN THIS SET OF DOCUMENTS
IS PROPRIETARY BY NATURE.
ANY USE OR DISCLOSURE
OTHER THAN THAT WHICH
RELATES TO VERIZON WIRELESS
IS STRICTLY PROHIBITED.

WATERTOWN
WEST
SITE B
OLD BAIRD ROAD
WATERTOWN, CONNECTICUT

SCALE: AS NOTED

SC-3

STRUCTURAL NOTES

FOUNDATION NOTES

- PRESUMPTION SOIL BEARING CAPACITY OF 3000 PSF WAS USED FOR THE FOUNDATION DESIGN. GENERAL CONTRACTOR IS TO CONFIRM THE SPECIFIED SOIL BEARING PRESSURE.
- ALL FOOTINGS SHALL BEAR ON EXISTING UNDISTURBED ORGANIC FREE SOIL. A 12" DEEP, 12" DIAMETER CONCRETE PILE SHALL BE SAWN AS DIRECTED BY THE MANUFACTURER'S RECOMMENDATION AND PLACED IN THE SOIL. A 12" DIAMETER CONCRETE PILE SHALL BE SAWN AS DIRECTED BY THE MANUFACTURER'S RECOMMENDATION AND PLACED IN 6" LAYERED GRAVEL AND COMPACTED TO 95% OF MODIFIED OPTIMUM DENSITY.
- ALL FOOTINGS TO BE A MINIMUM OF 3'-6" BELOW FINISH GRADE UNLESS OTHERWISE NOTED. EXCEPT WHERE ROCK OR LEDGE OCCURS, PIN FOUNDATION TO ROCK.
- INSTALLATION OF CONCRETE EXPANSION/HEDGE ANCHOR, SHALL BE PER MANUFACTURER'S RECOMMENDED PROCEDURE. THE ANCHOR (SCB) OR DOWEL OR ROD SHALL CONFORM TO MANUFACTURER'S RECOMMENDATION FOR EMBEDMENT DEPTH OR AS SHOWN ON THE DRAWINGS. NO REBAR SHALL BE CUT WITHOUT PRIOR ENGINEERING APPROVAL. WHEN DRILLING HOLES IN CONCRETE.

CELLCO PARTNERSHIP
DBA

verizon wireless

ORS CORPORATION AES
500 ENTERPRISE DRIVE
SUITE 3B
ROCKY HILL, CONNECTICUT
1-800-243-1234





THE INFORMATION CONTAINED
IN THIS SET OF DOCUMENTS
IS PROPRIETARY BY NATURE.
ANY USE OR DISCLOSURE
OTHER THAN THAT WHICH
RELATES TO YOUR PROHIBITED
STRICTLY PROHIBITED.

WATERTOWN
WEST
SITE B


OLD BAIRD ROAD
WATERTOWN, CONNECTICUT

**EQUIPMENT SHELTER
FOUNDATION PLAN,
ELEVATIONS,
DETAILS AND NOTES**


SC-4

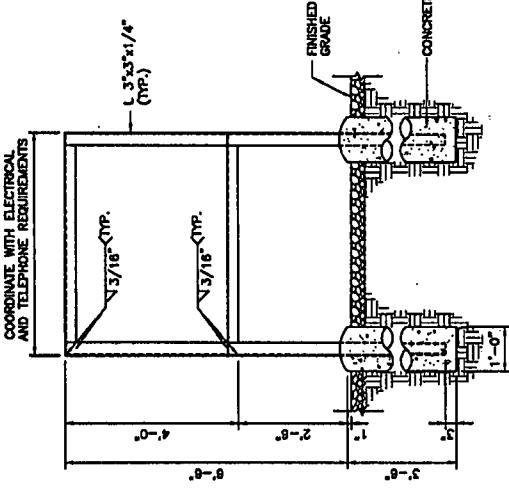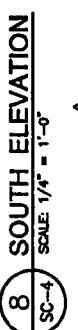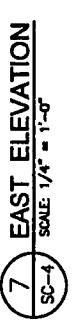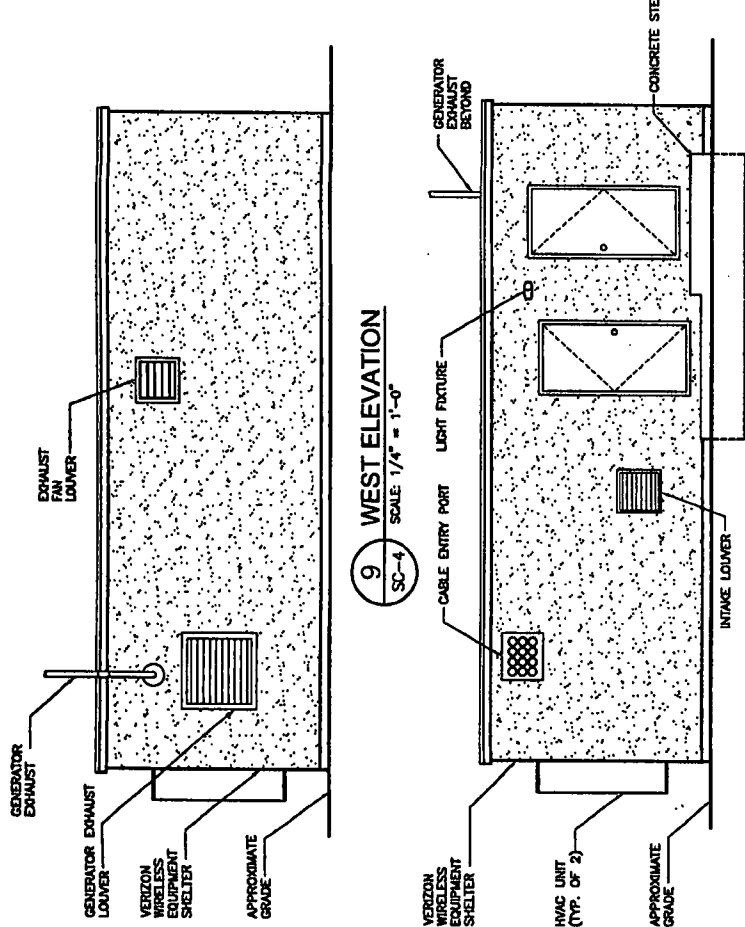

11 ELECTRIC-TELCO SERVICE FRAME DETAIL

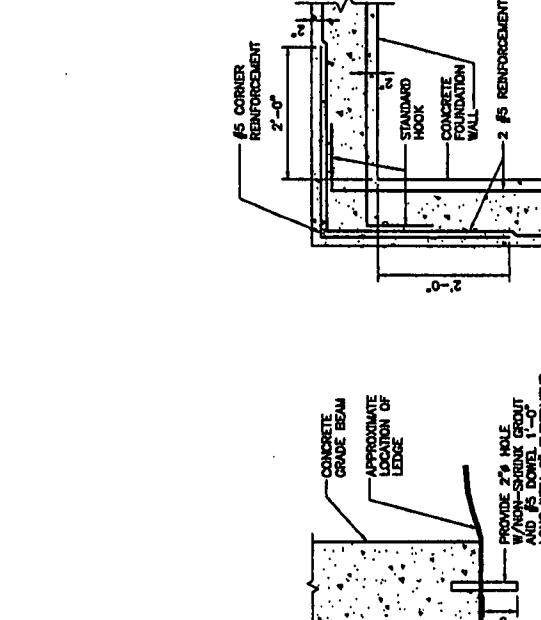

PINNED FOUNDATION

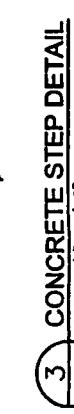



2 FOUNDATION SECTION



224

CELLCO PARTNERSHIP
DBA


AE FROM
URS CORPORATION INC.
500 ENTERPRISE DRIVE
SUITE 3B
ROCKY HILL, CONNECTICUT
1-(860)-525-8882

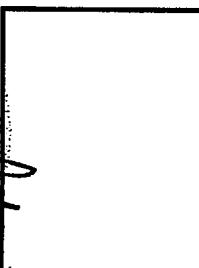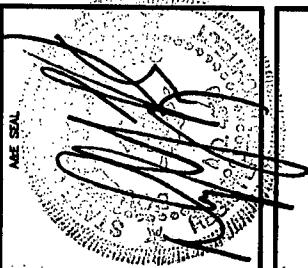

PROJECT NO: 36931053

JOB NO: VZ1-228

DRAWN BY: JES

CHECKED BY:

ISSUED FOR

05-03-07 REVIEW

07-24-07 REVIEW

09-11-07 REVIEW

09-17-07 SITE COUNCIL APPROVAL


THE INFORMATION CONTAINED
IN THIS SET OF DOCUMENTS
IS PROPRIETARY BY NATURE.
ANY USE OR DISCLOSURE
OTHER THAN THAT WHICH
RELATES TO VERIZON WIRELESS
IS STRICTLY PROHIBITED.

WATERTOWN
WEST
SITE B
OLD BAIRD ROAD
WATERTOWN, CONNECTICUT

SCALE: AS NOTED
ABUTTERS
MAP

AB-1

N 

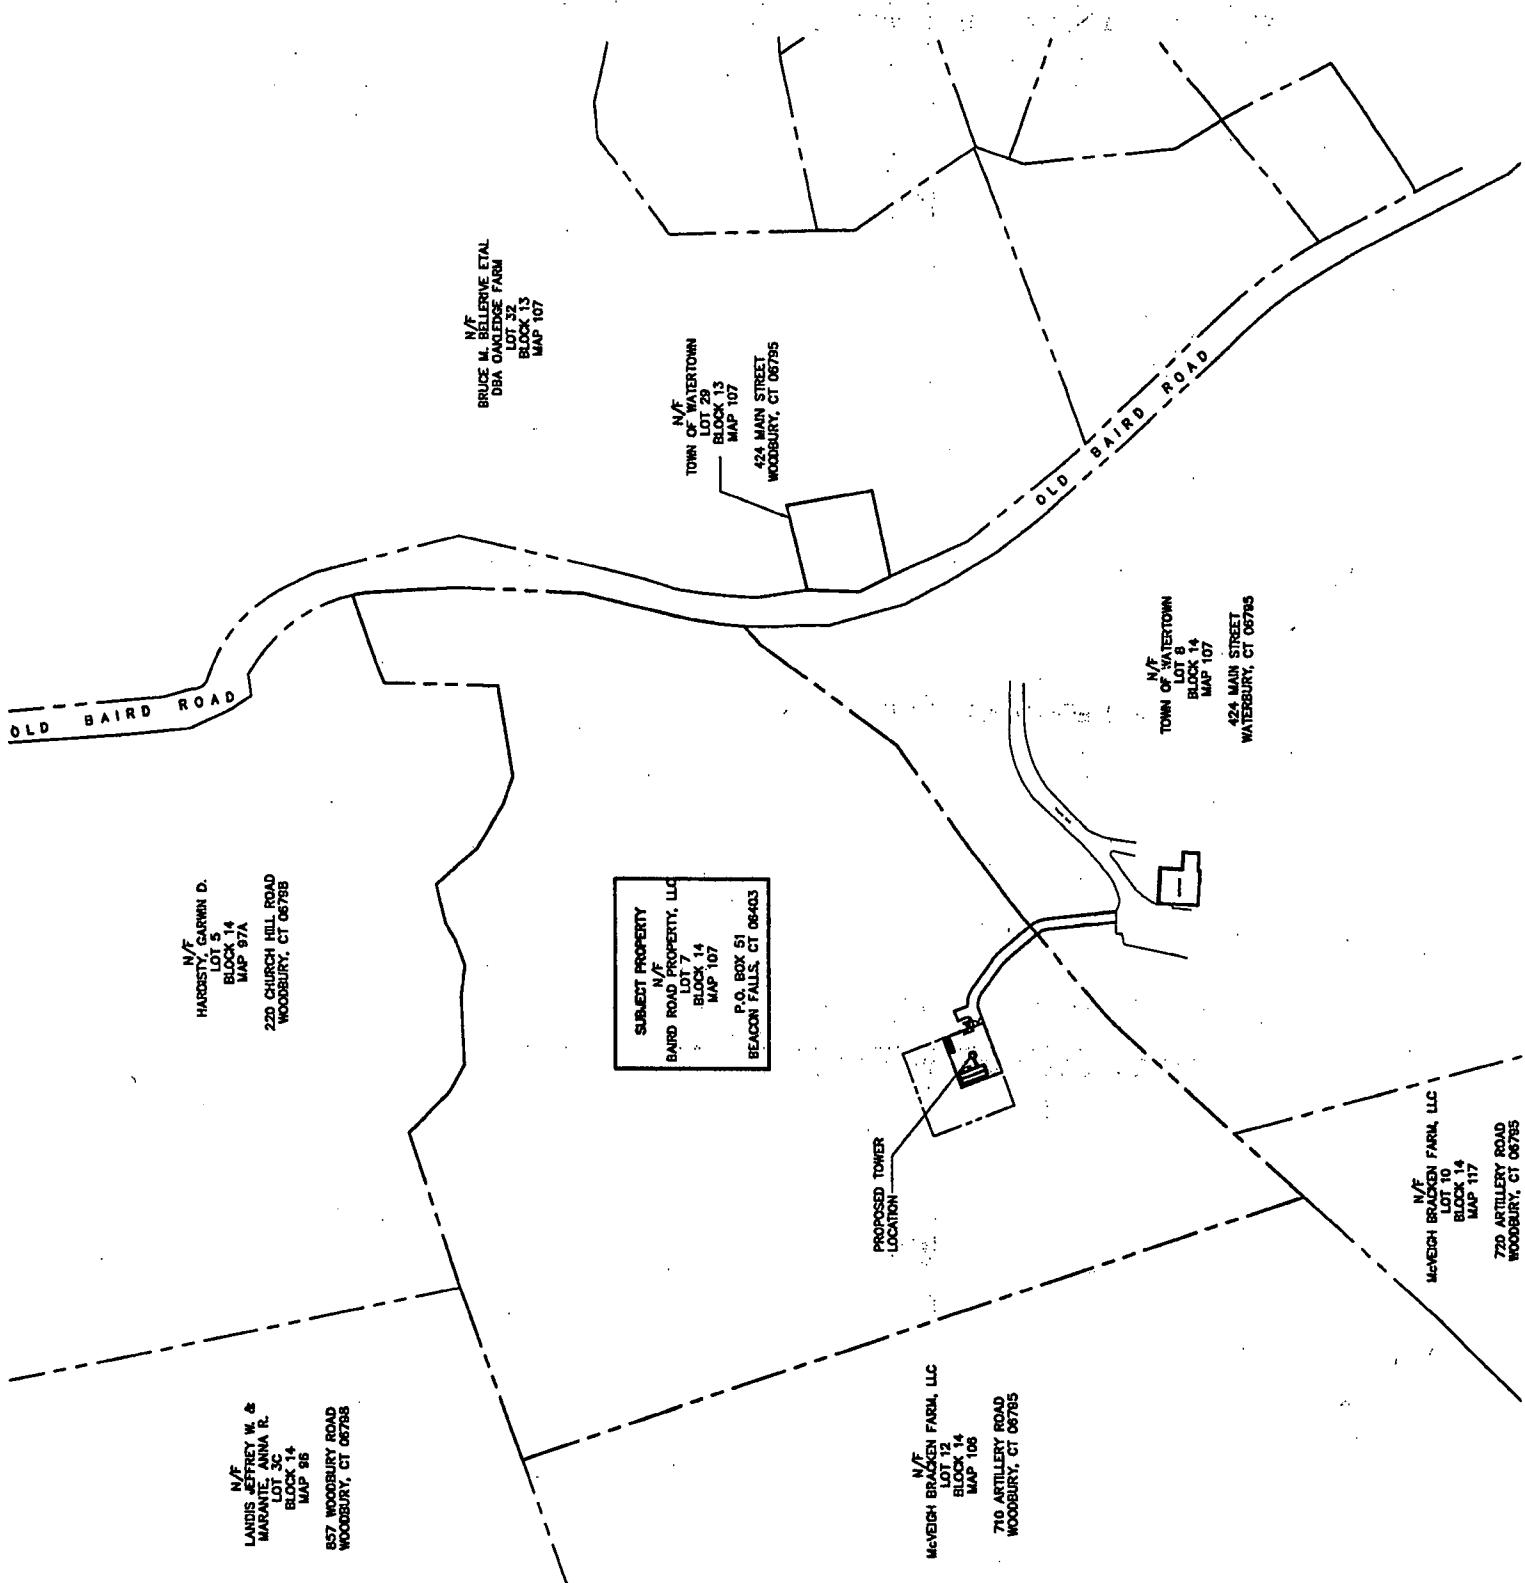

1  ABUTTERS PLAN
AB-1
SCALE: 1" = 100'-0"

