
# WIRELESS COMMUNICATIONS FACILITY **GUILFORD**

**DEVELOPMENT & MANAGEMENT PLAN** 1919 BOSTON POST ROAD GUILFORD, CONNECTICUT

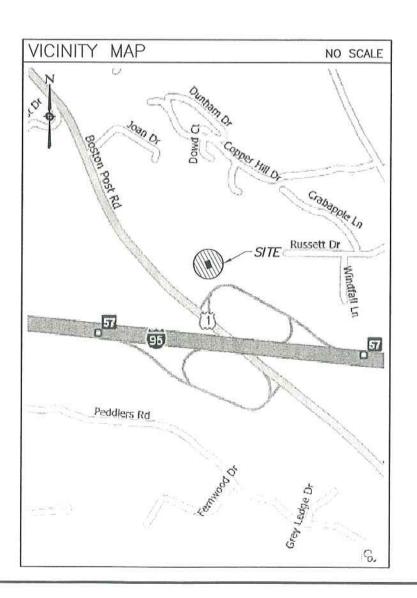

# PROJECT SUMMARY

SITE ADDRESS:

JURISDICTION-CONNECTICUT SITING COUNCIL

GOVERNING CODE:

LOT

ZONE: (SERVICE CENTER WEST ZONING DISTRICT)

OWNER: C & K REAL ESTATE, LLC

APPLICANT: GLOBAL SIGNAL

ARCHITECT:

M/E/P ENGINEER:

LATITUDE 41"-18"-1.2657" LONGITUDE 72"-42"-29.1285" CEODETIC COORDINATES:

GROUND ELEVATION:

TION OR DETAIL NUMBER TO WHERE DETAIL/SECTION OCCURS ATION NUMBER TO WHERE ELEVATION OCCURS

ELEVATION 98'

# **ABBREVIATIONS**

VERIFY IN FIELD ON CENTER PSF POUND/SQUARE FOOT TYP. TYPICAL FT. FEET SO.FT. SQUARE FEET

SH	EET INDEX
SHT. NO.	DESCRIPTION

SHT. NO.	DESCRIPTION
T-1	TITLE SHEET - GENERAL NOTES AND LEGENDS
C-1	EXISTING SITE PLAN AND SITE WORK GENERAL NOTES
C-2	PROPOSED PARTIAL SITE PLAN
C-3	COMPOUND PLAN
C-4	TOWER ELEVATION
C-5	SITE DETAILS AND NOTES
C-6	CINGULAR WIRELESS EQUIPMENT SHELTER ELEVATION
	AND DETAILS
C-7	VERIZON WIRELESS EQUIPMENT SHELTER ELEVATIONS
	AND DETAILS
C-8	NEXTEL/SPRINT EQUIPMENT SHELTER ELEVATIONS
	AND DETAILS
C-9	T-MOBILE EQUIPMENT SECTIONS

# URS CORPORATION AES

500 ENTERPRISE DRIVE ROCKY HILL, CONNECTICUT



PROJECT NO: 36928481

JES

DRAWN BY:

CHECKED BY:

ISSUED FOR A 06-11-08 REVIEW 0 07-07-08 DAW 1 07-22-08 REVISED DAM

IN THIS SET OF DOCUMENTS IS PROPRIETARY BY NATURE. ANY USE OR DISCLOSURE OTHER THAN THAT WHICH RELATES TO GLOBAL SIGNAL IS STRICTLY PROHIBITED.

**GUILFORD** 

1919 BOSTON POST ROAD GUILFORD, CONNECTICUT

SCALE:

AS NOTED TITLE SHEET-

**GENERAL NOTES** AND LEGENDS

T-1

### SITEWORK GENERAL NOTES

- STATE OF CONNECTICUT DEPARTMENT OF TRANSPORTATION "STANDARD SPECIFICATIONS FOR ROADS, BRIDGES AND IN-CIDENTAL CONSTRUCTION" FORM 816 ENGLISH & METRIC FORM 816 ORIGINAL -FORM 816 SUMMARY OF CHANGES
- SUPPLEMENT FORM 816 JANUARY 2005 SUPPLEMENT FORM 816 JULY 2005
- DEP BULLETIN 34, CONNECTICUT GUIDELINES FOR SOIL EROSION AND SEDIMENT CONTROL DATED 2002.
- THE CONTRACTOR SHALL INSTALL ALL EROSION AND SEDIMENTATION CONTROL MEASURES PRIOR TO MAY GRADING ACTIVITIES.
- THE CONTRACTOR SHALL ESTABLISH AND MAINTAIN SOIL EROSION AND SEDIMENTATION CONTROLS AT ALL TIMES DURING CONSTRUCTION, ALL SOIL EROSION AND SEDIMENTATION CONTROL MEASURES ARE SUBJECT TO INSPECTION AND MONITORING BY THE TOWN.
- COORDINATION, LAYOUT AND FURNISHING OF CONDUIT, CABLE AND ALL APPURTEMANCES REQUIRED FOR PROPER INSTALLATION OF ELECTRICAL AND TELECOMMUNICATION SERVICE SHALL BE SOLELY THE RESPONSIBILITY OF THE CONTRACTOR.
- ALL UTILITY WORK SHALL BE IN ACCORDANCE WITH LOCAL UTILITY COMPANY REQUIREMENTS AND SPECIFICATIONS.
- IF ANY FIELD CONDITIONS PRECLUDE COMPLIANCE WITH THE DRAWINGS AND/OR CONDITIONS SPECIFIED, THE CONTRACTOR SHALL IMMEDIATELY NOTIFY CELLULAR CARRIER AND SHALL NOT PROCEED WITH ANY AFFECTED WORK.
- THE CONTRACTOR SHALL STABILIZE ALL UTILITY LINE TRENCHES WITHIN FIVE WORKING DAYS AFTER EXCAVATION UNLESS OTHERWISE APPROVED BY CELLULAR CARRIER.

- ALL EXISTING ACTIVE SEWER, WATER, GAS, ELECTRIC, AND OTHER UTILITIES WHERE ENCOUNTERED IN THE WORK, SHALL BE PROTECTED AT ALL TIMES, AND WHERE REQUIRED FOR THE PROPER EXCEUTION OF THE WORK, SHALL BE RELOCATED AS DIRECTED BY ENGINEERS. EXTREME CAUTION SHOULD BE USED BY THE SUBCONTRACTOR WHEN EXCAVATING OR DRILLING PIERS AROUND OR NEAR UTILITIES. SUBCONTRACTOR SHALL PROVIDE SAFETY TRAINING FOR THE WORKING CREW. THIS WILL INCLUDE BUT NOT BE LIMITED TO A) FALL PROTECTION B) CONFINED SPACE C) ELECTRICAL SAFETY D) TRENCHING & EXCAVATION.
- ALL SITE WORK SHALL BE AS INDICATED ON THE DRAWINGS AND PROJECT SPECIFICATIONS.

- THE SITE SHALL BE GRADED TO CAUSE SURFACE WATER TO FLOW AWAY FROM THE EQUIPMENT SHELTERS/SLABS AND TOWER AREAS.
   NO FILL OR EMBANKMENT MATERIAL SHALL BE PLACED ON FROZEN GROUND. FROZEN MATERIALS, SNOW OR ICE SHALL NOT BE PLACED IN ANY FILL OR EMBANGMENT.
- 14. ALL EXISTING INACTIVE SEWER, WATER, GAS, ELECTRIC AND OTHER UTILITIES, WHICH INTERFERE WITH THE EXECUTION OF THE WORK, SHALL BE REMOVED AND/OR CAPPED, PLIGOGED OR OTHERWISE DISCONTINUED AT POINTS WHICH WILL NOT INTERFERE WITH THE EXECUTION OF THE WORK, SUBJECT TO THE APPROVAL OF ENGINEERING, OWNER AND/OR LOCAL UTILITIES.
- 15. ALL EXISTING AREAS DISTURBED DUE TO CONSTRUCTION SHALL BE RESTORED TO MATCH PRECONSTRUCTION CONDITIONS.
- 17 COORDINATED CONTROL POINTS TO BE PROVIDED BY URS CORPORATION A.E.S.
- 18. THE CONTRACTOR SHALL CONTACT "CALL BEFORE YOU DIG" AT LEAST 48 HOURS PRIOR TO ANY EXCAVATIONS TO VERIFY AND IDENTIFY THE EXACT LOCATIONS OF ALL UNDERGROUND UTILITIES AND OBSTRUCTIONS PRIOR TO COMMENCING WORK IN THE CONTRACT AREA.

- 20. DURING CONSTRUCTION, LARGE OBJECTS SUCH AS LOGS AND MOVEABLE ROCKS SHALL BE MOVED OUT OF THE WAY OF HEAVY MACHINERY TO MINIMIZE ANY POTENTIAL HARM TO HOGNOSE SNAKES THAT MIGHT BE IN THE AREA

#### SEDIMENTATION CONTROL FENCE SPECIFICATIONS MAINTENANCE

- 1. SILT FENCES SHALL BE INSPECTED IMMEDIATELY AFTER EACH RAINFALL AND AT LEAST DAILY DURING PROLONGED RAINFALL. ANY REPAIRS THAT ARE REQUIRED SHALL BE MADE IMMEDIATELY.
- IF THE FABRIC ON A SILT FENCE SHOULD DECOMPOSE OR BECOME INEFFECTIVE DURING THE EXPECTED LIFE OF THE FENCE, THE FABRIC SHALL BE REPLACED
- SEDIMENT DEPOSITS SHOULD BE INSPECTED AFTER EVERY STORM EVENT, THE DEPOSITS SHOULD BE REMOVED WHEN THEY REACH APPROXIMATELY ONE—HALF THE HEIGHT OF THE BARRIER.
- SEDIMENT DEPOSITS THAT ARE REMOVED OR LEFT IN PLACE AFTER THE FABRIC HAS BEEN REMOVED SHALL BE GRADED TO CONFORM WITH THE EXISTING TOPOGRAPHY AND VEGETATION.

#### CONSTRUCTION SEQUENCE

- 1. THE GEOTEXTILE FABRIC SHALL MEET THE DESIGN CRITERIA FOR SILT FENCES
- THE FABRIC SHALL BE EMBEDDED A MINIMUM OF 8 INCHES INTO THE GROUND AND THE SOIL COMPACTED OVER THE EMBEDDED FABRIC.
- WOVEN WIRE FENCES SHALL BE FASTENED SECURELY TO THE FENCE POSTS WITH WIRE TIES OR STAPLES.
- FILTER CLOTH SHALL BE FASTENED SECURELY TO THE WOVEN WIRE FENCE WITH TIES SPACED EVERY 24 INCHES AT THE TOP, MID-SECTION, AND BOTTOM.

- FENCE POSTS SHALL BE A MINIMUM OF 36 INCHES LONG AND DRIVEN A MINIMUM OF 16 INCHES INTO THE GROUND, WOOD POSTS SHALL BE OF SOUND GUALITY HARDWOOD AND SHALL HAVE A MINIMUM CROSS SECTIONAL AREA OF 3.0 SQUARE
- MAINTENANCE SHALL BE PERFORMED AS NEEDED TO PREVENT BULGES IN THE SILT FENCE DUE TO DEPOSITION OF SEDIMENT.

#### EROSION CONTROL NOTES

- 1. DURING CONSTRUCTION AND THEREAFTER EROSION CONTROL MEASURES ARE TO BE IMPLEMENTED AS NOTED. NOT GREATER THAN 80,000 SQ. FT. OF LAND SHALL BE EXPOSED AT ANY ONE TIME DURING DEVELOPMENT. WHEN LAND IS EXPOSED DURING DEVELOPMENT, THE EXPOSURE SHOULD BE KEPT TO THE SHORTEST PRACTICAL PERIOD OF TIME AND SHALL NOT EXCEED 90 DAYS. LAND SHOULD NOT BE LEFT EXPOSED DURING THE WINTER MONTHS.
- SILTATION FENCING SHALL BE INSTALLED WHERE SHOWN PRIOR TO ANY ON SITE GRADING
  OR DISTURBANCE OF EXISTING SURFACE MATERIAL. IT SHOULD BE MAINTAINED DURING
  AND AFTER DEVELOPMENT TO REMOVE SEDIMENT FROM RUNOFF WATER AND FROM LAND
  UNDERGOING DEVELOPMENT. WHERE POSSIBLE NATURAL DRAINAGE-WAYS SHOULD BE
  UTILIZED AND LEFT OPEN TO REMOVE EXCESS SURFACE WATER.
- ALL DISTURBED AREAS AND SIDE SLOPES WHICH ARE FINISH GRADED WITH NO FURTHER CONSTRUCTION TO TAKE PLACE SHALL BE LOAMED AND SEEDED. A MINIMUM OF 4" OF LOAM SHALL BE INSTALLED.
- 4. ANY DISTURBED AREAS WHICH ARE TO BE LEFT TEMPORARILY, AND WHICH WILL BE REGRADED LATER DURING CONSTRUCTION SHALL BE MACHINE HAY MULCHED AND SEEDED WITH RYE GRASS TO PREVENT EROSION. HAY OR STRAW MULCH SHALL BE APPLIED TO ALL FRESHLY SEEDED AREAS AT A RATE OF 2 TONS PER ACRE. BALES SHALL BE UNSPOILED, AIR—DRIED, AND FREE FROM WEED, SEEDS AND ANY COARSE MATERIAL.

**URS CORPORATION ALS** 

500 ENTERPRISE DRIVE ROCKY HILL, CONNECTICUT 1-(860)-529-8882



PROJECT NO: 36928481

JES

JOB NO: GS1-001

DRAWN BY:

CHECKED BY:

ISSUED FOR A 06-11-08 REVIEW 0 07-07-08 D&M 1 07-22-08 REVISED D&M 2 08-11-08 D&M APPROVAL


THE INFORMATION CONTAINED IN THIS SET OF DOCUMENTS IS PROPRIETARY BY NATURE ANY USE OR DISCLOSURE OTHER THAN THAT WHICH RELATES TO GLOBAL SIGNAL IS STRICTLY PROHIBITED.


**GUILFORD** 

1919 BOSTON POST ROAD GUILFORD, CONNECTICUT

AS NOTED

**EXISTING SITE** PLAN AND SITE WORK GENERAL NOTES

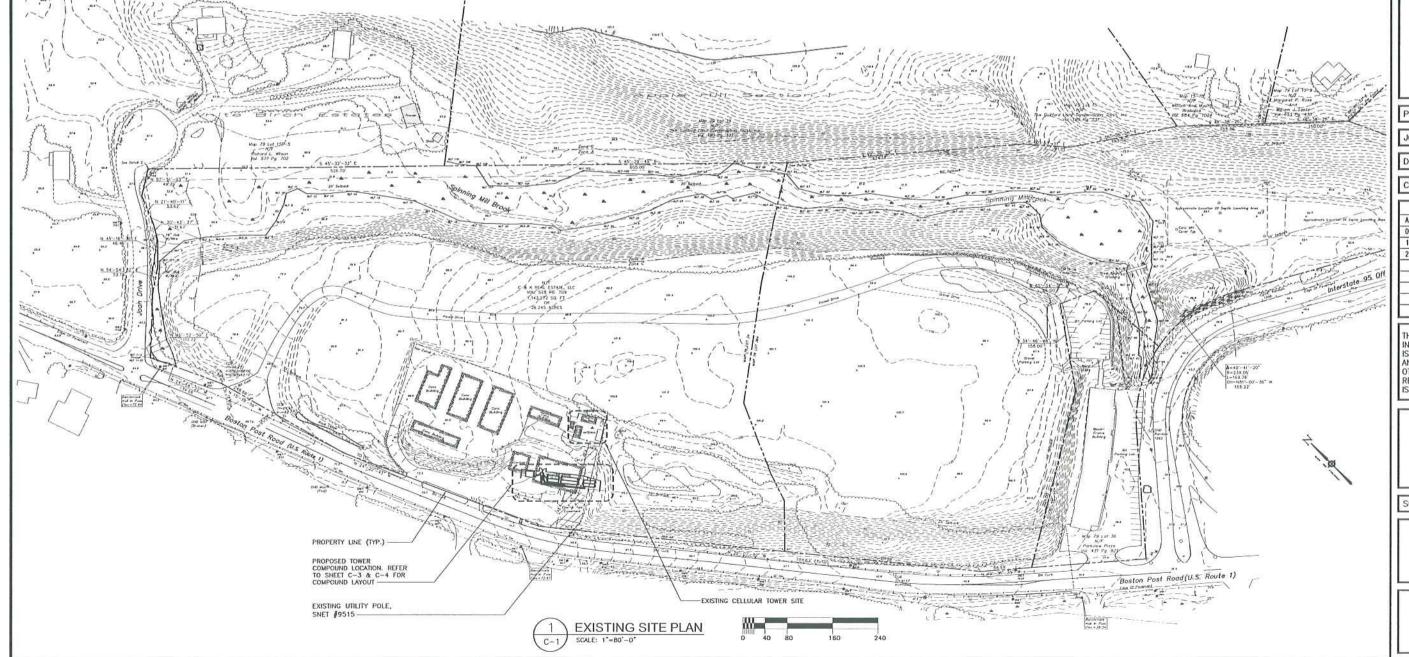

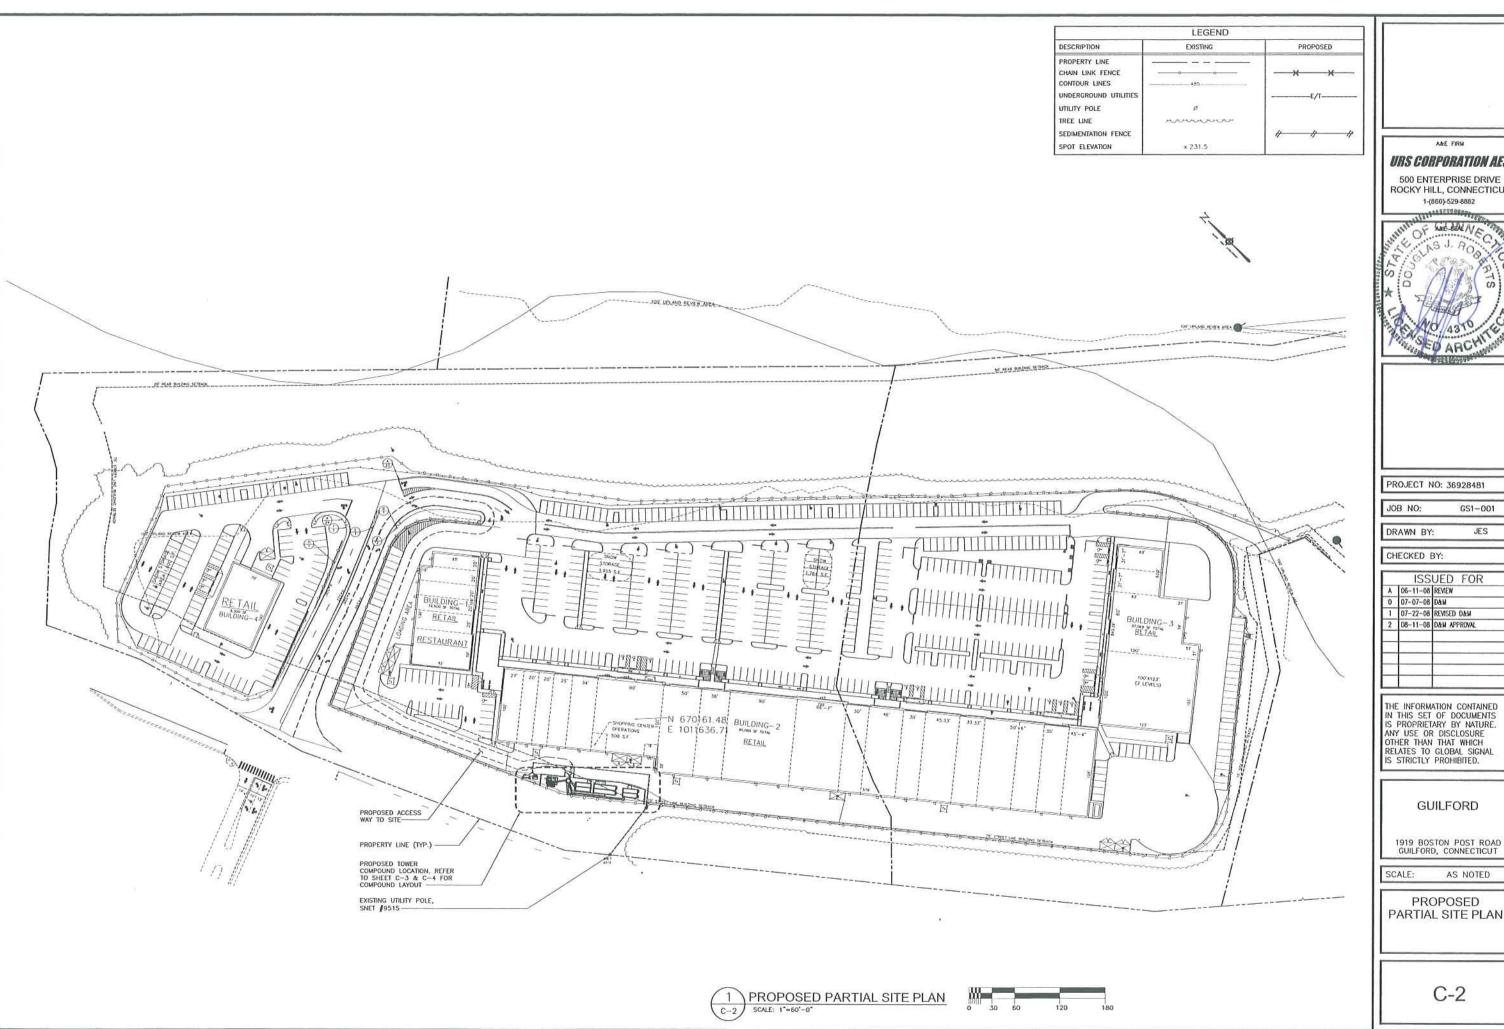

URS CORPORATION AES

ROCKY HILL, CONNECTICUT 1-(860)-529-8882




PROJECT NO: 36928481

GS1-001

A	06-11-08	REVIEW
)	07-07-08	DAM
1	07-22-08	REVISED DAM
2	08-11-08	DAM APPROVAL

1919 BOSTON POST ROAD GUILFORD, CONNECTICUT

PARTIAL SITE PLAN

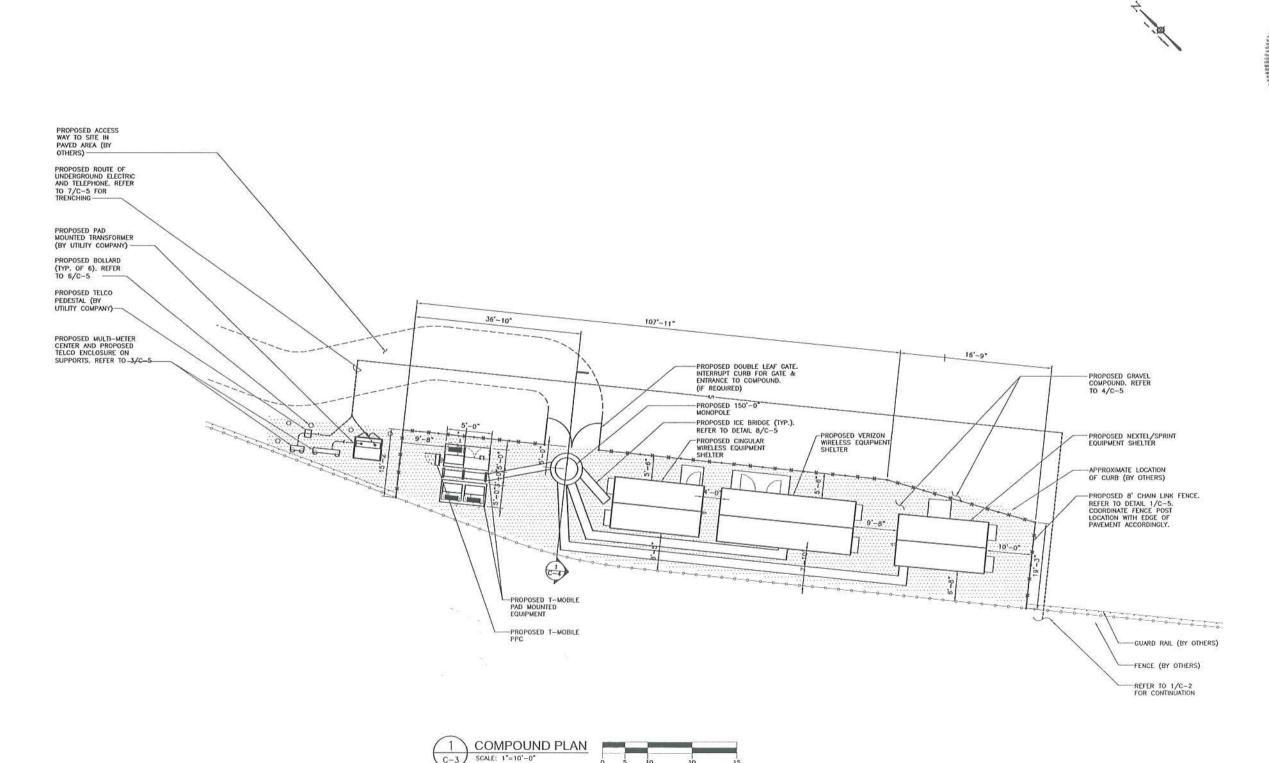

A&E FIRM

URS CORPORATION AES

500 ENTERPRISE DRIVE ROCKY HILL, CONNECTICUT



PROJECT NO: 36928481

JES

JOB NO: GS1-001

DRAWN BY:

CHECKED BY:

| ISSUED FOR | A | 06-11-08 | REVIEW | 0 | 07-07-08 | D&M | 1 | 07-22-08 | REVISED D&M |

1 07-22-08 REVISED D&M 2 08-11-08 D&M APPROVAL


THE INFORMATION CONTAINED IN THIS SET OF DOCUMENTS IS PROPRIETARY BY NATURE. ANY USE OR DISCLOSURE OTHER THAN THAT WHICH RELATES TO GLOBAL SIGNAL IS STRICTLY PROHIBITED.

**GUILFORD** 

1919 BOSTON POST ROAD GUILFORD, CONNECTICUT

CALE: AS NOTED

COMPOUND PLAN

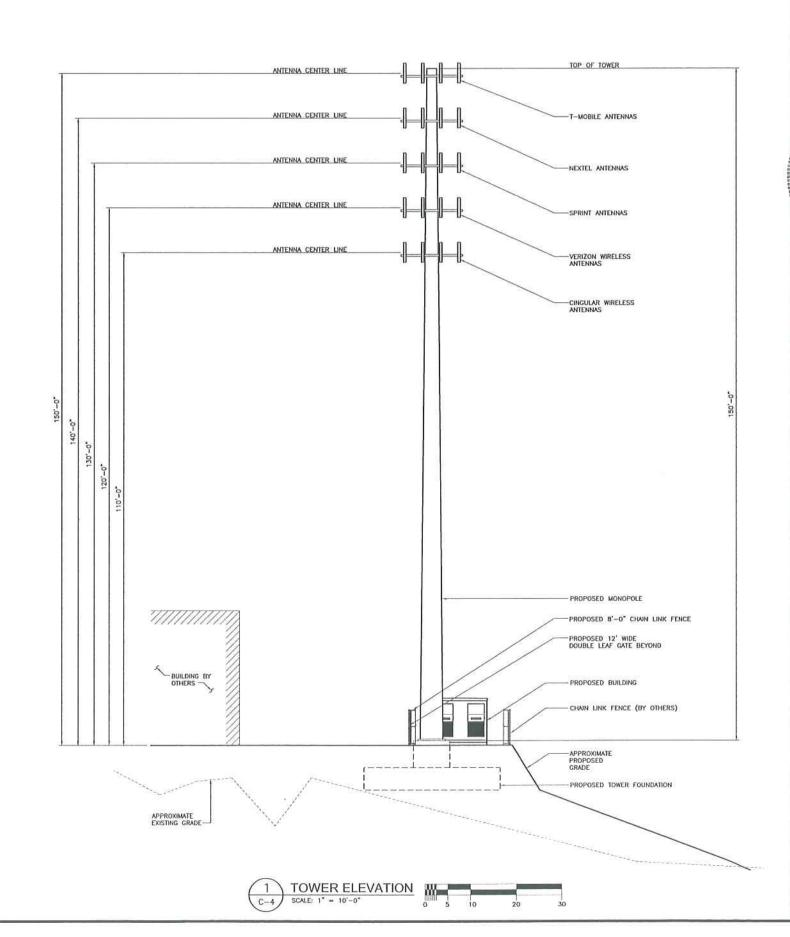

AME FIRM
URS CORPORATION AES

500 ENTERPRISE DRIVE ROCKY HILL, CONNECTICUT 1-(860)-529-8882



PROJECT NO: 36928481

JOB NO: GS1-001

DRAWN BY: JES

CHECKED BY:

ISSUED FOR

A 06-11-08 REVIEW
0 07-07-08 DAM
1 07-22-08 REVISED DAM
2 08-11-08 DAM APPROVAL

THE INFORMATION CONTAINED IN THIS SET OF DOCUMENTS IS PROPRIETARY BY NATURE. ANY USE OR DISCLOSURE OTHER THAN THAT WHICH RELATES TO GLOBAL SIGNAL IS STRICTLY PROHIBITED.

**GUILFORD** 

1919 BOSTON POST ROAD GUILFORD, CONNECTICUT

SCALE: AS NOTED

TOWER ELEVATION

#### **DESIGN LOAD CRITERIA** GENERAL NOTES EQUIPMENT SHELTER SHALL BE DESIGNED AND MANUFACTURED TO MEET ALL STATE AND LOCAL CODES, ITS LAYOUT SHALL BE COORDINATED WITH CARRIERS. SOIL BEARING CAPACITY OF 3,000 PSF USED FOR FOUNDATION DESIGN. GENERAL CONTRACTOR RESPONSIBLE FOR VERIFYING BEARING CAPACITIES ALL SURFACES MUST BE FREE OF STANDING WATER PRIOR TO PLACING CONCRETE DESIGN BASIS GOVERNING CODE DESIGN LIVE LOADS: CONNECTICUT STATE BUILDING CODE (3) 3/8" BOLTS COMPACTED GRAVEL FILL PER CONNECTICUT DOT STANDARD SPEC. SECTION M.02.01 AND ASTM D1557. -24"x10"-0" GRIP STRUT COAX BRIDGE KIT WITH DIRECT BURIAL POSTS-MICROFLECT# B2959-REFER TO 9/C-5 FOR CABLE SUPPORT BRACKE IMPORTANCE CATEGORY m GRIP STRUT COAX BRIDGE KIT SNOW LOAD: GROUND SNOW LOAD(Pg) IMPORTANCE FACTOR (Is) EXPOSURE FACTOR (Ct) THERMAL FACTOR (Ct) CONTACT THE ENGINEER IF GROUND WATER IS IN ENCOUNTED AND DEWATERING IS REQUIRED. CONCRETE 0 ALL CONCRETE WORK SHALL BE IN ACCORDANCE WITH THE ACI 301, ACI 318 AND THE SPECIFICATION CAST—IN—PLACE CONCRETE. MIND LOAD: BASIC WIND LOAD EXPOSURE GROUP IMPORTANCE FACTOR (IW) SHELTER LOAD: FLOOR LIVE LOAD INCLUDING EQUIPMENT: EQUIPMENT SHELTER DL: 0 110 MPH (3 SECOND GUST) 0 -FINISHED GRADE ALL CONCRETE SHALL HAVE A MINIMUM COMPRESSIVE STRENGTH OF 3500 PSI AT 28 DAYS, UNLESS NOTED OTHERWISE. CONCRETE SHALL BE AIR ENTRAINED TO (4% TO 6%) AND SLUMP OF 3" TO 5". 0 0 1.15 3. REINFORCING STEEL SHALL CONFORM TO ASTM A 615, GRADE 60, DEFORMED UNLESS NOTED OTHERWISE. WELDED WIRE FABRIC SHALL CONFORM TO ASTM A 185 WELDED STEEL WIRE FABRIC UNLESS NOTED OTHERWISE. SPLICES SHALL BE CLASS "B" AND ALL HOOKS SHALL BE STANDARD, UNO. MICROFLECT B1752 SNAP IN HANGER BRACKET 0 SEISMIC DESIGN PARAMETERS: SEISMIC USE GROUP MCE SPECTRAL ACCELERATION SHORT (Sm) 0.273 MCE SPECTRAL ACCELERATION SHORT (Sm) 0.001 MCE SPECTRAL ACCELERATI 0 4'-0" o.c. MAX 4. THE FOLLOWING MINIMUM CONCRETE COVER SHALL BE PROVIDED FOR REINFORCING STEEL UNLESS SHOWN OTHERWISE ON DRAWINGS: CONCRETE IMPORTANCE FACTOR (I.) CONCRETE CAST AGAINST EARTH......................... IN. CONCRETE EXPOSED TO EARTH OR WEATHER: CABLE SUPPORT DETAIL 12"# SCALE: 1 1/2" = 1'-0" CONCRETE NOT EXPOSED TO EARTH OR WEATHER OR NOT CAST AGAINST THE GROUND: MAXIMUM 10' SPACING BETWEEN POST SUPPORTS POSTS REQUIRED A CHAMFER 3/4" SHALL BE PROVIDED AT ALL EXPOSED EDGES OF CONCRETE, UNO, IN ACCORDANCE WITH ACI 301 SECTION 4.2.4. \ ICE BRIDGE DETAIL 6. INSTALLATION OF CONCRETE EXPANSION/WEDGE ANCHOR, SHALL BE PER MANUFACTURER'S WRITTEN RECOMMENDED PROCEDURE. THE ANCHOR BOLT, DOWEL OR ROD SHALL CONFORM TO MANUFACTURER'S RECOMMENDATION FOR EMBEDWENT DEPTH OR AS SHOWN ON THE DRAWINGS. NO REBAR SHALL BE CUT WITHOUT PRIOR ENGINEERING APPROVAL WHEN DRILLING HOLES IN CONCRETE. C-5 CONCRETE CAP 1. THE CLEAN FILL SHALL PASS THROUGH A 3/8" MESH SCREEN AND SHALL NOT CONTAIN SHARP STONES, OTHER BACKFILL SHALL NOT CONTAIN ASHES, CINDERS, SHELLS, FROZEN MATERIAL, LOOSE DEBRIS OR STONES LARGER THAN 2" IN MAXIMUM DIMENSION, THE TRENCH SHALL BE BACKFILLED IMMEDIATELY FOLLOWING PLACEMENT OF THE CONDUITS. 7. COLD WEATHER CONCRETE PLACING SHALL BE IN ACCORDANCE WITH ACI-306. 8. NO FOOTING SHALL BE PLACED ON FROZEN GROUND, UNCURED CONCRETE SHALL BE PROTECTED AGAINST FROST. 6"# SCHEDULE 40 GALVANIZED STEEL PIPE FILLED W/ CONCRETE 9. APPLY NON-SUP BROOM FINISH IMMEDIATELY AFTER TROWEL FINISHING. 2. WHERE EXISTING UTILITIES ARE LIKELY TO BE ENCOUNTERED, CONTRACTOR SHALL HAND DIG AND PROTECT EXISTING UTILITIES. WIRE FENCING-POSTS -1. SET POSTS AND EXCAVATE A 6" X 6" TRENCH, SET POST ANGLE 10" UPSLOPE FOR STABILITY AND SELF CLEANING STRUCTURAL STEEL VARIES 1. MATERIALS FINISHED GRADE FINISHED GRADE ASTM A572 GRADE 50 ASTM A53 GRADE B ASTM A500 ASTM A325 ASTM E 70 ASTM A307 STRUCTURAL STEEL, PLATES, ANGLES PIPE COLUMNS TUBE COLUMNS BOLTS WELDING ELECTRODE ANCHOR BOLTS CABLE WARNING TAPE (RED) 12" BELOW GRADE — THE PROPERTY OF THE PARTY OF TH GRADE MATERIAL VARIES RESTORE GRADE MATERIAL AS REQUIRED TO MATCH STRUCTURAL STEEL SHALL CONFORM TO THE CURRENT "AISC SPECIFICATION FOR THE DESIGN, FABRICATION, AND ERECTION OF STRUCTURAL STEEL FOR BUILDINGS", AND THE "AISC CODE OF STANDARD PRACTICE FOR STEEL BUILDINGS AND BRIDGES". BACKFILL W/SUITABLE MATERIAL COMPACTED TO 95% MAXIMUM DENSITY (ASTM D 1557) 30" MIN. ALL WELDING SHALL BE DONE BY A CERTIFIED WELDER IN ACCORDANCE WITH A.W.S. STANDARDS. CLEAN FILL-4. BACKFILL THE TRENCH AND COMPACT THE EXCAVATED SOIL COMPACTED BACKFILL — 0 1'-2"# TYPICAL ELECTRICAL/ TELEPHONE TRENCH DETAIL **BOLLARD DETAIL** SEDIMENTATION CONTROL BARRIER - SILT FENCE SCALE: N.T.S. C-5 SCALE: 1"-1'-0" SCALE: N.T.S. PAVEMENT | GRAVEL (2) CONTINUOUS TOP RAIL COORDINATE WITH ELECTRICAL AND TELEPHONE REQUIREMENTS ADJUSTABLE RIDE AND TURNBUCKLE ASSEMBLY AT ALL CORNERS HEAVY DUTY ARM LATCH 1 1/4 8 V 3/16" (TYP. 3" CORNER - 2"ø GALVANIZED LINE POSTS 1 5/8"# PIPE FRAME GATE TENSION BOTTOM RAIL FOR 6'-0" GATE LEAF B" GRAVEL COMPOUND FINISH-3/4" GRAVEL THOROUGHLY COMPACTED — SLOPE TOP OF CONCRETE FINISHED 355555 REKERKEKERA FINISHED GRADE MATERIAL TO MATCH CONCRETE BABBBBBBBBB NOIL: THE SHADED AREA WITHIN THE FENCED COMPOUND, 1' MIN. BEYOND THE FENCE AS FOLLOWS: -ALL EXISTING PAVEMENT, BRUSH, GRASS, TOP SOIL, ROCKS, DEBRIS, ETC. SHALL BE CLEARED FROM THE DESIGNATED AREA TO A DEPTH OF 8'. WOVEN GEOTEXTILE FABRIC (AMOCO 2002 OR APPROVED EQUAL) SHALL BE PUT DOWN AND ROLLED GRAVEL BASE COURSE SHALL THEN BE PLACED TO A MINIMUM OF 8'. THE ACCESS DRIVE SHALL BE TREATED AS NOTED ON DETAIL 7/C-5. - CONCRETE TAGLES: 1. FENCE POST SPACING NOT TO EXCEED 10'-0" O.C. 2. TENSION ALL BARBED WIRE TO SNUG TIGHT, 3. VERIFY ALL DIMENSIONS WITH FENCE MANUFACTURER'S REQUIREMENTS. GRAVEL COMPOUND DETAIL ELECTRIC AND TELCO SERVICE FRAME DETAIL TYPICAL FENCE DETAIL - SECTION TYPICAL FENCE DETAIL C-5 SCALE: N.T.S. SCALE: 1/2"=1'-0"

urs corporation aes 500 ENTERPRISE DRIVE

ROCKY HILL, CONNECTICUT

LANE SEAL OF 20/4310

PROJECT NO: 36928481

JOB NO: GS1-001

JES

DRAWN BY

CHECKED BY:

ISSUED FOR A 06-11-08 REVIEW

0 07-07-08 D&M 07-22-08 REVISED DAM 2 08-11-08 DAM APPROVAL


THE INFORMATION CONTAINED IN THIS SET OF DOCUMENTS IS PROPRIETARY BY NATURE. ANY USE OR DISCLOSURE OTHER THAN THAT WHICH RELATES TO GLOBAL SIGNAL IS STRICTLY PROHIBITED.

**GUILFORD** 

1919 BOSTON POST ROAD GUILFORD, CONNECTICUT

AS NOTED

SITE DETAILS AND NOTES

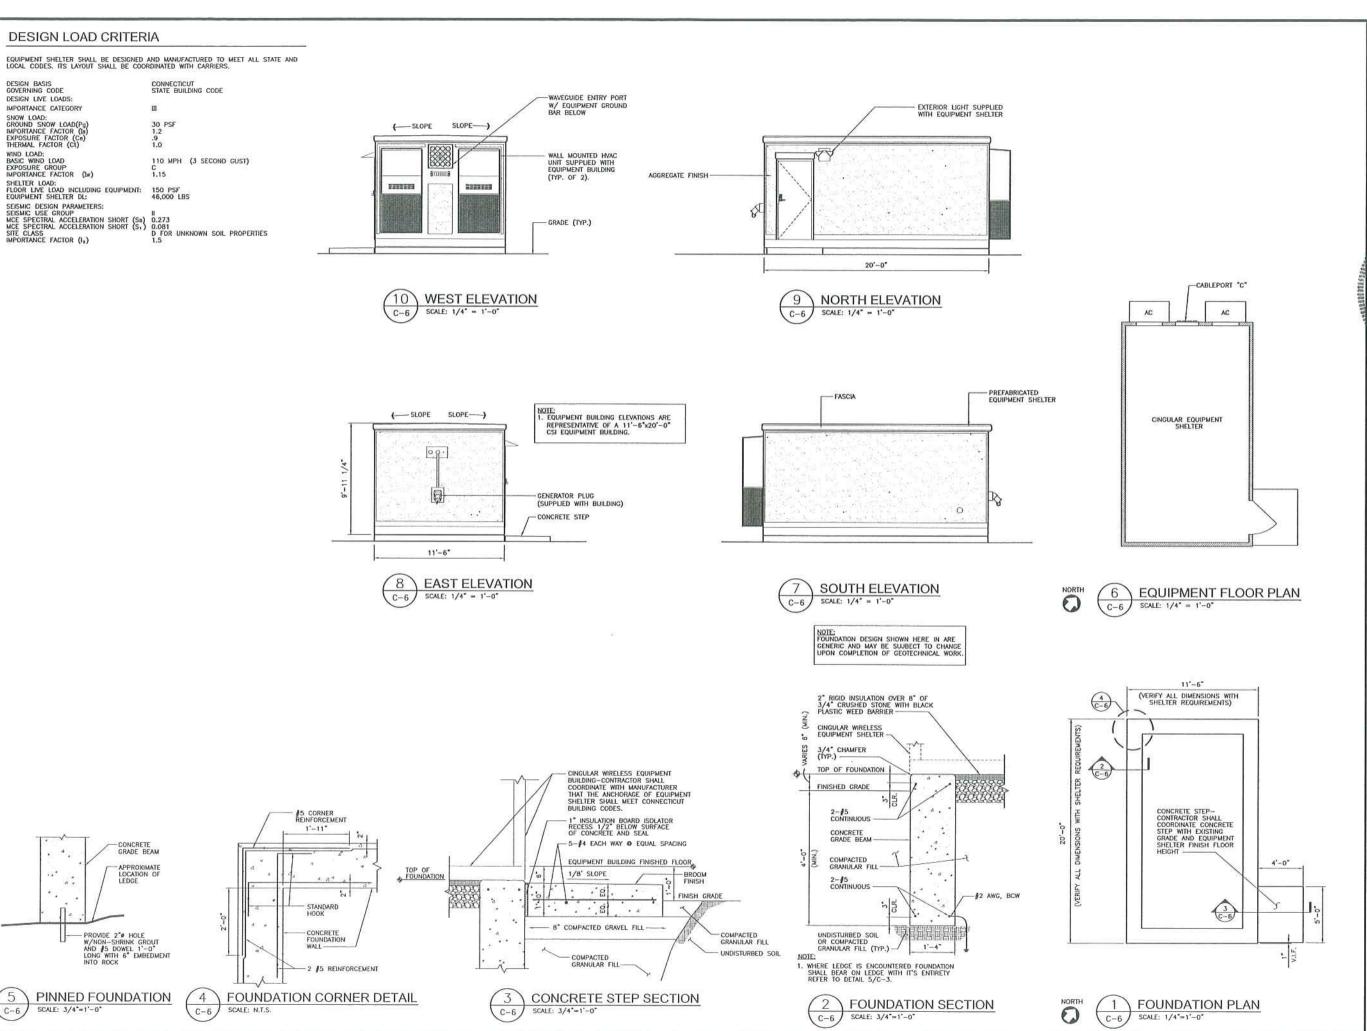

AME FIRM

# URS CORPORATION AES

500 ENTERPRISE DRIVE ROCKY HILL, CONNECTICUT 1-(860)-529-8882



PROJECT NO: 36928481

JOB NO: GS1-001

JES

DRAWN BY:

CHECKED BY:

ISSUED FOR A 06-11-08 REVIEW 0 07-07-08 D&M 1 07-22-08 REVISED DAM 2 08-11-08 D&W APPROVAL

THE INFORMATION CONTAINED IN THIS SET OF DOCUMENTS IS PROPRIETARY BY NATURE. ANY USE OR DISCLOSURE OTHER THAN THAT WHICH RELATES TO GLOBAL SIGNAL IS STRICTLY PROHIBITED.


**GUILFORD** 

1919 BOSTON POST ROAD GUILFORD, CONNECTICUT

SCALE:

CINGULAR WIRELESS EQUIPMENT SHELTER **ELEVATIONS AND DETAILS** 

AS NOTED

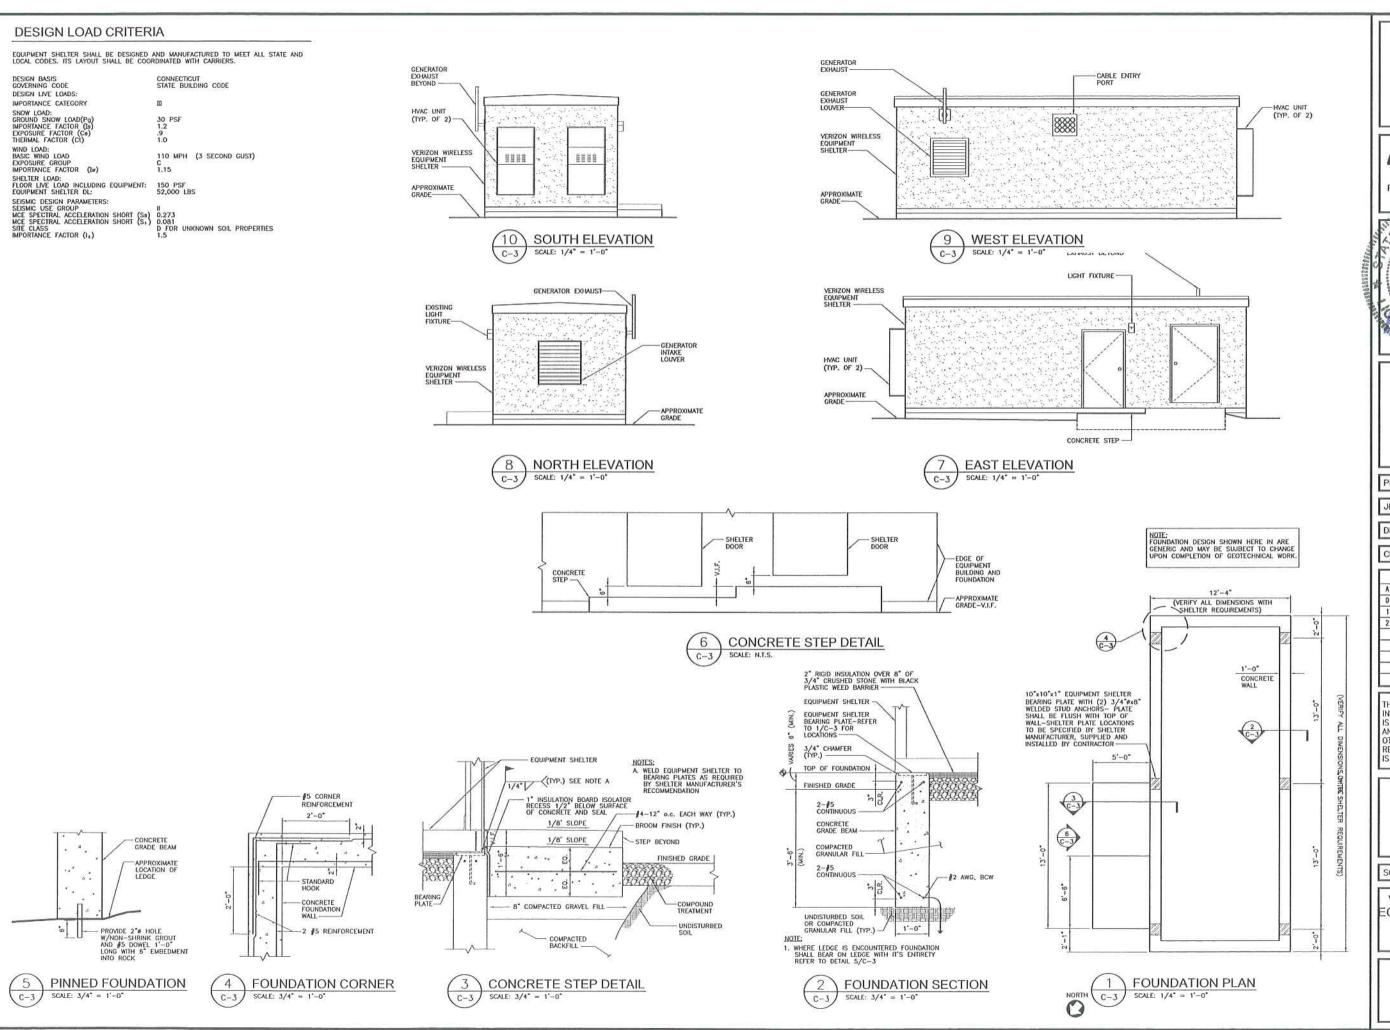

AME FIRM

URS CORPORATION AES

500 ENTERPRISE DRIVE ROCKY HILL, CONNECTICUT 1-(860)-529-8882



PROJECT NO: 36928481

JOB NO: GS1-001

JES/RRH DRAWN BY:

CHECKED BY:

ISSUED FOR A 06-11-08 REVIEW 0 07-07-08 D&M 07-22-08 REVISED DAM 2 08-11-08 D&M APPROVAL


THE INFORMATION CONTAINED IN THIS SET OF DOCUMENTS IS PROPRIETARY BY NATURE.
ANY USE OR DISCLOSURE RELATES TO GLOBAL SIGNAL IS STRICTLY PROHIBITED.

GUILFORD

1919 BOSTON POST ROAD GUILFORD, CONNECTICUT

SCALE: AS NOTED

VERIZON WIRELESS EQUIPMENT SHELTER **ELEVATIONS AND** SITE DETAILS

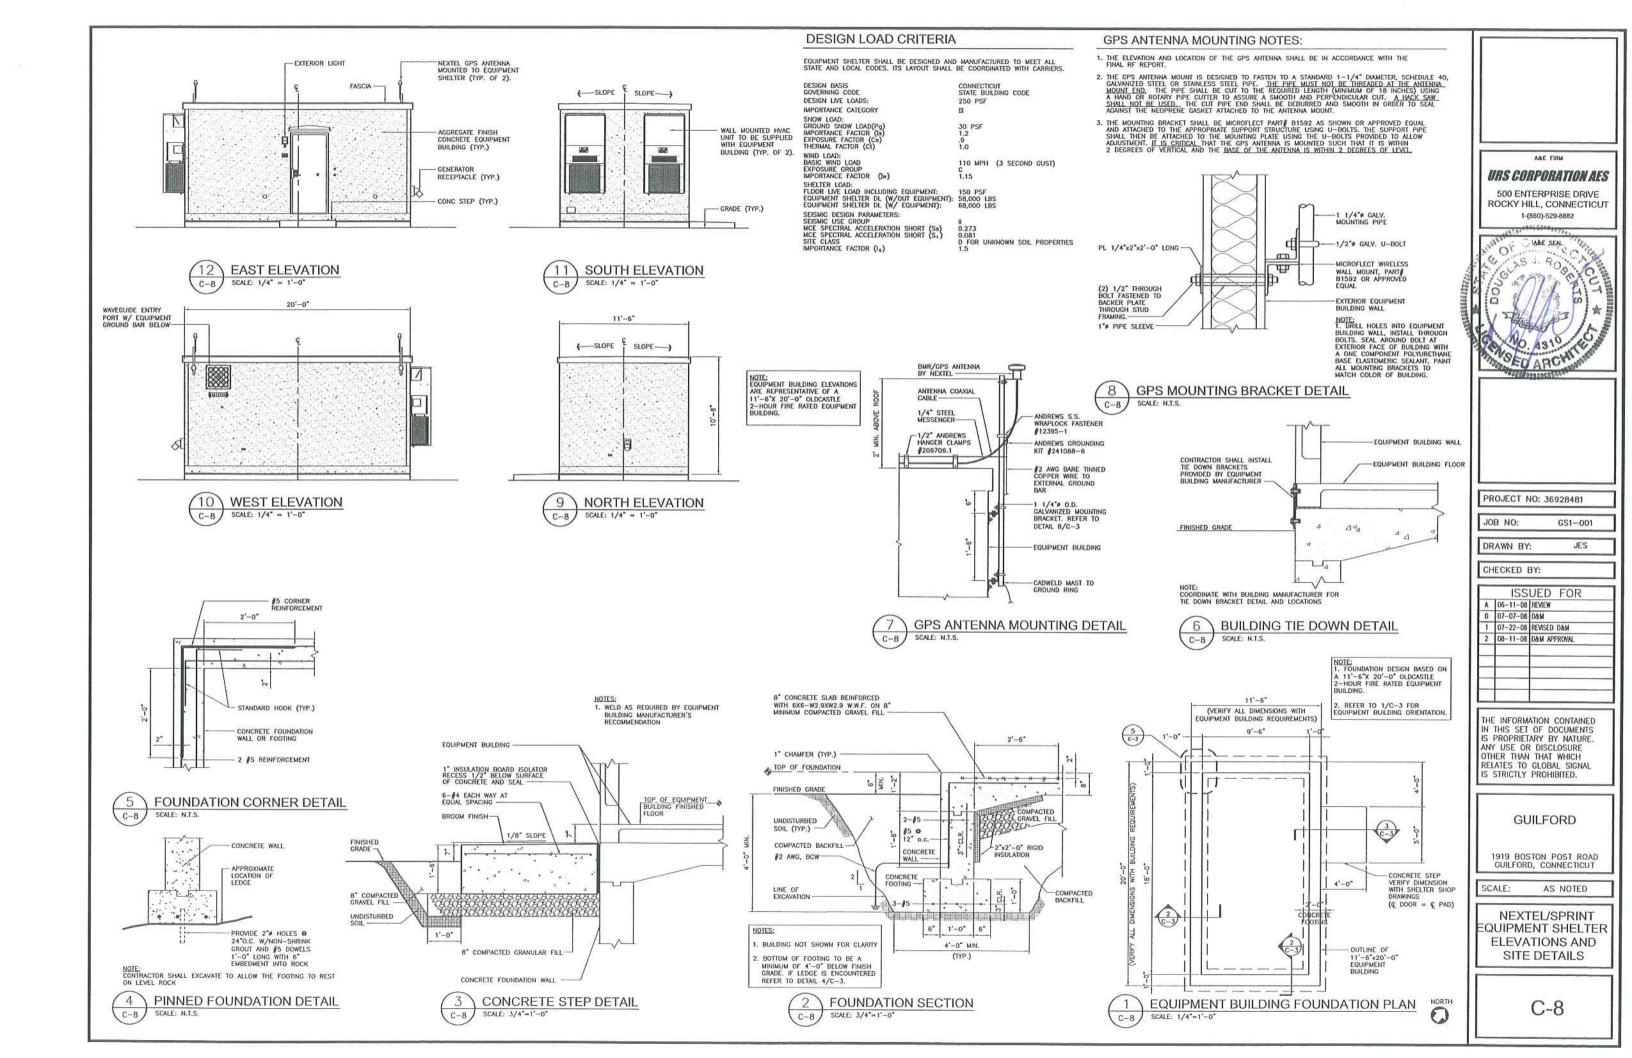

## **DESIGN LOAD CRITERIA**

EQUIPMENT SHELTER SHALL BE DESIGNED AND MANUFACTURED TO MEET ALL STATE AND LOCAL CODES. IT'S LAYOUT SHALL BE COORDINATED WITH CARRIERS.

ш

DESIGN BASIS GOVERNING CODE DESIGN LIVE LOADS:

CONNECTICUT STATE BUILDING CODE

IMPORTANCE CATEGORY

SNOW LOAD: GROUND SNOW LOAD(Pg) IMPORTANCE FACTOR (Is) EXPOSURE FACTOR (Ce) THERMAL FACTOR (CI) 30 PSF 1.2 1.0

WIND LOAD: BASIC WIND LOAD EXPOSURE GROUP IMPORTANCE FACTOR (Iw)

110 MPH (3 SECOND GUST)


1.15 9,000 LBS

EQUIPMENT LOAD: EQUIPMENT DL:


EGUIPMENT DL: 9,000 LBS

SEISMIC DESIGN PARAMETERS:
SEISMIC USE GROUP
MCE SPECTRAL ACCELERATION SHORT (Sp)
D FOR UNKNOWN SOIL PROPERTIES
IMPORTANCE FACTOR (Ic)

1.5

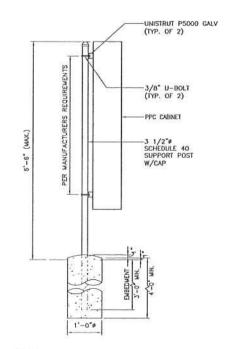



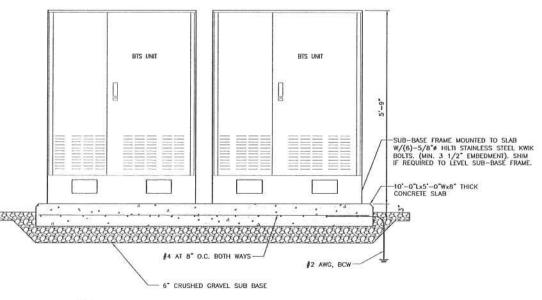

SECTION AT T-MOBILE EQUIPMENT SLAB SCALE: NTS

# URS CORPORATION AES

500 ENTERPRISE DRIVE ROCKY HILL, CONNECTICUT



PROJECT NO: 36928481

JES

JOB NO: GS1-001

DRAWN BY:

CHECKED BY:

٨	06-11-08	
0	07-07-08	
1	07-22-08	REVISED DAM
2	08-11-08	DAM APPROVAL
	_	

THE INFORMATION CONTAINED IN THIS SET OF DOCUMENTS IS PROPRIETARY BY NATURE. ANY USE OR DISCLOSURE OTHER THAN THAT WHICH RELATES TO GLOBAL SIGNAL IS STRICTLY PROHIBITED.

GUILFORD

1919 BOSTON POST ROAD CUILFORD, CONNECTICUT

SCALE:

AS NOTED T-MOBILE

**EQUIPMENT** SECTIONS