PROJECT SUMMARY

SITE NAME:

BRIDGEWATER 4

SITE ADDRESS:

42 & 89 WEWAKA BROOK RD

BRIDGEWATER CT 06752

MARY ALLEN, EDWARD AND

JURISDICTION:

CT SITING COUNCIL

COUNTY:

LITCHFIELD COUNTY

ZONING:

PROPERTY OWNER:

CYNTHIA BENNETT

APPLICANT:

SBA TOWERS III LLC 5900 BROKEN SOUND PARKWAY BOCA RATON, FL 33487-2797 OFFICE: (561) 226-9523

FAX: (561) 226-3572 HOLLIS REDDING (203) 464-3623

SITE COORDINATES:

LATITUDE: N. 41° 30′ 31.5″

LONGITUDE: ELEVATION:

W. 73° 21' 16.0"

(NAD 83) (NAD 83) (NAVD 88)

UNMANNED OCCUPANCY: CONSTRUCTION TYPE: RAW LAND

HANDICAPPED REQUIREMENTS

FACILITY IS UNMANNED AND NOT FOR HUMAN HABITATION. HANDICAP ACCESS NOT REQUIRED.

PLUMBING REQUIREMENTS

FACILITY HAS NO PLUMBING.

CONSULTING TEAM

ARCHITECTURAL - ENGINEERING FIRM:

2139 SILAS DEANE HIGHWAY, SUITE 212, ROCKY HILL, CT 06067 CONTACT: PAUL LUSITANI

PHONE: (860) 257-4557 FAX: (860) 257-7514

SURVEYING FIRM:

CHA 2139 SILAS DEANE HIGHWAY, SUITE 212, ROCKY HILL, CT 06067 CONTACT: PAUL LUSITANI PHONE: (860) 257–4557 FAX: (860) 257–7514

TELEPHONE COMPANY:

1441 NORTH COLONY ROAD, MERIDEN, CT CONTACT: UKNOWN

PHONE: (203) 420-3131

POWER COMPANY:

107 SELDEN STREET, BERLIN, CT CONTACT: UNKNOWN


PHONE: (860) 947-2000

ELECTRICAL ENGINEER:

2139 SILAS DEANE HIGHWAY, SUITE 212, ROCKY HILL, CT 06067

CONTACT: PAUL LUSITANI

PHONE: (860) 257-4557 FAX: (860) 257-7514

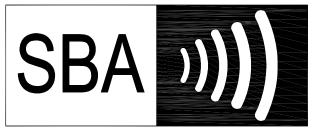

DEVELOPMENT & MANAGEMENT PLANS CSC DOCKET NO. 412


SITE NAME BRIDGEWATER 4

SITE I.D. CT11934

E911 ADDRESS

42 & 89 WEWAKA BROOK ROAD BRIDGEWATER, CT 06752

PROJECT TYPE 170' MONOPOLE TOWER HEIGHT NOT TO EXCEED 170'

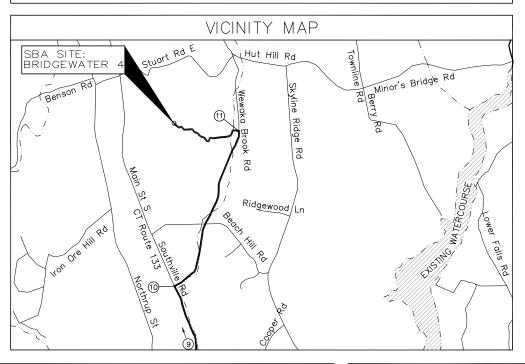

DRIVING DIRECTIONS

FROM HARTFORD: 1. TAKE I-84W TOWARD WATERBURY


- TAKE EXIT 10 FOR US-6W TOWARD NEWTOWN/SANDY HOOK
- TURN RIGHT ONTO CT-34W/US-6W/CHURCH HILL ROAD TURN RIGHT ONTO THE BLVD TURN RIGHT TO STAY ON THE BLVD

- CONTINUE STRAIGHT ONTO HANOVER ROAD
- CONTINUE ONTO DINGLEBROOK LANE CONTINUE ONTO OBTUSE ROCKS ROAD
- TURN RIGHT ONTO CT-133N/OBTUSE HILL ROAD. CONTINUE TO FOLLOW CT-133N
- 10. TURN RIGHT ONTO WEWAKA ROAD/WEWAKA BROOK ROAD
- TURN LEFT INTO DRIVEWAY AT 89 WEWAKA BROOK ROAD. CROSS OVER BRIDGE AND TURN LEFT AT EXISTING RESIDENCE TO FOLLOW ACCESS DRIVE TO TOWER.

SHEET SCALE FACTOR: PLOT SIZE: 11"x17": "TO SCALE"

24"x36": 1/2 SCALE AS NOTED



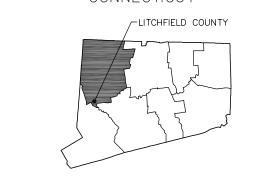


SHFFT INDEX

| NO. DESCRIPTION T-1 TITLE SHEET T-2 ABBREVIATIONS & SYMBOLS LEGEND GN-1 GENERAL NOTES EN-1 ENVIRONMENTAL NOTES C-1 SITE PLAN C-2 PHOTO PLAN C-3A SITE GRADING PLAN - 1 OF 3 C-3B SITE GRADING PLAN - 2 OF 3 C-3C SITE BRAINAGE PLAN - 1 OF 3 C-4A SITE DRAINAGE PLAN - 1 OF 3 C-4B SITE DRAINAGE PLAN - 2 OF 3 C-4C SITE DRAINAGE PLAN - 2 OF 3 C-4C SITE DRAINAGE PLAN - 3 OF 3 C-5 ENLARGED SITE PLAN C-6 SITE ELEVATIONS C-7A PROFILE - 1 OF 3 C-7B PROFILE - 2 OF 3 C-7C PROFILE - 3 OF 3 C-8 SITE DETAILS C-9 FENCE DETAILS C-10 FENCE DETAILS C-11 SITE DETAILS E-1 UTILITY SITE PLAN E-2 UTILITY DETAILS E-3 SINGLE-LINE DIAGRAM & PANEL SCHEDULE EG-1 GROUNDING PLAN & DETAILS EG-2 GROUNDING DETAILS EG-3 GROUNDING DETAILS | OTTLET HINDEX | | | |
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| C-3C SITE GRADING PLAN - 3 OF 3 C-4A SITE DRAINAGE PLAN - 1 OF 3 C-4B SITE DRAINAGE PLAN - 2 OF 3 C-4C SITE DRAINAGE PLAN - 3 OF 3 C-5 ENLARGED SITE PLAN C-6 SITE ELEVATIONS C-7A PROFILE - 1 OF 3 C-7B PROFILE - 2 OF 3 C-7C PROFILE - 3 OF 3 C-8 SITE DETAILS C-9 FENCE DETAILS C-10 FENCE DETAILS C-11 SITE DETAILS E-1 UTILITY SITE PLAN E-2 UTILITY DETAILS E-3 SINGLE-LINE DIAGRAM & PANEL SCHEDULE EG-1 GROUNDING PLAN & DETAILS EG-2 GROUNDING DETAILS | C-3A | SITE GRADING PLAN - 1 OF 3 | | |
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| C-4B SITE DRAINAGE PLAN - 2 OF 3 C-4C SITE DRAINAGE PLAN - 3 OF 3 C-5 ENLARGED SITE PLAN C-6 SITE ELEVATIONS C-7A PROFILE - 1 OF 3 C-7B PROFILE - 2 OF 3 C-7C PROFILE - 3 OF 3 C-8 SITE DETAILS C-9 FENCE DETAILS C-10 FENCE DETAILS C-11 SITE DETAILS E-1 UTILITY SITE PLAN E-2 UTILITY DETAILS E-3 SINGLE-LINE DIAGRAM & PANEL SCHEDULE EG-1 GROUNDING PLAN & DETAILS EG-2 GROUNDING DETAILS | C-3C | SITE GRADING PLAN - 3 OF 3 | | |
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| C-7B PROFILE - 2 OF 3 C-7C PROFILE - 3 OF 3 C-8 SITE DETAILS C-9 FENCE DETAILS C-10 FENCE DETAILS C-11 SITE DETAILS E-1 UTILITY SITE PLAN E-2 UTILITY DETAILS E-3 SINGLE-LINE DIAGRAM & PANEL SCHEDULE EG-1 GROUNDING PLAN & DETAILS EG-2 GROUNDING DETAILS | C-6 | SITE ELEVATIONS | | |
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| C-9 FENCE DETAILS C-10 FENCE DETAILS C-11 SITE DETAILS E-1 UTILITY SITE PLAN E-2 UTILITY DETAILS E-3 SINGLE-LINE DIAGRAM & PANEL SCHEDULE EG-1 GROUNDING PLAN & DETAILS EG-2 GROUNDING DETAILS | C-7C | PROFILE - 3 OF 3 | | |
| C-10 FENCE DETAILS C-11 SITE DETAILS E-1 UTILITY SITE PLAN E-2 UTILITY DETAILS E-3 SINGLE-LINE DIAGRAM & PANEL SCHEDULE EG-1 GROUNDING PLAN & DETAILS EG-2 GROUNDING DETAILS | C-8 | SITE DETAILS | | |
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| E-3 SINGLE-LINE DIAGRAM & PANEL SCHEDULE EG-1 GROUNDING PLAN & DETAILS EG-2 GROUNDING DETAILS | E-1 | UTILITY SITE PLAN | | |
| EG-1 GROUNDING PLAN & DETAILS EG-2 GROUNDING DETAILS | E-2 | UTILITY DETAILS | | |
| EG-2 GROUNDING DETAILS | E-3 | SINGLE-LINE DIAGRAM & PANEL SCHEDULE | | |
| | EG-1 | GROUNDING PLAN & DETAILS | | |
| EG-3 GROUNDING DETAILS | EG-2 | GROUNDING DETAILS | | |
| | EG-3 | GROUNDING DETAILS | | |
| | | | | |

| APPROVALS |
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| |

DATE LANDLORD

STATE COUNTY MAP

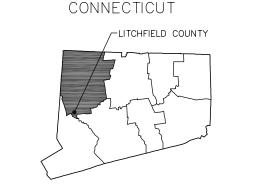

SBA I LUC 5900 BROKEN SOUND PARKWAY, NW BOCA RATON, FL 33487–2797 TEL: (561) 226–9523 FAX: (561) 226–9368



THE INFORMATION CONTAINED IN THIS SET OF DOCUMENTS IS PROPRIETARY BY NATURE. ANY USE OR DISCLOSURE OTHER THAN THAT WHICH RELATES TO THE CLIENT IS STRICTLY PROHIBITED

| A&E PROJECT #: | 15363-1054-43000 | |
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| DRAWN BY: | JDM | |
| CHECKED BY: | PAL | |
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| | REVISIONS | | | |
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| A | 10/01/12 | REVISED UTILITIES | | |
| \triangle | 06/22/12 | ISSUED FOR CONSTRUCTION | | |
| NO. | DATE | DESCRIPTION | | |
| | | | | |



15363-1054-43000

BRIDGEWATER

SITE NUMBER: CT 11934

SITE ADDRESS:

WEWAKA BROOK ROAD BRIDGEWATER, CT 06752

RAW LAND

TITLE SHEET

DRAWING NO.

Г-1

ABBREVIATIONS

| AB | ANCHOR BOLT | GR | GRADE |
|----------|----------------------|---------|----------------------|
| AC | ASPHALTIC CONCRETE | GYP | GYPSUM |
| A/C | AIR CONDITIONING | GFCI | GROUND FAULT CIRCUIT |
| ADJ | ADJUSTABLE | | INTERRUPT |
| A.F.F. | ABOVE FINISH FLOOR | GND | GROUND |
| ARCH | ARCHITECTURAL | HC | HOLLOW CORE |
| APPROX | APPROXIMATELY | HDW | HARDWARE |
| A.G.L. | ABOVE GRADE LEVEL | HTR | HEATER |
| A.M.S.L. | ABOVE MEAN SEA LEVEL | НМ | HOLLOW METAL |
| BD | BOARD | HORIZ | HORIZONTAL |
| BLDG | BUILDING | HR | HOUR |
| BLKG | BLOCKING | НТ | HEIGHT |
| BOT | ВОТТОМ | HV | HIGH VOLTAGE |
| BSMT | BASEMENT | ID | INSIDE DIMENSION |
| BTS | BASE TRANSCEIVER | INS | INSULATION |
| | STATION | INT | INTERIOR |
| С | COURSE(S) | JT | JOINT |
| CEM | CEMENT | LAM | LAMINATED |
| CL | CHAIN LINK | LBS | POUNDS |
| CLG | CEILING | LT | LIGHT |
| CLR | CLEAR | LA | LIGHTNING ARRESTOR |
| COL | COLUMN | LNA | LOW NOISE AMPLIFIER |
| CONC | CONCRETE | MFR | MANUFACTURER |
| CONST | CONSTRUCTION | MAT | MATERIAL |
| CONT | CONTINUOUS | MAX | MAXIMUM |
| CORR | CORRIDOR | MECH | MECHANICAL |
| CO | CONDUIT ONLY | MIN | MINIMUM |
| DIA | DIAMETER | MISC | MISCELLANEOUS |
| DBL | DOUBLE | ML | METAL LATH |
| DEPT | DEPARTMENT | MO | MASONRY OPENING |
| DEMO | DEMOLITION | MS | MACHINE SCREW |
| DIM | DIMENSION | MTD | MOUNTED |
| DN | DOWN | MTL | METAL |
| DR | DOOR | (N) | NEW |
| DTL | DETAIL | NIC | NOT IN CONTRACT |
| DWG | DRAWING | NO | NUMBER |
| (E) | EXISTING | NTS | NOT TO SCALE |
| EA | EACH | 0 | OVERHEAD |
| ELEC | ELECTRIC | OA | OVERALL |
| ELEV | ELEVATION | 0.C. | ON CENTER |
| EQUIP | EQUIPMENT | OPNG | OPENING |
| EXP | EXPANSION | OPP | OPPOSITE |
| EXT | EXTERIOR | PARTN | PARTITION |
| FA | FIRE ALARM | PL | PLATE |
| FB | FLAT BAR | PLAS | PLASTER |
| FF | FINISH FLOOR | PLYWD | PLYWOOD |
| FH | FLAT HEAD | POC | POINT OF CONNECTION |
| FIN | FINISH(ED) | PROP | PROPERTY |
| FLR | FLOOR | PT - | PRESSURE TREATED |
| FOS | FACE OF STUDS | R | RISER |
| FS | FINISH SURFACE | REQD | REQUIRED |
| FT | FOOT, FEET | RD | ROOF DRAIN |
| FTG | FOOTING | RM | ROOM |
| | | | |

RMS

RO

SC

SCHED

SECT

SHT

ROOMS

ROUGH OPENING


SOLID CORE

SCHEDULE

SECTION

SHEET

| SIM | SIMILAR |
|--------|-------------------------|
| SPECS | SPECIFICATIONS |
| SS | STAINLESS STEEL |
| STL | STEEL |
| STOR | STORAGE |
| STRUCT | STRUCTURAL |
| SUSP | SUSPENDED |
| SW | SWITCH |
| SWBO | SWITCHBOARD |
| THK | THICK |
| TI | TENANT IMPROVEMENT |
| TMA | TOWER MOUNTED AMPLIFIER |
| TOS | TOP OF SURFACE |
| TS | TUBE STEEL |
| TYP | TYPICAL |
| U | UNDERGROUND |
| UNO | UNLESS NOTED |
| | OTHERWISE |
| VCT | VINYL |
| | COMPOSITION |
| | TILE |
| VERT | VERTICAL |
| V.I.F. | VERIFY IN FIELD |
| VG | VERTICAL GRAIN |
| W/ | WITH |
| WD | WOOD |
| WR | WATER RESISTANT |
| WT | WEIGHT |
| XFMR | TRANSFORMER |
| a) | AT |
| | CHANNEL |
| Ģ | CENTERLINE |

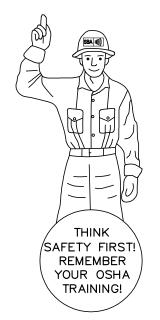

ANGLE

PROPERTY LINE

MASONRY

BRICK CONCRETE

EARTH STEEL

GRAVEL CENTER LINE

PROPERTY LINE LEASE LINE

EASEMENT LINE RIGHT-OF-WAY

CHAIN LINK FENCE

WOOD FENCE

SILT FENCE BELOW GRADE

ELECTRIC BELOW GRADE

TELEPHONE OVERHEAD

OVERHEAD

CONTOUR

FENCE

TREE LINE

WATER LINE

TREE PROTECTION

TREES, SHRUBS, BUSHES

SANITARY SEWER LINE

NATURAL GAS LINE


TELEPHONE OVERHEAD ELECTRIC

ELECTRIC/TELEPHONE

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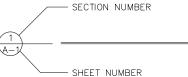
____OE/OT____




BUILDING SECTION REFERENCE

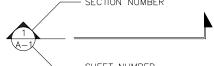

DETAIL REFERENCE



DETAIL SECTION REFERENCE

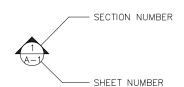

ELEVATION VIEW REFERENCE



101 AREA AND/OR ROOM NUMBER




UTILITY POLE







ELEVATION REFERENCE

SYMBOLS:

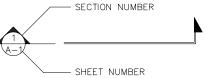

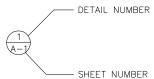


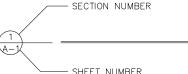




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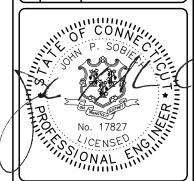
SBA TOWERS III LLC 5900 BROKEN SOUND PARKWAY, NW BOCA RATON, FL 33487–2797 TEL: (561) 226–9523 FAX: (561) 226–9368

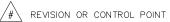

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OTHER THAN THAT WHICH RELATES
TO THE CLIENT IS STRICTLY PROHIBITED

| ١ | A&E PROJECT #: | 15363-1054-43000 |
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| ١ | DRAWN BY: | JDM |
| ١ | CHECKED BY: | PAL |
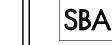
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| NO. | DATE | DESCRIPTION | |



PROJECT No. 15363-1054-43000

BRIDGEWATER

SITE NUMBER:

CT 11934

SITE ADDRESS: WEWAKA BROOK ROAD BRIDGEWATER, CT 06752

DESIGN TYPE:

RAW LAND

ABBREVIATIONS & SYMBOLS LEGEND

T-2



FW

F.G.

FUT

GΑ

GL

GALV

FINISH WALL

GALVANIZED

FUTURE

GAUGE

GLASS

FINISH GRADE

- 1. ALL REFERENCES TO OWNER HEREIN SHALL BE CONSTRUED TO MEAN SBA OR IT'S DESIGNATED REPRESENTATIVE.
- 2. ALL WORK PRESENTED ON THESE DRAWINGS MUST BE COMPLETED UNLESS NOTED OTHERWISE. THE CONTRACTOR MUST HAVE CONSIDERABLE EXPERIENCE IN PERFORMANCE OF WORK SIMILAR TO THAT DESCRIBED HEREIN. BY ACCEPTANCE OF THIS ASSIGNMENT, THE CONTRACTOR IS ATTESTING THAT HE DOES HAVE SUFFICIENT EXPERIENCE AND ABILITY. THAT HE IS KNOWLEDGEABLE OF THE WORK TO BE PERFORMED AND THAT HE IS LICENSED AND PROPERLY REGISTERED TO DO THIS WORK IN THE STATE AND/OR COUNTY IN WHICH IT IS TO BE PERFORMED.
- 3. UNLESS SHOWN OR NOTED OTHERWISE ON THE CONTRACT DRAWINGS, OR IN THE SPECIFICATIONS, THE FOLLOWING NOTES SHALL APPLY TO THE MATERIALS LISTED HEREIN, AND TO THE PROCEDURES TO BE USED ON THIS PROJECT.
- ALL HARDWARE ASSEMBLY MANUFACTURER'S INSTRUCTIONS SHALL BE FOLLOWED EXACTLY AND SHALL SUPERCEDE ANY CONFLICTING NOTES ENCLOSED HEREIN.
- 5. IT IS THE CONTRACTOR'S SOLE RESPONSIBILITY TO DETERMINE ERECTION PROCEDURE AND SEQUENCE TO INSURE THE SAFETY OF THE STRUCTURE AND ITS COMPONENT PARTS DURING ERECTION AND/OR FIELD MODIFICATIONS. THIS INCLUDES, BUT IS NOT LIMITED TO, THE ADDITION OF WHATEVER TEMPORARY BRACING, GUYS OR TIE DOWNS THAT MAY BE NECESSARY. SUCH MATERIAL SHALL BE REMOVED AND SHALL REMAIN THE PROPERTY OF THE CONTRACTOR AFTER COMPLETION OF THE PROJECT.
- ALL DIMENSIONS, ELEVATIONS AND EXISTING CONDITIONS SHOWN ON THE DRAWINGS SHALL BE FIELD VERIFIED BY THE CONTRACTOR AND THE TESTING AGENCY PRIOR TO BEGINNING ANY MATERIALS ORDERING, FABRICATION OR CONSTRUCTION WORK ON THIS PROJECT. ANY DISCREPANCIES SHALL BE IMMEDIATELY BROUGHT TO THE ATTENTION OF THE OWNER AND THE OWNER'S ENGINEER. THE DISCREPANCIES MUST BE RESOLVED BEFORE THE CONTRACTOR IS TO PROCEED WITH THE WORK. THE CONTRACT DOCUMENTS DO NOT INDICATE THE METHOD OF CONSTRUCTION. THE CONTRACTOR SHALL SUPERVISE AND DIRECT THE WORK AND SHALL BE SOLELY RESPONSIBLE FOR ALL CONSTRUCTION MEANS, METHODS, TECHNIQUES, SEQUENCES AND PROCEDURES, OBSERVATION VISITS TO THE SITE BY THE OWNER AND/OR THE ENGINEER SHALL NOT INCLUDE INSPECTION OF THE PROTECTIVE MEASURES OR THE CONSTRUCTION PROCEDURES.
- 7. ALL MATERIALS AND EQUIPMENT FURNISHED SHALL BE NEW AND OF GOOD QUALITY, FREE FROM FAULTS AND DEFECTS AND IN CONFORMANCE WITH THE CONTRACT DOCUMENTS. ANY AND ALL SUBSTITUTIONS MUST BE PROPERLY APPROVED AND AUTHORIZED IN WRITING BY THE OWNER AND ENGINEER PRIOR TO INSTALLATION. THE CONTRACTOR SHALL FURNISH SATISFACTORY EVIDENCE AS TO THE KIND AND QUALITY OF THE MATERIALS AND EQUIPMENT BEING SUBSTITUTED.
- THE CONTRACTOR SHALL BE RESPONSIBLE FOR INITIATING, MAINTAINING AND SUPERVISING ALL SAFETY PRECAUTIONS AND PROGRAMS IN CONNECTION WITH THE WORK. THE CONTRACTOR IS RESPONSIBLE FOR INSURING THAT THIS PROJECT AND RELATED WORK COMPLIES WITH ALL APPLICABLE LOCAL, STATE AND FEDERAL SAFETY CODES AND REGULATIONS GOVERNING THIS WORK.
- 9. ALL WORK SHALL BE COMPLETED IN ACCORDANCE WITH THE LATEST EDITION OF THE LOCAL BUILDING CODE.
- 10. ALL PROPOSED CELLULAR EQUIPMENT AND FIXTURES SHALL BE FURNISHED BY OWNER FOR INSTALLATION BY THE CONTRACTOR, UNLESS SPECIFICALLY NOTED OTHERWISE HEREIN.
- 11. ACCESS TO THE PROPOSED WORK SITE MAY BE RESTRICTED. THE CONTRACTOR SHALL COORDINATE INTENDED CONSTRUCTION ACTIVITY, INCLUDING WORK SCHEDULE AND MATERIALS ACCESS WITH THE RESIDENT LEASING AGENT FOR APPROVAL.
- 12. RADIO EQUIPMENT INSTALLATION SHALL BE IN ACCORDANCE WITH THE MANUFACTURER'S

- DESIGN REQUIREMENTS PER LOCAL BUILDING CODE AND THE EIA/TIA-222-F STRUCTURAL STANDARDS FOR STEEL ANTENNAS TOWERS AND SUPPORTING STRUCTURES.
- STRUCTURAL STEEL SHALL CONFORM TO THE LATEST EDITION OF A.I.S.C. SPECIFICATIONS FOR STRUCTURAL STEEL BUILDINGS-ALLOWABLE STRESS DESIGN AND PLASTIC DESIGN INCLUDING THE COMMENTARY AND THE A.I.S.C. CODE OF STANDARD PRACTICE.
- STRUCTURAL STEEL PLATES AND SHAPES SHALL CONFORM TO ASTM A36. ALL STRUCTURAL STEEL PIPES SHALL CONFORM TO ASTM A53 GRADE 8. ALL STRUCTURAL STEEL TUBING SHALL CONFORM TO ASTM A500 GRACE 8. ALL STRUCTURAL STEEL COMPONENTS AND FABRICATED ASSEMBLIES SHALL BE HOT DIP GALVANIZED AFTER FABRICATION.
- WELDING SHALL BE IN ACCORDANCE WITH THE AMERICAN WELDING SOCIETY (AWS) D.1.1-96. STRUCTURAL WELDING CODE-STEEL WELD ELECTRÓDES SHALL BE E70XX.
- ALL COAXIAL CABLE CONNECTORS AND TRANSMITTER EQUIPMENT SHALL BE AS SPECIFIED BY THE OWNER AND IS NOT INCLUDED IN THESE CONSTRUCTION DOCUMENTS. THE CONTRACTOR SHALL FURNISH ALL CONNECTION HARDWARE REQUIRED TO SECURE THE CABLES. CONNECTION HARDWARE SHALL BE STAINLESS STEEL.
- NORTH ARROW SHOWN ON PLANS REFERS TO TRUE NORTH. CONTRACTOR SHALL VERIFY NORTH AND INFORM OWNER OF ANY DISCREPANCY BEFORE STARTING CONSTRUCTION.
- ALL CAST IN PLACE CONCRETE SHALL BE MIXED AND PLACED IN ACCORDANCE WITH THE REQUIREMENTS OF ACI 318 AND AC1 301, AND SHALL HAVE A 28 DAY MINIMUM COMPRESSIVE STRENGTH OF 3000 PSI (U.O.N.). CONCRETE SHALL BE PLACED AGAINST UNDISTURBED SOIL UNLESS OTHERWISE NOTED. MINIMUM CONCRETE COVER SHALL BE 3 INCHES UNLESS OTHERWISE
- ALL REINFORCING STEEL SHALL CONFORM TO ASTM 615 GRADE 80, DEFORMED BILLET STEEL BARS. WELDED WIRE FABRIC REINFORCING SHALL CONFORM TO ASTM A185.
- THE FABRICATION AND ERECTION OF STRUCTURAL STEEL SHALL CONFORM TO THE LATEST A.I.S.C. SPECIFICATIONS.
- ALL CONNECTIONS NOT FULLY DETAILED ON THESE PLANS SHALL BE DETAILED BY THE STEEL FABRICATOR IN ACCORDANCE WITH ALSIC SPECIFICATIONS
- HOT-DIP GALVANIZE ITEMS SPECIFIED TO BE ZINC-COATED. AFTER FABRICATION WHERE PRACTICAL. GALVANIZING: ASTM A 123, ASTM A 153/A 153M OR ASTM A 653/A 653M, G90, AS
- 12. REPAIR DAMAGED SURFACES WITH GALVANIZING REPAIR METHOD AND PAINT CONFORMING TO ASTM A 780 OR BY APPLICATION OF STICK OR THICK PASTE MATERIAL SPECIFICALLY DESIGNED FOR REPAIR OF GALVANIZING. CLEAN AREAS TO BE REPAIRED, AND REMOVE SLAG FROM WELDS. HEAT SURFACES TO WHICH STICK OR PASTE MATERIAL IS APPLIED WITH A TORCH TO A TEMPERATURE SUFFICIENT TO MELT THE METALLICS. IN STICK OR PASTE, SPREAD MOLTEN MATERIAL UNIFORMLY OVER SURFACES TO BE COATED AND WIPE OFF EXCESS MATERIAL.
- 13. CONTRACTOR SHALL FOLLOW THE MANUFACTURER'S INSTRUCTIONS/ SPECIFICATIONS IF NO INFORMATION IS CONTAINED IN THESE PLANS OR IF THE MANUFACTURER'S SPECIFICATIONS ARE STRICTER.

PERMITS

- 1. CONTRACTOR SHALL SECURE ALL NECESSARY PERMITS FOR THIS PROJECT FROM ALL APPLICABLE GOVERNMENTAL AGENCIES. (NOT SUPPLIED BY OWNER)
- 2. ANY PERMITS WHICH MUST BE OBTAINED SHALL BE THE CONTRACTORS RESPONSIBILITY. THE CONTRACTOR SHALL BE RESPONSIBLE FOR ABIDING BY ALL CONDITIONS AND REQUIREMENTS OF THE PERMITS. (NOT SUPPLIED BY OWNER)
- 3. ALL WORK SHALL BE IN ACCORDANCE WITH LOCAL CODES AND THE LATEST APPLICABLE CODES AND STANDARDS.
- THE CONTRACTOR SHALL NOTIFY THE APPLICABLE JURISDICTIONAL (STATE, COUNTY, OR CITY) ENGINEER 24 HOURS PRIOR TO THE BEGINNING OF CONSTRUCTION.
- 5. CONTRACTOR RESPONSIBLE FOR CLOSING AND FILING ALL PERMITS ASSOCIATED WITH SITE.

- CONTRACTOR SHALL CONTACT A SUBSURFACE UTILITY LOCATOR FOR LOCATION OF EXISTING UTILITIES PRIOR TO COMMENCEMENT OF ANY CONSTRUCTION LOCATION OF EXISTING SEWER, WATER LINES, GAS LINES, CONDUITS OR OTHER STRUCTURES ACROSS, UNDERNEATH, OR OTHERWISE ALONG THE LINE OF PROPOSED WORK ARE NOT NECESSARILY SHOWN ON
- THE PLANS AND IF SHOWN ARE ONLY APPROXIMATELY CORRECT. CONTRACTOR ASSUMES SOLE RESPONSIBILITY FOR VERIFYING LOCATION AND ELEVATION OF ALL UNDERGROUND UTILITIES (INCLUDING TEST PITS BY HAND IF NECESSARY) IN AREAS OF CONSTRUCTION PRIOR TO STARTING WORK. CONTACT ENGINEER IMMEDIATELY IF LOCATION DR ELEVATION IS DIFFERENT FROM THAT SHOWN ON THE PLANS, OR IF THERE APPEARS TO BE A CONFLICT.
- CONTRACTOR SHALL COORDINATE ALL UTILITY CONNECTIONS WITH APPROPRIATE UTILITY OWNERS AND CONSTRUCTION MANAGER.
- DAMAGE BY THE CONTRACTOR TO UTILITIES OR PROPERTY OF OTHERS, INCLUDING EXISTING PAVEMENT AND OTHER SURFACES DISTURBED BY THE CONTRACTOR DURING CONSTRUCTION SHALL BE REPAIRED TO PRE CONSTRUCTION CONDITIONS BY THE CONTRACTOR AT NO ADDITIONAL COST TO THE CLIENT. FOR GRASSED AREAS, SEED AND MULCH SHALL BE ACCEPTABLE..
- 4. THE CONTRACTOR SHALL COORDINATE WITH THE OWNER THE REQUIREMENTS FOR AND LIMITS OF OVERHEAD AND/OR UNDERGROUND ELECTRICAL
- THE CONTRACTOR SHALL COORDINATE THE LOCATION OF NEW UNDERGROUND TELEPHONE SERVICE WITH THE TELEPHONE UTILITY AND THE OWNER'S REQUIREMENTS.
- ALL UNDERGROUND UTILITIES SHALL BE INSTALLED AND TESTED SATISFACTORY PRIOR TO COMMENCING ANY PAVING OPERATIONS WHERE SUCH UTILITIES ARE WITHIN THE LIMITS OF PAVEMENT.

GRADING

- 1. THE CONTRACTOR SHALL REWORK (DRY, SCARIFY, ETC...) ALL MATERIAL NOT SUITABLE FOR SUB GRADE IN ITS PRESENT STATE. IF THE MATERIAL, AFTER REWORKING, REMAINS UNSUITABLE THEN THE CONTRACTOR SHALL UNDERCUT THIS MATERIAL AND REPLACE WITH APPROVED MATERIAL AT HIS EXPENSE. ALL SUB GRADES SHALL BE PROOF ROLLED WITH A FULLY LOADED TANDEM AXLE DUMP TRUCK PRIOR TO PAVING. ANY SOFT MATERIAL SHALL BE REWORKED OR REPLACED
- THE CONTRACTOR IS REQUIRED TO MAINTAIN ALL DITCHES, PIPES, AND OTHER DRAINAGE STRUCTURES FREE FROM OBSTRUCTION UNTIL WORK IS ACCEPTABLE BY THE OWNER. THE CONTRACTOR IS RESPONSIBLE FOR ANY DAMAGES CAUSED BY FAILURE TO MAINTAIN DRAINAGE STRUCTURES IN OPERABLE CONDITION.
- ALL MATERIALS AND WORKMANSHIP SHALL BE WARRANTED FOR ONE (1) YEAR FROM DATE OF ACCEPTANCE.
- 4. ALL DIMENSIONS SHALL BE VERIFIED WITH THE PLANS (LATEST REVISION) PRIOR TO COMMENCING CONSTRUCTION. NOTIFY THE OWNER IMMEDIATELY IF DISCREPANCIES ARE DISCOVERED. THE CONTRACTOR SHALL HAVE A SET OF APPROVED PLANS AVAILABLE AT THE SITE AT ALL TIMES WHEN WORK IS BEING PERFORMED. A DESIGNATED RESPONSIBLE EMPLOYEE SHALL BE AVAILABLE FOR CONTACT BY GOVERNING AGENCY INSPECTORS.

- AWARDED CONTRACTOR WILL BE REQUIRED TO SIGN AND RETURN A COPY OF AN AWARD LETTER FOR SBA'S FILE.
- CONTRACTOR WILL BE REQUIRED TO PROVIDE PROOF OF LICENSE TO PERFORM WORK IN JURISDICTION AT TIME OF
- CONTRACTOR WILL PROVIDE A CONSTRUCTION SCHEDULE PRIOR TO CONSTRUCTION STARTING AND WILL PROVIDE UPDATE/CHANGES (WITH EXPLANATIONS) TO THAT SCHEDULE WHEN/IF ITEMS ARE DELAYED OR PUSHED OUT.
- CONTRACTOR WILL BE RESPONSIBLE FOR ALL CONCRETE COMPRESSIVE TESTING AND REQUIRED TO SUBMIT FINAL TEST RESULTS WITH CLOSE OUT BOOK.
- CONTRACTOR WILL BE RESPONSIBLE TO PROVIDE SBA PROJECT MANAGERS WITH PHOTOS OF THE MAJOR CONSTRUCTION MILESTONES AS THEY OCCUR.
- CONTRACTOR WILL BE RESPONSIBLE TO ASSIST IN COORDINATING AND OBTAINING PRIMARY POWER TO THE SITE PRIOR TO TOWER ERECTION, AS WELL AS TELCO SERVICE BEFORE PROJECT COMPLETION. (ON SITE VISITS WITH UTILITY COMPANY REPRESENTATIVES AS NECESSARY,
- CONTRACTOR WILL HAVE A REPRESENTATIVE ON A WEEKLY CONFERENCE CALL TO PROVIDE SBA WITH SITE SPECIFIC UPDATES. CURRENTLY, THIS CONFERENCE CALL IS HELD EACH AND EVERY THURSDAY AT 4 PM (EASTERN
- CONTRACTOR SHOULD BE PREPARED FOR RANDOM SBA SAFETY INSPECTIONS AT ALL TIMES.
- CONTRACTOR IS EXPECTED TO MAINTAIN PROPER WORKING CONDITIONS AND PROCEDURES PER OSHA STANDARDS AT
- 10. CONTRACTOR WILL BE REQUIRED TO OBTAIN THE NECESSARY ELECTRICAL PERMITS AND INSPECTIONS AS REQUIRED BY JURISDICTION.
- 11. CONTRACTOR IS EXPECTED TO CLOSE-OUT THE JOB SITE AS QUICKLY AS POSSIBLE (OBTAINING A CERTIFICATE OF OCCUPANCY AND GETTING SBA'S REGIONAL SITE MANAGER'S SIGN-OFF/CHECKLIST APPROVAL ON THE
- 12. CONTRACTOR WILL PROVIDE A COMPLETED TOWER HEIGHT VERIFICATION FORM AND TAPE DROP WITHIN 24 HOURS OF REACHING OVERALL HEIGHT.
- 13. CONTRACTOR WILL UTILIZE ALL OF THE SBA PROVIDED DOCUMENTATION INCLUDING BUT NOT LIMITED TO: TOWER CONSTRUCTION ACCEPTANCE CHECKLIST, CONSTRUCTION SCHEDULE, CONSTRUCTION CLOSE-OUT LIST & TOWER HEIGHT VERIFICATION
- 14. CONTRACTOR IS RESPONSIBLE FOR CONCRETE COMPRESSION TESTING.
- 15. CONTRACTOR IS RESPONSIBLE FOR GROUND MEG TESTING.



PARKWAY, NW BOCA RATON, FL 33487-2797 TEL: (561) 226-9523 FAX: (561) 226-9368


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| NO. | DATE | DESCRIPTION |



PROJECT No 15363-1054-43000

BRIDGEWATER

SITE NUMBER

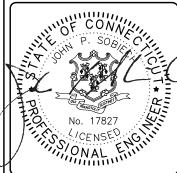CT 11934

WEWAKA BROOK ROAD BRIDGEWATER, CT 06752

DESIGN TYP

SITE ADDRESS

RAW LAND

SHEET TITLE

GENERAL NOTES

DRAWING NO

ENVIRONMENTAL NOTES

VERNAL POOL PROTECTION PROGRAM

THE CONSTRUCTION AREA IS LOCATED IN PROXIMITY TO SENSITIVE WETLAND RESOURCE AREAS THAT PROVIDE VERNAL POOL HABITAT. THE FOLLOWING PROTECTIVE MEASURES WILL AVOID UNINTENTIONAL MORTALITY TO VERNAL POOL HERPTOFAUNA (I.E., SPOTTED SALAMANDER, WOOD FROG, ETC.) AS A RESULT OF CONSTRUCTION ACTIVITIES FOR THE SITE IMPROVEMENTS PROPOSED. THIS VERNAL POOL PROTECTION PROGRAM HAS BEEN DEVELOPED IN ACCORDANCE WITH RECOMMENDATIONS CONTAINED IN THE CONNECTICUT SITING COUNCIL'S CERTIFICATE OF ENVIRONMENTAL COMPATIBILITY AND PUBLIC NEED (DOCKET NO. 412; JANUARY 19, 2012). WITH ADHERENCE TO THIS VERNAL POOL PROTECTION PROGRAM, THE PROPOSED DEVELOPMENT AT THIS PROPERTY WILL NOT HAVE AN ADVERSE EFFECT ON VERNÁL POOL

IT IS OF THE UTMOST IMPORTANCE THAT THE CONTRACTOR COMPLIES WITH THE REQUIREMENTS FOR THE INSTALLATION OF PROTECTIVE MEASURES AND THE EDUCATION OF EMPLOYEES AND SUBCONTRACTORS PERFORMING WORK ON THE PROJECT SITE. ALL-POINTS TECHNOLOGY CORPORATION, P.C. (APT) WILL SERVE AS THE ENVIRONMENTAL MONITOR FOR THIS PROJECT TO ENSURE THAT VERNAL POOL PROTECTION MEASURES ARE IMPLEMENTED PROPERLY. THE CONTRACTOR SHALL CONTACT DEAN GUSTAFSON, SENIOR WETLAND SCIENTIST AT APT, AT LEAST 5 BUSINESS DAYS PRIOR TO THE PRE-CONSTRUCTION MEETING. MR. GUSTAFSON CAN BE REACHED AT (860) 984-9515 AND AT DGUSTAFSON@ALLPOINTSTECH.COM.

THE PROPOSED VERNAL POOL PROTECTION PROGRAM CONSISTS OF SEVERAL COMPONENTS: ISOLATION OF THE PROJECT PERIMETER; PERIODIC INSPECTION AND MAINTENANCE OF ISOLATION STRUCTURES; HERPTOFAUNA SWEEPS; EDUCATION OF ALL CONTRACTORS AND SUB-CONTRACTORS PRIOR TO INITIATION OF WORK ON

1. <u>SEASONAL RESTRICTION</u>

CONSTRUCTION OF THE WIRELESS TELECOMMUNICATIONS FACILITY WILL BE SEASONALLY RESTRICTED FROM OCCURRING BETWEEN MARCH 1 TO MAY 15 TO AVOID CONSTRUCTION ACTIVITIES AND POTENTIAL DISTURBANCE DURING THE PEAK AMPHIBIAN MIGRATION AND BREEDING PERIOD. ACCESS DRIVE CONSTRUCTION ACTIVITIES LOCATED MOVE THAN 750 FEET FROM THE VERNAL POOLS ARE NOT SEASONALLY RESTRICTED FROM THIS PERIOD, EXCEPTING IN-STREAM WORK SEASONAL RESTRICTIONS ASSOCIATED WITH THE BRIDGE REPLACEMENT WORK (UNCONFINED IN-STREAM WORK, INCLUDING CONSTRUCTION, INSTALLATION OR REMOVAL OF COFFERDAM STRUCTURES OR PLACEMENT OF FILL, IS LIMITED TO THE PERIOD JULY 1 THROUGH SEPTEMBER 30).

2. <u>ISOLATION MEASURES</u>

- INSTALLATION OF CONVENTIONAL SILT FENCING, WHICH WILL ALSO SERVE AS AN ISOLATION OF THE WORK ZONE FROM SURROUNDING AREAS AND IS REQUIRED FOR EROSION CONTROL COMPLIANCE, SHALL BE PERFORMED BY THE CONTRACTOR FOLLOWING CLEARING ACTIVITIES AND PRIOR TO ANY EARTHWORK. APT WILL INSPECT THE WORK ZONE AREA PRIOR TO AND FOLLOWING EROSION CONTROL BARRIER INSTALLATION TO ENSURE THE AREA IS
- THE FENCING WILL CONSIST OF CONVENTIONAL EROSION CONTROL WOVEN FABRIC, INSTALLED APPROXIMATELY SIX INCHES BELOW SURFACE GRADE TO BURY THE BOTTOM OF THE SILT FENCE AND STAKED AT SEVEN TO TEN-FOOT INTERVALS USING FOUR-FOOT OAK STAKES OR APPROVED EQUIVALENT. IN ADDITION TO REQUIRED DAILY INSPECTION BY THE CONTRACTOR. THE FENCING WILL BE INSPECTED FOR TEARS OR BREECHES IN THE FABRIC FOLLOWING INSTALLATION AND AT APPROXIMATELY ONE-WEEK INTERVALS OR AFTER STORM EVENTS OF 0.5 INCH OR GREATER BY APT. INSPECTIONS WILL BE CONDUCTED BY APT THROUGHOUT THE COURSE OF THE CONSTRUCTION PROJECT.
- THE EXTENT OF THE BARRIER FENCING WILL BE AS SHOWN ON THE SITE PLANS. FIELD CONDITIONS MAY REQUIRE THE INSTALLATION OF ADDITIONAL BARRIER FENCING AT THE DIRECTION OF APT. THE CONTRACTOR SHALL MAINTAIN ADDITIONAL SUPPLIES OF BARRIER FENCING AND EROSION CONTROLS ON SITE FOR THIS PURPOSE
- D. NO EQUIPMENT, VEHICLES OR CONSTRUCTION MATERIALS SHALL BE STORED OUTSIDE OF BARRIER FENCING.

CONTRACTOR EDUCATION:

- PRIOR TO WORK ON SITE, THE CONTRACTOR SHALL ATTEND AN EDUCATIONAL SESSION AT THE PRE-CONSTRUCTION MEETING WITH APT. THIS ORIENTATION AND EDUCATIONAL SESSION WILL CONSIST OF AN INTRODUCTORY SESSION WITH PHOTOS IDENTIFYING VARIOUS COMMON VERNAL POOL HERPTOFAUNA, STRESSING THE NON-AGGRESSIVE NATURE OF THESE SPECIES AND THE ABSENCE OF NEED TO DESTROY ANIMALS THAT MIGHT BE ENCOUNTERED, HOW TO PROPERLY HANDLE THESE SPECIES IF ENCOUNTERED AND THE NEED TO FOLLOW PROTECTIVE MEASURES AS DESCRIBED IN SECTION 4.
- THE CONTRACTOR WILL BE PROVIDED WITH CELL PHONE AND EMAIL CONTACTS FOR APT ENVIRONMENTAL MONITOR STAFE TO IMMEDIATELY REPORT ANY ENCOUNTERS WITH VERNAL POOL HERPTOFAUNA. POSTER MATERIALS WILL BE PROVIDED BY APT TO THE CONTRACTOR FOR POSTING ON THE JOB SITE TO MAINTAIN WORKER AWARENESS OF THE SENSITIVE NATURE OF THE JOB SITE.

PROTECTIVE MEASURES

- A THOROUGH COVER SEARCH OF THE CONSTRUCTION AREA WILL BE PERFORMED BY AN APT ENVIRONMENTAL MONITOR FOR VERNAL POOL HERPTOFAUNA PRIOR TO AND FOLLOWING INSTALLATION OF SILT FENCING TO REMOVE ANY SPECIES FROM THE WORK ZONE PRIOR TO THE INITIATION OF CONSTRUCTION
- PRIOR TO THE START OF CONSTRUCTION EACH DAY, THE CONTRACTOR SHALL SEARCH THE ENTIRE WORK AREA FOR VERNAL POOL HERPTOFAUNA.
- IF HERPTOFAUNA ARE FOUND, THEY SHOULD BE CAREFULLY GRASPED IN BOTH HANDS AND PLACED JUST OUTSIDE OF THE ISOLATION BARRIER IN THE APPROXIMATE DIRECTION THEY WERE HEADING.
- SPECIAL CARE SHALL BE TAKEN BY THE CONTRACTOR DURING EARLY MORNING AND EVENING HOURS SO THAT POSSIBLE BASKING OR FORAGING HERPTOFAUNA ARE NOT HARMED BY CONSTRUCTION ACTIVITIES.
- ANY STORMWATER MANAGEMENT FEATURES, RUTS OR ARTIFICIAL DEPRESSIONS THAT COULD HOLD WATER CREATED INTENTIONALLY OR UNINTENTIONALLY BY SITE CLEARING/CONSTRUCTION ACTIVITIES WILL BE PROPERLY FILLED IN AND PERMANENTLY STABILIZED WITH VEGETATION TO AVOID THE CREATION OF VERNAL POOL "DEĆOY POOLS" THAT COULD INTERCEPT AMPHIBIANS MOVING TOWARD THE VERNAL POOLS. STORMWATER MANAGEMENT FEATURES SUCH AS PLUNCE POOLS LOCATED WITHIN 750 FEET OF VERNAL POOL HABITAT WILL CAREFULLY REVIEWED IN THE FIELD TO ENSURE THAT STANDING WATER DOES NOT ENDURE FOR MORE THAN A 24 HOUR PERIOD TO AVOID CREATION OF DECOY POOLS AND MAY BE SUBJECT TO FIELD DESIGN CHANGES. ANY SUCH DESIGN CHANGES WILL BE REVIEWED BY THE DESIGN ENGINEER TO ENSURE STORMWATER MANAGEMENT FUNCTIONS ARE MAINTAINED.
- EROSION CONTROL MEASURES WILL BE REMOVED NO LATER THAN 30 DAYS FOLLOWING FINAL SITE STABILIZATION SO AS NOT TO IMPEDE MIGRATION OF AMPHIBIANS OR OTHER WILDLIFE.
- THE USE OF HERBICIDES AND PESTICIDES AT THE PROPOSED WIRELESS TELECOMMUNICATIONS FACILITY AND ALONG THE PROPOSED ACCESS DRIVE ARE STRICTLY PROHIBITED.

5. REPORTING

WEEKLY INSPECTION REPORTS (BRIEF NARRATIVE AND APPLICABLE PHOTOS) WILL BE SUBMITTED TO THE CONNECTICUT SITING COUNCIL FOR COMPLIANCE VERIFICATION. ANY OBSERVATIONS OF VERNAL POOL HERPTOFAUNA WILL BE INCLUDED IN THE REPORTS.




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BRIDGEWATER

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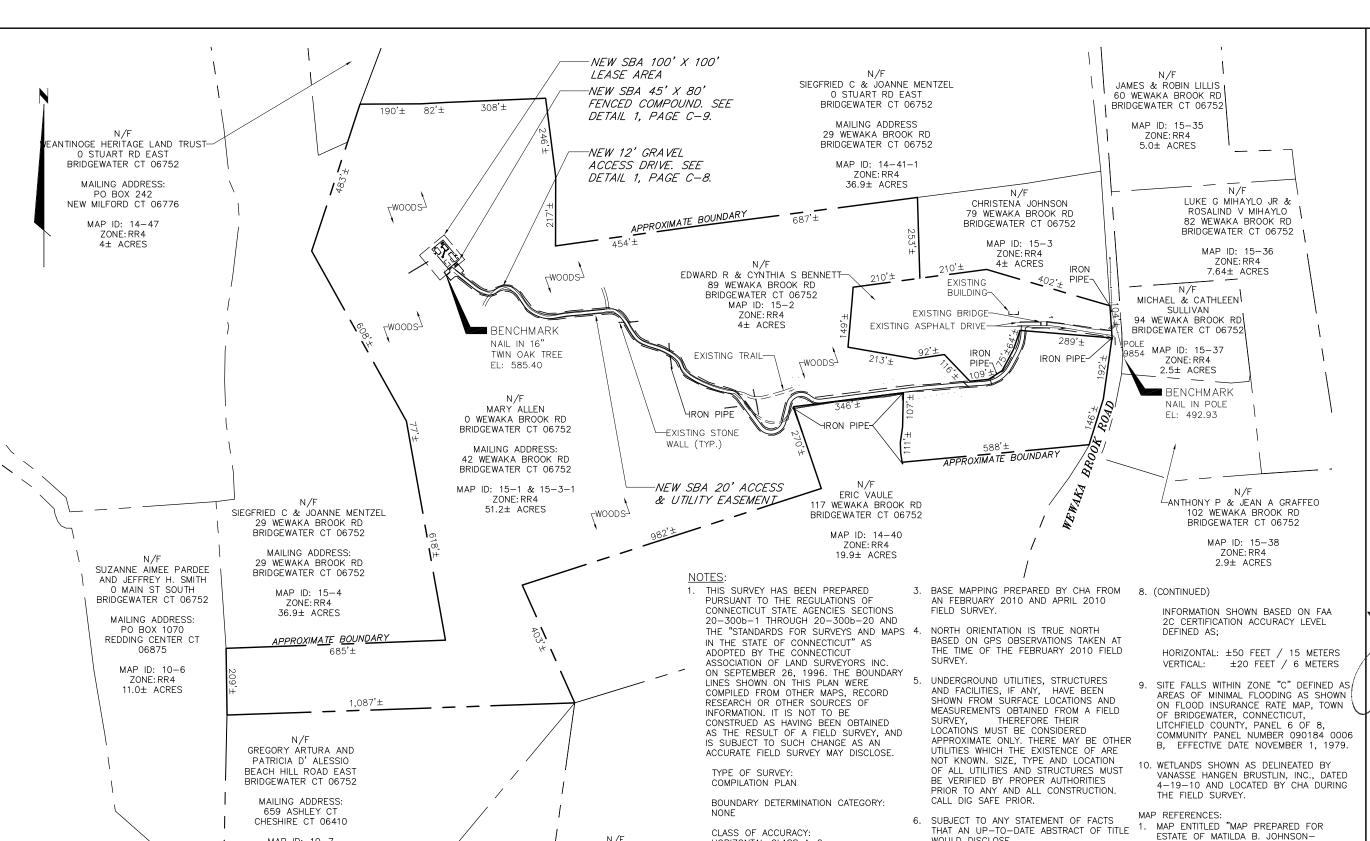
DESIGN TYP

RAW LAND

ENVIRONMENTAL NOTES

DRAWING NO

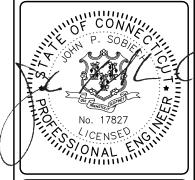



HORIZONTAL CLASS A-2

TOPOGRAPHIC CLASS T-2

MAPS AS OVERLAID ON ANY

PROPERTY LINES SHOWN HEREON ARE

MONUMENTATION OR OTHER EVIDENCE

FROM RECORD DEEDS PLOTS AND TAX

THAT MAY HAVE BEEN LOCATED DURING

THE TOPOGRAPHIC SURVEY. A PROPERTY

SURVEY WAS NOT PERFORMED BY CHA

AND AS A RESULT THE PROPERTY LINES

SHOWN ARE APPROXIMATE AND DO NOT

PRESENT A PROPERTY/BOUNDARY OPINION.

7. SUBJECT TO ALL RIGHTS, EASEMENTS,

SURVEY FEET. ELEVATIONS ARE

ACTUAL LOCATION.

REFERENCED TO NAVD88. TOP OF

COVENANTS OR RESTRICTIONS OF RECORD

LATITUDE/LONGITUDE ARE REFERENCED TO NAD83 CONNECTICUT ZONE. COORDINATES

SHOWN, IF ANY, ARE EXPRESSED IN U.S.

STRUCTURE HEIGHT AS SHOWN, IF ANY,

DETERMINED BY VERTICAL ANGLE OR BY

VFRTICAL CLASS V-2

WILLIAM KINSOLVING

) BEACH HILL ROAD WEST BRIDGEWATER CT 06752

MAILING ADDRESS:

P.O. BOX 175

BRIDGEWATER, CT 06752

MAP ID: 10-11

ZONE: RR4

12.88± ACRES

N/F

BRIDGÉWATER

LAND TRUST

O BEACH HILL RD WEST

BRIDGEWATER CT 06752

MAILING ADDRESS:

P.O. BOX 8

BRIDGEWATER CT 06752

MAP ID: 10-10

ZONE: RR4

10.1± ACRES


SBA TOWERS III LLC PARKWAY, NW BOCA RATON, FL 33487-2797 TEL: (561) 226-9523 FAX: (561) 226-9368



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| A&E PROJECT #: | 15363-1054-43000 |
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| DRAWN BY: | JDM |
| CHECKED BY: | PAL |

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| 1 | A | 06/22/12 | ISSUED FOR CONSTRUCTION |
| 1 | NO. | DATE | DESCRIPTION |

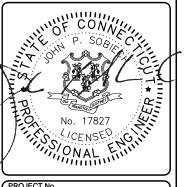

PROJECT No

15363-1054-43000

BRIDGEWATER

SITE NUMBER

CT 11934

SITE ADDRESS WEWAKA BROOK ROAD BRIDGEWATER, CT 06752

RAW LAND

WEWAKA BROOK ROAD" AS PREPARED BY

ARTHUR H HOWLAND, DATED MARCH 1981

AND FILED AS MAP No. 1057

NUMBERS 10,14 & 15.

TOWN OF BRIDGEWATER TAX MAP

SITE PLAN

REVISION:

150'

11 X 17: 1" = 300'


FULL SIZE: 1" = 150'


300'

MAP ID: 10-7

ZONE: RR4

13.2± ACRES

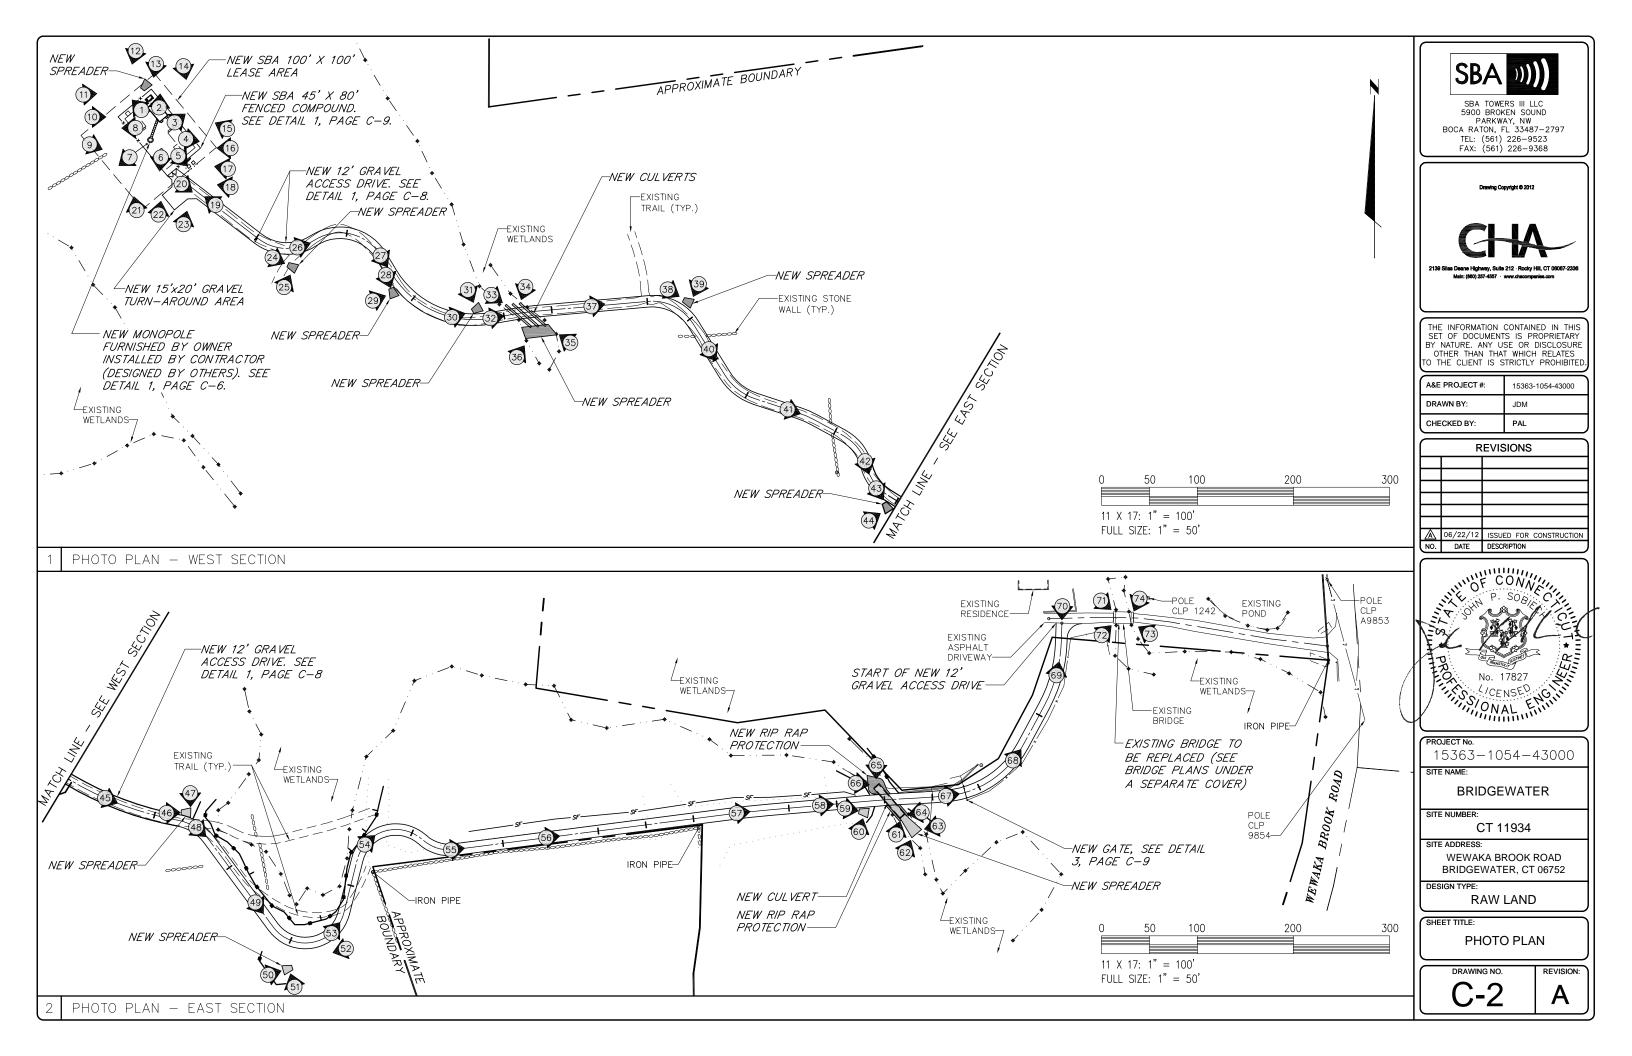

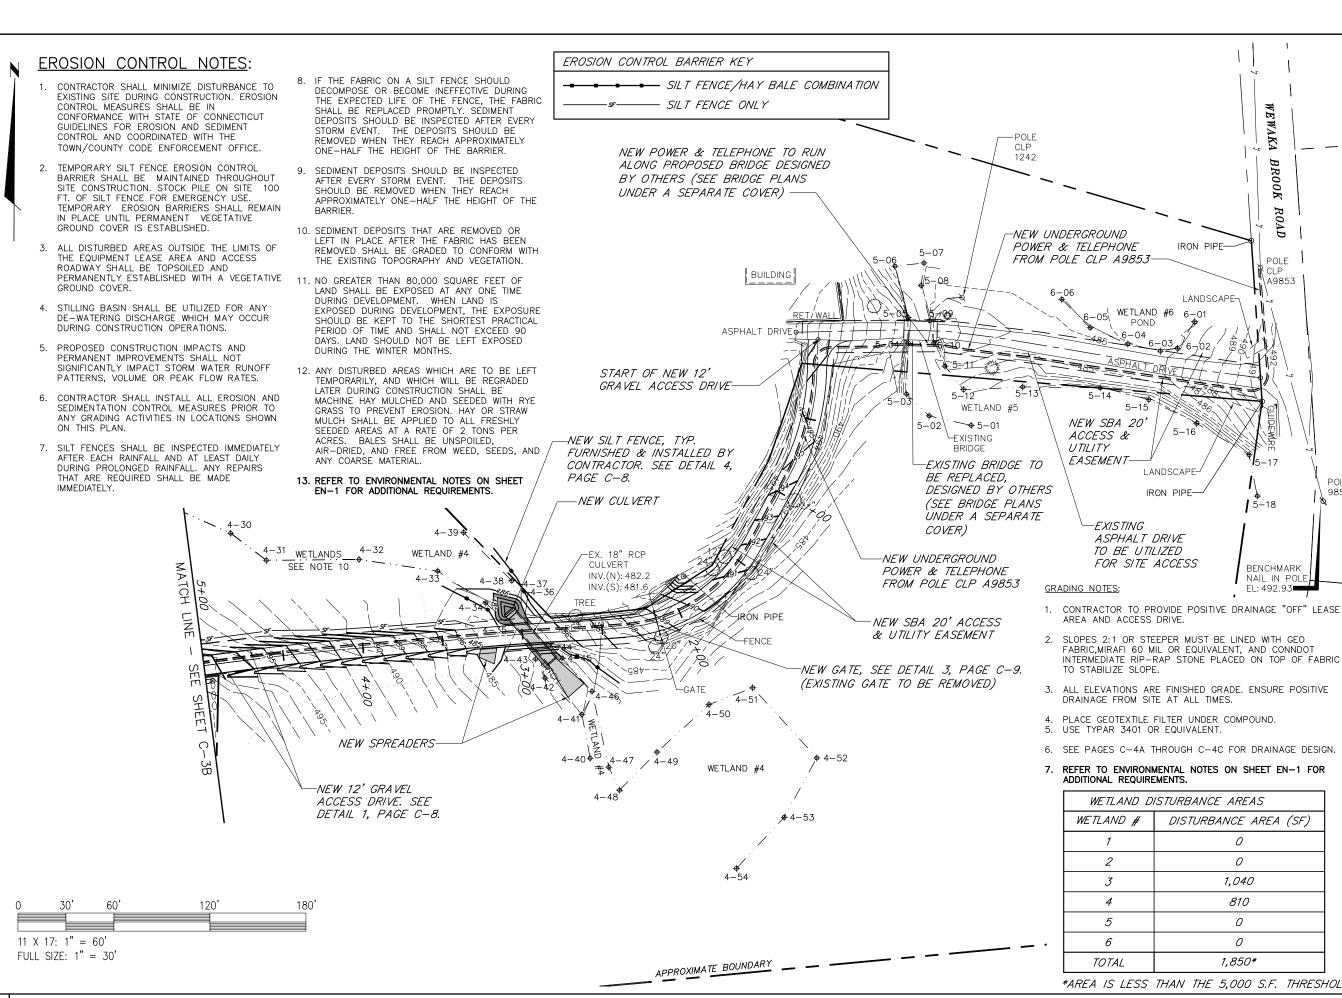



PARKWAY, NW BOCA RATON, FL 33487-2797 TEL: (561) 226-9523 FAX: (561) 226-9368

BR00K

ROAD

POLE

A9853

-18

BENCHMARK

NAIL IN POLE

EL: 492.93

POLE

9854

IRON PIPE-

LANDSCAPE-

WETLAND #6 6-01

5-16

FABRIC, MIRAFI 60 MIL OR EQUIVALENT, AND CONNDOT INTERMEDIATE RIP-RAP STONE PLACED ON TOP OF FABRIC

LANDSCAPE-

IRON PIPE-

POND

5-15

NEW SBA 20'

EXISTING

AREA AND ACCESS DRIVE

TO STABILIZE SLOPE.

ASPHALT DRIVE

FOR SITE ACCESS

DRAINAGE FROM SITE AT ALL TIMES.

USE TYPAR 3401 OR EQUIVALENT.

ADDITIONAL REQUIREMENTS.

WETLAND

1

2

3

4

5

6

TOTAL

PLACE GEOTEXTILE FILTER UNDER COMPOUND.

WETLAND DISTURBANCE AREAS

DISTURBANCE AREA (SF)

0

0

1,040

810

0

0

1.850*

*AREA IS LESS THAN THE 5.000 S.F. THRESHOLD

TO BE UTILIZED

ACCESS &

EASEMENT-


UTILITY



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| ١ | A&E PROJECT #: | 15363-1054-43000 |
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| ١ | DRAWN BY: | JDM |
| ١ | CHECKED BY: | PAL |

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| | NO. | DATE | DESCRIPTION |
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PROJECT No

15363-1054-43000

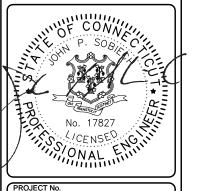BRIDGEWATER

SITE NUMBER:

CT 11934

SITE ADDRESS WEWAKA BROOK ROAD


BRIDGEWATER, CT 06752


DESIGN TYPE

RAW LAND

SITE GRADING PLAN 1 OF 3

DRAWING NO

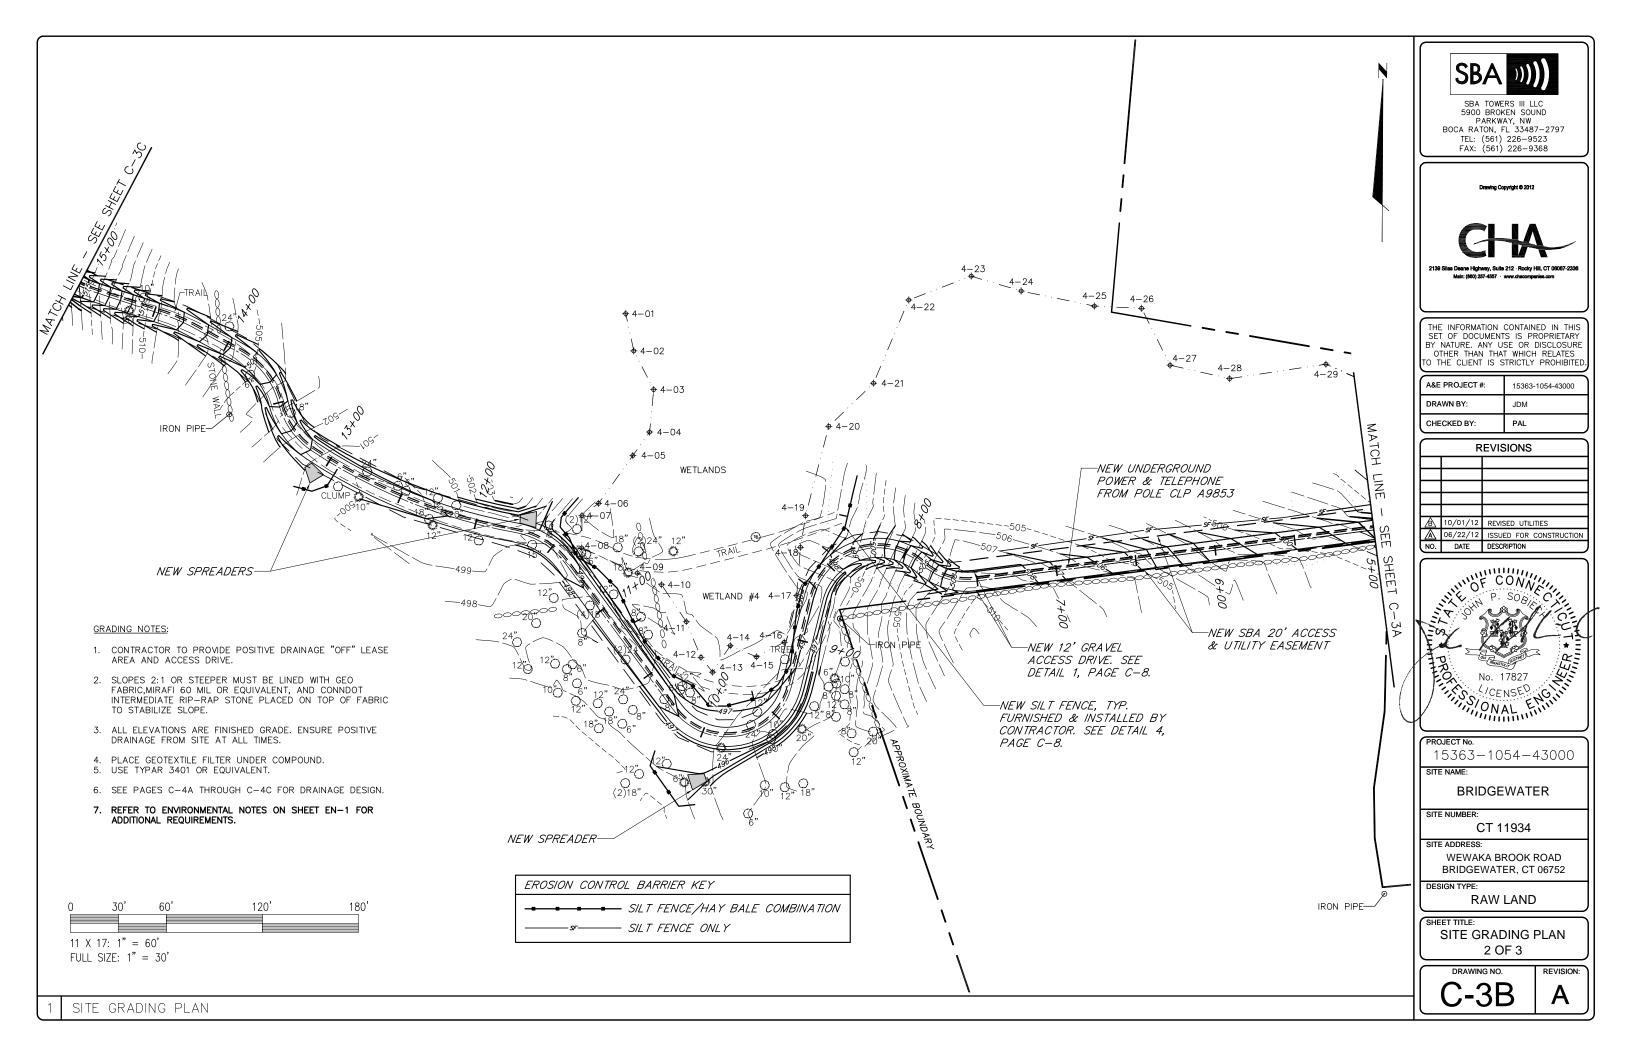

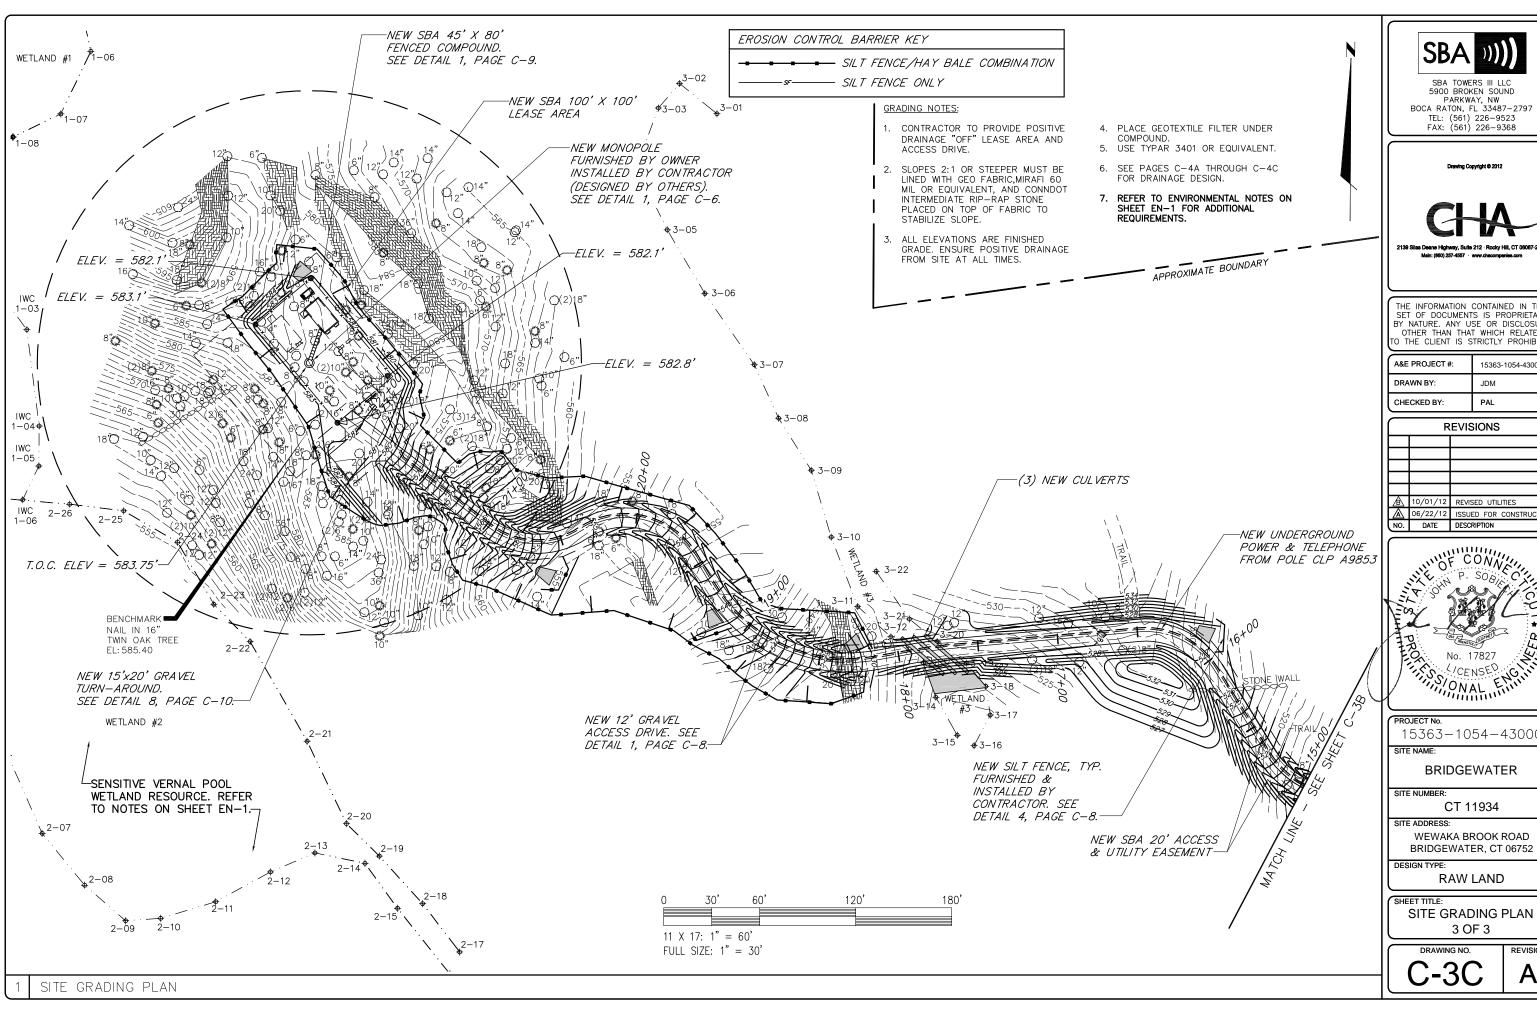


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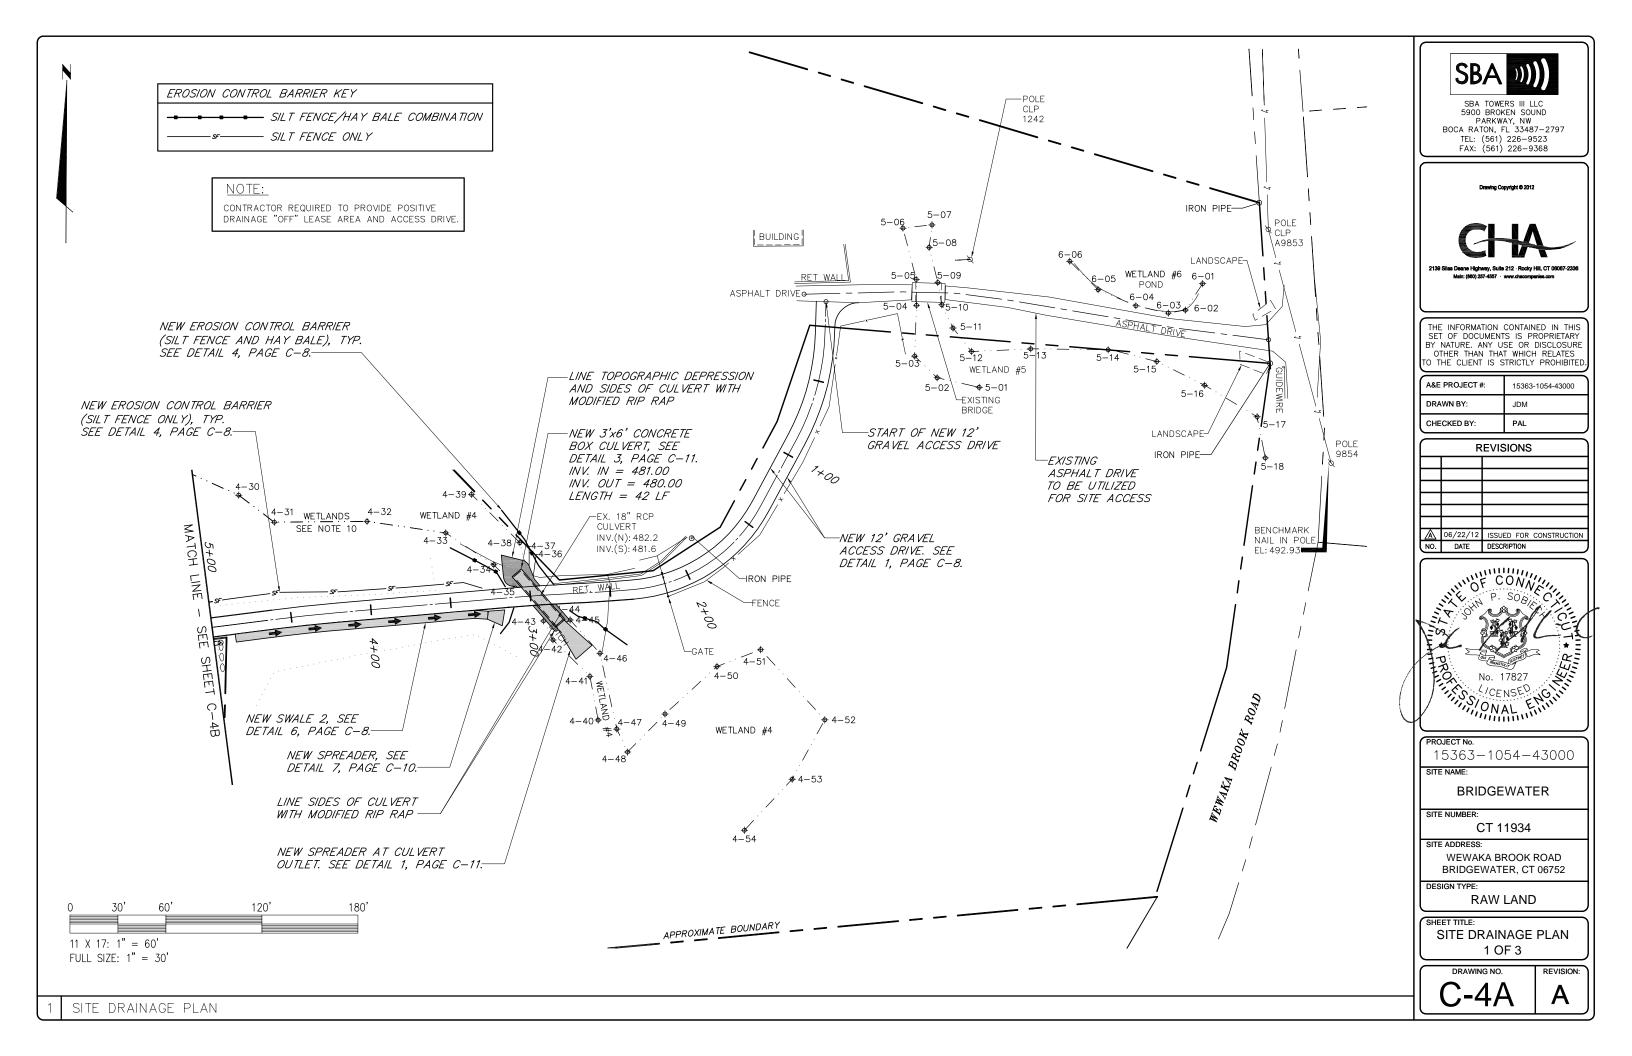



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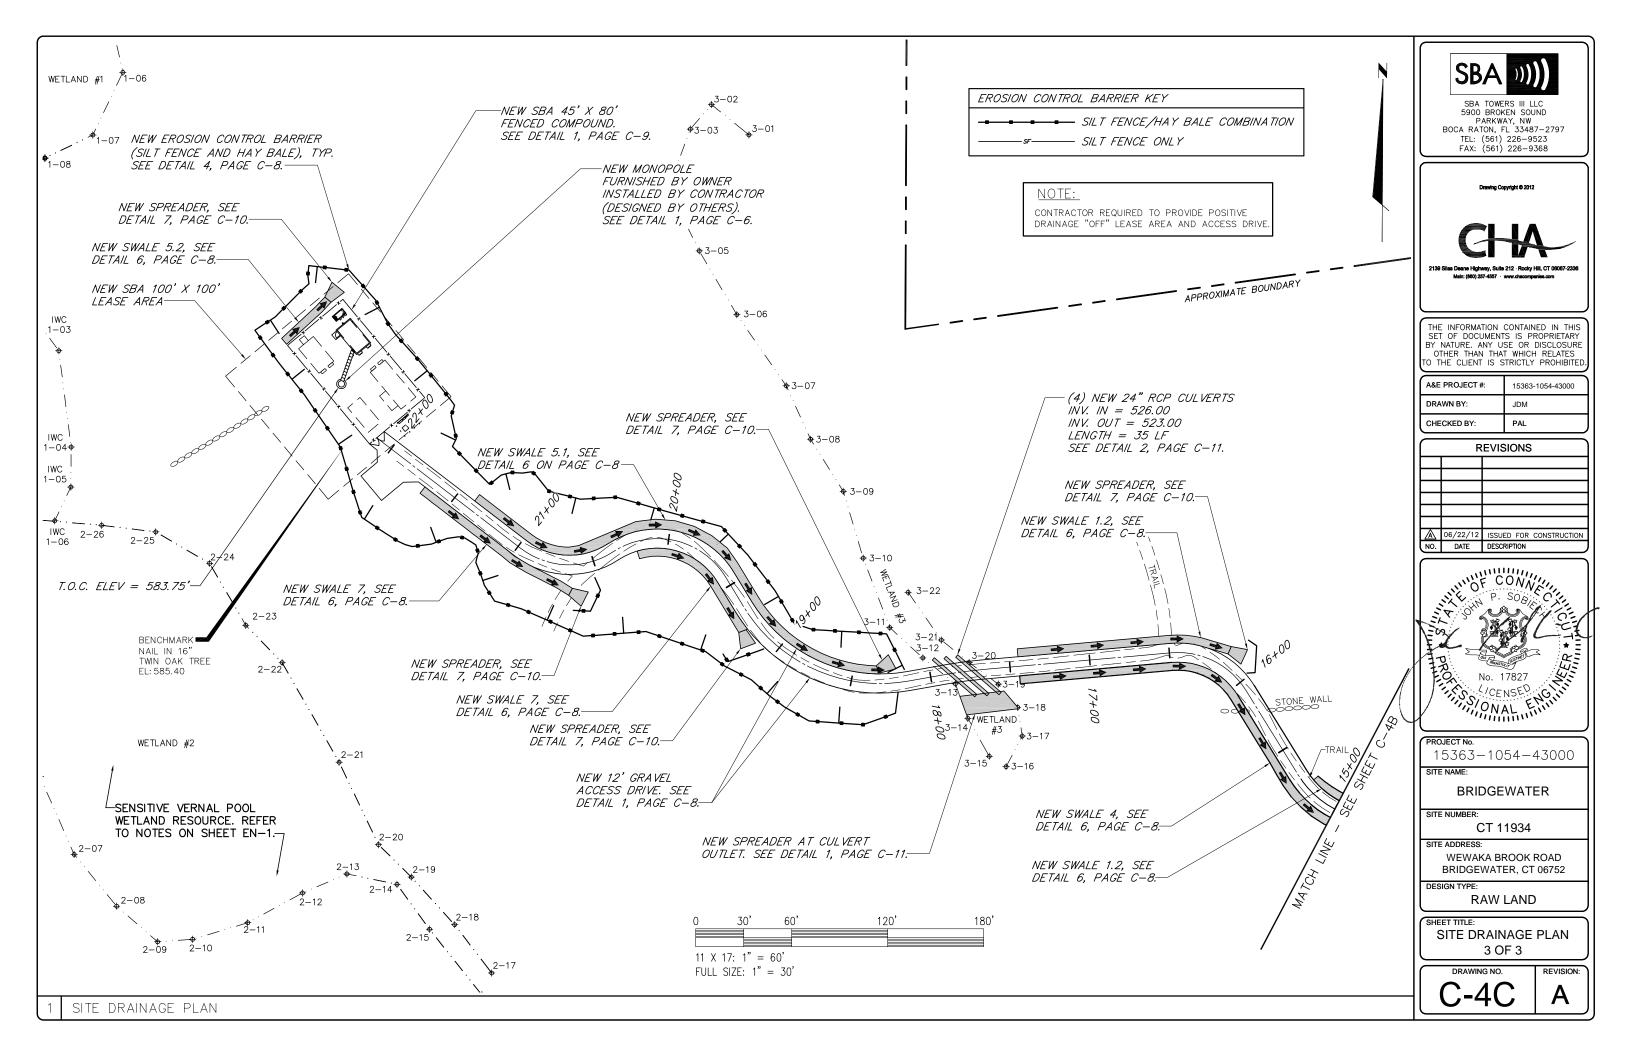
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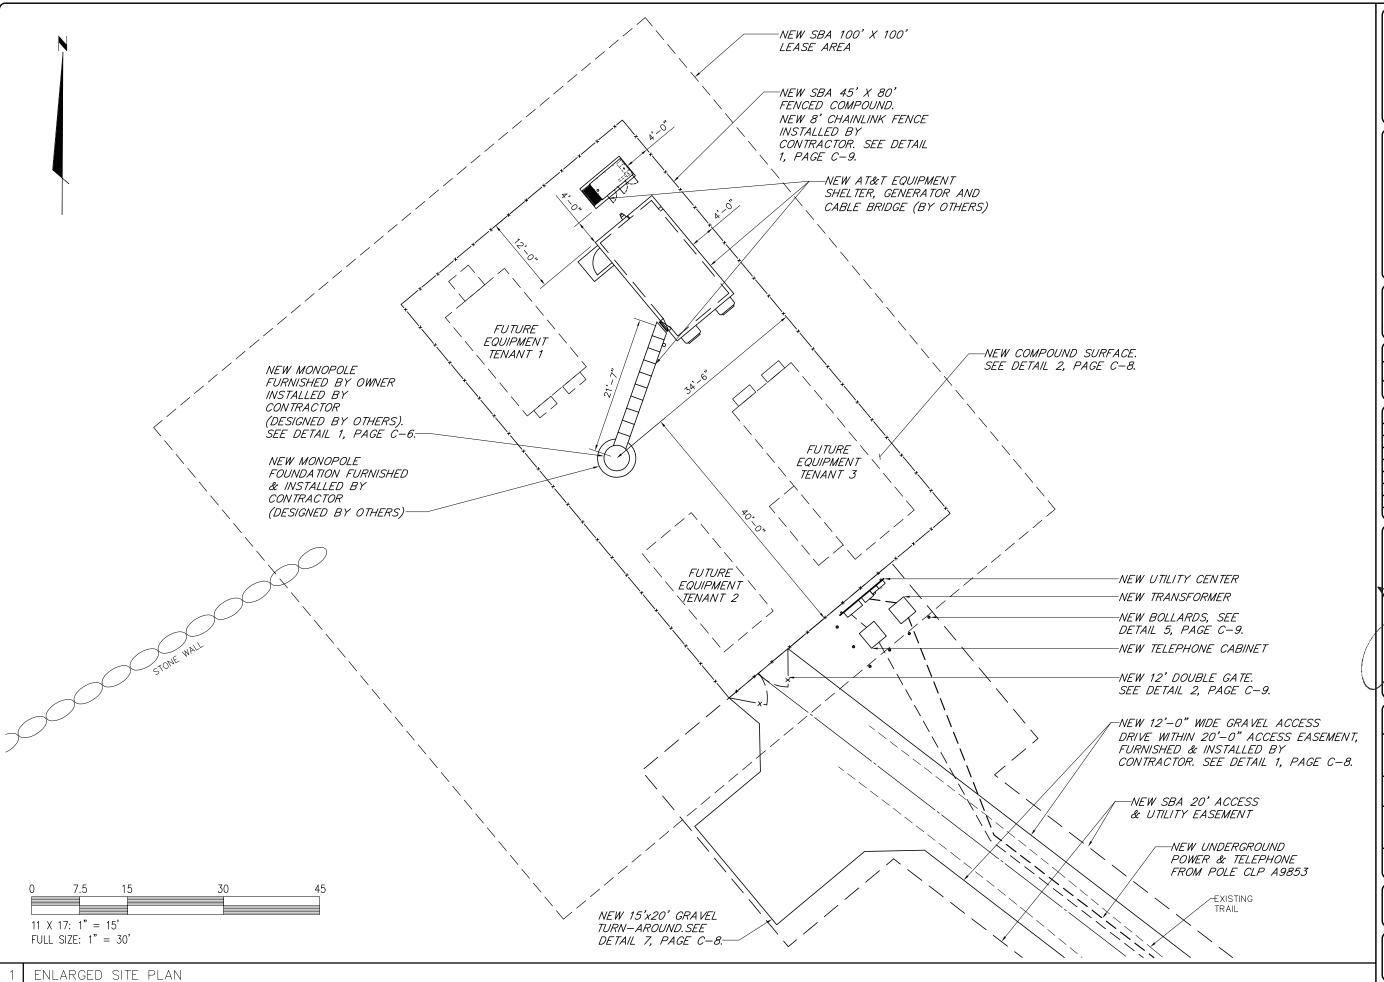
RAW LAND

SITE GRADING PLAN 3 OF 3





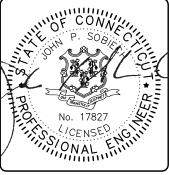

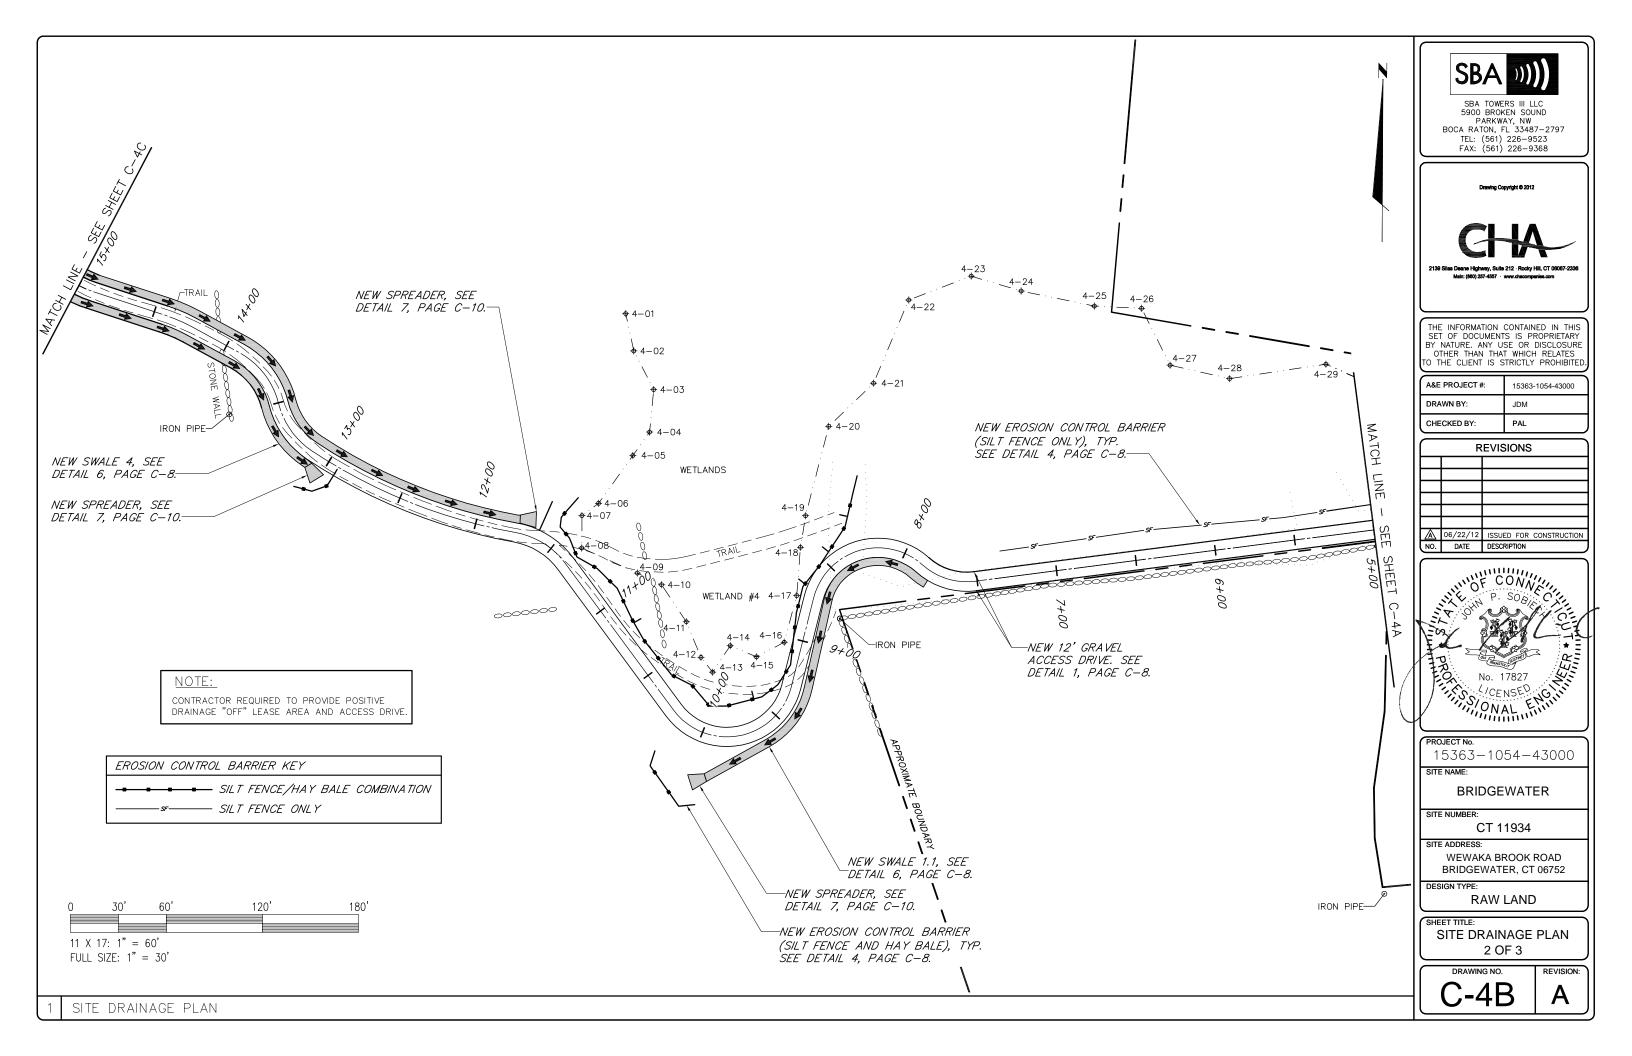



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| CHECKED BY: | PAL |

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| | 06/22/12 | ISSUED FOR CONSTRUCTION | |
| NO. | DATE | DESCRIPTION | |



PROJECT No.

15363-1054-43000

ITE NAME:

BRIDGEWATER

SITE NUMBER:

CT 11934

WEWAKA BROOK ROAD BRIDGEWATER, CT 06752

DESIGN TYPE:

RAW LAND


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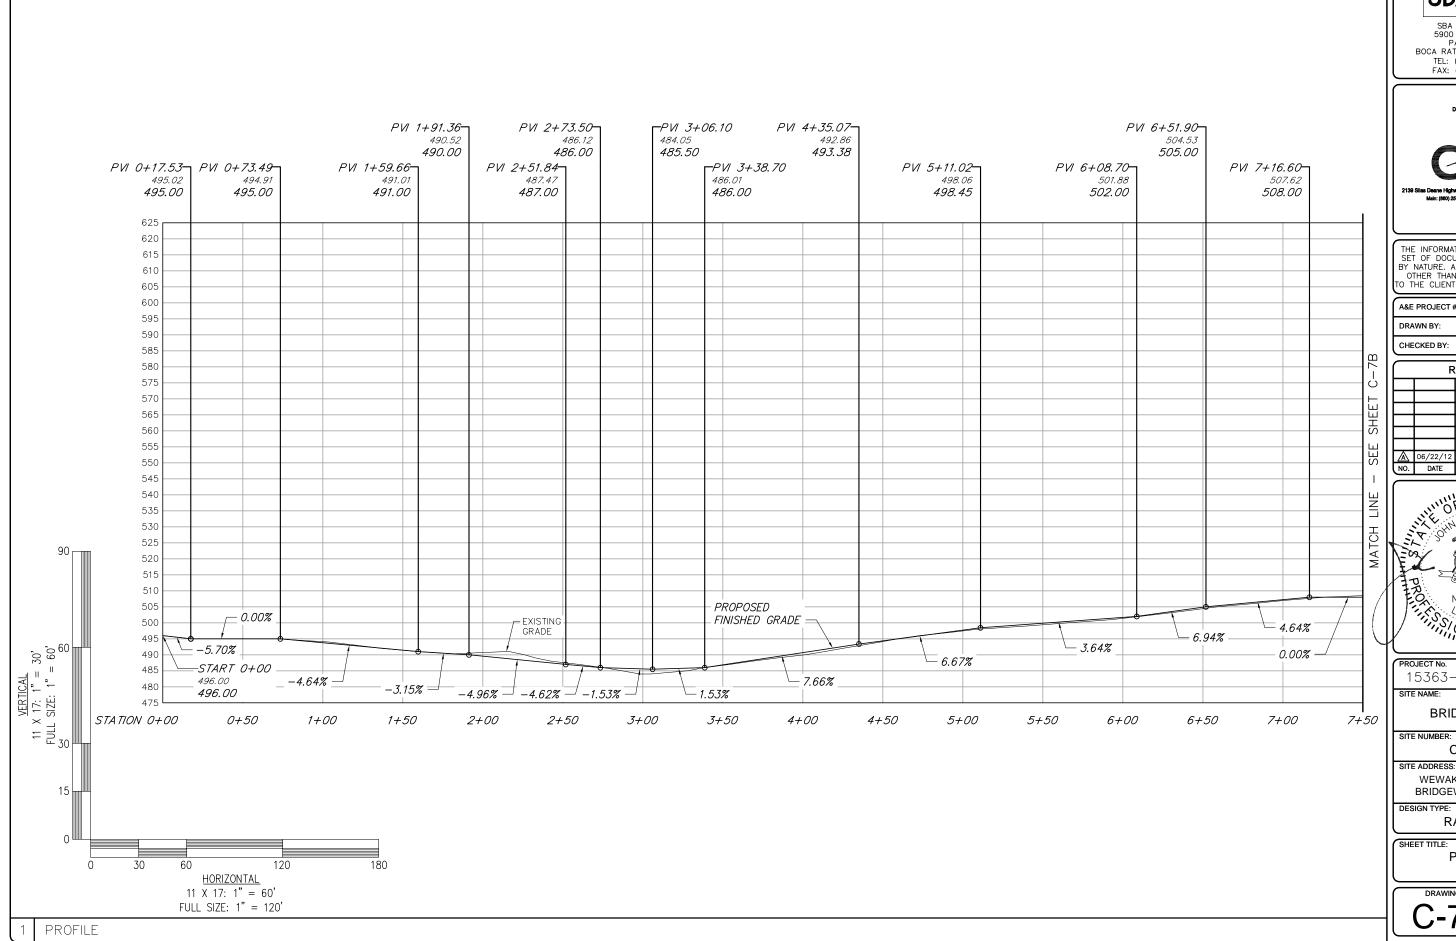
ENLARGED SITE PLAN

DRAWING NO

REVISION:

J-5



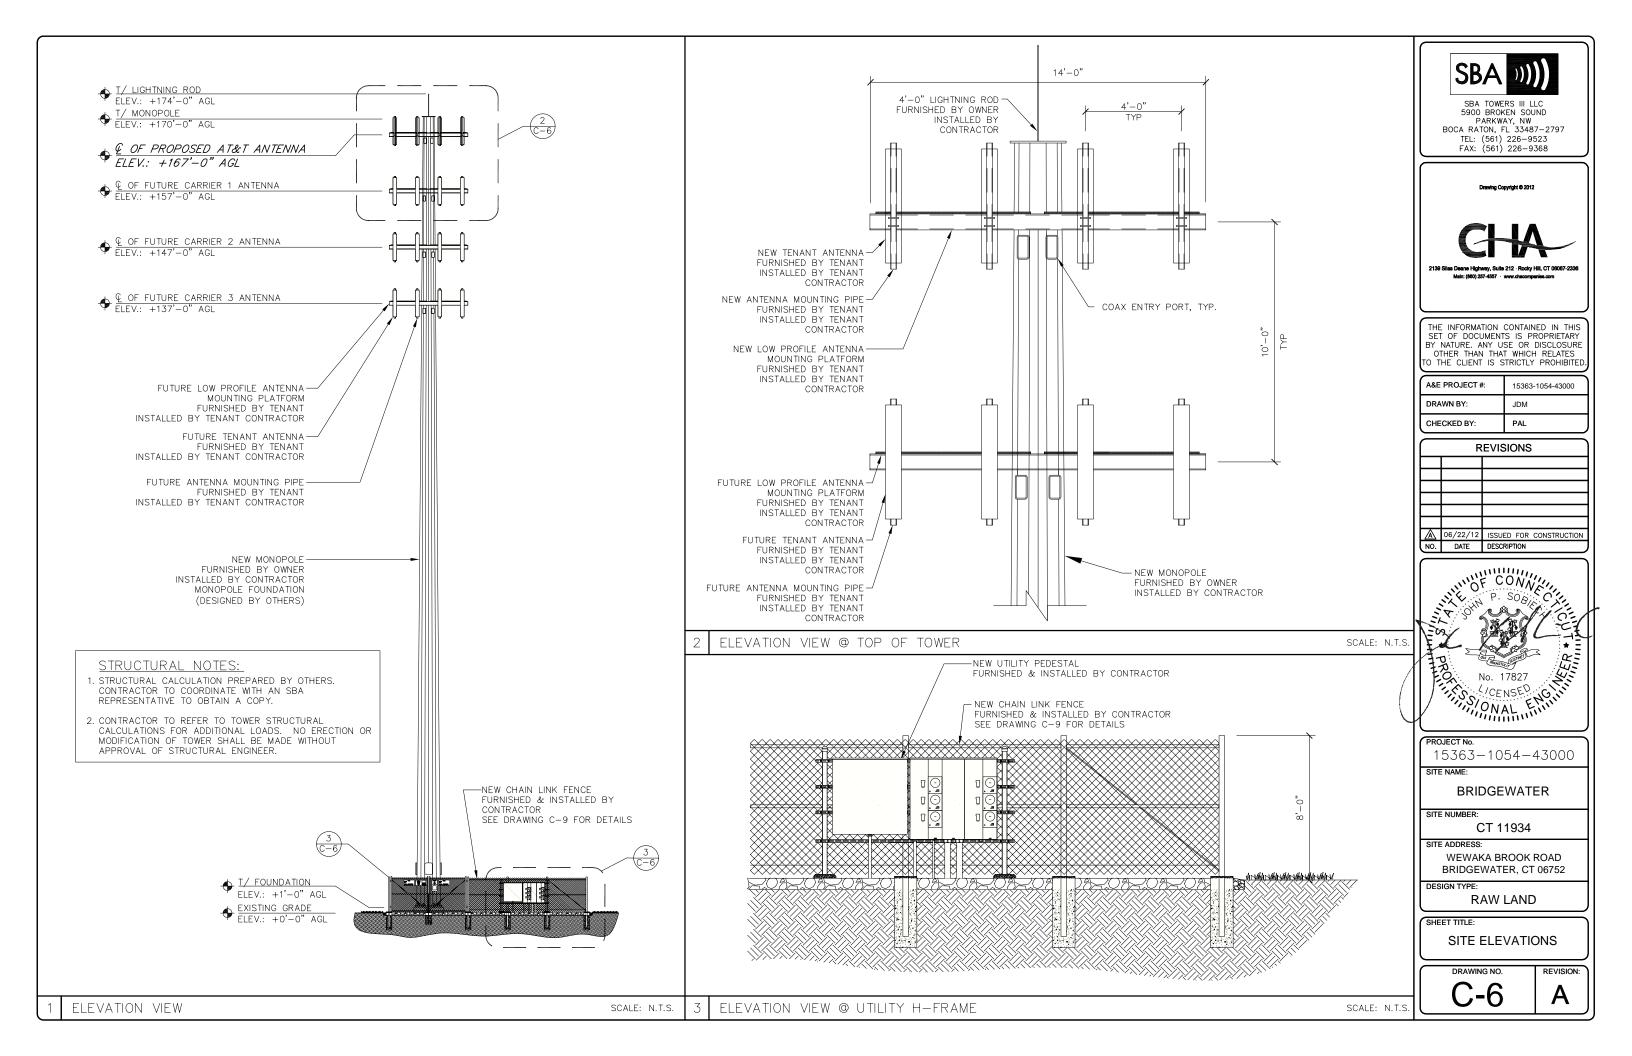




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PROJECT No.

15363-1054-43000

BRIDGEWATER


CT 11934

WEWAKA BROOK ROAD

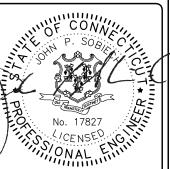BRIDGEWATER, CT 06752

RAW LAND

PROFILE 1 OF 3

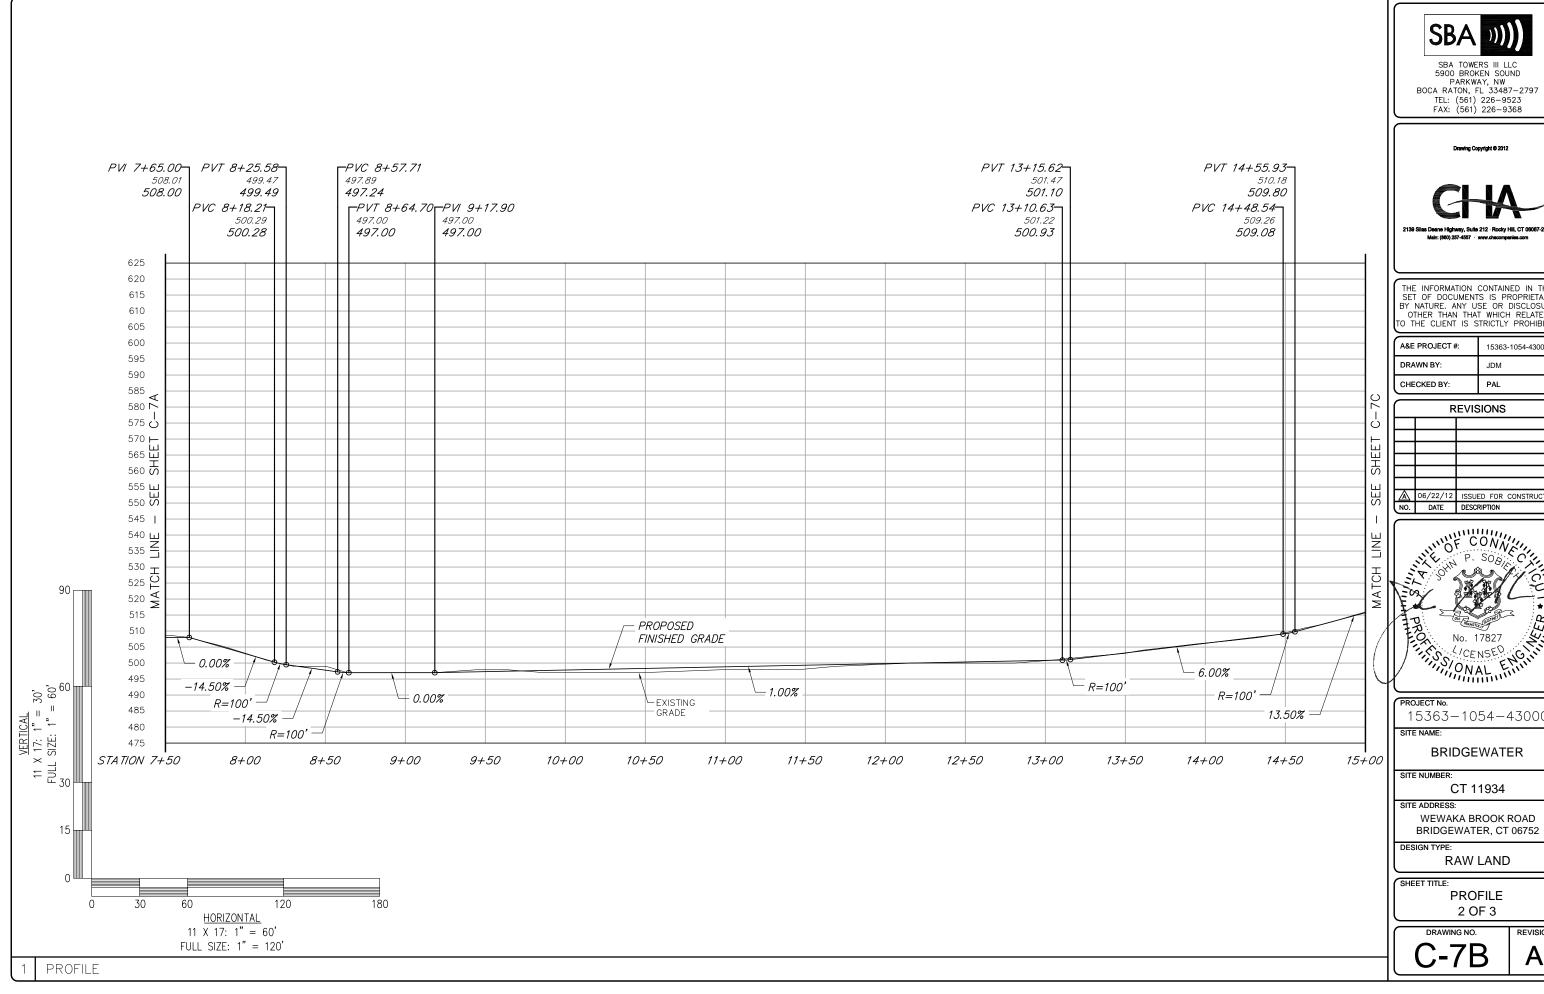



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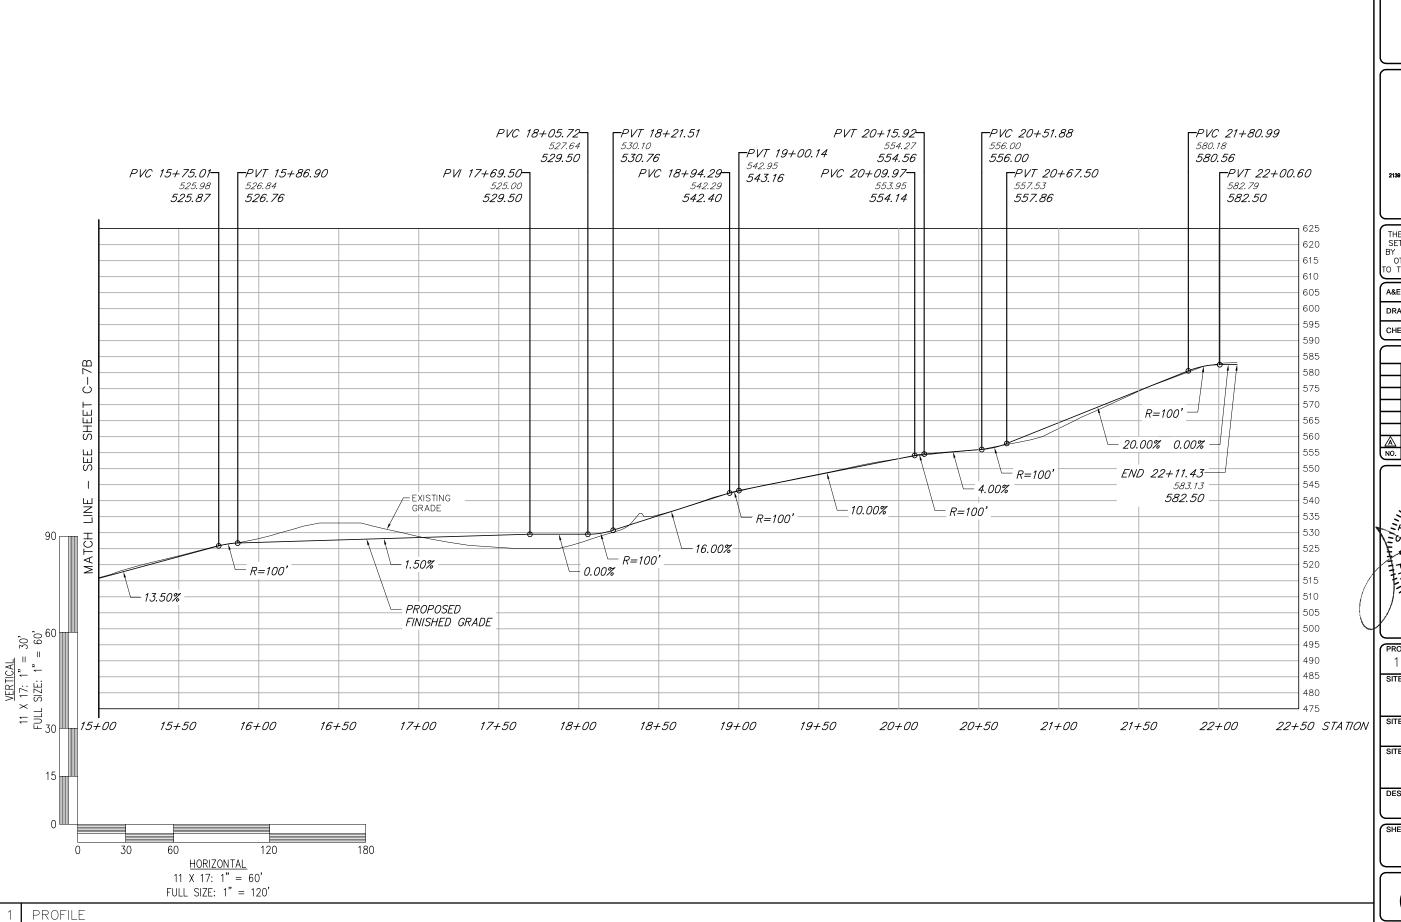
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15363-1054-43000

BRIDGEWATER, CT 06752





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PROJECT No.

15363-1054-43000

SITE NAM

BRIDGEWATER

SITE NUMBER:

CT 11934

SITE ADDRESS: WEWAKA BROOK ROAD

BRIDGEWATER, CT 06752

DESIGN TYPE:

RAW LAND


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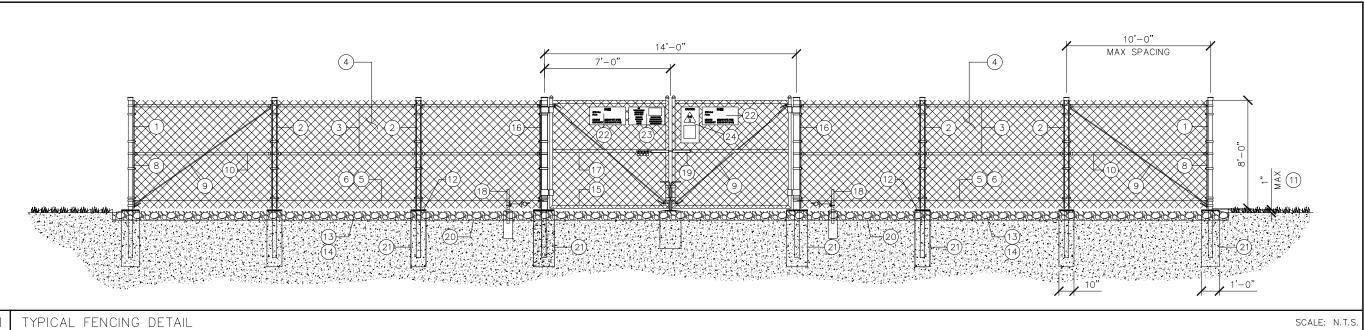
PROFILE 3 OF 3

DRAWING NO

REVISION:

C-7C



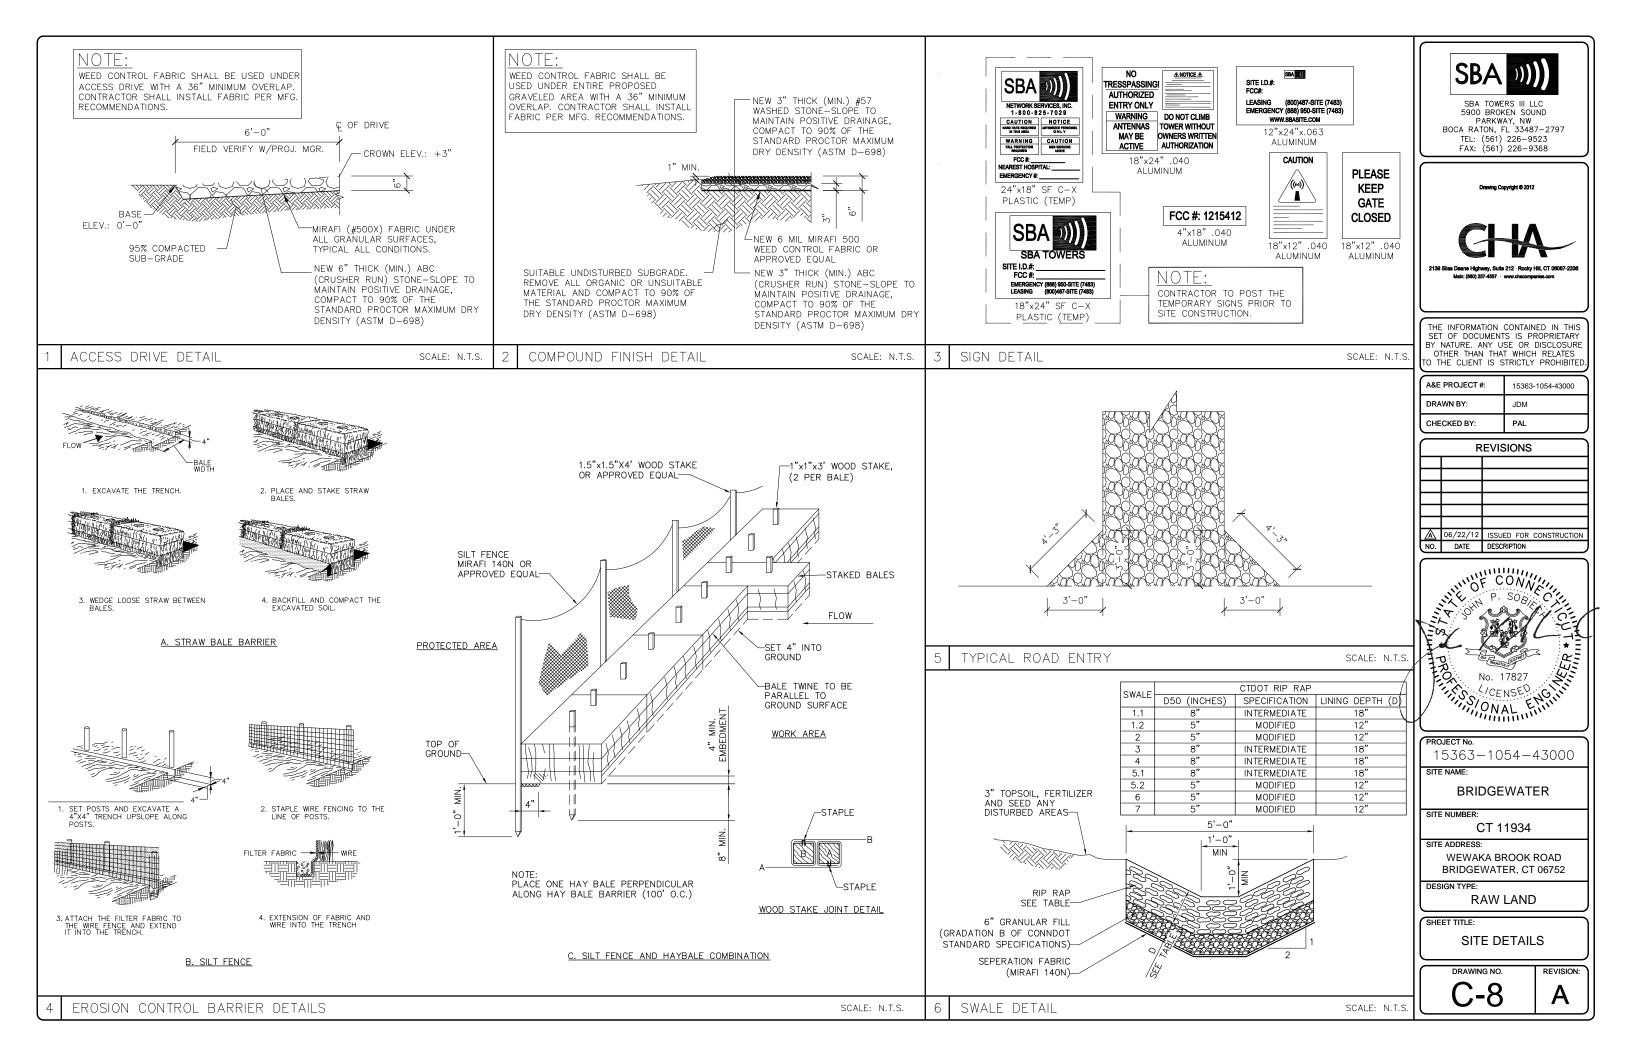

12'-0" DOUBLE SWING GATE 2" (MIN) GENERAL NOTES: GATE PLUNGER ROD-3" (MAX) 1. INSTALL FENCING PER ASTM F-567 2. INSTALL SWING GATES PER ASTM F- 900 3. LOCAL ORDINANCE OF BARBED WIRE PERMIT REQUIREMENT SHALL BE COMPLIED IF REQUIRED. 4. POST & GATE PIPE SIZES ARE INDUSTRY STANDARDS. ALL PIPE TO BE GALVANIZED (HOT DIP, ASTM A120 GRADE "A" STEEL). ALL GATE FRAMES SHALL BE WELDED. ALL WELDING SHALL BE COATED WITH (3) COATS OF COLD GALV. (OR EQUAL). 5. ALL OPEN POSTS SHALL HAVE END-CAPS. 6. USE GALVANIZED HOG-RING WIRE TO MOUNT ALL SIGNS. 7. ALL SIGNS MUST BE MOUNTED ON INSIDE OF FENCE CONCRETE POST 8. MUSHROOM ANCHOR & PLUNGER REQUIRED FOR GATE. 9. G.C. RESPONSIBLE FOR SBA GATE LOCK DOUBLE-SWING GATE DETAIL SCALE: 1/4"=1'-0" NOTES 14'-0" CHAIN AND LOCK. (22) HINGES 4" DIA. SCH. 40 STEEL PIPE, PROVIDE ONE PROGRAMMABLE (4 WELDED FILLED WITH CONCRETE. TO POST TAB) COMBINATION EXPOSED SURFACE SHALL BE LOCK PAINTED YELLOW

BALLOON REFERENCE NOTES:

- (1) CORNER, END OR PULL POST: 3" O.D. SCHEDULE 40 PIPE.
- 2 LINE POST: 2 1/2" NOMINAL SCHEDULE 40 PIPE, PER ASTM-F1083. LINE POSTS SHALL BE EQUALLY SPACED AT MAXIMUM 10'-0" O.C.
- (3) TOP RAIL & BRACE RAIL: 1-5/8"O.D. STANDARD ROUND PIPE, PER
- ASTM-F1083.

 (4) FABRIC: 9 GA CORE WIRE SIZE 2" MESH, CONFORMING TO ASTM-A392.
- (5) TIE WIRE: 9 GA ALUMINUM. A SINGLE WRAP OF FABRIC TIE AND AT TENSION WIRE BY HOG RINGS SPACED 12" O.C. POSTS/GATES AND 24" RAILS/WIRE.
- (6) TENSION WIRE: 9 GA ALUMINUM
- (7) BARBED WIRE: NOT REQUIRED
- (8) 3/16" X 3/4" (MIN) FULL HEIGHT STRETCHER BAR.
- (9) 3/8" DIAGONAL ROD WITH GALVANIZED STEEL TURNBUCKLE OR DIAGONAL THREADED ROD.
- (10) FENCE CORNER POST BRACE: 1 5/8" NOMINAL PIPE.
- 11) 1" MAXIMUM CLEARANCE FROM FINISH GRADE.
- (12) FENCE POST FOUNDATION TO BE 1" FINISH ABOVE FINISHED GRADE
- (13) 6" COMPACTED BASE MATERIAL
- (14) FINISH GRADE SHALL BE UNIFORM AND LEVEL.
- (15) WELDED GATE FRAME: 2" O.D., SCHEDULE 40 PIPE, PER ASTM-F1083.
- (16) GATE POST 4" O.D., SCHEDULE 40 PIPE, PER ASTM-F1083.
- 17) GATE FRAME BRACE RAIL: 1 1/2" NOMINAL PIPE, PER ASTM-F1083.
- (18) DUCK BILL OPEN GATE HOLDER. VERIFY LOCATION IN FIELD PRIOR TO INSTALLATION.
- (19) STYMIE LOCK MULTI-TENANT LOCKING DEVICE
- (20) GEOTEXTILE FABRIC
- 21) CONCRETE FOUNDATION (MIN 3000 PSI).
 MINIMUM DEPTH: 6" BELOW FROST LINE
- (22) 12" x 24" SBA SITE INFORMATION SIGN.
- (23) 12" x 24" NO TRESPASSING SIGN.
- (24) 12" x 24" RF CAUTION SIGN.
- 25) 18" x 12" KEEP GATE CLOSED SIGN.



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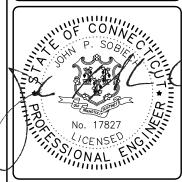
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PROJECT No. 15363−1054−43000

SITE NAM

BRIDGEWATER

SITE NUMBER:

CT 11934

WEWAKA BROOK ROAD BRIDGEWATER, CT 06752

SIGN TYPE:

RAW LAND

SHEET TITLE

SITE ADDRESS

FENCE DETAILS

DRAWING NO

REVISION:

C-9

3 SINGLE "CATTLE" GATE DETAIL

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SCALE: N.T.S. 5


-GROUND


BOLLARD DETAIL


SCALE: N.T.S.

2500 PSI CONCRETE

FENCING NOTES

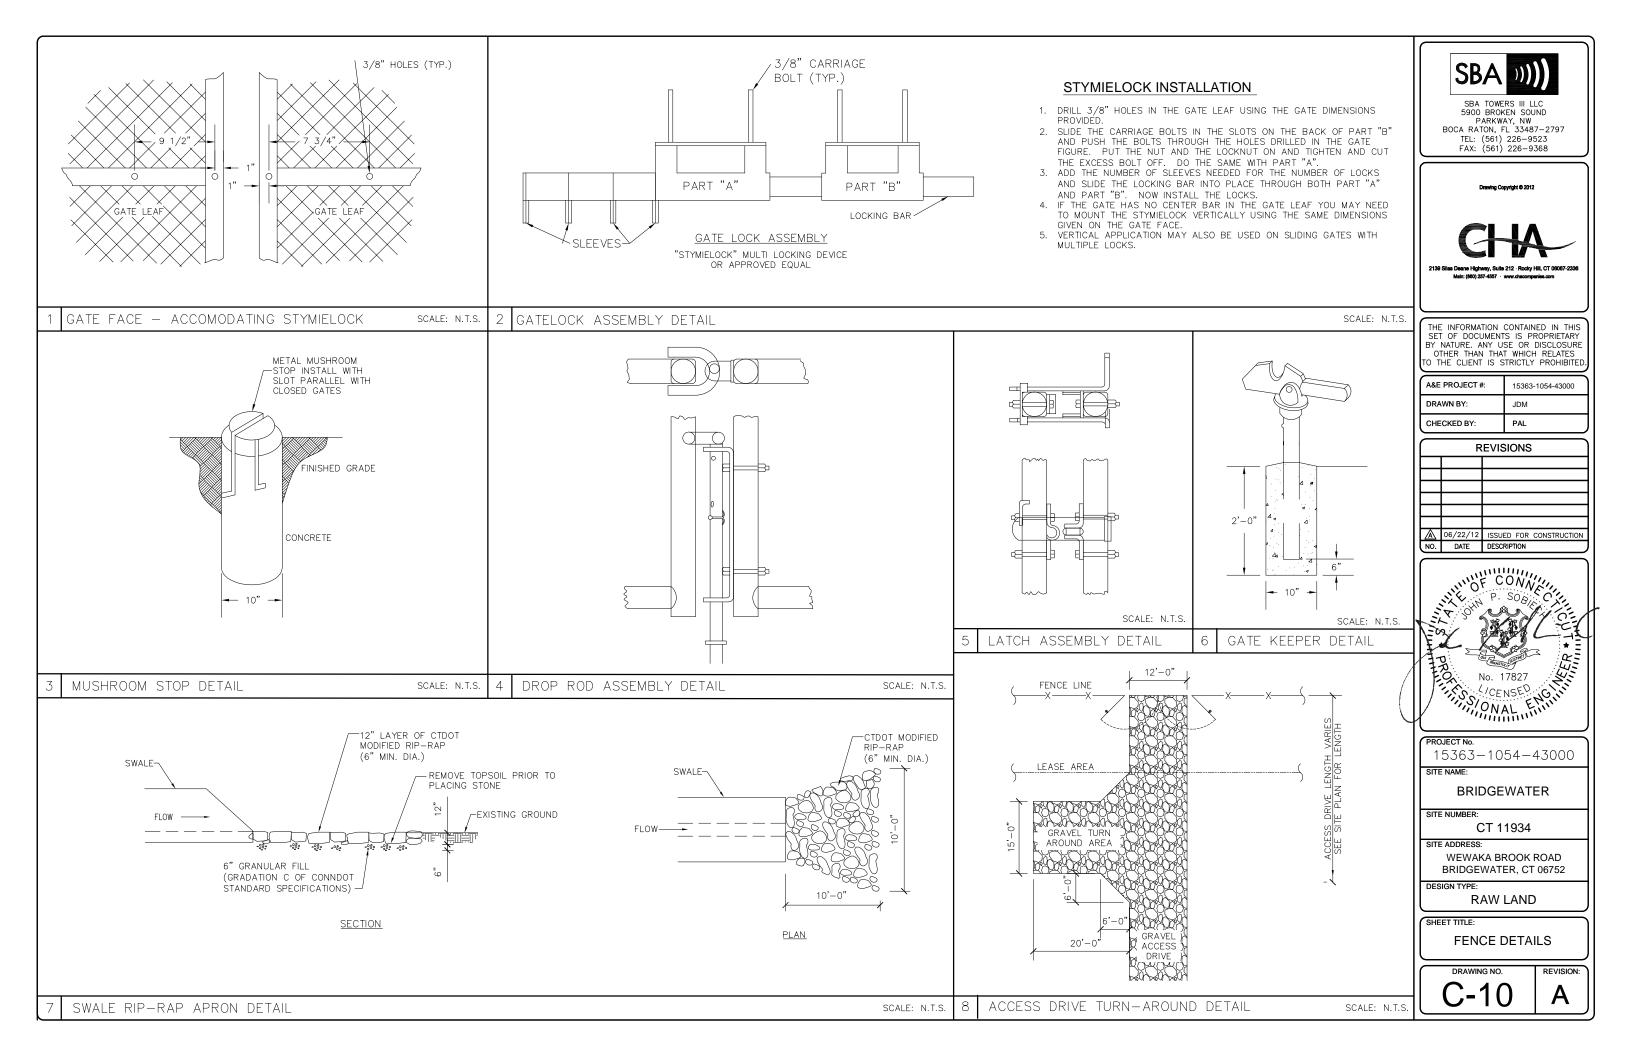

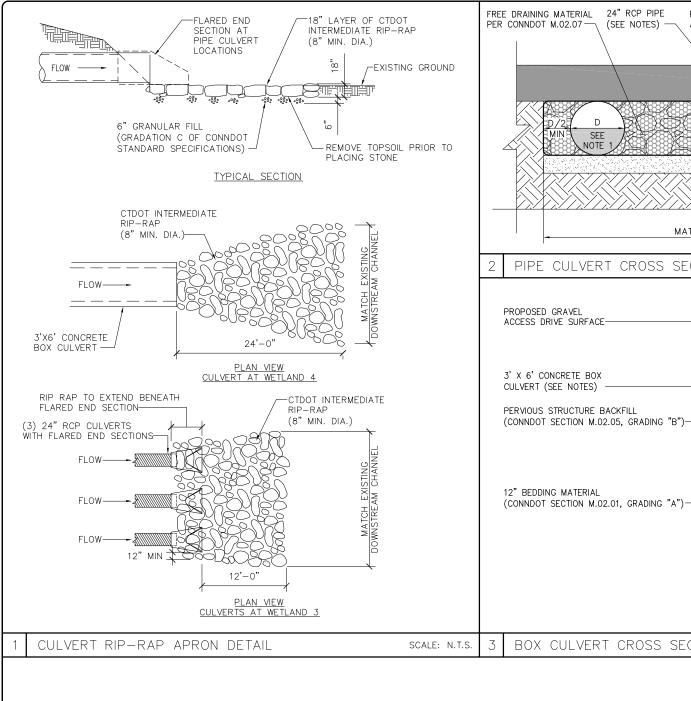

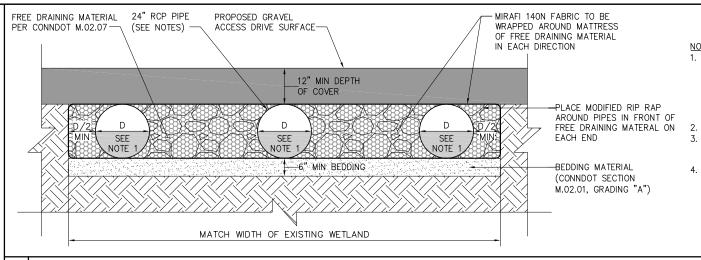

1

SEE NOTE 1

NOTES:

- BACKFILL CULVERT(S) WITH 12" NATURAL SUBSTRATE MATERIAL MATCHING THE UPSTREAM AND DOWNSTREAM STREAMBED SUBSTRATE. MATERIAL TO BE OBTAINED DURING EXCAVATION PRIOR TO INSTALLATION OF CULVERT AND SAVED
- PIPE CULVERTS TO BE CLASS V CONCRETE CULVERTS TO BE CONSTRUCTED IN 10' LENGTH (MAX) SECTIONS TO FACILITATE
- BACKFILLING WITH NATURAL SUBSTRATE. CULVERTS TO BE PRECAST UNITS DESIGNED AND FURNISHED BY OLDCASTLE PRECAST:

OLDCASTLE PRECAST NEW ENGLAND AVON PLANT (860) 673-3291 151 FARMS ROAD AVON, CT 06001-2253

-6" MIN DEPTH OF COVER

SCALE: N.T.

SBA TOWERS III LLC


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| ١ | CHECKED BY: | PAL |

REVISIONS 06/22/12 ISSUED FOR CONSTRUCTION NO. DATE DESCRIPTION



PROJECT No. 15363-1054-43000

SITE NAME:

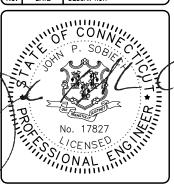BRIDGEWATER

SITE NUMBER:

CT 11934

SITE ADDRESS

WEWAKA BROOK ROAD BRIDGEWATER, CT 06752

DESIGN TYPE

RAW LAND

SITE DETAILS

SHEET TITLE:

REVISION:

PIPE CULVERT CROSS SECTION

BOX CULVERT CROSS SECTION

BACKFILL CULVERT(S) WITH 12" NATURAL SUBSTRATE MATERIAL MATCHING THE UPSTREAM AND DOWNSTREAM STREAMBED SUBSTRATE. MATERIAL TO BE OBTAINED DURING EXCAVATION PRIOR TO INSTALLATION OF CULVERT AND SAVED CULVERT TO BE OF SUFFICIENT STRENGTH TO WITHSTAND H20 LOADING UNDER THE CONFIGURATION SHOWN (6" COVER), REFER TO ASTM C1433.


CULVERT TO HAVE "SLAB" TOP TO FACILITATE BACKFILLING WITH NATURAL

SUBSTRATE. CULVERT TO BE PRECAST UNIT DESIGNED

AVON, CT 06001-2253

AND FURNISHED BY OLDCASTLE PRECAST: OLDCASTLE PRECAST NEW ENGLAND AVON PLANT (860) 673-3291 151 FARMS ROAD

SCALE: N.T.

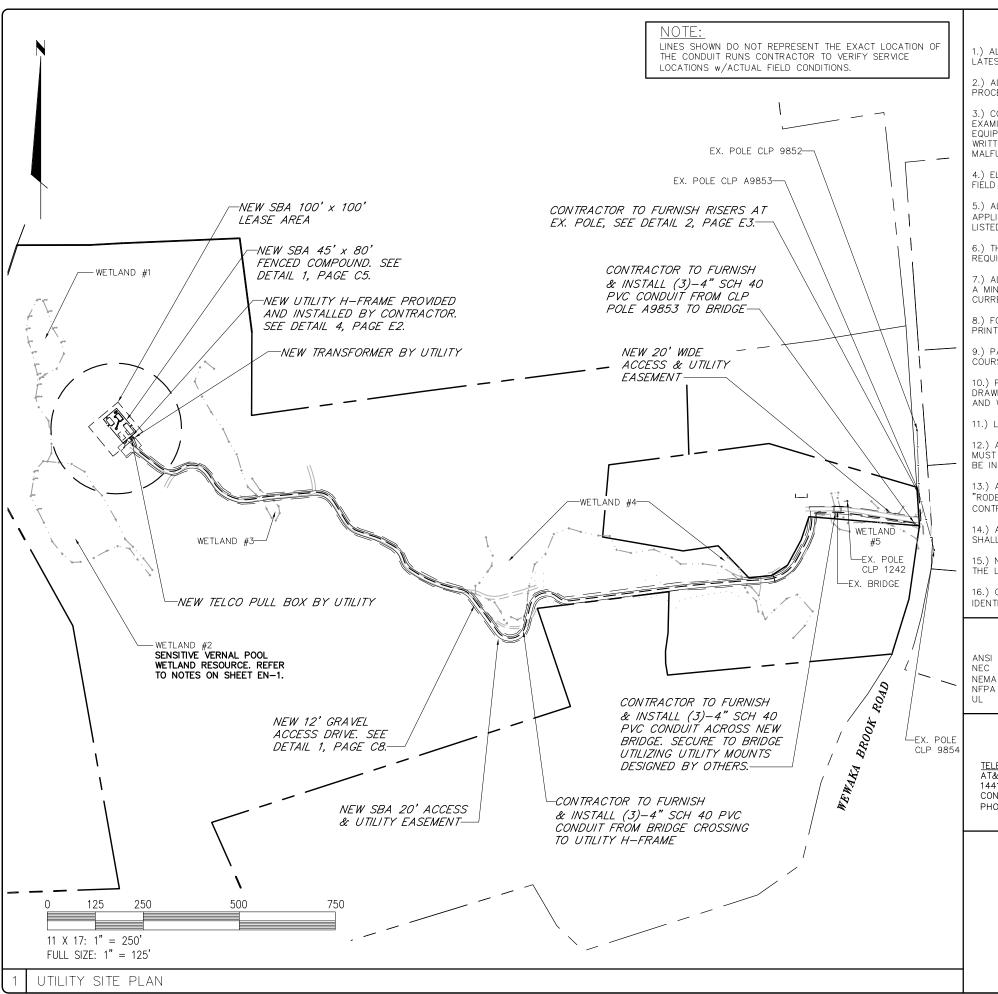

GENERAL ELECTRICAL NOTES

- 1.) ALL ELECTRICAL WORK SHALL CONFORM TO NATIONAL ELECTRIC CODE, LATEST ADOPTED EDITION, AND LOCAL CODES.
- 2.) ALL ELECTRICAL MATERIALS, EQUIPMENT AND INSTALLATION PROCEDURES TO CONFORM WITH SBA SPECIFICATIONS.
- 3.) CONTRACTOR SHALL PERFORM ALL VERIFICATION TESTS AND EXAMINATION WORK PRIOR TO THE ORDERING OF THE ELECTRICAL EQUIPMENT AND THE ACTUAL CONSTRUCTION. CONTRACTOR SHALL ISSUE A WRITTEN NOTICE OF ALL FINDINGS TO THE ENGINEER LISTING ALL MALFUNCTIONS, FAULTY EQUIPMENT & DISCREPANCIES.
- 4.) ELECTRICAL PLANS, DETAILS, AND DIAGRAMS ARE DIAGRAMMATIC ONLY. FIELD CONDITIONS DICTATE THE AMOUNT AND LOCATION OF EQUIPMENT.
- 5.) ALL MATERIALS SHALL BE MANUFACTURED IN ACCORDANCE WITH APPLICABLE STANDARDS ESTABLISHED BY ANSI, NEMA, NFPA, AND "UL" LISTED.
- 6.) THE ENTIRE ELECTRICAL INSTALLATION SHALL BE GROUNDED AS REQUIRED BY THE NEC, AND ALL APPLICABLE LOCAL CODES.
- 7.) ALL CIRCUIT BREAKERS, FUSES AND ELECTRICAL EQUIPMENT SHALL HAVE A MINIMUM INTERRUPTING RATING GREATER THAN THE UTILITY FAULT
- $8.) \ \mbox{FOR} \ \mbox{COMPLETE INTERNAL WIRING AND ARRANGEMENT REFER TO VENDOR PRINTS AND INSTRUCTIONS.$
- 9.) PATCH, REPAIR AND PAINT ANY AREA THAT HAS BEEN DAMAGED IN THE COURSE OF THE ELECTRICAL WORK.
- 10.) PROVIDE SBA WITH ONE SET OF COMPLETE ELECTRICAL "AS-BUILT" DRAWINGS AT THE COMPLETION OF THE JOB SHOWING ACTUAL ROUTINGS AND WIRING CONNECTIONS.
- 11.) LABEL ALL ELECTRICAL EQUIPMENT PER SBA SPECIFICATIONS.
- 12.) ALL SINGLE-PHASE SELF-CONTAINED METER CONNECTION DEVICES MUST INCLUDE HORN TYPE BY-PASS PROVISION SO THAT SERVICE WILL NOT BE INTERRUPTED WHEN A METER IS REMOVED FROM THE SOCKET.
- 13.) ALL EQUIPMENT PUNCH OUTS AND CONDUITS (USED AND SPARE) TO BE "RODENT PROOFED" WITH CAPS, STEEL MESH, AND/OR FOAM FILL BY CONTRACTOR (AS NEEDED).
- 14.) ALL INTERIOR CONDUITS AND BUSHINGS SHALL BE EMT. ALL EXTERIOR SHALL BE PVC UNLESS NOTED OTHERWISE. SEE SBA SPECIFICATIONS.
- 15.) NO SPOILS TO BE LEFT ON SITE WITHOUT THE WRITTEN CONSENT OF THE LANDOWNER
- 16.) CONTRACTOR TO PROVIDE 2 PHENOLIC LABELS AT METER. ONE TO IDENTIFY "SBA DISCONNECT" AND THE OTHER TO GIVE SITE ADDRESS.

<u>CODES AND STANDARDS</u>

AMERICAN NATIONAL STANDARDS INSTITUTE
C NATIONAL ELECTRICAL CODE, LATEST ADOPTED EDITION
MA NATIONAL ELECTRICAL MANUFACTURER'S ASSOCIATION
PA NATIONAL FIRE PROTECTION ASSOCIATION
UNDERWRITERS LABORATORIES, INC.

UTILITY PROVIDE INFORMATION

TELEPHONE COMPANY:

AI&I 1441 NORTH COLONY ROAD, MERIDEN, CT CONTACT: UKNOWN PHONE: (203) 420–3131 POWER COMPANY: CL&P 107 SELDEN STREET, BERLIN, CT CONTACT: UNKNOWN PHONE: (860) 947-2000 SBA TOWERS III LLC 5900 BROKEN SOUND PARKWAY, NW A BATON EL 33487, 2700

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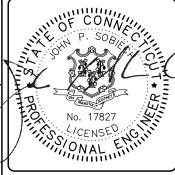
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| ١ | A&E PROJECT #: | 15363-1054-43000 |
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| ı | DRAWN BY: | JDM |
| | CHECKED BY: | PAL |
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| A | 10/01/12 | REVISED UTILITIES |
| \mathbb{A} | 06/22/12 | ISSUED FOR CONSTRUCTION |
| NO. | DATE | DESCRIPTION |
| | | |



PROJECT No

15363-1054-43000

SITE NAME:

BRIDGEWATER

SITE NUMBER:

CT 11934

SITE ADDRESS:
WEWAKA BROOK ROAD
BRIDGEWATER, CT 06752

IGN TYPE:

RAW LAND


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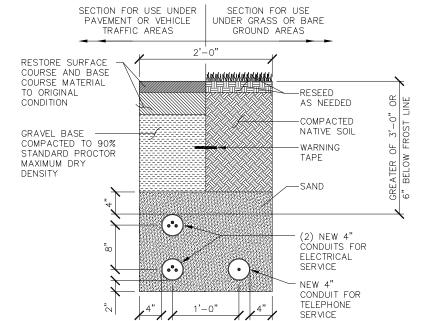
UTILITY SITE PLAN

DRAWING NO

REVISION:

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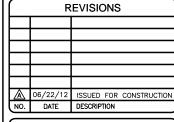
Drawing Copyright @ 201:

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39 Siles Deane Highway, Suite 212 - Rocky Hill, CT 00067-233
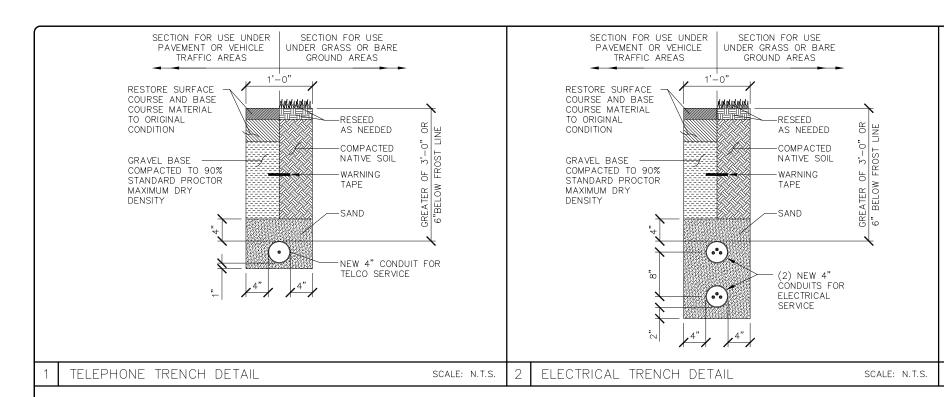
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| S. | A&E PROJECT #: | 15363-1054-43000 |
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| | DRAWN BY: | JDM |
| | CHECKED BY: | PAL |

SCALE: N.T.:





PROJECT No. 15363−1054−43000

SITE NAME:

BRIDGEWATER

SITE NUMBER:

CT 11934

SITE ADDRESS: WEWAKA BROOK ROAD

BRIDGEWATER, CT 06752

SIGN TYPE:

RAW LAND

UTILITY DETAILS

DRAWING NO


REVISION:


UTILITY & TELCO H-FRAME DETAIL

(5) HORIZONTAL SUPPORT MEMBER (UNISTRUT P1000, OR APPROVED EQUAL)

 $\stackrel{\text{\tiny \#2}}{\text{\tiny 6}}$ AWG BARE SOLID TINNED COPPER WIRE ROUTED TO GROUNDING SYSTEM (TYP. EACH LEG)

(7) 3" NOMINAL GALVANIZED STEEL PIPE WITH PIPE CAP

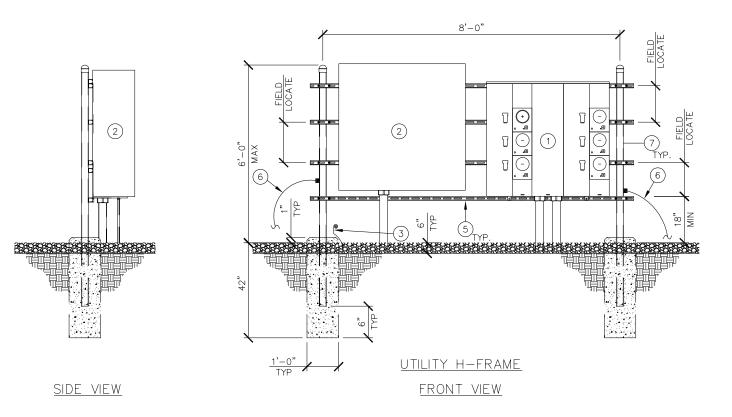

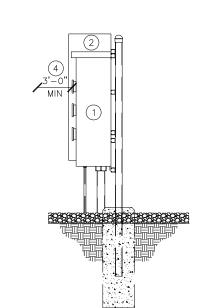


SIDE VIEW


JOINT UTILITY TRENCH DETAIL

BALLOON REFERENCE NOTES:

- 800A, 120/240V, 1 PHASE, 3 WIRE, 6 POSITION METERING CENTER (200A MAX CIRCUIT BREAKER) (SQUARE D METER PAK MPR86200, OR EQUAL)
- 2) 36" x 36" X 12" NEMA 3R ENCLOSURE HOFFMAN A-36R3612HCR OR EQUAL
- (3) 6' #6 GROUND WIRE COILED AT POST. CONNECT TO GROUNDING SYSTEM
- 4 CONTRACTOR TO MAINTAIN 3'-0" MINIMUM CLEARANCE FROM METERING CENTER TO NEAREST OBSTRUCTION

H—FRAME DETAIL

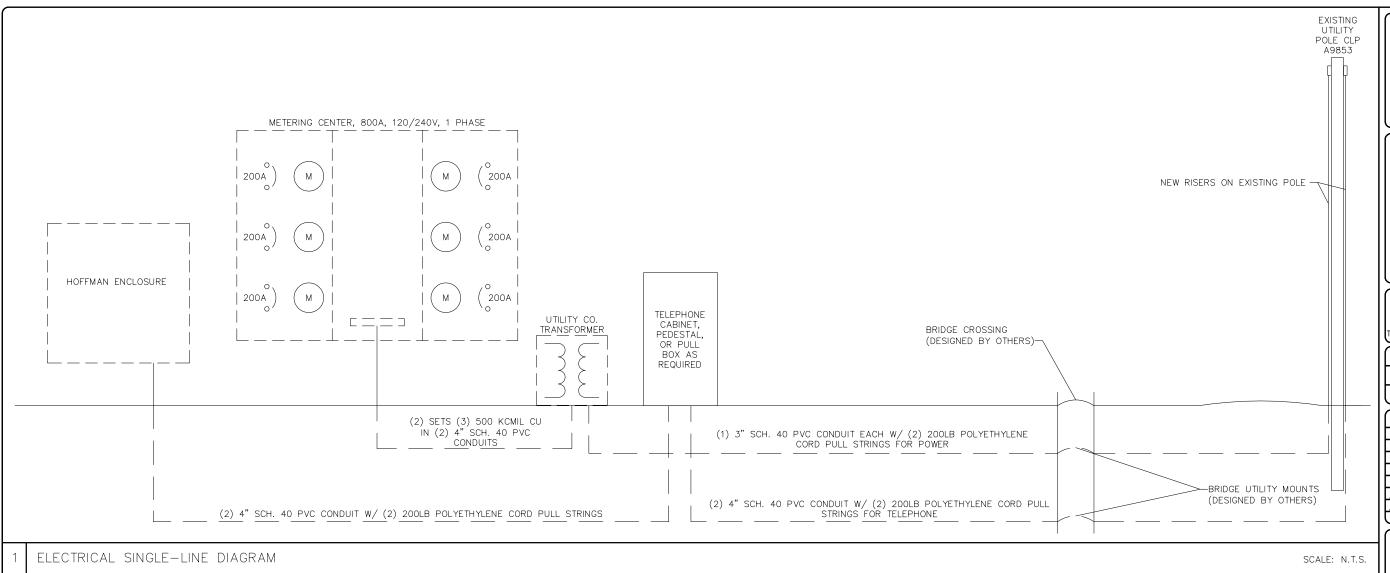

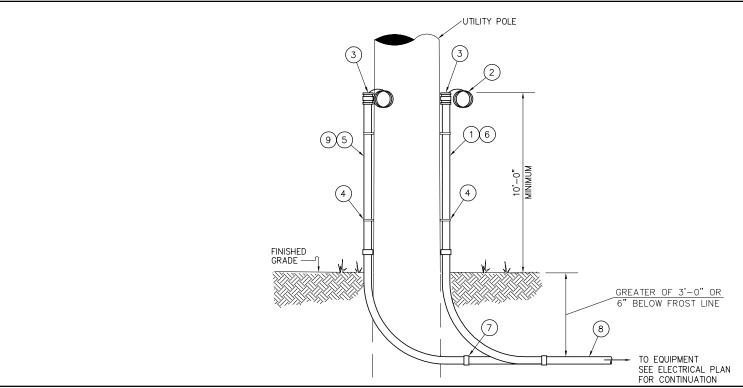

NOTES

- 1. BOND ALL METAL OBJECTS TO POLE GROUNDING SYSTEM.
- 2. COORDINATE ALL INSTALLATIONS TO UTILITY POLE WITH UTILITY CO.

SERVICE POLE CODED NOTES

- 1 ELECTRICAL SERVICE CONDUIT SIZE, QUANTITY AS INDICATED ON ELECTRICAL SITE PLAN.
- 2 PROVIDE SUFFICIENT CABLE TO REACH A MINIMUM 36" ABOVE TERMINATION LOCATIONS.
- 3 PROVIDE INSULATING BUSHING. USE DUCT SEAL TO MAKE WATERTIGHT.
- (4) PIPE STRAPS, INSTALL AT NOT MORE THAN 2'-0" INTERVALS.
- 5 TELEPHONE SERVICE CONDUIT WITH PULL WRE. SIZE, QUANTITY AS INDICATED ON ELECTRICAL SITE PLAN.
- 6 GALVANZINED RISER AND ELBOWS. SIZE AS INDICATED ON ELECTRICAL SITE PLAN.
- 7) PVC ADAPTER. TYPICAL TELEPHONE AND POWER CONDUITS.
- 8 DIRECT BURIED CONDUITS. SIZE, QUANTITY AND ROUTING AS INDICATED ON ELECTRICAL SITE PLAN.
- 9 SCH. 40 PVC CONUIT RISER AND ELBOWS. SIZE AS INDICATED ON ELECTRICAL SITE PLAN.



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PROJECT No.

15363-1054-43000

SITE NAME

BRIDGEWATER

SITE NUMBER:

CT 11934

SITE ADDRESS:
WEWAKA BROOK ROAD
BRIDGEWATER, CT 06752

DESIGN TYPE:

RAW LAND


& PANEL SCHEDULE

SHEET TITLE:
SINGLE LINE DIAGRAM

DRAWING NO

REVISI

E-3

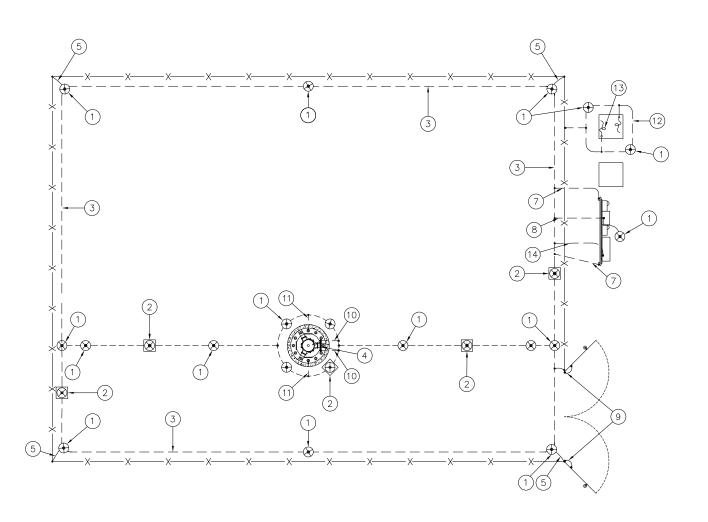

BALLOON REFERENCE NOTES:

- 1) 5/8"~X8' COPPER CLAD GROUND ROD BURIED 36" BELOW GRADE
- GROUND ROD ACCESS WELL (MIN. OF 4 EACH PER COMPOUND)
- #2 SOLID, TINNED, BARE COPPER WIRE GROUND RING (CONTINUOUS STRAND)
- 1/4"X4"X20" TINNED COPPER GROUND BAR. 2 TYP, AT BASE AND TOP OF TOWER. MOUNT DIRECT TO TOWER, DO NOT ISOLATE.
- #2 SOLID, TINNED, BARE COPPER WIRE GROUND LEAD TO FENCE CORNER POST.
- $\ensuremath{\#2}$ Solid, tinned, bare copper wire ground lead to telco common box
- $\ensuremath{\#2}$ Solid, tinned, bare copper wire ground lead to utility H-frame support post
- SERVICE ENTRANCE GROUND TO DEDICATED GROUND ROD

- (9) #2 INSULATED, STRANDED COPPER BOND STRAP FROM GATE FRAME TO GATE POST. (TYP EACH GATE)
- (10) #2 SOLID, TINNED, BARE COPPER GROUND LEAD FROM GROUND BAR AT MONOPOLE BASE TO GROUND RING. ROUTE IN 3/4" FLEX CONDUIT AND WEATHERPROOF OPEN END. (2 TYPICAL)
- (1) #2 SOLID, TINNED, BARE COPPER GROUND LEAD FROM MONOPOLE BASE TO GROUND RING. (2 TYPICAL, 180* SEPARATION)
- #2 SOLID, TINNED, BARE COPPER WRE GROUND RING (CONTINUOUS STRAND) FOR UTILITY TRANSFORMER. PER NEC AND UTILITY COMPANY SPECIFICATIONS
- #2 SOLID, TINNED, BARE COPPER GROUND LEAD FROM UTILITY TRANSFORMER TO GROUND RING. (2 TYPICAL)
- #2 SOLID, TINNED, BARE COPPER WIRE FROM HOFFMAN BOX TO GROUND RING

SYMBOLS LEGEND

GROUND ROD WITH ACCESS

 \bigcirc

ENLARGED GROUNDING PLAN @ TOWER BASE (TYP.)

MECHANICAL CONNECTION



(3)

GROUND ROD

GROUND BAR

EXOTHERMIC CONNECTION

GROUND WIRE



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| A&E PROJECT #: | 15363-1054-43000 |
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| DRAWN BY: | JDM |
| CHECKED BY: | PAL |

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15363-1054-43000

BRIDGEWATER

SITE NUMBER:

CT 11934

SITE ADDRESS: WEWAKA BROOK ROAD BRIDGEWATER, CT 06752


RAW LAND

GROUNDING PLAN & DETAILS

EG-

SITE GROUNDING PLAN (TYP.)

3 | ENLARGED GROUNDING PLAN @ UTILITY & TELCO PEDESTAL

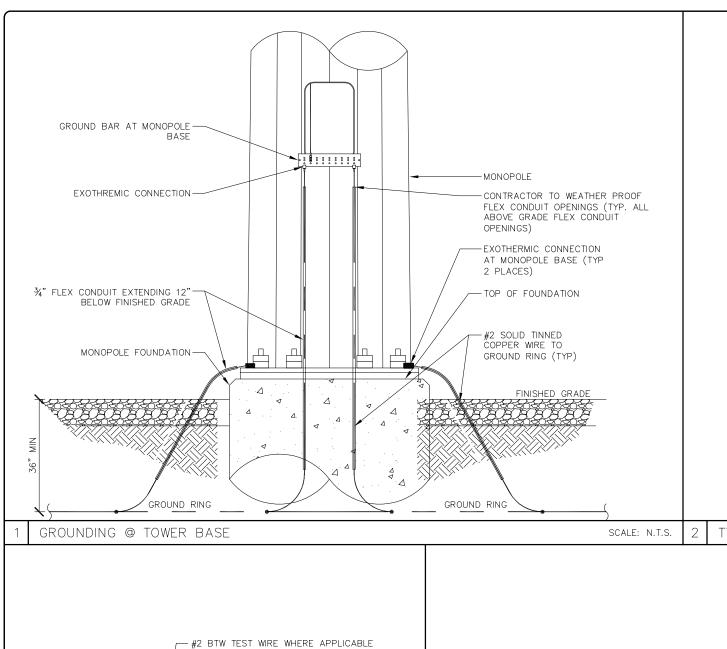

CADWELD CONNECTIONS (OR APPROVED EQUAL)



PARALLEL HORIZONTAL CONDUCTORS PARALLEL THROUGH CONNECTION OF HORIZONTAL CABLES TYPE PT



THROUGH CABLE TO GROUND ROD THROUGH CABLE TO TOP OF GROUND ROD TYPE



HORIZONTAL SPLICE SPLICE OF HORIZONTAL CABLES



HORIZONTAL STEEL SURFACE TO FLAT STEEL SURFACE OR HORIZONTAL PIPE TYPE



VERTICAL STEEL SURFACE CABLE DOWN AT 45° TO VERTICAL STEEL SURFACE INCLUDING PIPE TYPE VS



VERTICAL PIPE CABLE DOWN AT 45° TO RANGE OF VERTICAL PIPES TYPE VS

BURNDY CONNECTIONS

(OR APPROVED EQUAL)



"C" CONNECTOR HYPRESS TYPE YGHC



BOND JUMPER FIELD FABRICATED GREEN STRANDED INSULATED TYPE 2-YA-2



COPPER LUGS TWO HOLE — LONG BARREL LENGTH TYPE YA-2




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PROJECT No 15363-1054-43000

BRIDGEWATER

SITE NUMBER:

CT 11934 SITE ADDRESS


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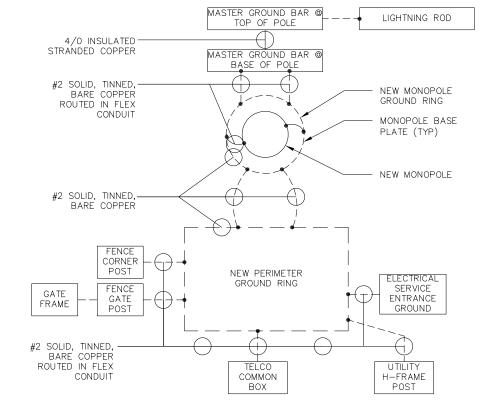
> > **RAW LAND**

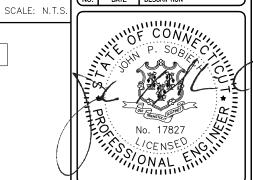REVISION:

DESIGN TYPE SHEET TITLE: **GROUNDING DETAILS** EG-2 SCALE: N.T.

TYPICAL WELDING CONNECTIONS



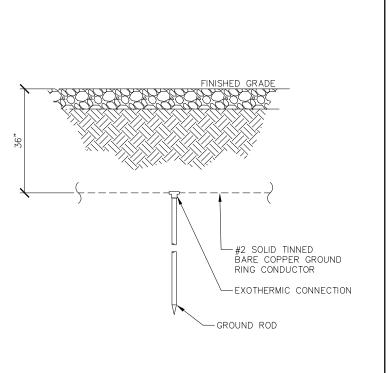

GROUNDING ROD DETAIL

SCALE: N.T.S.

ACCESS WELL DETAIL SCALE: N.T.S.

-#2 SOLID TINNED BARE COPPER GROUND

8" MIN. CRUSHED STONE

RING CONDUCTOR

A.L.T. OR EQUIVALENT


-EXOTHERMIC CONNECTION

8"~X44" SCH. 40 PVC TEST WELL W/ CAST IRON LID.

FINISHED GRADE

-GROUND ROD

SINGLE-LINE DIAGRAM

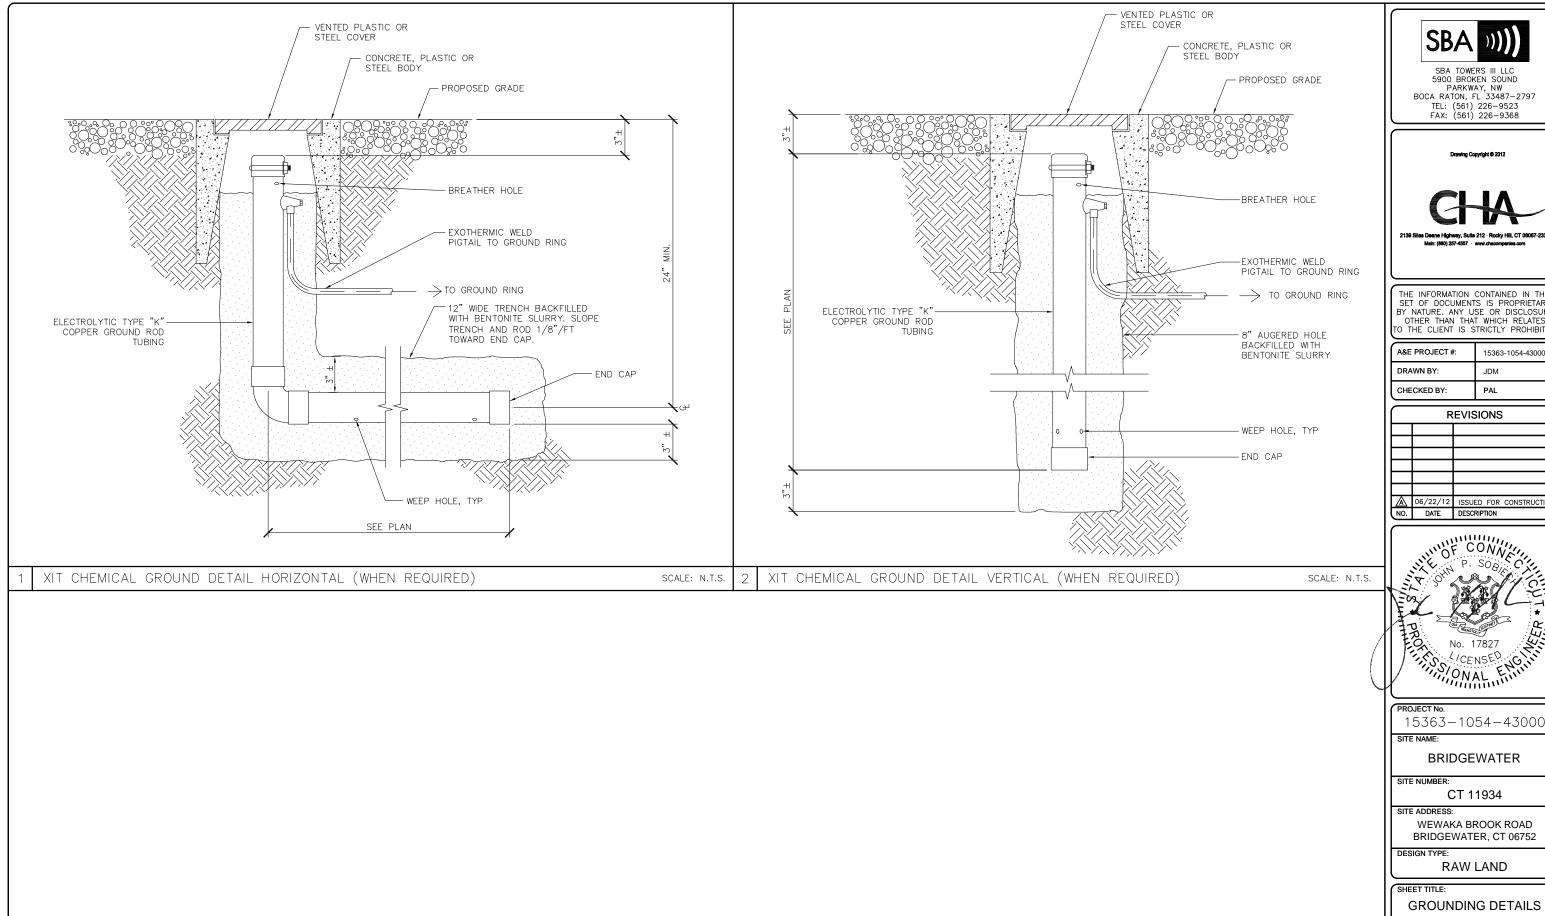

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15363-1054-43000

BRIDGEWATER

CT 11934

WEWAKA BROOK ROAD BRIDGEWATER, CT 06752

RAW LAND

REVISION:

EG-3