

Matt Burke

16 Chestnut Street, Suite 220 Foxboro, MA 02035 Tel (508) 930-0974 Fax (774) 215-5423

Melanie Bachman Acting Executive Director Connecticut Siting Council 10 Franklin Square New Britain, CT 06051

Re: Notice of Exempt Modification - Emergency Backup Generator 350 Burr Mountain Road, Torrington, CT 06790 (FA# 10035404)

Dear Ms. Bachman:

American Telephone and Telegraph Company ("AT&T") currently maintains a wireless telecommunications facility at the above referenced address. AT&T's facility consists of antennas at the 175' level of an existing 191-6' tower and a 12' x 20' equipment shelter. The tower and AT&T's shelter are located within an existing, fenced-in compound area. The shelter houses AT&T's equipment and space for a back-up generator. AT&T does not currently maintain a generator at this cell site.

In an effort to further enhance multiple tenants' network reliability, AT&T intends to modify its facility by installing a new diesel-fueled generator outside in a designated 4' x 8' ground space. The generator incorporates a built-in fuel tank as part of the unit. The diesel fuel tanks are double walled for added safety and will be filled by a licensed fuel filling company. The proposed modification will remain within the existing, fenced-in compound. The new generator and tank with be surrounded by a security fence and gate and will be placed on a 4' x 8' concrete pad. (See Facility Compound Plan attached).

Please accept this letter as notification pursuant to R.C.S.A Section 16-50j-73, for construction that constitutes modification pursuant to R.C.S.A Section 16-50j-72(b)(2). In accordance with R.C.S.A Section 16-50j-73, a copy of this submission is being sent to the City of Torrington. A copy of this submission is also being sent to SBA 2012 TC Assets LLC, the property owner on which the tower is located.

AT&T's Proposed Wireless Modifications Constitute An "Exempt Modification"

The proposed modification to the above mentioned Facility constitutes an exempt modification of an existing facility provided for in R.C.S.A Section 16-50j-72(b)(2) and Council regulations promulgated pursuant thereto.

- 1) The proposed modification will not result in an increase in the height of the existing tower.
- 2) The generator and attached fuel tank will remain entirely within the limits of the leased area. The modifications therefore, will not require the extension of the boundary.
- 3) The proposed modification does not increase the noise levels at the boundary by six (6) decibels or more under normal conditions. Proposed modification is only used during emergency power failure.
- 4) The installation of a new generator and attached fuel tank will not change, in any way, radio frequency (RF) emissions at the facility.
- 5) The facility has received all municipal zoning approvals and building permits. (Regs., Conn. State Agencies Section 16-50j-72))

For all the foregoing reasons, American Telephone and Telegraph Company respectfully submits that the proposed modifications to the above-referenced telecommunications facility constitutes an exempt modification under R.C.S.A Section 16-50j-72(b)(2)


Respectfully submitted,

Matt Burke 508.930.0974

On behalf of AT&T c/o Tower Resource Management, Inc. 16 Chestnut Street, Suite 220 Foxboro, MA 02035

cc: City of Torrington, CT SBA 2012 TC Assets, LLC Exhibit 1

Site Plan

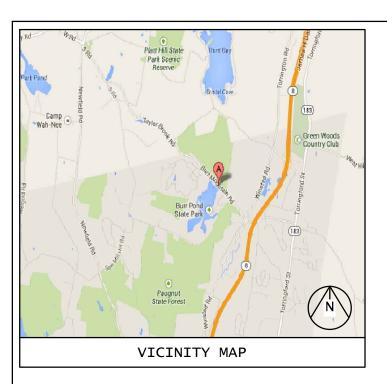

Know what's below.

Call before you dig.

at&t


BACKUP POWER PROJECT

SITE IDENTIFICATION:

SITE NUMBER: 10035404

SITE NAME: TORRINGTON-BURR MT ROAD

SITE ADDRESS: BURR MOUNTAIN ROAD TORRINGTON, CT 06790

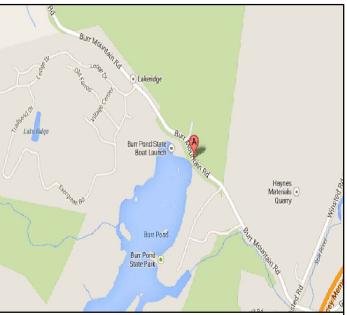

LOCAL MAP

NOTE:

CONTRACTOR TO VERIFY EXISTING MUX LOCATION. IF MUX LOCATION IS OUTSIDE OF AT&T EQUIPMENT AREA, CONTRACTOR IS TO FIELD VERIFY THE PRESENCE OF EMERGENCY BACK-UP SERVICE TO THE MUX. IF EMERGENCY BACK-UP SERVICE IS NOT PRESENT, CONTRACTOR IS TO ROUTE NEW SERVICE FROM AT&T EQUIPMENT AREA



500 ENTERPRISE DRIVE, SUITE 3A ROCKY HILL, CT 06067

Design Groupic

1600 OSGOOD STREET
BUILDING 20 NORTH, SUITE 3090
N. ANDOVER, MA 01845

TEL: (978) 557-5553 FAX: (978) 336-5586

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SITE NUMBER:

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TORRINGTON BURR MT ROAD

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TITLE SHEET VICINITY MAP AND GENERAL INFORMATION

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PROJECT DESCRIPTION:


THE PROPOSED PROJECT INCLUDES PLACING A 50 KW GENERATOR IN AN EXISTING CELLULAR TOWER COMPOUND.

PROJECT TEAM	PROJECT SUMMARY	PROJECT NOTES		SHEET INDEX			$\overline{}$	'l F
CUSTOMER REPRESENTATIVE:	GEOGRAPHIC COORDINATES:	TROJECT NOTES	SHT					
PEGGY POOR	LATITUDE: 41° 52' 33.9" N (41.876092 N)	1. THE FACILITY IS UNMANNED.	NO:	<u>DESCRIPTION:</u>	REV:	DATE:	BY:	
SABRE INDUSTRIES MARKET LEAD - AT&T NE GENERATOR PROGRAM	LONGITUDE: -73° 5' 7.1" W (-73.085299 W) GROUND ELEVATION: N/A	2. A TECHNICIAN WILL VISIT THE SITE APPROXIMATELY ONCE A MONTH FOR ROUTINE	T-1	TITLE SHEET, VICINITY MAP AND GENERAL INFORMATION	0	1-02-14	NS	
13010 MORRIS ROAD, 6TH FLOOR, BLDG 1	CODE BLOCK:	INSPECTION AND MAINTENANCE.	A-1	SITE PLAN	0	1-02-14	NS	
ALPHARETTA, GA 30004 CELL 770-990-0137	BUILDING CODE: 2009 INTERNATIONAL BUILDING	3. THE PROJECT WILL NOT RESULT IN ANY	A-2	CONCRETE PAD DETAILS	0	1-02-14	NS	
ppoor@sabreindustries.com	CODE	SIGNIFICANT LAND DISTURBANCE OR EFFECT OF STORM WATER DRAINAGE.	E-1	WIRING DIAGRAM & H-FRAME LAYOUT	0	1-02-14	NS	
			E-2	ELECTRICAL DETAILS	0	1-02-14	NS	
LANDLORD:	AT&T OPS FOR POWER CUT OVER:	4. NO SANITARY SEWER, POTABLE WATER OR TRASH DISPOSAL IS REQUIRED.	G-1	COMPOUND GROUNDING	0	1-02-14	NS	1 -
SBA 2012 TC ASSETS, LLC (TOWERCO) 5900 BROKEN SOUND PKWY NW 2ND FLOOR, BOCA RATON. FL 33487-2797	NEED 24 HOUR NOTICE TO OPEN A TAP TICKET	5. HANDICAP ACCESS IS NOT REQUIRED.		GENERATOR ASSEMBLY AND INSTALLATION SUPPLEMENT				
GREGORY CSAPO	DIAL: 1-800-638-2822 SELECT OPTION 1, THEN OPTION 2							h
919-653-5721		PROJECT LOCATION DIRECTIONS						W
GROUND OWNER: SBA 2012 TC ASSETS, LLC (TOWERCO)		START OUT GOING NORTHEAST ON ENTERPRISE						
5900 BROKEN SOUND PKWY NW 2ND FLOOR,		DR TOWARD CAPITOL BLVD. TURN LEFT ONTO CAPITOL BLVD. TURN LEFT ONTO WEST ST.						
BOCA RATON, FL 33487-2797 GREGORY CSAPO		MERGE ONTO I-91 S VIA THE RAMP ON THE LEFT TOWARD NEW HAVEN. MERGE ONTO I-691					-	
919-653-5721		W VIA EXIT 18 TOWARD MERIDEN/WATERBURY.						
UTTI TTTEC.		- MERGE ONTO I-84 W VIA EXIT 1 ON THE LEFT TOWARD WATERBURY/DANBURY. MERGE						
UTILITIES: POWER COMPANY:		ONTO CT-8 N VIA EXIT 20 TOWARD TORRINGTON. TAKE THE KENNEDY DR EXIT.						
NAME: NORTHEAST UTILITIES		EXIT 45. TURN LEFT ONTO KENNEDY DR. TURN						
		RIGHT ONTO WINSTED RD. TURN LEFT ONTO BURR MOUNTAIN RD. END AT 5 BURR MOUNTAIN						
		RD TORRINGTON, CT 06790						

NOTE:

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Hand Digging Only, no machines



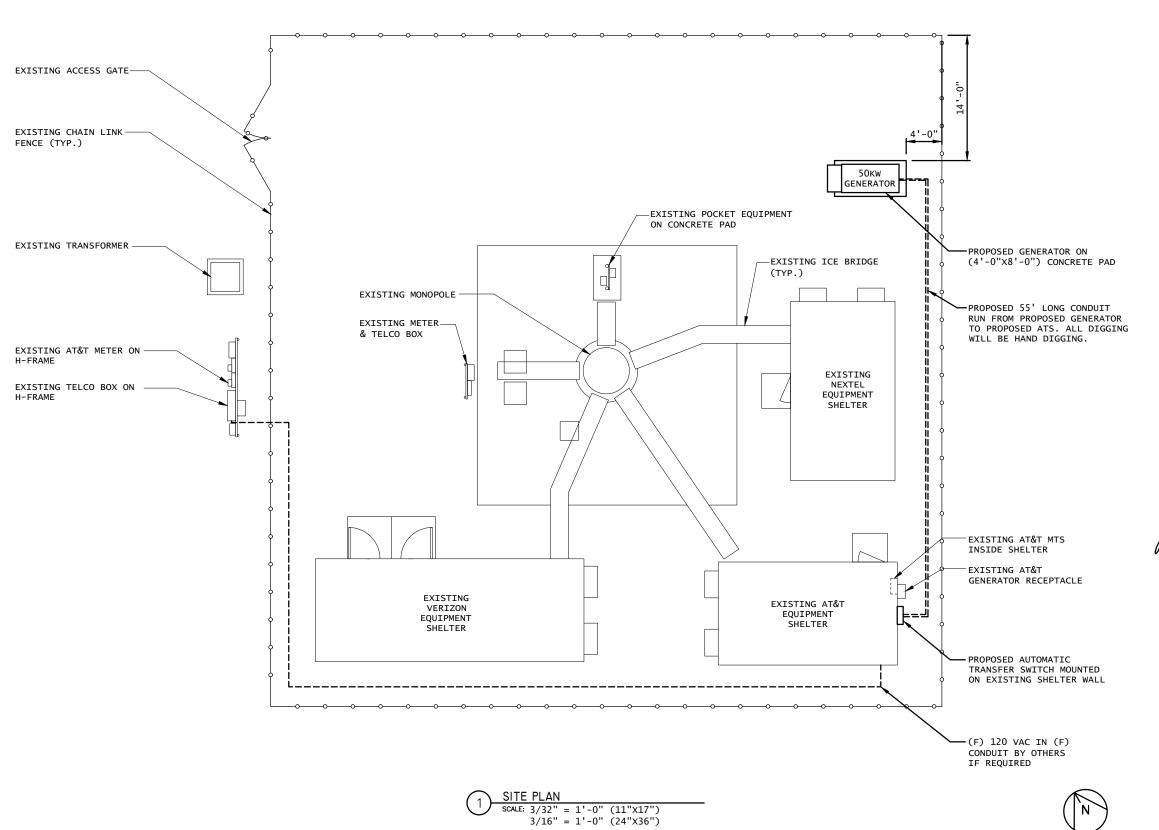

NESE DAMINGS AND/OR THE ACCOMPANYING SPECIFICATION AS INSTRUMENTS IS ESPUTCE ARE THE EXCLUSIVE PROPERTY OF A TAT. THERE USE AND THE UBLICATION SHALL BE RESTRICTED TO THE ORIGINAL SITE FOR WHICH THEY UBLICATION SHALL BE RESTRICTED TO THE ORIGINAL SITE FOR WHICH THEY O ATAT OR THE SPECIFIED CARRIER IS STRICTLY PROHIBITED. TITLE TO HEEP DOCUMENTS SHALL REMAIN THE PROPERTY OF ATAT WHETHER OR NOT HEEP DOCUMENTS SHALL REMAIN THE PROPERTY OF ATAT WHETHER OR NOT HEEP DOCUMENTS SHALL REMAIN THE PROPERTY OF ATAT WHETHER OR NOT HEEP DOCUMENTS SHALL REMAIN THE PROPERTY OF A TAT WHETHER AT HE PRODUCTION ON-STITE CONSTRUCTION REVIEW OF THIS PROJECT. OWTRACTOR(S) MUST VERTEY ALL DIMENSIONS AND ADVISE ATAT OF ANY SCHEPANCES. ANY PROINT SISSUANCE OF THIS DOMAIN IS SUPERSEEDED BY

Sabre Industries



1600 OSGOOD STREET BUILDING 20 NORTH, SUITE 3090 N. ANDOVER, MA 01845 TEL: (978) 557-5553 FAX: (978) 336-5586

SITE NUMBER: 10035404

SITE NAME:

TORRINGTON BURR MT ROAD

SITE ADDRESS: BURR MOUNTAIN ROAD TORRINGTON, CT 06790




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SITE PLAN


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SECTION A-A



CONCRETE SLAB (GENERATOR FOUNDATION)

PLAN VIEW

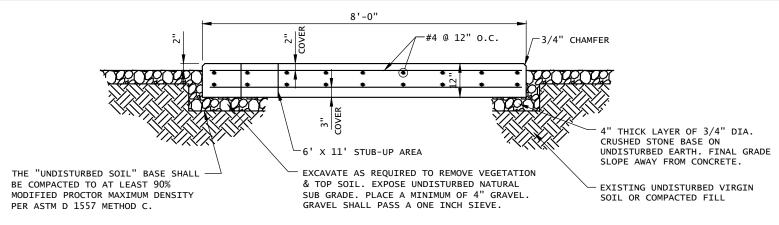CONCRETE AND REINFORCING STEEL NOTES:

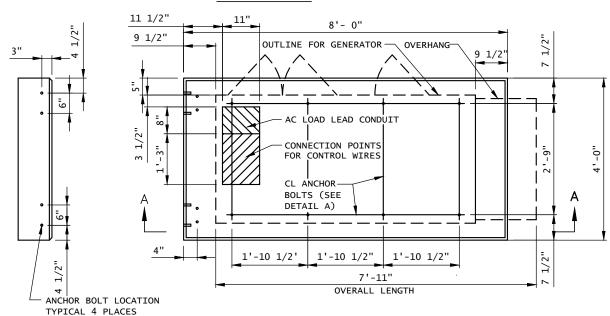
- 1. ALL CONCRETE CONSTRUCTION SHALL MEET THE REQUIREMENTS OF THE AMERICAN CONCRETE INSTITUTE (ACI 318-95) BUILDING CODE REQUIREMENTS FOR REINFORCED CONCRETE AND (ACI 301) STANDARD SPECIFICATION FOR STRUCTURAL CONCRETE. ALL CONCRETE WORK SHALL BE IN ACCORDANCE WITH THE ACIW301, ACIW318, ASTM A184 AND ASTM A185.
- 2. MINIMUM ALLOWABLE CONCRETE COMPRESSIVE STRENGTH SHALL BE 4000 PSI AT 28 DAYS WHEN TESTED IN ACCORDANCE WITH THE AMERICAN SOCIETY FOR TESTING AND MATERIALS METHODS STANDARDS ASTM C172, ASTM C31 AND ASTM C39 UNLESS NOTED OTHERWISE.
- 3. REINFORCING STEEL SHALL CONFORM TO ASTM A615, GRADE 60, DEFORMED UNLESS NOTED OTHERWISE. WELDING WIRE FABRIC SHALL CONFORM TO ASTM A185 WELDED STEEL FABRIC UNLESS NOTE OTHERWISE.SPLICES SHALL BE CLASS "B" AND ALL HOOKS SHALL BE STANDARD, UNLESS NOTED OTHERWISE.
- DETAILING SHALL BE ACCORDANCE WITH THE MANUAL OF STANDARD PRACTICE OF DETAILING REINFORCED CONCRETE STRUCTURES (ACI STD-315-92).
- CHAMFER ALL EXPOSED EDGES OF CONCRETE 3/4" IN ACCORDANCE WITH ACI 301 SECTION 4.2.2 UNLESS OTHERWISE NOTED.
- REINFORCING STEEL SHALL BE IN ACCURATELY PLACED AND ADEQUATELY SECURED IN POSITION. LOCATION OF REINFORCEMENT SHALL BE INDICATED ON THE DRAWINGS. CONCRETE COVER SHALL BE 3" MINIMUM.
- 7. TOP OF FOUNDATION TO HAVE A "BRUSH FINISH".
- 8. EXPOSED FINISHED SURFACE IS NOT TO HOLD WATER
- ALL SURFACES ARE TO BE CLEANED OF ANY RESIDUAL CONCRETE FROM SPLASHING OR SPILLS.


SOIL COMPACTION NOTES FOR SLAB ON GRADE:

- EXCAVATE AS REQUIRED TO REMOVE VEGETATION & TOPSOIL, EXPOSE UNDISTURBED NATURAL SUB GRADE AND PLACE CRUSHED STONE AS REQUIRED.
- COMPACTION CERTIFICATION: AN INSPECTION AND WRITTEN CERTIFICATION BY A QUALIFIED GEO TECHNICAL OR ENGINEER IS ACCEPTABLE.
- 3. AS AN ALTERNATIVE TO INSPECTION AND WRITTEN CERTIFICATION, THE "UNDISTURBED SOIL" BASE SHALL BE COMPACTED WITH "COMPACTION EQUIPMENT", LISTED BELOW, TO AT LEAST 90% MODIFIED PROCTOR MAXIMUM DENSITY PER ASTM D 1557 METHOD C.
- 4. COMPACTED SUB BASE SHALL BE UNIFORM & LEVELED. PROVIDE 6" MINIMUM CRUSHED STONE OR GRAVEL COMPACTED IN 3" LIFTS ABOVE COMPACTED SOIL. GRAVEL SHALL BE NATURAL OR CRUSHED WITH 100% PASSING 1" SIEVE.
- 5. AS AN ALTERNATIVE TO ITEMS 2 AND 3 PROOF ROLL THE SUB GRADE SOILS WITH 5 PASSES OF A MEDIUM SIZED VIBRATORY PLATE COMPACTOR (SUCH AS BOMAG BPR 30/38) OR HAND-OPERATED SINGLE DRUM VIBRATORY ROLLER (SUCH AS BOMAG BW 55E). ANY SOFT AREAS THAT ARE ENCOUNTERED SHOULD BE REMOVED AND REPLACED WITH A WELL-GRADED GRANULAR FILL AND COMPACTED AS STATED ABOVE.

COMPACTION EQUIPMENT:

 HAND OPERATED DOUBLE DRUM, VIBRATORY ROLLER, VIBRATORY PLATE COMPACTOR OR JUMPING JACK COMPACTOR.

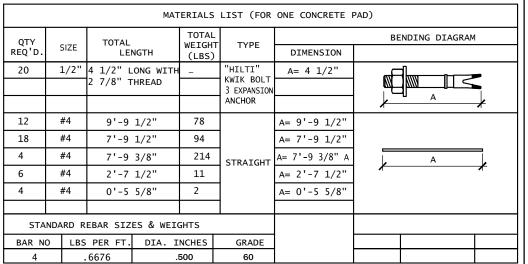

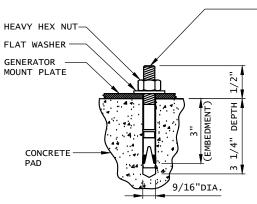

"HILTI" KWIK BOLT 3 EXPANSION ANCHOR

NOTE

- 1. BOLTS CAN BE INSTALLED 2 DAYS AFTER POURING CONCRETE PROVIDED THE KWIK BOLTS ARE ONLY TIGHTENED TO A SNUG TIGHT CONDITION.
- APPLY "HILTI" HIT-RE 500-SD EPOXY TO ALL GAPS TO PREVENT WATER/MOISTURE BUILD-UP.

DETAIL A

FOR REFERENCE.
TO BE USED FOR
INSTALLATION OF KWIK
BOLT EXPANSION ANCHORS
FOR 50KW GENERATORS.

NOTE:

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PRESENT, CONTRACTOR IS TO ROUTE NEW SERVICE
FROM AT&T EQUIPMENT AREA

DESTGIN

1. MAXIMUM DESIGN BASIC WIND SPEED(3-SECOND GUST): 135 MPH FOR GENERATOR MODELS SD050 AND SD080. 115 MPH FOR GENERATOR MODELS SD130 AND SD150.



HESE DUMINUS AMO/OR THE ACCOMPANYING SPECIFICATION AS INSTRUMENTS IN SERVICE ARE THE EXCLUSIVE ORPOPRITY OF ATAT, THERE USE AND UBLICATION SHALL BE RESTRICTED TO THE ORIGINAL SITE FOR WHICH THEY PREPARED. ANY USE OR DISCLOSURE OTHER THAN THAT WHICH RELATES O ATÂT OR THE SPECIFIC CARRIER IS STRICTLY PROHIBITED. TITLE TO HESE DOCUMENTS SHALL REMAIN THE PROPERTY OF ATÂT WHETHER OR NOT HEE PROJECT IS EXECUTED. NEITHER THE ARCHITECT MOR THE ENGINEER LIB EMPOYING MOSTST CONSTRUCTION ACCURE OF THIS PROFILE OF MISSING MOSTST CONSTRUCTION ACCURE OF THIS SPORT OF MISSING MOSTST CONSTRUCTION ACCURE OF THIS SPORT OF MISSING MOSTS OF THIS DOWN OF MISSING MOSTS OF THIS DOWN OF MISSING MOSTS OF THIS DOWN OF THE WILLIAM SCHOOL AND THE MISSING MOSTS OF THIS DOWN OF THE WILLIAM STREAM OF THIS DOWN OF MISSING MOSTS OF THIS DOWN OF THE MISSING MOSTS OF THE MISSING MOST OF THE WILLIAM THE MISSING MOST OF THE MISSING M






1600 OSGOOD STREET
BUILDING 20 NORTH, SUITE 3090
N. ANDOVER, MA 01845
TEL: (978) 557-5553
FAX: (978) 336-5586

10035404

STTE NAME:

TORRINGTON BURR MT ROAD

SITE ADDRESS:
BURR MOUNTAIN ROAD

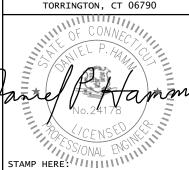

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CHECKED BY: SB
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JOB NO: 1205.01
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CONCRETE PAD DETAIL


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8' X 4' POURED IN PLACE GENERATOR PAD



FEEDER SIZING CHART FOR GENERATOR					
GEN SET SIZE	VOLTS-PHASE	PRIME RATING KW-AMPS	SIZE OF INLINE BREAKER (AT GERERATOR)	MAIN BREAKER SIZE SERVING ANCHOR TENANT:	FEEDER SIZES FROM GEN SET BREAKER TO ATS.
50 KW	120/240V - 1-PH	48KW - 200A	200A	200A 2-P C/B INTEGRAL TO GEN SET.	3#3/0, 1#6G, IN 3"C

NOTES:

- 1. SERVICE VOLTAGE IS 120/240 1-PHASE, AND SERVICE SIZES ARE TYPICAL 220A.
- 2. AUTOMATIC TRANSFER SWITCH (ATS) ARE 200A, 2-POLES, 120/240V 1-PHASE WITH SOLID NEUTRAL.
- 3. ALL EXTERIOR ELECTRICAL EQUIPMENT IS NEMA 3R RATED.
- 4. THE GENERATOR ELECTRICAL LOADS ARE ADEQUATE FOR THE CONNECTED LOADS.
- . ALL EQUIPMENT FURNISHED SHALL BE PROVIDED WITH EQUIPMENT RATED TO WITHSTAND FAULT CURRENT AVAILABLE AT PROJECT SITE.
- 6. ALL WIRE AND PANEL BUSSING SHALL BE COPPER UNLESS ALLOWED ELSEWHERE IN THIS DOCUMENT SET, WIRE SIZES ARE BASED ON COPPER.
- 7. ALL WORK SHALL CONFORM WITH THE CURRENT VERSION OF THE NEC AND ALL OTHER APPLICABLE CODES.
- 3. FIRST OVER-CURRENT PROTECTION DEVICE IS INTEGRAL TO GENERATOR . FEEDER SIZES INDICATED IN TABLE ABOVE ARE DOWNSTREAM OF THE FIRST OVER-CURRENT PROTECTION DEVICE.
- 9. INLINE BREAKER AT GENERATOR IS FACTORY INSTALLED, AND IS THE MANUFACTURERS RECOMMENDED SIZE.

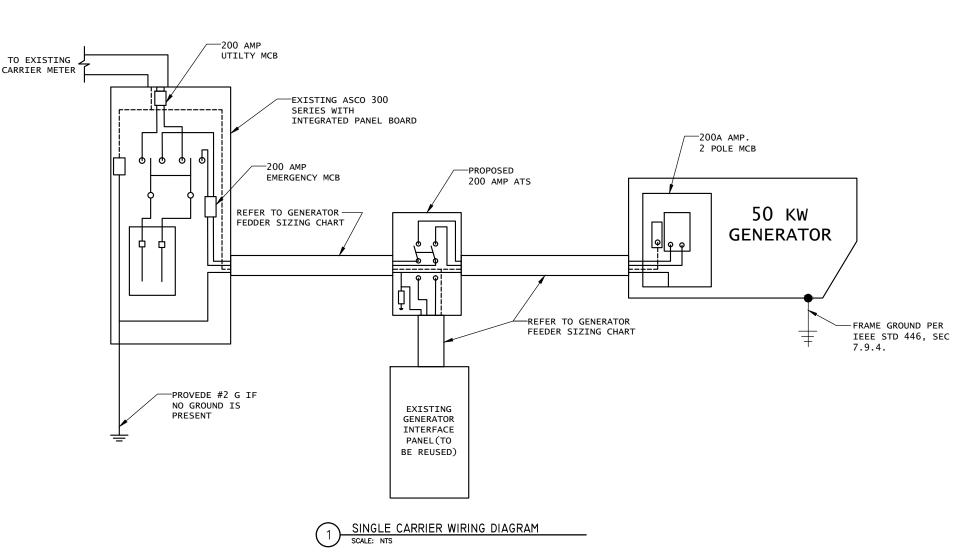NOTES:

- ALL UNDERGROUND CABLE TO BE BURIED AT 36" MIN. SHIELD TAPED AT 12" AND STUBBED OUT OF GROUND IN SCH 40 PVC CONDUIT.
- LOW VOLTAGE CONTROL WIRE PROVIDED BY MONITORING PROVIDER IN SEPARATE 1/2" CONDUIT FROM ATS TO GENERATOR.
- 3. BTS SITES: THE TENANT CONTRACTOR TO COMPLETE CUSTOMER ELECTRICAL CONDUIT TO CUSTOMER METER PER STANDARD COLLOCATION INSTALL.
- 4. TENANT CONTRACTOR HAS NOTHING TO INSTALL OR COMPLETE FOR GEN DURING CUSTOMER COLLOCATION ON TOWER.
- GEN INSTALL IS COMPLETED AFTER CUSTOMER TOWER COLLOCATION IS COMPLETE WITH LOAD ON CUSTOMER METER.
- ALL CONDUCTORS ARE SIZED FOR COPPER, BUT ALUMINUM CONDUCTORS ARE ALLOWED FOR FEEDERS PROVIDED THEY ARE UPSIZED PER NEC TABLE 310.16.
- 7. ALL ELECTRICAL WORK SHALL BE PER THE NATIONAL ELECTRICAL CODE (NFPA 70) AND ALL APPLICABLE LOCAL CODES.
- 8. MAINTAIN 36" CLEAR WORKSPACE IN FRONT OF METER, TRANSFER SWITCH, GENERATOR, PANELS ETC.
- 9. 800A PANEL HAS A COMMON NEUTRAL BUS. NEUTRALS BACK TO THE METER ARE SIZED ACCORDING TO THE DISTRIBUTION PANEL BRANCH BREAKER RATING. NEUTRAL IS BONDED AT THE PRIMARY SERVICE MAIN BONDING JUMPER ONLY.
- 10.GENERATOR CONTROLS AND SENSORS SHALL HAVE GFCI SENSING CAPABILITY PER NEC 700-6(D).

NOTE:

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BUILDING 20 NORTH, SUITE 3090 N. ANDOVER, MA 01845 TEL: (978) 557-5553 FAX: (978) 336-5586

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SITE ADDRESS: BURR MOUNTAIN ROAD TORRINGTON, CT 06790



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WIRING DIAGRAM & H-FRAME LAYOUT

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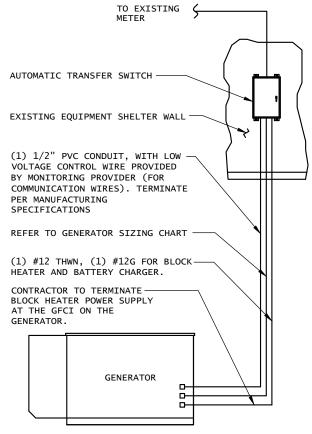
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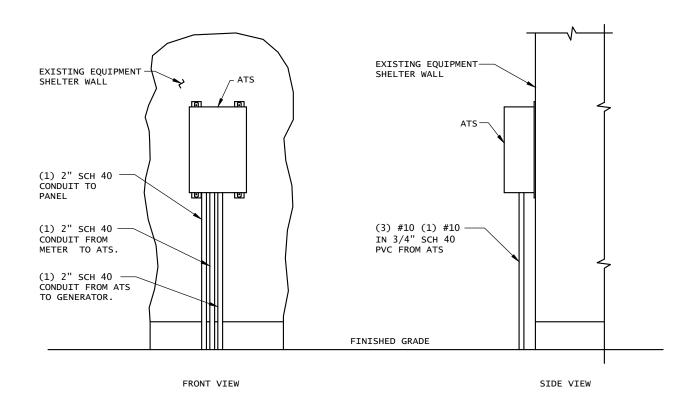
GENERATOR SET SIZING CHART

NOTE: UTILITY POWER FEEDS SHALL BE CONNECTED TO THE TRANSFER SWITCH FROM THE LOAD SIDE OF THE EXISTING SERVICE DISCONNECT. NO MODIFICATIONS SHALL BE MADE ON THE LINE SIDE OF THE EXISTING SERVICE DISCONNECT.



DISCONNECT POWER FEED FROM EXISTING METER TO EXISTING SHELTER. ROUTE NEW FEEDERS (SIZED BELOW) FROM METER TO NEW TRANSFER SWITCH AND BACK. RECONNECT NEW RETURN FEED FROM TRANSFER SWITCH TO SUPPLY POWER (UTILITY AND BACK-UP POWER) TO EXISTING SHELTER.





2 AUTOMATIC TRANSFER SWITCH LAYOUT SCALE: NOT TO SCALE

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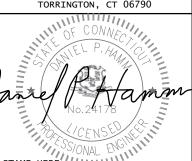
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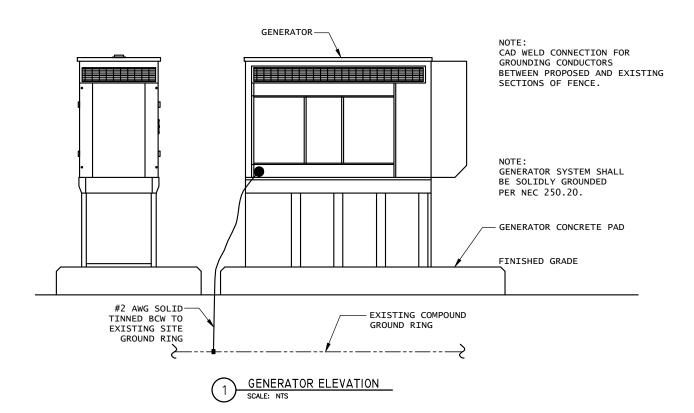
ELECTRICAL DETAILS

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SHEET TITLE:


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NOTES:

- 1. CONTRACTOR TO HAND DIG ALL NEW TRENCHES INSIDE COMPOUND.
- 2. SEPARATION DIMENSION TO BE VERIFIED WITH LOCAL UTILITY COMPANY REQUIREMENTS.



TRENCH DETAIL

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- 1. ELECTRICIAN SHALL VERIFY THAT GENERATOR IS INSTALLED SO THAT ELECTRICAL BACK-FEEDS ARE NOT POSSIBLE.
- 2. ELECTRICIAN SHALL VERIFY THAT GROUNDING IS INSTALLED SO THAT NO CIRCULATING CURRENTS ARE POSSIBLE BY FOLLOWING DETAIL 3 SO GROUNDING IS CONNECTED TO EXISTING TOWER GROUND FIELD.
- 3. ALL LIGHTNING GROUNDING SHALL BE FREE OF KINKS AND SHALL HAVE LONG RADIUS BENDS (MINIMUM 8").
- 4. ALL GROUNDING SHOULD BE INSTALLED PER CURRENT NEC, SECTION 250.
- 5. USE #2 AWG SOLID TINNED COPPER WIRE TO
 - (2) FENCE POSTS AND CADWELD FROM GENERATOR GROUND RING

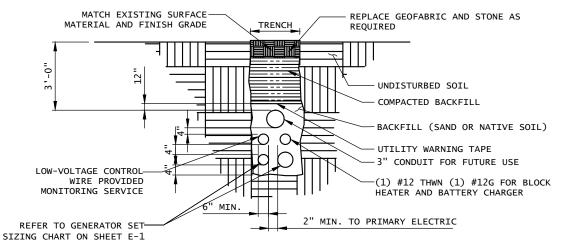





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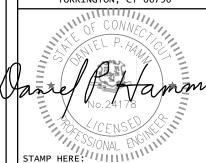
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SITE NAME:

TORRINGTON BURR MT ROAD

SITE ADDRESS: BURR MOUNTAIN ROAD TORRINGTON, CT 06790



	 SIAM HERE.	.111111
	DRAWN BY:	RS
	CHECKED BY:	SB
	DATE DRAWN:	1-02-14
	JOB NO:	1205.01
	SHEET TITLE:	

COMPOUND GROUNDING

SHEET NUMBER:

G-1

REV. # 0