

Matt Burke

16 Chestnut Street, Suite 220 Foxboro, MA 02035 Tel (508) 930-0974 Fax (774) 215-5423

Melanie Bachman Acting Executive Director Connecticut Siting Council 10 Franklin Square New Britain, CT 06051

Re: Notice of Exempt Modification - Emergency Backup Generator 393 Jackson Hill Road, Middlefield, CT 06455 (FA# 10071119)

Dear Ms. Bachman:

American Telephone and Telegraph Company ("AT&T") currently maintains a wireless telecommunications facility at the above referenced address. AT&T's facility consists of antennas at the 98' level of an existing 146' tower and equipment cabinets in a 7' x 16' lease area. The tower and AT&T's cabinets are located within an existing, fenced-in compound area. AT&T does not currently maintain a generator at this cell site.

In an effort to further enhance multiple tenants' network reliability, AT&T intends to modify its facility by installing a new diesel-fueled generator outside in a designated 4' x 8' ground space. The generator incorporates a built-in fuel tank as part of the unit. The diesel fuel tanks are double walled for added safety and will be filled by a licensed fuel filling company. The proposed modification will remain within the existing, fenced-in compound. The new generator and tank with be surrounded by a security fence and gate. (See Facility Compound Plan attached).

Please accept this letter as notification pursuant to R.C.S.A Section 16-50j-73, for construction that constitutes modification pursuant to R.C.S.A Section 16-50j-72(b)(2). In accordance with R.C.S.A Section 16-50j-73, a copy of this submission is being sent to the Town of Middlefield, who also owns the land in question.

AT&T's Proposed Wireless Modifications Constitute An "Exempt Modification"

The proposed modification to the above mentioned Facility constitutes an exempt modification of an existing facility provided for in R.C.S.A Section 16-50j-72(b)(2) and Council regulations promulgated pursuant thereto.

1) The proposed modification will not result in an increase in the height of the existing tower.

- 2) The generator and attached fuel tank will remain entirely within the limits of the leased area. The modifications therefore, will not require the extension of the boundary.
- 3) The proposed modification does not increase the noise levels at the boundary by six (6) decibels or more under normal conditions. Proposed modification is only used during emergency power failure.
- 4) The installation of a new generator and attached fuel tank will not change, in any way, radio frequency (RF) emissions at the facility.
- 5) The facility has received all municipal zoning approvals and building permits. (Regs., Conn. State Agencies Section 16-50j-72))

For all the foregoing reasons, American Telephone and Telegraph Company respectfully submits that the proposed modifications to the above-referenced telecommunications facility constitutes an exempt modification under R.C.S.A Section 16-50j-72(b)(2)

Respectfully submitted,


Matt Burke (508)930-0974

On behalf of AT&T c/o Tower Resource Management, Inc. 16 Chestnut Street, Suite 220 Foxboro, MA 02035

cc: Town of Middlefield, CT

Exhibit 1

Site Plan

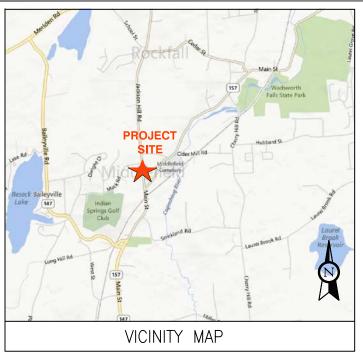



BACKUP POWER PROJECT

SITE IDENTIFICATION:

SITE NUMBER: 10071119

SITE NAME: MIDDLEFIELD

CENTRAL

SITE ADRESS: 393 JACKSON HILL ROAD

MIDDLEFIELD, CT 06455



THIS FACILITY SHALL MEET OR EXCEED ALL FAA AND FCC REGULATORY REQUIREMENTS.

PROJECT DESCRIPTION:

THE PROPOSED PROJECT INCLUDES PLACING A 50 KW GENERATOR IN AN EXISTING CELLULAR TOWER COMPOUND.



CONTRACTOR TO VERIFY EXISTING MUX LOCATION. IF MUX LOCATION IS OUTSIDE OF AT&T EQUIPMENT AREA, CONTRACTOR IS TO FIELD VERIFY THE PRESENCE OF EMERGENCY BACK-UP SERVICE TO THE MUX. IF EMERGENCY BACK-UP SERVICE IS NOT PRESENT, CONTRACTOR IS TO ROUTE NEW SERVICE FROM AT&T EQUIPMENT AREA.

PROJECT TEAM PROJECT SUMMARY PROJECT NOTES SHEET INDEX SHT **ENGINEER GEOGRAPHIC COORDINATES: DESCRIPTION:** REV: DATE: BY: THE FACILITY IS UNMANNED. NO: ADVANCED ENGINEERING GROUP, P.C. LATITUDE: 41° 31' 03" N 500 NORTH BROADWAY A TECHNICIAN WILL VISIT THE SITE APPROXIMATELY ONCE EAST PROVIDENCE, RI 02914 TEL: 401-354-2403 LONGITUDE: 72° 42' 51" W T-1 TITLE SHEET, VICINITY MAP AND GENERAL INFORMATION 11-13-2013 JG 0 A MONTH FOR ROUTINE INSPECTION AND MAINTFNANCE. CODE BLOCK: THE PROJECT WILL NOT RESULT IN ANY SIGNIFICANT COMPOUND PLAN 11-13-2013 A-1 0 JG CUSTOMER REPRESENTATIVE: LAND DISTURBANCE OR EFFECT OF STORM WATER SABRE INDUSTRIES CONCRETE PAD DETAILS A-2 11-13-2013 JG 2009 INTERNATIONAL BUILDING CODE 0 PEGGY POOR MARKET LEAD - AT&T NE GENERATOR PROGRAM 13010 MORRIS ROAD, 6TH FLOOR, BLDG 1 NO SANITARY SEWER, POTABLE WATER OR TRASH E-1 WIRING DIAGRAM & SIZING CHARTS 11-13-2013 JG 0 DISPOSAL AS REQUIRED ALPHARETTA, GA 30004 ELECTRICAL & ATS MOUNTING DETAILS E-2 11-13-2013 JG CELL 770-990-0137 HANDICAP ACCESS IS NOT REQUIRED. GROUNDING DETAILS G-1 11-13-2013 JG 0 LANDLORD: PROJECT LOCATION DIRECTIONS SBA 2012 TC ASSETS, LLC 5900 BROKEN SOUND PARKWAY, 2ND FLOOR BOCA RATON, FL 33487 DEPART RT-30 W / COCHITUATE RD TOWARD BURR ST TURN BACK ON RT-30 E / COCHITUATE RD **UTILITIES:** TAKE RAMP RIGHT FOR I-90 WEST TOWARD WORCESTER / POWER COMPANY: SPRINGFIELD AT EXIT 9, TAKE RAMP RIGHT FOR I-84 TOWARD NEW NORTHEAST UTILITIES (NU) YORK CITY / HARTFORD P.O. BOX 270 STOP FOR TOLL BOOTH HARTFORD, CT 06141-0270 AT EXIT 57, TAKE RAMP LEFT FOR CT-15 SOUTH TOWARD PHONE: 1-800-286-5000 CHARTER OAK BR / N.Y. CITY KEEP STRAIGHT ONTO US-5 S / CT-15 S AT EXIT 86, TAKE RAMP RIGHT FOR I-91 SOUTH TOWARD NEW HAVEN / N.Y. CITY AT EXIT 20, TAKE RAMP RIGHT FOR MIDDLE STREET TOWARD COUNTRY CLUB RD BEAR LEFT ONTO MIDDLE ST TURN LEFT ONTO COUNTRY CLUB RD TURN RIGHT ONTO HIGBY RD ROAD NAME CHANGES TO JACKSON HILL RD ARRIVE AT 393 JACKSON HILL RD, MIDDLEFIELD, CT 06455



Civil Engineering - Site Development Surveying - Telecommunications 500 NORTH BROADWAY EAST PROVIDENCE, RI 02914 PH: 401-354-2403 FAX: 401-633-6354



TOWER RESOURCE MANAGEMENT 16 CHESTNUT STREET, SUITE 220 FOXBORO, MA 02035 WWW.TRMCOM.COM



550 COCHITUATE ROAD, SUITE 13 & 14 FRAMINGHAM, MA 01701-4681



SITE NUMBER:

10071119

SITE NAME:

MIDDLEFIELD CENTRAL

SITE ADDRESS: 393 JACKSON HILL ROAD MIDDLEFIELD. CT 06455

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DATE DRAWN: 11-13-13

JOB NO: 10071119

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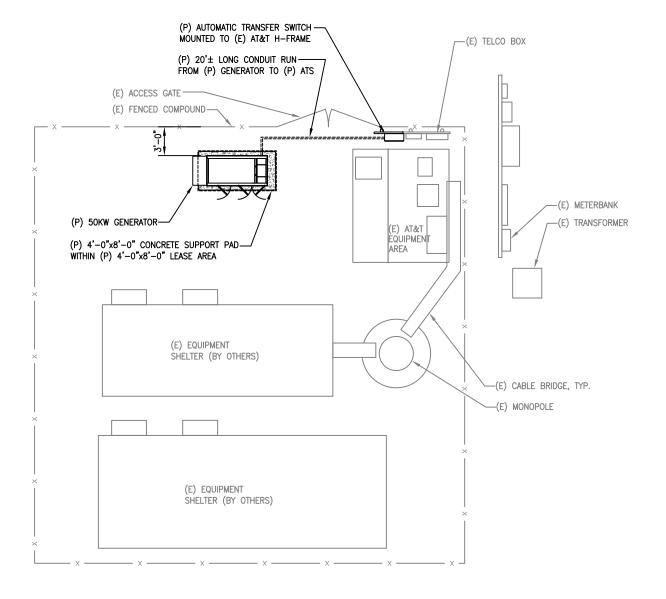
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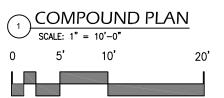
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NOTE:

A SITE VISIT/SURVEY WAS NOT CONDUCTED BY ADVANCED ENGINEERING GROUP, P.C. SITE INFORMATION AND PLANS ARE BASED UPON INFORMATION PROVIDED BY CLIENT







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13010 MORRIS ROAD, 6TH FLOOR, BLDG 1

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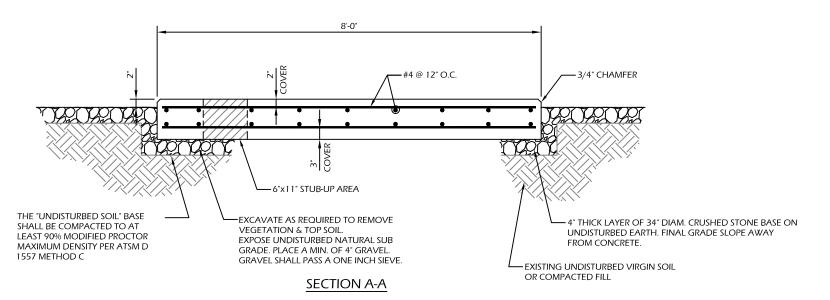
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COMPOUND PLAN

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9 1/2"

-OVERHANG

ANCHOR BOLT

(TYP) (4) PER SIDE

OUTLINE OF GENERATOR

8'-0"

AC LOAD LEAD CONDUIT


CONNECTION POINTS FOR CONTROL WIRES

PLAN VIEW

11 1/2"

9 1/2"

11"

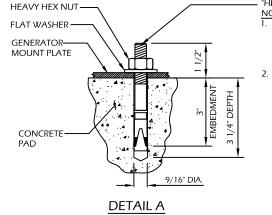

"HILTI" KWIK BOLT 3 EXPANSION ANCHOR

- BOLTS CAN BE INSTALLED 2 DAYS AFTER POURING CONCRETE PROVIDED THE KWIK **BOLTS ARE ONLY TIGHTENED TO A SNUG** TIGHT CONDITION.
- APPLY "HILTI" HIT-RE 500-SD EPOXY TO ALL GAPS TO PREVENT WATER/MOISTURE



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Surveying - Telecommunications

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CONCRETE PAD CONSTRUCTION NOTES

- 1. ALL REBAR (HORIZONTAL & VERTICAL) SHALL BE SECURELY WIRE TIED TO PREVENT DISPLACEMENT DURING POURING
- 2. CONCRETE TO HAVE A MINIMUM COMPRESSIVE STRENGTH OF 4000 PSI.
- REINFORCED CONCRETE CONSTRUCTION AND MATERIALS SHALL BE IN ACCORDANCE WITH ACI STANDARDS 318.
- MINIMUM CONCRETE COVER OVER REBAR IS 2 1/2".
- 5. REINFORCING MATERIAL SHALL BE IN ACCORDANCE WITH ASTM SPECIFICATION A615-85.

CONCRETE PAD AND EMBEDMENT TOLERANCES

- 1. CONCRETE DIMENSIONS: PLUS OR MINUS 1/4".
- 2. REINFORCING STEEL PLACEMENT: PLUS OR MINUS 1/4" INCLUDING CONCRETE COVER.

NOTES

- 1. FOUNDATION WAS DESIGNED BY ASSUMING ALLOWABLE SOIL BEARING CAPACITY OF 1000 PSI. THE SOIL BEARING CAPACITY FOR EACH SITE MUST BE VERIFIED USING THE SITE SPECIFIC GEOTECH REPORT. IF SHALLOW GROUNDWATER (≤3 FT.) WAS REPORTED, A FURTHER REVIEW OF THE DESIGN OR SPECIAL DESIGN MAY BE REQUIRED.
- 2. THE SOIL UNDERNEATH THE CONCRETE PAD MUST BE FREE OF ORGANIC MATTER OR OTHER DELETERIOUS SUBSTANCES, AND SHOULD BE COMPACTED AND LEVELED BEFORE PLACING THE FOUNDATION.
- 3. CONCRETE SLUMPS: 1"~3".
- 4. CONCRETE VOLUME: 2.4 CUBIC YARDS.

DESIGN

1. MAXIMUM DESIGN BASIC WIND SPEED (3-SECOND GUST): 155 MPH FOR GENERATOR MODELS SD050 AND SD080.


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CONCRETE PAD DETAILS

SHEET NUMBER: REV. #

PRE-CAST GENERATOR PAD



- ALL UNDERGROUND CABLE TO BE BURIED AT 36" MIN. SHIELD TAPED AT 12" AND STUBBED OUT OF GROUND IN SCH 40 PVC
- 2. LOW VOLTAGE CONTROL WIRE PROVIDED BY MONITORING PROVIDER IN SEPARATE 1/2" CONDUIT FROM ATS TO GENERATOR.
- 3. BTS SITES: THE TENANT CONTRACTOR TO COMPLETE CUSTOMER ELECTRICAL CONDUIT TO CUSTOMER METER PER STANDARD COLLOCATION INSTALL.
- TENANT CONTRACTOR HAS NOTHING TO INSTALL OR COMPLETE FOR ATC SHARED GEN DURING CUSTOMER COLLOCATION ON ATC
- 5. ATC SHARED GEN INSTALL IS COMPLETED AFTER CUSTOMER TOWER COLLOCATION IS COMPLETE WITH LOAD ON CUSTOMER METER.
- ALL CONDUCTORS ARE SIZED FOR COPPER, BUT ALUMINUM CONDUCTORS ARE ALLOWED FOR FEEDERS PROVIDED THEY ARE UPSIZED PER NEC TABLE 310.16.
- 7. ALL ELECTRICAL WORK SHALL BE PER THE NATIONAL ELECTRICAL CODE (NFPA 70) AND ALL APPLICABLE LOCAL CODES.
- MAINTAIN 36" CLEAR WORKSPACE IN FRONT OF METER, TRANSFER SWITCH, GENERATOR, PANELS, ETC.
- 800A PANEL HAS A COMMON NEUTRAL BUS. NEUTRALS BACK TO EACH CARRIER METER ARE SIZED ACCORDING TO THE DISTRIBUTION PANEL BRANCH BREAKER RATING. NEUTRAL IS BONDED AT THE PRIMARY SERVICE MAIN BONDING JUMPER ONLY.
- 10. GENERATOR CONTROLS AND SENSORS SHALL HAVE GFCI SENSING CAPABILITY PER NEC 700-6(D).
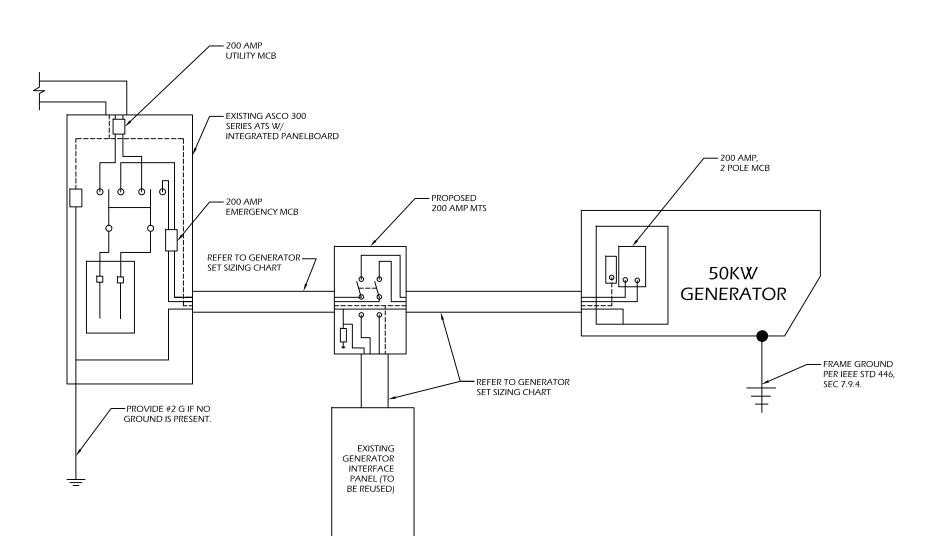
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SINGLE CARRIER WIRING DIAGRAM

FEEDER SIZING CHART FOR GENERATOR					
GEN SET SIZE	VOLTS - PHASE	PRIME RATING KW - AMPS	SIZE OF INLINE BREAKER (AT GENERATOR)	MAIN BREAKER SIZE SERVING ANCHOR TENANT:	FEEDER SIZES FROM GEN SET BREAKER TO DISTRIBUTION PANEL / ATS.
50KW	120/240V - 1-PH	48KW - 200A	200A	200A 2-P C/B INTEGRAL TO GEN SET	3#3/0, 1#6G, IN 2*C

NOTES:

- 1. SERVICE VOLTAGE FOR EACH CARRIER IS 120/240 1-PHASE. AND SERVICE SIZES ARE TYPICAL 200A PER CARRIER.
- 2. DISTRIBUTION PANEL IS 800A, 120/240V 1-PHASE, WITH 200A C/B FOR THE LISTED CARRIER OUTPUT. PANEL HAS (3) 200A BREAKER SPACES
- 3. AUTOMATIC TRANSFER SWITCH (ATS) ARE 200A 2-POLES, 120/240V 1-PHASE WITH SOLID NEUTRAL PER CARRIER.
- 4. ALL ELECTRICAL EQUIPMENT IS NEMÁ 3R RATED.
- 5. THE GENERATOR ELECTRICAL LOADS ARE ADEQUATE FOR THE CONNECTED LOADS.
- 6. ALL EQUIPMENT FURNISHED SHALL BE PROVIDED WITH EQUIPMENT RATED TO WITHSTAND FAULT CURRENT AVAILABLE AT PROJECT SITE.
 7. ALL WIRE AND PANEL BUSSING SHALL BE COPPER UNLESS ALLOWED ELSEWHERE IN THIS DOCUMENT SET, WIRE SIZES ARE BASED ON COPPER.
- 8. A NEW SET OF PLANS WILL BE PROVIDED AND SUBMITTED FOR ADDITIONAL CARRIERS.
- 9. ALL WORK SHALL CONFORM WITH THE CURRENT VERSION OF THE NEC AND ALL OTHER APPLICABLE CODES.
- 10. FIRST OVER-CURRENT PROTECTION DEVICE IS INTEGRAL TO GENERATOR. FEEDER SIZES INDICATED IN TABLE ABOVE ARE DOWNSTREAM OF THE FIRST OVER-CURRENT PROTECTION DEVICE.
- 11. INLINE BREAKER AT GENERATOR IS FACTORY INSTALLED, AND IS THE MANUFACTURER'S RECOMMENDED SIZE.





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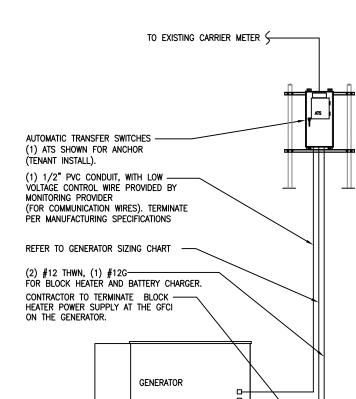
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WIRING DIAGRAM & SIZING CHARTS


SHEET NUMBER: REV. # NOTE: UTILITY POWER FEEDS SHALL BE CONNECTED TO THE TRANSFER SWITCH FROM THE LOAD SIDE OF THE EXISTING SERVICE DISCONNECT. NO MODIFICATIONS SHALL BE MADE ON THE LINE SIDE OF THE EXISTING SERVICE DISCONNECT.



DISCONNECT POWER FEED FROM EXISTING METER TO EXISTING SHELTER. ROUTE NEW FEEDERS (SIZED BELOW) FROM METER TO NEW TRANSFER SWITCH AND BACK. RECONNECT NEW RETURN FEED FROM TRANSFER SWITCH TO SUPPLY POWER (UTILITY AND BACK-UP POWER) TO EXISTING SHELTER.

METER CONFIGURATION

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H-FRAME LAYOUT SCALE: NOT TO SCALE

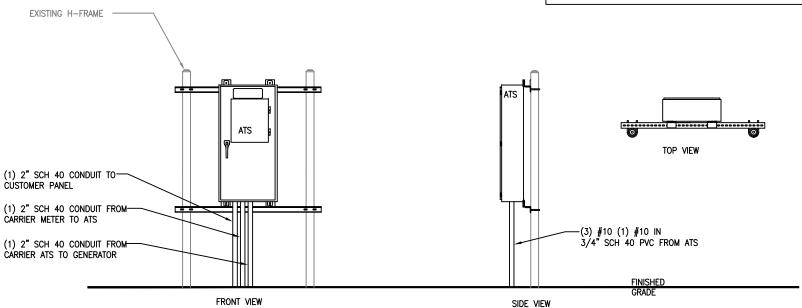

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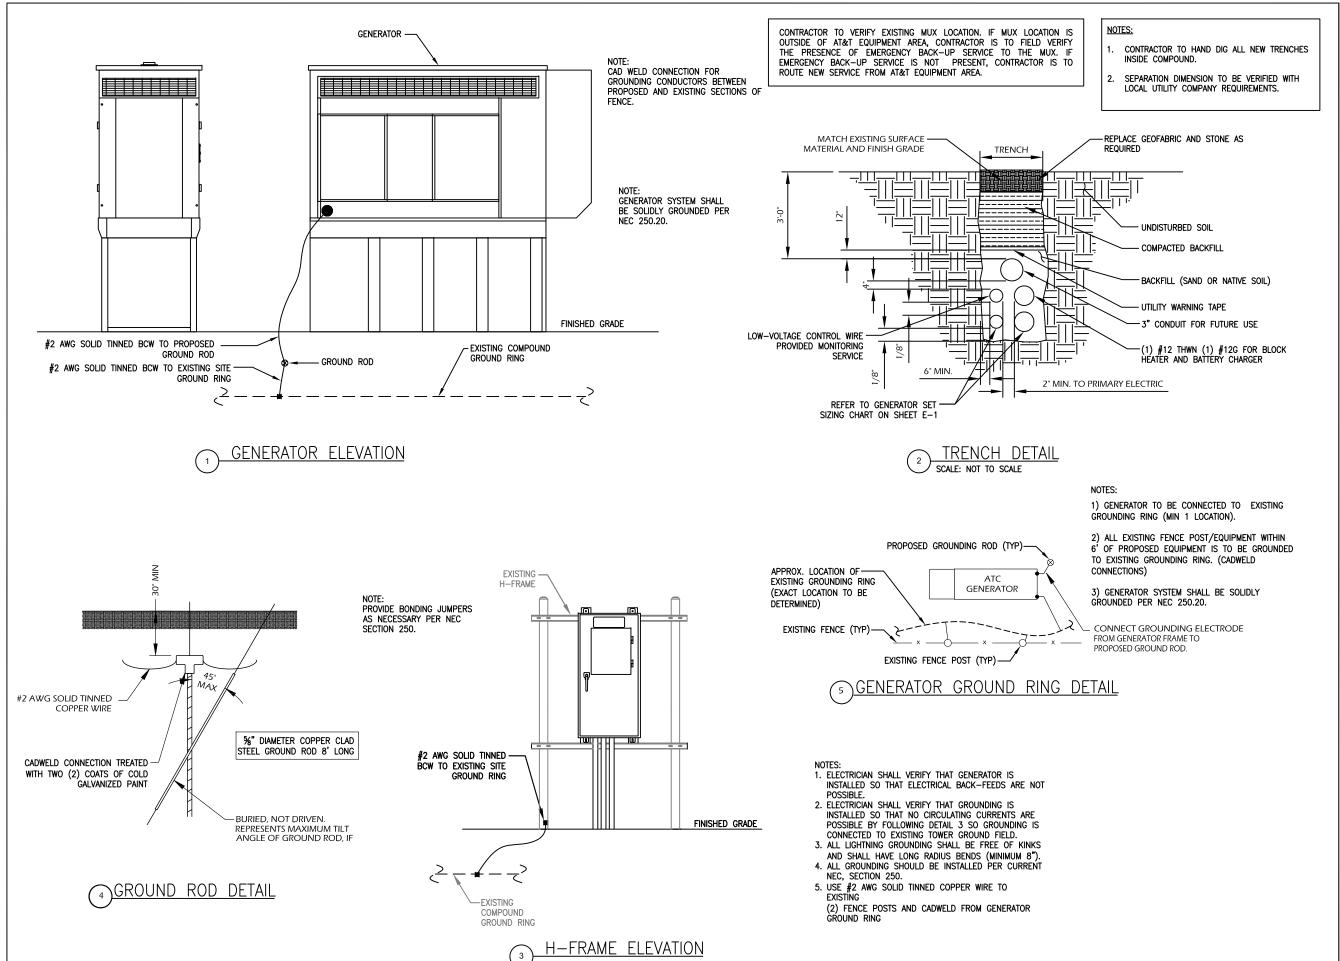
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SHEET TITLE:

ELECTRICAL & ATS MOUNTING **DETAILS**

SHEET NUMBER: REV. #



EADVANCED ENGINEERING GROUP, P.C

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ALPHARETTA, GA 30004

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SHEET TITLE:

GROUNDING DETAILS

SHEET NUMBER: REV. #