

Matt Burke

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Melanie Bachman Acting Executive Director Connecticut Siting Council 10 Franklin Square New Britain, CT 06051

# Re: Notice of Exempt Modification - Emergency Backup Generator 525 Plains Road, Haddam, CT 06438 (FA# 10035057)

Dear Ms. Bachman:

American Telephone and Telegraph Company ("AT&T") currently maintains a wireless telecommunications facility at the above referenced address. AT&T's facility consists of antennas at the 167' level of an existing 181' tower and an equipment shelter. The tower and AT&T's shelter are located within an existing lease area. The shelter houses AT&T's equipment and space for a back-up generator. AT&T does not currently maintain a generator at this cell site.

In an effort to further enhance multiple tenants' network reliability, AT&T intends to modify its facility by installing a new diesel-fueled generator outside in a designated 4' x 8' ground space. The generator incorporates a built-in fuel tank as part of the unit. The diesel fuel tanks are double walled for added safety and will be filled by a licensed fuel filling company. The proposed modification will expand the existing fenced-in compound area and AT&T's lease area by 10' x 20'. The new generator and tank with be surrounded by a security fence and gate. (See Facility Compound Plan attached).

Please accept this letter as notification pursuant to R.C.S.A Section 16-50j-73, for construction that constitutes modification pursuant to R.C.S.A Section 16-50j-72(b)(2). In accordance with R.C.S.A Section 16-50j-73, a copy of this submission is being sent to the Town of Haddam. A copy of this submission is also being sent to 539 Plains Road, LLC, the property owner on which the tower is located.

### AT&T's Proposed Wireless Modifications Constitute An "Exempt Modification"

The proposed modification to the above mentioned Facility constitutes an exempt modification of an existing facility provided for in R.C.S.A Section 16-50j-72(b)(2) and Council regulations promulgated pursuant thereto.

- 1) The proposed modification will not result in an increase in the height of the existing tower.
- 2) The generator and attached fuel tank will remain entirely within the limits of the leased area. The modifications therefore, will not require the extension of the boundary.
- The proposed modification does not increase the noise levels at the boundary by six
  (6) decibels or more under normal conditions. Proposed modification is only used during emergency power failure.
- 4) The installation of a new generator and attached fuel tank will not change, in any way, radio frequency (RF) emissions at the facility.
- 5) The facility has received all municipal zoning approvals and building permits. (Regs., Conn. State Agencies Section 16-50j-72))

For all the foregoing reasons, American Telephone and Telegraph Company respectfully submits that the proposed modifications to the above-referenced telecommunications facility constitutes an exempt modification under R.C.S.A Section 16-50j-72(b)(2)

Respectfully submitted,

#### Matt Burke 508.930.0974

On behalf of AT&T

c/o Tower Resource Management, Inc. 16 Chestnut Street, Suite 220 Foxboro, MA 02035

cc: Town of Haddam, CT 539 Plains Road, LLC c/o Crown Atlantic Company Exhibit 1

Site Plan








# BACKUP POWER PROJECT

SITE IDENTIFICATION:

SITE NUMBER: 10035057 SITE NAME: S.HADDAM

SITE ADDRESS: 525 PLAINS ROAD HADDAM, CT 06438

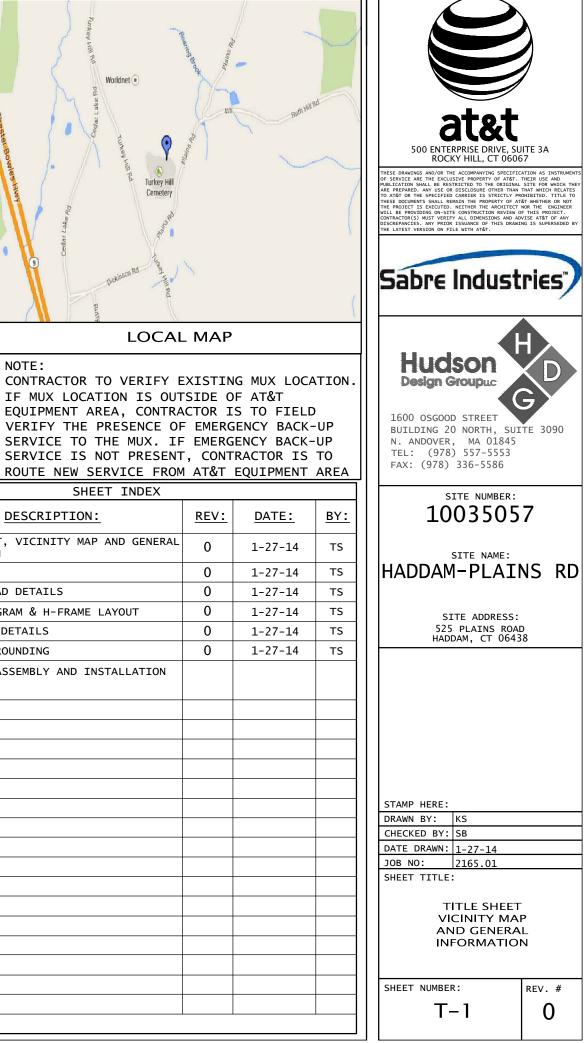




## **PROJECT DESCRIPTION:**

# THE PROPOSED PROJECT INCLUDES PLACING A 50 KW GENERATOR IN AN EXISTING CELLULAR TOWER COMPOUND.


PROJECT TEAM	PROJECT SUMMARY	PROJECT SUMMARY PROJECT NOTES					
APPLICANT: AT&T MOBILITY	GEOGRAPHIC COORDINATES: LATITUDE: 41°26'35.0" N (41.44305 N)	1. THE FACILITY IS UNMANNED.	<u>SHT</u> <u>NO:</u>	DESCRIPTION:			
550 COCHITUATE ROAD SUITES 13 & 14	LONGITUDE: -72° 30' 22.4" W (-72.50622 W) GROUND ELEVATION: N/A	2. A TECHNICIAN WILL VISIT THE SITE APPROXIMATELY ONCE A MONTH FOR ROUTINE	т-1	TITLE SHEET, VICINITY MAP AND GENERAL INFORMATION			
FRAMINGHAM, MA 01701		INSPECTION AND MAINTENANCE.	A-1	SITE PLAN			
	CODE BLOCK: BUILDING CODE:	3. THE PROJECT WILL NOT RESULT IN ANY	A-2	CONCRETE PAD DETAILS			
CUSTOMER REPRESENTATIVE:	2009 INTERNATIONAL BUILDING CODE	SIGNIFICANT LAND DISTURBANCE OR EFFECT OF STORM WATER DRAINAGE.	E-1	WIRING DIAGRAM & H-FRAME LAYOUT			
PEGGY POOR SABRE INDUSTRIES	2003 INTERNATIONAL BUILDING CODE & 2005 CT STATE BUILDING CODE WITH 2009 & 2011		E-2	ELECTRICAL DETAILS			
MARKET LEAD - AT&T NE GENERATOR PROGRAM	AMENDMENTS	4. NO SANITARY SEWER, POTABLE WATER OR TRASH DISPOSAL IS REQUIRED.	G-1	COMPOUND GROUNDING			
13010 MORRIS ROAD, 6TH FLOOR, BLDG 1 ALPHARETTA, GA 30004 CELL 770-990-0137	AT&T OPS FOR POWER CUT OVER: NEED 24 HOUR NOTICE	5. HANDICAP ACCESS IS NOT REQUIRED.		GENERATOR ASSEMBLY AND INSTALLATION SUPPLEMENT			
ppoor@sabreindustries.com	TO OPEN A TAP TICKET						
	DIAL: 1-800-638-2822	PROJECT LOCATION DIRECTIONS					
LANDLORD:	SELECT OPTION 1, THEN OPTION 2	START OUT GOING NORTHEAST ON ENTERPRISE					
CROWN ATLANTIC COMPANY LLC		DR TOWARD CAPITOL BLVD. TURN LEFT ONTO					
500 WEST CUMMINGS PARK, SUITE 3400, WOBURN, MA 01801		CAPITOL BLVD. TURN LEFT ONTO WEST ST. MERGE ONTO I-91 S VIA THE RAMP ON THE					
		LEFT TOWARD NEW HAVEN. MERGE ONTO CT-9 S					
		VIA EXIT 22S ON THE LEFT TOWARD					
GROUND OWNER: CROWN ATLANTIC COMPANY LLC		MIDDLETOWN/OLD SAYBROOK 15.7 MILES. TAKE THE BEAVER MEADOW RD EXIT, EXIT 8,					
500 WEST CUMMINGS PARK,		TOWARD HADDAM. TURN LEFT ONTO BEAVER					
SUITE 3400, WOBURN, MA 01801		MEADOW RD. TURN RIGHT ONTO TURKEY HILL					
		RD. TURN LEFT ONTO PLAINS RD (PORTIONS UNPAVED). 525 PLAINS RD IS ON THE LEFT.					
UTILITIES:		UNPAVED). 525 PLAINS RD IS UN THE LEFT.					
POWER COMPANY:							
NAME:							

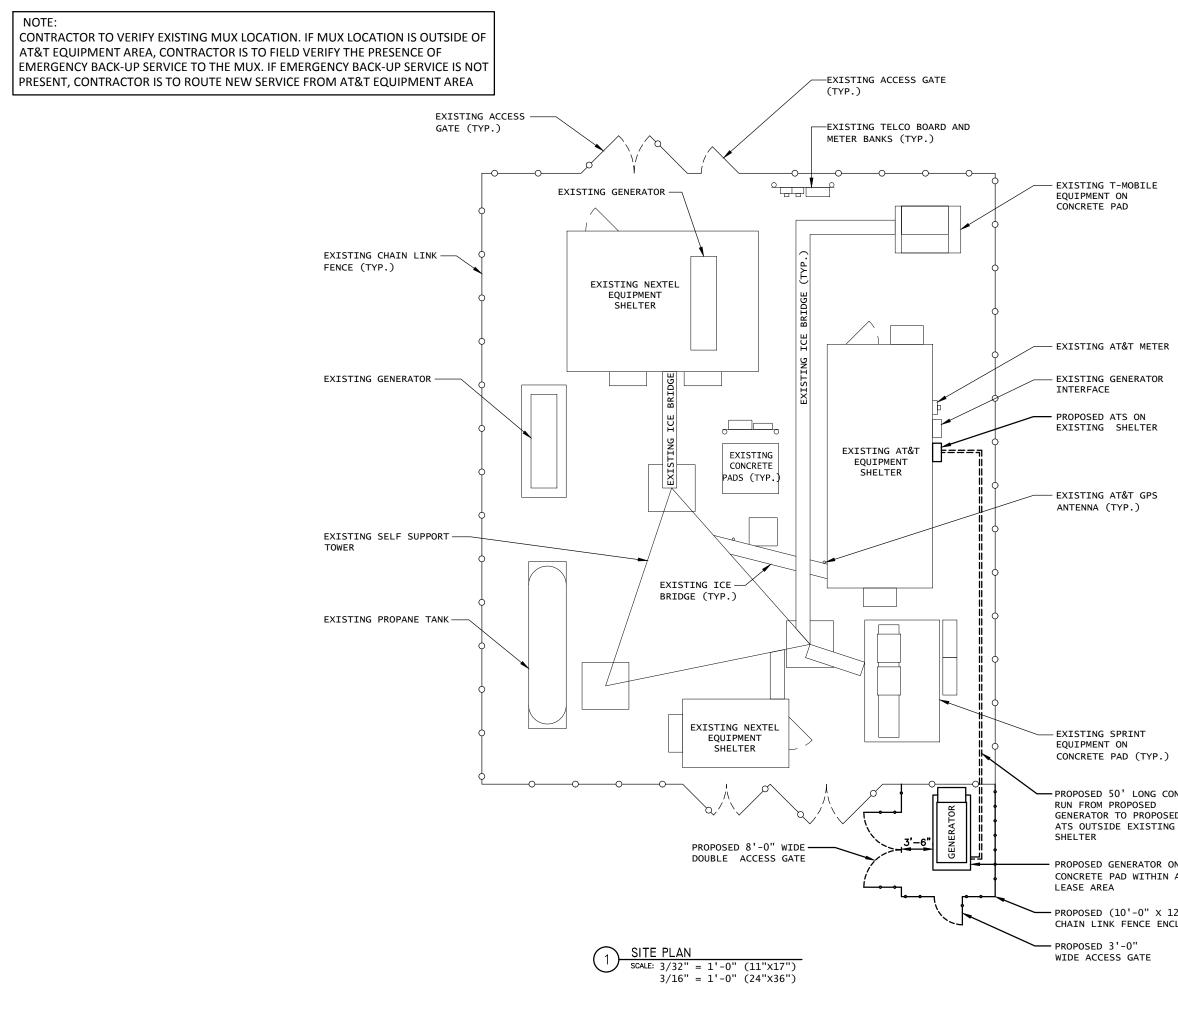


	PUBLICATION SHALL BE RESTRICTED TO THE ORIGINA ARE PREPARED, ANY USE ON DISCLOSURE OTHER THAN ARE PREPARED ANY USE ON DISCLOSURE OTHER THAN THESE DOCUMENTS SHALL REMAIN THE PROPERTY OF A THE PROJECT IS EXECUTED. NEITHER THE ARCHITECT WILL BE PROVIDING ON-SITE CONSTRUCTION REVIEW CONTRACTORS(S) MUST VERITY ALL DIMENSIONS AND A DISCREPANCIES. ANY PRIOR ISSUANCE OF THIS DRAW THE LATEST VERSION ON TISLE WITH ATA.	THAT WHICH RELATES ROHIBITED. TITLE TO .T&T WHETHER OR NOT NOR THE ENGINEER OF THIS PROJECT.			
	Sabre Indust	ries			
	Huckson Design Groupuc 1600 OSGOOD STREET BUILDING 20 NORTH, SU N. ANDOVER, MA 01845 TEL: (978) 557-5553 FAX: (978) 336-5586	HD G ITE 3090			
	SITE NUMBER: 10035057				
	SITE NAME: HADDAM-PLAI	NS RD			
	SITE ADDRESS: 525 PLAINS ROA HADDAM, CT 064	D			
NDUIT D	STAMP HERE:				
	DRAWN BY: KS CHECKED BY: SB				
N (4'-0"X8'-0") AT&T (10'-0"X12'-0")	DATE DRAWN: 1-27-14 JOB NO: 2165.01 SHEET TITLE:				
2'-0") LOSURE	SITE PLAN				
	SHEET NUMBER: A-1	rev. # 0			

500 ENTERPRISE DRIVE, SUITE 3A ROCKY HILL, CT 06067

THESE DRAWINGS AND/OR THE ACCOMPANYING SPECIFICATION AS INSTRUMENTS OF SERVICE ARE THE EXCLUSIVE PROPERTY OF AT&T. THEIR USE AND

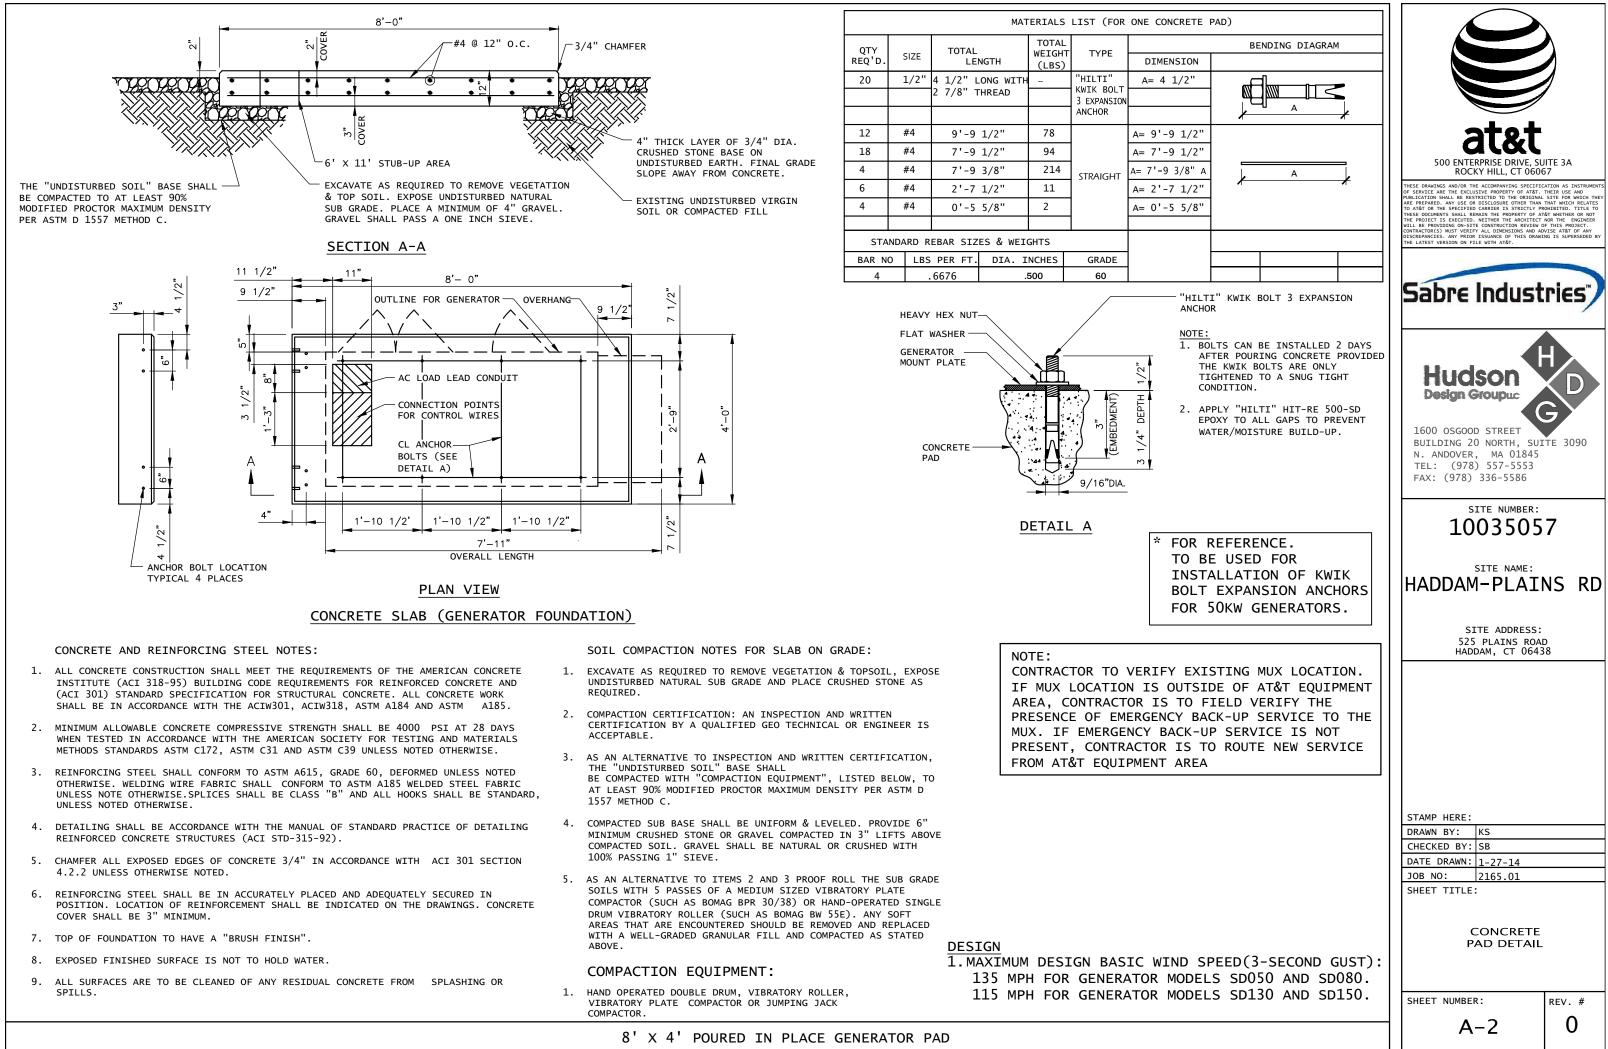

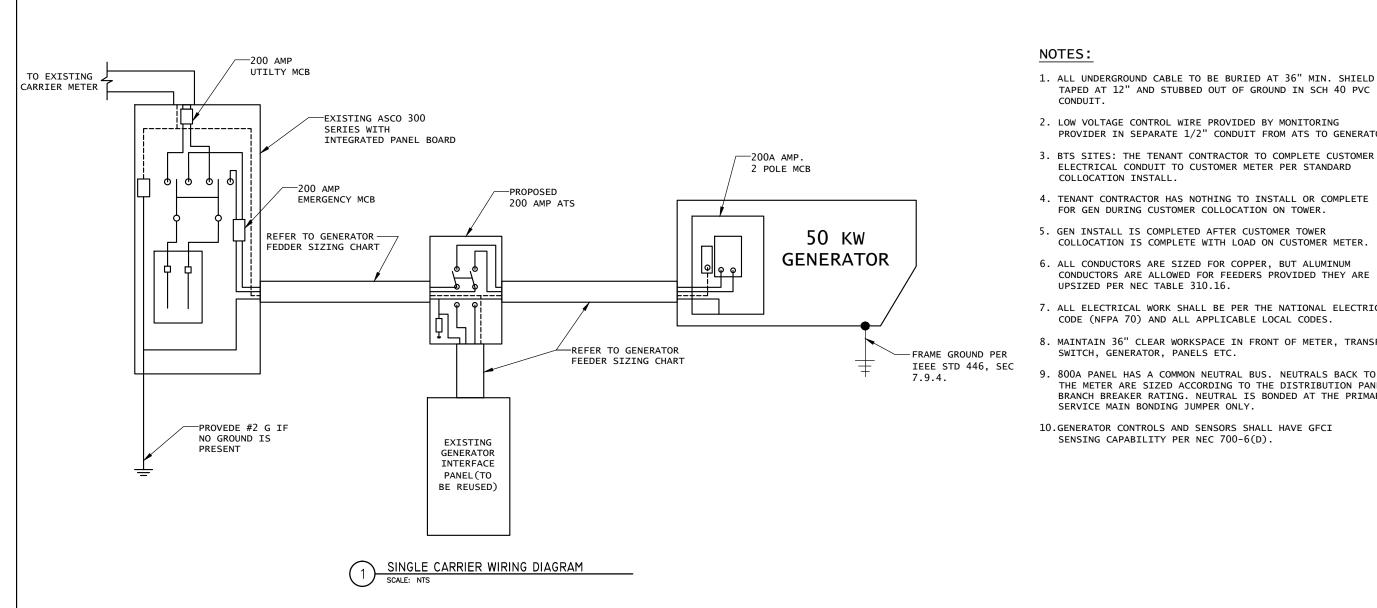

FEEDER SIZING CHART FOR GENERATOR						NOTE: CONTRACTOR TO VERIFY	
GEN SET SIZE	VOLTS-PHASE	PRIME RATING KW-AMPS	SIZE OF INLINE BREAKER (AT GERERATOR)	MAIN BREAKER SIZE SERVING ANCHOR TENANT:	FEEDER SIZES FROM GEN SET BREAKER TO ATS.	IF MUX LOCATION IS O AREA, CONTRACTOR IS PRESENCE OF EMERGENC MUX. IF EMERGENCY BA	
50 KW	120/240V - 1-PH	48KW - 200A	200A	200A 2-P C/B INTEGRAL TO GEN SET.	3#3/0, 1#6G, IN 2"C	PRESENT, CONTRACTOR FROM AT&T EQUIPMENT	

#### NOTES:

SERVICE VOLTAGE IS 120/240 1-PHASE. AND SERVICE SIZES ARE TYPICAL 220A. 1.

- 2. AUTOMATIC TRANSFER SWITCH (ATS) ARE 200A, 2-POLES, 120/240V 1-PHASE WITH SOLID NEUTRAL.
- 3. ALL EXTERIOR ELECTRICAL EQUIPMENT IS NEMA 3R RATED.
- THE GENERATOR ELECTRICAL LOADS ARE ADEQUATE FOR THE CONNECTED LOADS. 4.

SCALE: NTS

ALL EQUIPMENT FURNISHED SHALL BE PROVIDED WITH EQUIPMENT RATED TO WITHSTAND FAULT CURRENT AVAILABLE AT PROJECT SITE. 5.

ALL WIRE AND PANEL BUSSING SHALL BE COPPER UNLESS ALLOWED ELSEWHERE IN THIS DOCUMENT SET, WIRE SIZES ARE BASED ON COPPER. 6.

ALL WORK SHALL CONFORM WITH THE CURRENT VERSION OF THE NEC AND ALL OTHER APPLICABLE CODES. 7.

GENERATOR SET SIZING CHART

8. FIRST OVER-CURRENT PROTECTION DEVICE IS INTEGRAL TO GENERATOR . FEEDER SIZES INDICATED IN TABLE ABOVE ARE DOWNSTREAM OF THE FIRST OVER-CURRENT PROTECTION DEVICE.

9. INLINE BREAKER AT GENERATOR IS FACTORY INSTALLED, AND IS THE MANUFACTURERS RECOMMENDED SIZE.

TAPED AT 12" AND STUBBED OUT OF GROUND IN SCH 40 PVC

PROVIDER IN SEPARATE 1/2" CONDUIT FROM ATS TO GENERATOR.

ELECTRICAL CONDUIT TO CUSTOMER METER PER STANDARD

COLLOCATION IS COMPLETE WITH LOAD ON CUSTOMER METER.


CONDUCTORS ARE ALLOWED FOR FEEDERS PROVIDED THEY ARE


7. ALL ELECTRICAL WORK SHALL BE PER THE NATIONAL ELECTRICAL


8. MAINTAIN 36" CLEAR WORKSPACE IN FRONT OF METER. TRANSFER

9. 800A PANEL HAS A COMMON NEUTRAL BUS. NEUTRALS BACK TO THE METER ARE SIZED ACCORDING TO THE DISTRIBUTION PANEL BRANCH BREAKER RATING. NEUTRAL IS BONDED AT THE PRIMARY


Y EXISTING MUX LOCATION. OUTSIDE OF AT&T EQUIPMENT TO FIELD VERIFY THE CY BACK-UP SERVICE TO THE ACK-UP SERVICE IS NOT IS TO ROUTE NEW SERVICE AREA

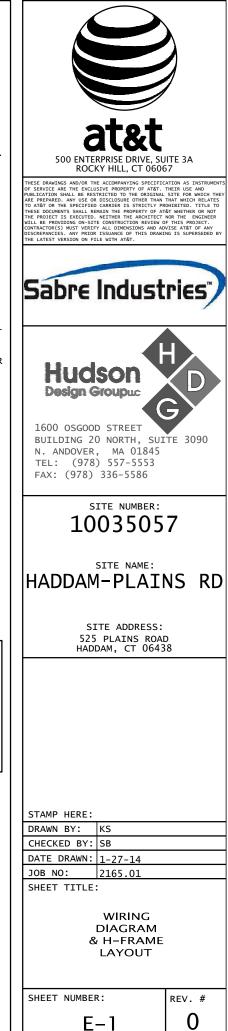

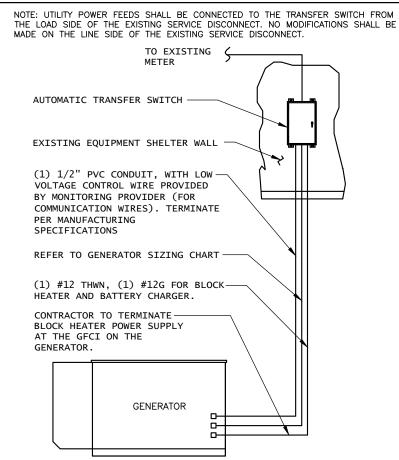

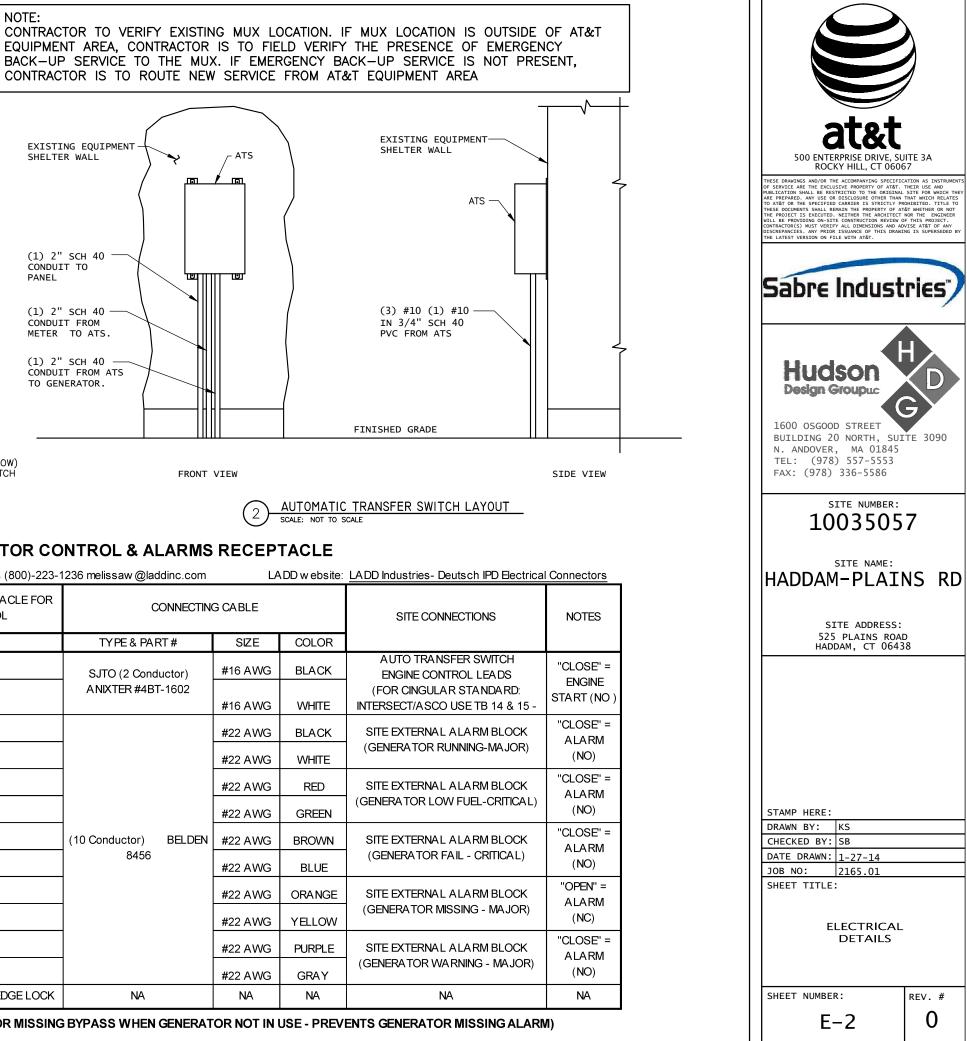

DISCONNECT POWER FEED FROM EXISTING METER TO EXISTING SHELTER. ROUTE NEW FEEDERS (SIZED BELOW) FROM METER TO NEW TRANSFER SWITCH AND BACK. RECONNECT NEW RETURN FEED FROM TRANSFER SWITCH TO SUPPLY POWER (UTILITY AND BACK-UP POWER) TO EXISTING SHELTER.

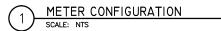

## SITE GENERATOR CONTROL & ALARMS RECEPTACLE

Distributor for Deutsch connectors	s is LADD Industries. Conta	act: Melissa Watkins (800)-223-7	1236 melissaw @laddinc.com	LA	DD w ebsite:	LADD Industries- Deutsch IPD Electrica	I Co
GENERATOR FUNCTION	DEUTSCH DTM0412PA-L012 SITE RECEPTACLE FOR GENERATOR ALARMS & CONTROL		CONNECTING CABLE		SITE CONNECTIONS		
	SOCKET PART #	PIN #	TYPE&PART#	SIZE	COLOR		
(CONTROL) AUTOMATIC START/STOP	#16 AWG 1062-20-0122	1	SJTO (2 Conductor) A NIXTER #4BT-1602	#16 AWG	BLACK	A UTO TRANSFER SWITCH ENGINE CONTROL LEADS	
	#16 AWG 1062-20-0122	2		#16 AWG	WHITE	(FOR CINGULAR STANDARD: INTERSECT/ASCO USE TB 14 & 15 -	s
(ALARM) GENERATOR RUNNING	#22 AWG 0462-201-20141	3		#22 AWG	BLACK	SITE EXTERNAL ALARM BLOCK (GENERATOR RUNNING-MAJOR)	Ţ
	#22 AWG 0462-201-20141	4		#22 AWG	WHITE		
(ALARM) GENERATOR LOW FUEL	#22 AWG 0462-201-20141	5		#22 AWG	2 AWG RED	SITE EXTERNAL ALARM BLOCK (GENERATOR LOW FUEL-CRITICAL)	
	#22 AWG 0462-201-20141	6		#22 AWG	GREEN		
(ALARM) GENERATOR FAIL - MAJOR [SHUTDOWN]	#22 AWG 0462-201-20141	7	(10 Conductor) BELDEN	#22 AWG	BROWN	SITE EXTERNAL ALARM BLOCK	Τ
	#22 AWG 0462-201-20141	8	8456	#22 AWG	BLUE	(GENERATOR FAIL - CRITICAL)	
(ALARM) GENERATOR MISSING [THEFT]	#22 AWG 0462-201-20141	9		#22 AWG	ORANGE	(GENERATOR MISSING - MAJOR)	
	#22 AWG 0462-201-20141	10		#22 AWG	YELLOW		
(ALARM) GENERATOR WARNING - MINOR - [NON-SHUTDOWN]	#22 AWG 0462-201-20141	11		#22 AWG	PURPLE		
	#22 AWG 0462-201-20141	12		#22 AWG	GRAY	(GENERATOR WARNING - MAJOR)	
NA	WM-12S	RECEPTACLE WEDGE LOCK	NA	NA	NA	NA	

SITE GENERATOR CONTROL & ALARMS PLUG (GENERATOR MISSING BYPASS WHEN GENERATOR NOT IN USE - PREVENTS GENERATOR MISSING ALARM)

