

Matt Burke

16 Chestnut Street, Suite 220 Foxboro, MA 02035 Tel (508) 930-0974 Fax (774) 215-5423

Melanie Bachman Acting Executive Director Connecticut Siting Council 10 Franklin Square New Britain, CT 06051

Re: Notice of Exempt Modification - Emergency Backup Generator 577 Bell St., Glastonbury, CT 06033 (FA# 10050975)

Dear Ms. Bachman:

American Telephone and Telegraph Company ("AT&T") currently maintains a wireless telecommunications facility at the above referenced address. AT&T's facility consists of antennas at the 93' level of an existing 104' tower and a 12' x 20' equipment shelter. The tower and AT&T's shelter are located within an existing lease area. The shelter houses AT&T's equipment and space for a back-up generator. AT&T does not currently maintain a generator at this cell site.

In an effort to further enhance multiple tenants' network reliability, AT&T intends to modify its facility by installing a new diesel-fueled generator outside in a designated 4' x 8' ground space. The generator incorporates a built-in fuel tank as part of the unit. The diesel fuel tanks are double walled for added safety and will be filled by a licensed fuel filling company. The proposed modification will remain within the existing, fenced-in compound. The new generator and tank with be surrounded by a security fence and gate and will be placed on a 4' x 8' concrete pad. (See Facility Compound Plan attached).

Please accept this letter as notification pursuant to R.C.S.A Section 16-50j-73, for construction that constitutes modification pursuant to R.C.S.A Section 16-50j-72(b)(2). In accordance with R.C.S.A Section 16-50j-73, a copy of this submission is being sent to the Town of Glastonbury. A copy of this submission is also being sent to Cox Connecticut Telcom, LLC, the property owner on which the tower is located.

AT&T's Proposed Wireless Modifications Constitute An "Exempt Modification"

The proposed modification to the above mentioned Facility constitutes an exempt modification of an existing facility provided for in R.C.S.A Section 16-50j-72(b)(2) and Council regulations promulgated pursuant thereto.

- 1) The proposed modification will not result in an increase in the height of the existing tower.
- 2) The generator and attached fuel tank will remain entirely within the limits of the leased area. The modifications therefore, will not require the extension of the boundary.
- The proposed modification does not increase the noise levels at the boundary by six
 (6) decibels or more under normal conditions. Proposed modification is only used during emergency power failure.
- 4) The installation of a new generator and attached fuel tank will not change, in any way, radio frequency (RF) emissions at the facility.
- 5) The facility has received all municipal zoning approvals and building permits. (Regs., Conn. State Agencies Section 16-50j-72))

For all the foregoing reasons, American Telephone and Telegraph Company respectfully submits that the proposed modifications to the above-referenced telecommunications facility constitutes an exempt modification under R.C.S.A Section 16-50j-72(b)(2)

Respectfully submitted,

Matt Burke 508.930.0974

On behalf of AT&T

- c/o Tower Resource Management, Inc. 16 Chestnut Street, Suite 220 Foxboro, MA 02035
- cc: **Town of Glastonbury, CT** Cox Connecticut Telcom, LLC

Exhibit 1

Site Plan



Know what's below.

Call before you dig.

THIS FACILITY SHALL MEET OR EXCEED ALL FAA AND FCC REGULATORY REQUIREMENTS.



BACKUP POWER PROJECT

SITE IDENTIFICATION:

SITE NUMBER: 10050975

SITE NAME: GLASTONBURY BELL STREET.

SITE ADDRESS: 577 BELL STREET GLASTONBURY, CT 06033

CONTRACTOR TO VERIFY EXISTING MUX OUTSIDE OF AT&T EQUIPMENT AREA, C THE PRESENCE OF EMERGENCY BACK EMERGENCY BACK-UP SERVICE IS NOT ROUTE NEW SERVICE FROM AT&T EQUIPI


PROJECT DESCRIPTION:

THE PROPOSED PROJECT INCLUDES PLACING A 50 KW GENERATOR IN AN EXISTING CELLULAR TOWER COMPOUND.

PROJECT TEAM	PROJECT SUMMARY	PROJECT NOTES		SHEET INDEX
ENGINEER: ADVANCED ENGINEERING GROUP, P.C.	GEOGRAPHIC COORDINATES: LATITUDE: 41' 44' 01.08"	1. THE FACILITY IS UNMANNED.	SHT NO:	DESCRIPTION:
500 NORTH BROADWAY EAST PROVIDENCE, RI 02914 TEL: 401–354–2403	LONGITUDE: 72' 32' 58.80" CODE BLOCK: BUILDING CODE:	2. A TECHNICIAN WILL VISIT THE SITE APPROXIMATELY ONCE A MONTH FOR ROUTINE INSPECTION AND MAINTENANCE.	T-1	TITLE SHEET, VICINITY MAP AND GENERAL INFORMATION
APPLICANT:		3. THE PROJECT WILL NOT RESULT IN ANY SIGNIFICANT LAND DISTURBANCE OR EFFECT OF STORM WATER	A-1	COMPOUND PLAN
AT&T MOBILITY 550 COCHITUATE ROAD	2009 INTERNATIONAL BUILDING CODE	DRAINAGE.	A-2	CONCRETE PAD DETAILS
SUITES 13 & 14 FRAMINGHAM, MA 01701		 NO SANITARY SEWER, POTABLE WATER OR TRASH DISPOSAL AS REQUIRED. 	E-1	WIRING DIAGRAM & SIZING CHARTS
CUSTOMER REPRESENTATIVE:		5. HANDICAP ACCESS IS NOT REQUIRED.	E-2	ELECTRICAL & ATS MOUNTING DETAILS
SABRE INDUSTRIES PEGGY POOR			G-1	GROUNDING DETAILS
MARKET LEAD – AT&T NE GENERATOR PROGRAM 13010 MORRIS ROAD, 6TH FLOOR, BLDG 1		PROJECT LOCATION DIRECTIONS		
ALPHARETTA, GA 30004 CELL 770–990–0137		1. 550 COCHITUATE RD, FRAMINGHAM, MA 01701		
		2. DEPART LEGGAT MCCALL CONNECTOR RD TOWARD SPEEN ST		
LANDLORD: COX COMMUNICATIONS INC		 TURN RIGHT ONTO SPEEN ST TURN RIGHT ONTO RT-30 / COCHITUATE RD 		
BOB DEANGILIS 1400 LAKE HEARN DRIVE		 TAKE RAMP RIGHT FOR I-90 WEST TOWARD WORCESTER / SPRINGFIELD 		
NE ATLANTA GA 30319 PHONE: 401 615 1421		6. AT EXIT 9, TAKE RAMP RIGHT FOR I-84 TOWARD NEW YORK CITY / HARTFORD		
UTILITIES:		7. AT EXIT 59, TAKE RAMP RIGHT FOR I-384 EAST TOWARD SILVER LANE		
POWER COMPANY: NORTHEAST UTILITIES (NU)		8. AT EXIT 2, TAKE RAMP RIGHT TOWARD KEENEY STREET		
P.O. BOX 270 HARTFORD, CT 06141–0270		9. TURN LEFT ONTO WETHERELL ST 10. TURN RIGHT ONTO KEENEY ST		
PHONE: 1-800-286-5000		11. TURN RIGHT ONTO BUSH HILL RD 12. TURN LEFT ONTO BELL ST		
		13. ARRIVE AT 577 BELL ST, GLASTONBURY, CT 06033		


Operation New York Citcle Beneticited Dr. New York Weekyoon W


IS ING	Windbrook Ad Bush Hill Rd	Auchior Buchtor Boomer L	ENGINEERING GROUP, P.C. Civil Engineering - Site Development Surveying - Telecommunications 500 NORTH BROADWAY EAST PROVIDENCE, RI 02914 PH: 401-354-2403 FAX: 401-633-6354 Convergent Network Solutions TOWER RESOURCE MANAGEMENT 16 CHESTNUT STREET, SUITE 220 FOXBORO, MA 20205 WWW.TRMCOM.COM Stor Cochiruate ROAD, SUITE 13 & 14 FRAMINGHAM, MA 01701-4681
L MAP			
CONTRACTOR K-UP SERVI	IF MUX LOCATION IS TO FIELD VER CE TO THE MUX. T, CONTRACTOR IS	IFY IF	SITE NUMBER: 10050975 SITE NAME: GLASTONBURY BELL ST.
<u>REV:</u>	DATE:	<u>BY:</u>	SITE ADDRESS: 577 BELL STREET
1	01-21-2014	CJG	GLASTONBURY, CT 06033
1	01-21-2014	CJG	
		+	STAMP HERE:
		+	DRAWN BY: CJG CHECKED BY: SNA
		+	DATE DRAWN: 01-21-2014
		+	JOB NO: 10050975
			SHEET TITLE: TITLE SHEET, VICINITY MAP AND GENERAL INFORMATION
			SHEET NUMBER: REV. #
			T-1 1

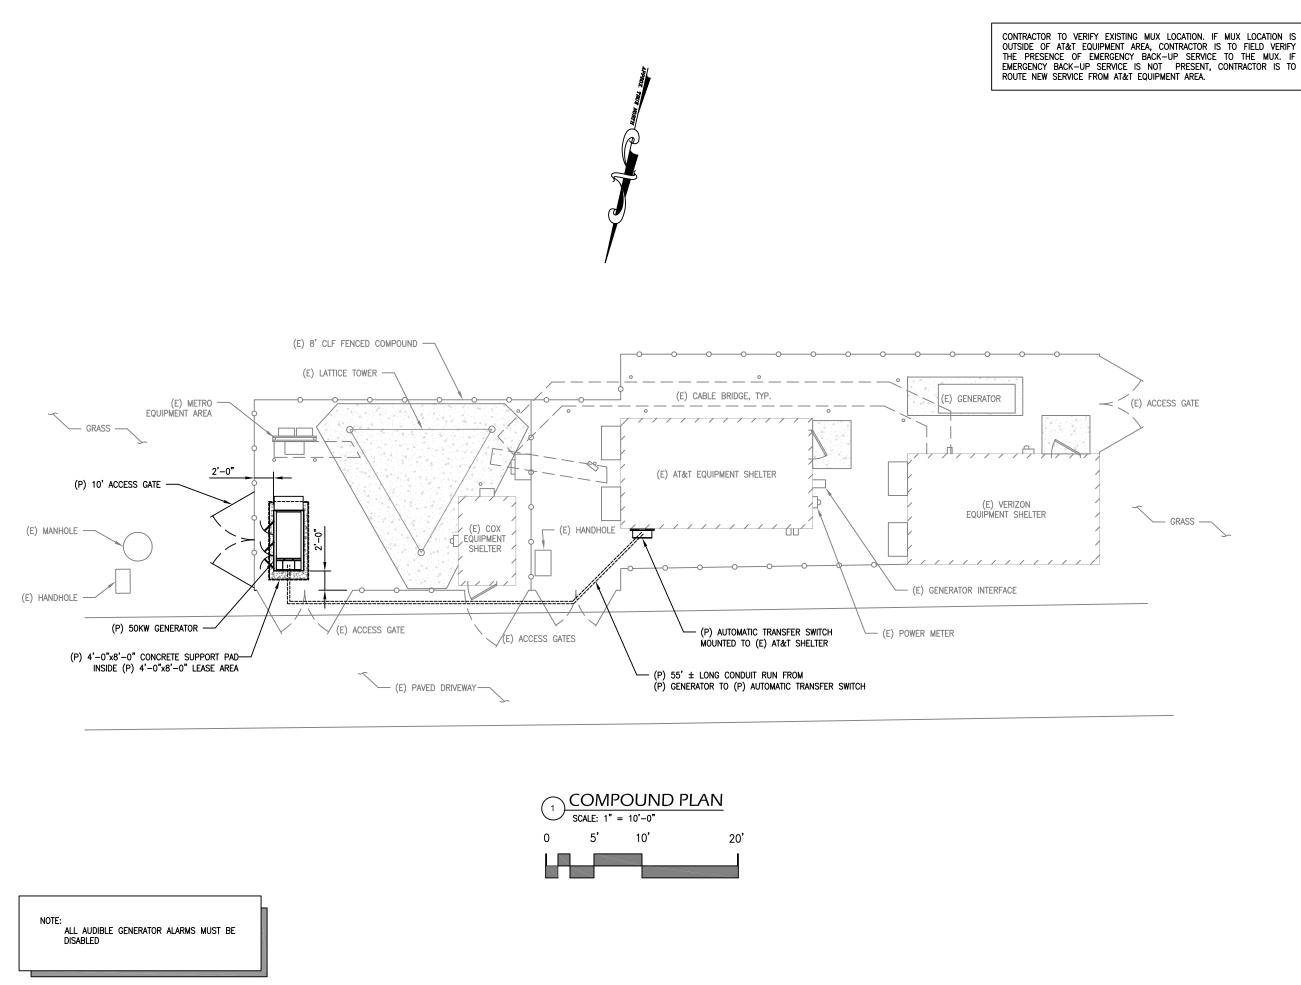

(E) ACCESS GATE

— GRASS —

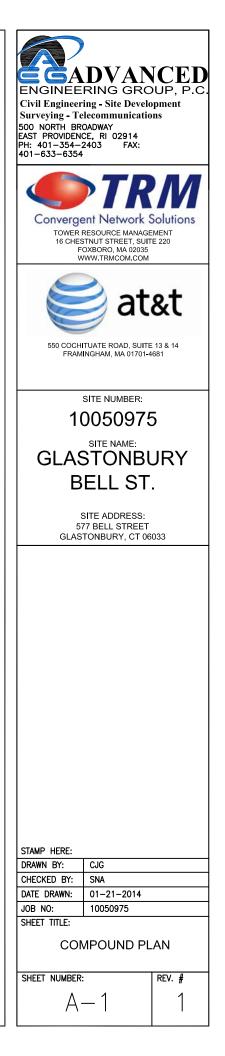

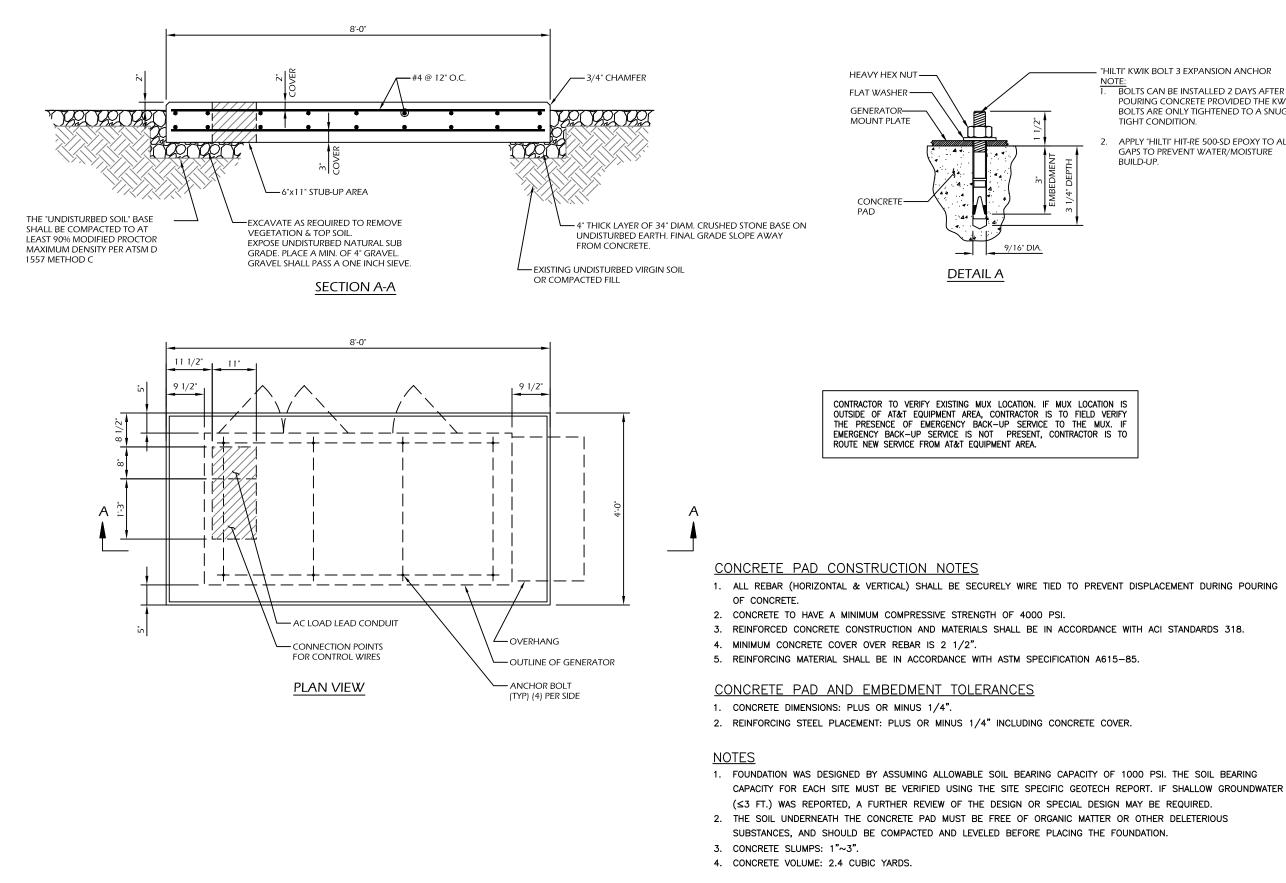


DESIGN


1. MAXIMUM DESIGN BASIC WIND SPEED (3-SECOND GUST): 155 MPH FOR GENERATOR MODELS SD050 AND SD080.

"HILTI" KWIK BOLT 3 EXPANSION ANCHOR

BOLTS CAN BE INSTALLED 2 DAYS AFTER POURING CONCRETE PROVIDED THE KWIK BOLTS ARE ONLY TIGHTENED TO A SNUG TIGHT CONDITION.

APPLY "HILTI" HIT-RE 500-SD EPOXY TO ALL GAPS TO PREVENT WATER/MOISTURE

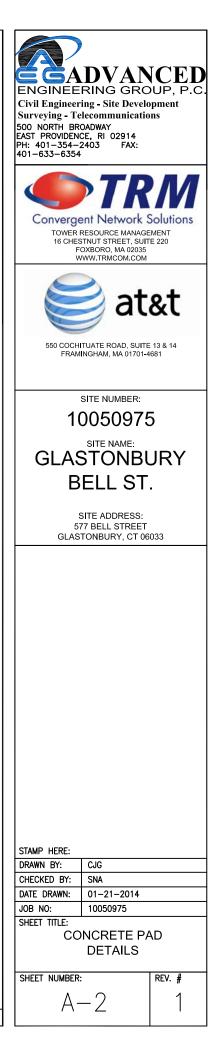

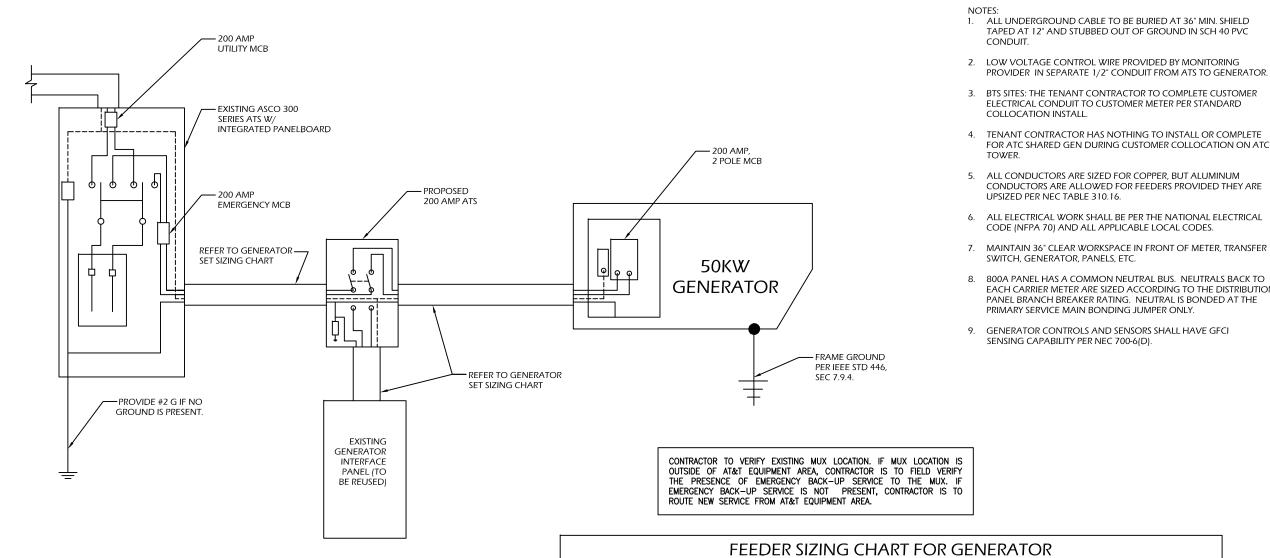

SINGLE CARRIER WIRING DIAGRAM SCALE: NOT TO SCALE

FEEDER SIZING CHART FOR GENERATOR					
GEN SET SIZE	Volts - Phase	PRIME RATING KW - AMPS	SIZE OF INLINE BREAKER (AT GENERATOR)	MAIN BREAKER SIZE SERVING ANCHOR TENANT:	FEEDER SIZES FROM GI BREAKER TO DISTRIBUT PANEL / ATS.
50KW	120/240V - 1-PH	48KW - 200A	200A	200A 2-P C/B INTEGRAL TO GEN SET	3#3/0, 1#6G, IN 2"C

NOTES:

1. SERVICE VOLTAGE FOR EACH CARRIER IS 120/240 1-PHASE, AND SERVICE SIZES ARE TYPICAL 200A PER CARRIER.

2. DISTRIBUTION PANEL IS 800A, 120/240V 1-PHASE, WITH 200A C/B FOR THE LISTED CARRIER OUTPUT. PANEL HAS (3) 200A BREAKER SPACES FOR FUTURE CARRIERS.

3. AUTOMATIC TRANSFER SWITCH (ATS) ARE 200A 2-POLES, 120/240V 1-PHASE WITH SOLID NEUTRAL PER CARRIER.

4. ALL ELECTRICAL EQUIPMENT IS NEMÁ 3R RATED.

5. THE GENERATOR ELECTRICAL LOADS ARE ADEQUATE FOR THE CONNECTED LOADS.

ALL EQUIPMENT FURNISHED SHALL BE PROVIDED WITH EQUIPMENT RATED TO WITHSTAND FAULT CURRENT AVAILABLE AT PROJECT SITE.
 ALL WIRE AND PANEL BUSSING SHALL BE COPPER UNLESS ALLOWED ELSEWHERE IN THIS DOCUMENT SET, WIRE SIZES ARE BASED ON COPPER.

8. A NEW SET OF PLANS WILL BE PROVIDED AND SUBMITTED FOR ADDITIONAL CARRIERS.

9. ALL WORK SHALL CONFORM WITH THE CURRENT VERSION OF THE NEC AND ALL OTHER APPLICABLE CODES. 10. FIRST OVER-CURRENT PROTECTION DEVICE IS INTEGRAL TO GENERATOR. FEEDER SIZES INDICATED IN TABLE ABOVE ARE DOWNSTREAM OF THE FIRST OVER-CURRENT PROTECTION DEVICE.

11. INLINE BREAKER AT GENERATOR IS FACTORY INSTALLED, AND IS THE MANUFACTURER'S RECOMMENDED SIZE.




PROVIDER IN SEPARATE 1/2" CONDUIT FROM ATS TO GENERATOR.


FOR ATC SHARED GEN DURING CUSTOMER COLLOCATION ON ATC

CONDUCTORS ARE ALLOWED FOR FEEDERS PROVIDED THEY ARE

800A PANEL HAS A COMMON NEUTRAL BUS. NEUTRALS BACK TO EACH CARRIER METER ARE SIZED ACCORDING TO THE DISTRIBUTION

1	G	ΕN	SET	
B	U	TIO	N	

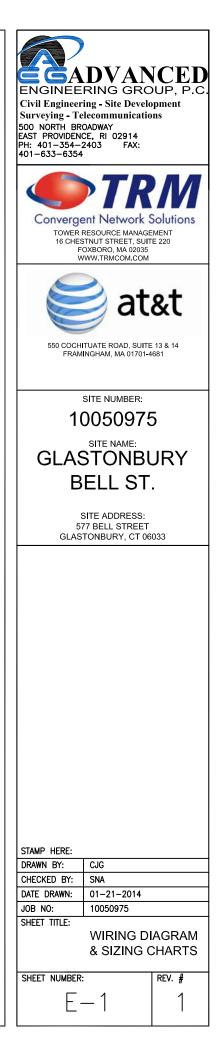


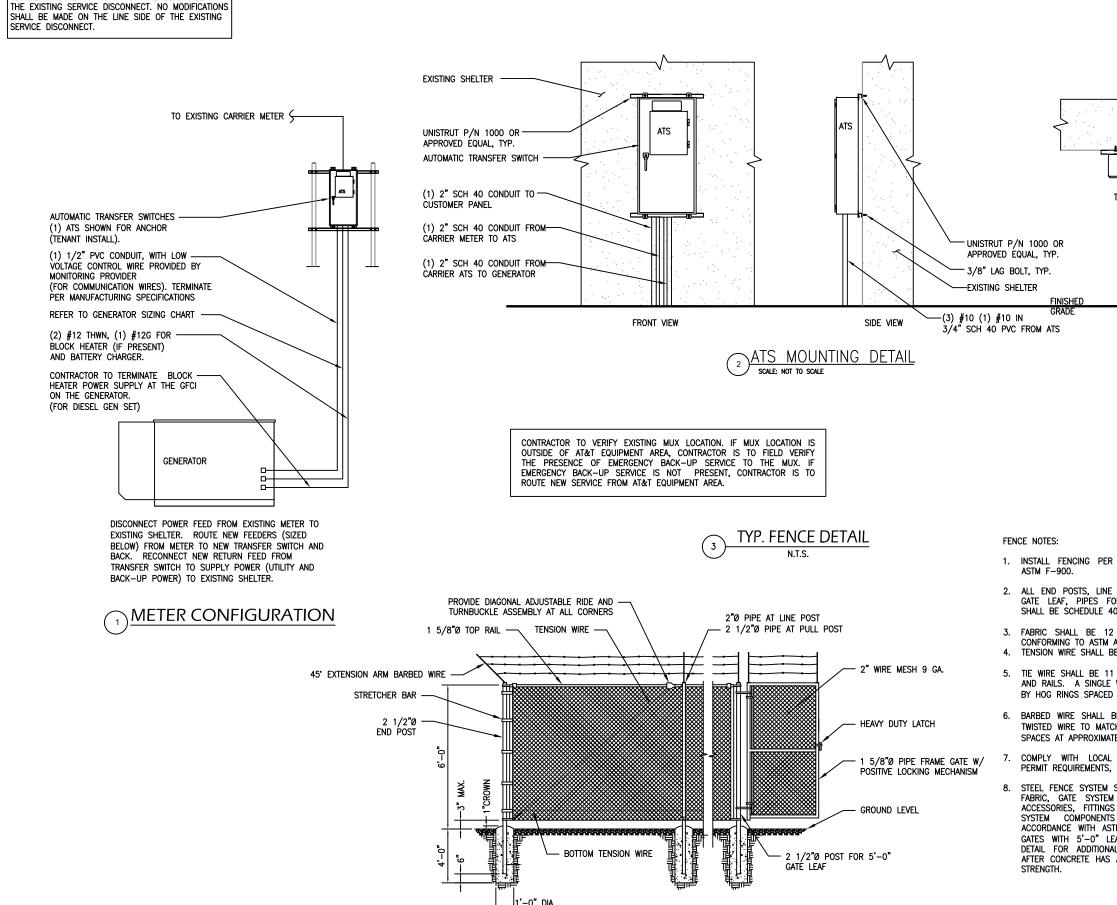


NOTE: UTILITY POWER FEEDS SHALL BE CONNECTED TO THE TRANSFER SWITCH FROM THE LOAD SIDE OF

TOP VIEW
R ASTM F-567, SWING GATE PER
E POSTS, PULL POSTS, POSTS FOR OR GATE FRAME AND TOP RAILS 40 PIPE PER ASTM F-1083.
2 GA. CORE WIRE SIZE 2" MESH A-392. BE 7 GA. GALV. STEEL.
1 GA. GALV. STEEL (MIN.) AT POSTS WRAP FABRIC TIE AT TENSION WIRE MAX. OF 24" INTERVALS
BE DOUBLE STRAND 12 1/2" O.D. CH W/FABRIC 14 GA., 4 PT. BARBS TELY 5" O.C.
ORDINANCES OF BARBED WIRE, IF REQUIRED.

STEEL FENCE SYSTEM SHALL INCLUDE THE FENCE POSTS, FABRIC, GATE SYSTEM AND ALL NECESSARY ERECTION ACCESSORIES, FITTINGS AND FASTENINGS. ALL FENCE SYSTEM COMPONENTS SHALL BE GALVANIZED IN ACCORDANCE WITH ASTM A153. GATES SHALL BE SWING GATES WITH 5'-0" LEAFS. REFER TO TYPICAL FENCE DETAIL FOR ADDITIONAL INFORMATION. INSTALL FENCE AFTER CONCRETE HAS ATTAINED 75% OF 28 DAY DESIGN

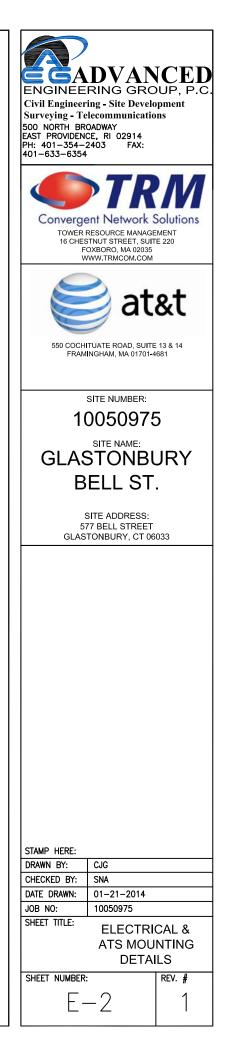

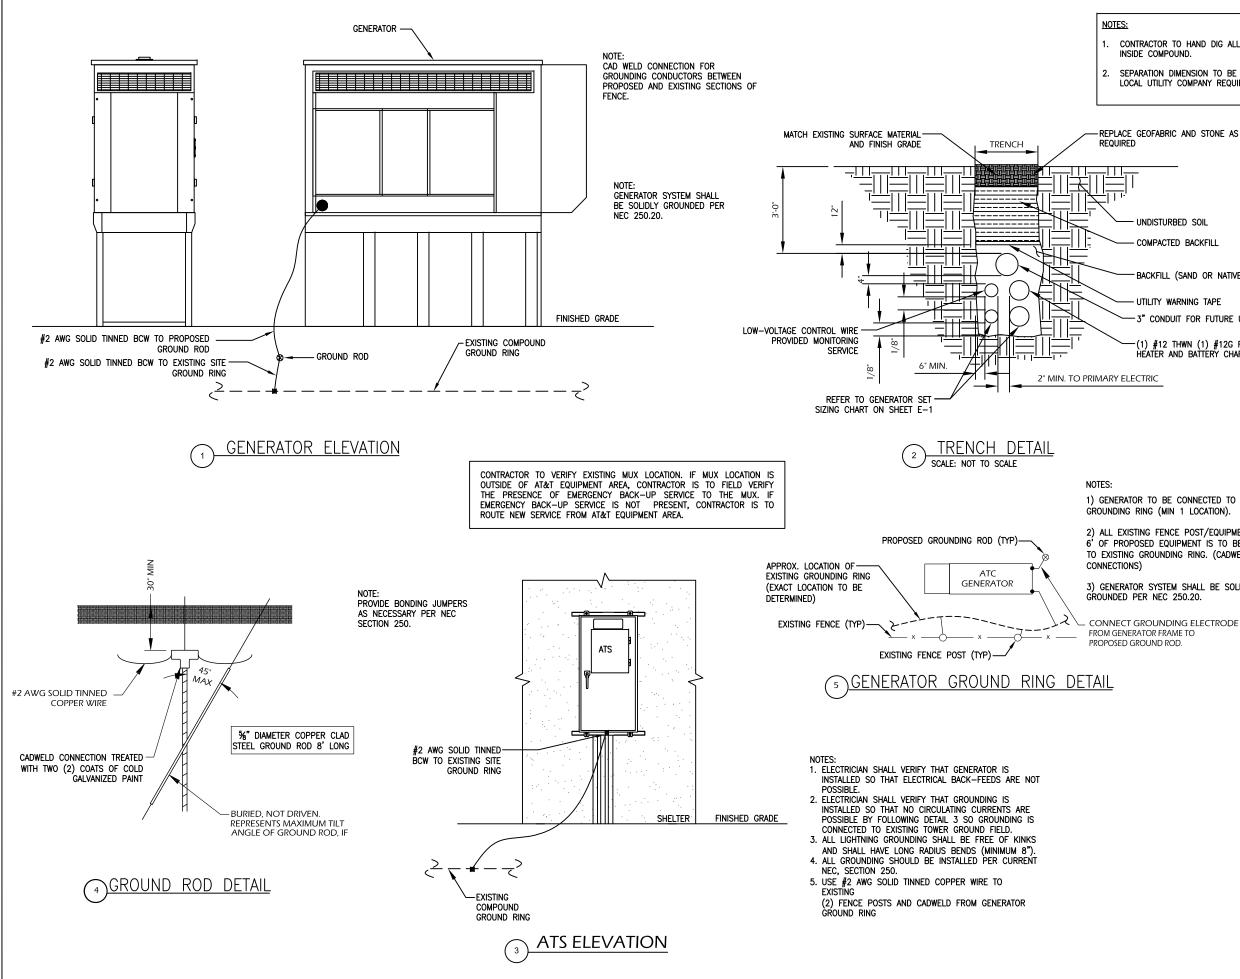

CONTRACTOR TO HAND DIG ALL NEW TRENCHES

2. SEPARATION DIMENSION TO BE VERIFIED WITH LOCAL UTILITY COMPANY REQUIREMENTS.

-REPLACE GEOFABRIC AND STONE AS

- UNDISTURBED SOIL

- COMPACTED BACKFILL

- BACKFILL (SAND OR NATIVE SOIL)

- UTILITY WARNING TAPE - 3" CONDUIT FOR FUTURE USE

(1) #12 THWN (1) #12G FOR BLOCK HEATER AND BATTERY CHARGER

1) GENERATOR TO BE CONNECTED TO EXISTING GROUNDING RING (MIN 1 LOCATION).

2) ALL EXISTING FENCE POST/EQUIPMENT WITHIN 6' OF PROPOSED EQUIPMENT IS TO BE GROUNDED TO EXISTING GROUNDING RING. (CADWELD

3) GENERATOR SYSTEM SHALL BE SOLIDLY

