

Matt Burke

16 Chestnut Street, Suite 220 Foxboro, MA 02035 Tel (508) 930-0974 Fax (774) 215-5423

Melanie Bachman Acting Executive Director Connecticut Siting Council 10 Franklin Square New Britain, CT 06051

Re: Notice of Exempt Modification - Emergency Backup Generator 10 Main St., Essex, CT 06426 (FA# 10035078) (also known as 6 Main St.)

Dear Ms. Bachman:

American Telephone and Telegraph Company ("AT&T") currently maintains a wireless telecommunications facility at the above referenced address. AT&T's facility consists of antennas at the 115' level of an existing 128-6' water tank-tower (now used exclusively as a communications facility) and an equipment shelter. The tower and AT&T's shelter are located within an existing lease area. The shelter houses AT&T's equipment and space for a back-up generator. AT&T does not currently maintain a generator at this cell site.

In an effort to further enhance multiple tenants' network reliability, AT&T intends to modify its facility by installing a new diesel-fueled generator outside in a designated 4' x 8' ground space. The generator incorporates a built-in fuel tank as part of the unit. The diesel fuel tanks are double walled for added safety and will be filled by a licensed fuel filling company. The proposed modification will be adjacent to the existing shelter area. (See Facility Compound Plan attached).

Please accept this letter as notification pursuant to R.C.S.A Section 16-50j-73, for construction that constitutes modification pursuant to R.C.S.A Section 16-50j-72(b)(2). In accordance with R.C.S.A Section 16-50j-73, a copy of this submission is being sent to the Town of Essex. A copy of this submission is also being sent to Macbeth Ventures, LLC, the property owner on which the tower is located.

AT&T's Proposed Wireless Modifications Constitute An "Exempt Modification"

The proposed modification to the above mentioned Facility constitutes an exempt modification of an existing facility provided for in R.C.S.A Section 16-50j-72(b)(2) and Council regulations promulgated pursuant thereto.

1) The proposed modification will not result in an increase in the height of the existing tower.

- 2) The generator and attached fuel tank will remain entirely within the limits of the leased area. The modifications therefore, will not require the extension of the boundary.
- The proposed modification does not increase the noise levels at the boundary by six
 (6) decibels or more under normal conditions. Proposed modification is only used during emergency power failure.
- 4) The installation of a new generator and attached fuel tank will not change, in any way, radio frequency (RF) emissions at the facility.
- 5) The facility has received all municipal zoning approvals and building permits. (Regs., Conn. State Agencies Section 16-50j-72))

For all the foregoing reasons, American Telephone and Telegraph Company respectfully submits that the proposed modifications to the above-referenced telecommunications facility constitutes an exempt modification under R.C.S.A Section 16-50j-72(b)(2)

Respectfully submitted,


Matt Burke 508.930.0974

On behalf of AT&T

- c/o Tower Resource Management, Inc. 16 Chestnut Street, Suite 220 Foxboro, MA 02035
- cc: Town of Essex, CT Macbeth Ventures, LLC

Exhibit 1

Site Plan

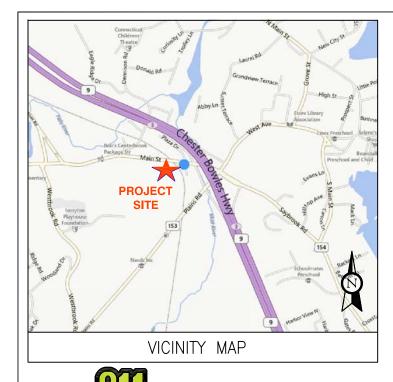

Know what's below.

Call before you dig.

THIS FACILITY SHALL MEET OR

EXCEED ALL FAA AND FCC REGULATORY REQUIREMENTS.



BACKUP POWER PROJECT

SITE IDENTIFICATION:

SITE NUMBER: 10035078

SITE NAME: ESSEX

SITE ADDRESS: 10 MAIN STREET ESSEX, CT 06426 $\mathbf{\overline{x}}$ PROJECT


SITE

CONTRACTOR TO VERIFY EXISTING MUX LOCATION. IF MUX LOCATION IS OUTSIDE OF AT&T EQUIPMENT AREA, CONTRACTOR IS TO FIELD VERIFY THE PRESENCE OF EMERGENCY BACK-UP SERVICE TO THE MUX. IF EMERCENCY BACK-UP SERVICE IS NOT PRESENT, CONTRACTOR IS TO ROUTE NEW SERVICE FROM AT&T EQUIPMENT AREA.

PROJECT DESCRIPTION:


THE PROPOSED PROJECT INCLUDES PLACING A 50 KW GENERATOR IN AN EXISTING CELLULAR TOWER COMPOUND.

ENGINEER: GEOGRAPHIC C ADVANCED ENGINEERING GROUP, P.C. LATITUDE: 500 NORTH BROADWAY LONGITUDE: EAST PROVIDENCE, RI 02914 LONGITUDE: TEL: 401–354–2403 APPLICANT: BUILDING CODE: AT&T MOBILITY 2009 INTERNATIONAL	11 280 2. 3. 3.		SHT NO: T-1	DESCRIPTION: TITLE SHEET, VICINITY MAP AND GENERAL INFORMATION
500 NORTH BROADWAY LONGITUDE: -72.406 EAST PROVIDENCE, RI 02914 TEL: 401-354-2403 APPLICANT: BUILDING CODE: AT&T MOBILITY 2009 INTERNATIONAL 550 COCHITUATE ROAD Store Continuate Road	280 2. 3.	A MONTH FOR ROUTINE INSPECTION AND MAINTENANCE. THE PROJECT WILL NOT RESULT IN ANY SIGNIFICANT		TITLE SHEET, VICINITY MAP AND GENERAL INFORMATION
APPLICANT: AT&T MOBILITY 550 COCHITUATE ROAD			H +	
AT&T MOBILITY 2009 INTERNATIONAL 550 COCHITUATE ROAD	BUILDING CODE	LAND DISTURDANCE OR EFFECT OF STORM WATER	A-1	COMPOUND PLAN
		DRAINAGE.	A-2	CONCRETE PAD DETAILS
SUITES 13 & 14 FRAMINGHAM, MA 01701	4.	NO SANITARY SEWER, POTABLE WATER OR TRASH DISPOSAL AS REQUIRED.	E-1	WIRING DIAGRAM & SIZING CHARTS
CUSTOMER REPRESENTATIVE:	5.		E-2	ELECTRICAL & ATS MOUNTING DETAILS
SABRE INDUSTRIES PEGGY POOR	о. 		G-1	GROUNDING DETAILS
MARKET LEAD – AT&T NE GENERATOR PROGRAM 13010 MORRIS ROAD, 6TH FLOOR, BLDG 1		PROJECT LOCATION DIRECTIONS		
ALPHARETTA, GA 30004				
CELL 770–990–0137		HEAD WEST ON COCHITUATE RD TOWARD BURR ST TAKE THE 1ST RIGHT ONTO BURR ST		
LANDLORD: MACBETH VENTURES, LLC C/O REALTY CONCEPTS	3. N	MAKE A U-TURN AT LEGGAT MCCALL CONN TURN LEFT ONTO COCHITUATE RD		
2514 BOSTON POST ROAD, 9C GUILFORD, CT 06437	5. T	TAKE THE RAMP TO I-90 E/MASSPIKE		
	6. K	/SPRINGFIELD/BOSTON KEEP LEFT AT THE FORK, FOLLOW SIGNS FOR		
UTILITIES: POWER COMPANY:		TERSTATE 90 W/MASSACHUSETTS JRNPIKE/WORCHESTER/SPRINGFIELD AND MERGE ONTO		
NORTHEAST UTILITIES (NU) P.O. BOX 270		90 W/MASSACHUSETTS TURNPIKE ARTIAL TOLL ROAD		
HARTFORD, CT 06141–0270 PHONE: 1–800–286–5000	7. т	TAKE EXIT 10 TOWARD AUBURN/WORCESTER		
FRUNE: 1-000-200-5000	8. F	FOLLOW SIGNS FOR US-20 E/I-395 S AND MERGE		
	PAR	ATTAL TOLL ROAD ITERING CONNECTICUT		
	9. N	MERGE ONTO I-95 S J. TAKE EXIT 69 TO MERGE ONTO CT-9 N TOWARD		
	ESSI	SEX/HARTFORD		
	CT-	. TAKE EXIT 3 FOR CT-154 TOWARD I-153/ESSEX/CENTERBROOK		
	12.	2. TURN LEFT ONTO CT-154 N/MIDDLESEX		

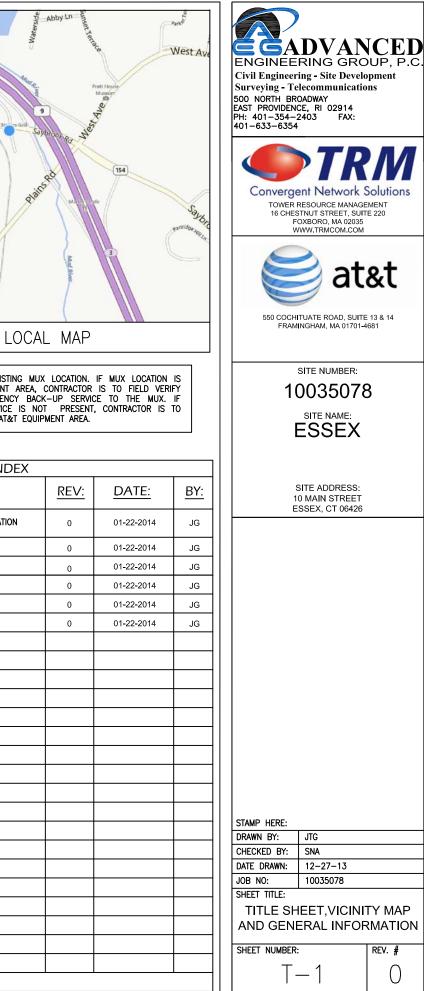

CONTRACTOR TO VERIFY EXISTING MUX LOCATION. IF MUX LOCATION IS OUTSIDE OF AT&T EQUIPMENT AREA, CONTRACTOR IS TO FIELD VERIFY THE PRESENCE OF EMERGENCY BACK-UP SERVICE TO THE MUX. IF EMERGENCY BACK-UP SERVICE IS NOT PRESENT, CONTRACTOR IS TO ROUTE NEW SERVICE FROM AT&T EQUIPMENT AREA.


NOTE:

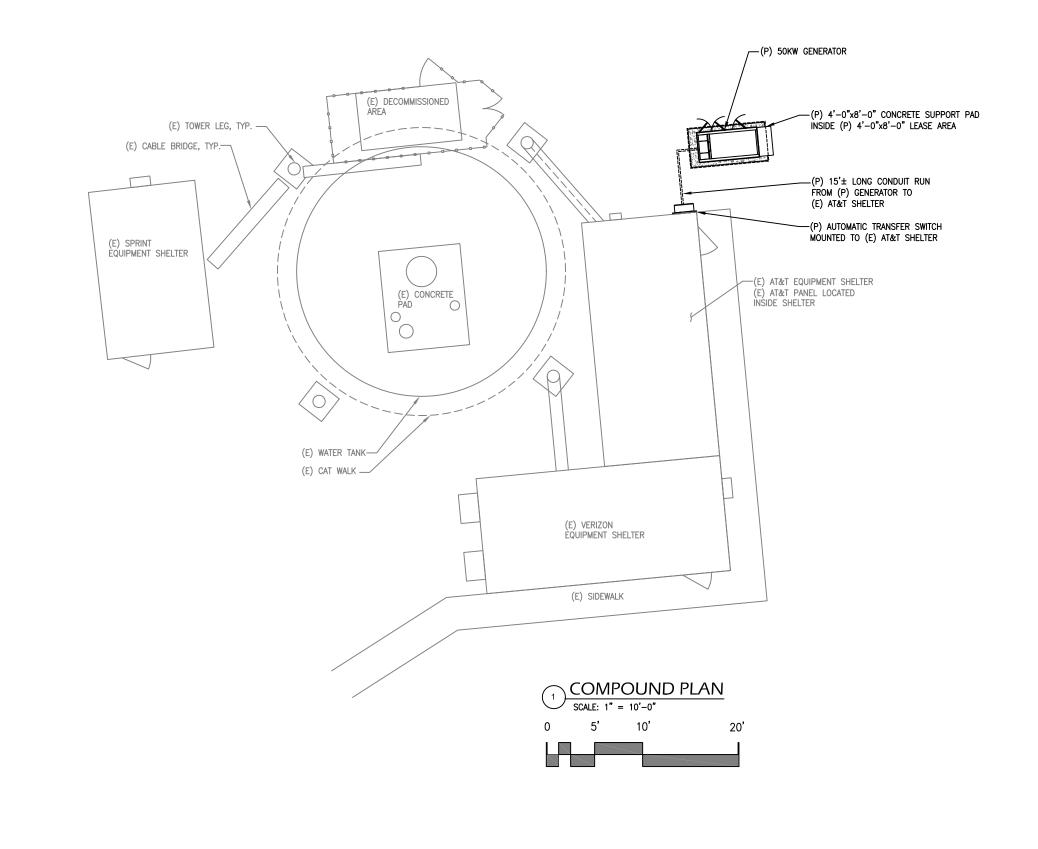

A SITE VISIT/SURVEY WAS NOT CONDUCTED BY ADVANCED ENGINEERING GROUP, P.C. SITE INFORMATION AND PLANS ARE BASED UPON INFORMATION PROVIDED BY CLIENT



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CONVERGENT NETWORK Solutions TWE RESOURCE MANAGEMENT 19 CHESTNUT STREET, SUITE 220 FOXBORO, MA 02035 WWW.TRMCOM.COM SUITE NUMBER: 10035078 SITE NUMBER: 10035078 SITE ADDRESS: 10 MAIN STREET ESSEX, CT 06426 STAMP HERE: DRAWN BY: JTG CHECKED BY: SNA DATE DRAWN: 12–27–13 JOB NO: 10035078 SHEET TITLE: COMPOUND PLAN SHEET NUMBER: REV. #	500 NORTH BROADWAY EAST PROVIDENCE, RI 02914 PH: 401-354-2403 EAX
STAMP HERE: DRAWN BY: JTG CHECKED BY: SNA DATE DRAWN: 12-27-13 JOB NO: 10035078 SHEET NUMBER: REV. #	Convergent Network Solutions TOWER RESOURCE MANAGEMENT 16 CHESTNUT STREET, SUITE 220 FOXBORO, MA 02035
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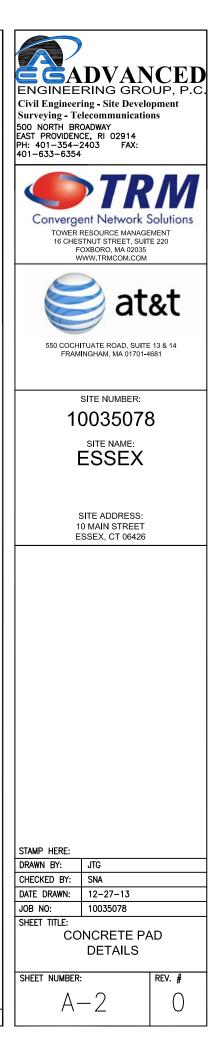


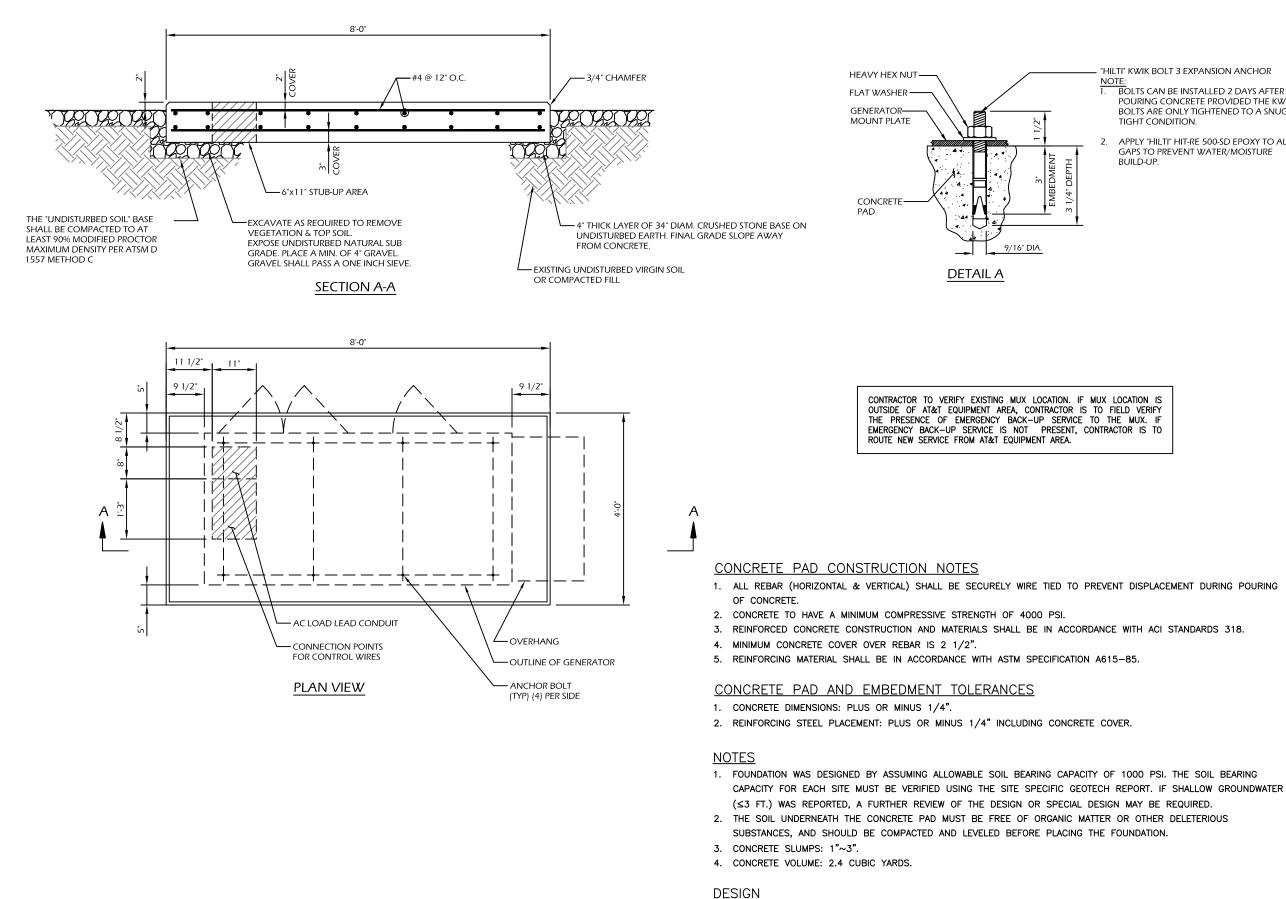
1. MAXIMUM DESIGN BASIC WIND SPEED (3-SECOND GUST): 155 MPH FOR GENERATOR MODELS SD050 AND SD080.

"HILTI" KWIK BOLT 3 EXPANSION ANCHOR

BOLTS CAN BE INSTALLED 2 DAYS AFTER POURING CONCRETE PROVIDED THE KWIK BOLTS ARE ONLY TIGHTENED TO A SNUG TIGHT CONDITION.

APPLY "HILTI" HIT-RE 500-SD EPOXY TO ALL GAPS TO PREVENT WATER/MOISTURE



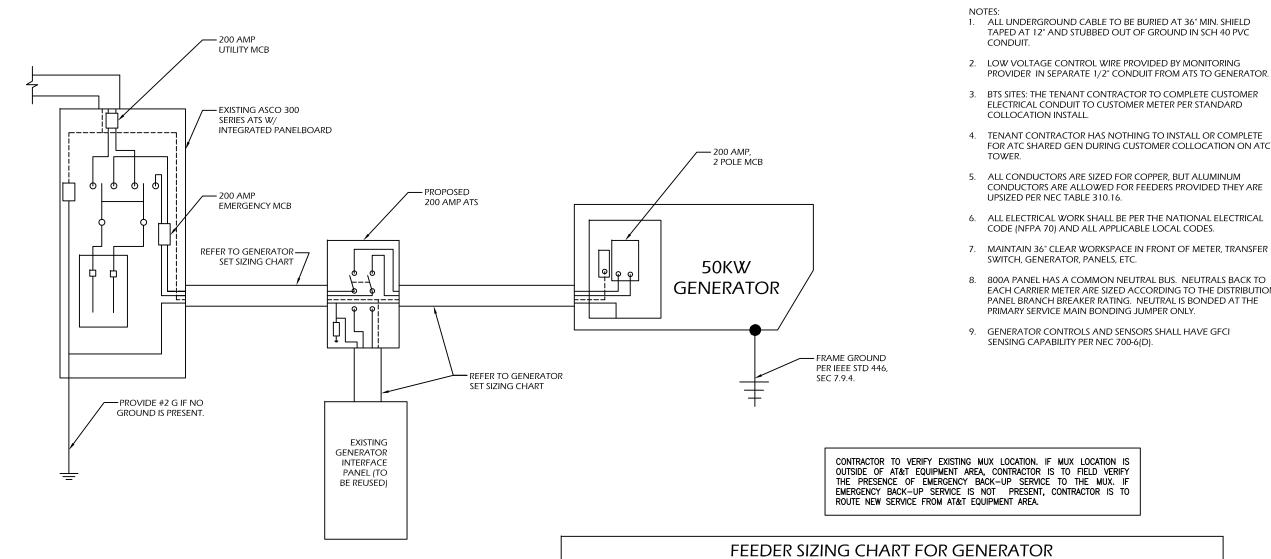

SINGLE CARRIER WIRING DIAGRAM SCALE: NOT TO SCALE

T LEDER SIZING CHART FOR GENERATOR					
GEN SET SIZE	VOLTS - PHASE	PRIME RATING KW - AMPS	SIZE OF INLINE BREAKER (AT GENERATOR)	MAIN BREAKER SIZE SERVING ANCHOR TENANT:	FEEDER SIZES FROM C BREAKER TO DISTRIBL PANEL / ATS.
50KW	120/240V - 1-PH	48KW - 200A	200A	200A 2-P C/B INTEGRAL TO GEN SET	3#3/0, 1#6G, IN 2"C

NOTES:

1. SERVICE VOLTAGE FOR EACH CARRIER IS 120/240 1-PHASE, AND SERVICE SIZES ARE TYPICAL 200A PER CARRIER.

2. DISTRIBUTION PANEL IS 800A, 120/240V 1-PHASE, WITH 200A C/B FOR THE LISTED CARRIER OUTPUT. PANEL HAS (3) 200A BREAKER SPACES FOR FUTURE CARRIERS.

3. AUTOMATIC TRANSFER SWITCH (ATS) ARE 200A 2-POLES, 120/240V 1-PHASE WITH SOLID NEUTRAL PER CARRIER.

4. ALL ELECTRICAL EQUIPMENT IS NEMÁ 3R RATED.

5. THE GENERATOR ELECTRICAL LOADS ARE ADEQUATE FOR THE CONNECTED LOADS.

- ALL EQUIPMENT FURNISHED SHALL BE PROVIDED WITH EQUIPMENT RATED TO WITHSTAND FAULT CURRENT AVAILABLE AT PROJECT SITE.
 ALL WIRE AND PANEL BUSSING SHALL BE COPPER UNLESS ALLOWED ELSEWHERE IN THIS DOCUMENT SET, WIRE SIZES ARE BASED ON COPPER.

8. A NEW SET OF PLANS WILL BE PROVIDED AND SUBMITTED FOR ADDITIONAL CARRIERS.

9. ALL WORK SHALL CONFORM WITH THE CURRENT VERSION OF THE NEC AND ALL OTHER APPLICABLE CODES. 10. FIRST OVER-CURRENT PROTECTION DEVICE IS INTEGRAL TO GENERATOR. FEEDER SIZES INDICATED IN TABLE ABOVE ARE DOWNSTREAM OF THE FIRST OVER-CURRENT PROTECTION DEVICE.

11. INLINE BREAKER AT GENERATOR IS FACTORY INSTALLED, AND IS THE MANUFACTURER'S RECOMMENDED SIZE.




BE BURIED AT 36" MIN. SHIELD	C
JT OF GROUND IN SCH 40 PV0	2


FOR ATC SHARED GEN DURING CUSTOMER COLLOCATION ON ATC

EACH CARRIER METER ARE SIZED ACCORDING TO THE DISTRIBUTION


OM GEN SET RIBUTION

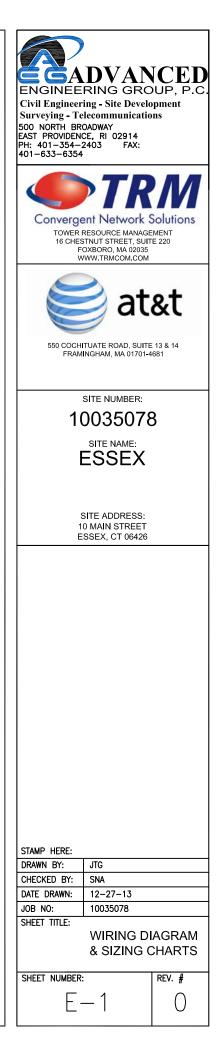

NOTE: UTILITY POWER FEEDS SHALL BE CONNECTED TO THE TRANSFER SWITCH FROM THE LOAD SIDE OF THE EXISTING SERVICE DISCONNECT. NO MODIFICATIONS SHALL BE MADE ON THE LINE SIDE OF THE EXISTING SERVICE DISCONNECT.

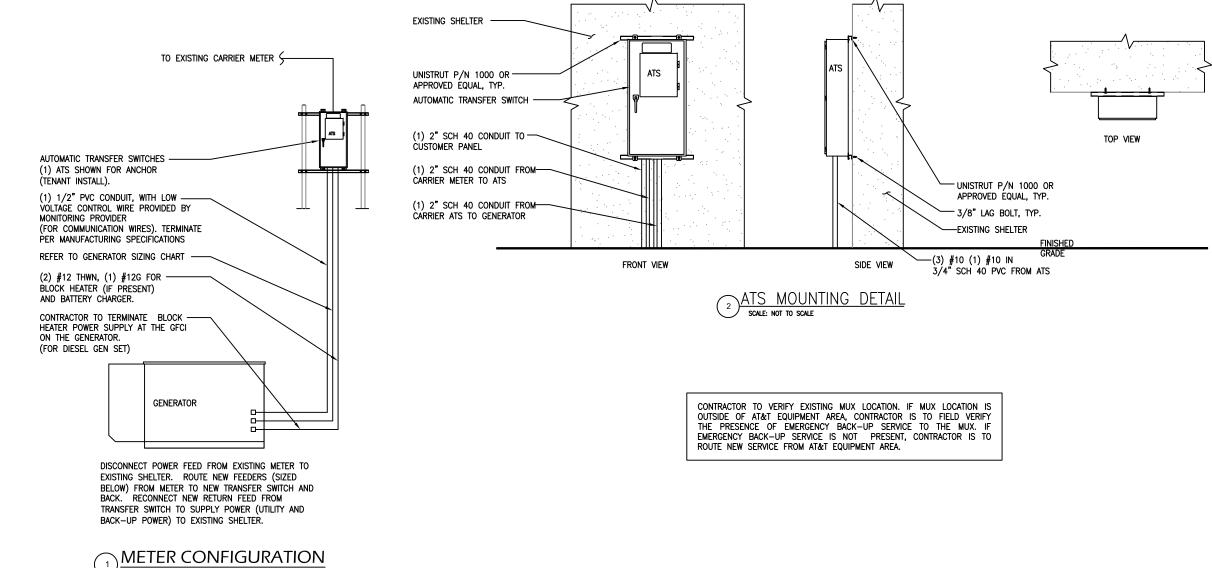

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ENGINEERING GRC Civil Engineering - Site Develo Surveying - Telecommunicatio 500 NORTH BROADWAY EAST PROVIDENCE, RI 02914 PH: 401-354-2403 FAX: 401-633-6354	OUP, P.C.
Convergent Network S TOWER RESOURCE MANAGE 16 CHESTNUT STREET, SUIT FOXBORO, MA 02035 WWW.TRMCOM.COM	Solutions
550 COCHITUATE ROAD, SUITE FRAMINGHAM, MA 01701-4	13 & 14
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CONTRACTOR TO HAND DIG ALL NEW TRENCHES

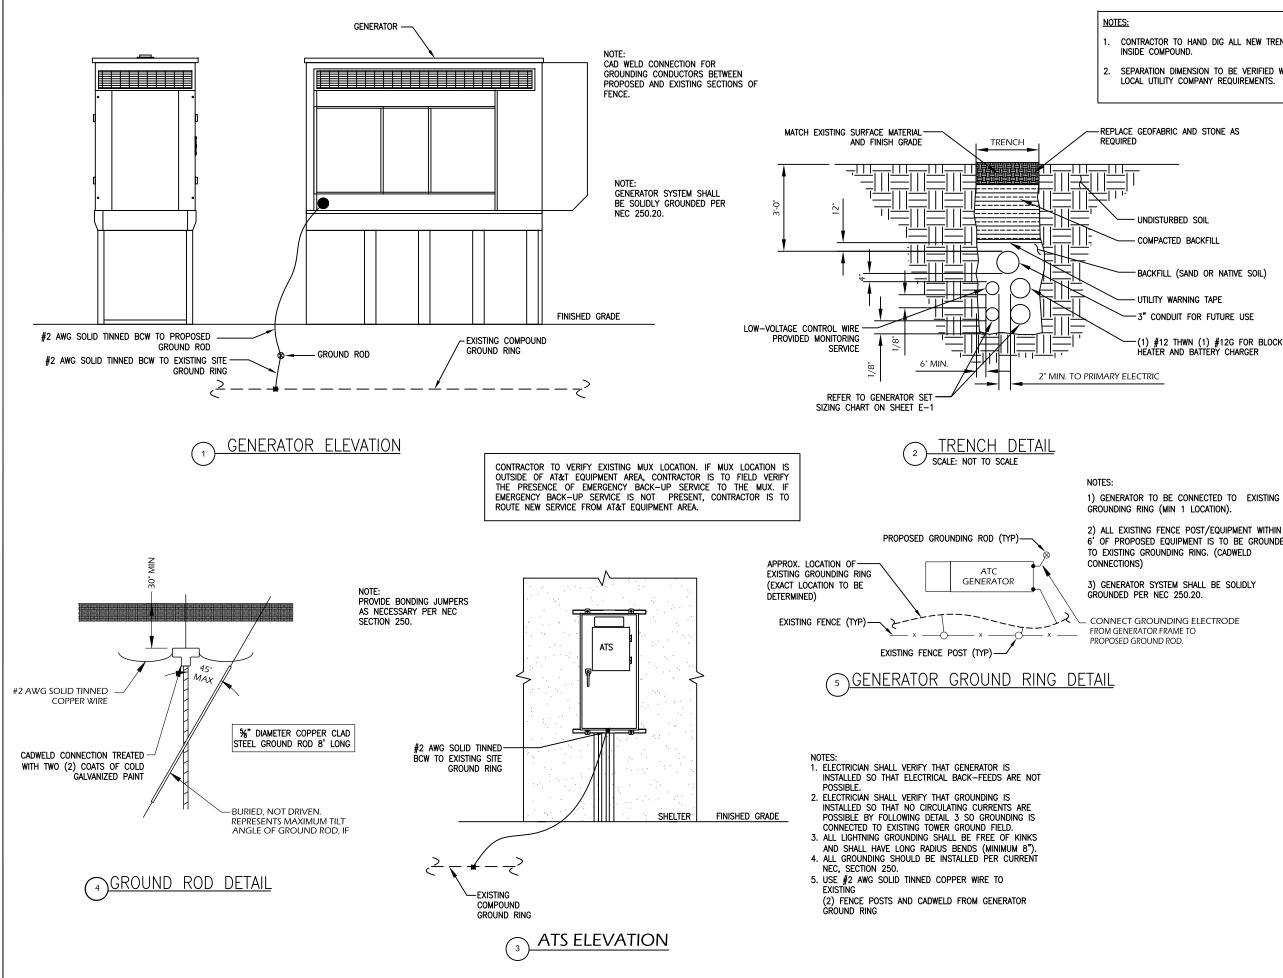2. SEPARATION DIMENSION TO BE VERIFIED WITH LOCAL UTILITY COMPANY REQUIREMENTS.

REPLACE GEOFABRIC AND STONE AS

UNDISTURBED SOIL

COMPACTED BACKFILL

BACKFILL (SAND OR NATIVE SOIL)

- UTILITY WARNING TAPE - 3" CONDUIT FOR FUTURE USE

(1) #12 THWN (1) #12G FOR BLOCK HEATER AND BATTERY CHARGER

1) GENERATOR TO BE CONNECTED TO EXISTING GROUNDING RING (MIN 1 LOCATION).

6' OF PROPOSED EQUIPMENT IS TO BE GROUNDED TO EXISTING GROUNDING RING. (CADWELD

3) GENERATOR SYSTEM SHALL BE SOLIDLY

