PROJECT 2203 - 700 EAST BROADWAY, MILFORD, CT

COMMUNITY DEVELOPMENT BLOCK GRANT DISASTER RECOVERY PROGRAM OWNER OCCUPIED REHABILITATION AND REBUILDING CONNECTICUT DEPARTMENT OF HOUSING HARTFORD, CONNECTICUT 06118

GENERAL NOTES:

- 1. WHERE REFERENCED IN THIS PLAN SET, MARTINEZ COUCH & ASSOCIATES, LLC SHALL HEREIN BE REFERRED TO AS "MCA."
- THE CONTRACTOR SHALL ABIDE BY ALL OSHA, FEDERAL, STATE, AND LOCAL REGULATIONS.
- THE CONTRACTOR SHALL POST ALL BONDS, PAY ALL FEES, PROVIDE PROOF OF INSURANCE, AND PROVIDE TRAFFIC CONTROL NECESSARY FOR THIS WORK.
 THE CONTRACTOR SHALL VERIFY ALL SITE CONDITIONS IN THE FIELD AND CONTACT MCA IF THERE ARE ANY QUESTIONS OR CONFLICTS REGARDING THE CONSTRUCTION DOCUMENTS AND/OR FIELD CONDITIONS, SO THAT APPROPRIATE REVISIONS CAN BE MADE PRIOR TO BIDDING. ANY CONFLICT BETWEEN THE DRAWINGS AND
- SPECIFICATIONS SHALL BE CONFIRMED WITH MCA PRIOR TO BIDDING.

 5. REFER TO OTHER PLANS, DETAILS, AND PROJECT MANUAL FOR ADDITIONAL INFORMATION.

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STREET VIEW

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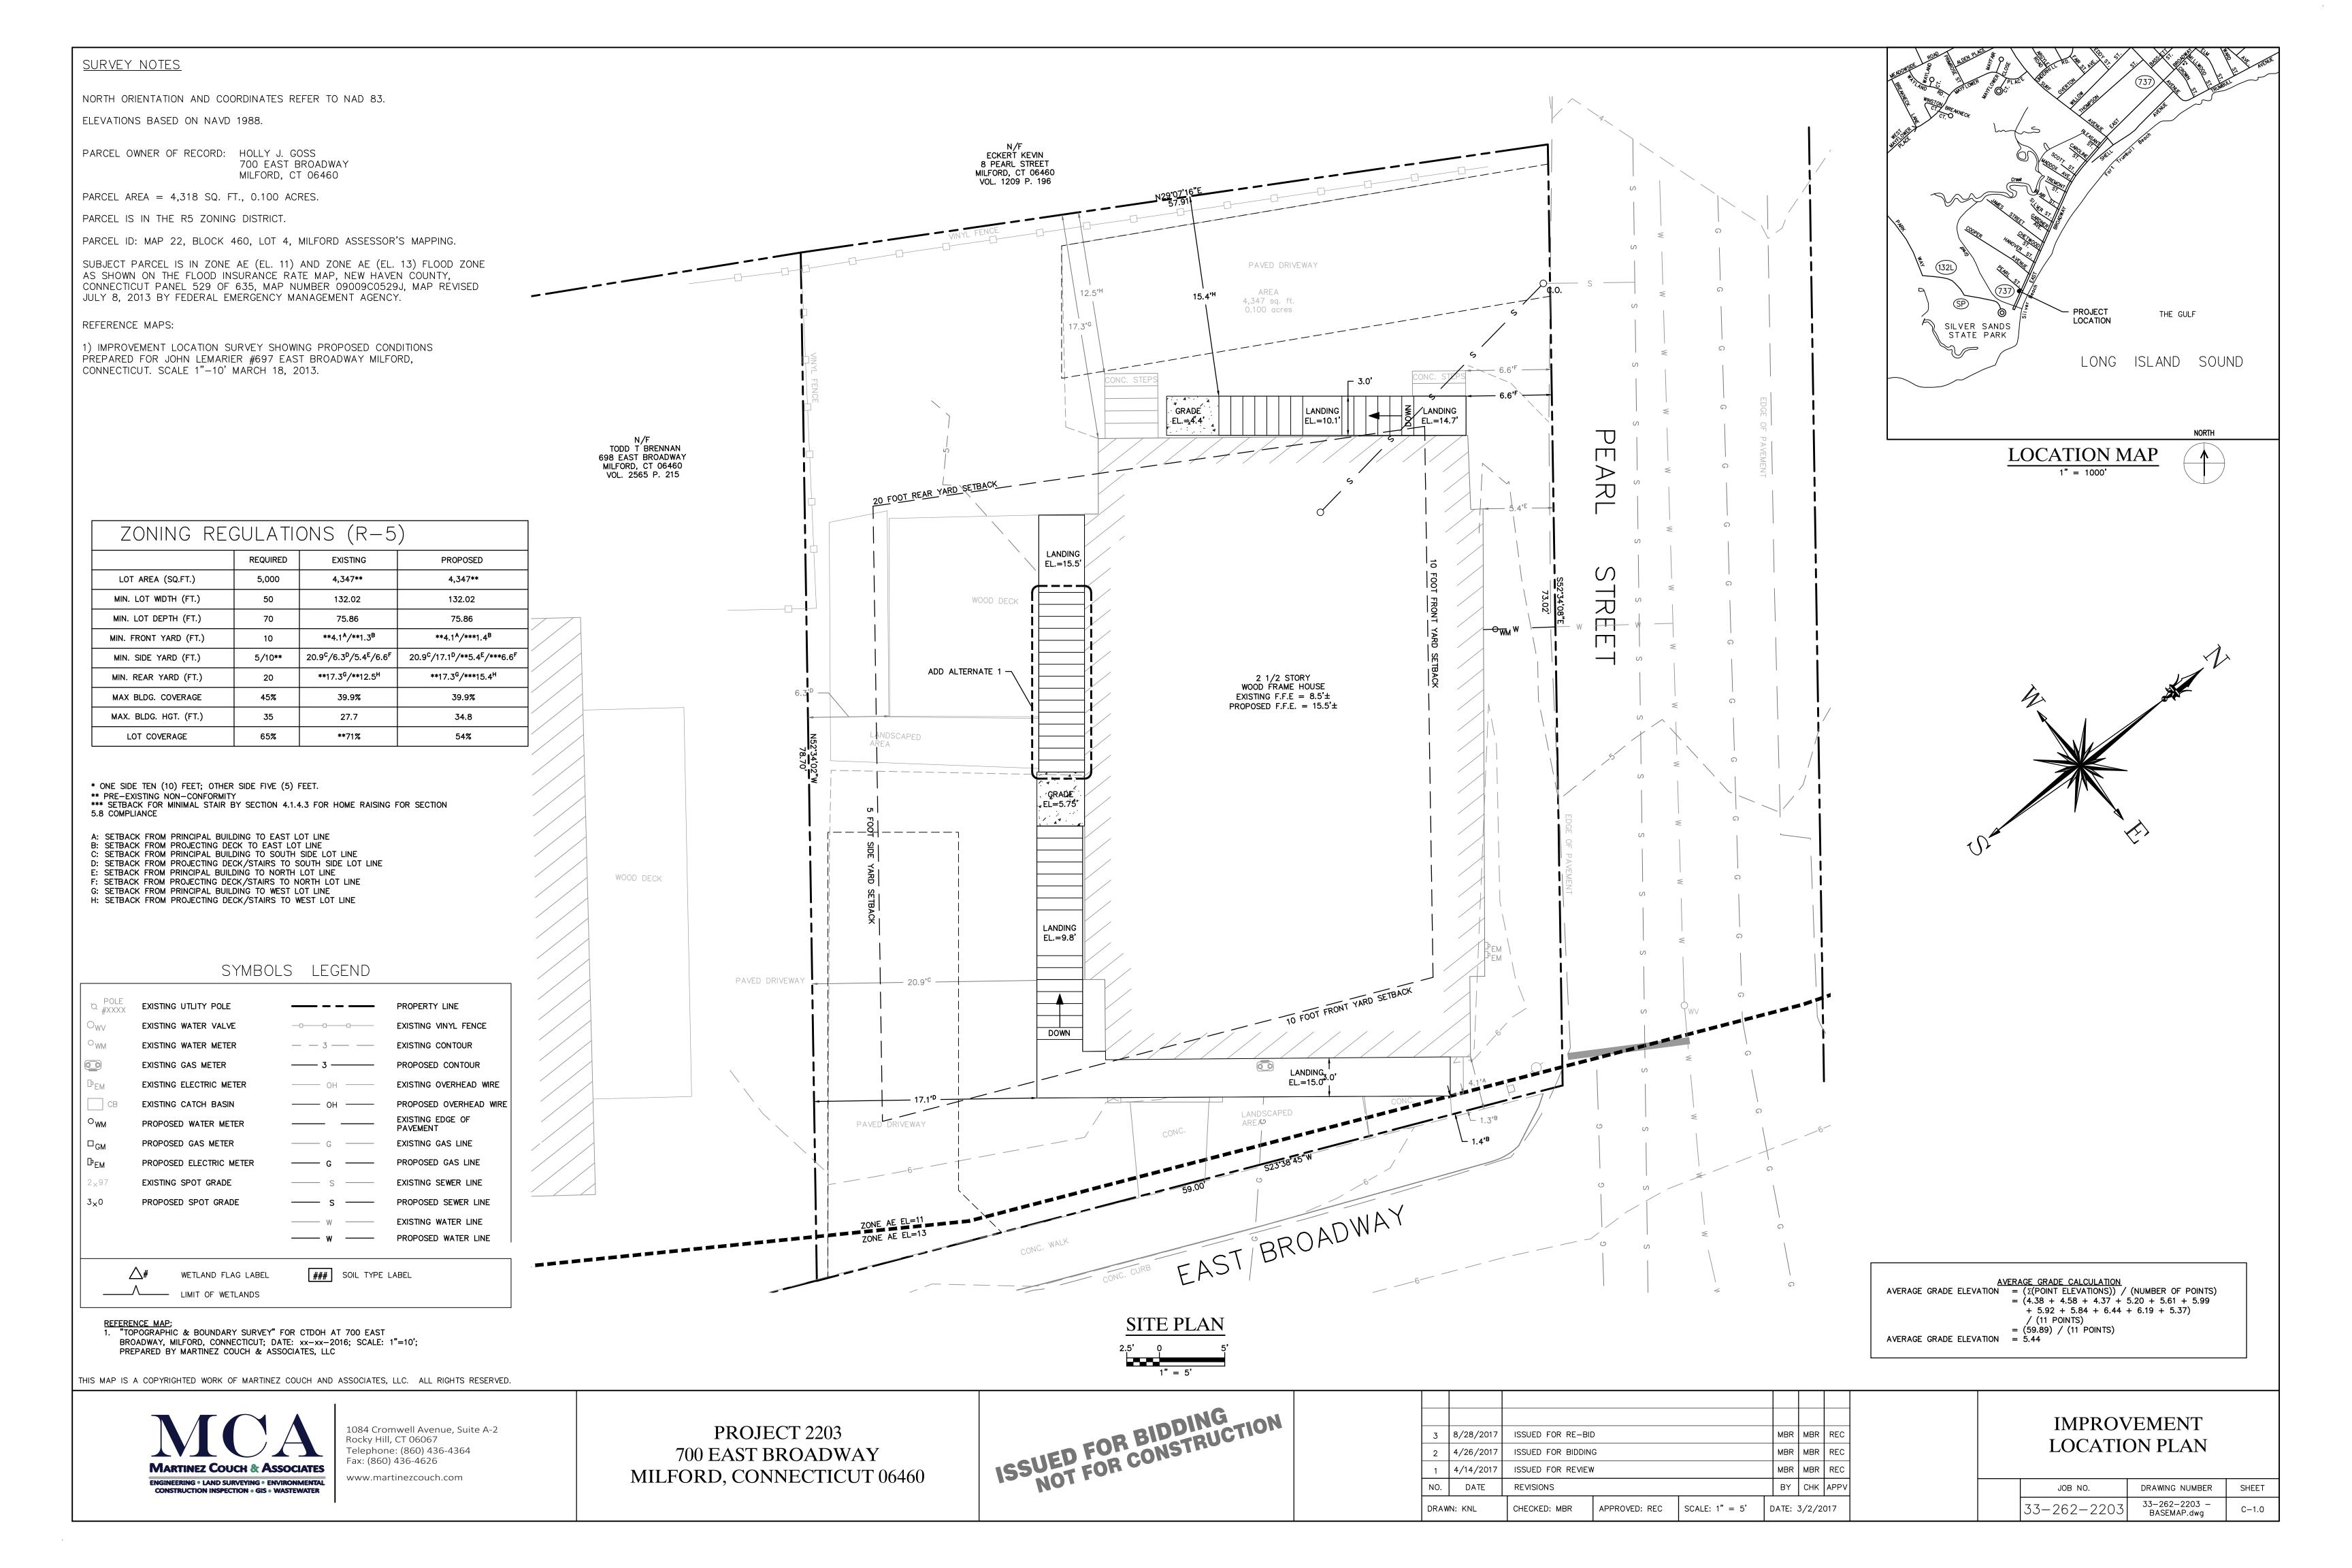
1084 Cromwell Avenue, Suite A-2 Rocky Hill, CT 06067 Telephone: (860) 436-4364 Fax: (860) 436-4626 PROJECT 2203 700 EAST BROADWAY MILFORD, CONNECTICUT 06460





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1	4/14/2017	ISSUED FOR REVIEW	V		МЕ	3R	MBR	REC
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TITLE SHEET

JOB NO.	DRAWING NUMBER	SHEET
33-262-2203	33-262-2203 - BASEMAP.dwg	T-0.0





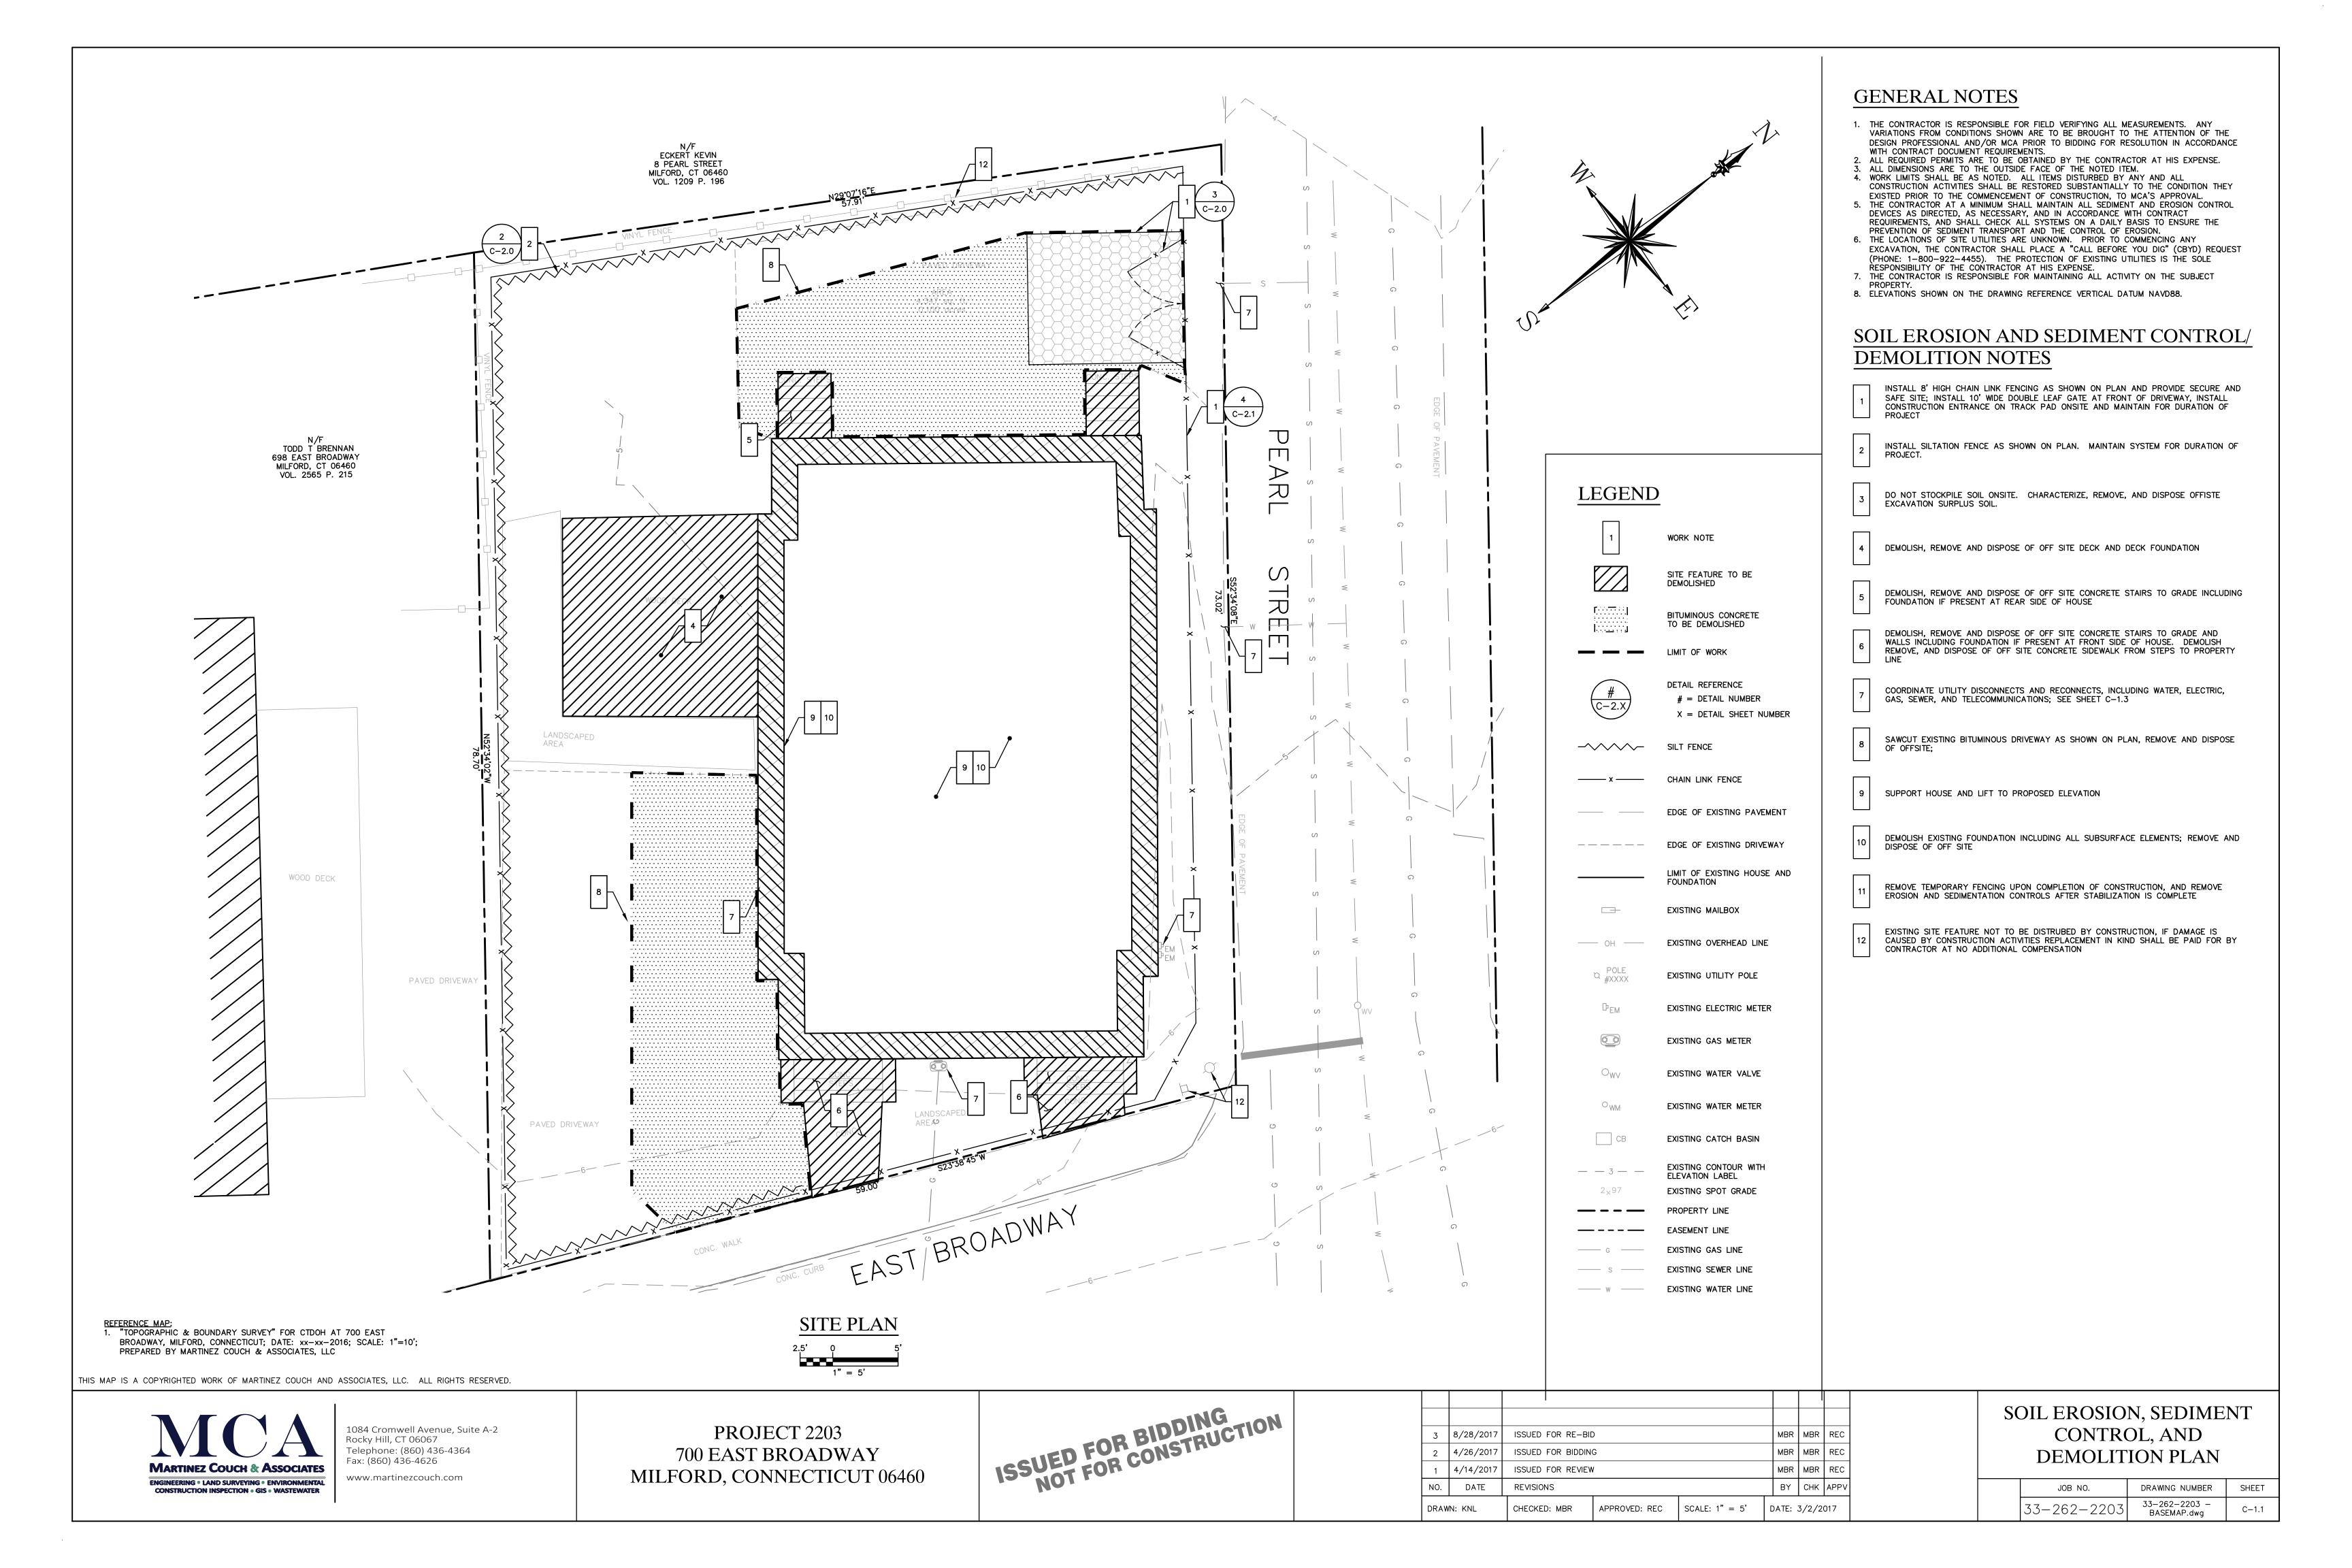

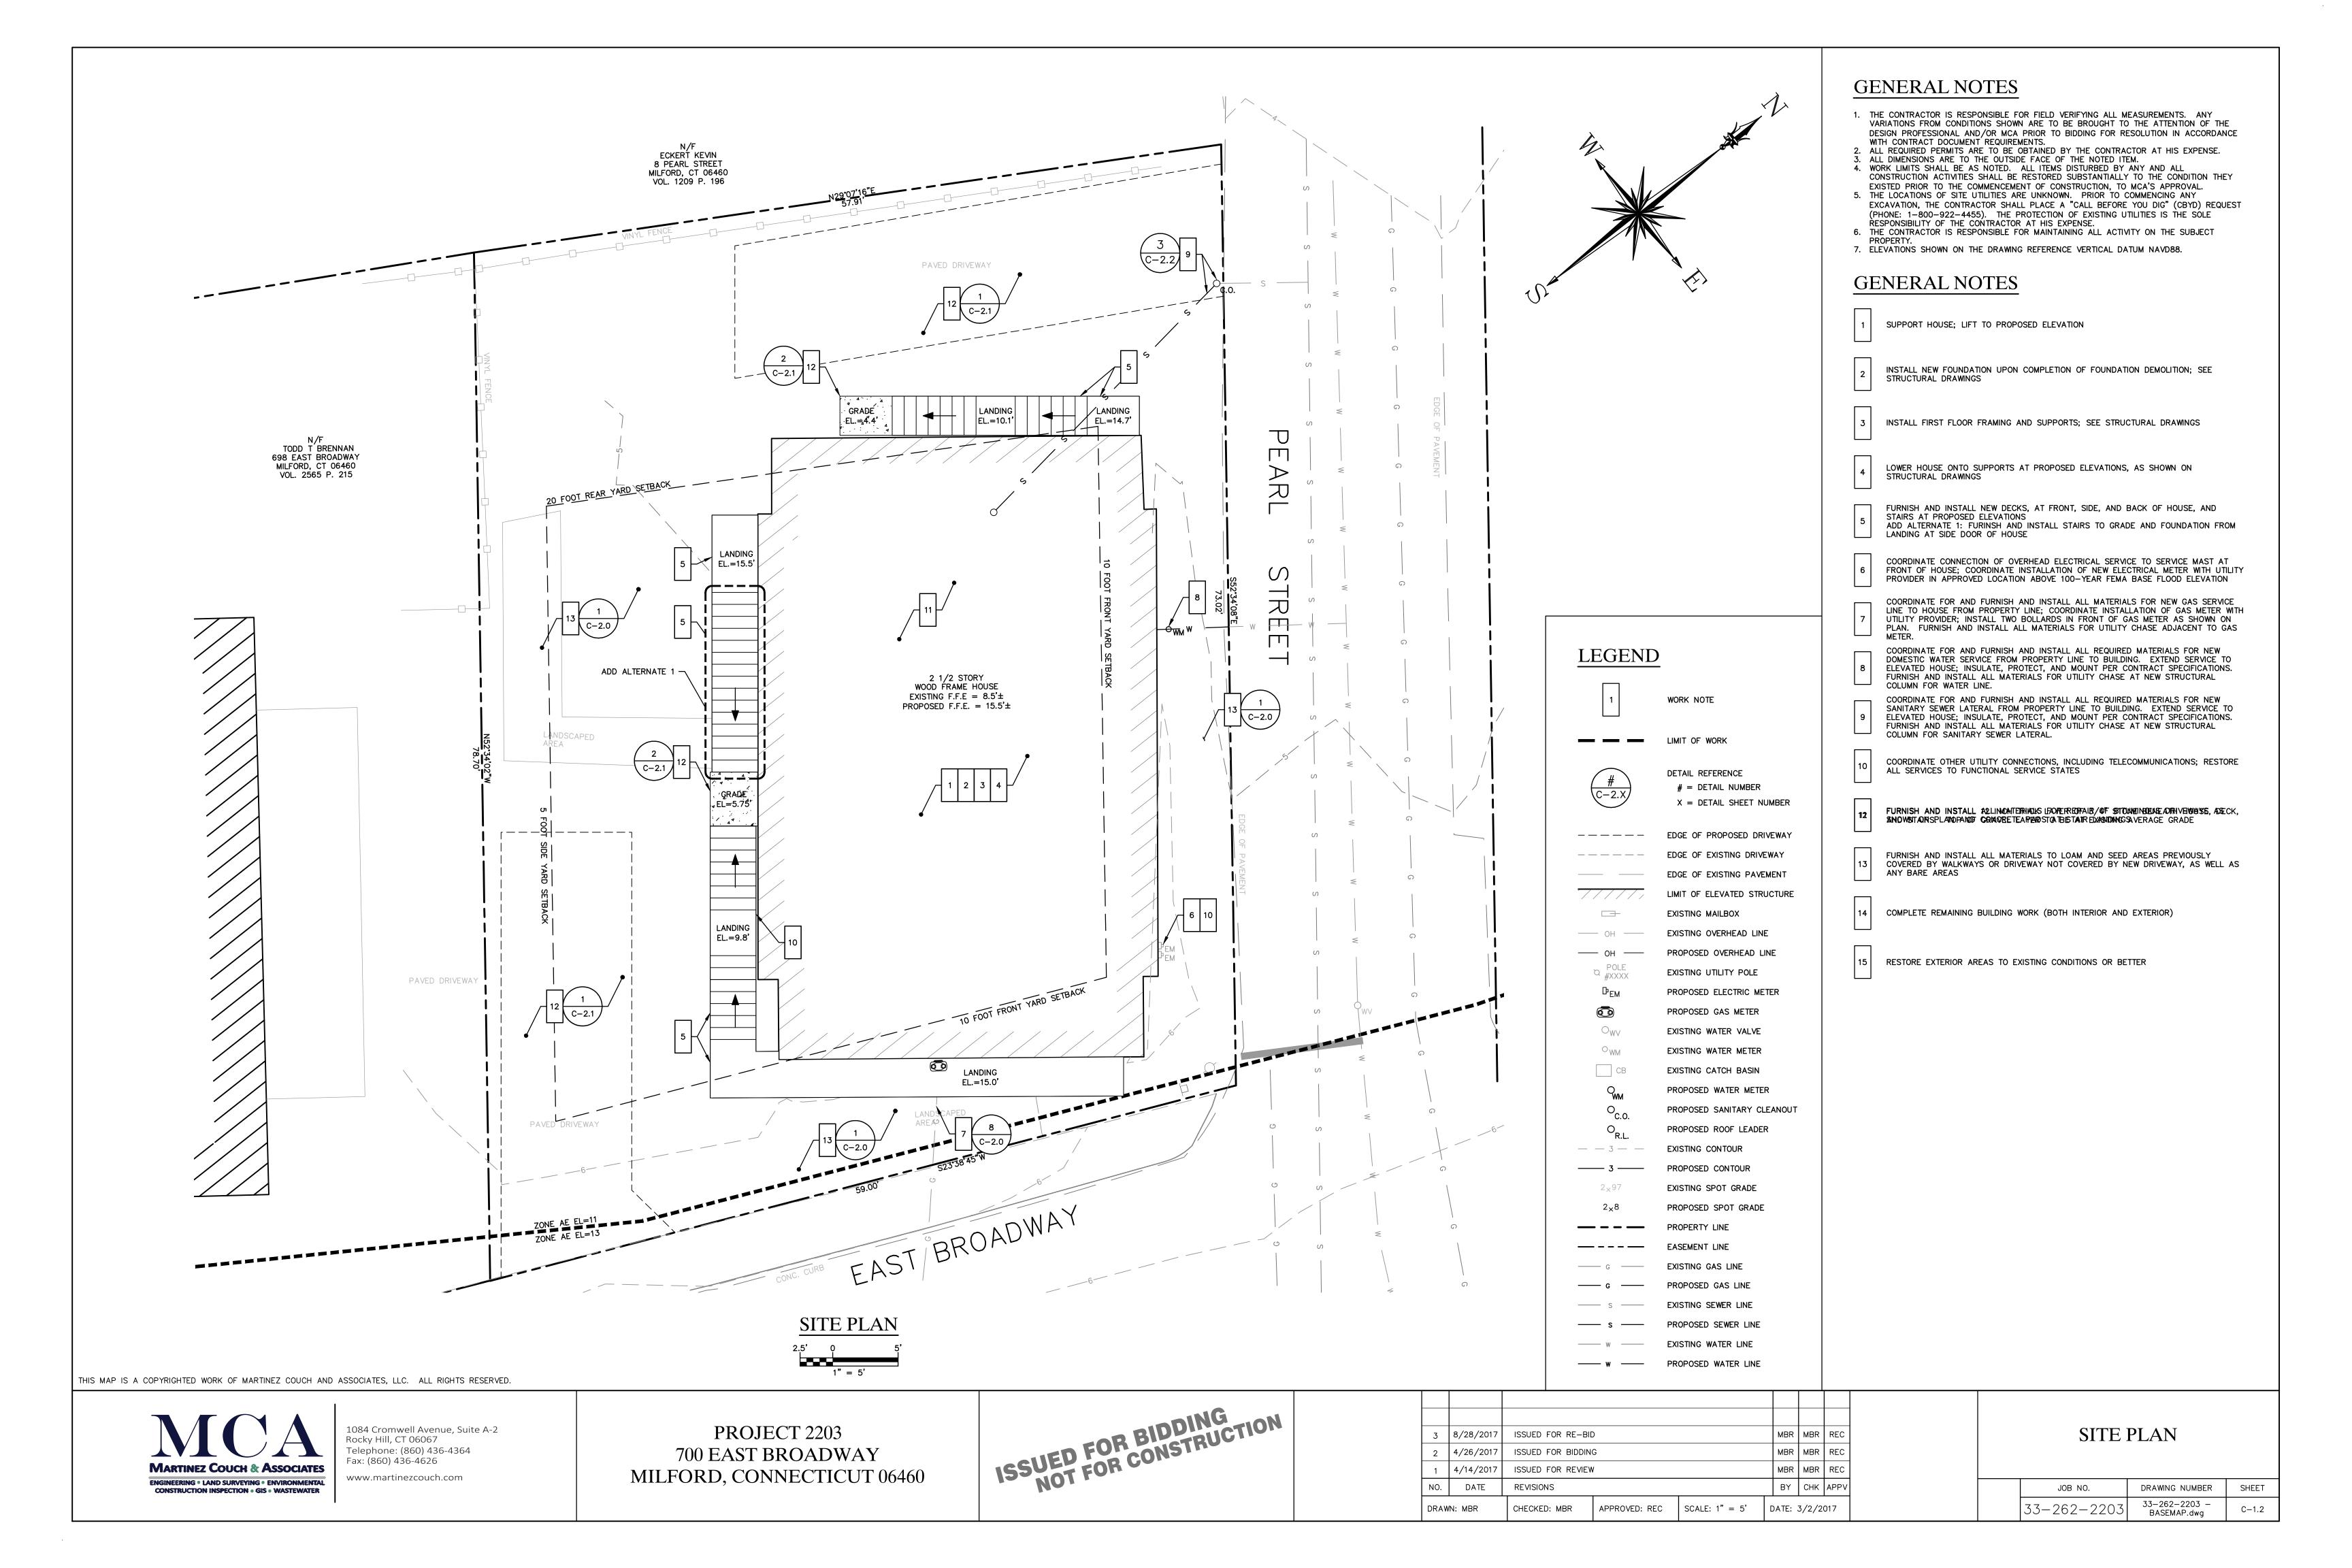SEEDING SCHEDULE

PERMANENT SEEDING SHALL BE ACCOMPLISHED WITH ONE OF THE FOLLOWING SEEDING MIXTURES:

KIND OF AREA:

LAWNS AND HIGH MAINTENANCE AREAS SEED MIXTURE LBS/ACRE LBS/1,000 SQ.FT. KENTUCKY BLUEGRASS 0.45 CREEPING RED FESCUE 0.45 PERENNIAL RYEGRASS

TEMPORARY SEEDING RATES AND DATES

SEED MIXTURE ANNUAL RYEGRASS 40

DATE (1)(3) DEPTH (2) 8/1-10/1 0.5 INCHES 1.0 3/1-6/15

(1) MAY BE PLANTED THROUGHOUT SUMMER IF SOIL IS ADEQUATE OR CAN BE IRRIGATED. (2) SEED AT TWICE THE INDICATED DEPTH FOR SANDY SOILS.

SOURCE: U.S. DEPARTMENT OF AGRICULTURE, SOIL CONSERVATION SERVICE, STORRS, CT


ORGANIC MULCH MATERIALS AND APPLICATION RATES

PER ACRE PER 1,000 SQ.FT. NOTES

STRAW OR HAY 1/2-2 TONS 70-90 LBS FREE FROM MATTER AND COURSE

MATTER. MUST BE ANCHORED. SPREAD WITH MULCH BLOWER OR BY HAND.

TYPICAL SEEDING SCHEDULE

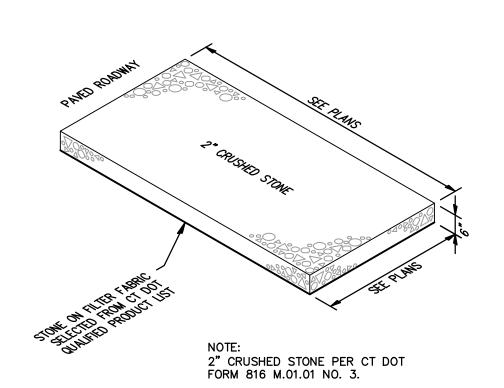



TYPICAL CONSTRUCTION TRACKPAD

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PROJECT 2203 700 EAST BROADWAY MILFORD, CONNECTICUT 06460



3	8/28/2017	ISSUED FOR RE-BIL)		MBR	MBR	REC
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STAKE 42 " MIN. (TYP.) —

FILTER FABRIC (TYP.) —

UPSLOPE FOR STABILITY AND

SELF CLEANING.

WOOD STAKE 42"

FILTER FABRIC

DRAINAGEWAY

PLAN VIEW

MINIMUM (TYPICAL)

TRENCH AND

COMPACT THE

POINTS "A" SHOULD BE HIGHER THAN POINT "B"

ELEVATION

EXCAVATED SOIL.

TYPICAL SILTATION FENCE

A) MINIMUM LENGTH OF SILT FENCE IS 15 L.F.

C) JOINTS ONLY AT SUPPORT POST WITH MINIMUM

D) SEDIMENTATION DEPOSITS SHALL BE REMOVED

E) SILT FENCE SHALL NOT BE USED IN A WATER

F) UPON ESTABLISHMENT OF GROUND COVER

ON DISTURBED AREAS, AND WHEN DIRECTED BY THE ENGINEER, FENCE WILL BE REMOVED

AND ANY SEDIMENTATION WILL BE THINLY

SPREAD UPON EXISTING GROUND COVER.

WHEN THEY REACH 1/2 THE HEIGHT OF THE SILT

B) MAXIMUM POST SPACING IS 10 L.F.


6" OVERLAP, SECURELY SEALED.

FENCE.


COURSE.

SOIL EROSION AND SEDIMENT CONTROL DETAILS

DRAWING NUMBER SHEET 33-262-2203 -BASEMAP.dwg 33-262-2203

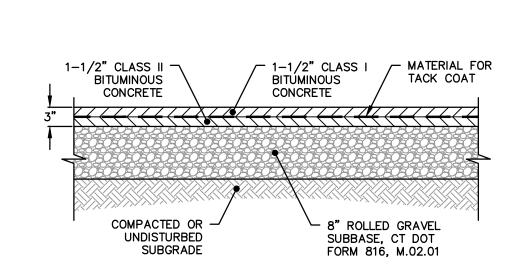



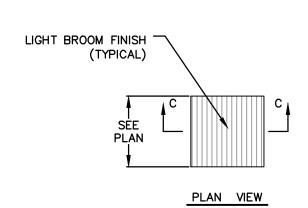


NOTES:

1. MATERIALS, METHODS OF INSTALLATION, CURING, TESTING, SHALL CONFORM TO "STATE OF CT DEPARTMENT OF TRANSPORTATION STANDARD SPECIFICATIONS FORM 816 OR CURRENT SPECIFICATION FOR SUCH WORK.

2. ANY WALKING SURFACE SHALL BE LIGHTLY BROOMED PERPENDICULAR TO THE TRAVEL


WAY.

MIRE MESH SHALL BE PLACED 2 1/2"
BELOW THE SIDEWALK SURFACE. MATERIAL
SHALL BE 6"x6"-W6.0xW6.0 AND IN
ACCORDANCE WITH ASTM 185 (AASHTO
M55),AS SHOWN ON THE PLANS OR AS
DIRECTED. WIRE MESH TO BE USED IN ALL
SIDEWALK APPLICATIONS.

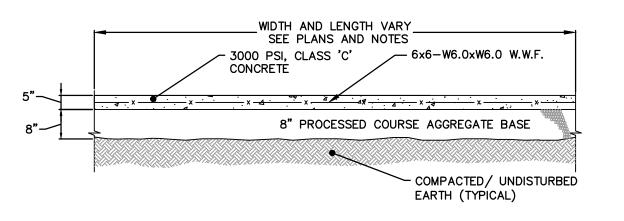


2 TYPICAL CONCRETE STAIR LANDING C-2.1 N.T.S.

SECTION C-C

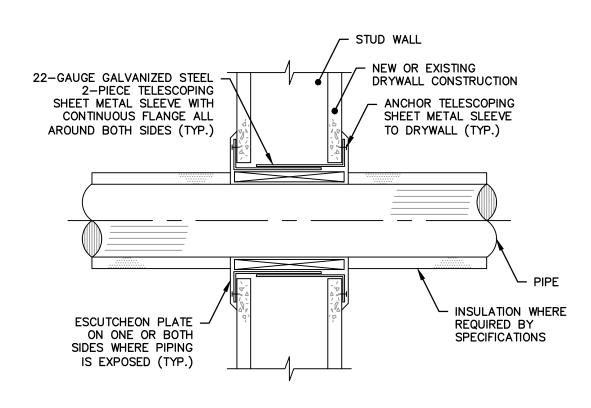

TYPICAL WALL/FLOOR PENETRATION
C-2.1 N.T.S.

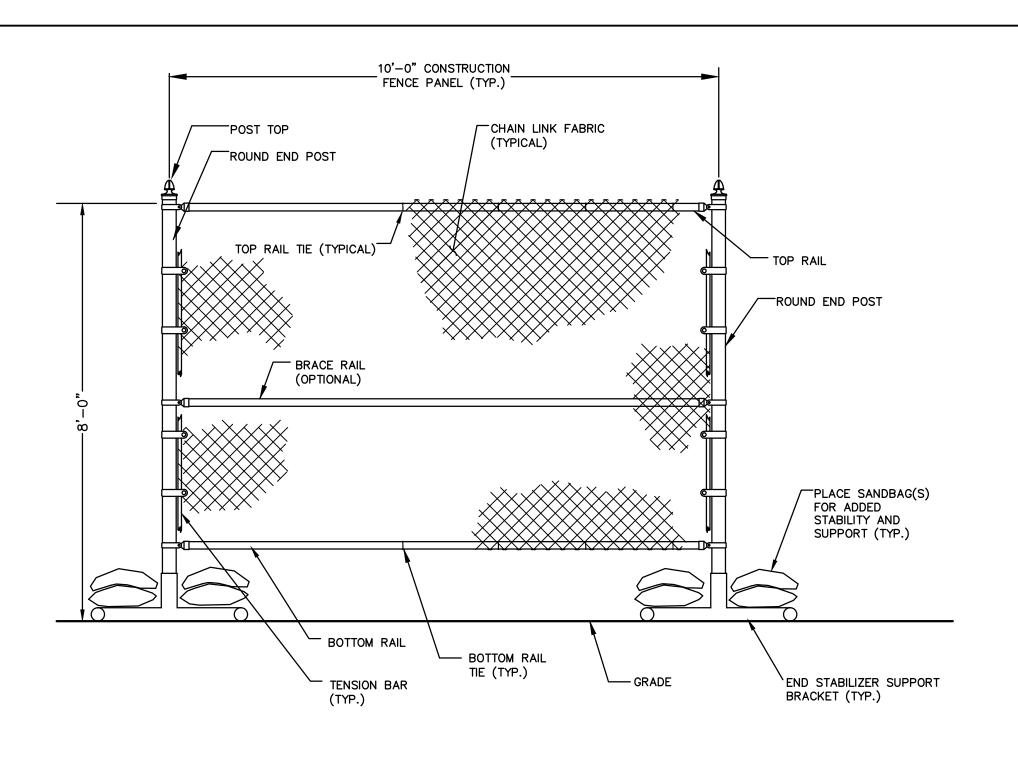

TYPICAL PORTABLE CONSTRUCTION CHAIN LINK FENCE


Output

Output

Output

Description

Output

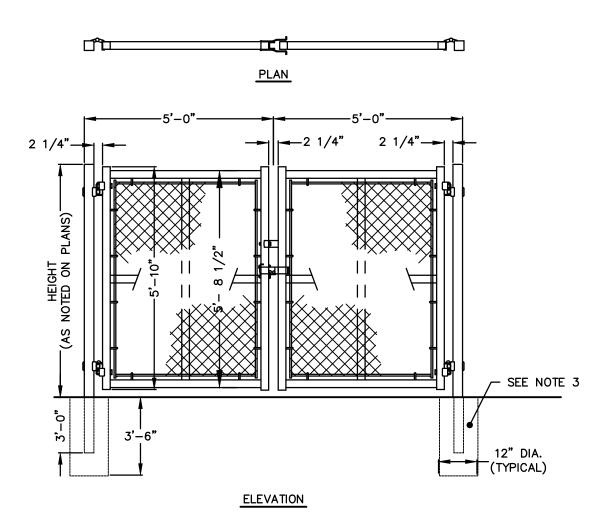

NOTES:
1. GATES SHOULD OPEN TOWARD SITE, AWAY FROM STREET.
2. GATES SHALL HAVE LOCKING MECHANISM THAT CAN BE PADLOCKED.
3. METAL TRIPODS MAY BE USED FOR BOTTOM SUPPORTS INSTEAD OF MOUNTING INTO THE GROUND.
4. MATERIALS, METHODS OF INSTALLATION SHALL BE CONFORM TO "STATE OF


4. MATERIALS, METHODS OF INSTALLATION SHALL BE CONFORM TO "STATE OF CT DEPARTMENT OF TRANSPORTATION STANDARD SPECIFICATIONS FORM 816 M.10.05" OR CURRENT SPECIFICATION FOR SUCH WORK.

TYPICAL DOUBLE LEAF CHAIN LINK FENCE GATE


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Description:

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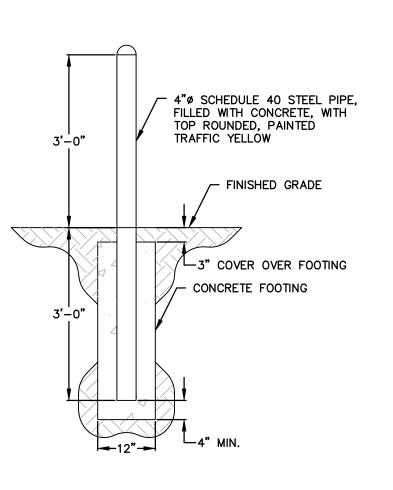




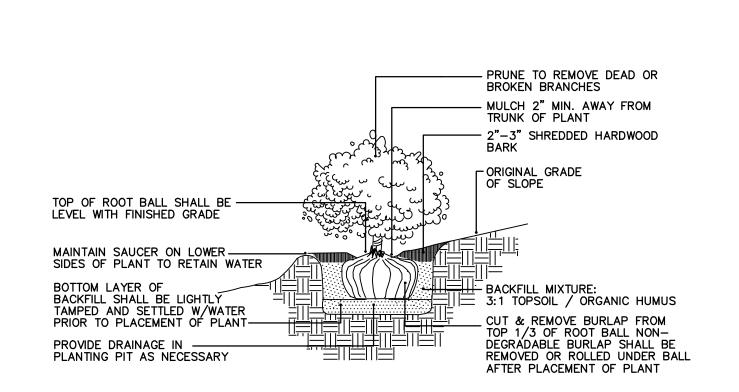

1. TOPSOIL MIX, SEE SPEC.
2. DO NOT DAMAGE MAIN ROOTS OR DESTROY ROOT BALL WHEN INSTALLING TREE STAKE.
3. WATER THOROUGHLY AFTER INSTALLATION.
4. REMOVE TREE RINGS AND STAKES TWO YEARS AFTER INSTALLATION.
5. PROVIDE DRAINAGE FOR PLANTING PIT IN IMPERMEABLE SOIL.
6. ALL TREES MUST BE TAGGED AND APPROVED BY CONSULTANT WITHIN 14 DAYS AFTER TENDER CLOSING.

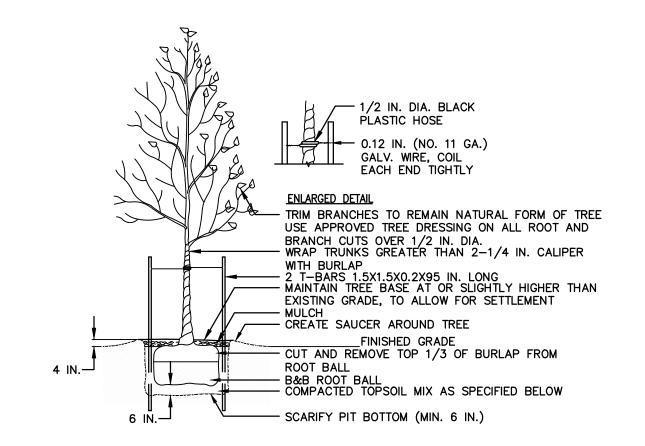



8 TYPICAL BOLLARD N.T.S.

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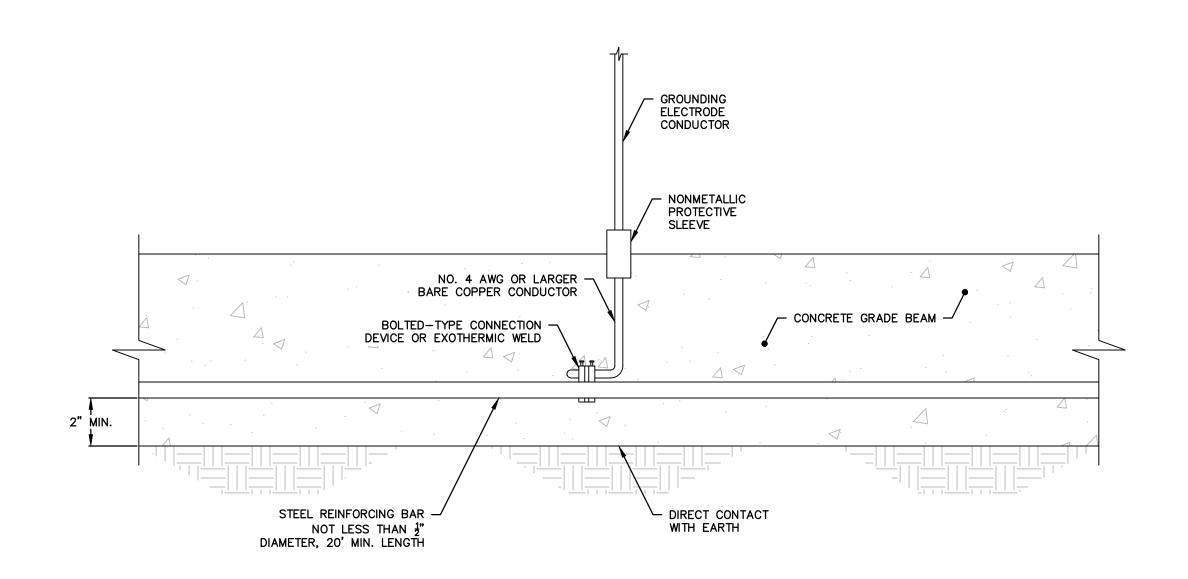
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PROJECT 2203 700 EAST BROADWAY MILFORD, CONNECTICUT 06460 ISSUED FOR BIDDING CONSTRUCTION


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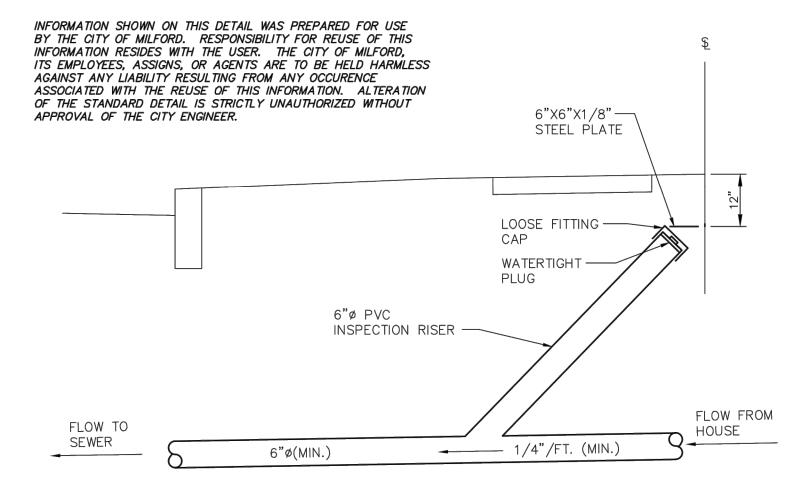
SITE DETAILS

JOB NO.	DRAWING NUMBER	SHEET	
33-262-2203	33-262-2203 - BASEMAP.dwg	C-2.1	



1 CONCRETE-ENCASED ELECTRODE C-2.2 N.T.S.



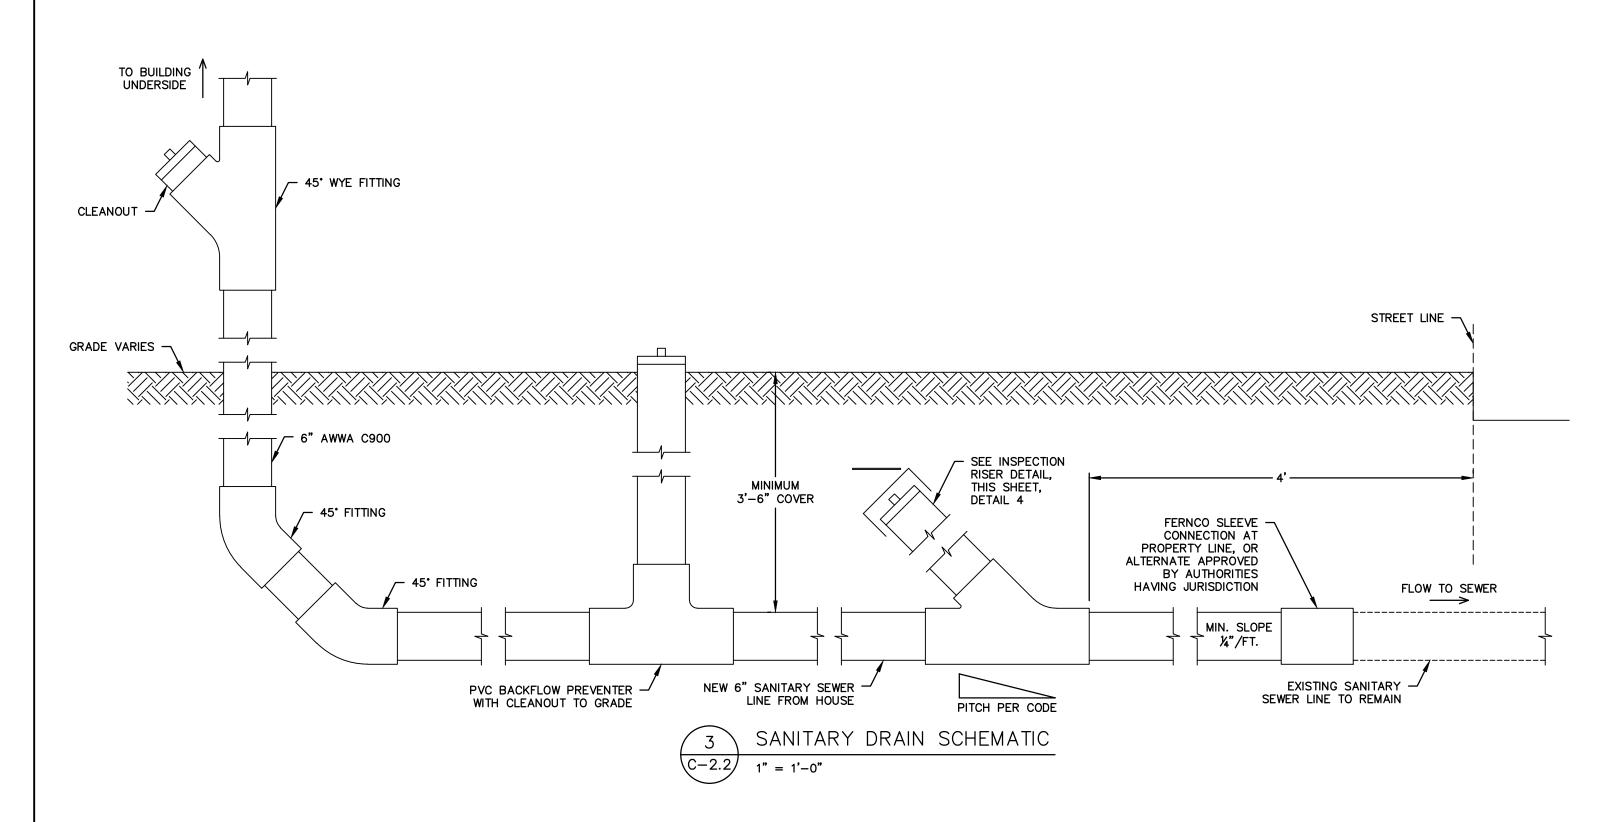

A CONDITION OF ALL SEWER PERMITS FOR INSTALLING RESIDENTIAL SEWER CONNECTIONS IS THE REQUIREMENT TO FURNISH AND INSTALL A SEWER INSPECTION RISER IN THAT AREA OF THE STREET RIGHT-OF-WAY BETWEEN THE CURB AND THE STREETLINE (FRONT PROPERTY LINE). THE INSPECTION RISER IS TO CONSIST OF A 45° WYE FITTING INSTALLED ON THE HOUSE CONNECTION SEWER APPROXIMATELY 4 FEET BEHIND THE STANDARD CURB LOCATION*. A 6"Ø PVC INSPECTION RISER PIPE IS TO BE INSTALLED TO WITHIN 12" OF THE FINISHED GROUND SURFACE AND FITTED WITH A WATERTIGHT PLUG. A 6"X6"X1/8" STEEL PLATE IS TO BE PLACED ABOVE THE END OF THE INSPECTION RISER WHEN BACKFILLING THE AREA TO GRADE TO ASSIST WITH FUTURE RECOVERY OF THE INSPECTION RISER BY MEANS OF A MAGNETIC DETECTOR.

*IN A SEWER EASEMENT THE INSPECTION RISER IS TO BE AT THE EDGE OF THE EASEMENT.

*IN LOCATIONS WHERE AN EXISTING LATERAL EXTENDS TO THE STREET LINE, THE "Y" CONNECTION SHALL BE PLACED AS CLOSE TO THE STREET LINE AS POSSIBLE, WITH THE INSPECTION RISER EXTENDING TO WITHIN 12" OF GRADE AND LOCATED ON PRIVATE

2 INSPECTION RISER C-2.2 N.T.S.

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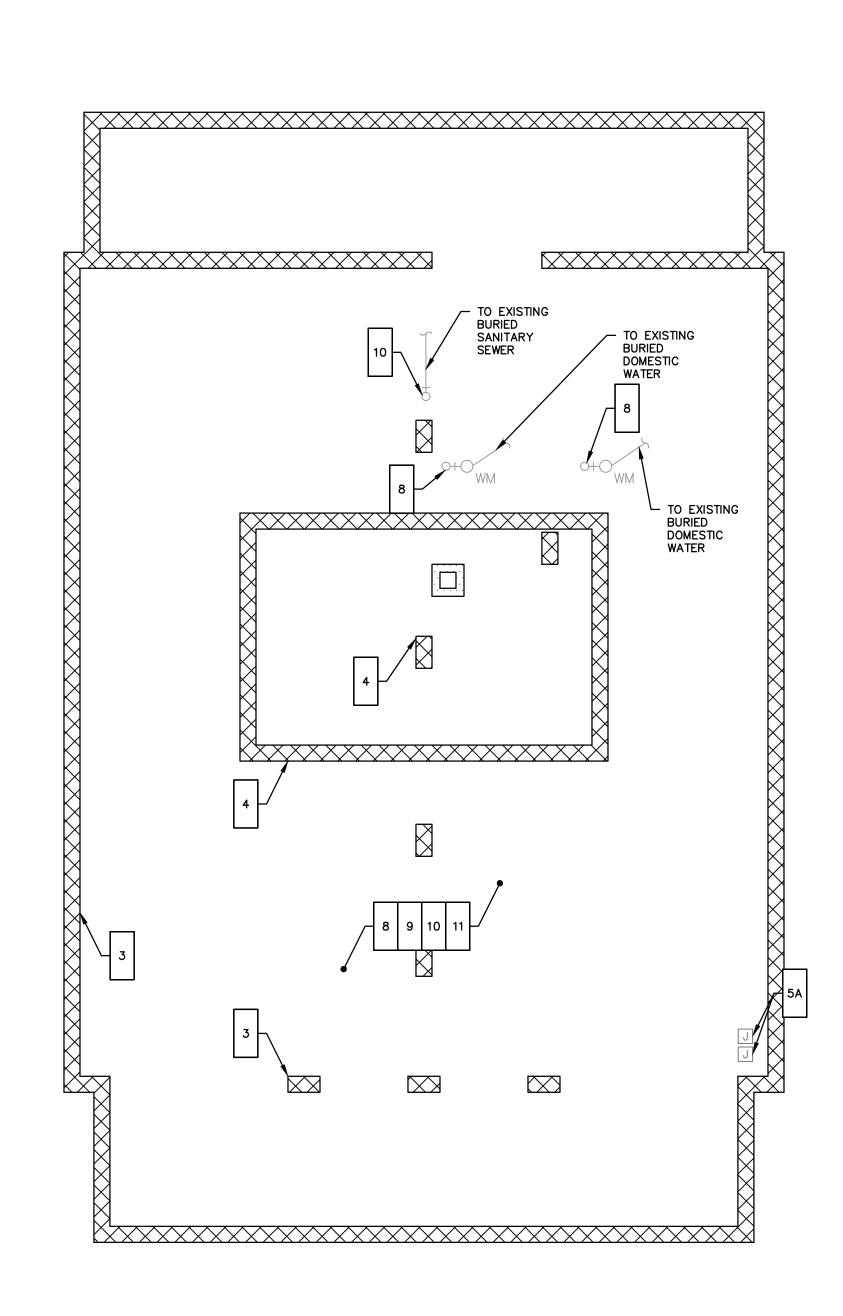
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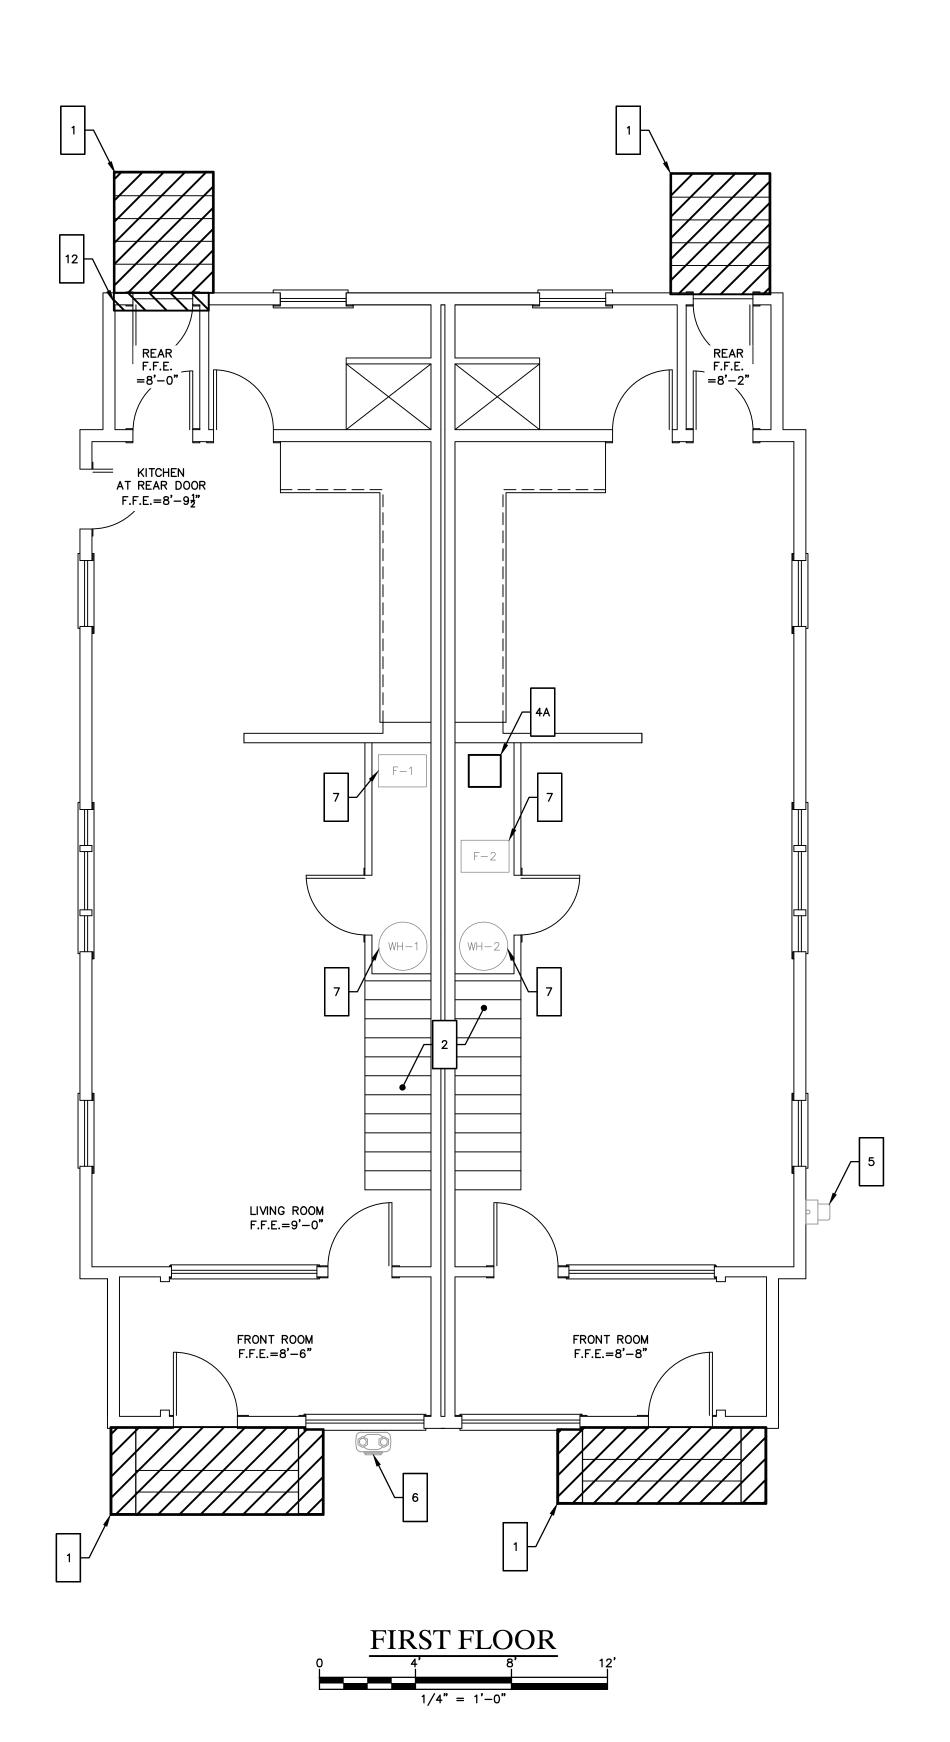
PROJECT 2203 700 EAST BROADWAY MILFORD, CONNECTICUT 06460 ISSUED FOR BIDDING TON LONG TON TON LONG TON CONSTRUCTION

3	8/28/2017	ISSUED FOR RE-BIL)		мвғ	R MBR	REC
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SITE UTILITY DETAILS

JOB NO.	DRAWING NUMBER	SHEET
33-262-2203	33-262-2203 - BASEMAP.dwa	C-2.2





GENERAL NOTES

- THE CONTRACTOR IS RESPONSIBLE FOR FIELD VERIFYING ALL MEASUREMENTS. ANY VARIATIONS FROM CONDITIONS SHOWN ARE TO BE BROUGHT TO THE ATTENTION OF THE DESIGN PROFESSIONAL AND/OR MARTINEZ COUCH AND ASSOCIATES PRIOR TO BIDDING FOR RESOLUTION IN ACCORDANCE WITH CONTRACT DOCUMENT REQUIREMENTS.
- 2. ALL REQUIRED PERMITS ARE TO BE OBTAINED BY THE CONTRACTOR AT HIS EXPENSE.

 3. ALL DIMENSIONS ARE TO THE OUTSIDE FACE OF THE NOTED ITEM.
- 4. WORK LIMITS SHALL BE AS NOTED. ALL ITEMS DISTURBED BY ANY AND ALL CONSTRUCTION ACTIVITIES SHALL BE RESTORED SUBSTANTIALLY TO THE CONDITION THEY EXISTED PRIOR TO THE COMMENCEMENT OF CONSTRUCTION, AND TO THE PROPERTY OWNER'S SATISFACTION.
- 5. THE LOCATIONS OF SITE UTILITIES ARE UNKNOWN. PRIOR TO COMMENCING ANY EXCAVATION, THE CONTRACTOR SHALL PLACE A "CALL BEFORE YOU DIG" (CBYD) REQUEST (PHONE: 1–800–922–4455). THE PROTECTION OF EXISTING UTILITIES IS THE SOLE
- RESPONSIBILITY OF THE CONTRACTOR AT HIS EXPENSE.

 6. THE CONTRACTOR IS RESPONSIBLE FOR MAINTAINING ALL ACTIVITY ON THE SUBJECT
- 7. ELEVATIONS SHOWN ON THE DRAWING REFERENCE VERTICAL DATUM NAVD88.

WORK NOTES

- 1 DEMOLISH EXISTING FRONT AND REAR STEPS AND DISPOSE OF OFFSITE
- 2 SUPPORT HOUSE AND LIFT TO PROPOSED ELEVATION
- DEMOLISH, REMOVE, AND DISPOSE OFFSITE ENTIRE BUILDING FOUNDATION, FOOTING BELOW GRADE, INTERMEDIATE PIERS, AND OTHER SUPPORTS, WHETHER SHOWN ON DRAWING OR NOT.
- DEMOLISH, REMOVE, AND DISPOSE OFFSITE CHIMNEY, CHIMNEY FOUNDATION, CEMENT PAD, AND BLOCK WALL BENEATH HOUSE
- DEMOLISH, REMOVE, AND DISPOSE OFFSITE EXISTING BRICK MASONRY CHIMNEY UP
 THROUGH THIRD FLOOR AND ROOF; CUT AND PATCH INTERIOR FINISHES AS REQUIRED.
 MINIMIZE DISTURBANCE TO FINISHES
- DEMOLISH, REMOVE, AND DISPOSE OFFSITE ELECTRIC SERVICE MAST. REMOVE AND RESET ELECTRIC METER, DISCONNECT, AND EQUIPMENT FOR REINSTALLATION ON NEW STRUCTURAL COLUMN
- EXISTING JUNCTION BOXES TO BE REMOVED, TEMPORARILY SUPPORT AND MOUNT ON NEW STRUCTURAL FRAMING
- 6 SALVAGE GAS METER FOR REINSTALLATION OR REMOVE OFFSITE AND DISPOSE AS REQUIRED BY UTILITY PROVIDER.
- EXISTING MECHANICAL AND PLUMBING EQUIPMENT; DISCONNECT, TEMPORARILY RELOCATE, AND REINSTALL AS REQUIRED FOR PROJECT WORK. SEE BUILDING UTILITY PLAN SHEET C-1.3 AND PROPOSED FLOOR PLANS. PROTECT ALL EQUIPMENT FOR PROJECT DUTATION; REPLACE EQUIPMENT NOT ABLE TO BE REINSTALLED OR DAMAGED

BY CONTRACTOR WORK OPERATIONS

- REMOVE AND DISPOSE EXISTING DOMESTIC WATER PIPING TO FLOOR PENETRATIONS AT UNDERSIDE OF FIRST FLOOR;
- REMOVE AND DISPOSE EXISTING NATURAL GAS PIPING TO PENETRATIONS AT UNDERSIDE OF FIRST FLOOR
- REMOVE AND DISPOSE EXISTING SANITARY DRAIN PIPING TO PENETRATIONS AT UNDERSIDE OF FIRST FLOOR
- 11 REMOVE AND DISPOSE EXISTING DUCTING TO PENETRATIONS AT FIRST FLOOR
- DEMOLISH, REMOVE, AND DISPOSE OFFSITE REAR DOOR AS INDICATED; REMOVE TRIM, FRAME, SILL. PROTECT BUILDING ENVELOPE UNTILL PERMANANT WALL CONSTRUCTION IS COMPLETE

CRAWLSPACE LEVEL

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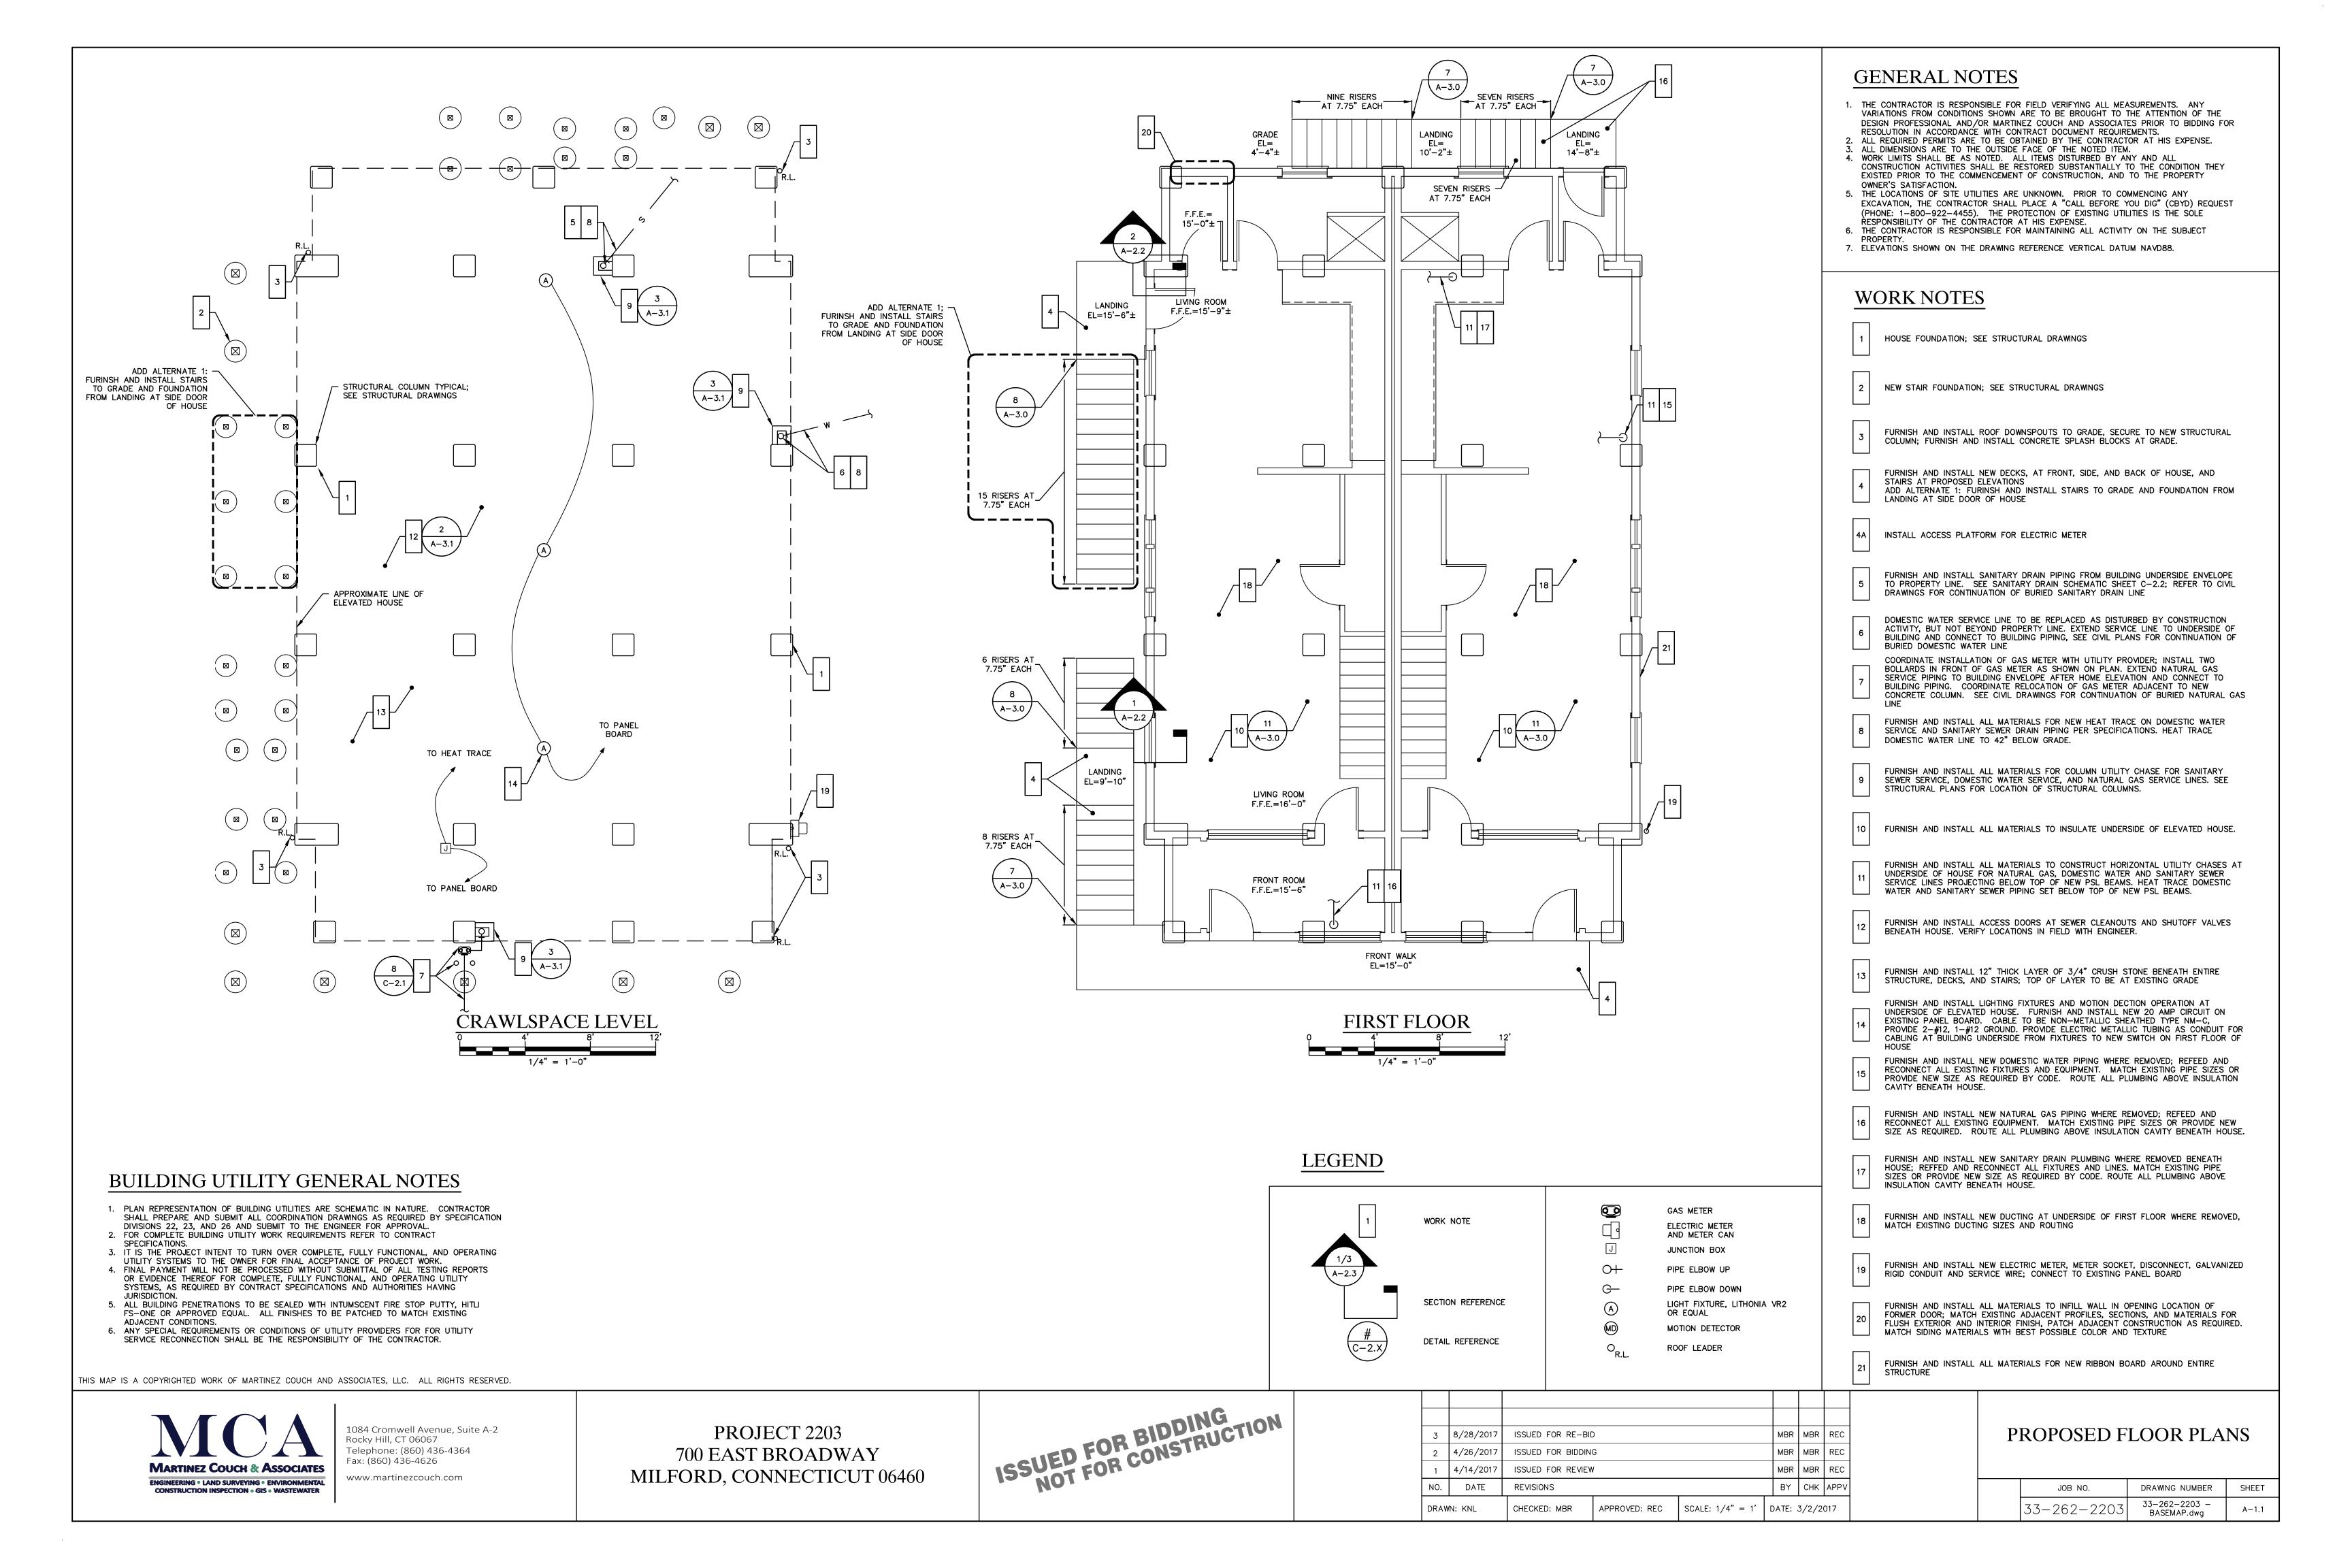
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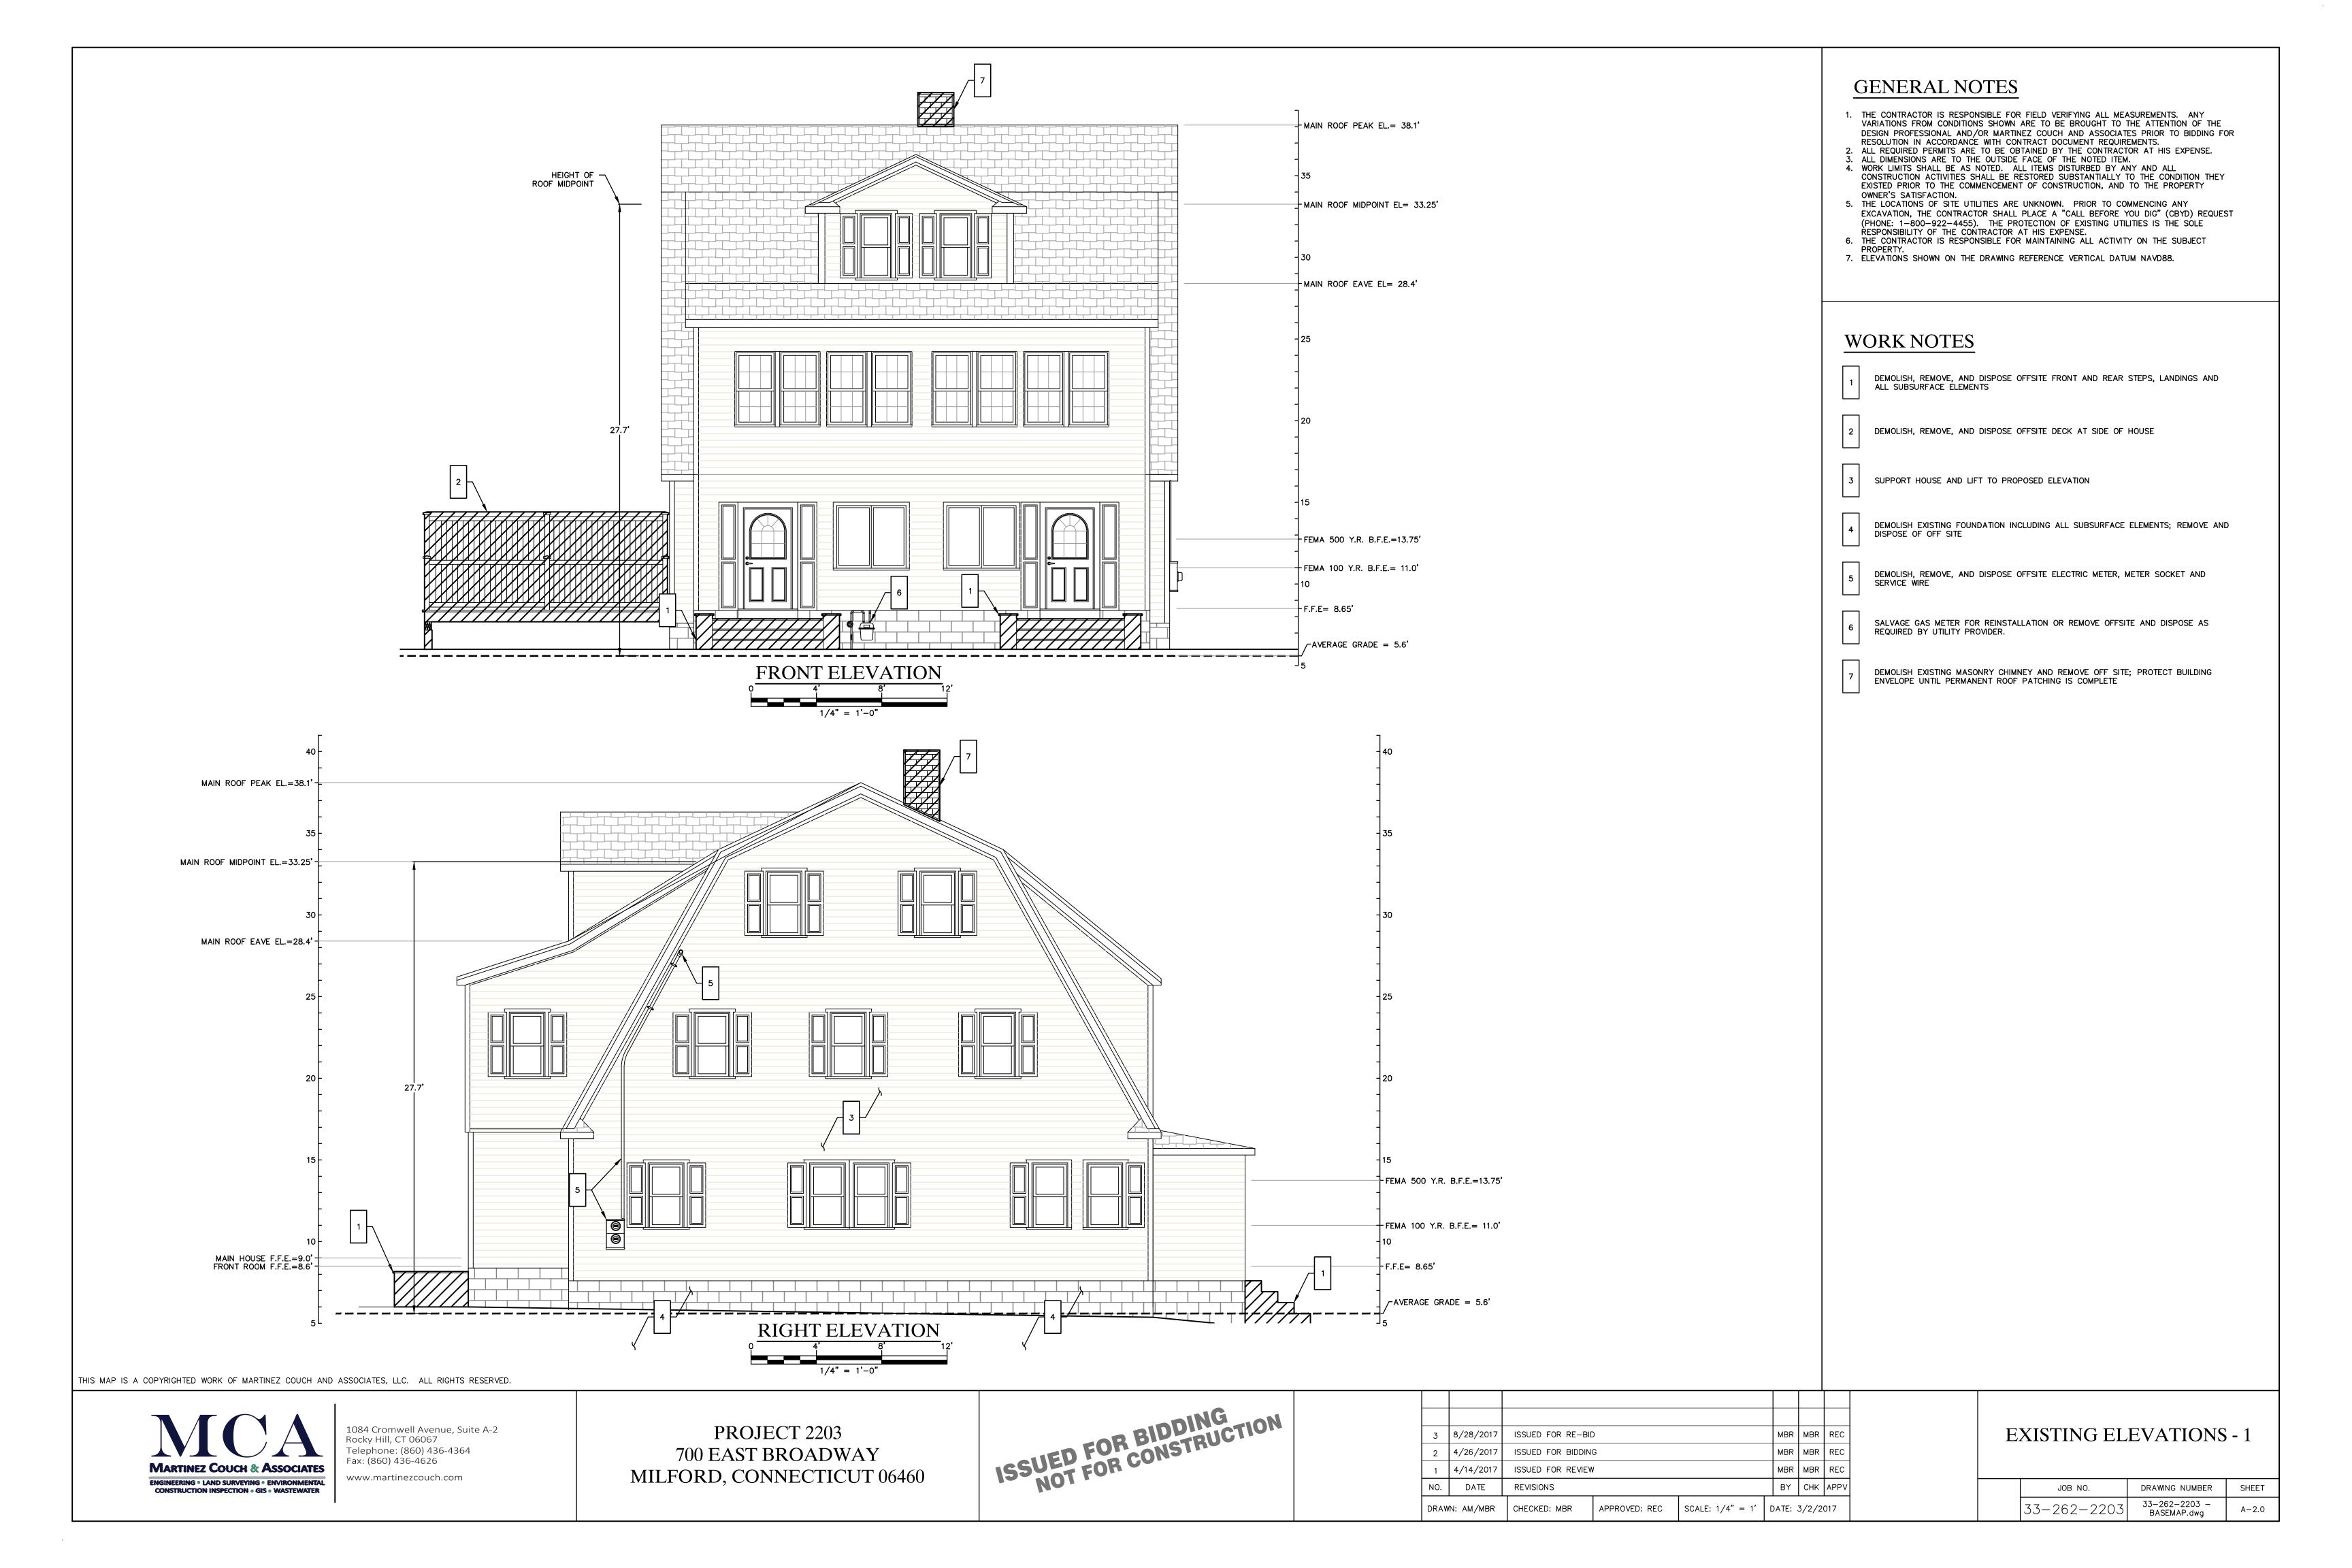
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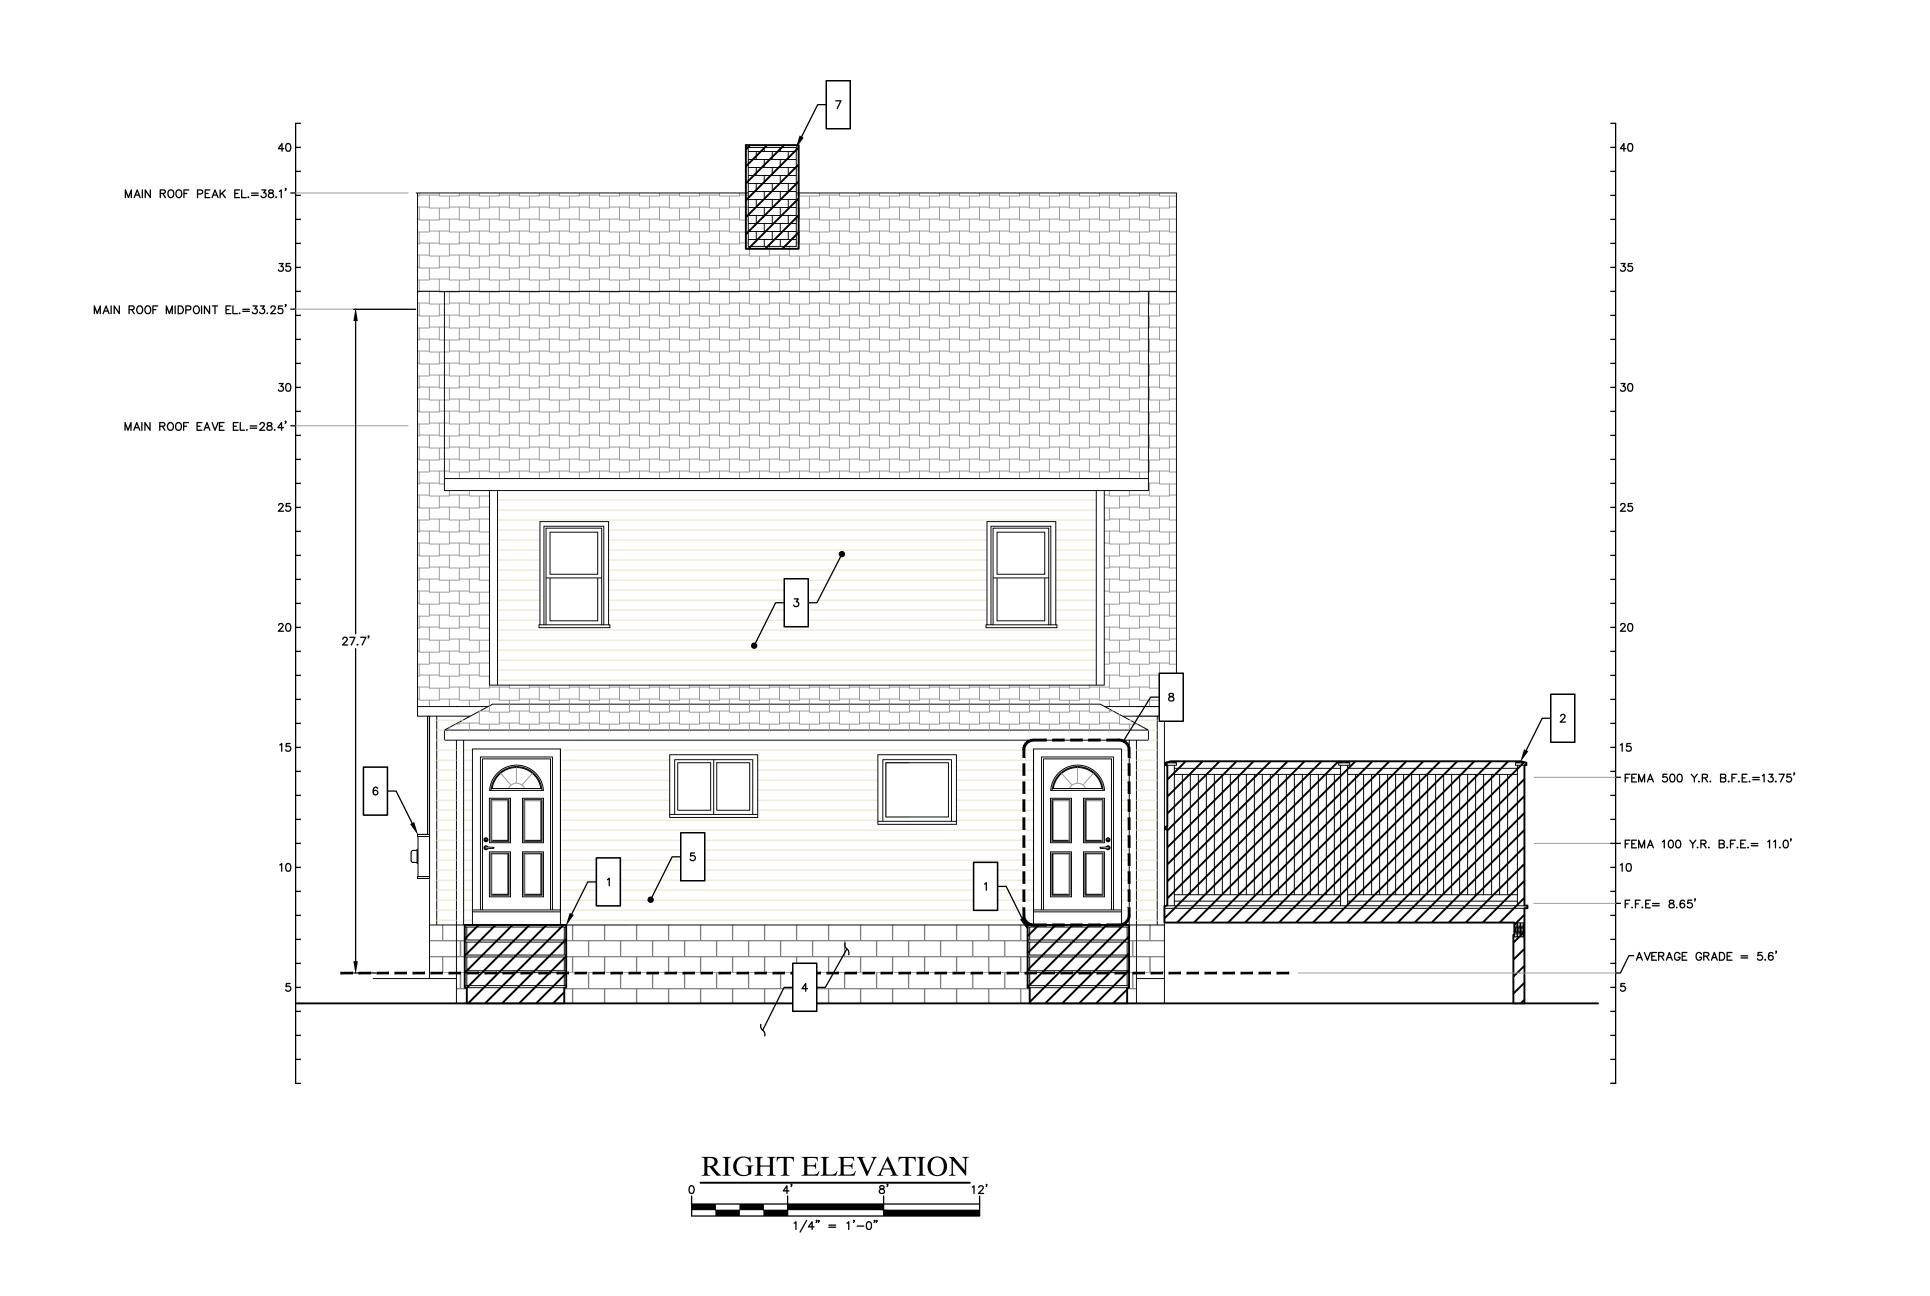
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EXISTING FLOOR PLANS

JOB NO.	DRAWING NUMBER	SHEET
33-262-2203	33-262-2203 - BASEMAP dwg	A-1.0







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 4. WORK LIMITS SHALL BE AS NOTED. ALL ITEMS DISTURBED BY ANY AND ALL CONSTRUCTION ACTIVITIES SHALL BE RESTORED SUBSTANTIALLY TO THE CONDITION THEY EXISTED PRIOR TO THE COMMENCEMENT OF CONSTRUCTION, AND TO THE PROPERTY OWNER'S SATISFACTION.
- 5. THE LOCATIONS OF SITE UTILITIES ARE UNKNOWN. PRIOR TO COMMENCING ANY EXCAVATION, THE CONTRACTOR SHALL PLACE A "CALL BEFORE YOU DIG" (CBYD) REQUEST (PHONE: 1–800–922–4455). THE PROTECTION OF EXISTING UTILITIES IS THE SOLE RESPONSIBILITY OF THE CONTRACTOR AT HIS EXPENSE.
- 6. THE CONTRACTOR IS RESPONSIBLE FOR MAINTAINING ALL ACTIVITY ON THE SUBJECT PROPERTY.
- 7. ELEVATIONS SHOWN ON THE DRAWING REFERENCE VERTICAL DATUM NAVD88.

WORK NOTES

- DEMOLISH, REMOVE, AND DISPOSE OFFSITE FRONT AND REAR STEPS, LANDINGS AND ALL SUBSURFACE ELEMENTS
- DEMOLISH, REMOVE, AND DISPOSE OFFSITE DECK AT SIDE OF HOUSE
- 3 SUPPORT HOUSE AND LIFT TO PROPOSED ELEVATION
- DEMOLISH EXISTING FOUNDATION INCLUDING ALL SUBSURFACE ELEMENTS; REMOVE AND DISPOSE OF OFF SITE
- DEMOLISH EXISTING HOSE BIB AND PLUMBING BACK TO SOURCE, PATCH OPENING IN BUILDING ENVELOPE
- DEMOLISH, REMOVE, AND DISPOSE OFFSITE ELECTRIC METER, METER SOCKET AND SERVICE WIRE
- DEMOLISH EXISTING MASONRY CHIMNEY AND REMOVE OFF SITE; PROTECT BUILDING ENVELOPE UNTIL PERMANENT ROOF PATCHING IS COMPLETE
- DEMOLISH, REMOVE, AND DISPOSE OFFISTE REAR DOOR AS INDICATED; REMOVE TRIM, FRAME, SILL. PROTECT BUILDING ENVELOPE UNTILL PERMANANT WALL CONSTRUCTION IS COMPLETE

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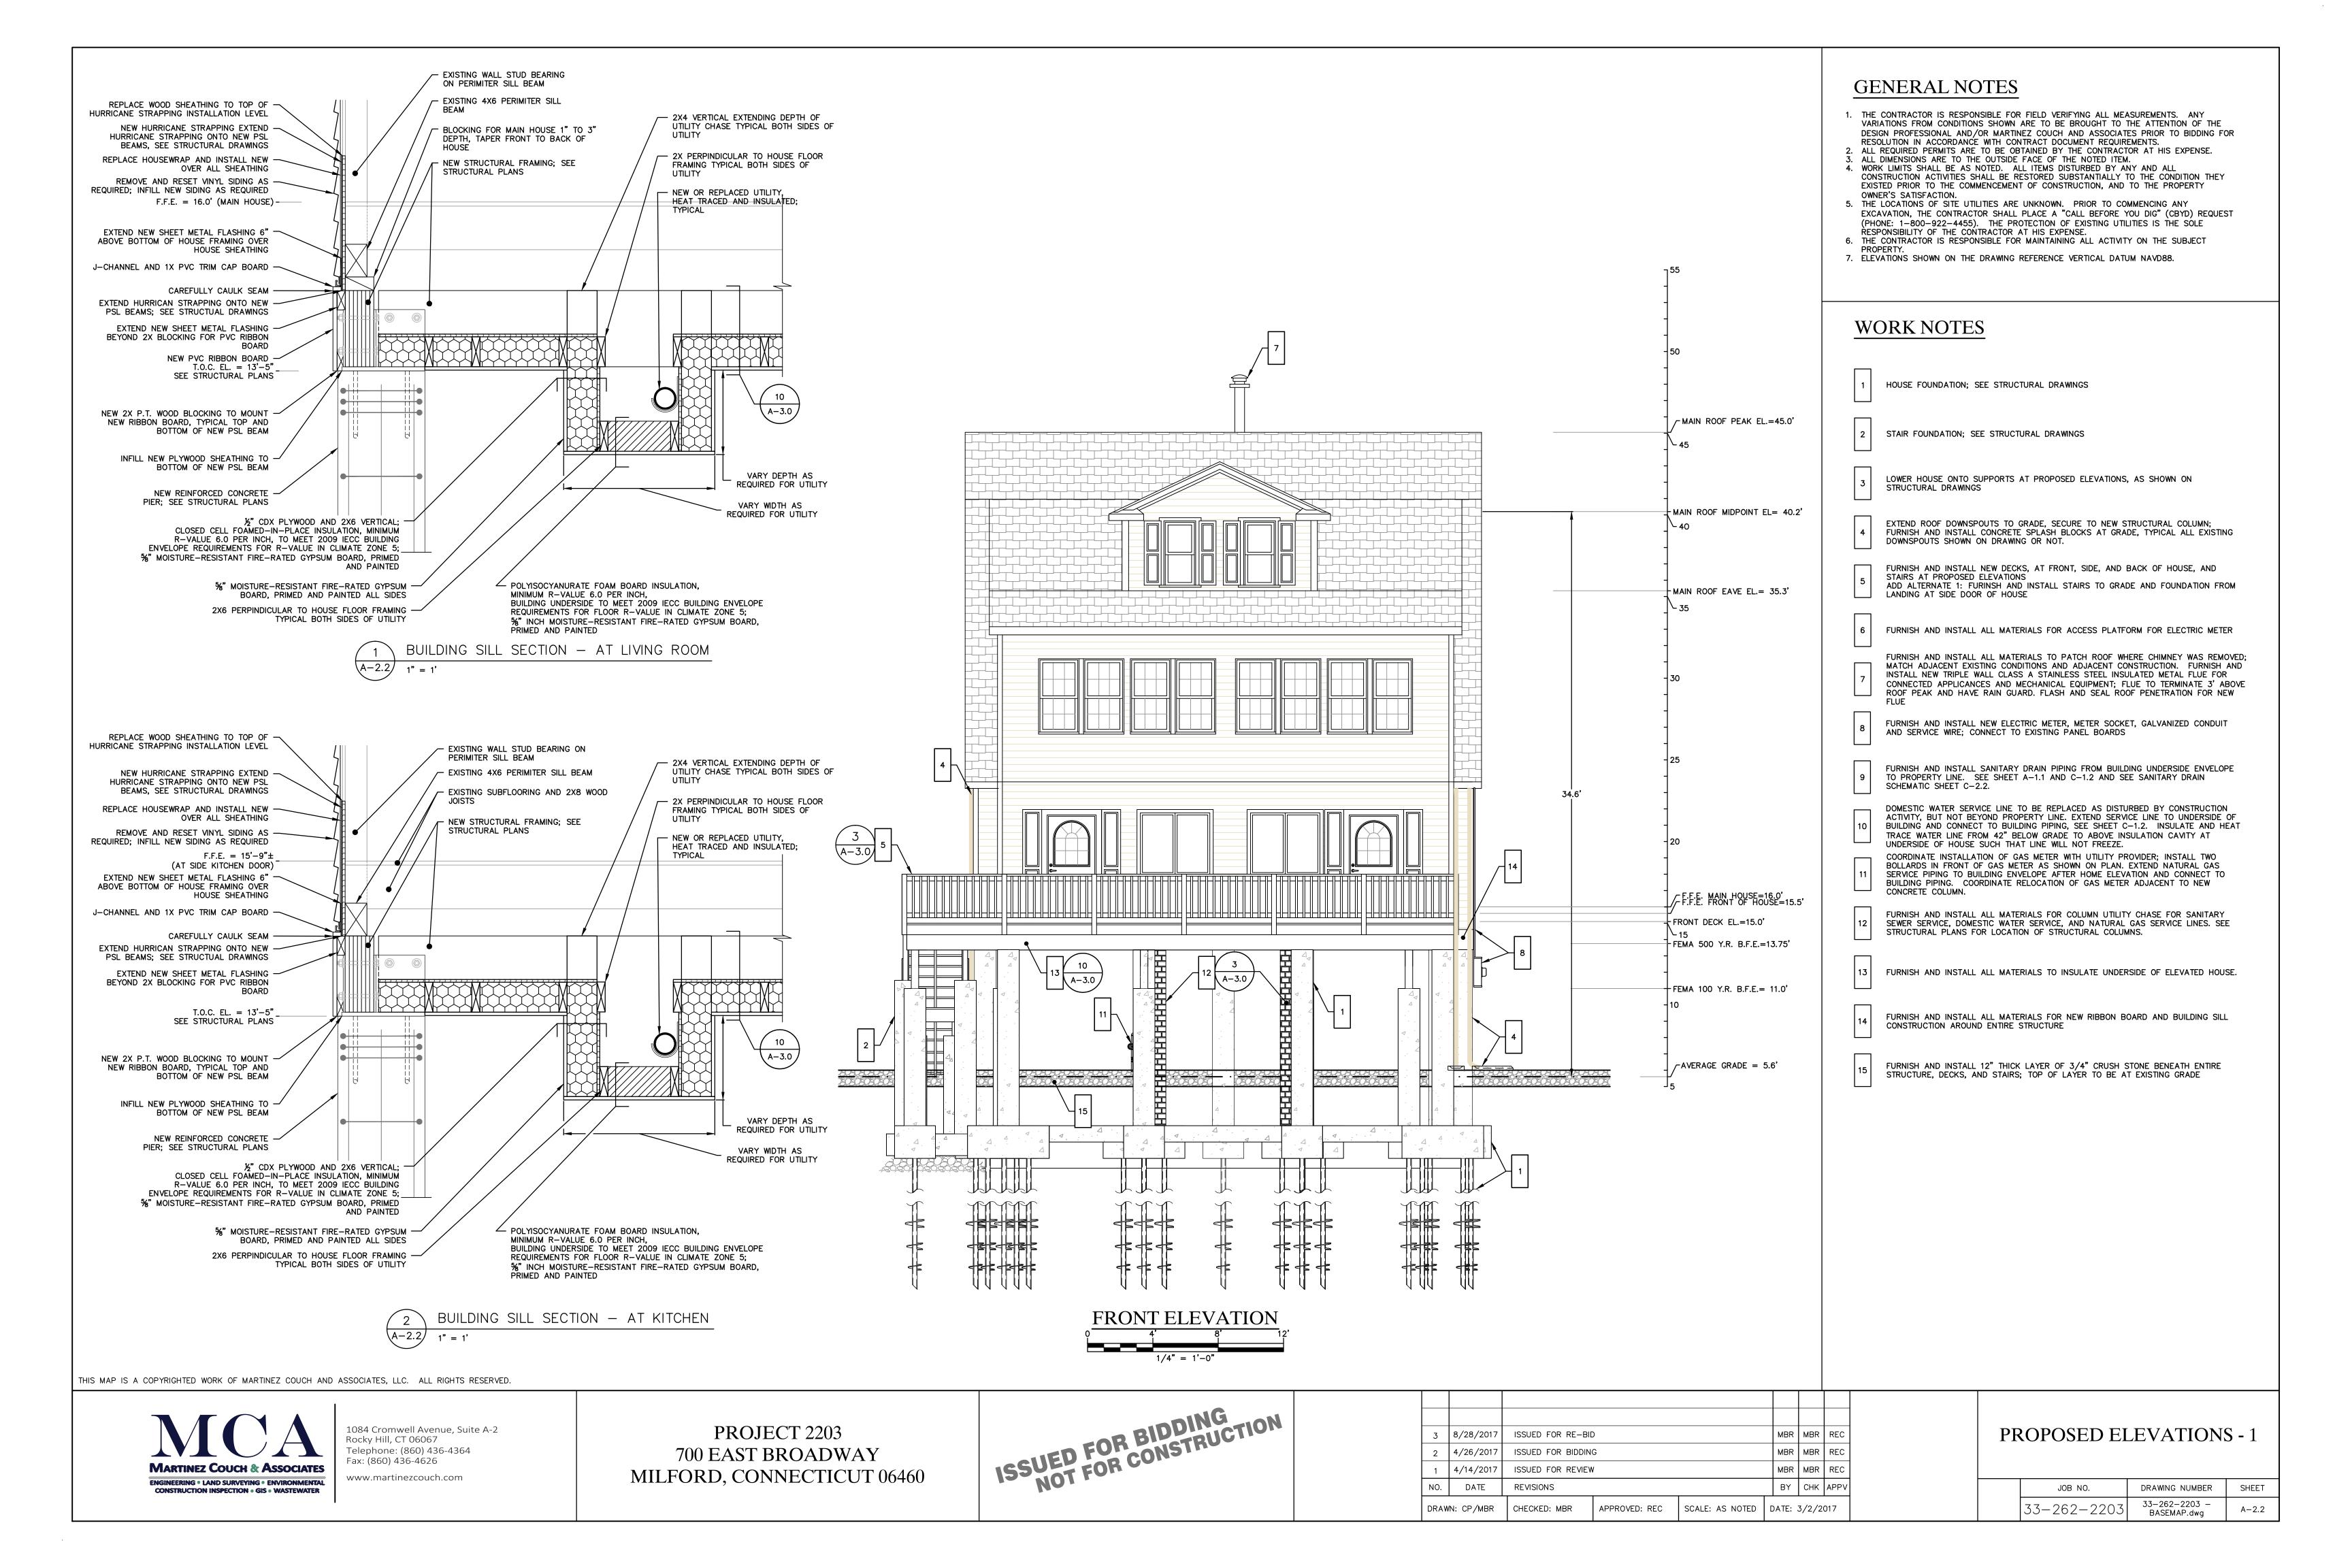
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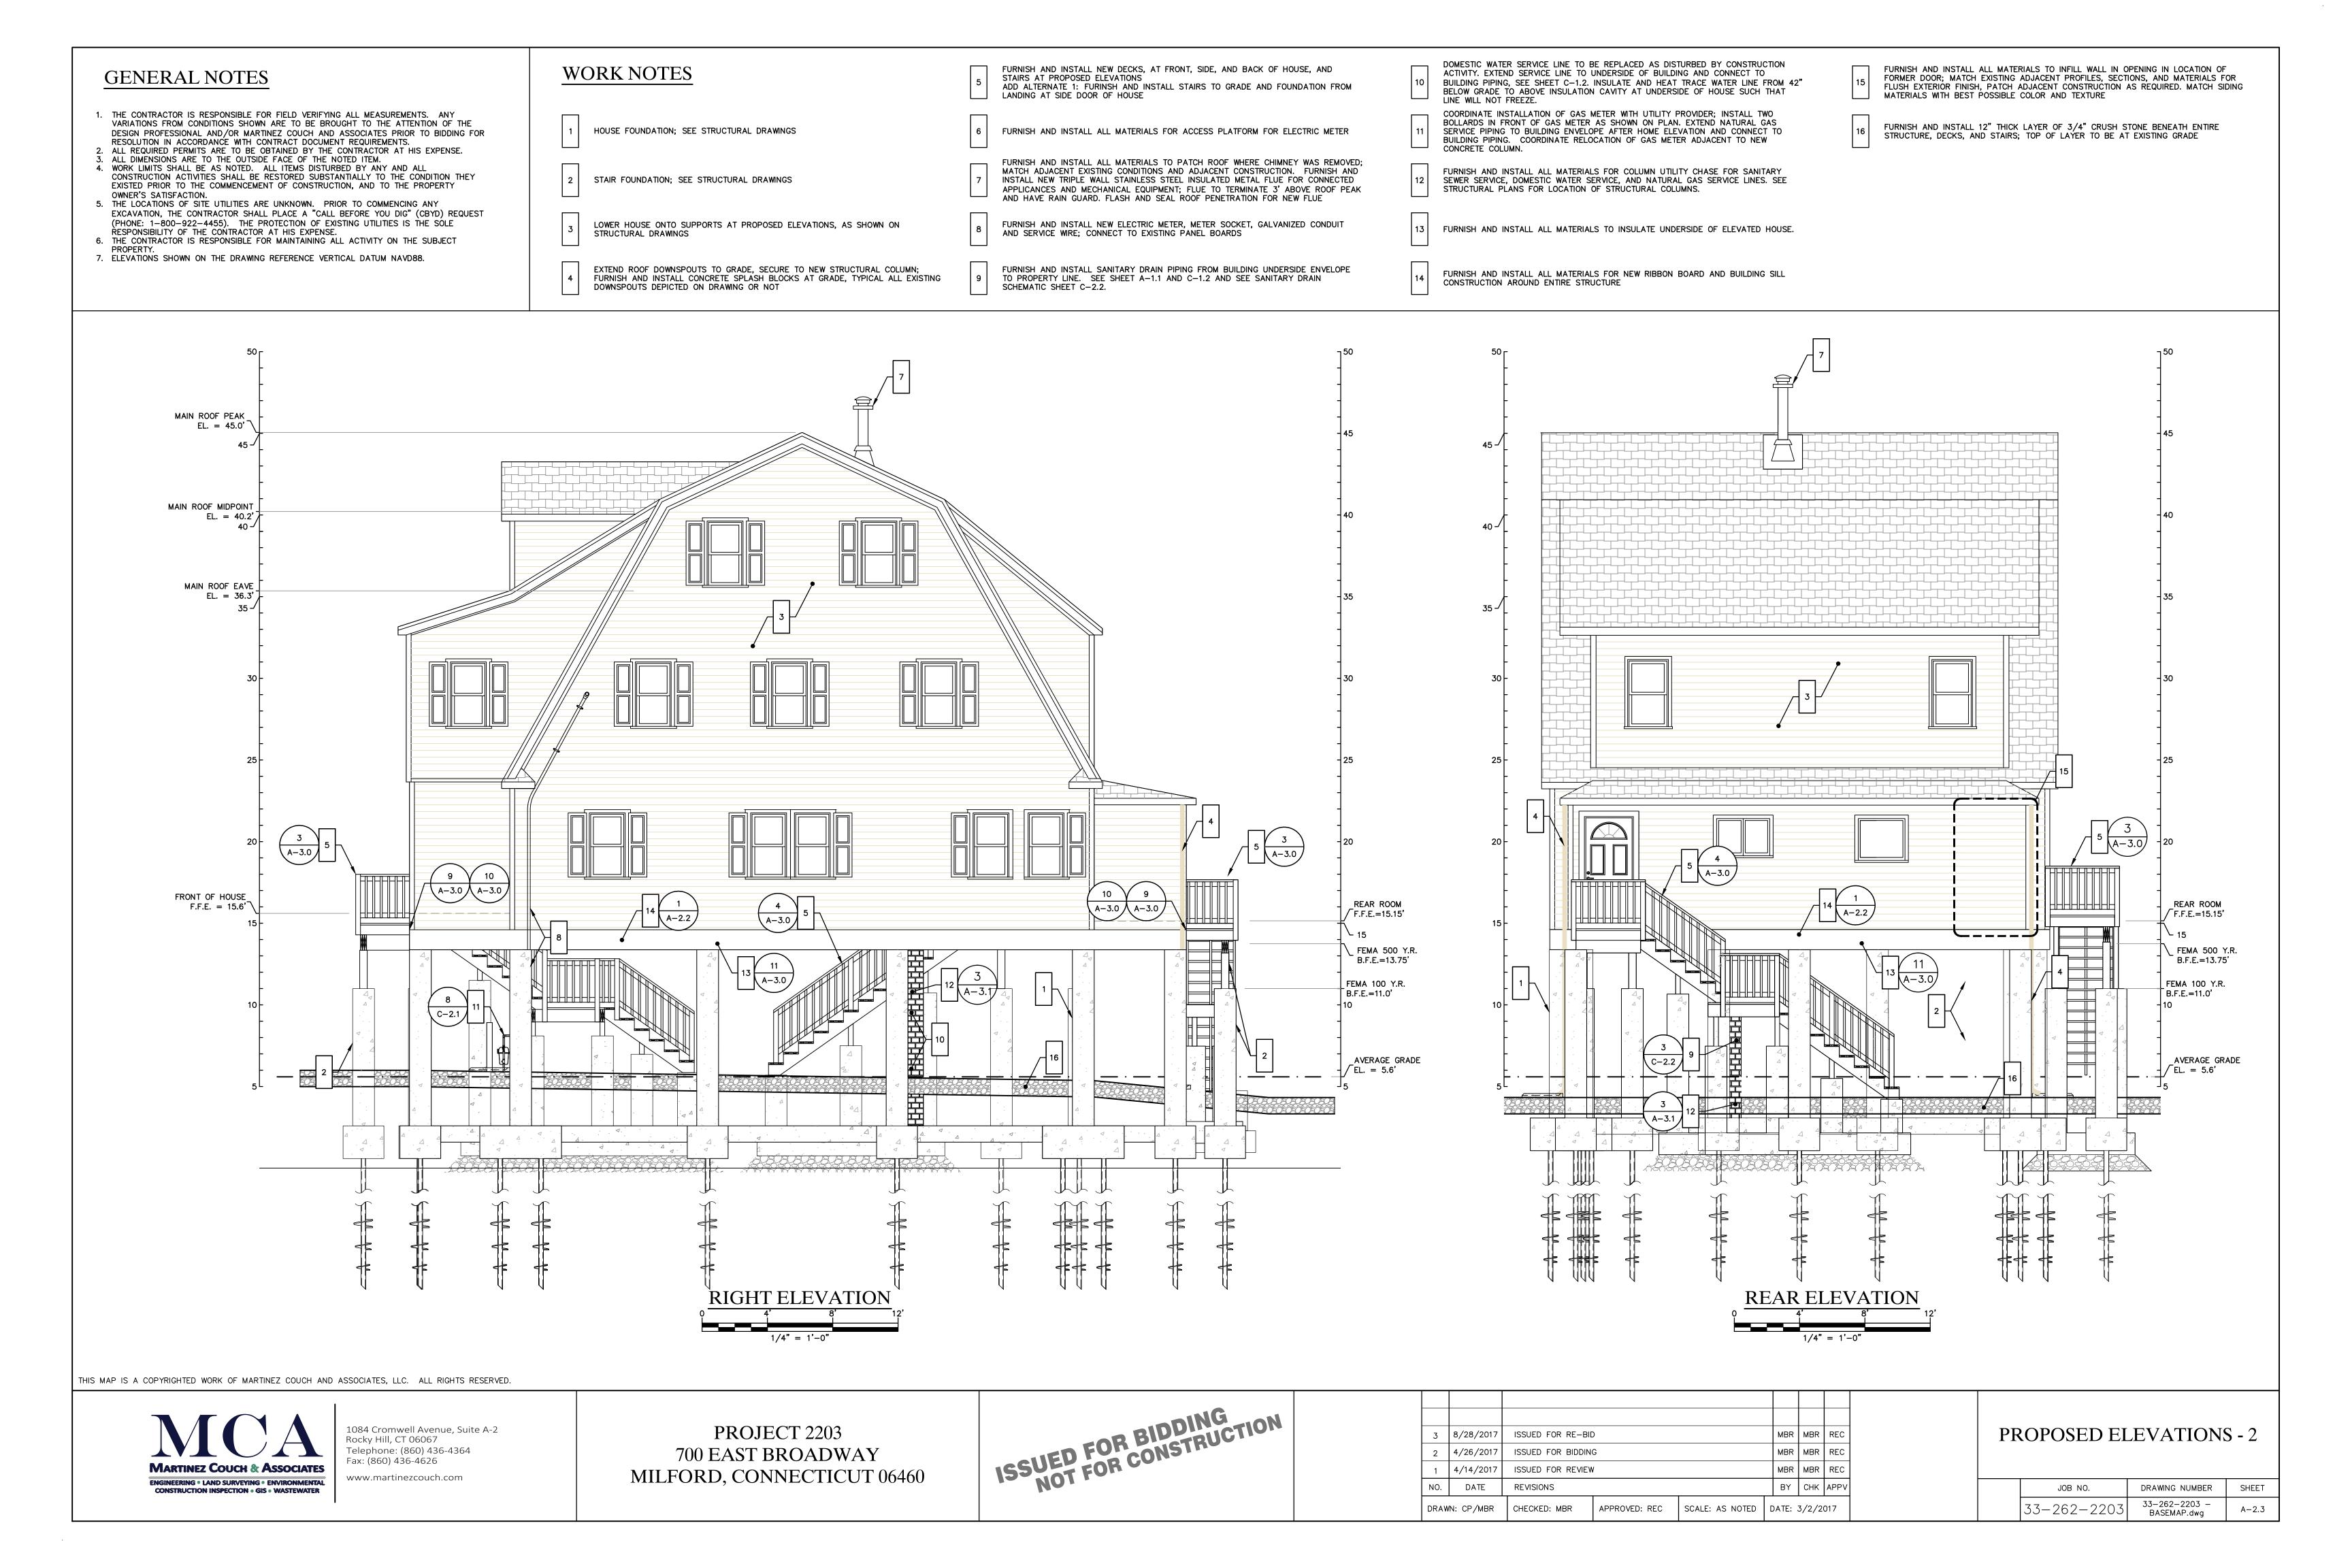
PROJECT 2203 700 EAST BROADWAY MILFORD, CONNECTICUT 06460 ISSUED FOR BIDDING
NOT FOR CONSTRUCTION


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NO.	DATE	REVISIONS			BY	СНК	APPV
DRAW	DRAWN: AM/MBR CHECKED: MBR APPROVED: REC SCALE: 1/4" = 1' DA			DATE:	3/2/2	017	


EXISTING ELEVATIONS - 2

JOB NO.	DRAWING NUMBER	SHEET
33-262-2203	33-262-2203 - BASEMAP.dwa	A-2.1





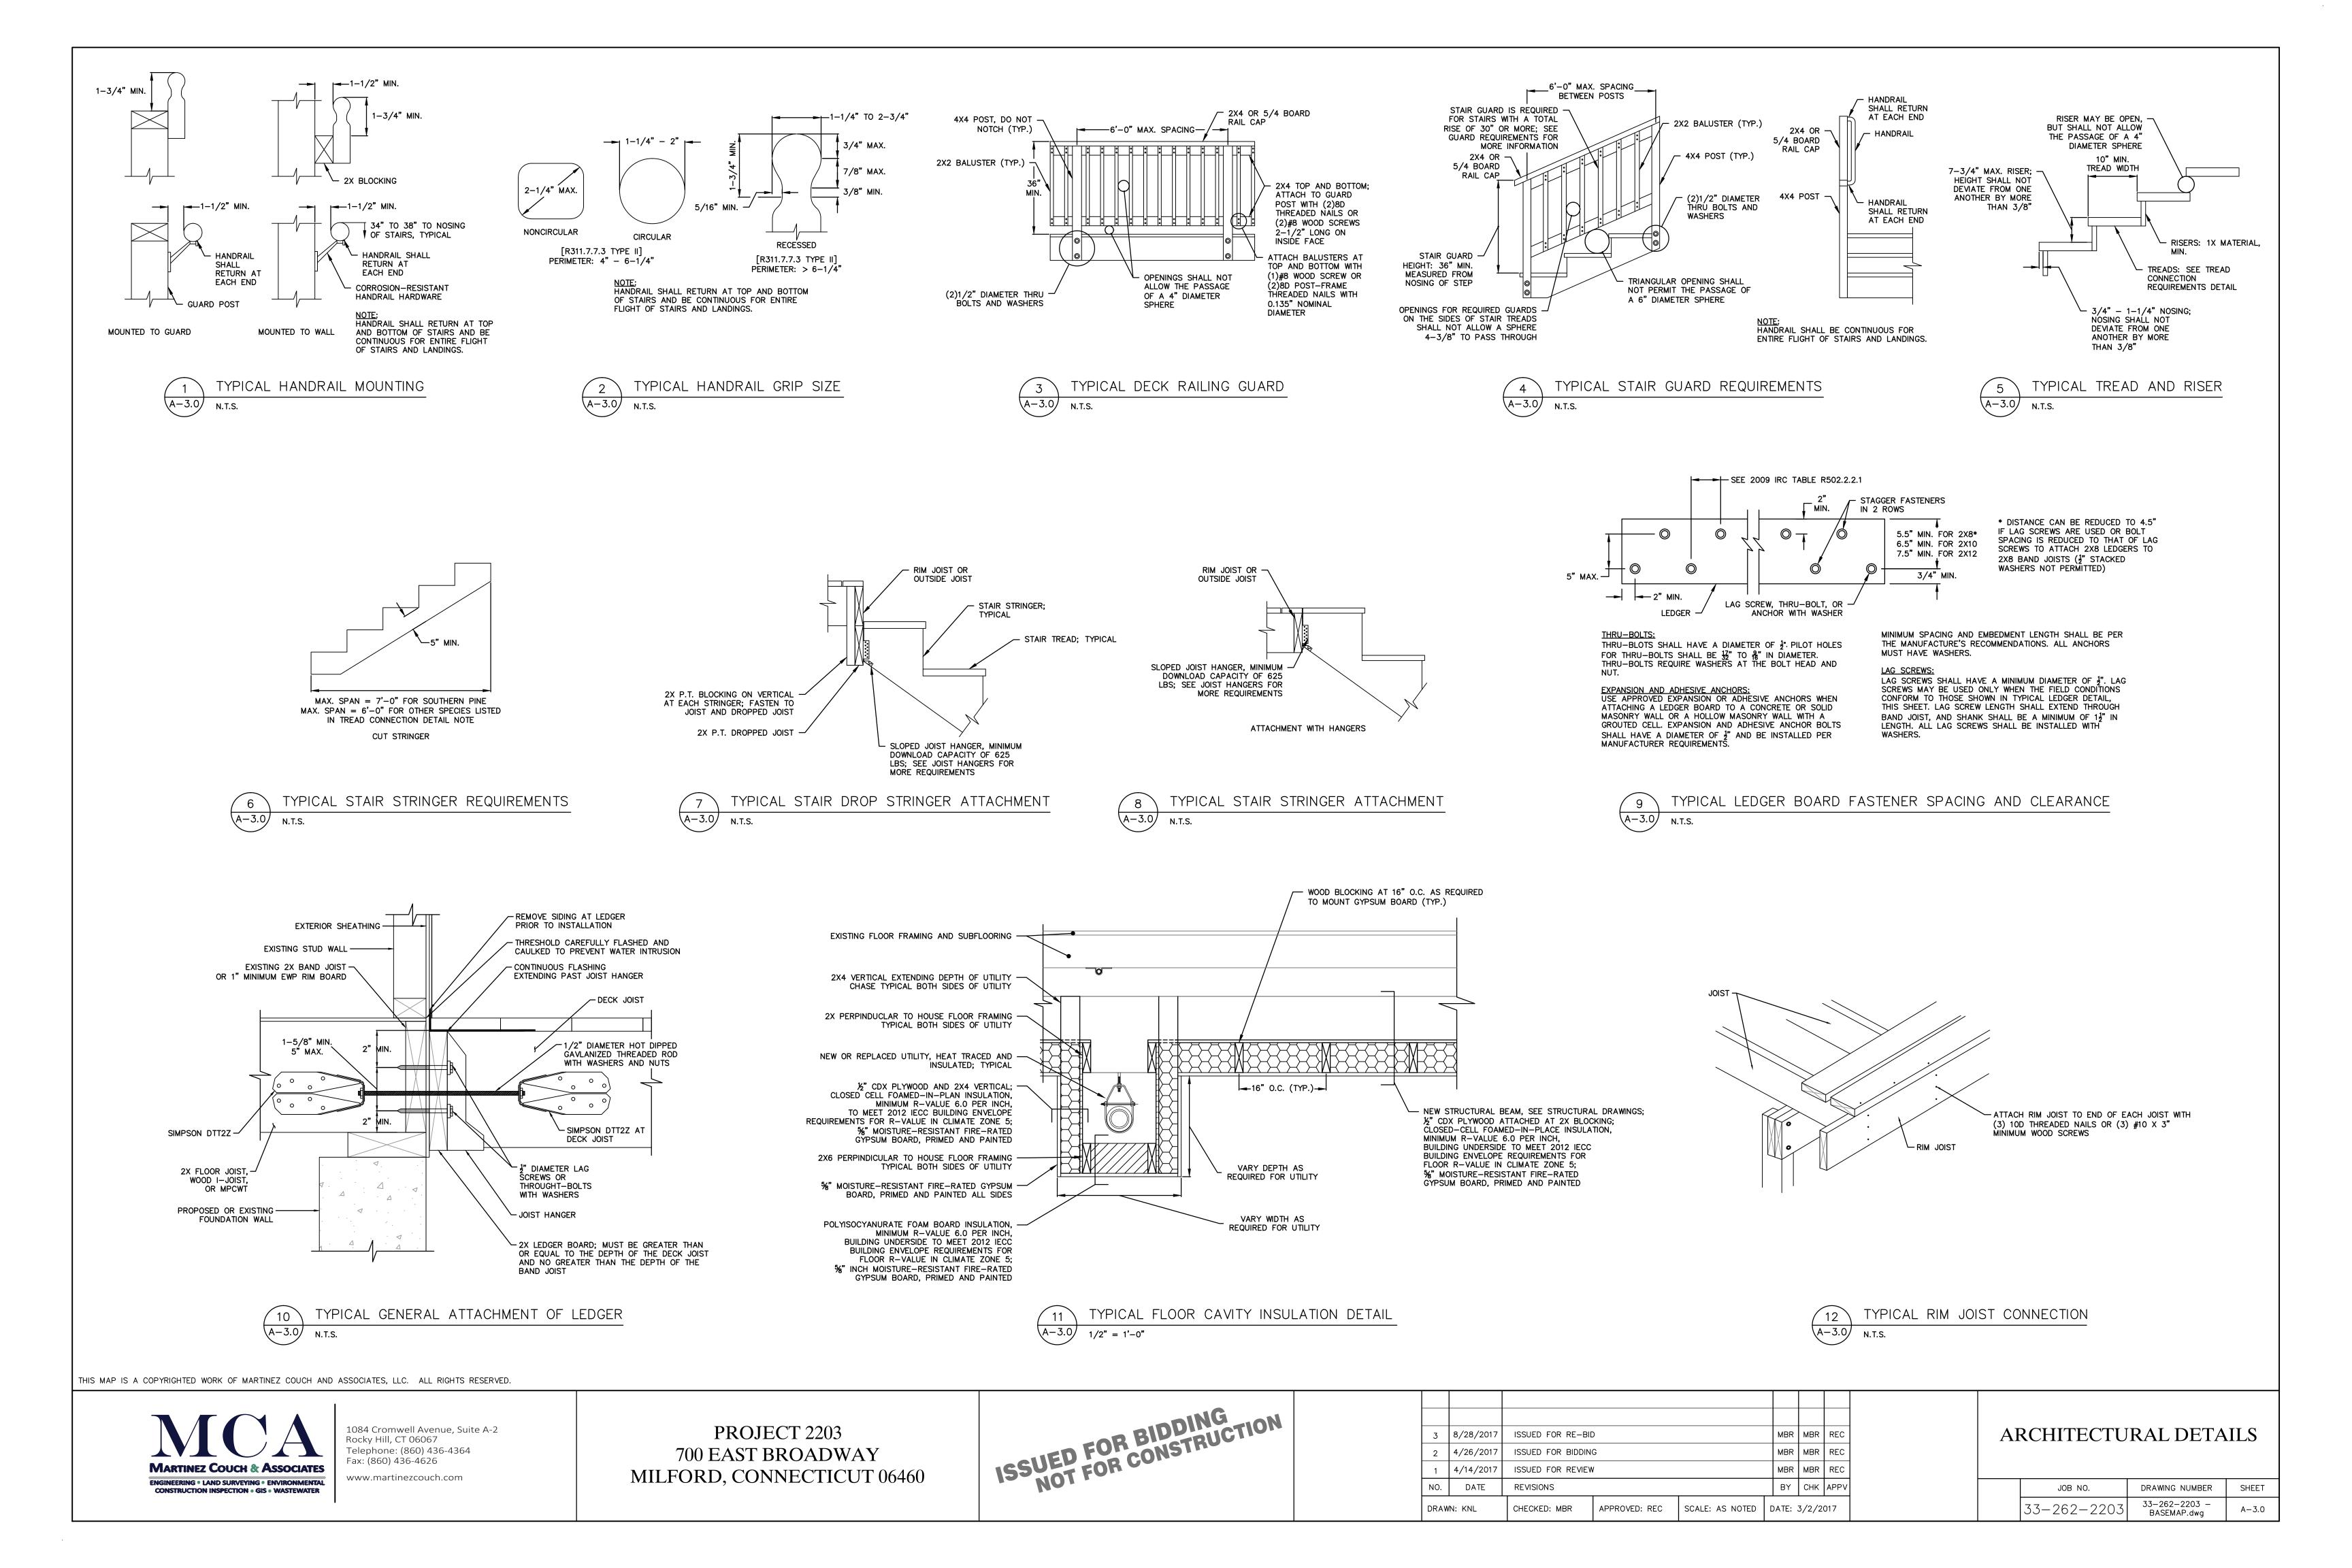


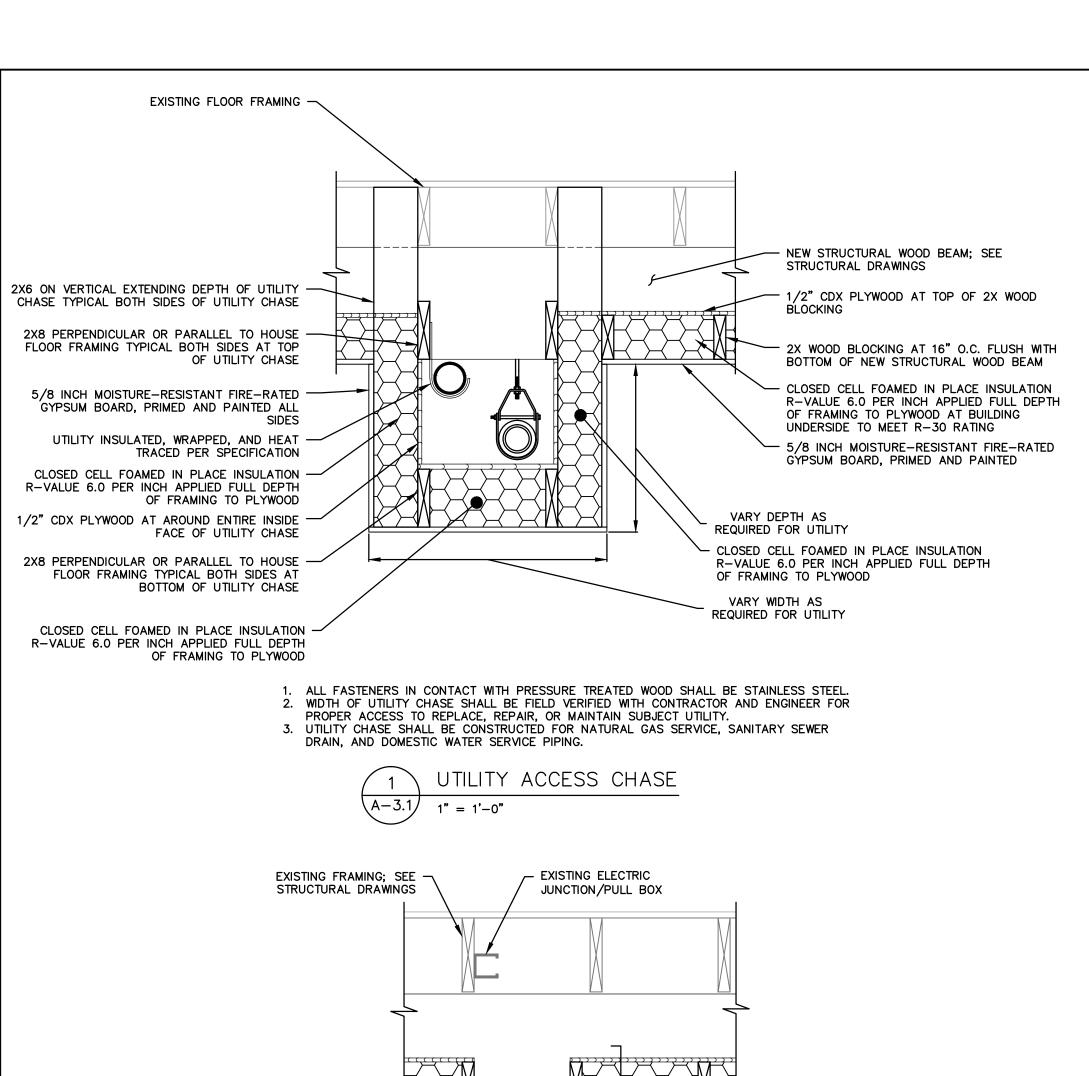

- INSULATION CAVITY; SEE SHEET A-3.0, DETAIL 10 2X BLOCKING AS NECESSARY -- NEMA 4X MARINE GRADE JUNCTION BOX WITH STAINLESS STEEL TORX FASTENER CLOSING SCREWS. JUNCTION BOX SHALL HAVE TO MOUNT NEMA 4X BOX CONFIGURABLE KNOCK-OUT BACK PLATE.
- 1. ALL FASTENERS IN CONTACT WITH PRESSURE TREATED WOOD SHALL BE STAINLESS STEEL. 2. CONTRACTOR SHALL VERIFY IN FIELD AND REVIEW WITH ENGINEER LOCATIONS OF EXISTING
- JUNCTION/PULL BOXES FOR NEW ACCESS BOX INSTALLATION.

 3. NEMA JUNCTION BOX SHALL BE INSTALLED PER MANUFACTURER INSTRUCTIONS, FLUSH WITH SURROUNDING GYPSUM BOARD, WITH WEATHER TIGHT SEAL.



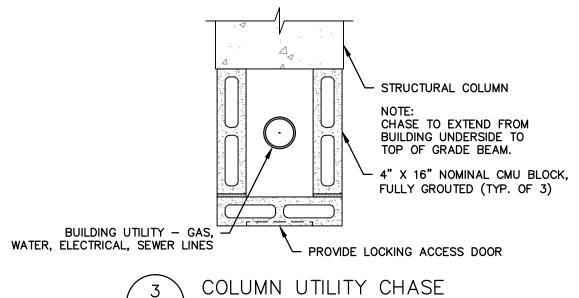

COLUMN UTILITY CHASE A-3.1 1" = 1'-0"

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MARTINEZ COUCH & ASSOCIATES ENGINEERING • LAND SURVEYING • ENVIRONMENTAL CONSTRUCTION INSPECTION • GIS • WASTEWATER


1084 Cromwell Avenue, Suite A-2 Rocky Hill, CT 06067 Telephone: (860) 436-4364 Fax: (860) 436-4626 www.martinezcouch.com

PROJECT 2203 700 EAST BROADWAY MILFORD, CONNECTICUT 06460 ISSUED FOR BIDDING TON CONSTRUCTION

3	8/28/2017	ISSUED FOR RE-BIE)		MBR	MBR	REC
2	4/26/2017	ISSUED FOR BIDDING			MBR	MBR	REC
1	4/14/2017	ISSUED FOR REVIEW			MBR	MBR	REC
NO.	DATE	REVISIONS			BY	СНК	APPV
DRAWN: KNL		CHECKED: MBR	APPROVED: REC	SCALE: AS NOTED	DATE: 3/2/2017		

ARCHITECTURAL DETAILS

JOB NO.	DRAWING NUMBER	SHEET
33-262-2203	33-262-2203 - BASEMAP.dwg	A-3.1

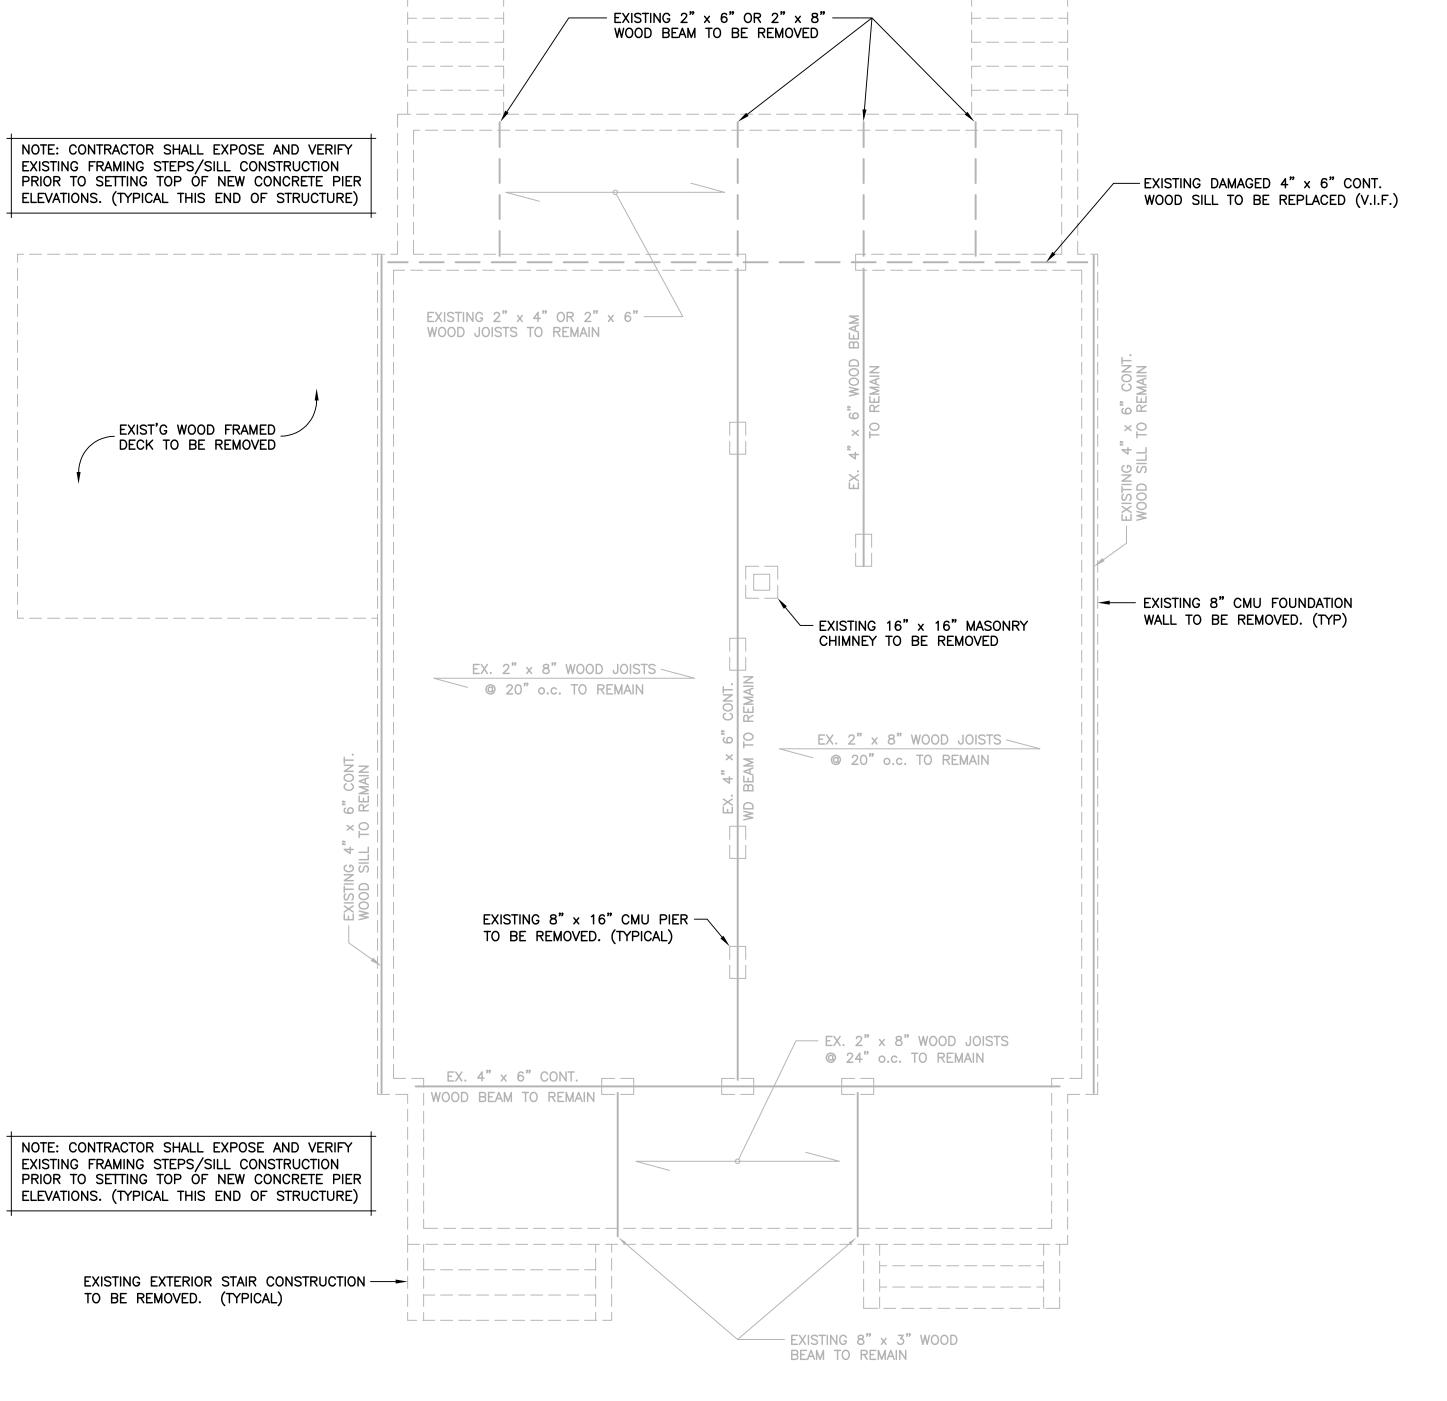

EXISTING CONDITIONS PLAN

SCALE: 1/4" = 1'-0"

NOTES:

- 1. THE EXISTING WOOD FRAMED SUPERSTRUCTURE SHALL BE ADEQUATELY SHORED PRIOR TO DEMOLITION OF EXISTING FOUNDATION CONSTRUCTION.
- 2. REFER TO THE ACCOMPANYING DRAWINGS FOR PLANS, DETAILS AND ADDITIONAL REQUIREMENTS RELATED TO THE NEW FOUNDATION AND FRAMING CONSTRUCTION TO SUPPORT THE EXISTING SUPERSTRUCTURE TO BE ELEVATED.
- 3. CONDITIONS SHOWN ARE BASED SOLELY ON AVAILABLE INFORMATION AND HAVE NOT BEEN INDEPENDENTLY VERIFIED TO BE COMPLETELY ACCURATE.

THOMAS A. TORRENTI, P.C.

Consulting Engineers

316 Dogburn Lane P.O. Box 1153 Orange, CT 06477-7153 ttorrenti@optonline.net

ISSUED FOR RE-BID 8/29/2017 DEB | TAT | TAT DEB TAT TAT 4/26/2017 ISSUED FOR BIDDING 3/15/2017 ISSUED FOR REVIEW DEB | TAT | TAT DATE REVISIONS BY CHK APPV 3/2/2017 | THOMAS A. TORRENTI, P.E. DRAWN BY: DEB CHECKED BY: TAT SCALE: AS NOTED

FOUNDATION DESIGN

..ASTM A325

...ASTM E 70

875 PSI

825 PSI

385 PSI

1,827 PSI

197 PSI 1,397 PSI

368 PSI

 $. F_{c} = 1,508 PSI$

E = 1,460,000 PSI

 $.. F_c = 1,050 PSI$

E = 1,700,000 PSI

95 PSI

.2012 INTERNATIONAL RESIDENTIAL CODE +

2016 CONNECTICUT AMENDMENT

SHOP DRAWINGS ARE TO BE CHECKED BY THE CONTRACTOR AND BEAR THE

THE CONTRACTOR SHALL VERIFY ALL DIMENSIONS, ELEVATIONS, ANGLES, AND EXISTING

PROCEDURE AND SEQUENCE, AND TO ENSURE THE SAFETY OF THE BUILDING AND ITS

ALL NEW FOUNDATIONS SHALL BE SUPPORTED BY NEW HELICAL PILES MANUFACTURED

ALL HELICAL PILES SHALL DEVELOP A MINIMUM ALLOWABLE LOAD CARRYING CAPACITY

ALL HELICAL PILES SHALL BE DESIGNED BY A PROFESSIONAL ENGINEER LICENSED IN THE STATE OF CONNECTICUT. THE PROPOSED HELICAL PILE SHALL HAVE A MINIMUM SHAFT SIZE OF 3 1/2" OUTSIDE DIAMETER x 0.300" WALL THICKNESS, BE FILLED SOLID w/ GROUT AND BE HOT DIP GALVANIZED IN ACCORDANCE WITH ASTM 123 AND BE SUBMITTED FOR APPROVAL PRIOR TO COMMENCEMENT OF ANY WORK. SUBMITTAL

ALL CONCRETE SHALL DEVELOP A MINIMUM COMPRESSIVE STRENGTH OF 5,000 PSI

OTHERWISE NOTED, MUST FOLLOW THE LATEST ACI CODE AND LATEST ACI "MANUAL

ALL REINFORCING STEEL SHALL BE EPOXY COATED IN ACCORDANCE WITH ASTM A775.

ALL STRUCTURAL STEEL AND CONNECTION HARDWARE SHALL BE HOT DIP GALVANIZED

ALL WELDING SHALL BE DONE BY A CERTIFIED WELDER IN ACCORDANCE WITH A.W.S.

ALL STRUCTURAL STEEL, FROM DELIVERY TO THE JOB SITE TO AFTER ERECTION SHALL

STRUCTURAL LUMBER USED FOR BRIDGING, BLOCKING AND OTHER MISCELLANEOUS

FRAMING SHALL BE NOT LESS THAN NO. 2 GRADE DOUGLAS FIR AND SHALL HAVE

MOISTURE CONTENT OF ALL FRAMING LUMBER WHEN DELIVERED TO THE PROJECT SITE

NAILING AND OTHER FASTENING SHALL BE AS PER TABLE 2304.9.1, FASTENING

PLYWOOD WALL SHEATHING SHALL BE NOMINAL 5/8" THICK SQUARE EDGE

PLYWOOD ROOF SHEATHING SHALL BE NOMINAL 3/4" THICK SQUARE EDGE

MAINTAIN STRESS-GRADED MOISTURE CONTENT NOT TO EXCEED 19%.

HAVE THE FOLLOWING MINIMUM ALLOWABLE UNIT STRESSES:

ELEMENTS. FOLLOWING ERECTION, JOISTS SHALL BE SHEATHED AND PROTECTED TO

PARALLAM PLUS PSL WOLMANIZED MEMBERS USED FOR BEAMS AND HEADERS SHALL

SCHEDULE, OF THE 2005 STATE OF CONNECTICUT BUILDING CODE.

NO CALCIUM CHLORIDE OR ADMIXTURES CONTAINING MORE THAN 1% CHLORIDE BY

ALL DETAILING, FABRICATION, AND ERECTION OF REINFORCING BARS, UNLESS

OF STANDARD PRACTICE FOR DETAILING REINFORCED CONCRETE STRUCTURES".

SHALL INCLUDE SIZE, STRENGTH, GALVANIZING, DEPTH, SEAT TYPE AND SIZE.

IT IS THE CONTRACTOR'S SOLE RESPONSIBILITY TO FOLLOW ALL APPLICABLE SAFETY

IT IS THE CONTRACTOR'S SOLE RESPONSIBILITY TO DETERMINE CONSTRUCTION

COMPONENT PARTS DURING CONSTRUCTION. THIS INCLUDES THE ADDITION OF

WORK THESE DRAWINGS WITH THOSE OF OTHER TRADES FOR LOCATIONS OF

REFER TO GEOTECHNICAL REPORT FOR SUBSURFACE PREPARATION & RELATED

BY EARTH CONTACT PRODUCTS, LLC, OLATHE KA, OR APPROVED EQUAL.

CHECKER'S INITIALS BEFORE BEING SUBMITTED TO THE ENGINEER.

CODES AND REGULATIONS DURING ALL PHASES OF CONSTRUCTION.

WHATEVER SHORING, BRACING, ETC. THAT MAY BE REQUIRED.

CONDITIONS BEFORE PROCEEDING WITH ANY WORK.

OPENINGS, RECESSES, BUILT-IN WORK, ETC.

OF 10 TONS (20 KIPS) UNLESS OTHERWISE NOTED.

INSTALL ONE (1) TEST PILE PRIOR TO CONSTRUCTION.

AT 28 DAYS. CONTRACTOR TO SUBMIT CONCRETE MIX DESIGN.

WEIGHT OF ADMIXTURE SHALL BE USED IN THE CONCRETE.

UNLESS OTHERWISE NOTED, ALL LAP SPLICES SHALL BE CLASS B.

PROVIDE 5% TO 7% AIR ENTRAINMENT IN ALL CONCRETE.

ANGLES, MISCELLANEOUS PLATES AND BARS....

CONFORM TO ALL REQUIREMENTS OF ASTM A6.

THE FOLLOWING MINIMUM ALLOWABLE UNIT STRESSES:

EXTERIOR GRADE CDX AND CONTAIN (4) INNER PLIES.

ENGINEERED WOOD PRODUCTS

COMPRESSION PERPENDICULAR TO GRAIN..

FOUNDATION NOTES

REQ'MENTS.

HELICAL PILES

CONCRETE

STRUCTURAL STEEL

IN ACCORDANCE WITH ASTM A123.

STRUCTURAL LUMBER

EXTREME FIBER IN BENDING.

TENSION PARALLEL TO GRAIN..

MODULUS OF ELASTICITY ..

SHALL NOT EXCEED 19%.

EXTREME FIBER IN BENDING.

TENSION PARALLEL TO GRAIN..

COMPRESSION PARALLEL TO GRAIN.

HORIZONTAL SHEAR..

MODULUS OF ELASTICITY.

COMPRESSION PERPENDICULAR TO GRAIN..

COMPRESSION PARALLEL TO GRAIN...

HORIZONTAL SHEAR..

EXTERIOR GRADE.

WELDING ELECTRODE...

MATERIALS:

BOLTS...

STANDARDS.

EXISTING CONDITIONS PLAN & STRUCTURAL NOTES

DRAWING NUMBER SHEET 33-262-2203 21706 S1-S4.dwg

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MILFORD, CONNECTICUT 06460

THIS MAP IS NOT VALID WITHOUT A LIVE SIGNATURE AND SEAL

DESIGN BASIS

GOVERNING CODE

GENERAL NOTES:

