


WALNUT & WILDEMERE BEACH STABILIZATION PROJECT MILFORD, CONNECTICUT


SCHEDULE OF DRAWINGS

1. DUNE AND BEACH NOURISHMENT PLAN
2. DUNE AND BEACH NOURISHMENT PLAN
3. DUNE AND BEACH NOURISHMENT PLAN
4. DUNE AND BEACH NOURISHMENT PLAN
5. DUNE AND BEACH NOURISHMENT PLAN
6. DUNE AND BEACH NOURISHMENT PLAN
7. DUNE AND BEACH NOURISHMENT PLAN
8. DUNE AND BEACH NOURISHMENT PLAN
9. DUNE AND BEACH NOURISHMENT PLAN
10. DUNE AND BEACH NOURISHMENT PLAN
11. DUNE AND BEACH NOURISHMENT PLAN
12. DUNE AND BEACH NOURISHMENT PLAN
13. WILDEMERE BEACH DUNE & BEACH NOURISHMENT TYPICAL SECTIONS
14. WILDEMERE BEACH DUNE & BEACH NOURISHMENT TYPICAL SECTIONS
15. WILDEMERE BEACH DUNE & BEACH NOURISHMENT TYPICAL SECTIONS
16. STORM DRAIN OUTFALL DETAILS
17. HYDRODYNAMIC SEPARATOR, DIVERSION CHAMBER, AND OUTFALL DETAIL
18. STORM DRAIN DATA TABLE AND OUTFALL DETAILS
19. DUNE PLANTING DETAILS
20. SAND DUNE COIR REINFORCEMENT DETAILS
21. DUNE WALKOVER AND PLANTING DETAILS
22. DUNE CROSS-OVER ANCHORAGE DETAILS
23. EROSION AND SEDIMENT CONTROL DETAILS
24. EROSION AND SEDIMENT CONTROL NOTES

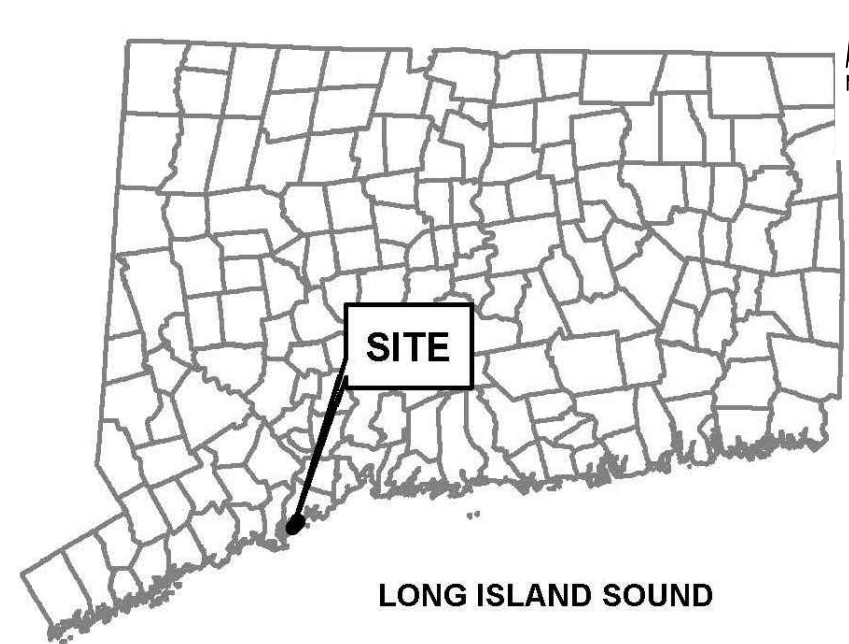

STATE MAP
0 15mi 30mi 60mi
1" = 30mi

PREPARED BY:

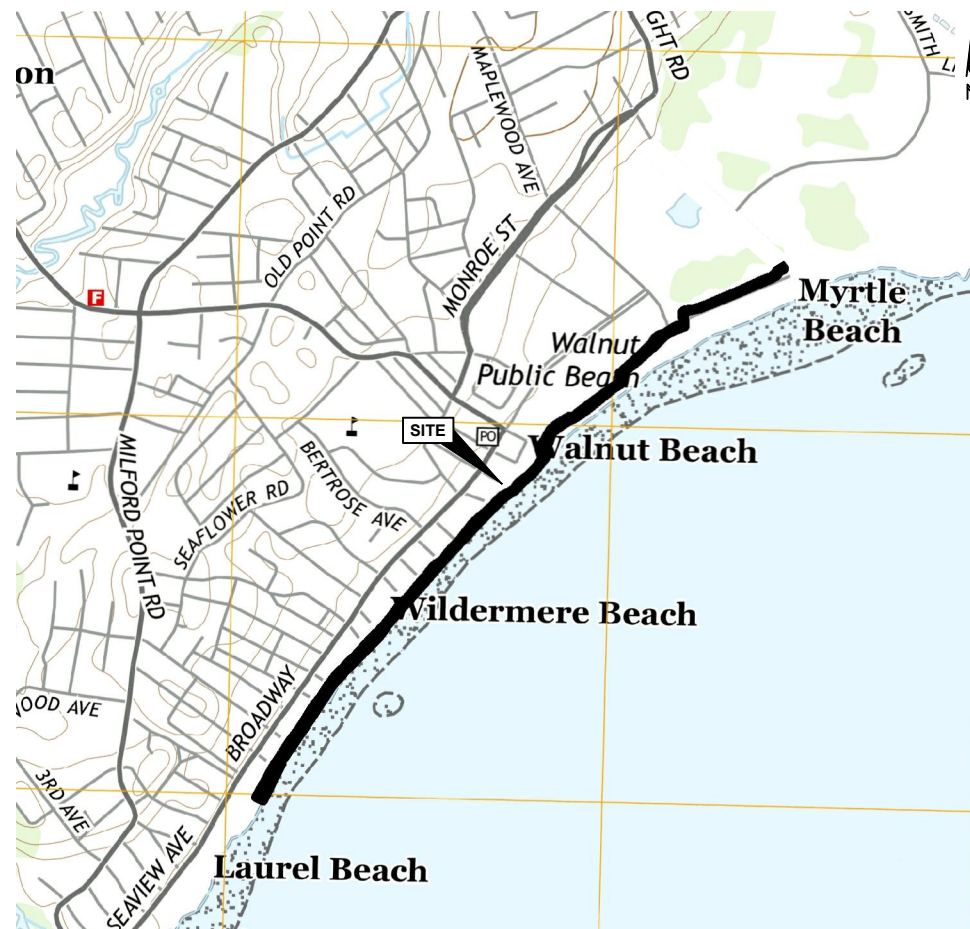


REGIONAL MAP
0 2000 4000
SCALE: 1" = 2000'

PREPARED FOR:
**CITY OF MILFORD
MILFORD, CONNECTICUT**

NOTE: THESE PLANS HAVE BEEN DEVELOPED SOLELY FOR THE PURPOSE OF PERMIT REVIEW AND CONTAIN A LEVEL OF DETAIL COMMENSURATE WITH PERMIT REVIEW REQUIREMENTS.

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|------------|-----|------------|----------------------------------|-----|
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Designed: JM
Checked: BG
Drawn: DE
Approved By: JM

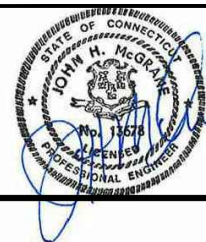Walnut & Wildemere Beach Stabilization Project
Milford, Connecticut

City of Milford
Milford, Connecticut













Project 1700458

COVER/INDEX SHEET

December 2017



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LEGEND:


-  TURBIDITY CURTAIN
-  SEDIMENT FENCE
-  MANHOLE
-  COASTAL JURISDICTION LINE +4.7 (CJL)
-  HIGH TIDE LINE +4.46 (HTL)
-  MEAN HIGH WATER +3.15 (MHW)
-  MEAN LOW WATER -3.60 (MLW)
-  SAND FENCE
-  WETLAND DELINEATION
-  PROPERTY LINE

GENERAL NOTES:

1. THESE PLANS ARE INTENDED FOR PERMIT REVIEW AND APPROVAL PURPOSES ONLY. THEY ARE NOT TO BE USED FOR CONSTRUCTION UNTIL ALL FINAL DETAILS AND CONDITIONS OF PERMIT APPROVAL HAVE BEEN INCORPORATED, AND UNTIL THE PLANS ARE ACCOMPANIED BY A SUITABLE SET OF CONTRACT SPECIFICATIONS THAT FURTHER DEFINE THE WORK.
2. ALL UTILITY INFORMATION SHOWN ON THESE PLANS IS APPROXIMATE IN NATURE. UNDERGROUND UTILITIES MAY EXIST WHICH ARE NOT DEPICTED ON THESE PLANS, OR WHICH ARE NOT IN THE LOCATIONS SHOWN. THE CONTRACTOR ULTIMATELY SELECTED FOR THIS WORK SHALL PERFORM UTILITY IDENTIFICATION AND LOCATION PRIOR TO CONSTRUCTION USING CALL-BEFORE-U-DIG (CBUD) AND OTHER PRIVATE UTILITY IDENTIFICATION SERVICES TO ENSURE THAT ALL UTILITIES ARE LOCATED.
3. PROPERTY LINE INFORMATION SHOWN HAS BEEN OBTAINED FROM CITY OF MILFORD ASSESSOR RECORDS AND IS CONSIDERED RELEVANT FOR THESE PERMIT LEVEL DRAWINGS.
4. BASE SURVEY PREPARED BY MILONE & MACBROOM, INC. TO T-2 TOPOGRAPHIC STANDARDS, AND A-2 STANDARDS FOR HORIZONTAL LOCATIONS.
5. VERTICAL DATUM ON THESE PLANS IS NAVD88.

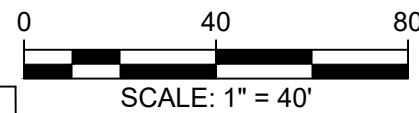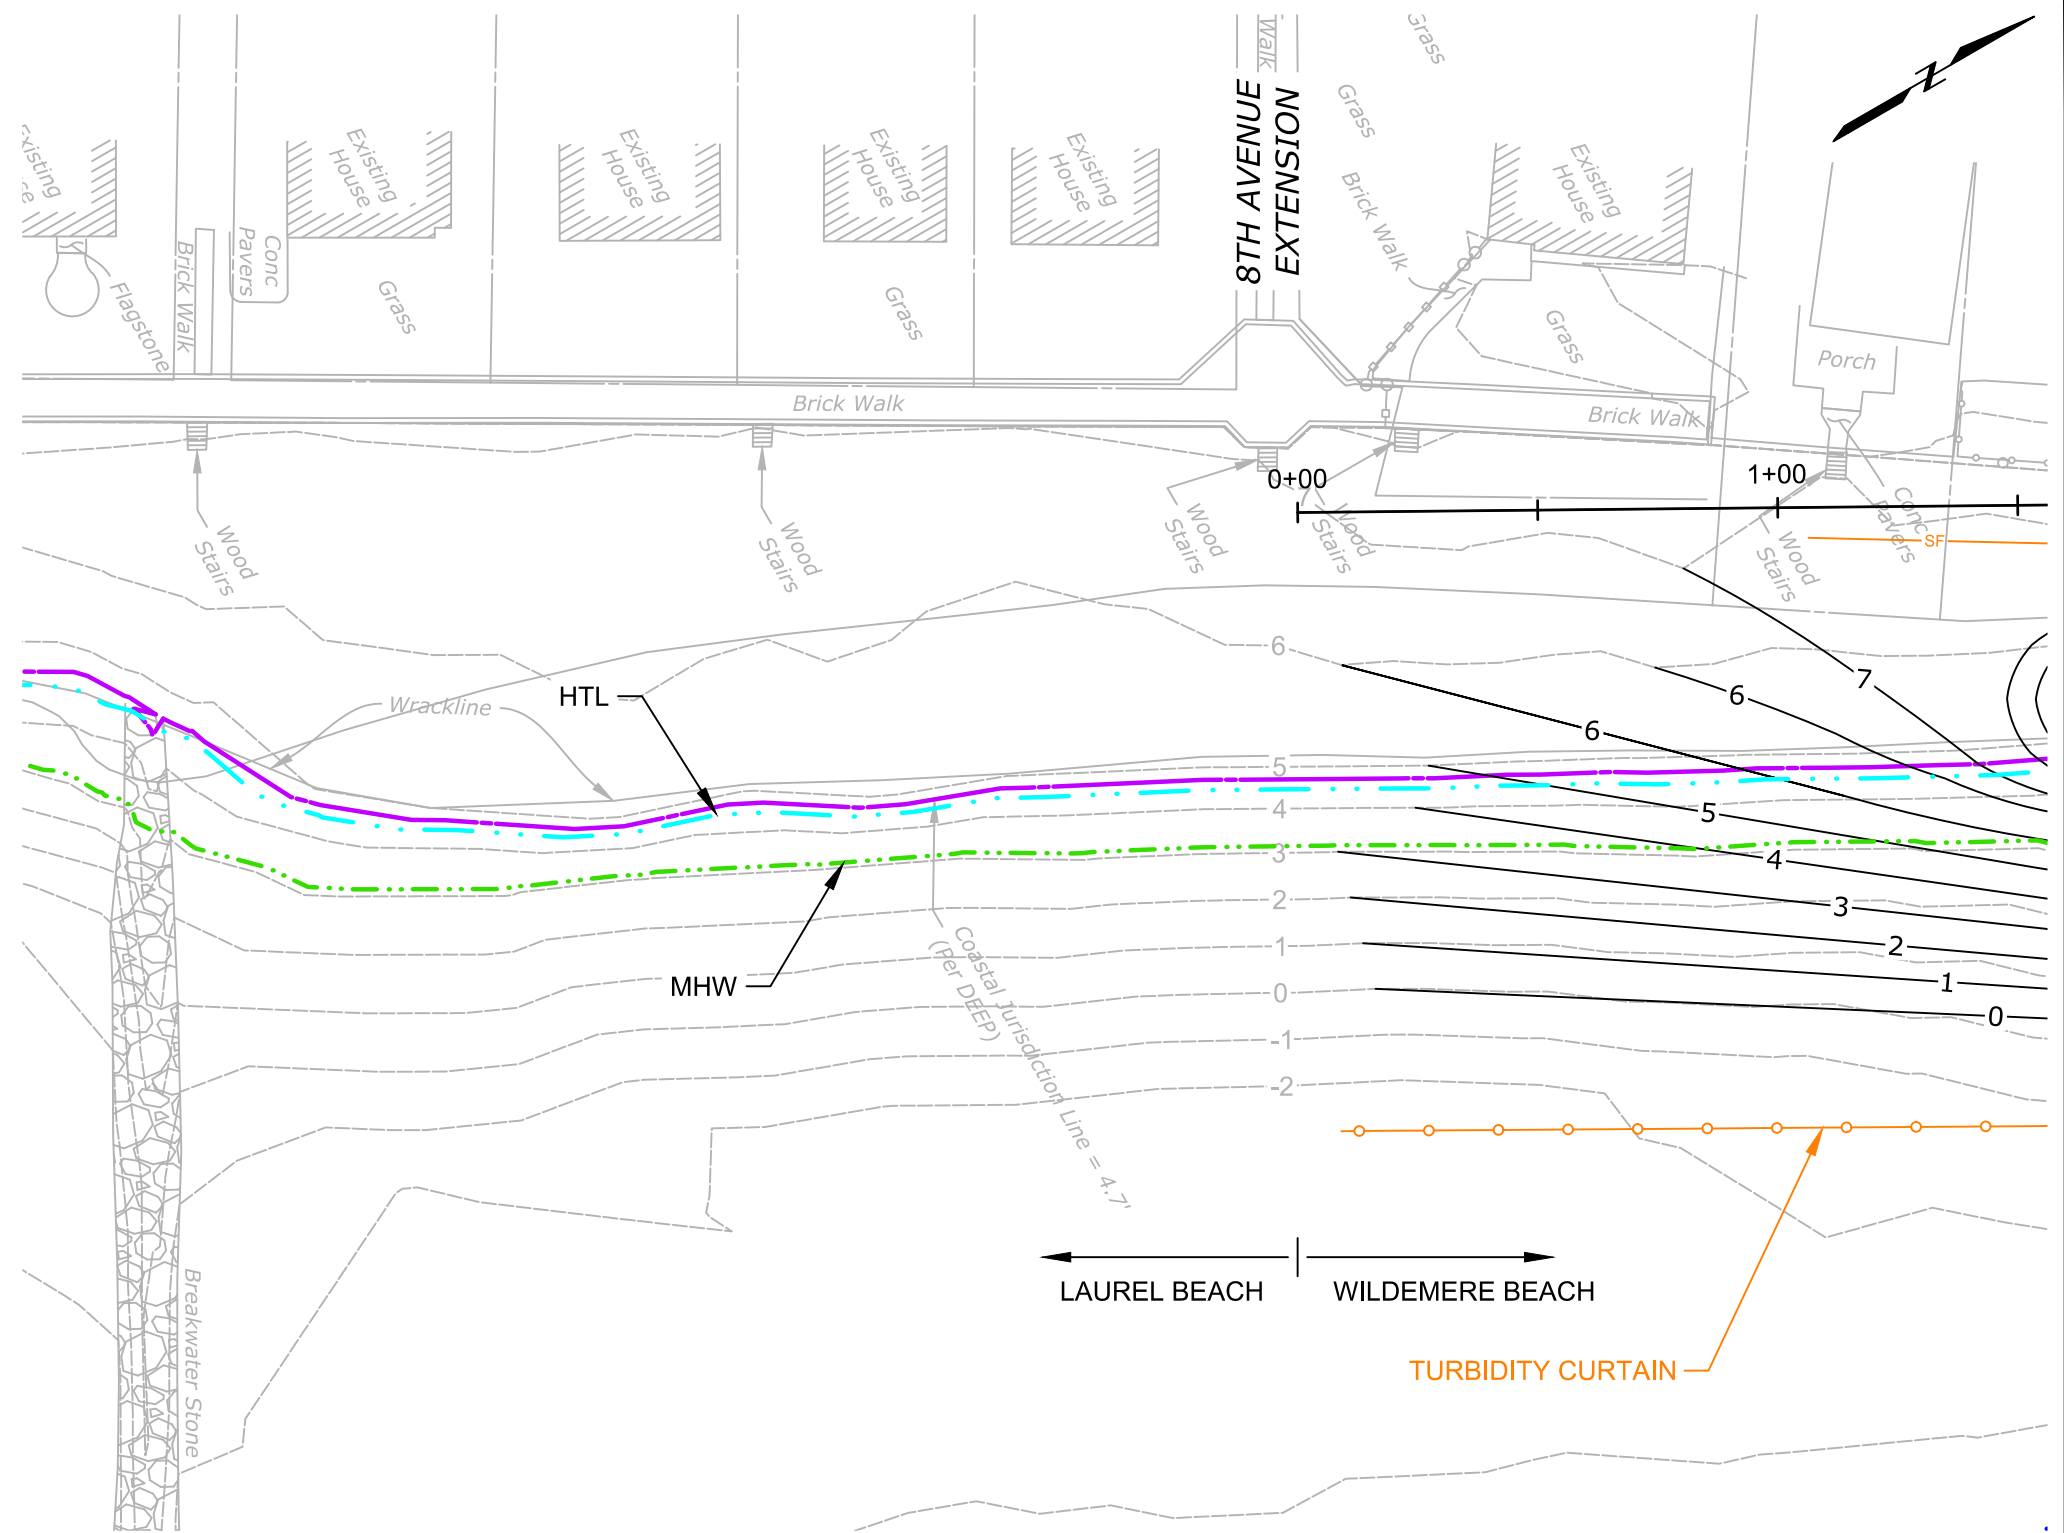

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Attention:

 If this scale bar does not measure 1" then drawing is not original scale.





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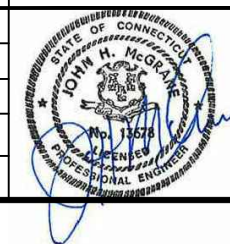
Walnut & Wildemere Beach Stabilization Project
 Milford, Connecticut
 City of Milford
 Milford, Connecticut



DUNE AND BEACH
 NOURISHMENT PLAN
 Project 1700458
 December 2017
 Fig. 1

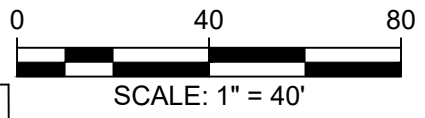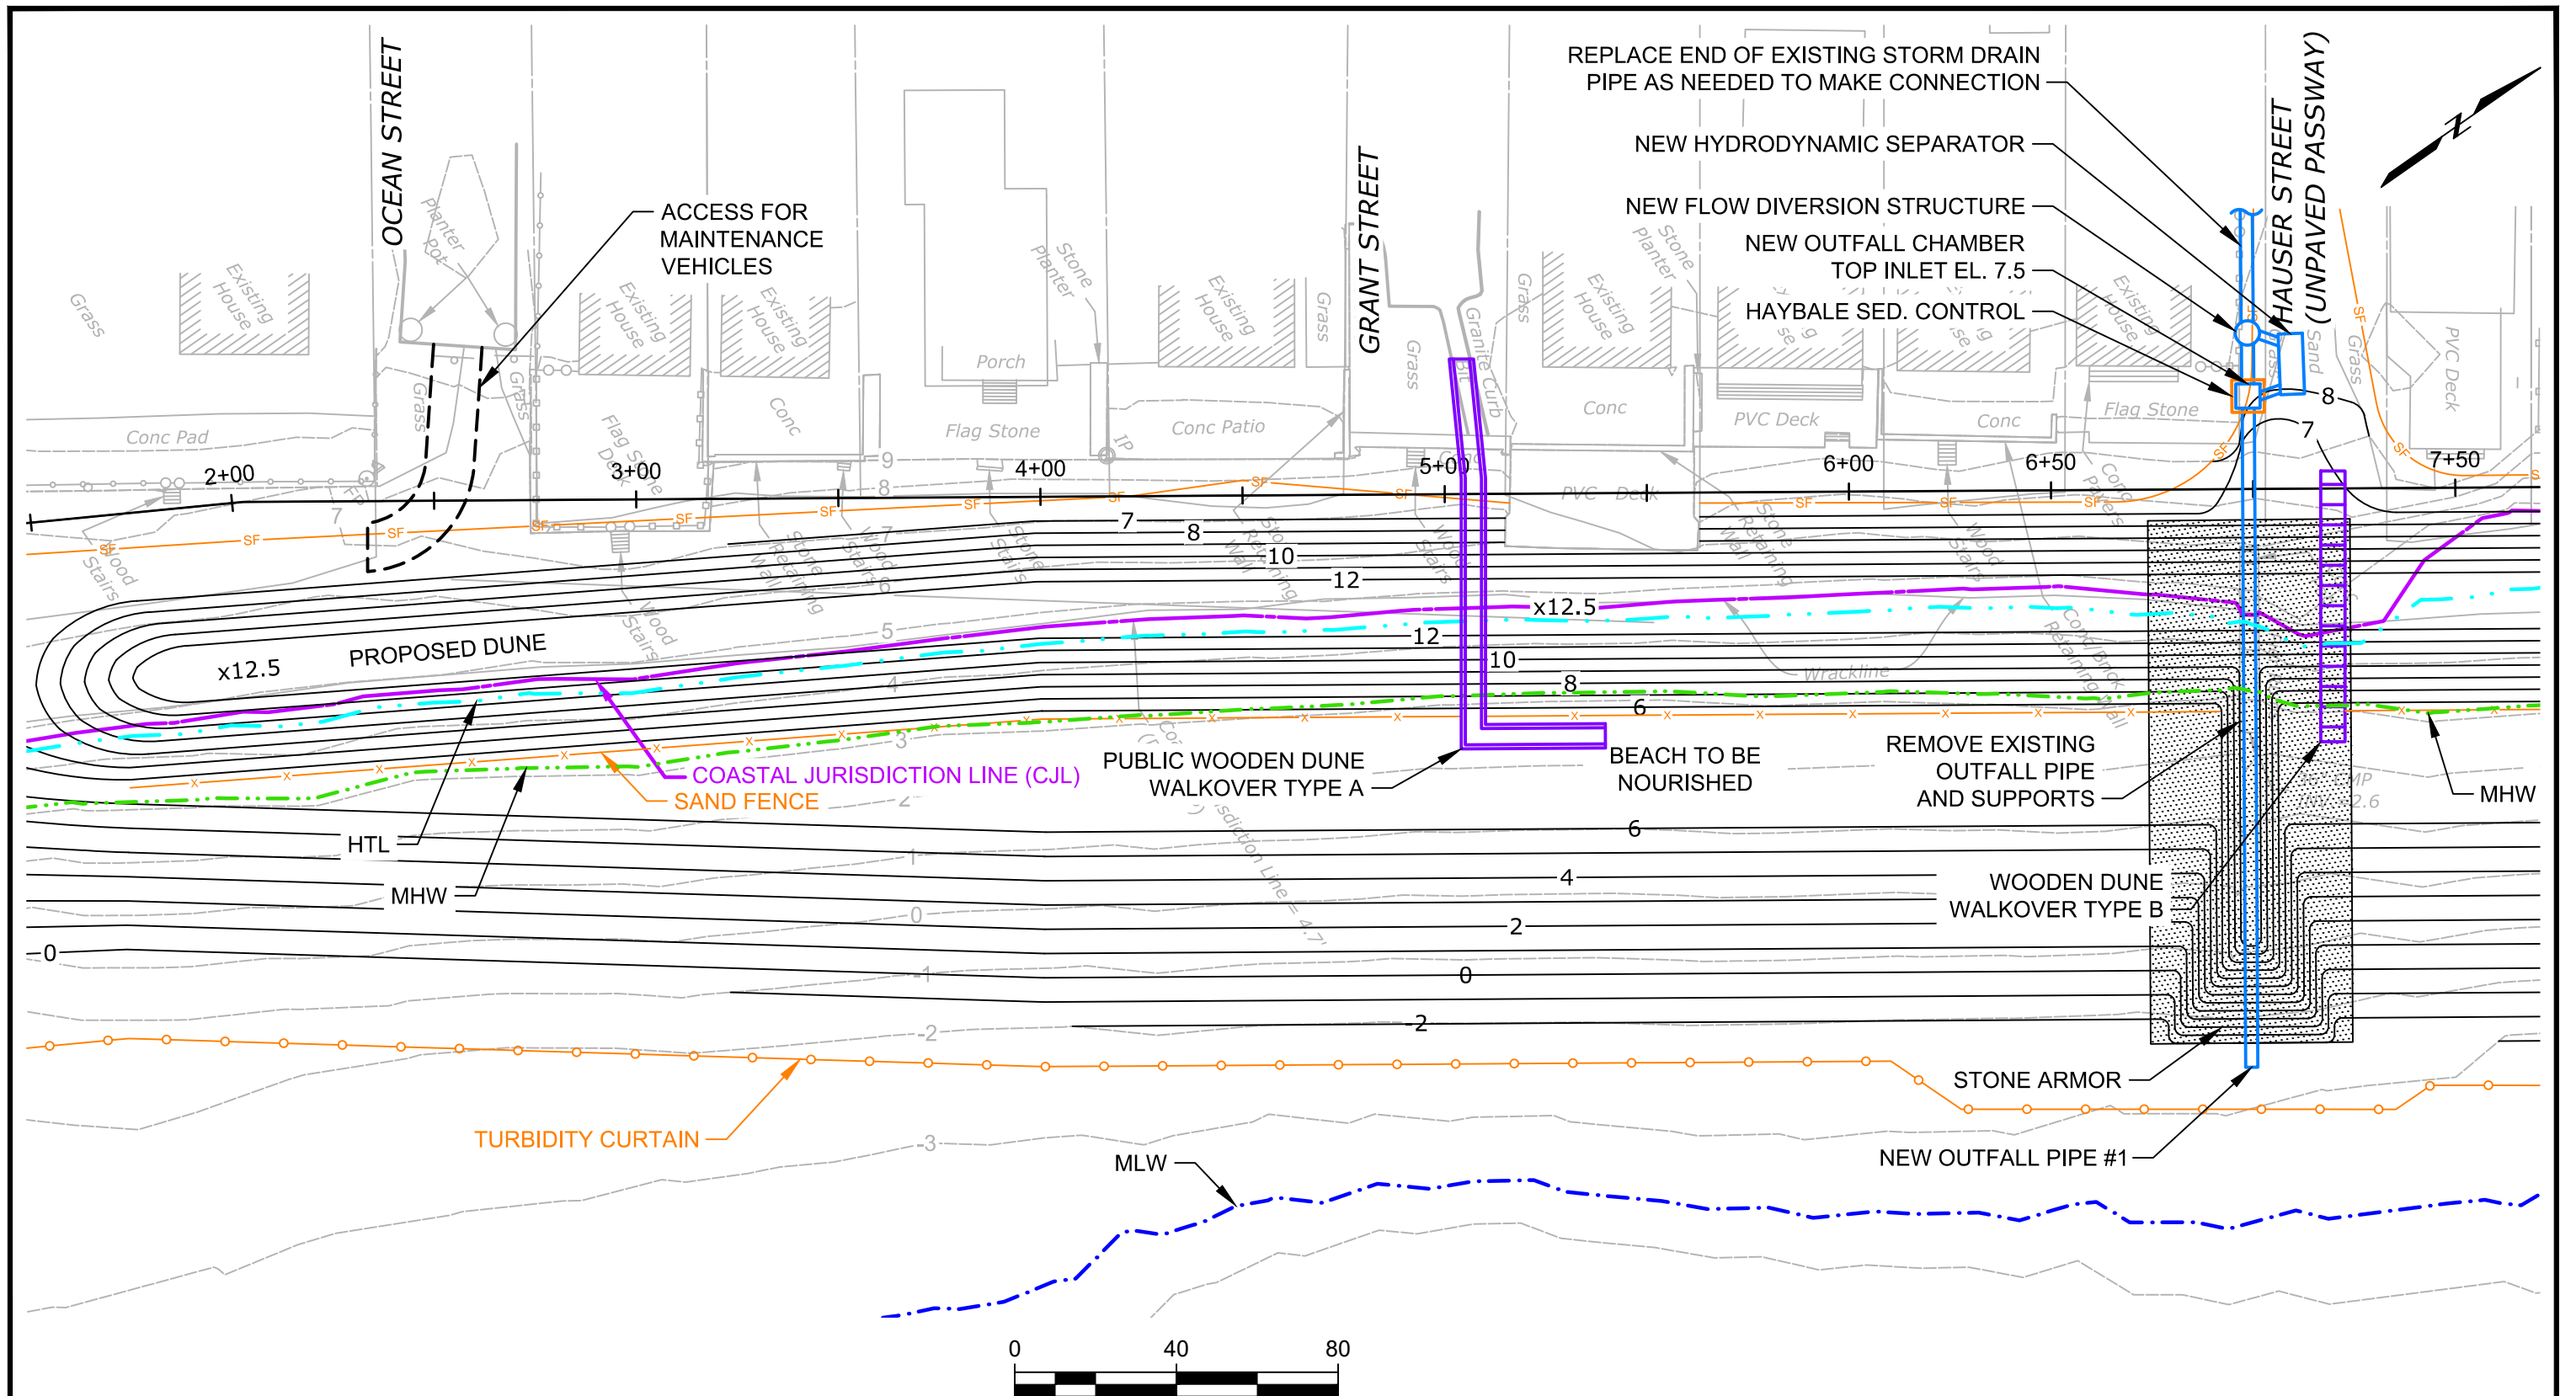

| | | | | |
|------------|-----|------------|----------------------------------|-----|
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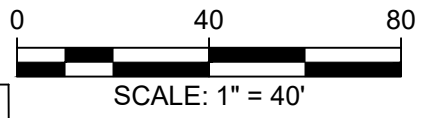
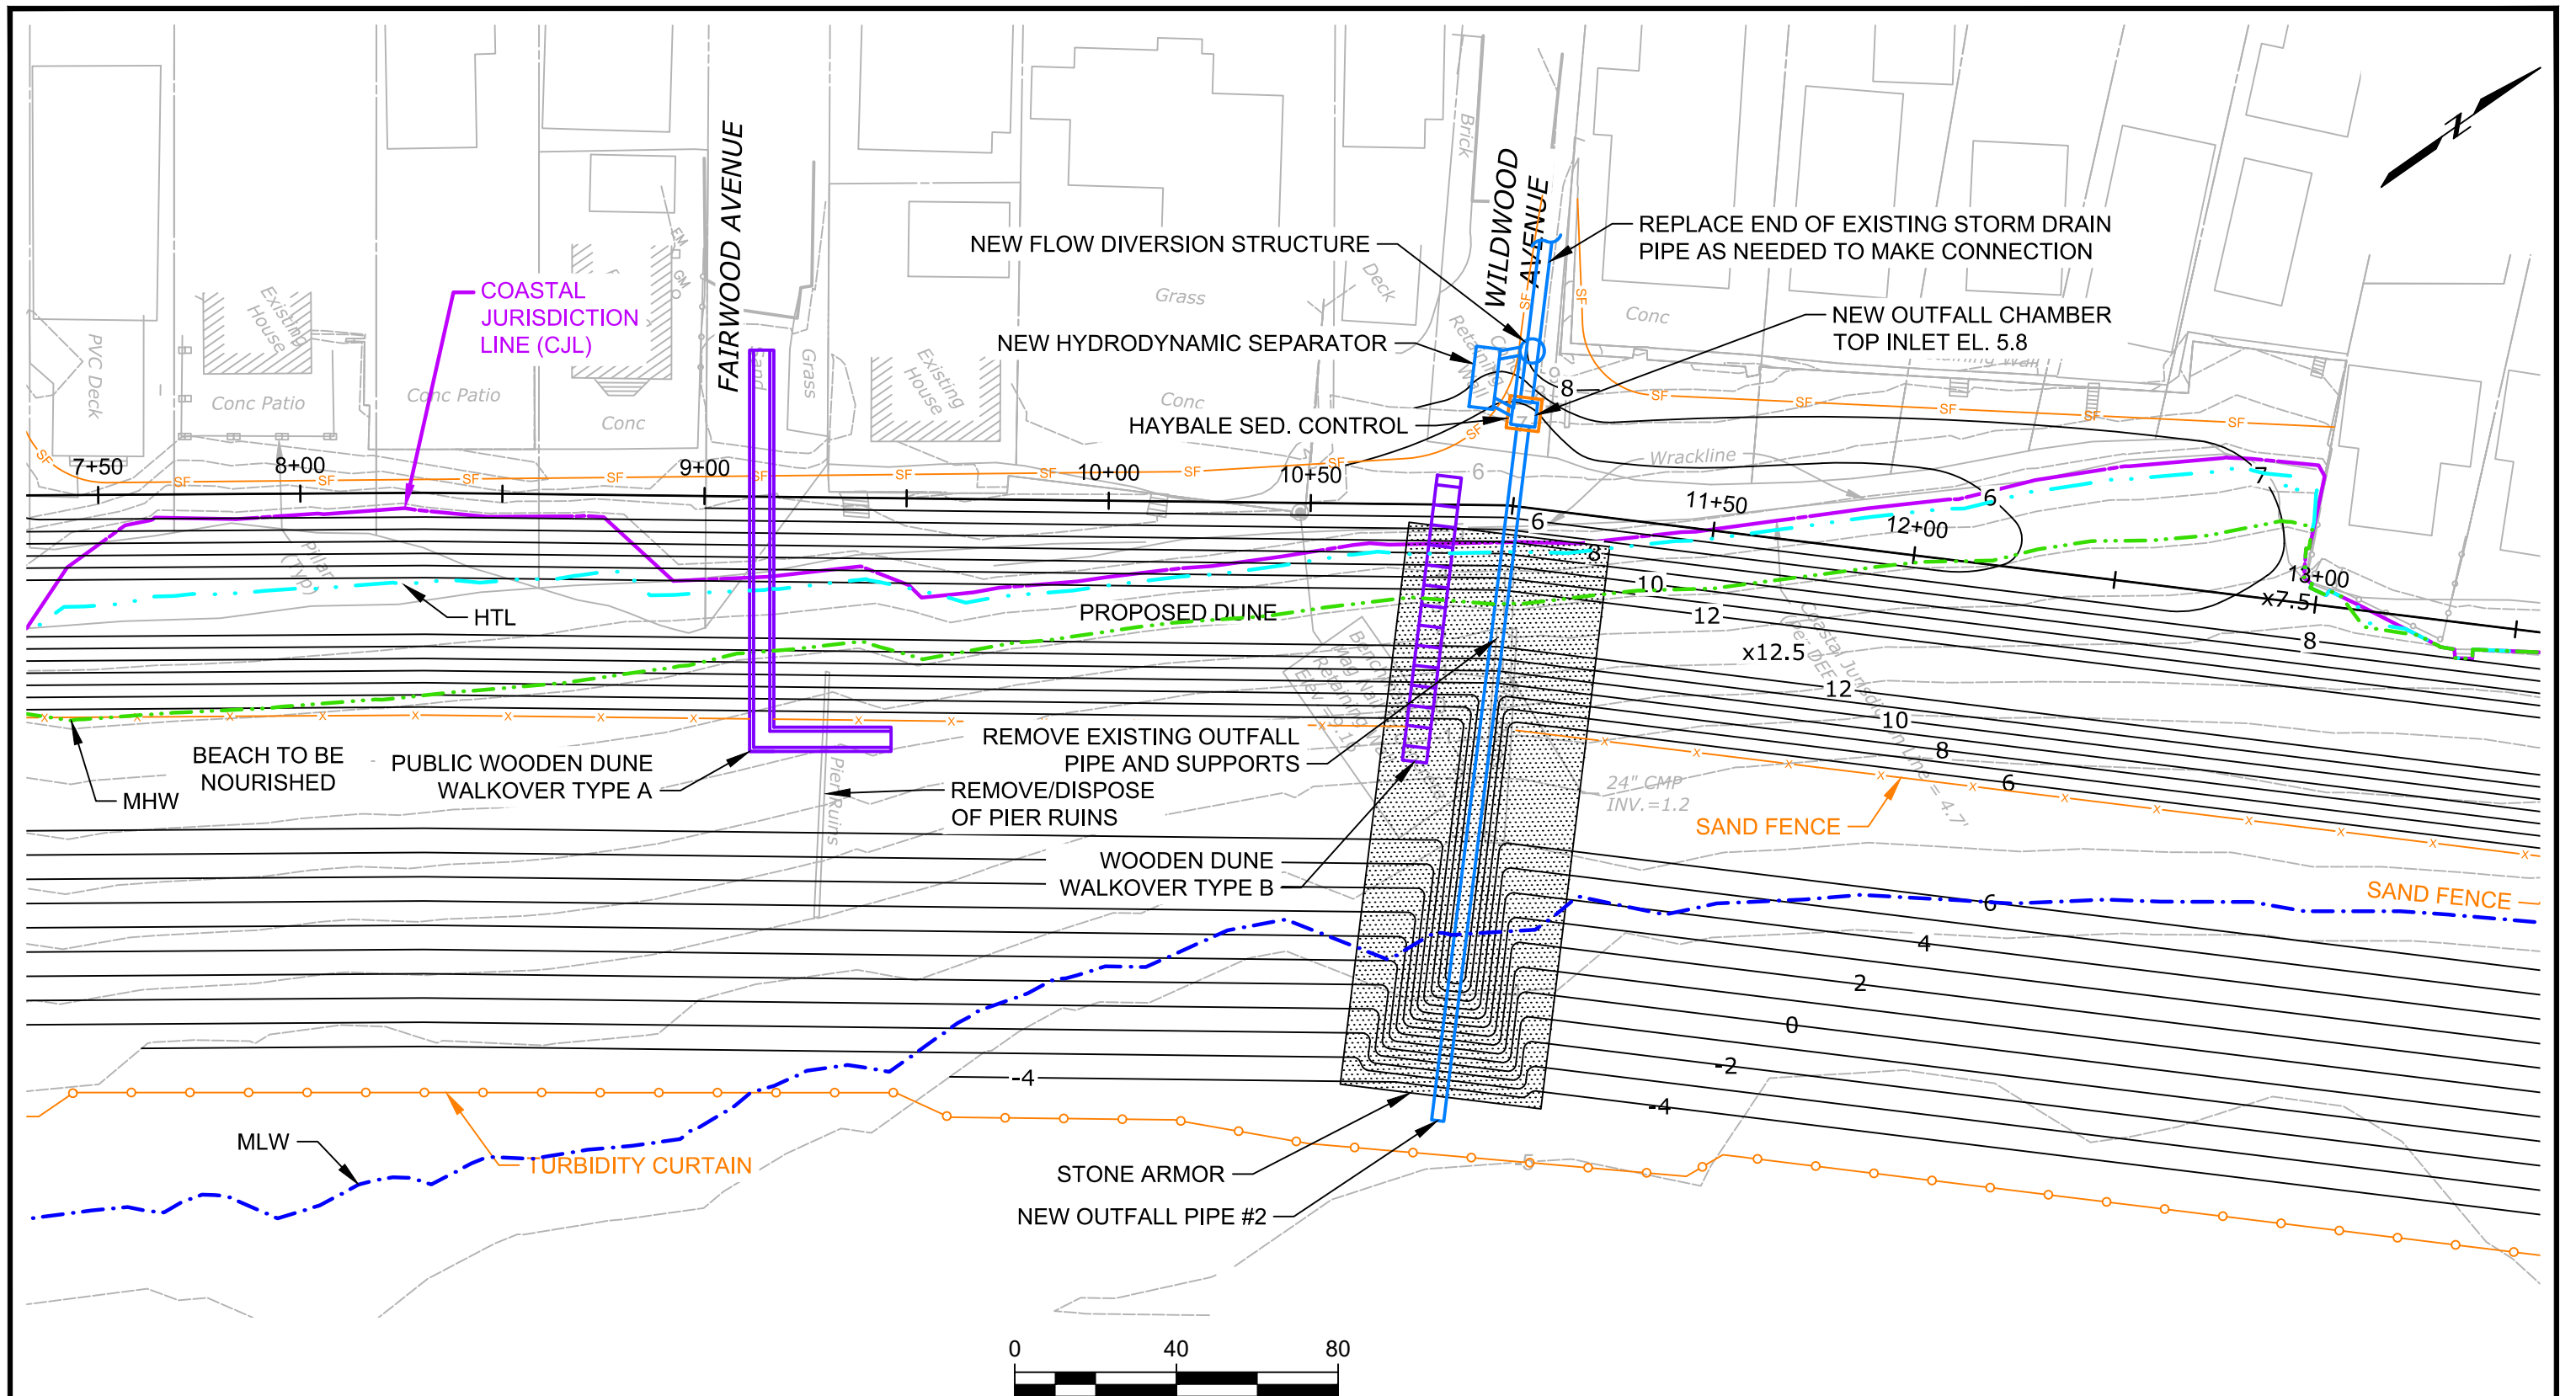
Walnut & Wildemere Beach Stabilization Project
Milford, Connecticut

City of Milford
Milford, Connecticut



DUNE AND BEACH
NOURISHMENT PLAN

Project 1700458 December 2017 Fig. 2



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Attention:
 0 1"
 If this scale bar does not measure 1" then drawing is not original scale.




Designed: JM
 Checked: BG
 Drawn: DE
 Approved By: JM

Walnut & Wildemere Beach Stabilization Project
 Milford, Connecticut
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 Milford, Connecticut



DUNE AND BEACH
 NOURISHMENT PLAN
 Project 1700458
 December 2017
 Fig. 3

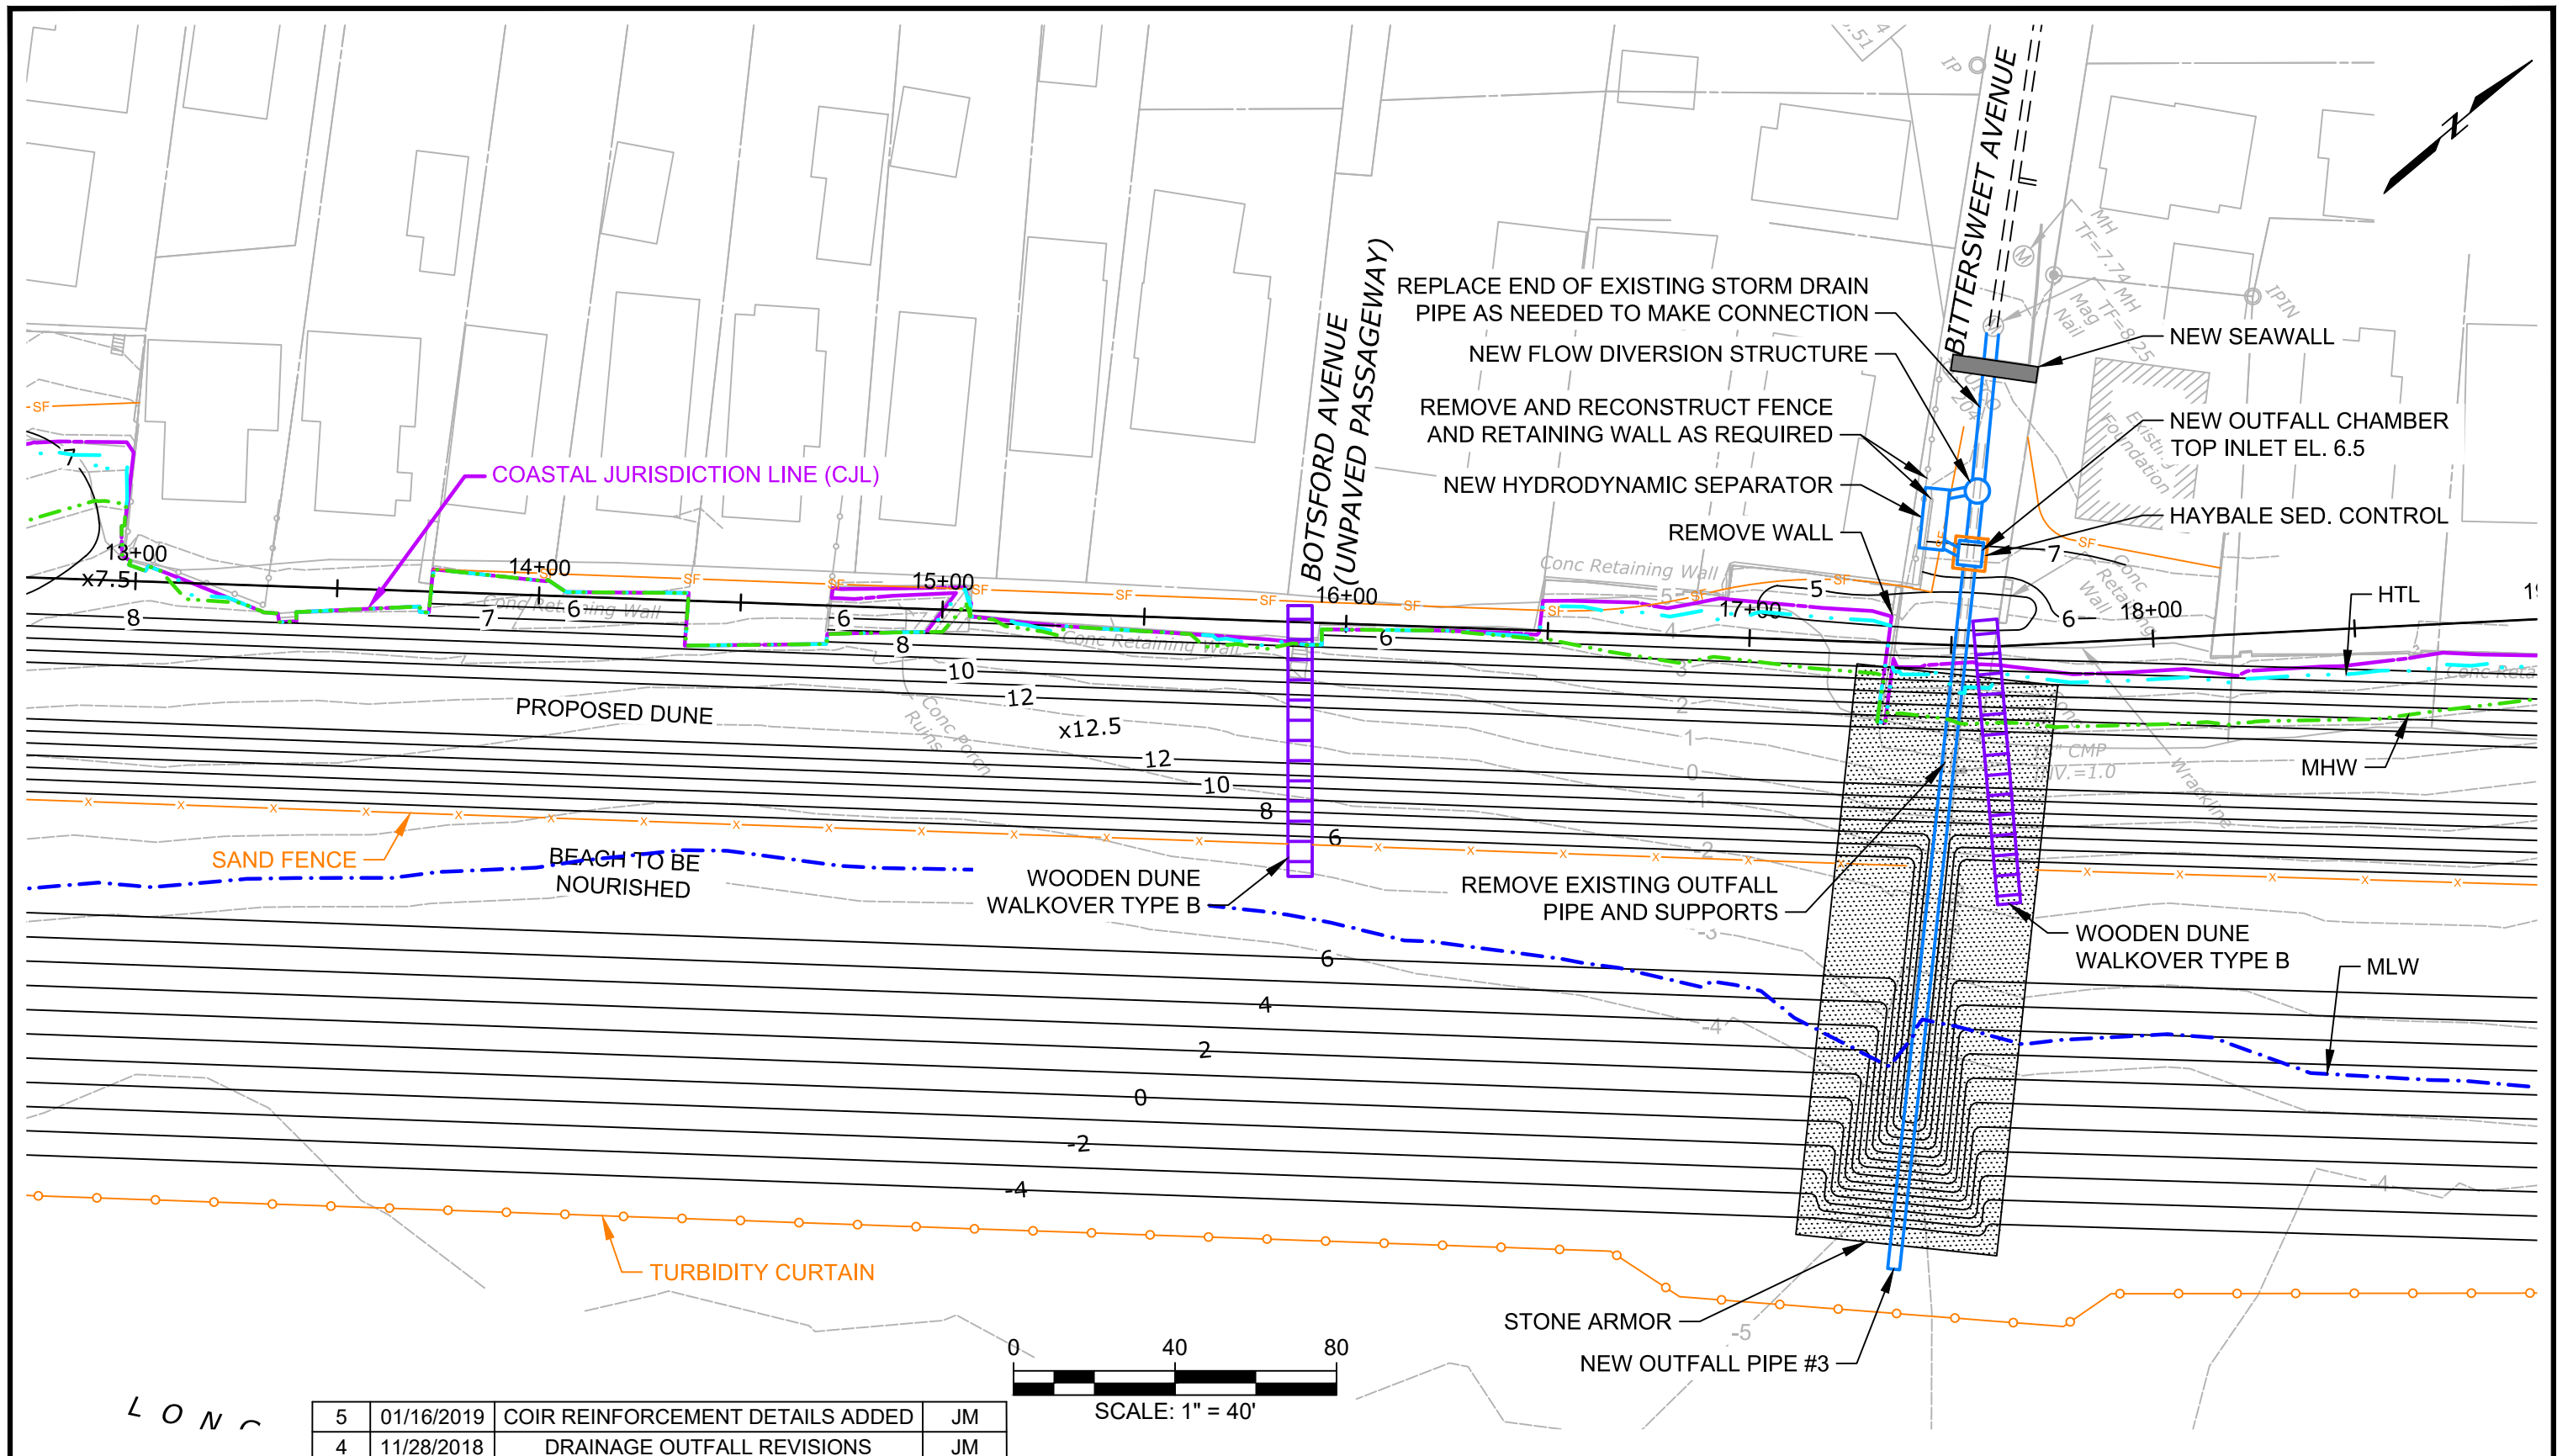


0 40 80
SCALE: 1" = 40'

L O N

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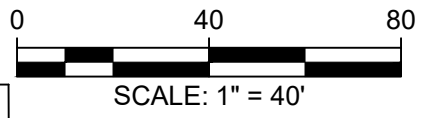
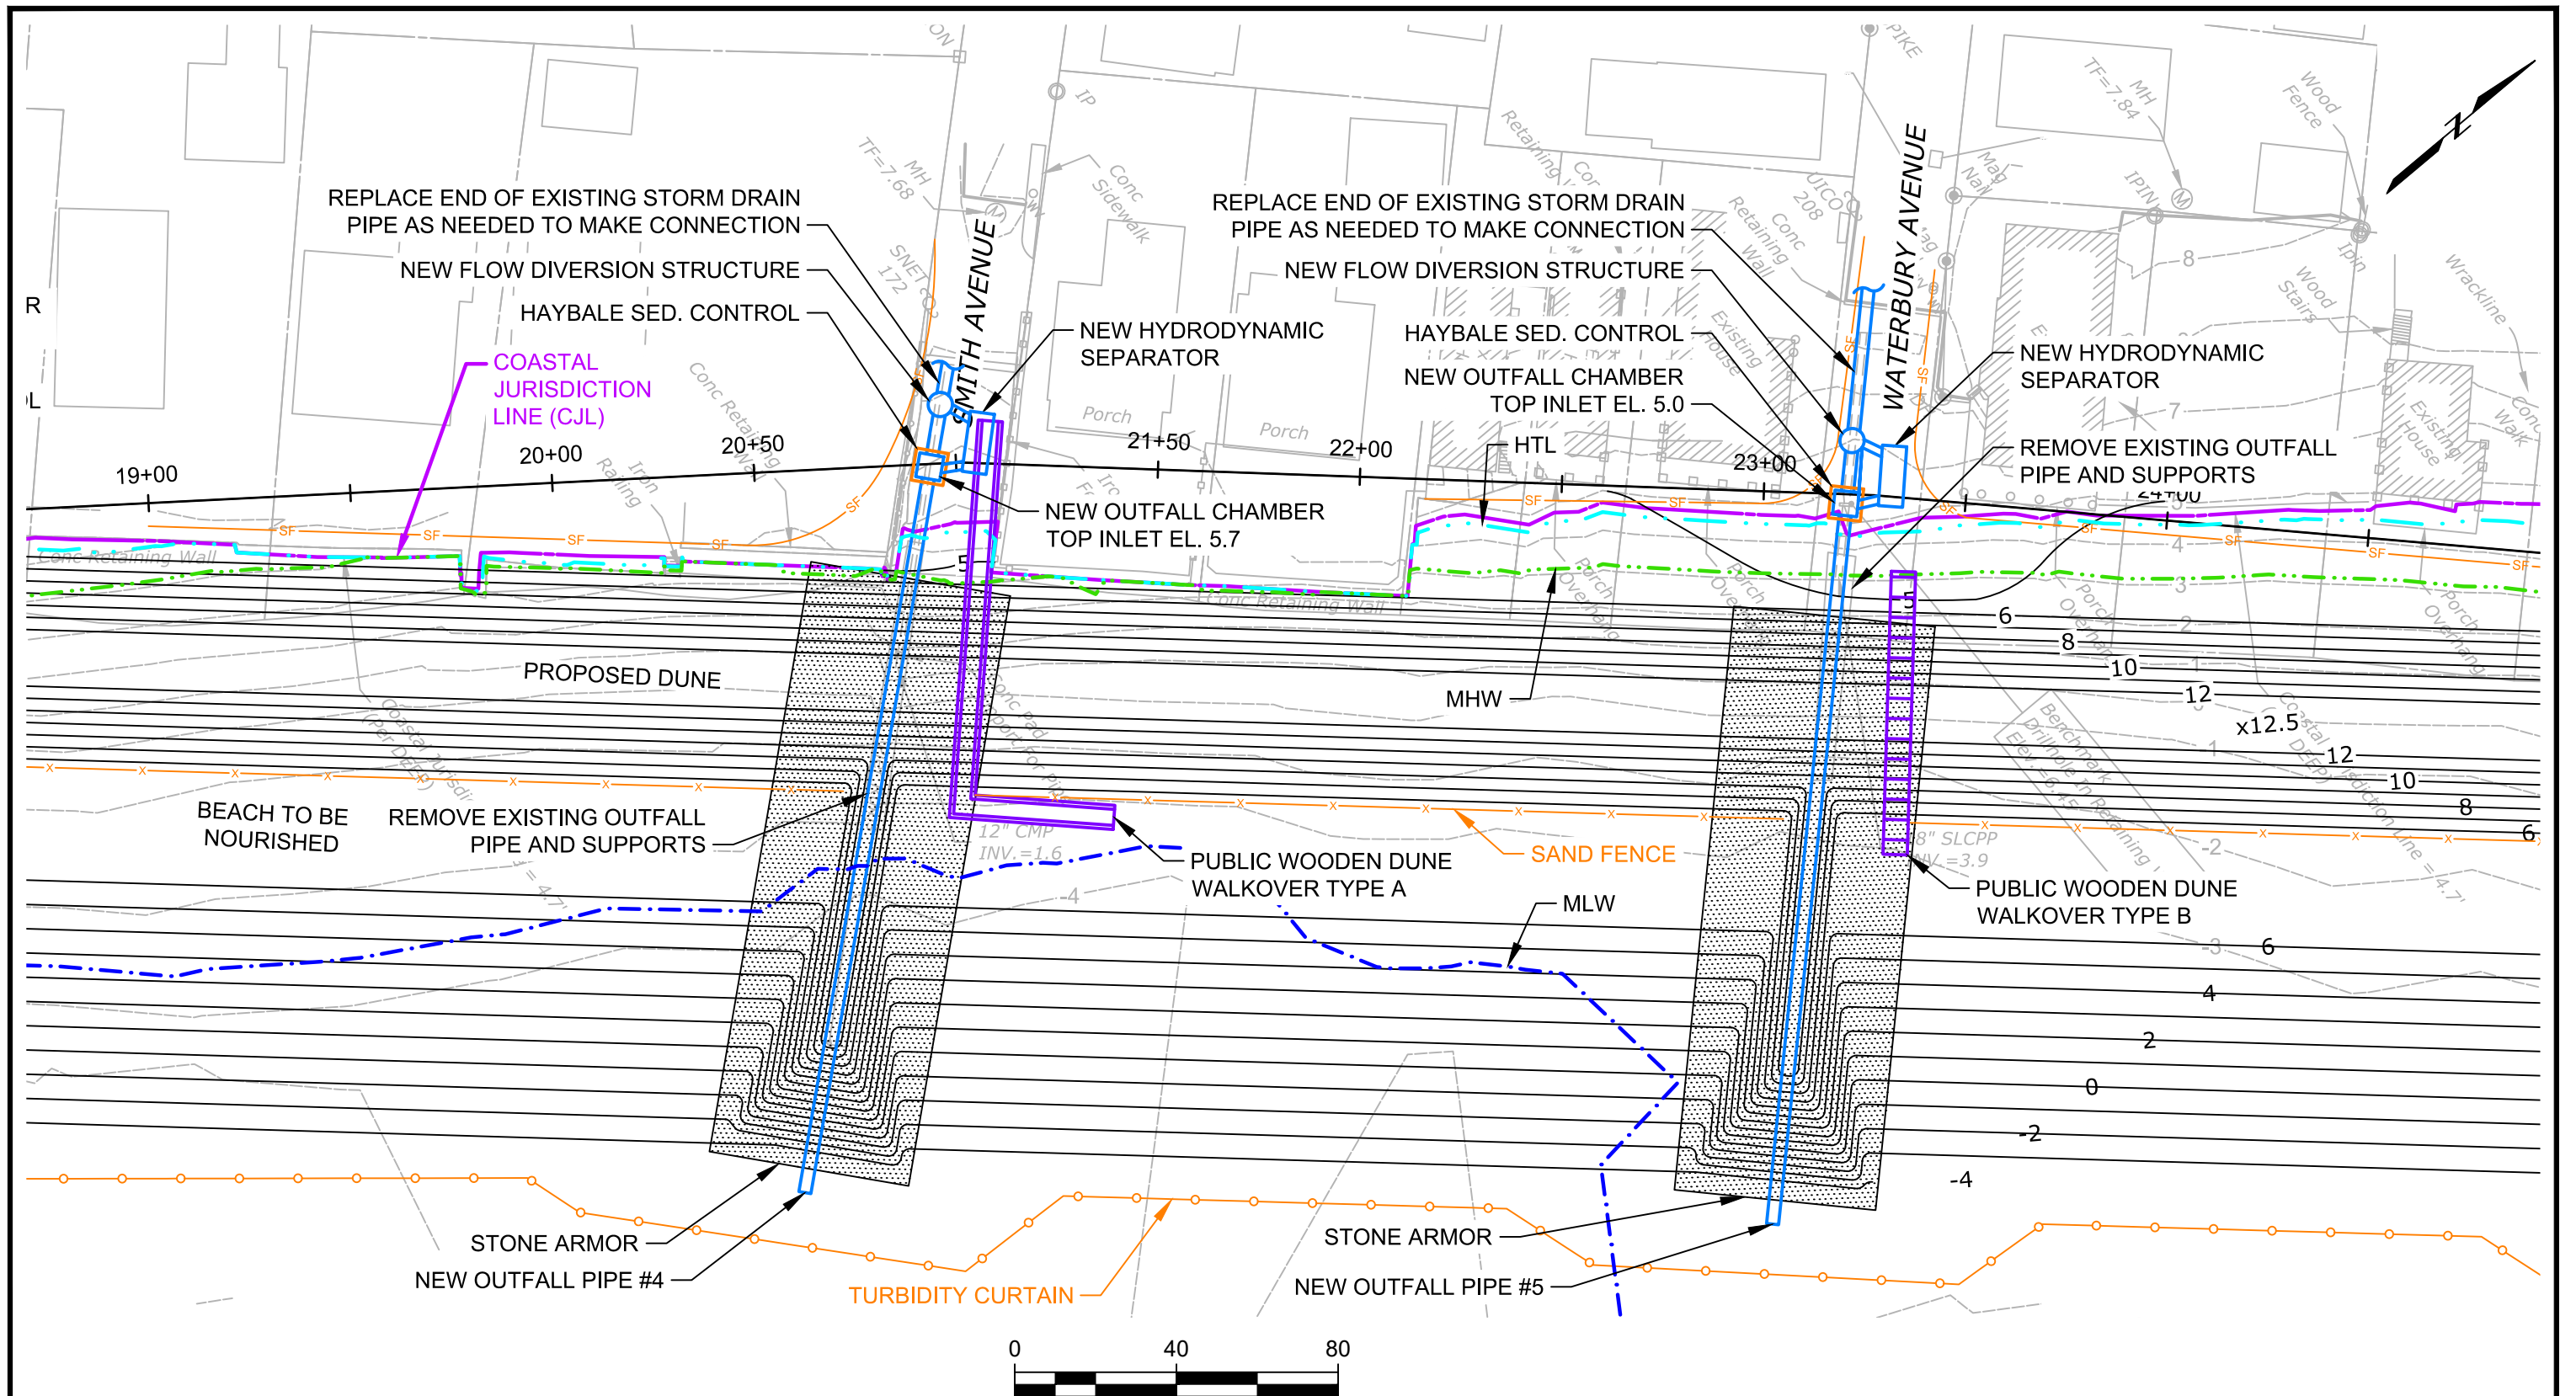


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Drawn: DE
Approved By: JM

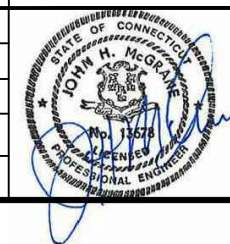Walnut & Wildemere Beach Stabilization Project
Milford, Connecticut
City of Milford
Milford, Connecticut



DUNE AND BEACH NOURISHMENT PLAN
Project 1700458
December 2017
Fig. 4



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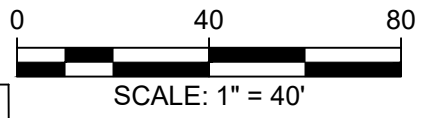
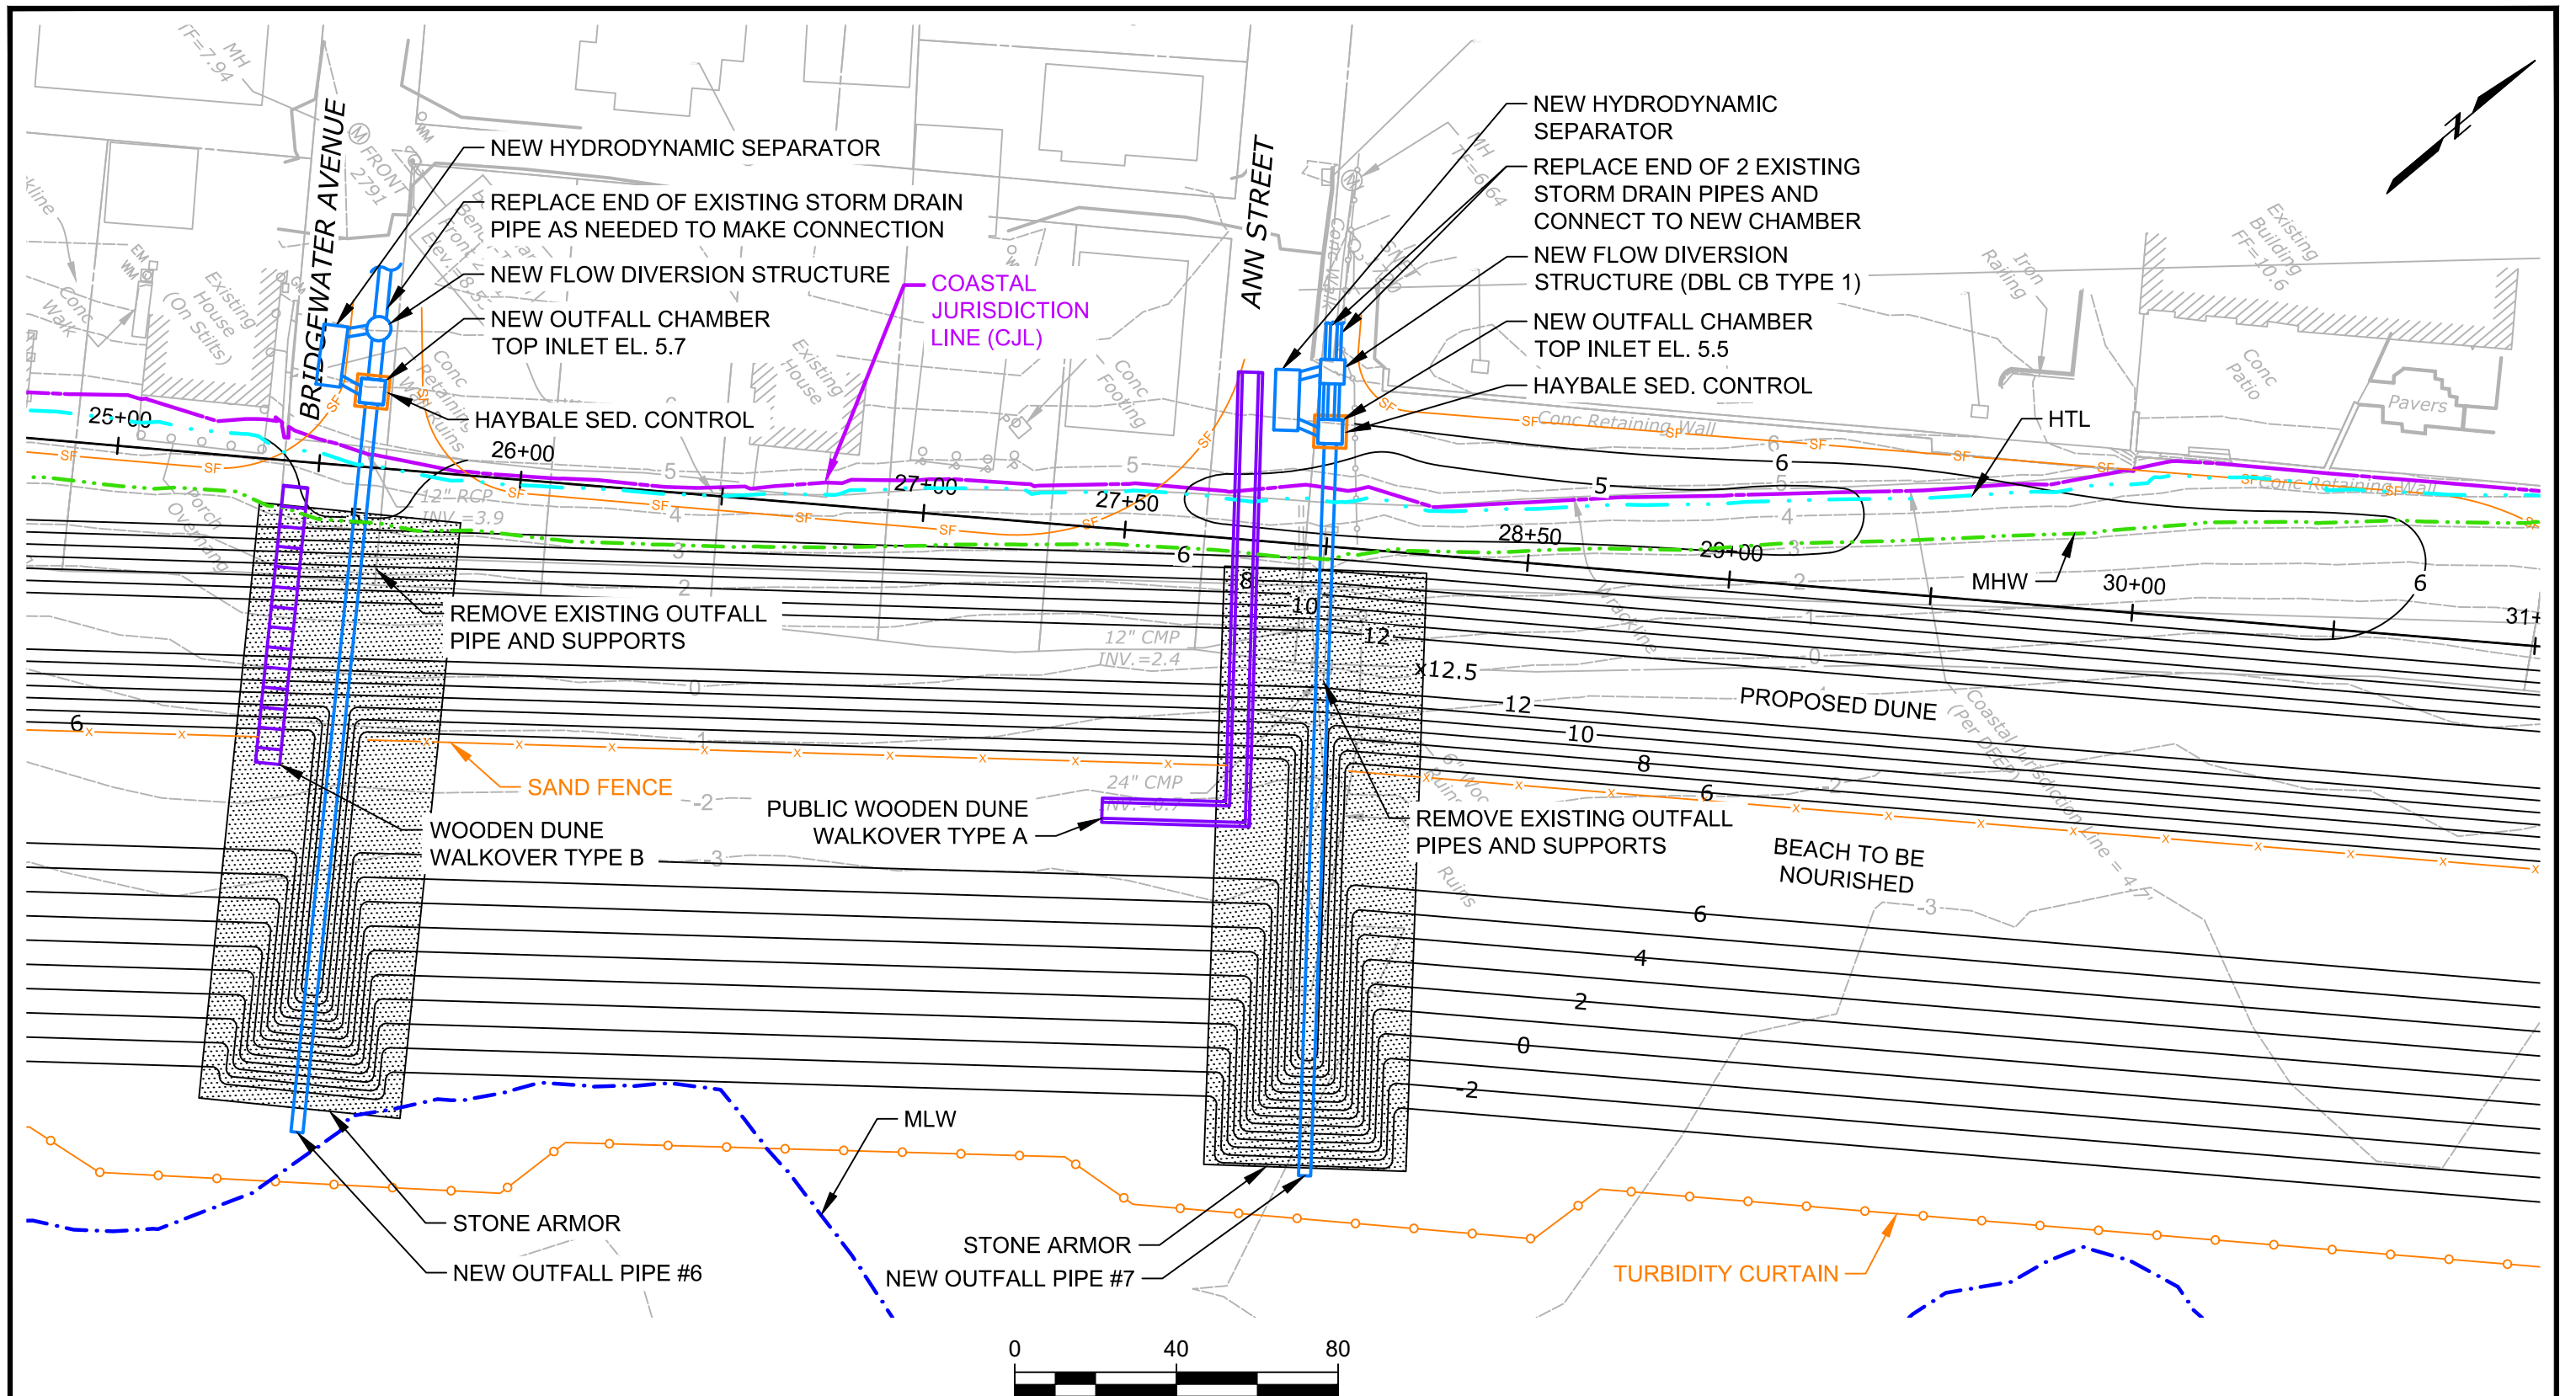


Designed: JM
 Checked: BG
 Drawn: DE
 Approved By: JM

Walnut & Wildemere Beach Stabilization Project
 Milford, Connecticut
 City of Milford
 Milford, Connecticut



DUNE AND BEACH
 NOURISHMENT PLAN
 Project 1700458
 December 2017
 Fig. 5



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Attention:
 0 1" scale bar
 If this scale bar does not measure 1" then drawing is not original scale.




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Walnut & Wildemere Beach Stabilization Project
 Milford, Connecticut
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DUNE AND BEACH NOURISHMENT PLAN
 Project 1700458
 December 2017
 Fig. 6



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Attention:
 0 1" = 40'
 If this scale bar does not measure 1" then drawing is not original scale.

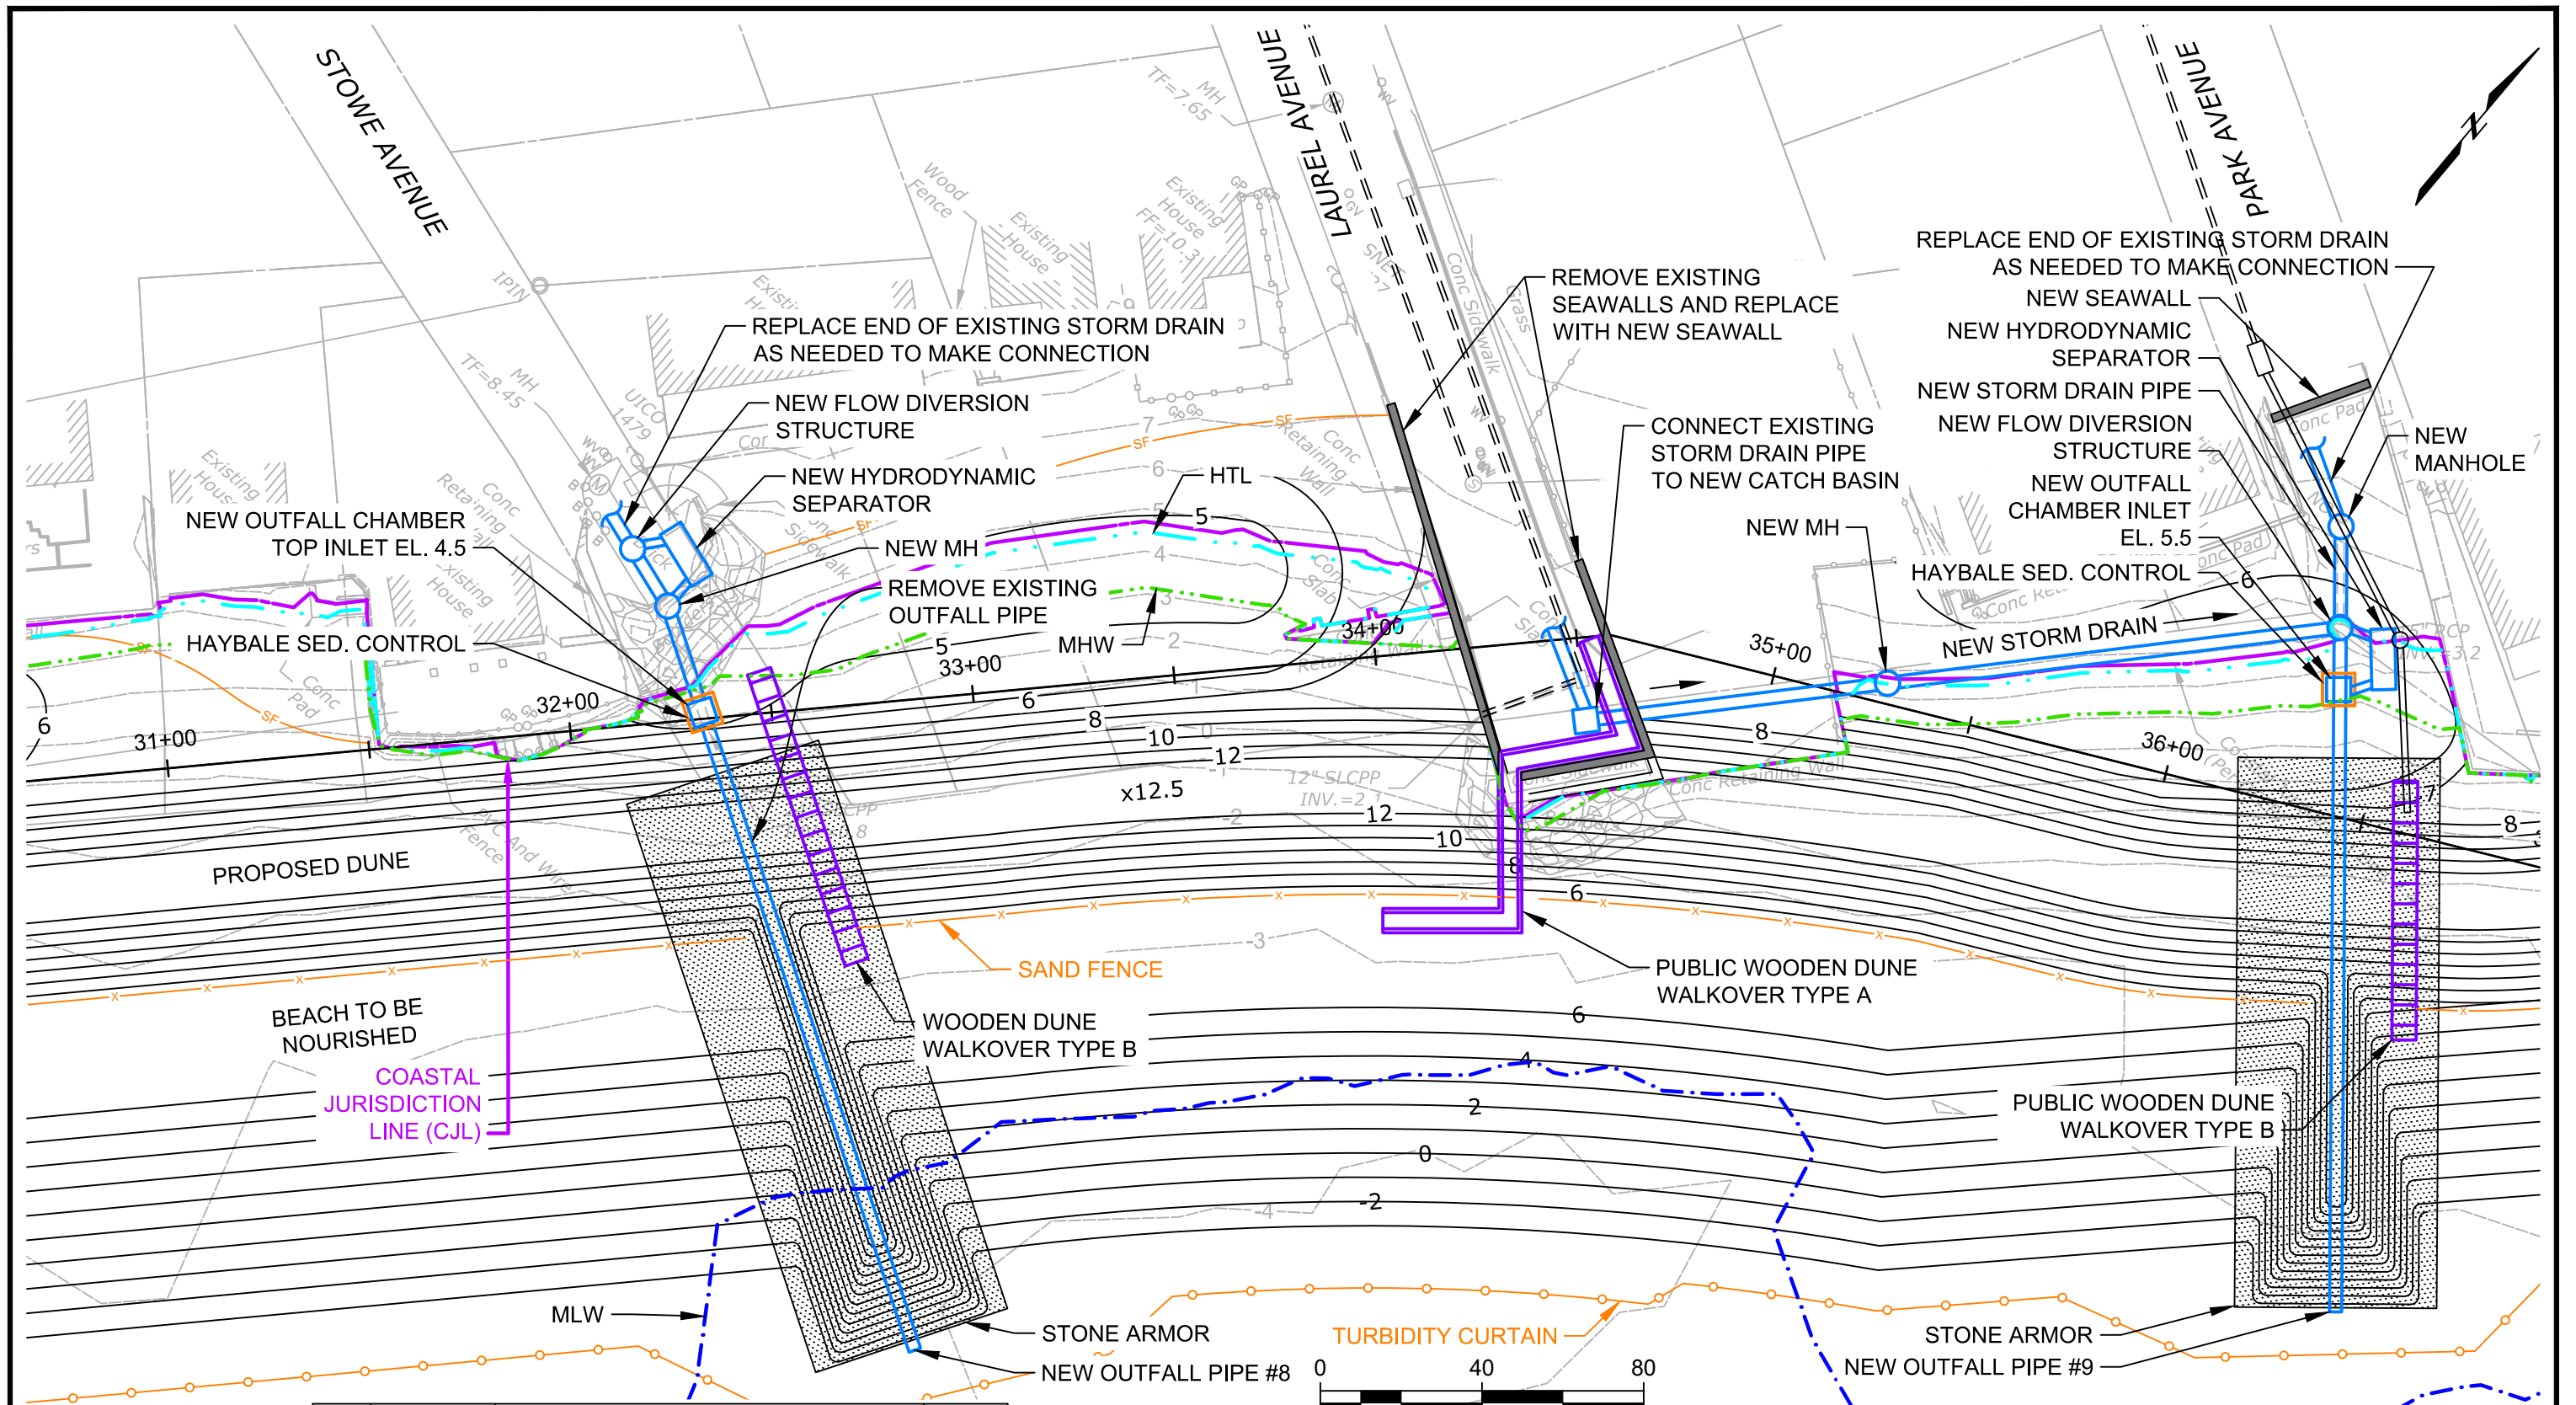


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Walnut & Wildemere Beach Stabilization Project
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DUNE AND BEACH NOURISHMENT PLAN
 Project 1700458
 December 2017
 Fig. 7



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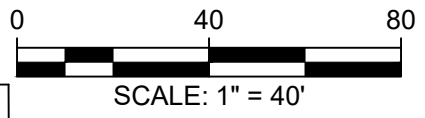
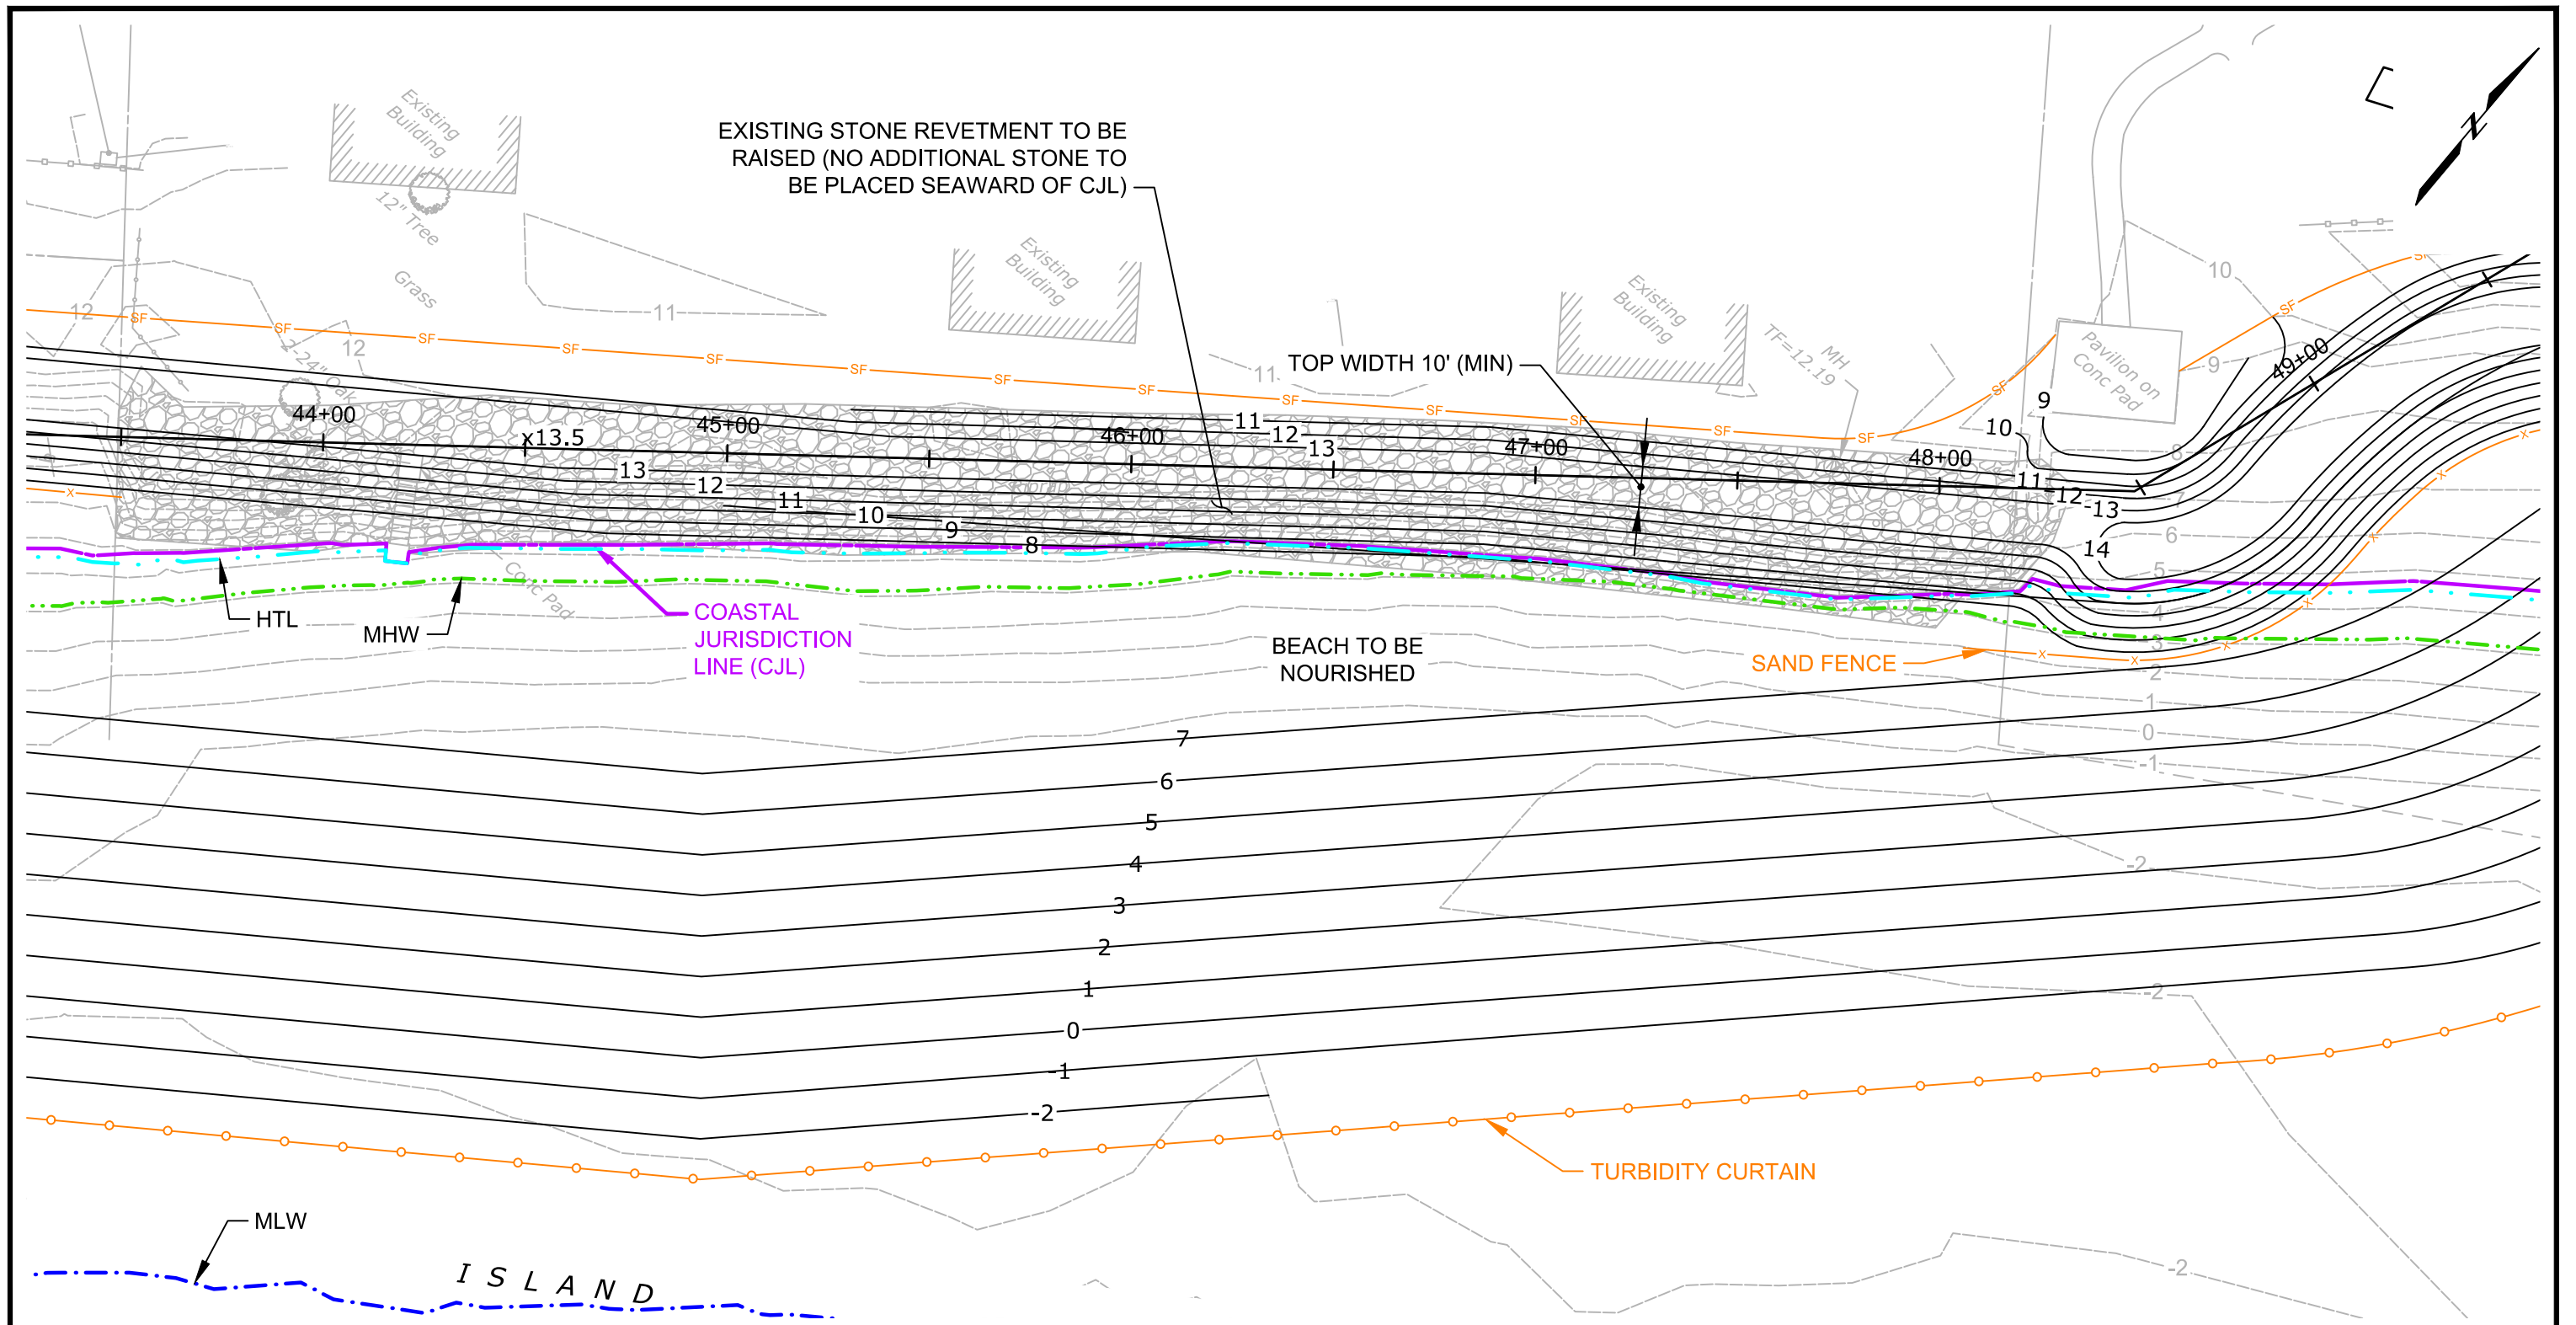


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Walnut & Wildemere Beach Stabilization Project
 Milford, Connecticut
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 Milford, Connecticut

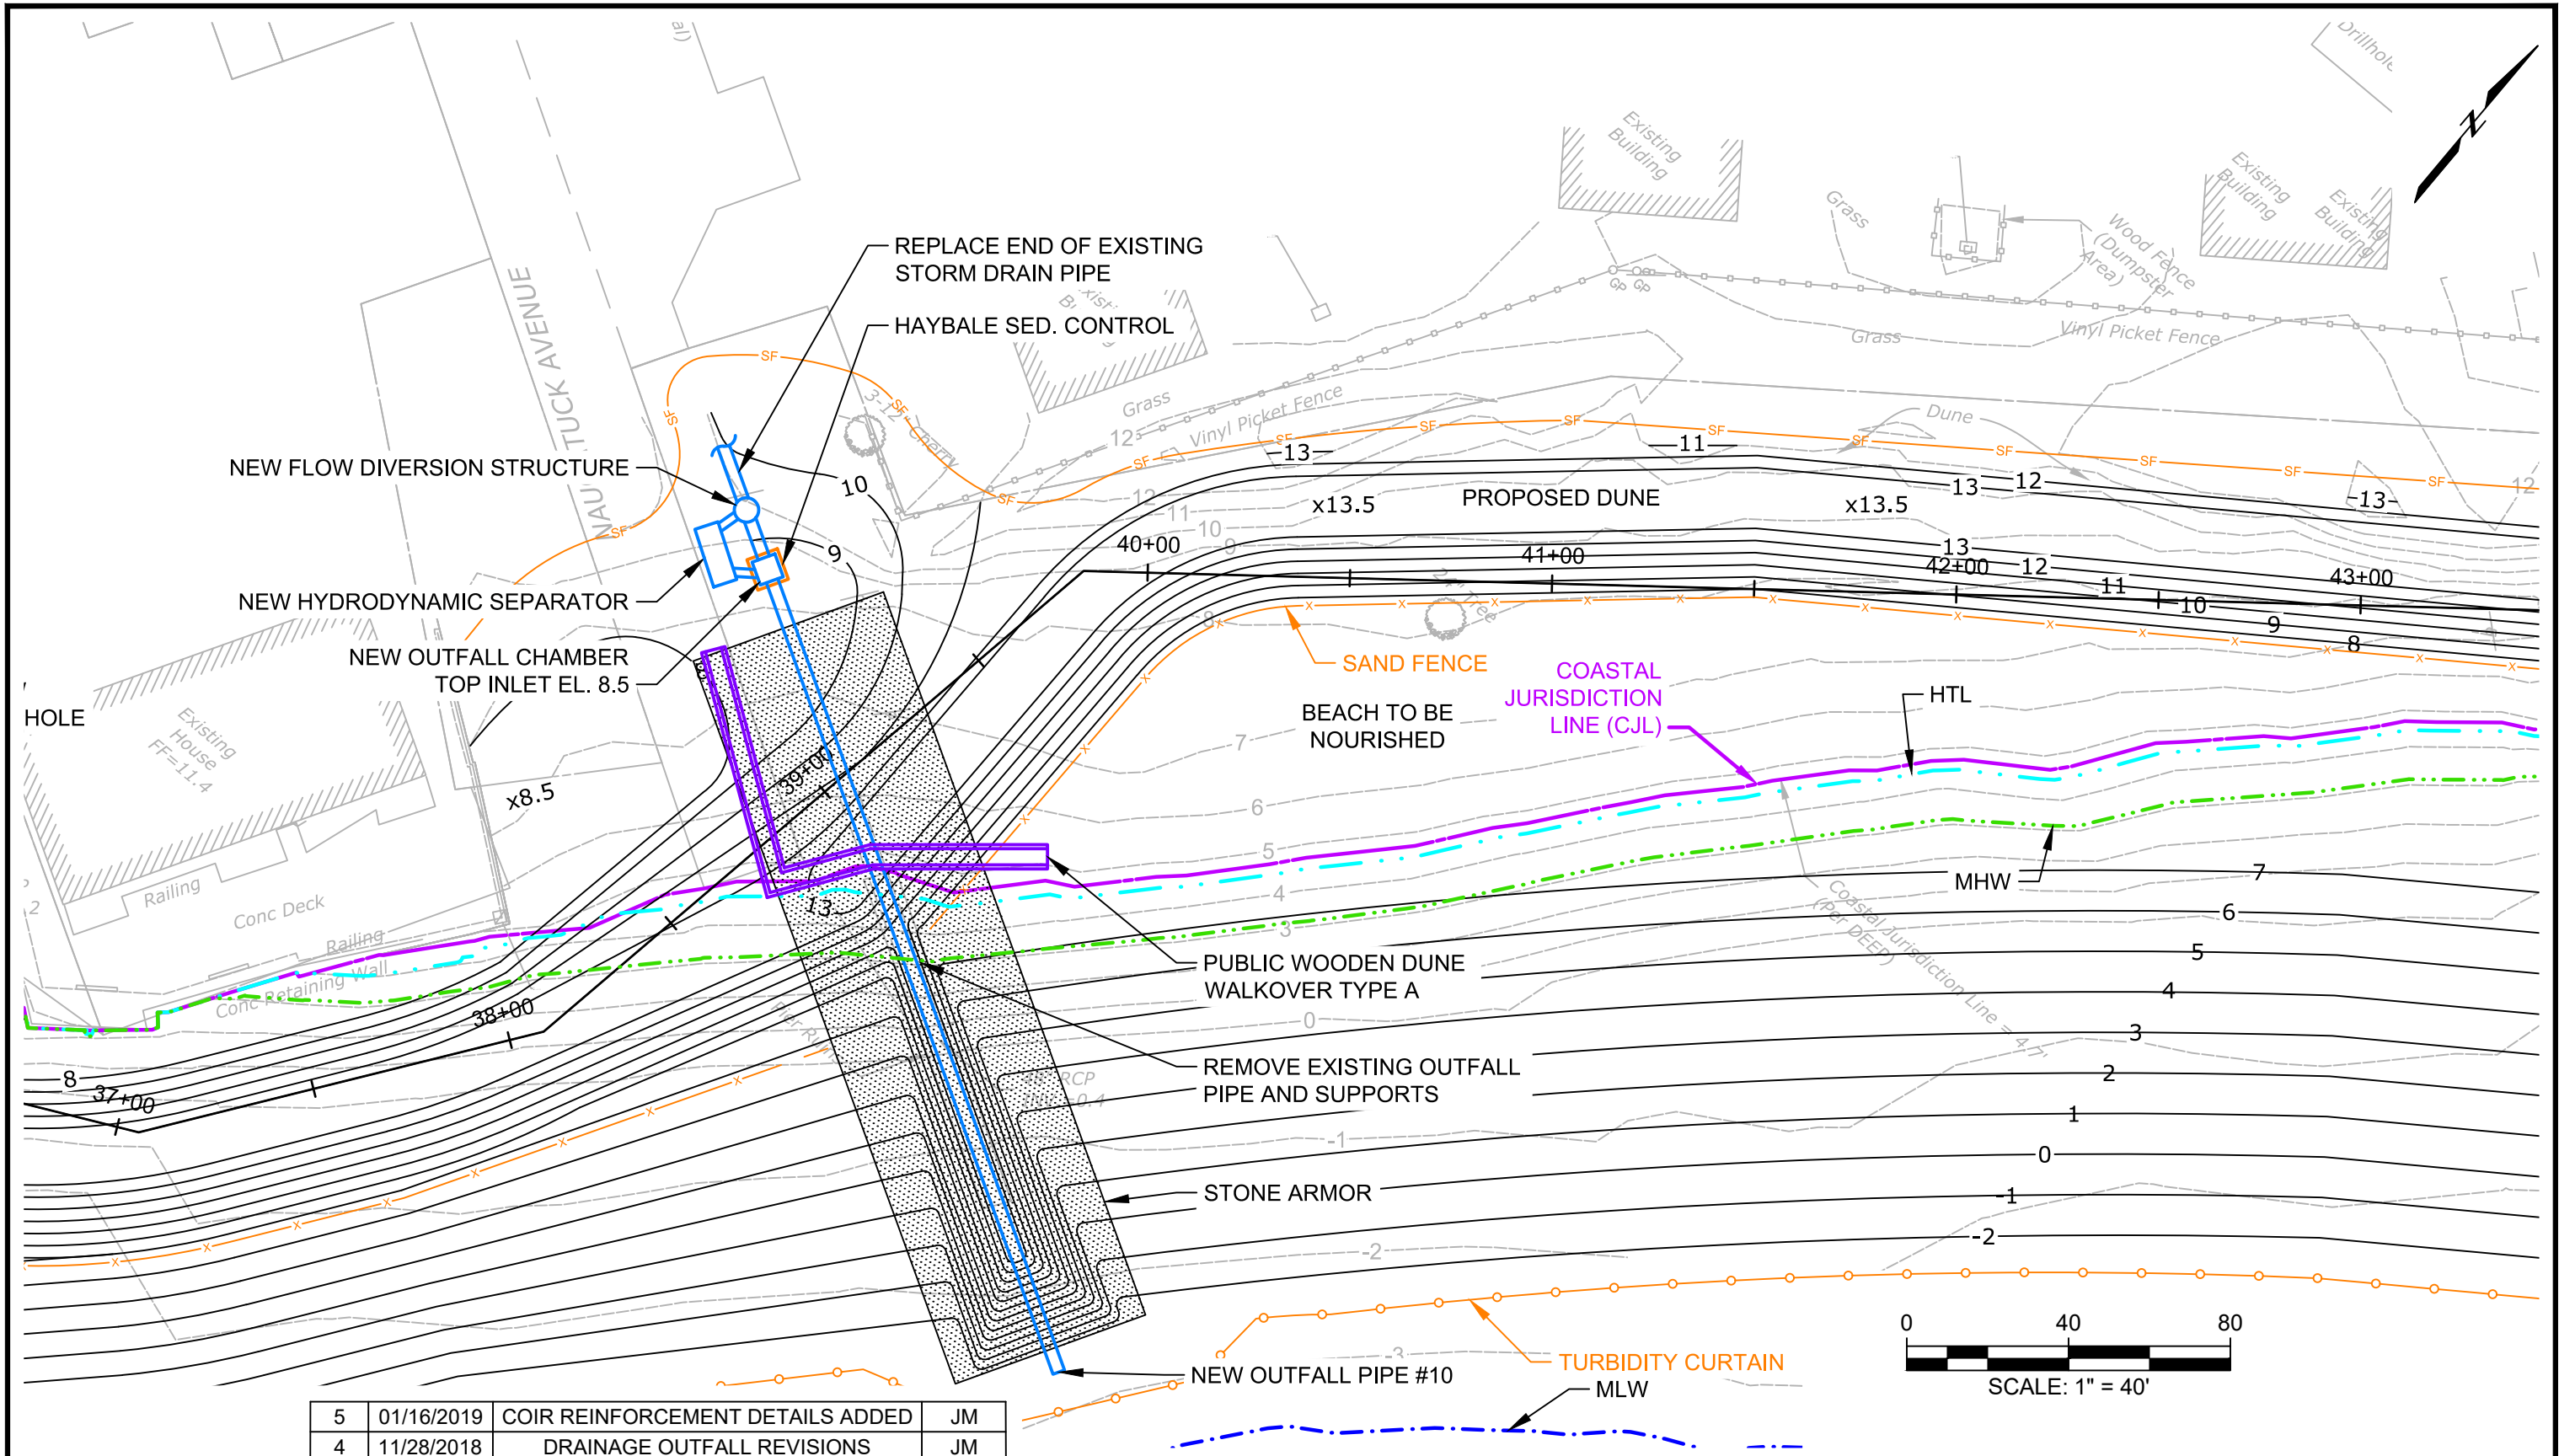

DUNE AND BEACH NOURISHMENT PLAN
 Project 1700458
 December 2017
 Fig. 8



| 5 | 01/16/2019 | COIR REINFORCEMENT DETAILS ADDED | JM |
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Attention:

0 1"

If this scale bar does not measure 1" then drawing is not original scale.



Designed: JM

Checked: BG

Drawn: DE

Approved By: JM


Walnut & Wildemere Beach Stabilization Project
Milford, Connecticut

City of Milford
Milford, Connecticut



DUNE AND BEACH NOURISHMENT PLAN

Project 1700458 December 2017 Fig. 9

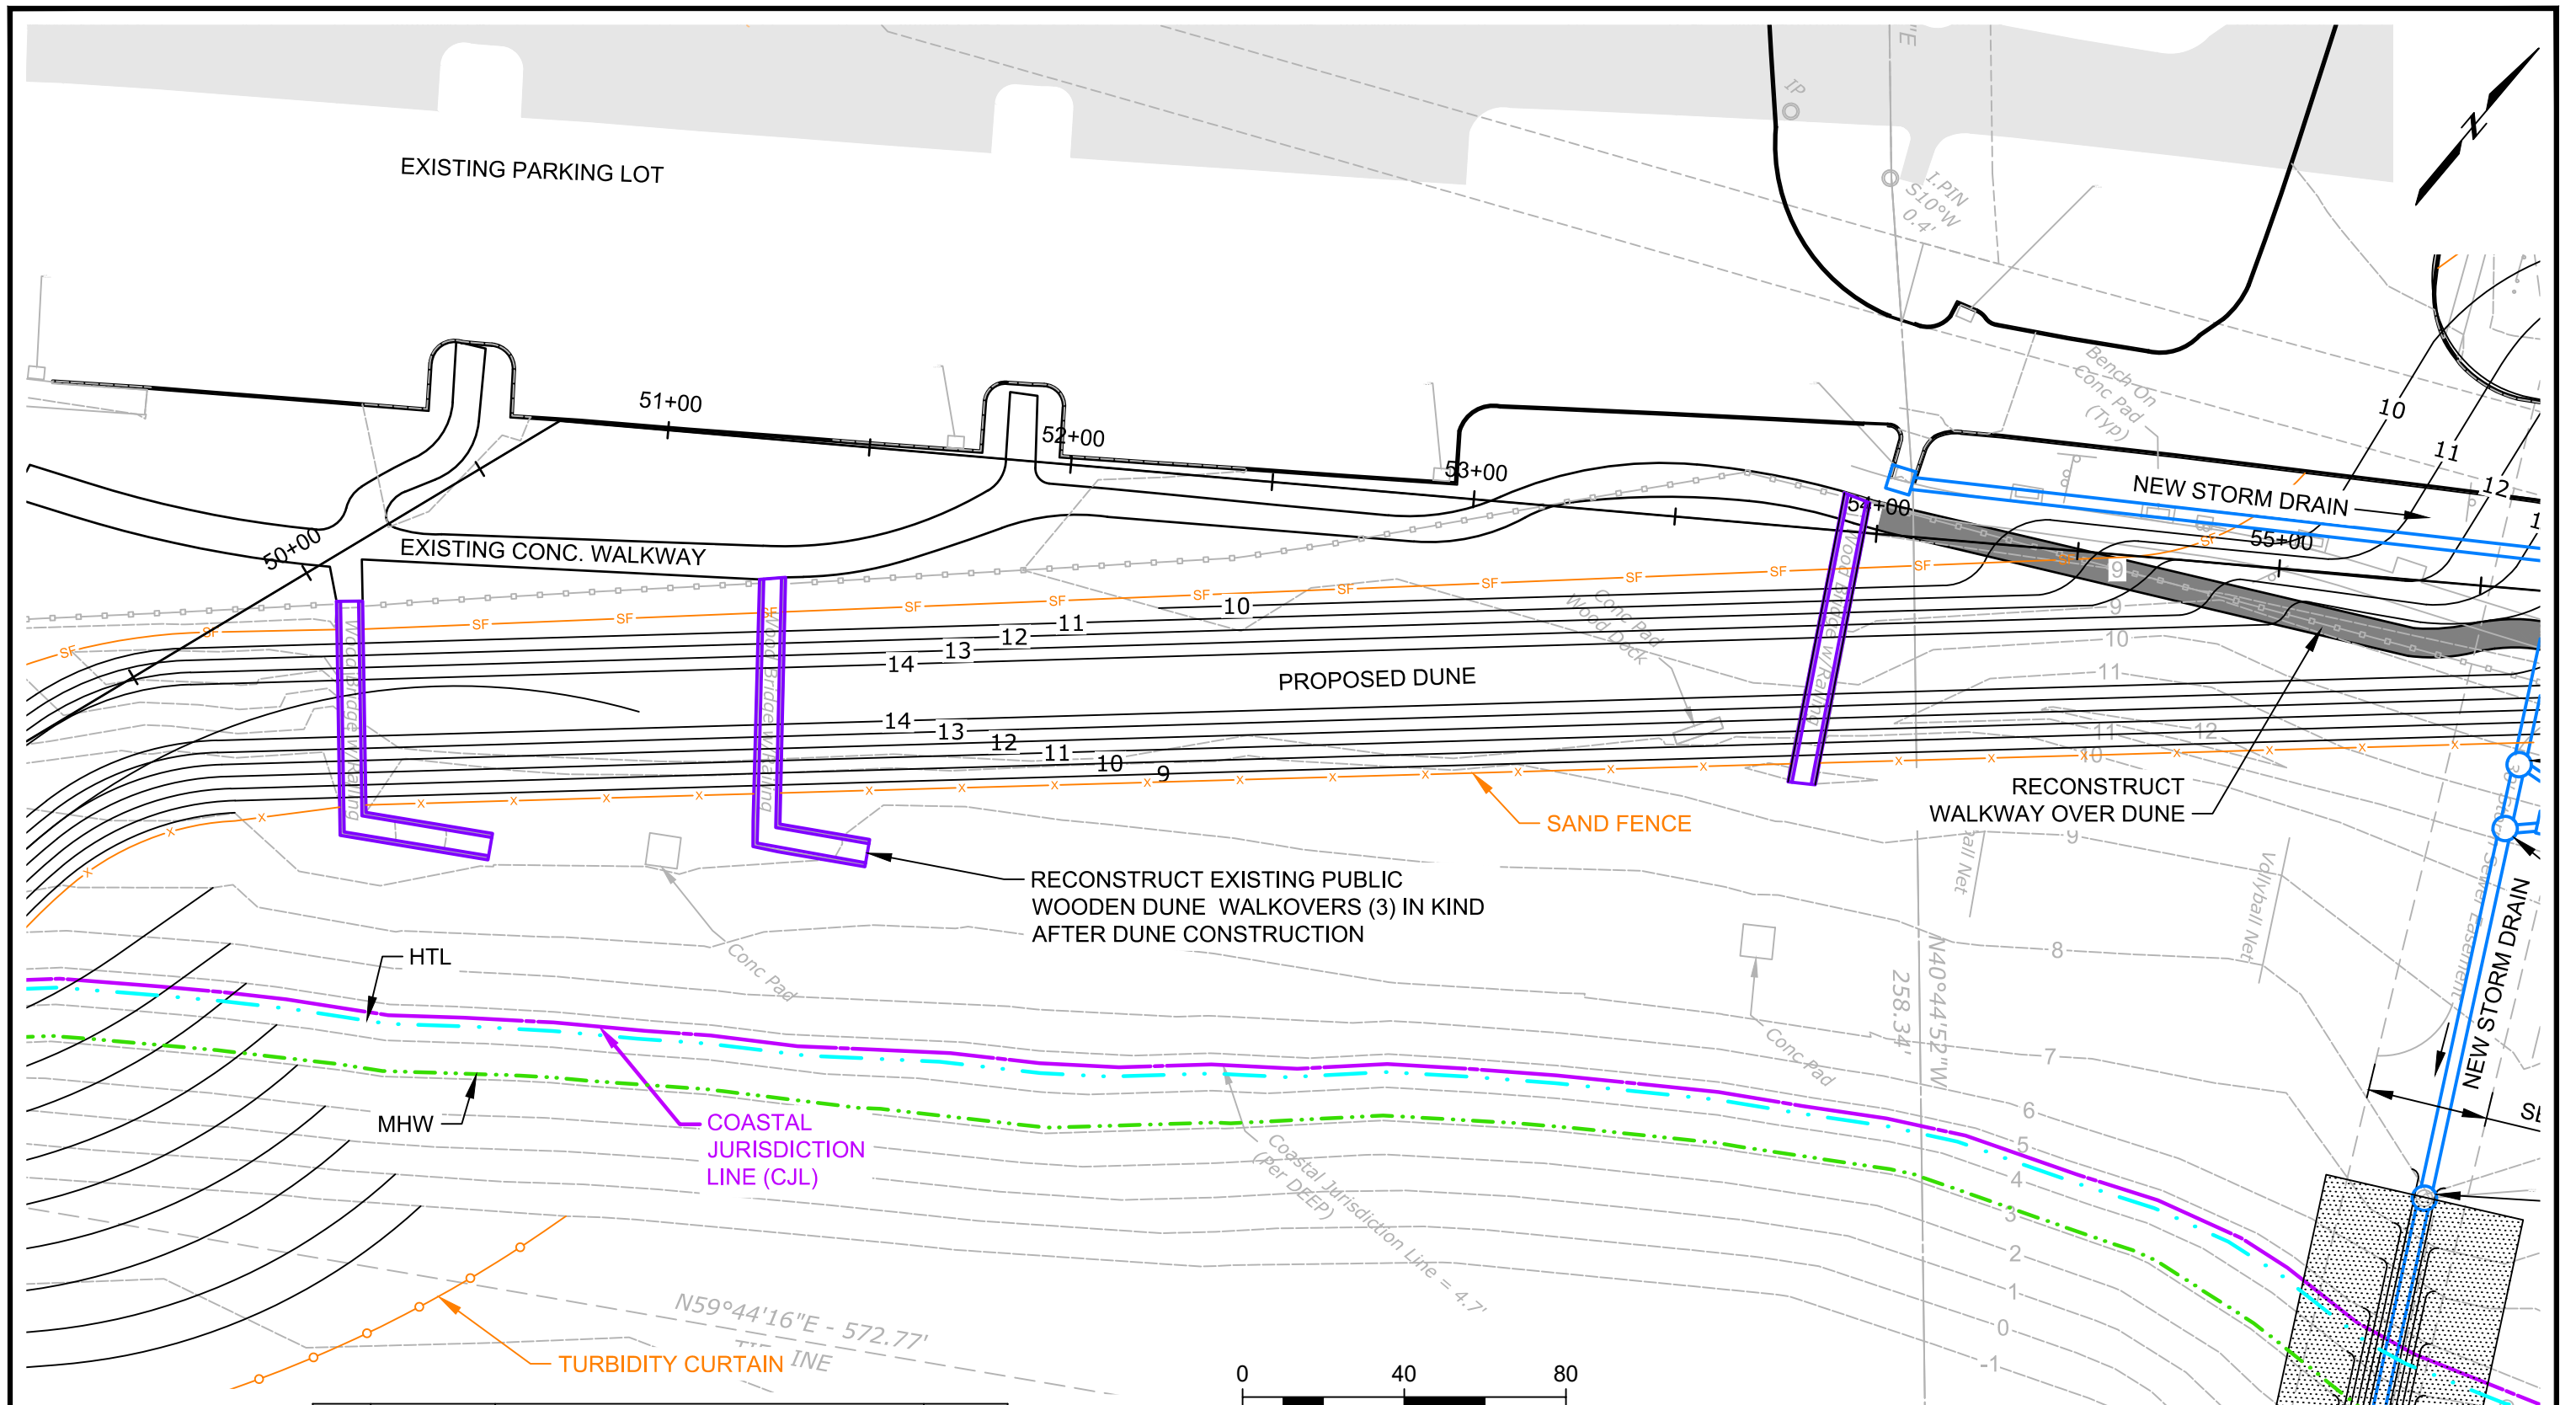

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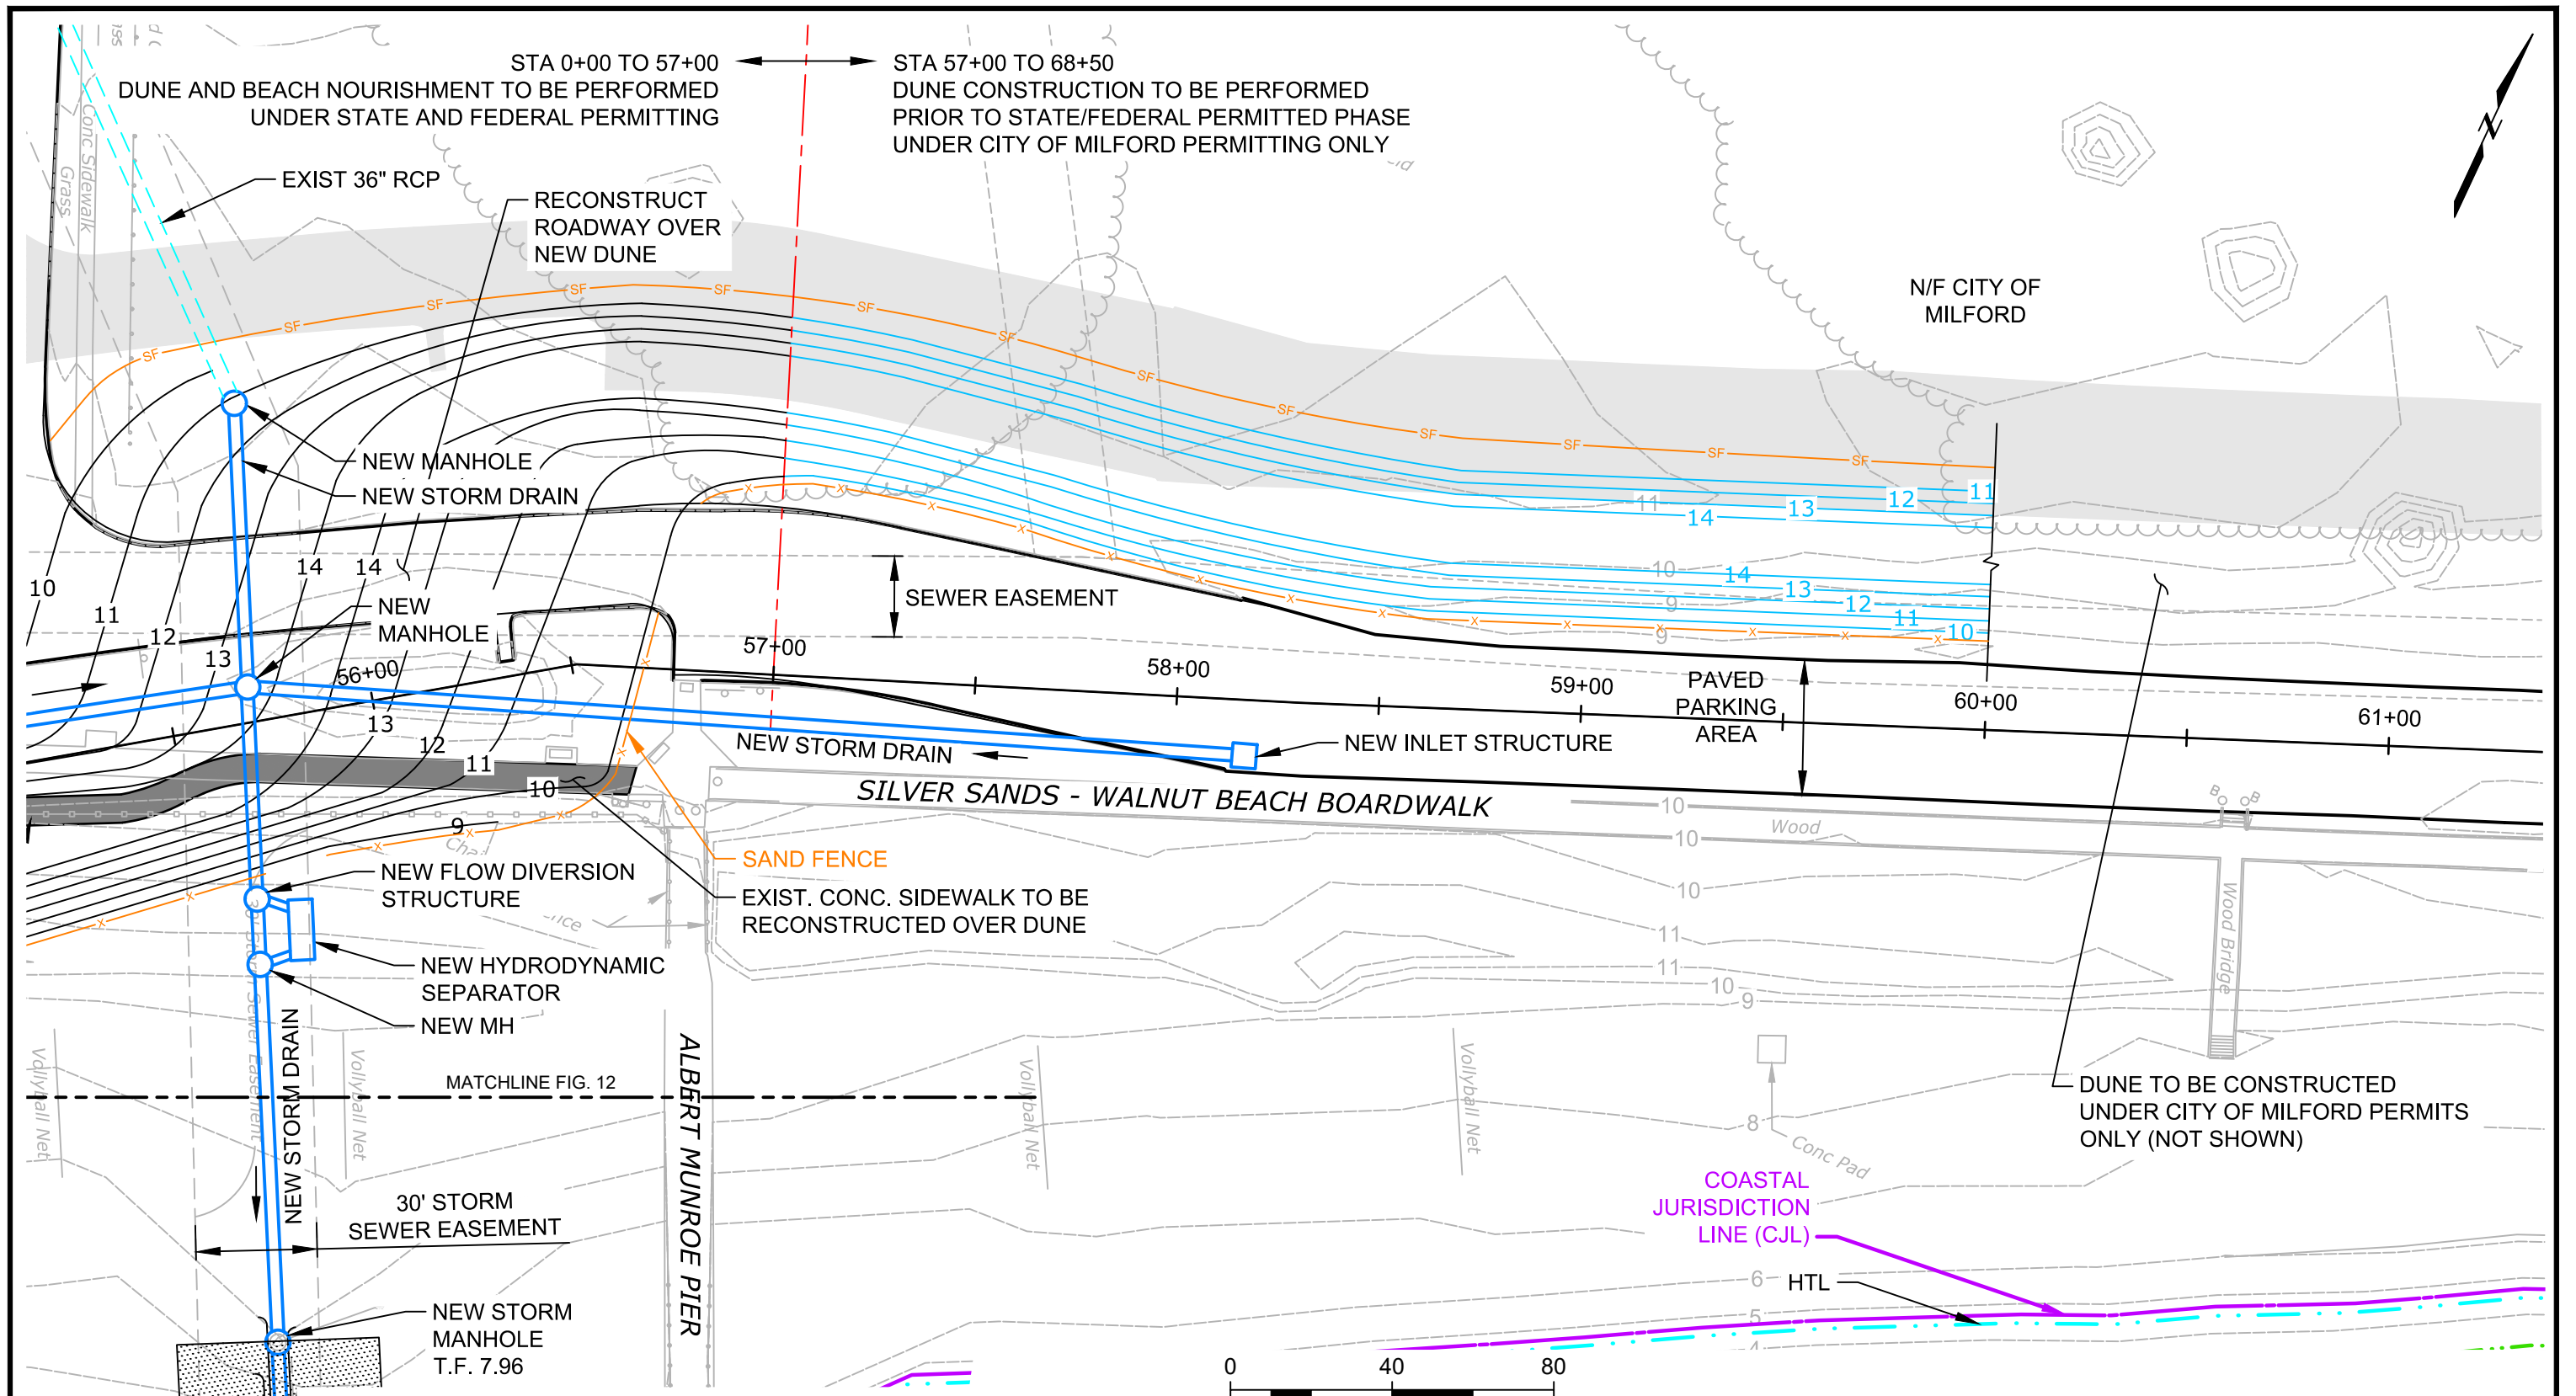


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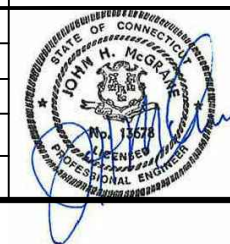
Walnut & Wildemere Beach Stabilization Project
 Milford, Connecticut
 City of Milford
 Milford, Connecticut



DUNE AND BEACH NOURISHMENT PLAN
 Project 1700458
 December 2017
 Fig. 10



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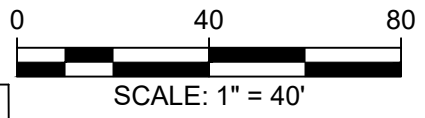
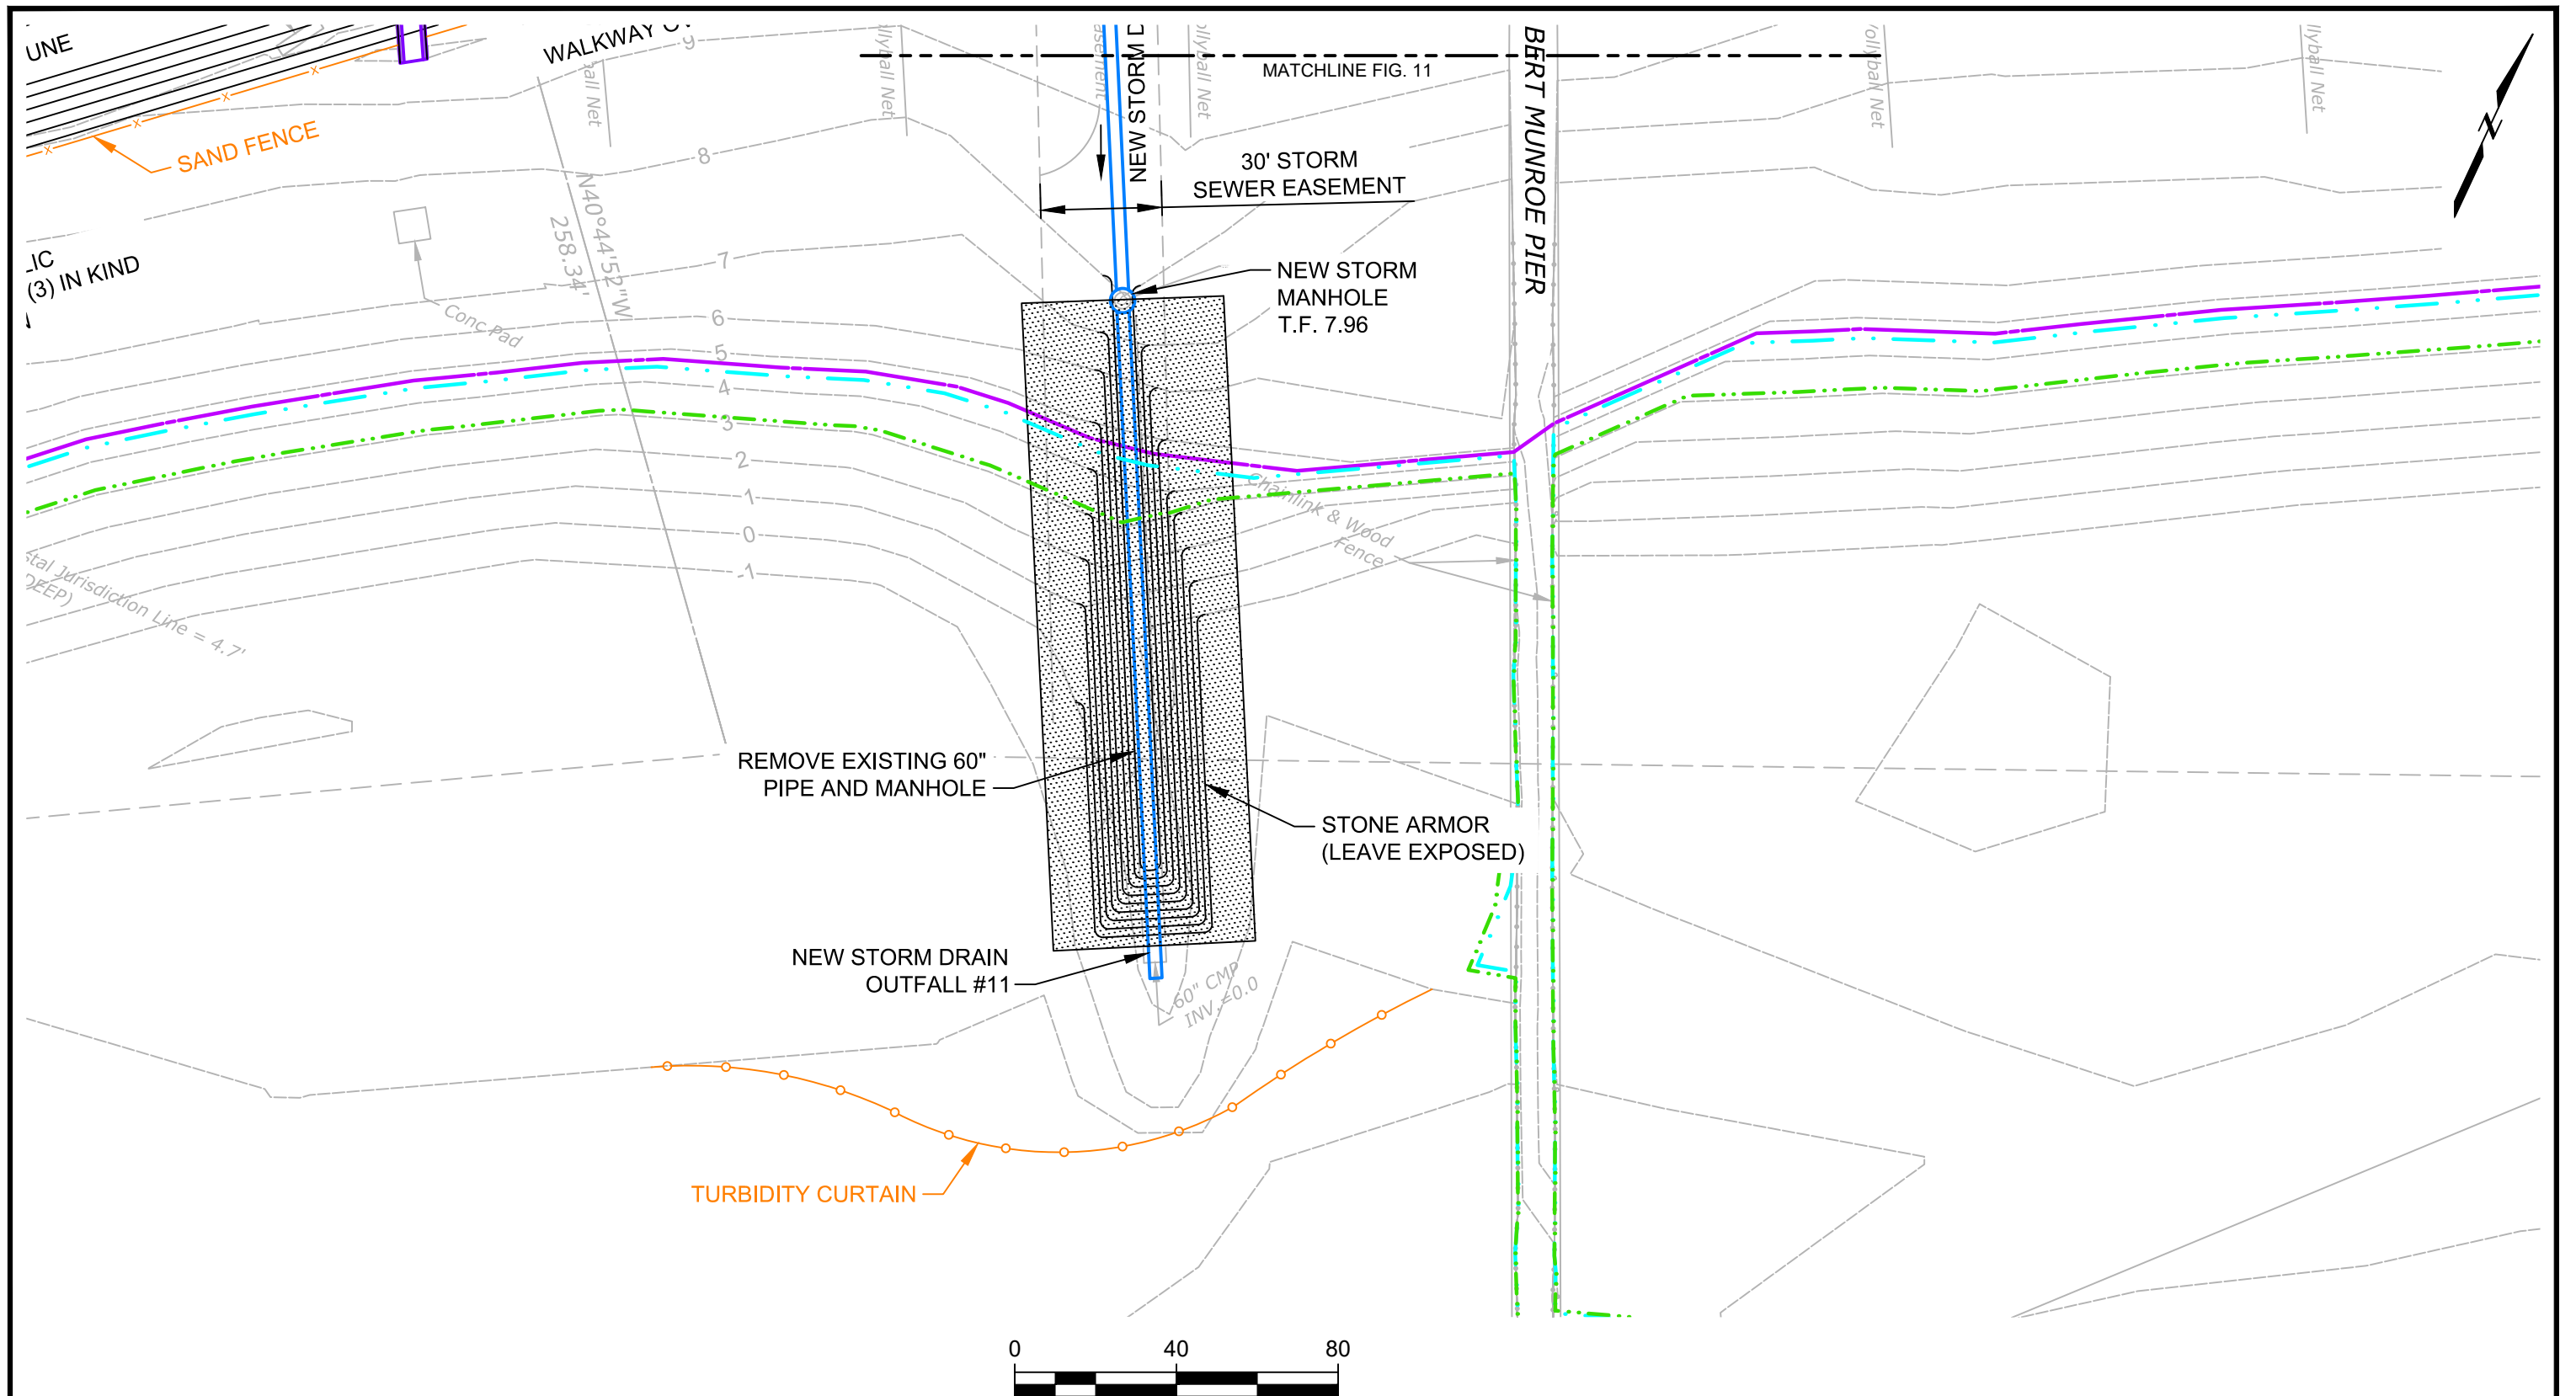
Walnut & Wildemere Beach Stabilization Project
Milford, Connecticut

City of Milford
Milford, Connecticut



DUNE AND BEACH
NOURISHMENT PLAN


Project 1700458
December 2017
Fig. 11



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Attention:

 If this scale bar does not measure 1\"/>




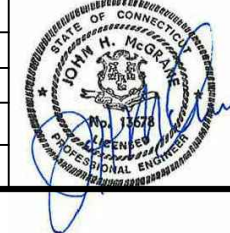


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DUNE AND BEACH
 NOURISHMENT PLAN
 Project 1700458
 December 2017
 Fig. 12



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| 5 | 01/16/2019 | COIR REINFORCEMENT DETAILS ADDED | JM |
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| 1 | 03/09/2018 | REVISIONS PER MILFORD FECB | JM |
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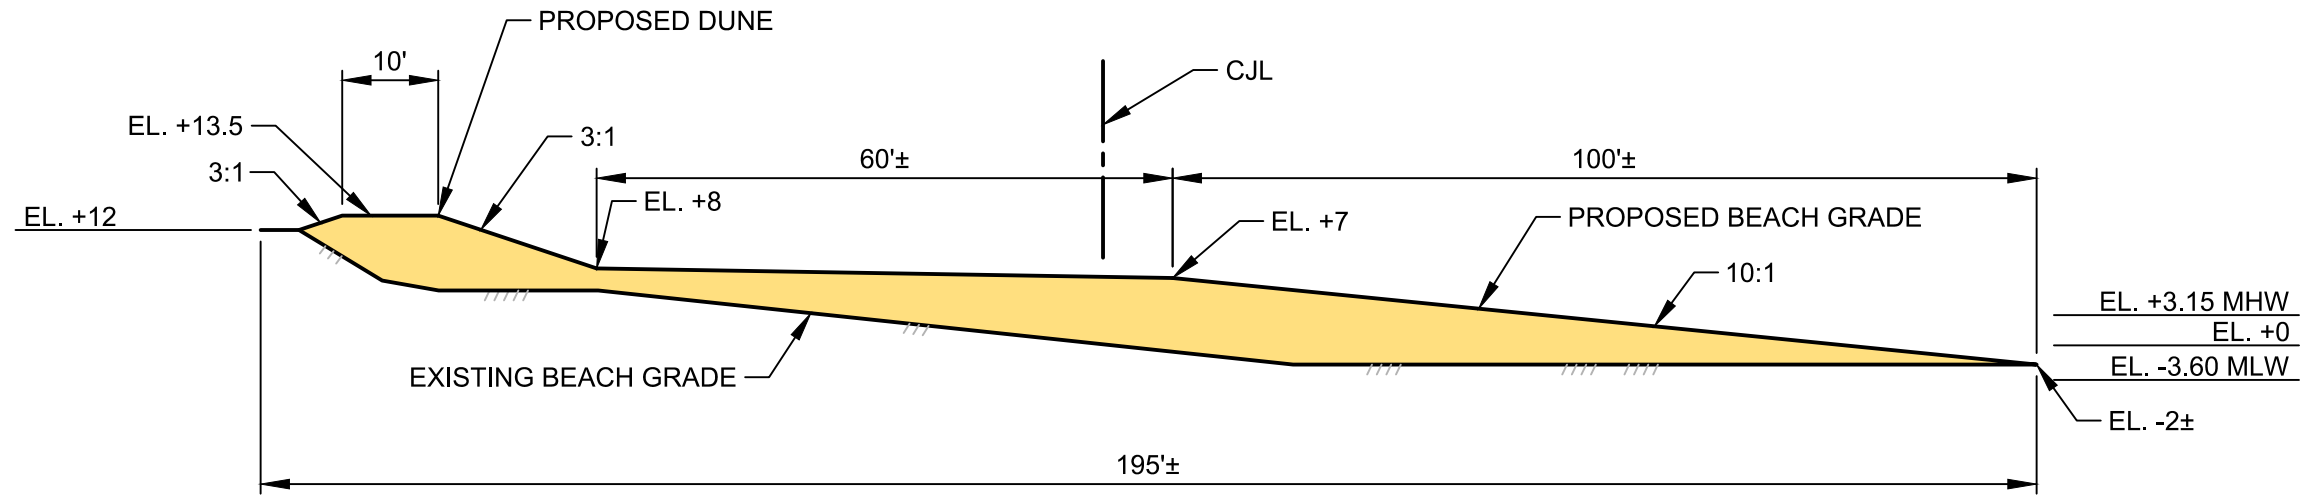
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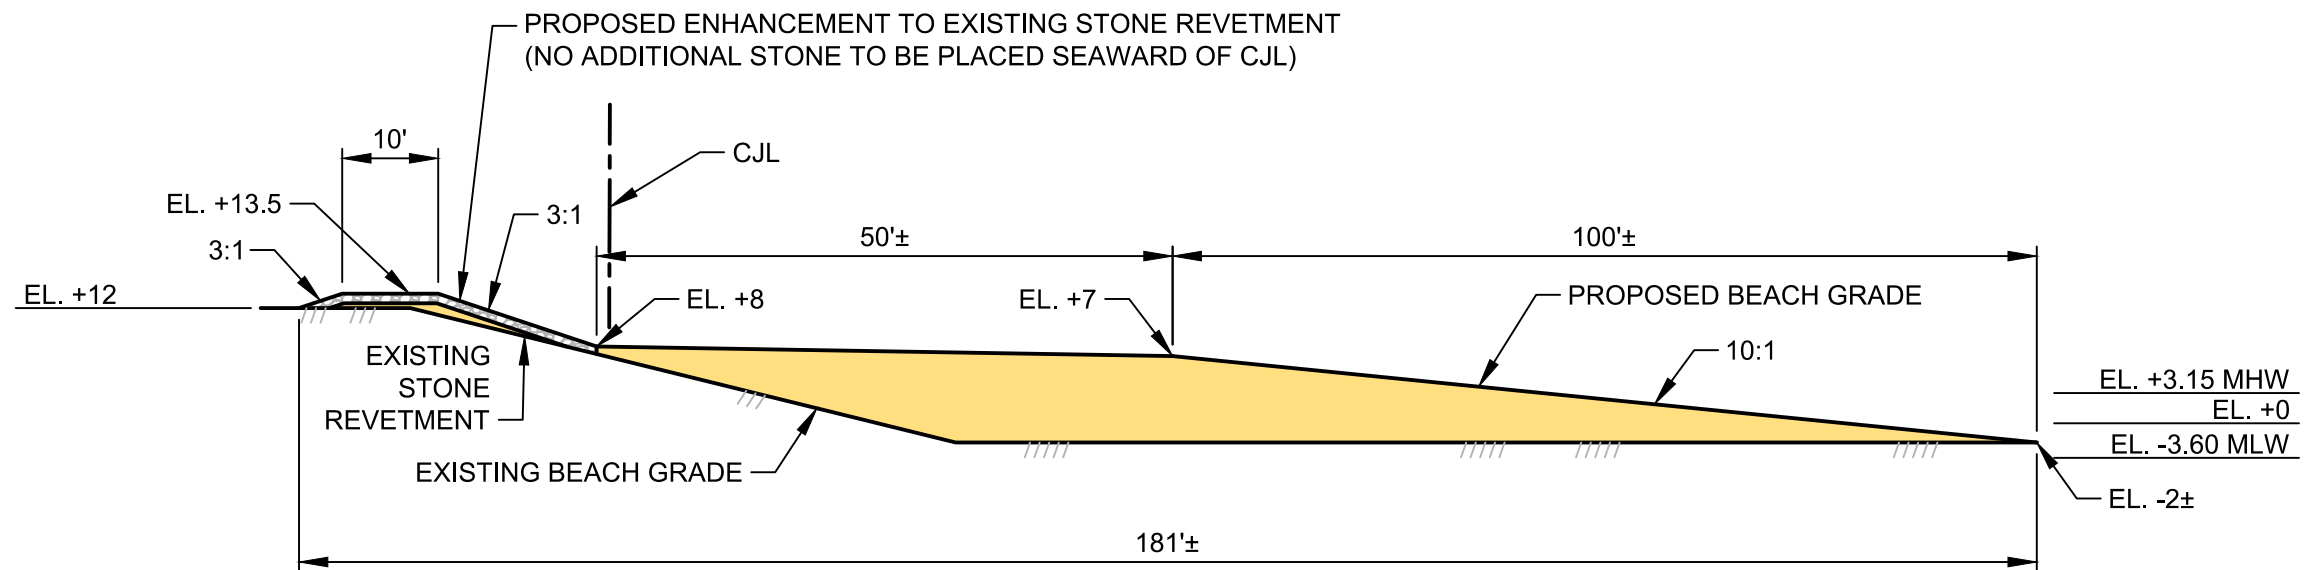
WILDEMERE BEACH DUNE & BEACH NOURISHMENT TYPICAL SECTIONS
 Project 1700458
 December 2017
 Fig. 13

Attention:
 If this scale bar does not measure 1" then drawing is not original scale.

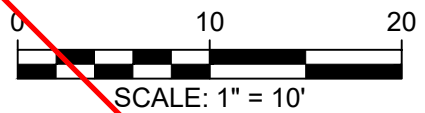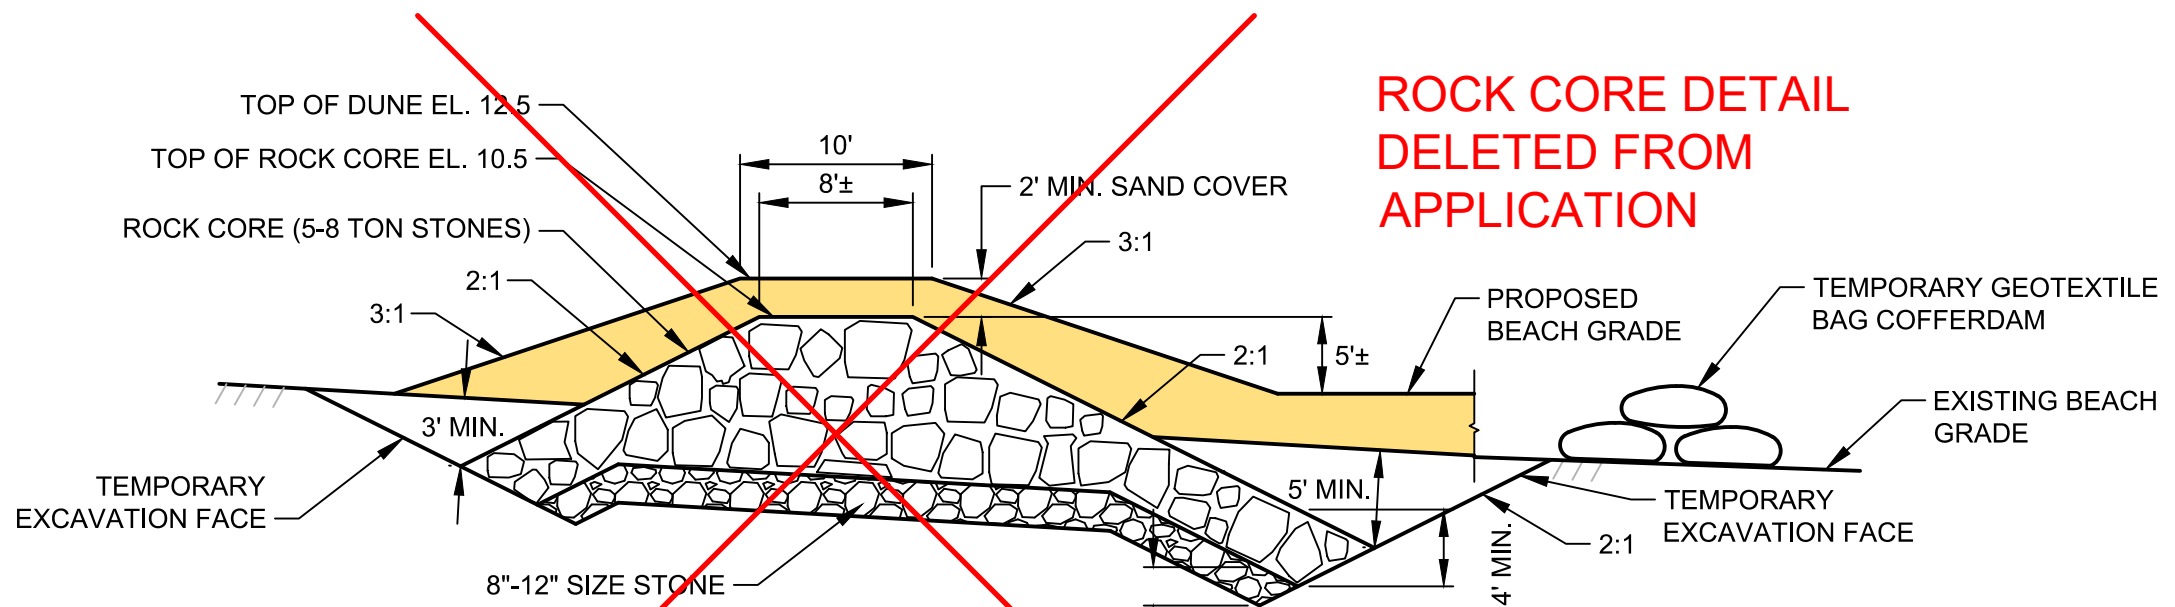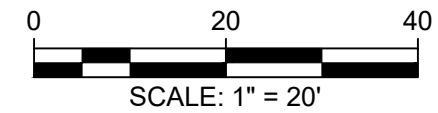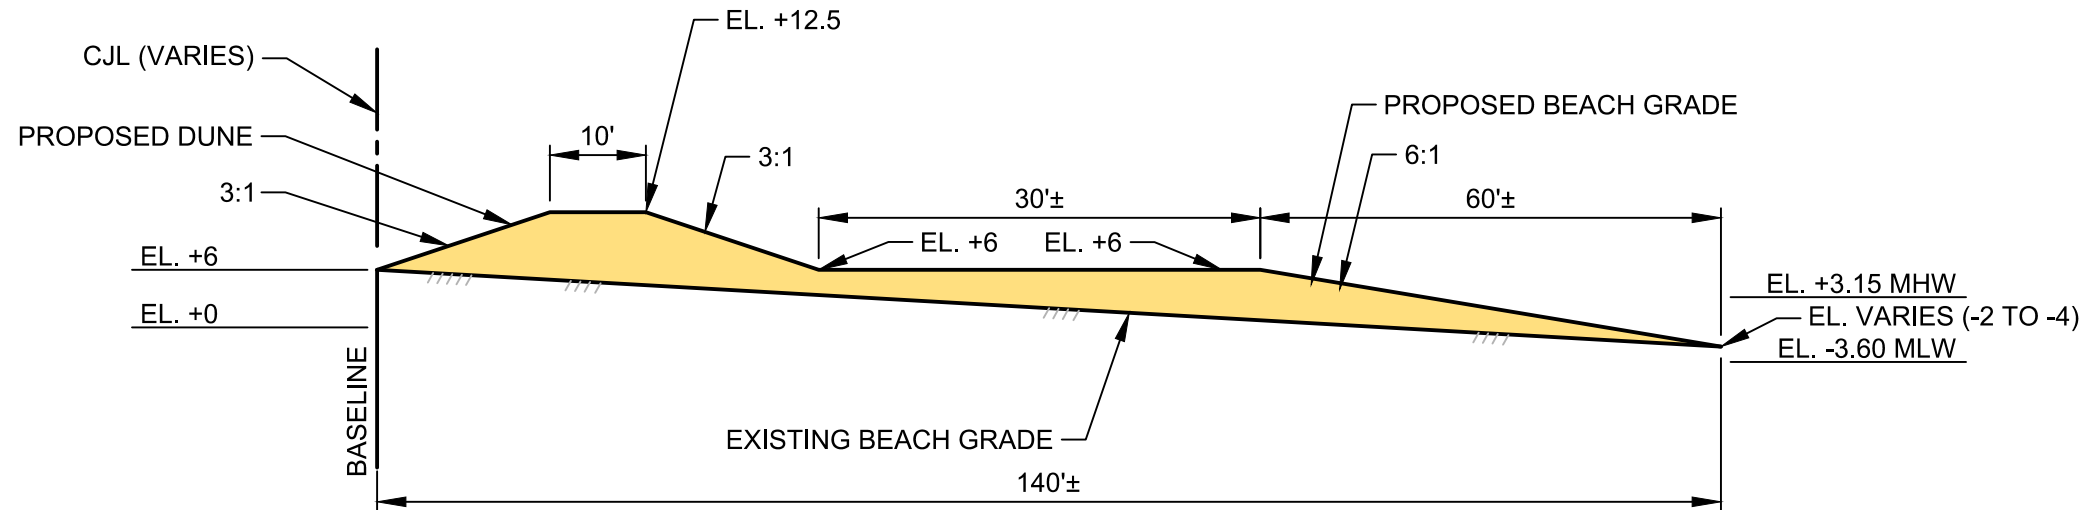

DUNE & BEACH NOURISHMENT SECTION

STA. 41+50



DUNE & BEACH NOURISHMENT SECTION

STA. 45+00



| | | | | |
|---|-----|------------|----------------------------------|-----|
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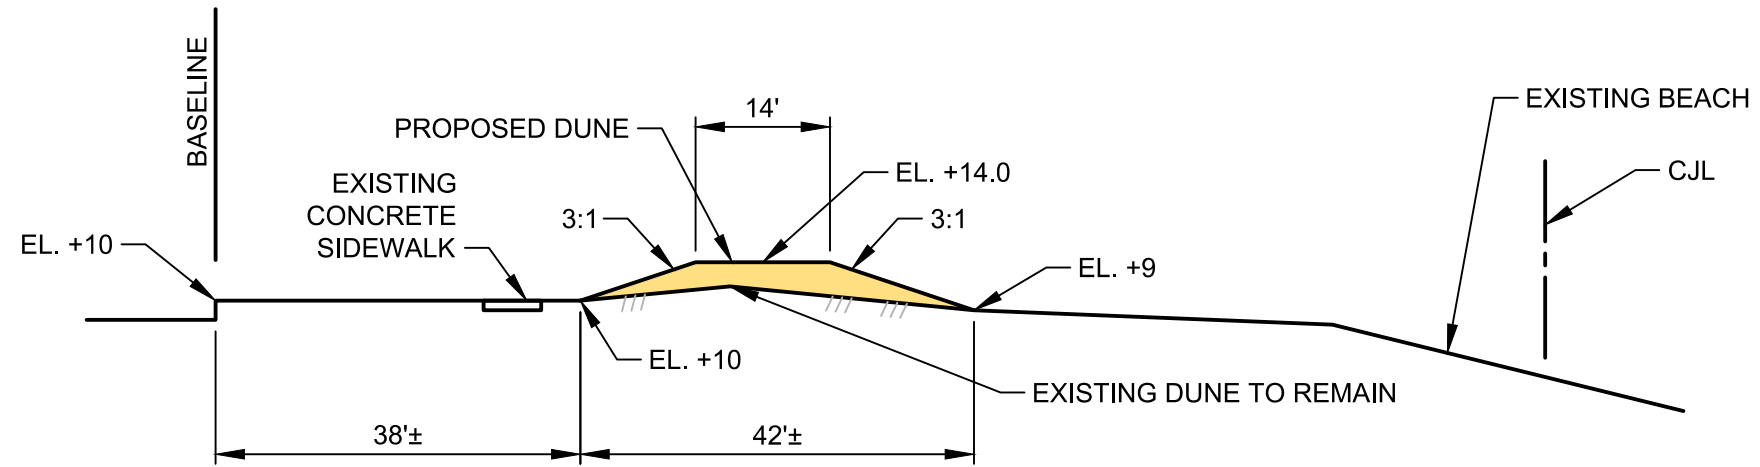
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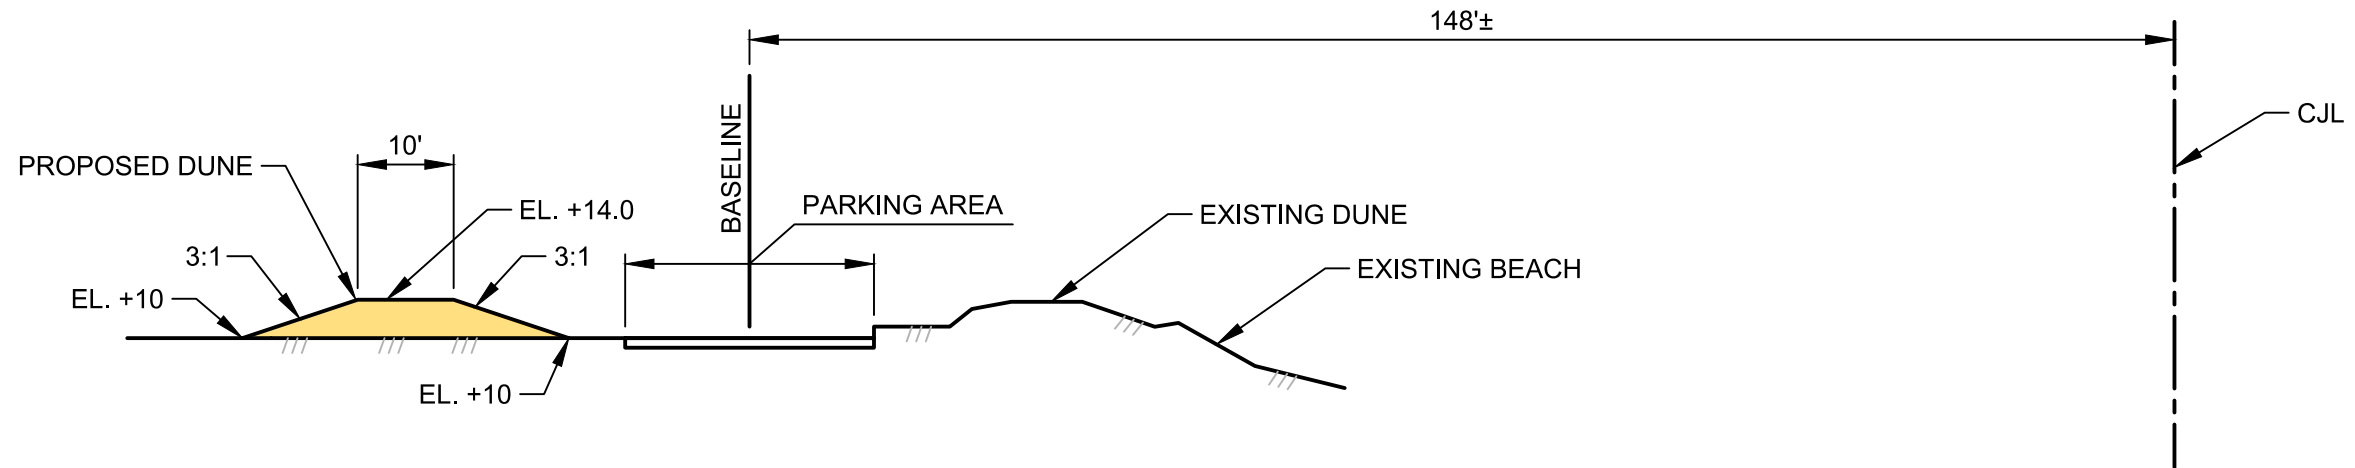


WILDEMERE BEACH DUNE & BEACH NOURISHMENT TYPICAL SECTIONS
Project 1700458
December 2017
Fig. 14




DUNE & BEACH NOURISHMENT SECTION

STA. 51+00



DUNE & BEACH NOURISHMENT SECTION (CITY OF MILFORD PERMITTED SECTION - INFORMATION ONLY)

STA. 59+50

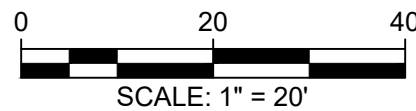

| | | | | |
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City of Milford
Milford, Connecticut




Project 1700458


WILDEMERE BEACH DUNE
& BEACH NOURISHMENT
TYPICAL SECTIONS

December 2017


Fig. 15

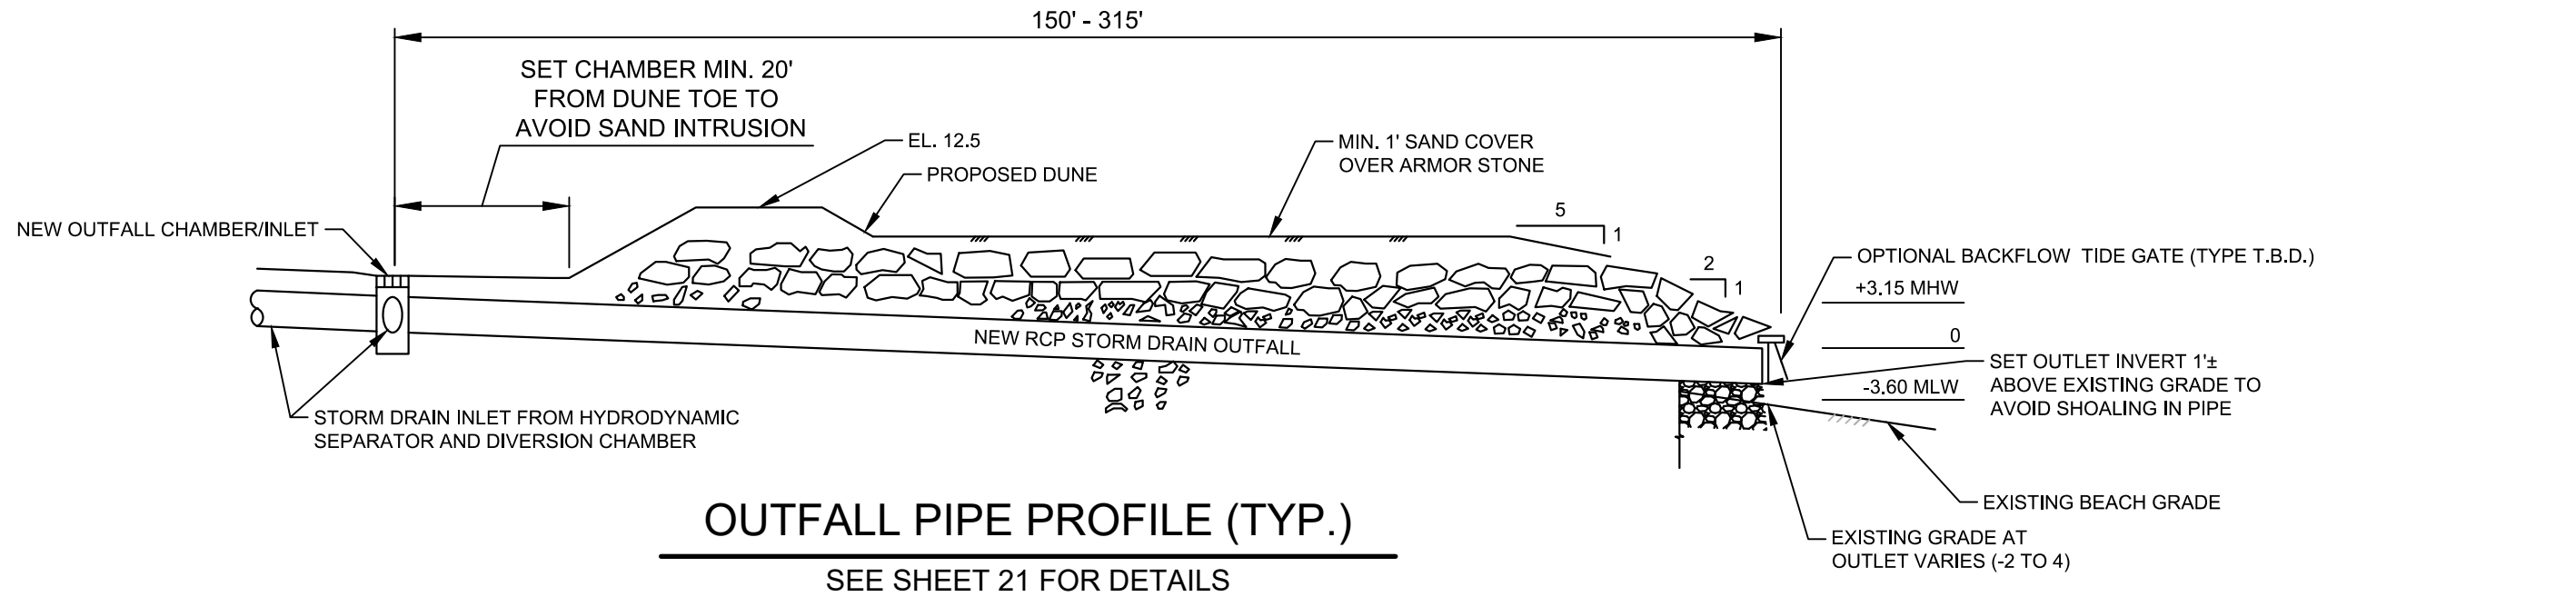

OUTFALL PIPE PROFILE (TYP.)
SEE SHEET 21 FOR DETAILS

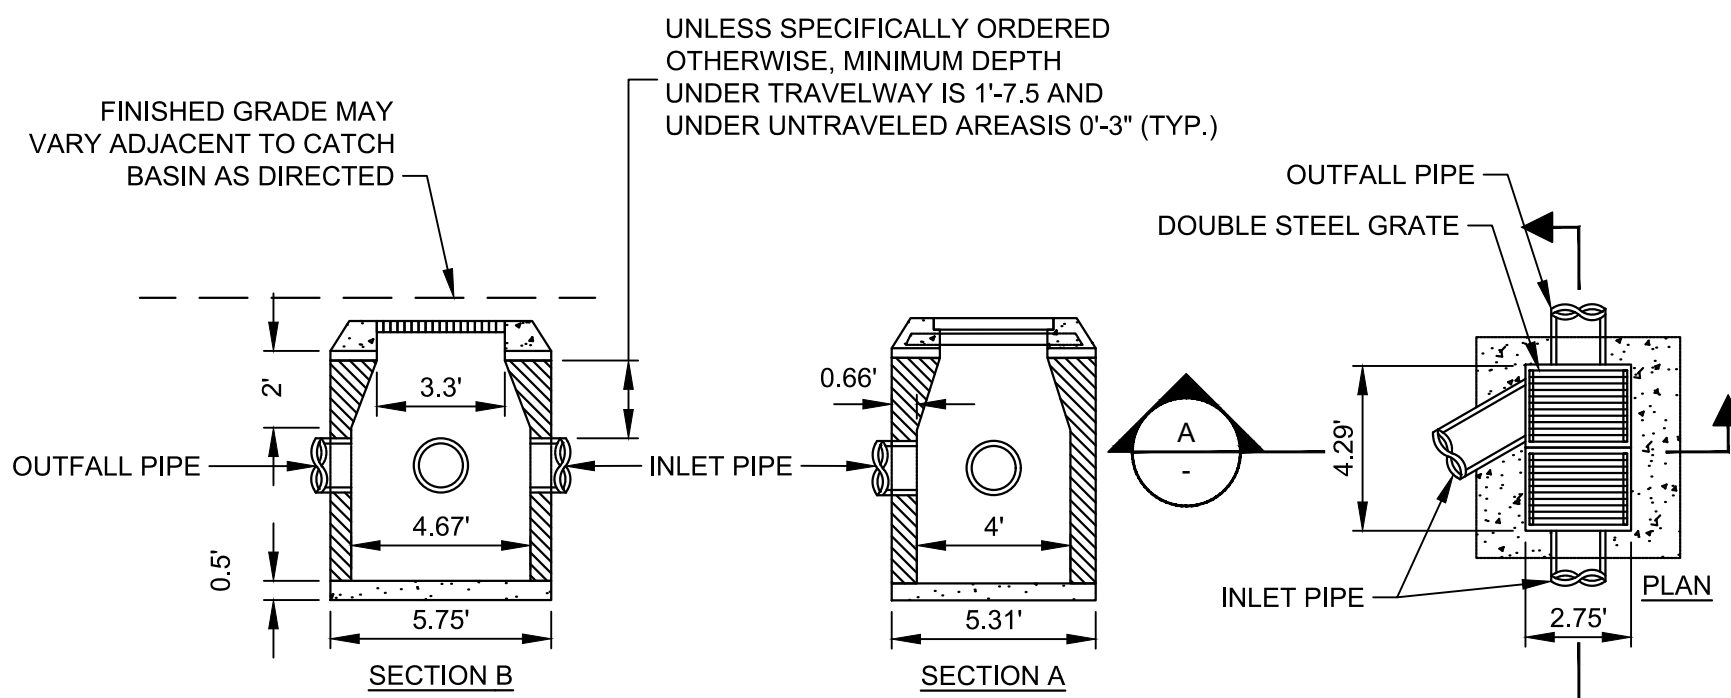


OUTFALL CHAMBER/INLET DETAIL
DOT TYPE C-L CATCH BASIN DOUBLE GRATE, TYPE 1

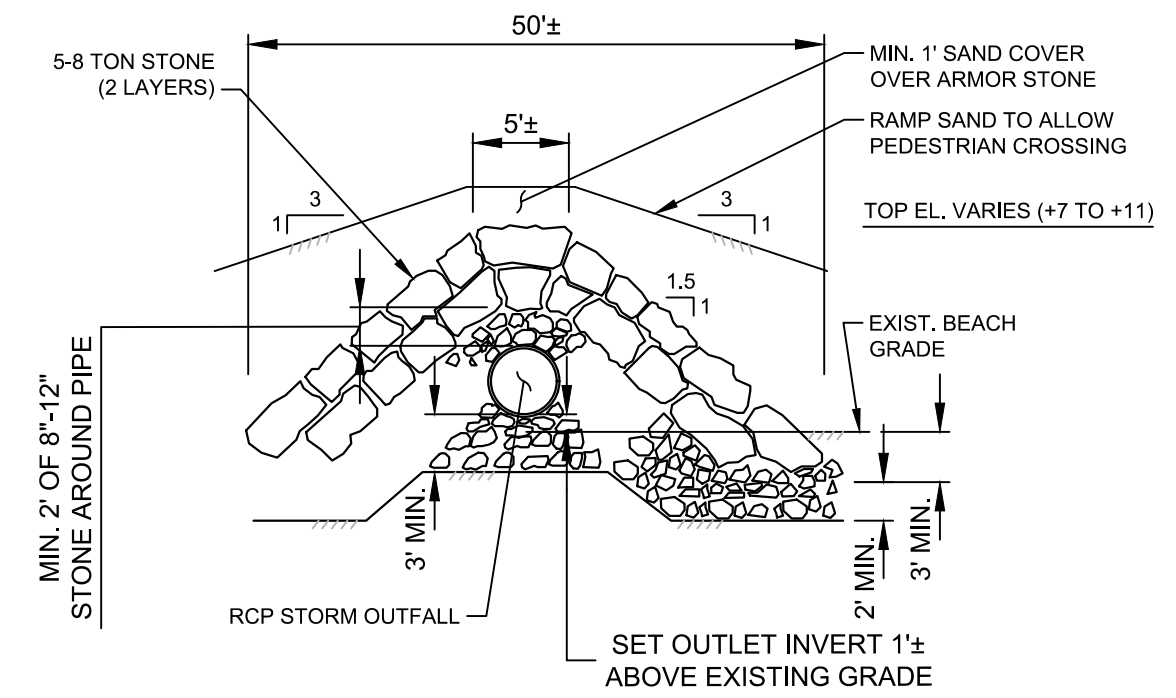

OUTFALL PIPE CROSS SECTION (TYP.)
SEE SHEET 21 FOR DETAILS

| | | | |
|-----|------------|----------------------------------|-----|
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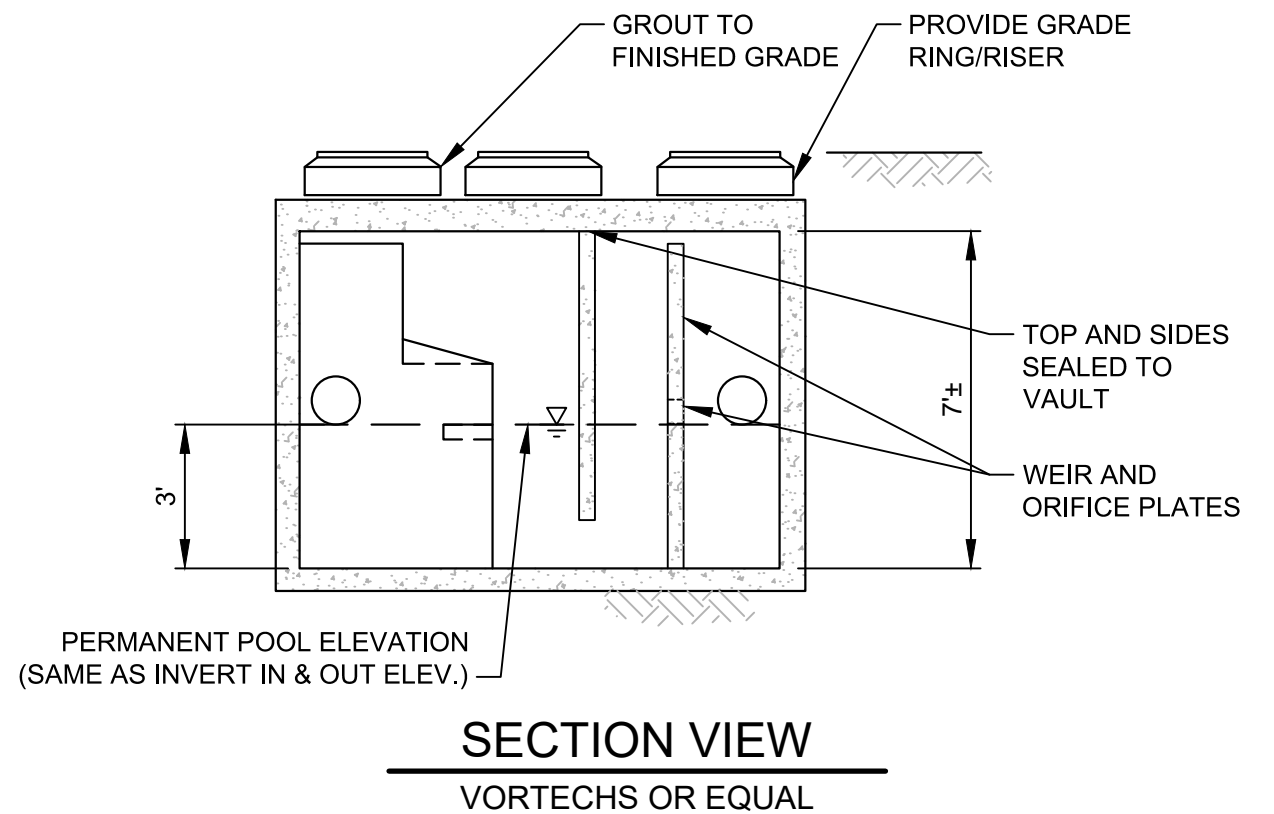
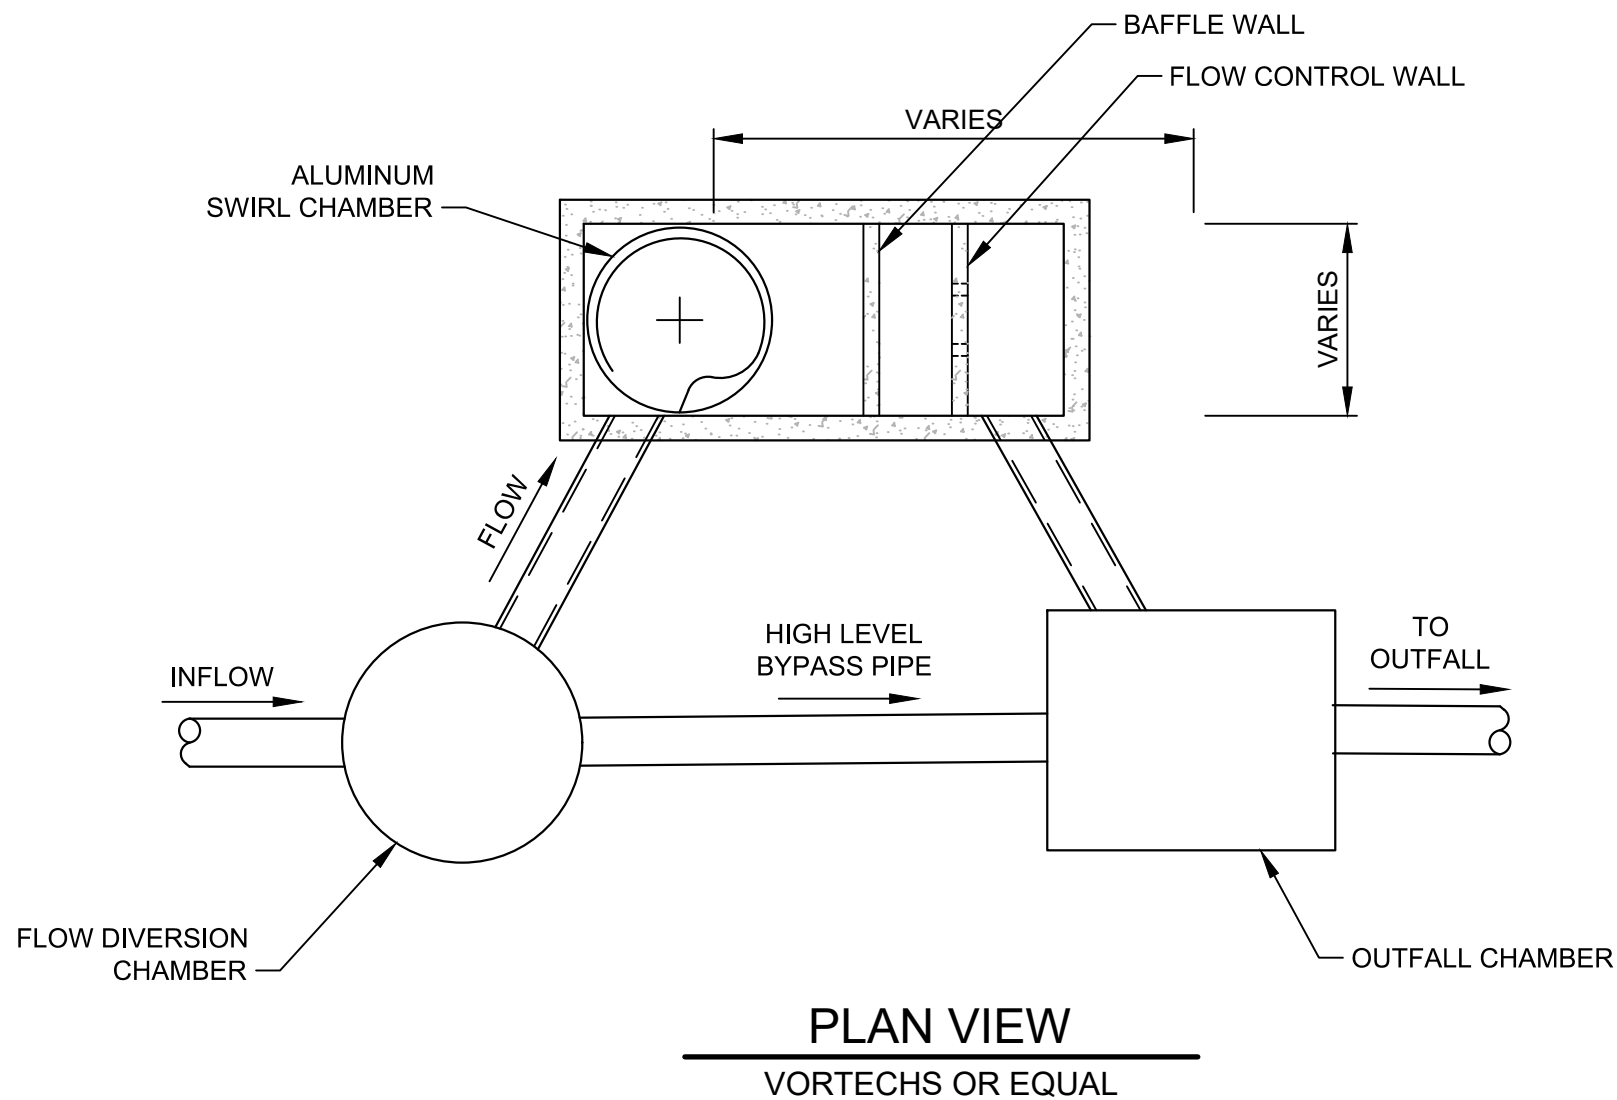


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STORM DRAIN OUTFALL DETAILS
Project 1700458
December 2017
Fig. 16

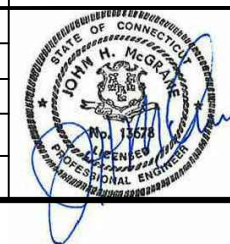

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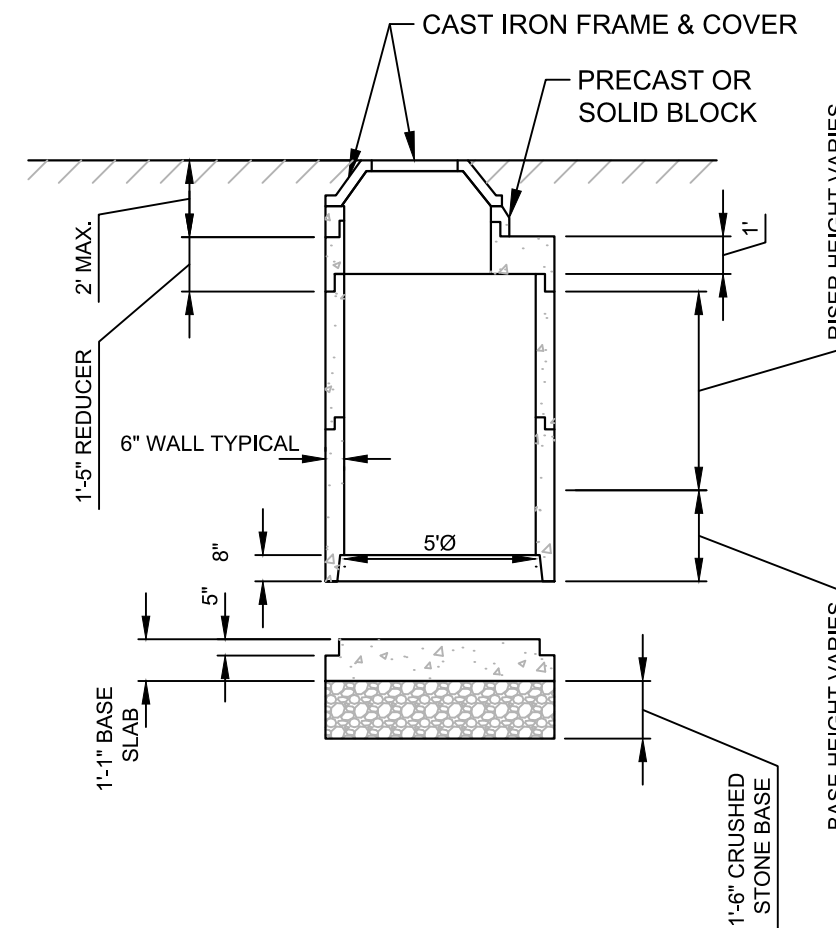


HYDRODYNAMIC SEPARATOR, DIVERSION CHAMBER, AND OUTFALL DETAIL
 Project 1700458
 December 2017
 Fig. 17

| STORM DRAIN DATA TABLE | | | | | | | |
|------------------------|------------------|----------------------------|----------------------------|----------------|-----------------------------|------------------------|--|
| Outfall Name | Location | Existing Outfall Pipe Size | Proposed Outfall Pipe Size | Approx. Length | Proposed Outfall Invert EL* | Proposed Pipe Material | Hydrodynamic Separator Site and Pipe Inverts |
| Outfall #1 | Hauser St. | 36" | 36" +/- | 150' | -1.5 | RCP | See Note 3 |
| Outfall #2 | Wildwood Ave. | 24" | 24" +/- | 160' | -3.5 | RCP | See Note 3 |
| Outfall #3 | Bittersweet Ave. | 18" | 36" +/- | 165' | -4.0 | RCP | See Note 3 |
| Outfall #4 | Smith Ave. | 12" | 24" +/- | 170' | -3.5 | RCP | See Note 3 |
| Outfall #5 | Waterbury Ave. | 18" | 24" +/- | 165' | -3.0 | RCP | See Note 3 |
| Outfall #6 | Bridgewater Ave. | 12" | 24" +/- | 170' | -3.0 | RCP | See Note 3 |
| Outfall #7 | Ann St. | 24" + 12" | 30" +/- | 170' | -2.0 | RCP | See Note 3 |
| Outfall #8 | Stowe Ave. | 24" | 24" +/- | 180' | -3.0 | RCP | See Note 3 |
| Outfall #9 | Park Ave. | 15" | 24" +/- | 160' | -2.0 | RCP | See Note 3 |
| Outfall #10 | Naugatuck Ave. | 48" | 48" +/- | 200' | -1.5 | RCP | See Note 3 |
| Outfall #11 | Viscount Dr. | 36" x 58" Squash | 48" +/- | 315' | 0.5 | RCP | See Note 3 |

NOTES:

1. INVERT ELEVATIONS SET AT 1'± ABOVE SEA FLOOR.
2. EXISTING OUTFALL PIPES LESS THAN 24" DIAMETER HAVE BEEN UPGRADED TO 24" DIAMETER MINIMUM FOR CONTRACTIBILITY AND DURABILITY REASONS.
3. SPECIFIC SIZING FOR THE HYDRODYNAMIC SEPARATOR, AS WELL SIZING FOR INLET/OUTLET & BYPASS PIPING TO BE DETERMINED AS PART OF FINAL DESIGN DRAWINGS.



5' DIA. PRECAST CONCRETE MANHOLE DETAILS

| | | | | |
|-----|------|----------------|----------------------------------|----|
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 City of Milford
 Milford, Connecticut



STORM DRAIN DATA TABLE AND OUTFALL DETAILS
 Project 1700458
 December 2017
 Fig. 18

DUNE PLANTING NOTES:

- DORMANT BEACHGRASS STEMS SHALL BE HELD IN COLD STORAGE PRIOR TO DELIVERY TO SITE.
- DELIVER PLANTS IMMEDIATELY PRIOR TO PLANTING ON SITE. STORE ALL PLANT MATERIALS, NOT INSTALLED IMMEDIATELY AFTER DELIVERY, OUT OF DIRECT EXPOSURE TO SUN AND WIND. MAINTAIN MOISTNESS OF PLANT CONTAINERS OR ROOT BALLS BY PERIODICALLY COVERING WITH WET STRAW OR CLOTH UNTIL TIME OF PLANTING.
- DO NOT STACK PLANTS DURING TRANSPORT OR TEMPORARY STORAGE TO AVOID CRUSHING.
- INSTALL SAND FENCE PRIOR TO PLANTING DUNE. INSTALL TWO (2) ROWS OF SAND FENCE PARALLEL TO THE SHORELINE, AS DEPICTED IN THE PLANS. SPACE POSTS 10 FT. APART AND SET POSTS A MINIMUM OF 3 FOOT DEPTH. WEAVE SAND FENCING IN FRONT OF AND BEHIND ALTERNATING POSTS TO ATTAIN MAXIMUM STRENGTH, AND ATTACH FENCING TO EACH POST WITH FOUR (4) WIRE TIES (≥ 12 GA.).
- STAKE OUT EDGES OF PLANTING ZONE AND CONTACT THE PROJECT ENGINEER OR LANDSCAPE ARCHITECT FOR INSPECTION PRIOR TO PLANT INSTALLATION.
- PLANT HARVESTED DORMANT BEACHGRASS STEMS FROM OCTOBER 15th THROUGH APRIL 15TH; OR NURSERY-GROWN BEACHGRASS PLUGS FROM APRIL 15TH TO May 31st.
- PLANT THE DUNE STARTING FROM THE SEAWARD SIDE (TOE OF THE DUNE) TOWARDS THE LANDWARD SIDE.
- INSTALL TWO (2) DORMANT BEACHGRASS (AMMOPHILA BREVILIGULATA) STEMS/CULMS, OR ONE PLUG PER PLANTING HOLE, APPROXIMATELY 8"-10" DEEP, SPACED A MAXIMUM OF 12" ON-CENTER.
- PLANT A MINIMUM OF TEN (10) PARALLEL ROWS, AND STAGGER/OFFSET THE PLANTS IN ALTERNATING ROWS TO MAXIMIZE PROTECTION.



SAND FENCING REQUIREMENTS:

- STANDARD FOUR (4) FOOT SLATTED WOOD SNOW FENCING.
- WOODEN POSTS:
 - POSTS SHALL BE BLACK LOCUST, EASTERN REDCEDAR ATLANTIC WHITE CEDAR OR OTHER SPECIES OF SIMILAR DURABILITY AND STRENGTH.
 - WOODEN POSTS MUST BE GREATER THAN 6 1/2 FEET IN LENGTH (7 TO 8 FT. TYP.).
- INSTALL POSTS IN A REPEATING ZIG-ZAG PATTERN SO THAT SAND FENCE SECTIONS ARE PLACED AT A 45 DEGREE ANGLE TO THE SHOREFRONT. THIS PATTERN WILL MAXIMIZE SAND ENTRAPMENT ALONG THE BEACHFRONT.
- SAND WILL TYPICALLY FILL FENCING TO 3/4 OF ITS TOTAL HEIGHT.
- REPLACE DAMAGED SAND FENCING AND POSTS WITHIN ONE MONTH OF STORM DAMAGE TO MAINTAIN A CONTINUOUS DUNE LINE.

| DUNE PLANTING SCHEDULE | | | | | | |
|-------------------------|--|-------------------------------|--------------------------------|----------------|---------|------|
| Abv. | Botanical Name | Common Name | Location | Size | Spacing | Qty. |
| Shrubs | | | | | | |
| BhT | <i>Baccharis halimifolia</i> | Groundselbush | Vegetated rip-rap, Wildemere | 2 yr. tubeling | 2' O.C. | |
| lft | <i>Iva frutescens</i> | Marsh Elder | Vegetated rip-rap, Wildemere | 2 yr. tubeling | 2' O.C. | |
| Mp | <i>Morella pensylvanica</i> | Northern Bayberry | Backdune & Planting Berm | 1 Gal. Cont. | 4' O.C. | |
| Pm | <i>Prunus maritima</i> | Beach Plum | Backdune & Planting Berm | 2 Gal. Cont. | 4' O.C. | |
| Rc | <i>Rosa carolina</i> | Carolina Rose | Backdune & Planting Berm | 1 Gal. Cont. | 2' O.C. | |
| Rv | <i>Rosa virginiana</i> | Virginia Rose | Backdune & Planting Berm | 1 Gal. Cont. | 2' O.C. | |
| Herbaceous Plugs | | | | | | |
| Ab | <i>Ammophila breviligulata</i> | American Beachgrass | Foredune & backdune throughout | Dormant culm | 1' O.C. | |
| Pa | <i>Panicum amarulum</i> | "Atlantic" Coastal Panicgrass | Backdune & Planting Berm | 2" Plug | 2' O.C. | |
| Pv | <i>Panicum virgatum</i> | Switchgrass | Backdune & Planting Berm | 2" Plug | 2' O.C. | |
| Sn | <i>Sorghastrum nutans</i> | Indiangrass | Backdune & Planting Berm | 2" Plug | 2' O.C. | |
| Sos | <i>Solidago sempervirens</i> | Seaside Goldenrod | Foredune & backdune throughout | 2" Plug | 2' O.C. | |
| Vines | | | | | | |
| Lj | <i>Lathyrus japonicus var. maritimus</i> | Beach Pea | Foredune & backdune throughout | 2" Plug | 2' O.C. | |

PLANTING TABLE NOTES:

CONT. = CONTAINER
 GAL. = GALLON
 O.C. = ON CENTER

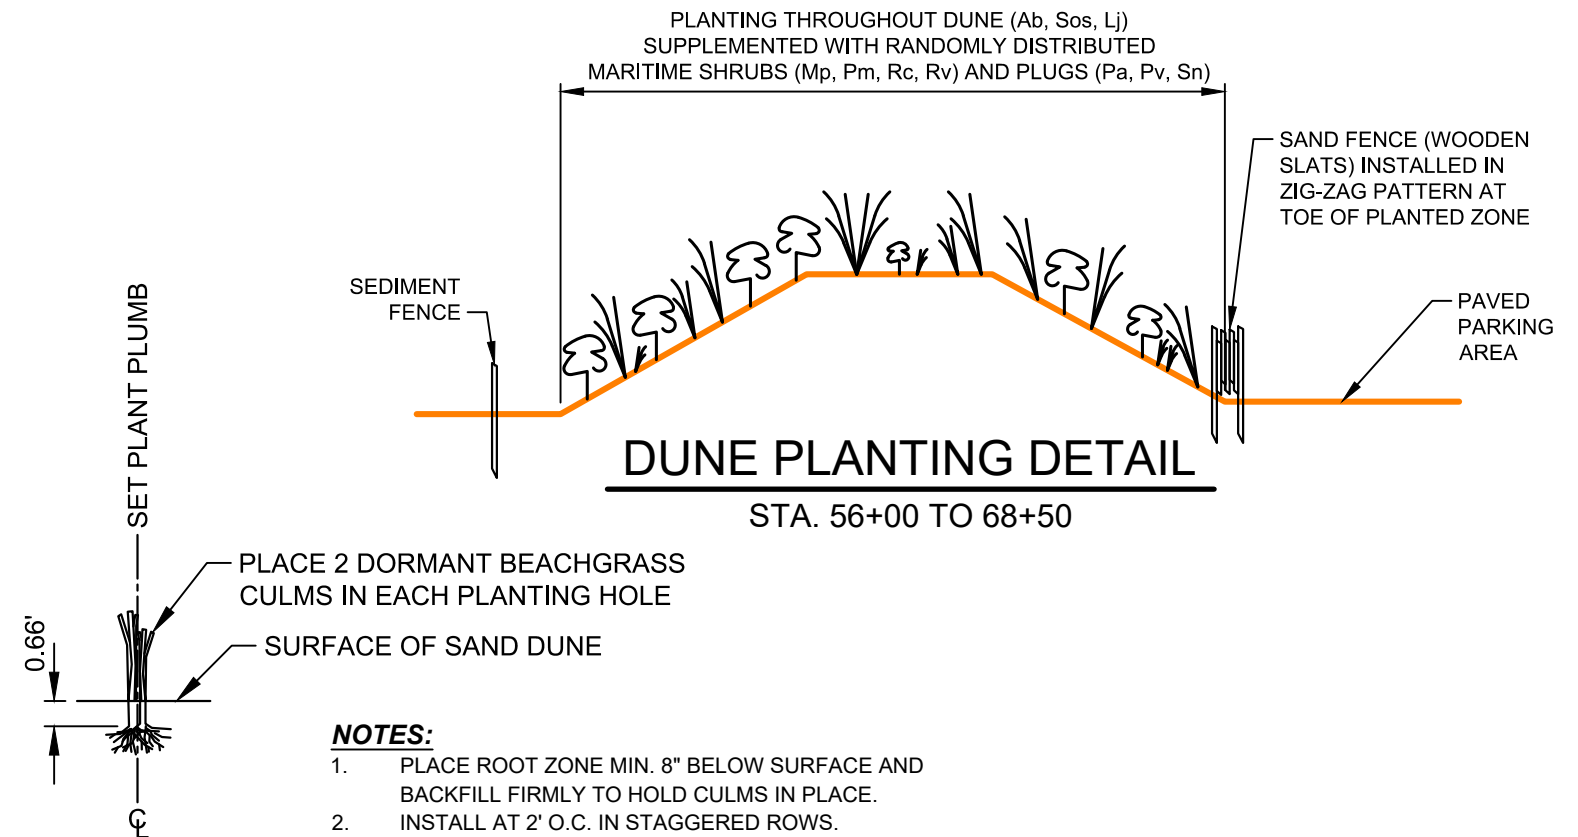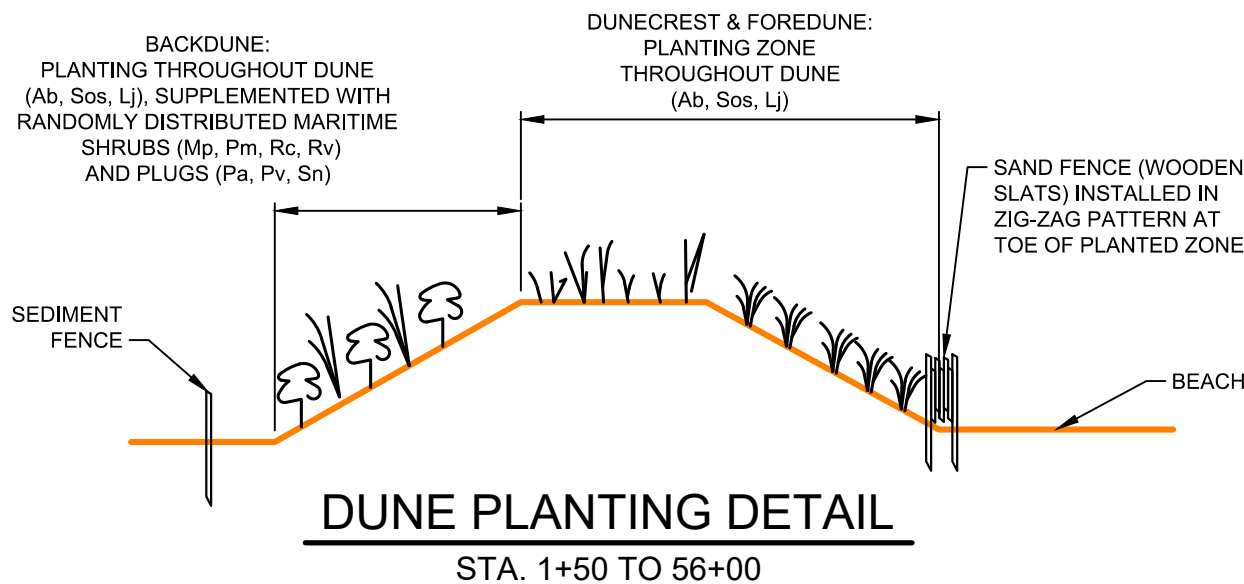

- NOTES:**
- PLACE ROOT ZONE MIN. 8" BELOW SURFACE AND BACKFILL FIRMLY TO HOLD CULMS IN PLACE.
 - INSTALL AT 2' O.C. IN STAGGERED ROWS.

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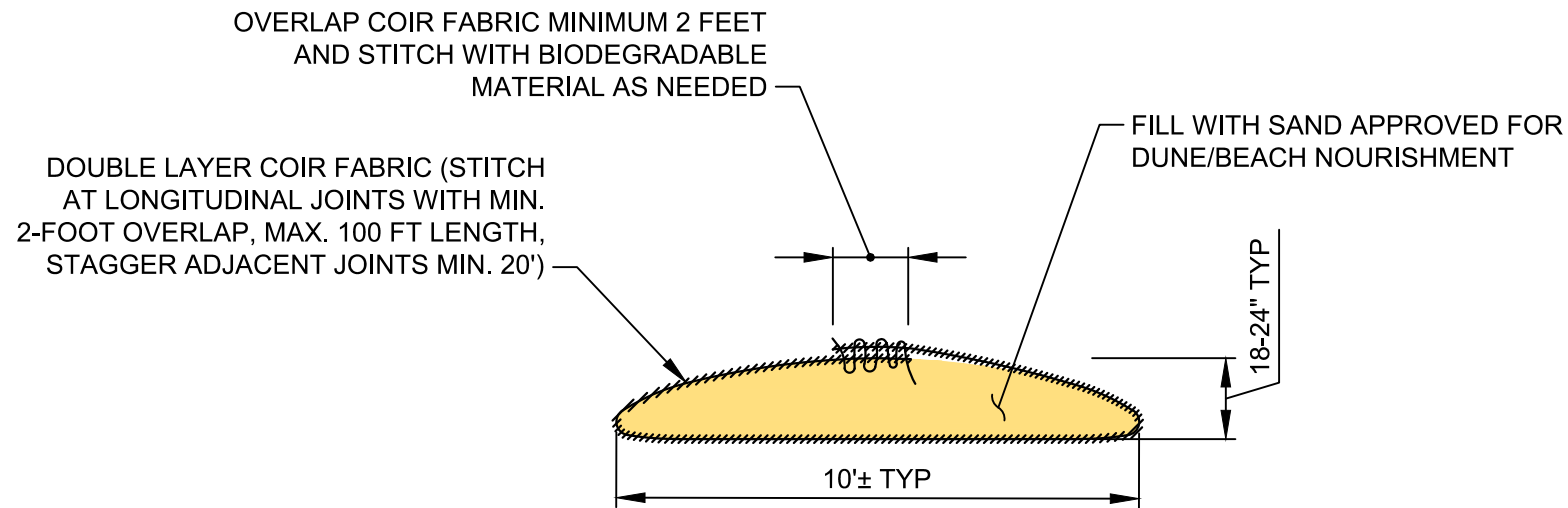


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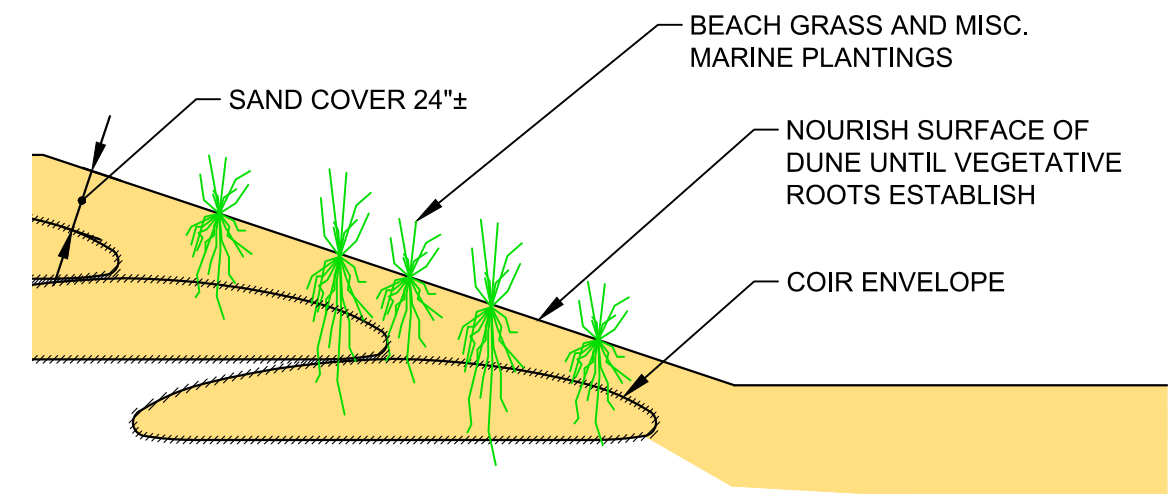


DUNE PLANTING DETAILS
 Project 1700458
 December 2017
 Fig. 19




COIR ENVELOPE DETAIL

COCONUT COIR "CONTROL MAT 90" BY GEI WORKS OR EQUAL




VEGETATED COVER DETAIL

N.T.S.

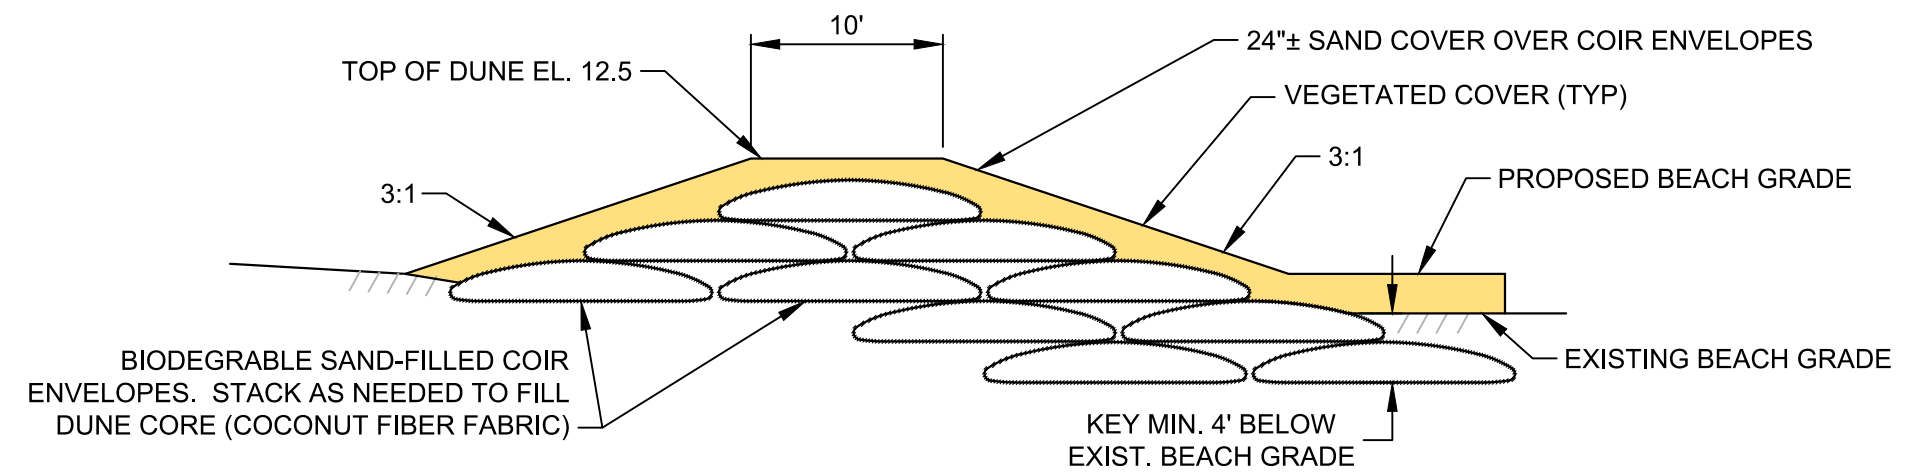


**ALTERNATE
BIO-ENGINEERED SAND DUNE
WITH COIR REINFORCEMENT**

CONTINUOUS STA. 2+00 THRU 39+00
(WITH EXCEPTION OF STORM OUTFALL LOCATIONS)

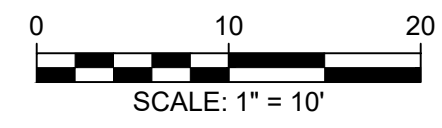

| | | | |
|-----|------------|----------------------------------|-----|
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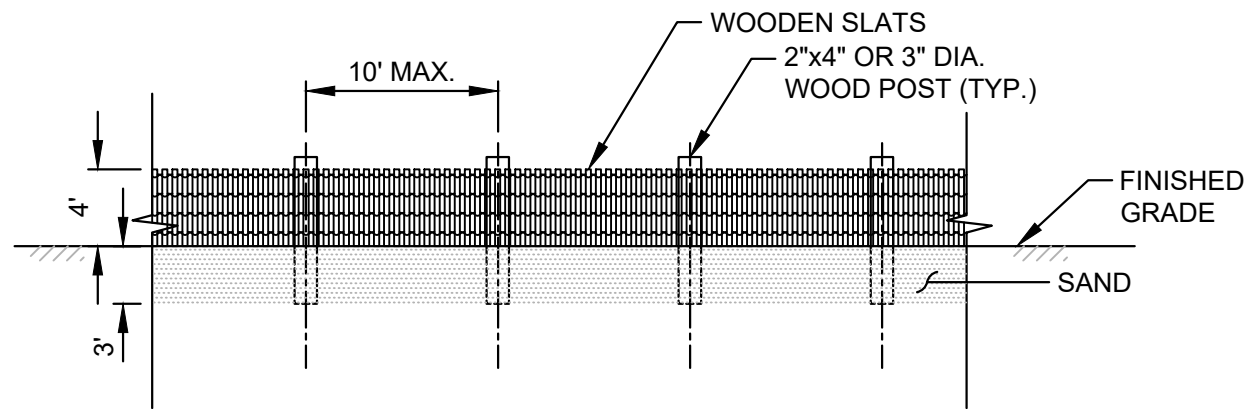


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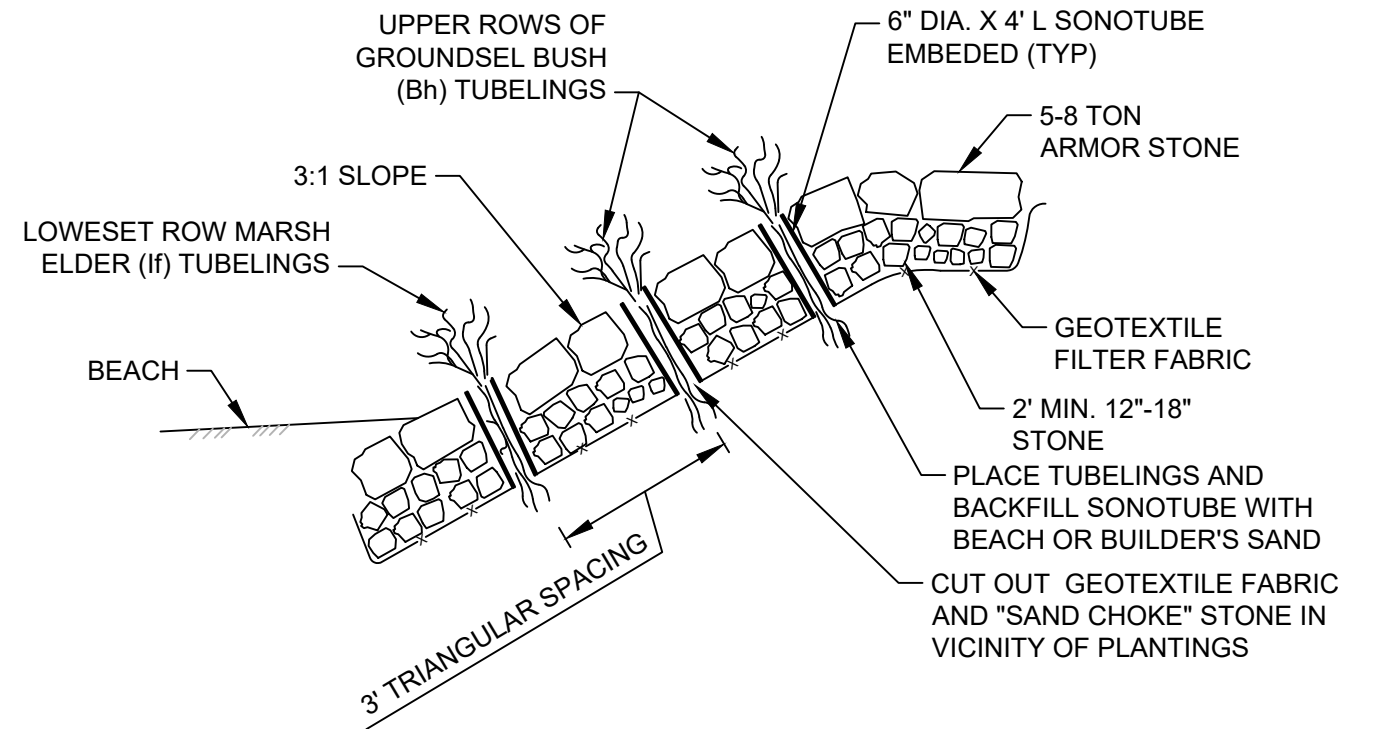
Crescent Beach Stabilization Project
Milford, Connecticut
City of Milford
Milford, Connecticut

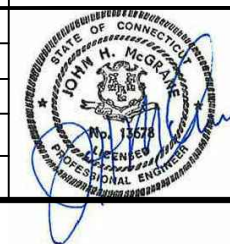

SAND DUNE COIR REINFORCEMENT DETAILS
Project 1700457
December 2017
Fig. 20




SAND FENCE




PLANTING DETAIL FOR ARMORED REVETMENT

NOT TO SCALE

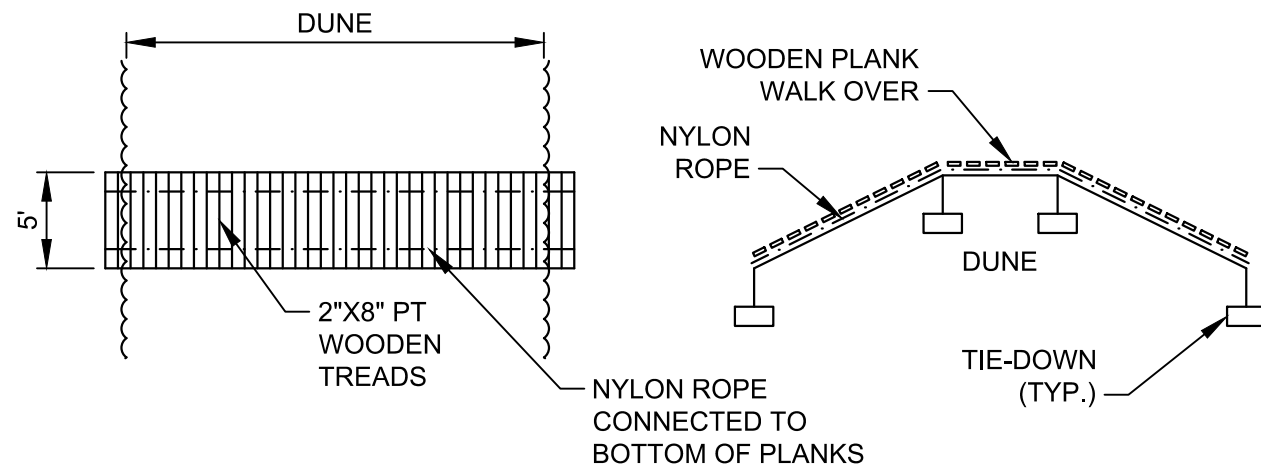

WOODEN WALKOVER DETAIL (TYPE B)

FOR MINOR PUBLIC CROSSINGS AND "PRIVATE" WALK-OVERS

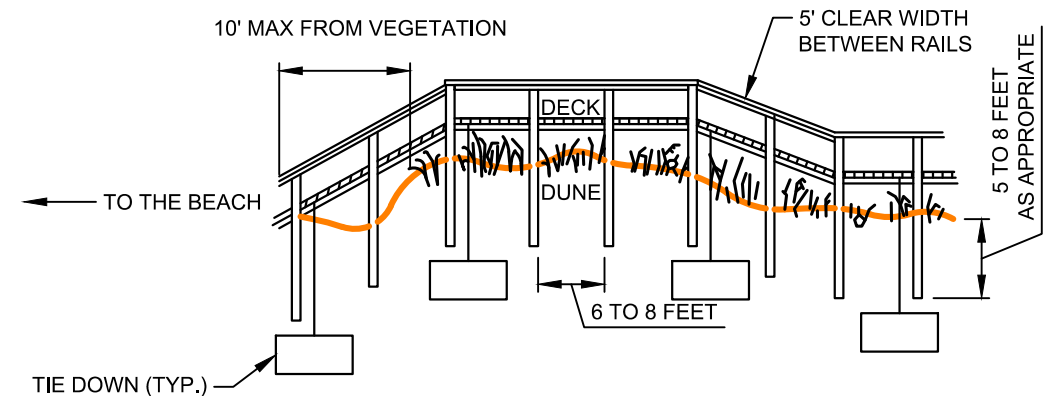

WOODEN WALKOVER DETAIL (TYPE A)

FOR MAJOR PUBLIC CROSSINGS - ADA COMPLIANT

| | | | |
|-----|------------|----------------------------------|-----|
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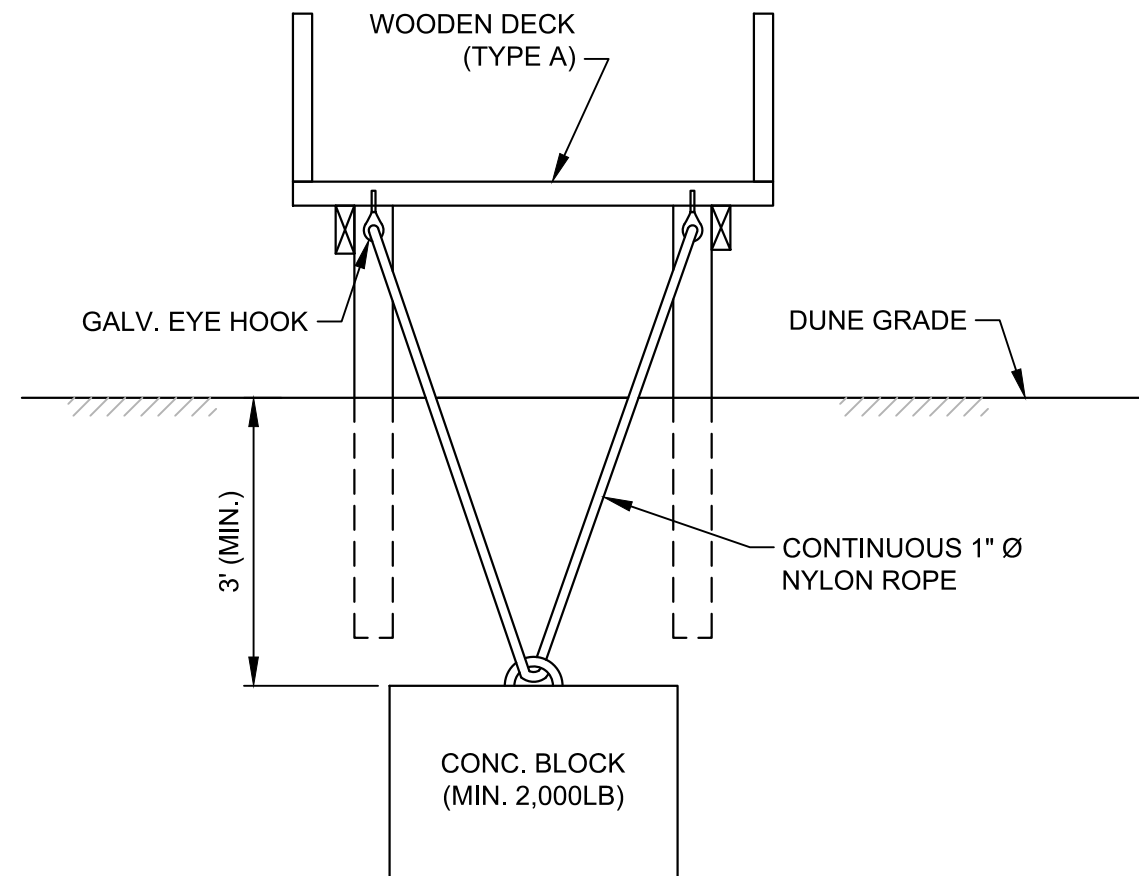


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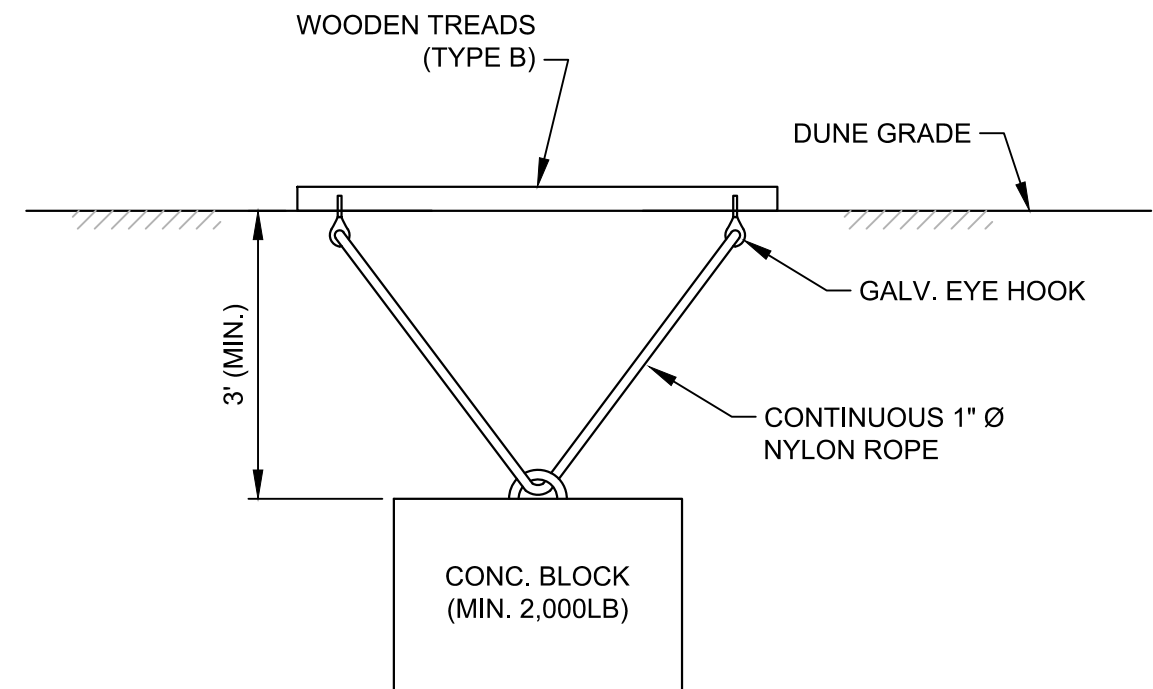
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 City of Milford
 Milford, Connecticut



DUNE WALKOVER AND PLANTING DETAILS
 Project 1700458
 December 2017
 Fig. 21



WOODEN WALKOVER TIE-DOWN DETAIL (TYPE A)



WOODEN WALKOVER TIE-DOWN DETAIL (TYPE B)

| | | | | |
|------------|-----|------------|----------------------------------|-----|
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0 1"
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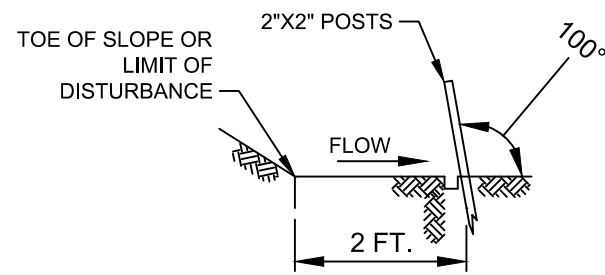


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| Designed: | JM |
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| Approved By: | JM |


Crescent Beach Stabilization Project
Milford, Connecticut
City of Milford
Milford, Connecticut




DUNE CROSS-OVER ANCHORAGE DETAILS
Project 1700457
December 2017
Fig. 22




1. SET POSTS AND EXCAVATE A 6"x6" TRENCH. SET POSTS DOWN SLOPE. ANGLE 10° UPSLOPE FOR STABILITY AND SELF CLEANING

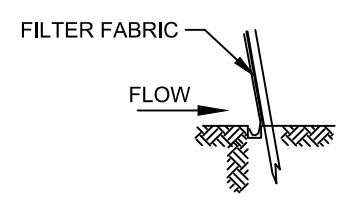

3. ATTACH FILTER FABRIC TO THE WIRE FENCING AND EXTEND IT TO THE TRENCH.

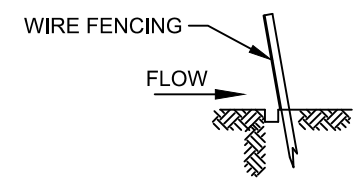


2. ATTACH THE WIRE MESH FENCING TO POST.

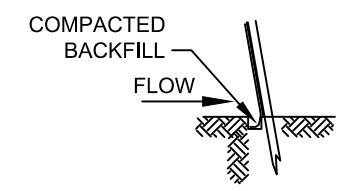

4. BACKFILL THE TRENCH AND COMPACT THE EXCAVATED SOIL.


**FILTER FABRIC FENCE SYSTEM
SEDIMENTATION CONTROL SYSTEM INSTALLATION
NOT TO SCALE**

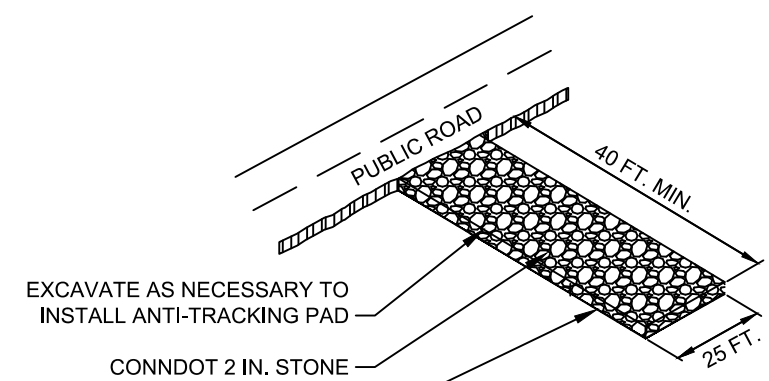


EXCAVATE AS NECESSARY TO INSTALL ANTI-TRACKING PAD
CONNDOT 2 IN. STONE
SEPARATION FABRIC

**ANTI-TRACKING PAD
NOT TO SCALE**

- NOTES:**
1. TRACKING PAD 4" MIN. THICK.
 2. PLACEMENT/LOCATION OF ANTI-TRACKING PADS WILL BE CONTAINED IN A CONTRACTOR SUBMITTED DETAILED EROSION AND SEDIMENT CONTROL PLAN.

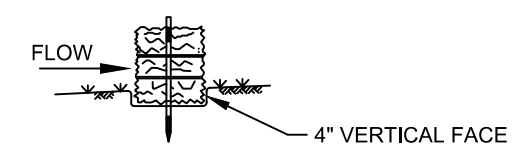


**BEDDING DETAIL
NOT TO SCALE**

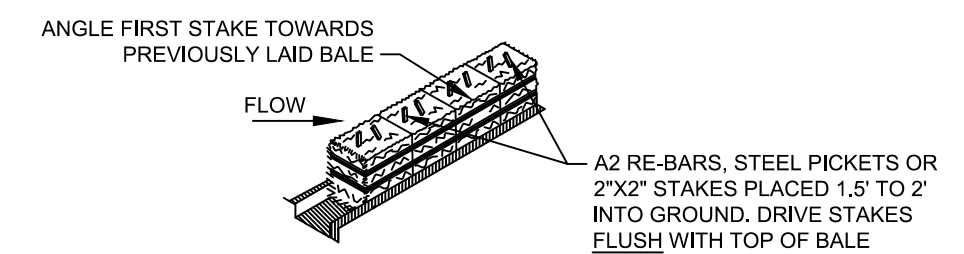


**ANCHORING DETAIL
SINGLE-STACKED STRAW BALE DIKE DETAIL
NOT TO SCALE**

TURBIDITY CURTAIN NOTES:

1. CURTAIN FABRIC SHALL BE A BRIGHTLY COLORED, TIGHTLY WOVEN, GEOSYNTHETIC OR IMPERVIOUS REINFORCED THERMOPLASTIC MATERIAL.
2. CONTRACTOR SHALL SUBMIT SHOP DRAWING OF FLOATING SEDIMENT BARRIER TO ENGINEER FOR REVIEW AND APPROVAL.
3. FLOATING SEDIMENT BARRIER AND ANCHORS SHALL BE CAREFULLY REMOVED FROM WATERCOURSE AND ACCUMULATED SEDIMENT SHALL BE DISPOSED OF IN AN OFF-SITE UPLAND AREA.
4. FLOATING SEDIMENT BARRIER SHALL BE INSPECTED DAILY FOR DAMAGE AND SEDIMENT LOAD. DEPENDING ON THE DURATION OF THE PROJECT, SEDIMENT SHALL BE REMOVED WHEN ITS ACCUMULATION INTERFERES WITH THE FUNCTION OF THE FLOATING SEDIMENT BARRIER.

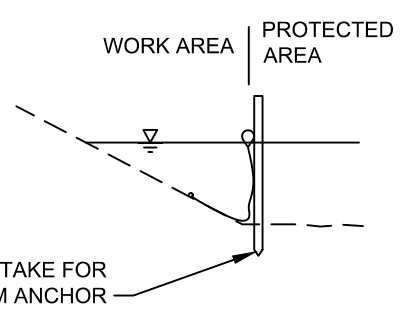


SHALLOW INSTALLATION

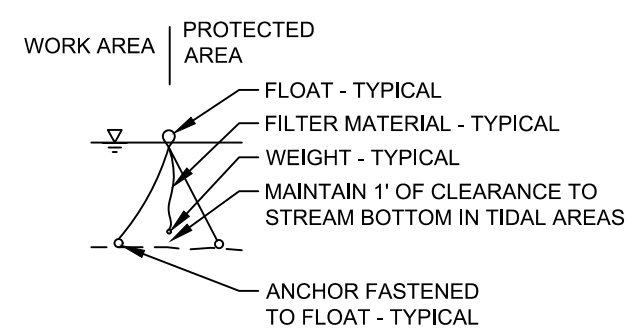

DEEP INSTALLATION

**TURBIDITY CURTAIN DETAIL
NOT TO SCALE**

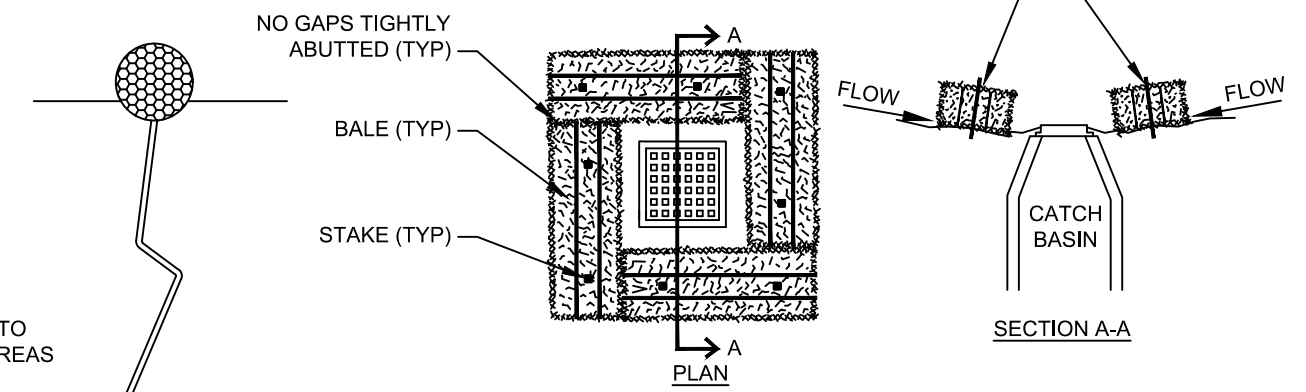


**STRAW SEDIMENT CONTROL AT CATCH BASINS
NOT TO SCALE**

- NOTES:**
1. BALES ARE TO BE PLACED 4 INCHES IN THE SOIL, TIGHTLY ABUTTING WITH NO GAPS, STAKED AND BACKFILLED AROUND THE ENTIRE OUTSIDE PERIMETER.

| NO. | DATE | ISSUE/REVISION | APP |
|-----|------------|----------------------------------|-----|
| 5 | 01/16/2019 | COIR REINFORCEMENT DETAILS ADDED | JM |
| 4 | 11/28/2018 | DRAINAGE OUTFALL REVISIONS | JM |
| 3 | 07/26/2018 | REVISED PER CT DEEP REVIEW | JM |
| 2 | 03/23/2018 | REVISIONS PER MILFORD FECB | JM |
| 1 | 03/09/2018 | REVISIONS PER MILFORD FECB | JM |
| 0 | 12/12/2017 | PERMIT REVIEW | JM |

Attention:
0 1"
If this scale bar does not measure 1" then drawing is not original scale.

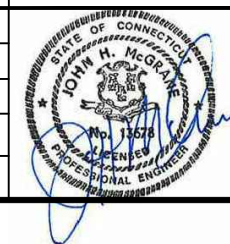

Designed: JM
Checked: BG
Drawn: DE
Approved By: JM


Walnut & Wildemere Beach Stabilization Project
Milford, Connecticut
City of Milford
Milford, Connecticut



EROSION AND SEDIMENT CONTROL DETAILS
Project 1700458
December 2017
Fig. 23

PROJECT NOTES:

1. THE CONTRACTOR ULTIMATELY SELECTED SHALL COMPLY WITH THE DEEP PERMIT FOR THE DISCHARGE OF STORMWATER AND DEWATERING WASTEWATERS ASSOCIATED WITH CONSTRUCTION ACTIVITIES, AND BE RESPONSIBLE FOR OVERSEEING THE INSTALLATION AND MAINTENANCE OF ALL SEDIMENTATION AND EROSION CONTROL MEASURES. CONTRACTOR WILL BE RESPONSIBLE FOR PREPARING AND OBTAINING THIS PERMIT, AND FOR COMPLIANCE DURING CONSTRUCTION.
2. THE CONTRACTOR ULTIMATELY SELECTED WILL BE REQUIRED TO PROVIDE A SUBMITTAL WHICH PROVIDES DETAILS, PROCEDURES, AND WORK METHODS TO PROPERLY EXECUTE THE WORK, PROTECT THE ENVIRONMENT, AND MINIMIZE DISRUPTION TO ADJACENT PROPERTIES AND PUBLIC FACILITIES. THIS PLAN SHALL INCLUDE, BUT IS NOT LIMITED TO:
 - PREPARATION OF VARIOUS PLANS AND OTHER WRITTEN SUBMITTALS REQUIRED FOR PROPER CONTROLS DURING CONSTRUCTION.
 - IDENTIFICATION OF STAGING AND STOCKPILE AREAS.
 - LOCATION AND PLACEMENT OF ANTI TRACKING PADS TO CONTROL SEDIMENTS.
 - SEQUENCING OF PLACEMENT AND REMOVAL OF TURBIDITY CURTAINS THAT WILL BE INSTALLED IN PHASES ALONG DUNE AND BEACH NOURISHMENT SECTIONS IN A "ROLLING" FASHION.
 - TRUCK ROUTES AND ACCESS POINTS FOR PORTIONS OF THE PROJECT REQUIRING OVERLAND DELIVERY OR REMOVAL OF MATERIAL.
 - FOR MATERIAL DELIVERED OR REMOVED FROM SITE USING WATERBORNE MEANS (BARGES, ETC.) A DETAILED SUBMITTAL WILL BE REQUIRED.
3. SEDIMENTATION AND EROSION CONTROL MEASURES ARE PROPOSED TO ADEQUATELY CONTROL THE ACCELERATED EROSION AND SEDIMENTATION AND REDUCE THE DANGER FROM STORMWATER RUNOFF AT THE SITE. THE RUNOFF SHALL BE CONTROLLED BY THE INTERCEPTION, DIVERSION, AND SAFE DISPOSAL OF PRECIPITATION. RUNOFF SHALL ALSO BE CONTROLLED BY STAGING CONSTRUCTION ACTIVITY AND PRESERVING NATURAL VEGETATION WHENEVER POSSIBLE.
4. EXISTING DUNE VEGETATION SHALL BE PROTECTED AND ONLY THAT CLEARING AND GRUBBING THAT IS ABSOLUTELY NECESSARY FOR THE PROPOSED DUNE CONSTRUCTION, DRAINAGE INSTALLATION, AND BEACH NOURISHMENT SHALL BE PERFORMED. ALL DISTURBED AREAS SHALL BE RESTORED TO THEIR ORIGINAL CONDITION AND CONTOUR, UNLESS OTHERWISE INDICATED ON THE PLANS. THE CONTRACTOR SHALL TAKE SPECIAL CARE WITH HIS DUNE CONSTRUCTION, BEACH NOURISHMENT, AND DREDGING METHODS AND SHALL COMPLY WITH SPECIFICATIONS FOR EROSION AND SEDIMENT CONTROLS.
5. ALL AREAS SHALL BE PROTECTED FROM SEDIMENTATION DURING AND AFTER DREDGING, INCLUDING THE CORRESPONDING STORAGE AND HANDLING AREAS FOR DREDGED SEDIMENT. STOCKPILES MUST BE ADEQUATELY PROTECTED WITH HAY BALES AND/OR FILTER FABRIC FENCE AS INDICATED.
6. FREQUENTLY INSPECT EROSION CONTROLS. REPAIR/REPLACE DEFICIENT EROSIONS CONTROLS PROMPTLY, AS NEEDED.
7. STONE STABILIZED VEHICLE ANTI-TRACKING PADS SHALL BE LOCATED AT POINTS OF VEHICULAR INGRESS AND EGRESS FROM THE CONSTRUCTION SITE TO REDUCE TRACKING OR FLOWING OF SEDIMENT INTO PUBLIC RIGHTS-OF-WAY. FILTER FABRIC SHALL BE PLACED ON SUBGRADE PRIOR TO PLACEMENT OF STONE. STONE SHALL BE PLACED TO THE DIMENSIONS SHOWN ON THE PLAN. PERIODIC TOP DRESSING WITH ADDITIONAL STONE OR ADDITIONAL LENGTH, AS CONDITIONS DEMAND, MAY BE REQUIRED TO ENSURE THAT THE ENTRANCE FUNCTIONS AS INTENDED. PUBLIC ROADWAYS SHALL BE CLEANED OF DIRT AND DEBRIS AS NECESSARY, OR AS DIRECTED BY THE ENGINEER.
8. IN ALL AREAS, REMOVAL OF TREES, BUSHES AND OTHER VEGETATION, AND DISTURBANCE OF THE SOIL, IS TO BE KEPT TO AN ABSOLUTE MINIMUM WHILE ALLOWING PROPER DEVELOPMENT OF THE SITE.
9. DURING DREDGING OPERATIONS REQUIRED FOR INSTALLATION OF DRAINAGE, ROCK CORE BASE, AND OTHER COMPONENTS, THE AREA AND DURATION OF SEDIMENT EXPOSURE SHALL BE MINIMIZED, AND THE SEQUENCE OF DREDGING OPERATION SHALL ACT TO MINIMIZE THE EXPOSURE.
10. ALL SEDIMENTATION AND EROSION CONTROL DEVICES SHALL BE INSPECTED DURING CONSTRUCTION AND THE CONTRACTOR SHALL MAINTAIN AND MAKE REPAIRS AND REMOVE SEDIMENT IF IT HAS ACCUMULATED AND RENDERED THE SEDIMENT CONTROL NON-FUNCTIONAL. THE CONTRACTOR SHALL IN ADDITION MAINTAIN AND MAKE REPAIRS AND REMOVE SEDIMENT AS REQUESTED BY THE ENGINEER. THE CONTRACTOR SHALL CLEAN SEDIMENT AND DEBRIS FROM ALL DRAINAGE STRUCTURES AND PIPES AT THE COMPLETION OF THE DREDGING ACTIVITIES AND AS REQUESTED BY THE ENGINEER TO KEEP THE DRAINAGE SYSTEM PROPERLY FUNCTIONING.

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|--|-----|------------|----------------------------------|-----|
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|--------------|----|
| Designed: | JM |
| Checked: | BG |
| Drawn: | DE |
| Approved By: | JM |

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| Walnut & Wildemere Beach Stabilization Project Milford, Connecticut |
| City of Milford Milford, Connecticut |



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|------------------------------------|---------------|---------|
| EROSION AND SEDIMENT CONTROL NOTES | | |
| Project 1700458 | December 2017 | Fig. 24 |