



Connecticut Department of Energy and Environmental Protection License*

Inland Wetlands & Watercourses Permit

Licensee(s): CT Department of
Transportation

Licensee Address(s): 2800 Berlin Turnpike
Newington CT, 06111

License Number(s): 202411418-IW

Municipality: Mansfield/Windham

Project Description: Rehabilitation of Bridge No. 06729 for Infrastructure
Improvement

Project Address/Location: Route 6, north of Cameo Drive

Waters: Unnamed brook, unnamed wetlands

**Authorizing CT Statute(s)
and/or Federal Law:** CGS Section 22a-36 to 45

**Applicable Regulations of
CT State Agencies:** 22a-39-1 to 15

Agency Contact: Land & Water Resources Division,
Bureau of Water Protection & Land Reuse, 860-424-3019

License Expiration: Five (5) years from the date of issuance of this license.

Project Site Plan Set: *Environmental Permit Plans State Project No. 0163-0206
Rehabilitation of Bridge No. 06729 U.S. Route 6 over unnamed
brook, 6 sheets prepared by Weston & Sampson, dated November
7, 2024.*

License Enclosures: LWRD General Conditions; Site Plan Set; LWRD Work
Commencement Form; LWRD Compliance Certification Form

*Connecticut's Uniform Administrative Procedure Act defines License to include, "the whole or part of any agency permit, certificate, approval, registration, charter or similar form of permission required by law . . ."

Authorized Activities:

The Licensee is hereby authorized to conduct the following work as described in application # 202411418 and as depicted on any site plan sheets / sets cited herein:

1. Install sediment and erosion control fencing in accordance with plan sheet PMT-03;
2. Install permanent northeast access road in accordance with plan sheet PMT-03;
3. Install temporary sandbag cofferdams, bypass pipes and/or pump hoses throughout culvert, and at the outlet's southwest wingwall for ancillary drainage, as needed and in accordance with plan sheet PMT-04;
4. Repair steel arch plates within the existing 325'6" long, 8'10" wide and 6'1" tall asphalt-coated corrugated metal pipe culvert and install low pressure grout to fill voids in accordance with plan sheet PMT-03;
5. Install a new 4" thick, steel-reinforced concrete invert liner to a height of 4" throughout the length of the culvert in accordance with plan sheets PMT-03 and PMT-05;
6. Install natural streambed material and match channel bed to new invert grade in accordance with plan sheets PMT-05 & PMT-06; and
7. Remove temporary water handling cofferdams, bypass pipes and/or pumps.

Failure to comply with the terms and conditions of this license shall subject the Licensee and / or the Licensee's contractor(s) to enforcement actions and penalties as provided by law.

This license is subject to the following Terms and Conditions:

1. **License Enclosure(s) and Conditions.** The Licensee shall comply with all applicable terms and conditions as may be stipulated within the License Enclosure(s) listed above.
2. **Time-of-Year Restrictions.** Any unconfined in-stream work within the watercourse shall be restricted to the period from June 1st to September 30th, inclusive.
3. **Discharge of Concrete.** At no time shall the Licensee allow concrete to discharge into the unnamed watercourse or surrounding wetlands.
4. **Stockpile Location.** The Licensee shall store excavated sediment for native streambed material outside of regulated wetland and watercourse areas.
5. **Temporary Water Handling.** Temporary water handling facilities shall be conducted within the low flow period from June 1 to September 30, inclusive, and within a period of three (3) months, inclusive, unless otherwise authorized in writing by the commissioner.

Issued under the authority of the Commissioner of Energy and Environmental Protection on:

Date

Emma Cimino
Deputy Commissioner
Environmental Quality Branch



LWRD General Conditions

1. **Land Record Filing (for Structures Dredging & Fill, Tidal Wetlands, Certificate of Permission, and Long Island Sound General Permit Licenses only).** The Licensee shall file the Land Record Filing on the land records of the municipality in which the subject property is located not later than thirty (30) days after license issuance pursuant to Connecticut General Statutes (CGS) Section 22a-363g. A copy of the Notice with a stamp or other such proof of filing with the municipality shall be submitted to DEEP.LWRDRegulatory@ct.gov no later than sixty (60) days after license issuance. If a Land Record Filing form is not enclosed and the work site is not associated with an upland property, no filing is required.
2. **Contractor Notification.** The Licensee shall give a copy of the license and its attachments to the contractor(s) who will be carrying out the authorized activities prior to the start of construction and shall receive a written receipt for such copy, signed and dated by such contractor(s). The Licensee's contractor(s) shall conduct all operations at the site in full compliance with the license and, to the extent provided by law, may be held liable for any violation of the terms and conditions of the license. At the work site, the contractor(s) shall, whenever work is being performed, have on site and make available for inspection a copy of the license and the authorized plans.
3. **Work Commencement¹.** Not later than two (2) weeks prior to the commencement of any work authorized herein, the Licensee shall submit to DEEP.LWRDRegulatory@ct.gov, on the Work Commencement Form attached hereto, the name(s) and address(es) of all contractor(s) employed to conduct such work and the expected date for commencement and completion of such work, if any.
 - For water diversion activities authorized pursuant to 22a-377(c)-1 of the Regulations of Connecticut State Agencies, the Licensee shall also notify the Commissioner in writing two weeks prior to initiating the authorized diversion.
 - For emergency activities authorized pursuant Connecticut General Statutes Section 22a-6k, the Licensee shall notify the Commissioner, in writing, of activity commencement at least one (1) day prior to construction and of activity completion no later than five (5) days after conclusion.
4. **For Coastal Licenses Only - License Notice.** The Licensee shall post the first page of the License in a conspicuous place at the work area while the work authorized therein is undertaken.
5. **Unauthorized Activities.** Except as specifically authorized, no equipment or material, including but not limited to, fill, construction materials, excavated material or debris, shall be deposited, placed or stored in any wetland or watercourse on or off-site. The Licensee may not

¹ The Work Commencement condition and the need for a Work Commencement Form is not applicable to Flood Management Certification approvals.

conduct work within wetlands or watercourses other than as specifically authorized, unless otherwise authorized in writing by the Commissioner. Tidal wetlands means “wetland” as defined by section 22a-29 and “freshwater wetlands and watercourses” means “wetlands” and “watercourses” as defined by section 22a-38.

6. **Management of Materials.** Any materials removed from the site shall be managed in accordance with all federal, state, and local requirements, including Chapter 446K Water Pollution Control, Chapter 445 Hazardous Waste, and Chapter 446d Solid Waste of the Connecticut General Statutes.
7. **Unconfined Instream Work.** Unless otherwise noted in a condition of the license, the following conditions apply to projects in non-coastal waters:
 - Unconfined instream work is limited to the period June 1 through September 30.
 - Confinement of a work area by cofferdam techniques using sand bag placement, sheet pile installation (vibratory method only), portadam, or similar confinement devices is allowed any time of the year. The removal of such confinement devices is allowed any time of the year.
 - Once a work area has been confined, in-water work within the confined area is allowed any time of the year.
 - The confinement technique used shall completely isolate and protect the confined area from all flowing water. The use of silt boom/curtain or similar technique as a means for confinement is prohibited.
8. **For State Actions Only - Material or Equipment Storage in the Floodplain.** Unless approved by a Flood Management Exemption, the storage of any materials at the site which are buoyant, hazardous, flammable, explosive, soluble, expansive, radioactive, or which could in the event of a flood be injurious to human, animal or plant life, below the elevation of the five-hundred (500) year flood is prohibited. Any other material or equipment stored at the site below said elevation by the Licensee or the Licensee's contractor must be firmly anchored, restrained or enclosed to prevent flotation. The quantity of fuel stored below such elevation for equipment used at the site shall not exceed the quantity of fuel that is expected to be used by such equipment in one day. In accordance with the licensee's Flood Contingency Plan, the Licensee shall remove equipment and materials from the floodplain during periods when flood warnings have been issued or are anticipated by a responsible federal, state or local agency. It shall be the Licensee's responsibility to obtain such warnings when flooding is anticipated.
9. **Temporary Hydraulic Facilities for Water Handling.** If not reviewed and approved as a part of the license application, temporary hydraulic facilities shall be designed by a qualified professional and in accordance with the *Connecticut Guidelines for Soil Erosion and Sediment Control*, the *2004 Connecticut Stormwater Quality Manual*, or the *Department of Transportation's ConnDOT Drainage Manual*, as applicable. Temporary hydraulic facilities may include channels, culverts or bridges which are required for haul roads, channel relocations, culvert installations, bridge construction, temporary roads, or detours.
10. **Excavated Materials.** Unless otherwise authorized, all excavated material shall be staged and

managed in a manner which prevents additional impacts to wetlands and watercourses.

- 11. Best Management Practices.** The Licensee shall not cause or allow pollution of any wetlands or watercourses, including pollution resulting from sedimentation and erosion. In constructing or maintaining any authorized structure or facility or conducting any authorized activity, or in removing any such structure or facility, the Licensee shall employ best management practices to control storm water discharges, to prevent erosion and sedimentation, and to otherwise prevent pollution of wetlands and other waters of the State. For purposes of the license, “pollution” means “pollution” as that term is defined by CGS section 22a-423. Best Management Practices include, but are not limited, to practices identified in the *Connecticut Guidelines for Soil Erosion and Sediment Control* as revised, *2004 Connecticut Stormwater Quality Manual*, Department of Transportation’s *ConnDOT Drainage Manual* as revised, and the Department of Transportation Standard Specifications as revised.
- 12. In-Water Work Vessel Staging and Storage. (for Structures Dredging & Fill, Tidal Wetlands, Certificate of Permission, and Long Island Sound General Permit Licenses only).** For any barge, vessel, skiff or floating work platform (“work vessels”) utilized in the execution of the work authorized herein, the Licensee shall ensure that such work vessels:

 - do not rest on, or come in contact with, the substrate at any time, unless specifically authorized in the license.
 - are not stored over intertidal flats, submerged aquatic vegetation or tidal wetland vegetation or in a location that interferes with navigation. In the event any work vessel is grounded, no dragging or prop dredging shall occur to free it.
- 13. Work Site Restoration.** Upon completion of any authorized work, the Licensee shall restore all areas temporarily impacted by construction, or used as a staging area or accessway in connection with such work, to their condition prior to the commencement of such work.
- 14. Inspection.** The Licensee shall allow any representative of the Commissioner to inspect the project location at reasonable times to ensure that work is being or has been conducted in accordance with the terms and conditions of this license.
- 15. Change of Use. (Applies only if a use is specified within the License “Project Description”)**

 - a. The work specified in the license is authorized solely for the purpose set forth in the license. No change in purpose or use of the authorized work or facilities as set forth in the license may occur without the prior written approval of the Commissioner. The Licensee shall, prior to undertaking or allowing any change in use or purpose from that which is authorized by this license, request permission from the Commissioner for such change. Said request shall be in writing and shall describe the proposed change and the reason for the change.
 - b. A change in the form of ownership of any structure authorized herein from a rental/lease commercial marina to a wholly-owned common interest community or dockominium may constitute a change in purpose as specified in paragraph (a) above.
- 16. De Minimis Alteration.** The Licensee shall not deviate from the authorized activity without prior written approval from the Commissioner. The Licensee may request a de minimis change

to any authorized structure, facility, or activity. A de minimis alteration means a change in the authorized design, construction or operation that individually and cumulatively has minimal additional environmental impact and does not substantively alter the project as authorized.

- For diversion activities authorized pursuant to 22a-377(c)-2 of the Regulations of Connecticut State Agencies, a de minimis alteration means an alteration which does not significantly increase the quantity of water diverted or significantly change the capacity to divert water.

17. Extension Request. The Licensee may request an extension of the license expiration date. Such request shall be in writing and shall be submitted to DEEP.LWRDRegulatory@ct.gov at least thirty (30) days prior to the license expiration. Such request shall describe the work done to date, what work still needs to be completed, and the reason for such extension. The Commissioner may extend the expiration date of this license for a period of up to one year, in order for the Licensee to complete the authorized activities. It shall be at the Commissioner's sole discretion to grant or deny such request. No more than three (3) one-year extensions will be granted under this license.

18. Compliance Certification². Not later than 90 days after completion of the authorized work, the Licensee shall prepare and submit to DEEP.LWRDRegulatory@ct.gov, the attached Compliance Certification Form. Such Compliance Certification shall be completed, signed, and sealed by the Licensee and a Connecticut Licensed Design Professional. If non-compliance is indicated on the form, or the Commissioner has reason to believe the activities and/or structures were conducted in non-compliance with the license, the Commissioner may require the Licensee to submit as-built plans as a condition of this license.

19. Maintenance. The Licensee shall maintain all authorized structures or work in optimal condition or shall remove such structures or facility and restore the affected waters to their pre-work condition. Any such maintenance or removal activity shall be conducted in accordance with applicable law and any additional approvals required by law.

20. No Work After License Expiration. Work conducted after the license expiration date is a violation of the license and may subject the licensee to enforcement action, including penalties, as provided by law.

21. License Transfer. The license is not transferable without prior written authorization of the Commissioner. A request to transfer a license shall be submitted in writing and shall describe the proposed transfer and the reason for such transfer. The Licensee's obligations under the license shall not be affected by the passage of title to the license site to any other person or municipality until such time as a transfer is approved by the Commissioner.

22. Document Submission. Any document required to be submitted to the Commissioner under the license or any contact required to be made with the Commissioner shall, unless otherwise specified in writing by the Commissioner, be directed to:

DEEP.LWRDRegulatory@ct.gov or

² The Work Commencement condition and the need for a Work Commencement Form is not applicable to Flood Management Certification approvals.

Regulatory Section
Land & Water Resources Division
Department of Energy and Environmental Protection
79 Elm Street
Hartford, Connecticut 06106-5127
860-424-3019

- 23. Date of Document Submission.** The date of submission to the Commissioner of any document required by the license shall be the date such document is received by the Commissioner. The date of any notice by the Commissioner under the license, including but not limited to notice of approval or disapproval of any document or other action, shall be the date such notice is personally delivered or the date three (3) days after it is mailed by the Commissioner, whichever is earlier. Except as otherwise specified in the license, the word “day” as used in the license means calendar day. Any document or action which is required by the license to be submitted or performed by a date which falls on a Saturday, Sunday or a Connecticut or federal holiday shall be submitted or performed on or before the next day which is not a Saturday, Sunday, or a Connecticut or federal holiday.
- 24. Certification of Documents.** Any document, including but not limited to any notice, which is required to be submitted to the Commissioner under the license shall be signed by the Licensee and by the individual or individuals responsible for actually preparing such document, each of whom shall certify in writing as follows: “I have personally examined and am familiar with the information submitted in this document and all attachments and certify that based on reasonable investigation, including my inquiry of those individuals responsible for obtaining the information, the submitted information is true, accurate and complete to the best of my knowledge and belief, and I understand that any false statement made in this document or its attachments may be punishable as a criminal offense.”
- 25. Accuracy of Documentation.** In evaluating the application for the license, the Commissioner has relied on information and data provided by the Licensee and on the Licensee’s representations concerning site conditions, design specifications and the proposed work, including but not limited to representations concerning the commercial, public or private nature of the work or structures, the water-dependency of said work or structures, its availability for access by the general public, and the ownership of regulated structures or filled areas. If such information proves to be false, deceptive, incomplete or inaccurate, the license may be modified, suspended or revoked, and any unauthorized activities may be subject to enforcement action.
- 26. Limits of Liability.** In granting the license, the Commissioner has relied on all representations of the Licensee, including information and data provided in support of the Licensee’s application. Neither the Licensee’s representations nor the issuance of the license shall constitute an assurance by the Commissioner as to the structural integrity, the engineering feasibility or the efficacy of such design.
- 27. Reporting of Violations.** In the event that the Licensee becomes aware that they did not or may not comply, or did not or may not comply on time, with any provision of this license or

of any document incorporated into the license, the Licensee shall immediately notify the agency contact specified within the license and shall take all reasonable steps to ensure that any noncompliance or delay is avoided or, if unavoidable, is minimized to the greatest extent possible. In so notifying the agency contact, the Licensee shall provide, for the agency's review and written approval, a report including the following information:

- a. the provision(s) of the license that has been violated;
- b. the date and time the violation(s) was first observed and by whom;
- c. the cause of the violation(s), if known;
- d. if the violation(s) has ceased, the duration of the violation(s) and the exact date(s) and times(s) it was corrected;
- e. if the violation(s) has not ceased, the anticipated date when it will be corrected;
- f. steps taken and steps planned to prevent a reoccurrence of the violation(s) and the date(s) such steps were implemented or will be implemented; and
- g. the signatures of the Licensee and of the individual(s) responsible for actually preparing such report.

If the violation occurs outside of normal business hours, the Licensee shall contact the Department of Energy and Environmental Protection Emergency Dispatch at 860-424-3333. The Licensee shall comply with any dates which may be approved in writing by the Commissioner.

- 28. Revocation/Suspension/Modification.** The license may be revoked, suspended, or modified in accordance with applicable law.
- 29. Other Required Approvals.** License issuance does not relieve the Licensee of their obligations to obtain any other approvals required by applicable federal, state and local law.
- 30. Rights.** The license is subject to and does not derogate any present or future property rights or powers of the State of Connecticut, and conveys no property rights in real estate or material nor any exclusive privileges, and is further subject to any and all public and private rights and to any federal, state or local laws or regulations pertinent to the property or activity affected hereby.
- 31. Condition Conflicts.** In the case where a project specific special condition listed on the license differs from, or conflicts with, one of the general conditions listed herein, the project specific special condition language shall prevail. It is the licensee's responsibility to contact the agency contact person listed on the license for clarification if needed prior to conducting any further regulated activities.

WATER HANDLING NOTES

1. THE CONTRACTOR SHALL MAINTAIN WATER THROUGH THE TEMPORARY WATER HANDLING SYSTEM AS REQUIRED DURING CONSTRUCTION.
2. A DEWATERING BASIN SHALL BE ESTABLISHED OUTSIDE OF THE WETLAND LIMITS.
3. TEMPORARY WATERHANDLING-COFFERDAM SHALL CONSIST OF AN APPROVED SYSTEM THAT THE CONTRACTOR ELECTS TO USE WHICH WILL SAFELY CONVEY WATER FLOWS THROUGH THE CONSTRUCTION AREA. SHALL BE ABLE TO SUPPORT CONSTRUCTION ACTIVITY AND SHALL CONFORM TO PERMITS. ANY WATER HANDLING SCHEME ENERGED WITHIN THE DEPARTMENT'S HANDLING WATER TYPICAL SCHEMATIC MAY BE UTILIZED UNLESS SPECIFICALLY PROHIBITED. A MEANS AND METHOD FOR WATER HANDLING SYSTEMS SHALL BE SUBMITTED BY THE ENGINEER TO THE ENGINEER FOR APPROVAL.
4. WATER HANDLING MEASURES SHALL NOT EXCEED IMPACT AREAS SHOWN ON THE WETLAND IMPACT SHEET OF THE PERMIT PLANS.
5. ANY STORM DRAINAGE DISCHARGING INTO A CONFINED WORK AREA FROM EXISTING STORM DRAINAGE PIPES SHALL BE DIVERTED OR PUMPED OUTSIDE THE CONFINED AREA. PUMPED PIPES SHALL BE PROVIDED BY THE CONTRACTOR TO HANDLE THE EXPECTED FLOWS AND BE DISCHARGED TO A STABLE LOCATION. THE WATER HANDLING SHALL BE DESIGNED AND METHODS OF HANDLING SHALL BE PROVIDED TO THE ENGINEER FOR APPROVAL AND BE INCLUDED AS PART OF THE WATER HANDLING.
6. BASED UPON FIELD CONDITIONS, WORK DURATION AND EXPECTED WEATHER CONDITIONS, THE ENGINEER MAY APPROVE A CONSTRUCTION WATER HANDLING PLAN WITH LOWER PUMPING FLOWS, PROVIDED THAT IT INCLUDES A CONTINGENCY PLAN, WHICH MINIMIZES NEGATIVE IMPACTS AND SAFELY CONVEYS LARGER FLOWS THROUGH THE WORK AREA.

NATIVE STREAMBED MATERIAL NOTES

1. NATIVE STREAMBED MATERIALS EXCAVATED DURING THE INSTALLATION OF THE CULVERT PIPING SHALL BE STOCKPILED AND THEN REPLACED AS DIRECTED BY THE ENGINEER. ANY STOCKPILES WITHIN THE SPECIAL PROVISIONS SHALL BE PROTECTED FROM EROSION AND DAMAGE BY EROSION CONTROL MEASURES.
2. THE STOCKPILE SHALL BE LOCATED OUTSIDE THE WETLAND LIMITS AND PROTECTED WITH SEDIMENTATION CONTROL SYSTEM.
3. ADDITIONAL STREAMBED MATERIAL, IF REQUIRED, SHALL BE IN ACCORDANCE WITH SPECIAL PROVISIONS SUPPLEMENTAL STREAMBED CHANNEL MATERIAL.

SUGGESTED SEQUENCE OF CONSTRUCTION

1. EXISTING 3" CABLE GUARD RAIL SYSTEM SHALL REMAIN IN PLACE DURING WORK.
2. INSTALL ANTI-BACKING PAD, ACCESS ROAD AND SEDIMENTATION CONTROL SYSTEM.
3. INSTALL BYPASS PIPE AND WATERHANDLING-COFFERDAM.
4. CLEAN AND PERFORM REPAIRS TO EXISTING CULVERT.
5. INSTALL CAST-IN-PLACE CONCRETE INVERT AT THE SPECIFIED INCREASMENTS.
6. REMOVE BYPASS PIPE WATERHANDLING-COFFERDAM.
7. ESTABLISH VEGETATION AS REQUIRED.
8. REMOVE SEDIMENTATION CONTROL SYSTEM UPON FINAL STABILIZATION.

UNCONFINED IN-STREAM WORK BMP NOTES:




1. UNCONFINED IN-STREAM WORK SHALL BE LIMITED TO THE PERIOD FROM JUNE 01 TO SEPTEMBER 30, INCLUSIVE.
2. PUMPING ALLOWED ONLY BETWEEN JUNE 01 TO SEPTEMBER 30 FOR NO LONGER THAN 30-MINUTE DURATION.

TEMPORARY HYDRAULIC DATA	
AVERAGE DAILY FLOW	0.41 CFS
AVERAGE SPRING FLOW	0.77 CFS
2-YEAR FREQUENCY DISCHARGE	42 CFS
TEMPORARY DESIGN DISCHARGE - LOW FLOW PUMPING	6.2 CFS*
TEMPORARY DESIGN FREQUENCY	8x ASF
TEMPORARY WATER SURFACE ELEVATION UPSTREAM	261.7 FT.
TEMPORARY WATER SURFACE ELEVATION DOWNSTREAM	259.9 FT.

*6.2 CFS BASED ON 8x ASF SPRING FLOW & 30-MINUTE PUMPING DURATION

NOTE:

VALUES AND ELEVATIONS MAY VARY SLIGHTLY FROM THE CONTRACT PLANS.

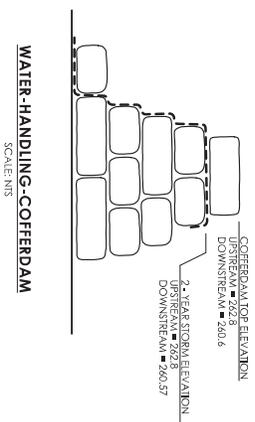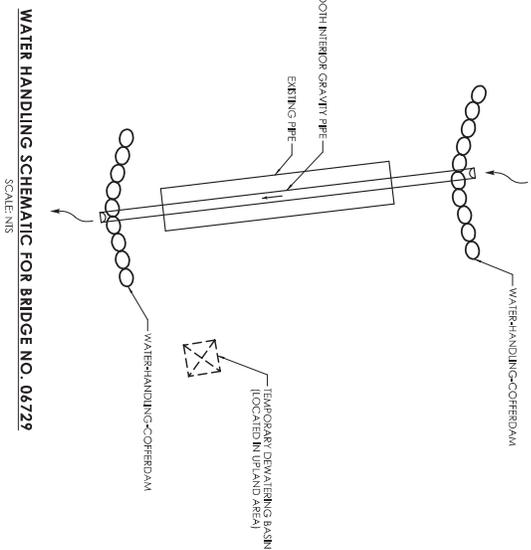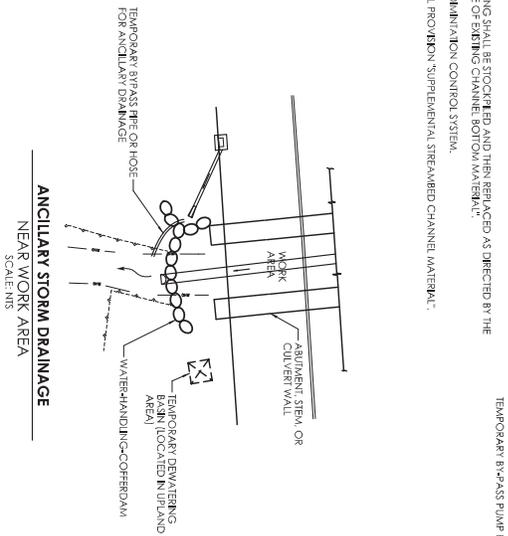

**ENVIRONMENTAL PERMIT PLANS
PLAN DATE: NOVEMBER 07, 2024**

REV	DATE	REVISION DESCRIPTION

DESIGNER/DATE: BSB	CHECKED BY: JGC
DATE: 11/7/2024	DATE: 11/7/2024

PROJECT NUMBER: 01824202	PROJECT LOCATION: BEAUBIEN BRIDGE NO. 06729 - U.S. ROUTE 6 OVER UNNAMED BROOK
TOWN: WINDHAM	DRAWING TITLE: WATER HANDLING PLAN

WESTON & SAMPSON


14 MARKET STREET
WINDHAM, VERMONT 05791

STATE OF VERMONT
DEPARTMENT OF TRANSPORTATION



PROJECT NUMBER: 01824202	PROJECT LOCATION: BEAUBIEN BRIDGE NO. 06729 - U.S. ROUTE 6 OVER UNNAMED BROOK
TOWN: WINDHAM	DRAWING TITLE: WATER HANDLING PLAN

DATE: 11/7/2024	PROJECT NUMBER: 01824202
PROJECT LOCATION: BEAUBIEN BRIDGE NO. 06729 - U.S. ROUTE 6 OVER UNNAMED BROOK	TOWN: WINDHAM
DRAWING TITLE: WATER HANDLING PLAN	DATE: 11/7/2024

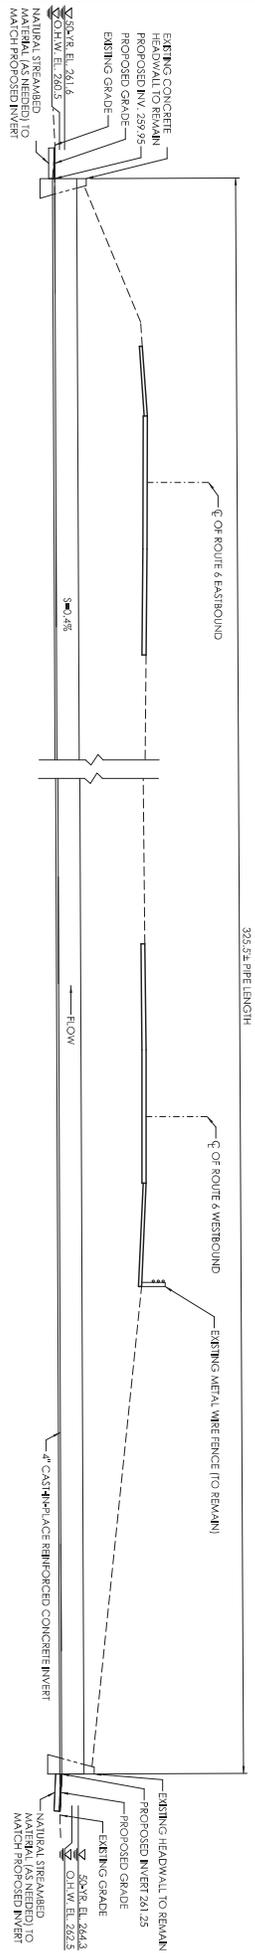

CULVERT SECTION - REINFORCED CONCRETE INVERT

SCALE: 1" = 10'

REV	DATE	REVISION DESCRIPTION

DESIGNED BY: [Redacted]	CHECKED BY: [Redacted]	PROJECT NO.:	PROJECT NAME:
DATE: 11/2/24	SCALE: 1" = 10'	PROJECT NUMBER: Q124-2204	PROJECT LOCATION: REHABILITATION OF BRIDGE NO. 06729 - U.S. ROUTE 6 OVER UNKNOWN BROOK
7188 Main Street, Suite 203 Middletown, CT 06457 www.westonsampson.com		PROJECT NUMBER: Q124-2204 PROJECT LOCATION: REHABILITATION OF BRIDGE NO. 06729 - U.S. ROUTE 6 OVER UNKNOWN BROOK DRAWING TITLE: SECTION PLAN	DRAWING NO.: PM-106 SHEET NO.: 6 OF 6

ENVIRONMENTAL PERMIT PLANS
PLAN DATE: NOVEMBER 07, 2024



LWRD Work Commencement Form

To: DEEP.LWRDRegulatory@ct.gov or
Regulatory Section
Department of Energy and Environmental Protection
Land & Water Resources Division
79 Elm Street
Hartford, CT 06106-5127

Licensee Name: CT Department of Transportation

Municipality in which the project is occurring: Mansfield & Windham

DEEP License No(s): 202411418-IW

CONTRACTOR(s):

1 Name: _____
Address: _____
Telephone: _____
E-mail: _____

2 Name: _____
Address: _____
Telephone: _____
E-mail: _____

3 Name: _____
Address: _____

Date Contractor(s) received a copy
of the license and approved plans: _____

EXPECTED DATE OF COMMENCEMENT OF WORK: _____

EXPECTED DATE OF COMPLETION OF WORK: _____

LICENSEE: _____
(Signature) (Date)

