


GENERAL NOTES:

- 1. THESE PLANS ARE INTENDED ONLY FOR ENVIRONMENTAL PERMITTING PURPOSES. THESE PLANS HOLD AUTHORITY FOR ALL ACTIVITIES CONCERNING THE REGULATED AREA. FOR DETAILED PLANIMETRIC INFORMATION AND PAYMENT REFER TO THE APPLICABLE CONTRACT DOCUMENTS.
- 2. THE DEPARTMENT OF TRANSPORTATION WILL ONLY SUBMIT REVISIONS TO DEEP AND USACE FOR CHANGES TO THE DESIGN THAT WILL AFFECT REGULATED AREAS.
- 3. FOR A DESCRIPTION OF THE WATERCOURSES, WETLANDS AND WETLAND SOILS SEE RELEVANT SECTIONS OF THE PERMIT APPLICATION.
- 4. 400 FOOT GRID BASED ON CONNECTICUT COORDINATE SYSTEM N.A.D. 1983. VERTICAL DATUM BASED ON NGVD 1929.
- 5. ALL CONSTRUCTION ACTIVITIES WILL BE CONDUCTED IN ACCORDANCE WITH THE DEPARTMENT'S STANDARD SPECIFICATIONS FOR ROADS, BRIDGES, AND INCIDENTAL CONSTRUCTION, FORM 818, DATED 2020; SUPPLEMENTAL SPECIFICATIONS, DATED JULY 2020; SECTION 1.10 AND WILL ALSO FOLLOW REQUIRED BEST MANAGEMENT PRACTICES (BMPs) AND SEDIMENT AND EROSION CONTROL MEASURES IN ACCORDANCE WITH THE 2002 EROSION AND SEDIMENTATION CONTROL GUIDELINES AND THE 2004 STORMWATER QUALITY CONTROL MANUAL.


ENVIRONMENTAL PERMIT PLANS STATE PROJECT NO. 056-305 BRIDGE REPLACEMENT BRIDGE NO. 01872, U.S. ROUTE 1 OVER GREENWICH CREEK TOWN OF GREENWICH

PROJECT LOCATION BRIDGE NO. 01872

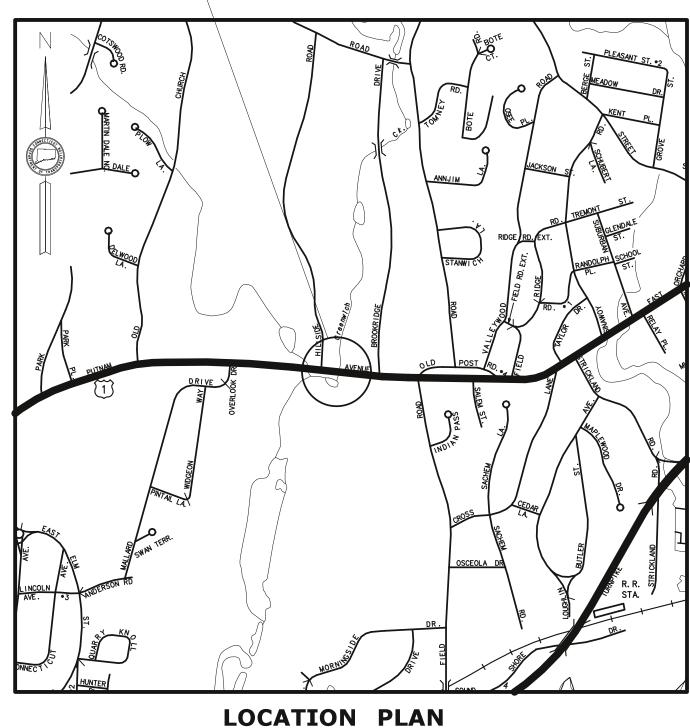

SCALE 1 INCH = 1,000 FEET

LIST OF DRAWINGS				
DRAWING NO.	DRAWING TITLE			
PMT-01	TITLE SHEET			
PMT-02	GENERAL SITE PLAN			
PMT-03	WATERCOURSE/WETLAND IMPACT PLAN			
PMT-04	100-YEAR FLOOD IMPACT PLAN			
PMT-05	BRIDGE SECTION AND ELEVATIONS			
PMT-06	STAGE 1A AND 1D BRIDGE CONSTRUCTION			
PMT-07	STAGE 1B AND 1C BRIDGE CONSTRUCTION			
PMT-08	STAGE 2 BRIDGE CONSTRUCTION			
PMT-09	RETAINING WALL CONSTRUCTION			
PMT-10	ROCK WEIR DETAILS			
PMT-11	TEMPORARY UTILITY BRIDGE			
PMT-12	TOE BOULDER AND DIKE REMOVAL DETAILS			
PMT-13	PERMIT PLANTING PLAN			

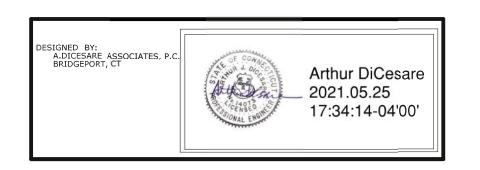

PLAN DATE: MAY 25, 2021

	·				DES:
				THE INFORMATION, INCLUDING ESTIMATED	
				QUANTITIES OF WORK, SHOWN ON THES	CHE
				INVESTIGATIONS BY THE STATE AND IS	
				IN NO WAY WARRANTED TO INDICATE THE CONDITIONS OF ACTUAL QUANTITIES	
				OF WORK WHICH WILL BE REQUIRED.	
REV.	DATE	REVISION DESCRIPTION	SHEET NO.	Plotted Date: 5/24/2021	

ER/DRAFTER:

JVS/DSM


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ADC

SCALE AS NOTED


STATE OF CONNECTICUT
DEPARTMENT OF TRANSPORTATION


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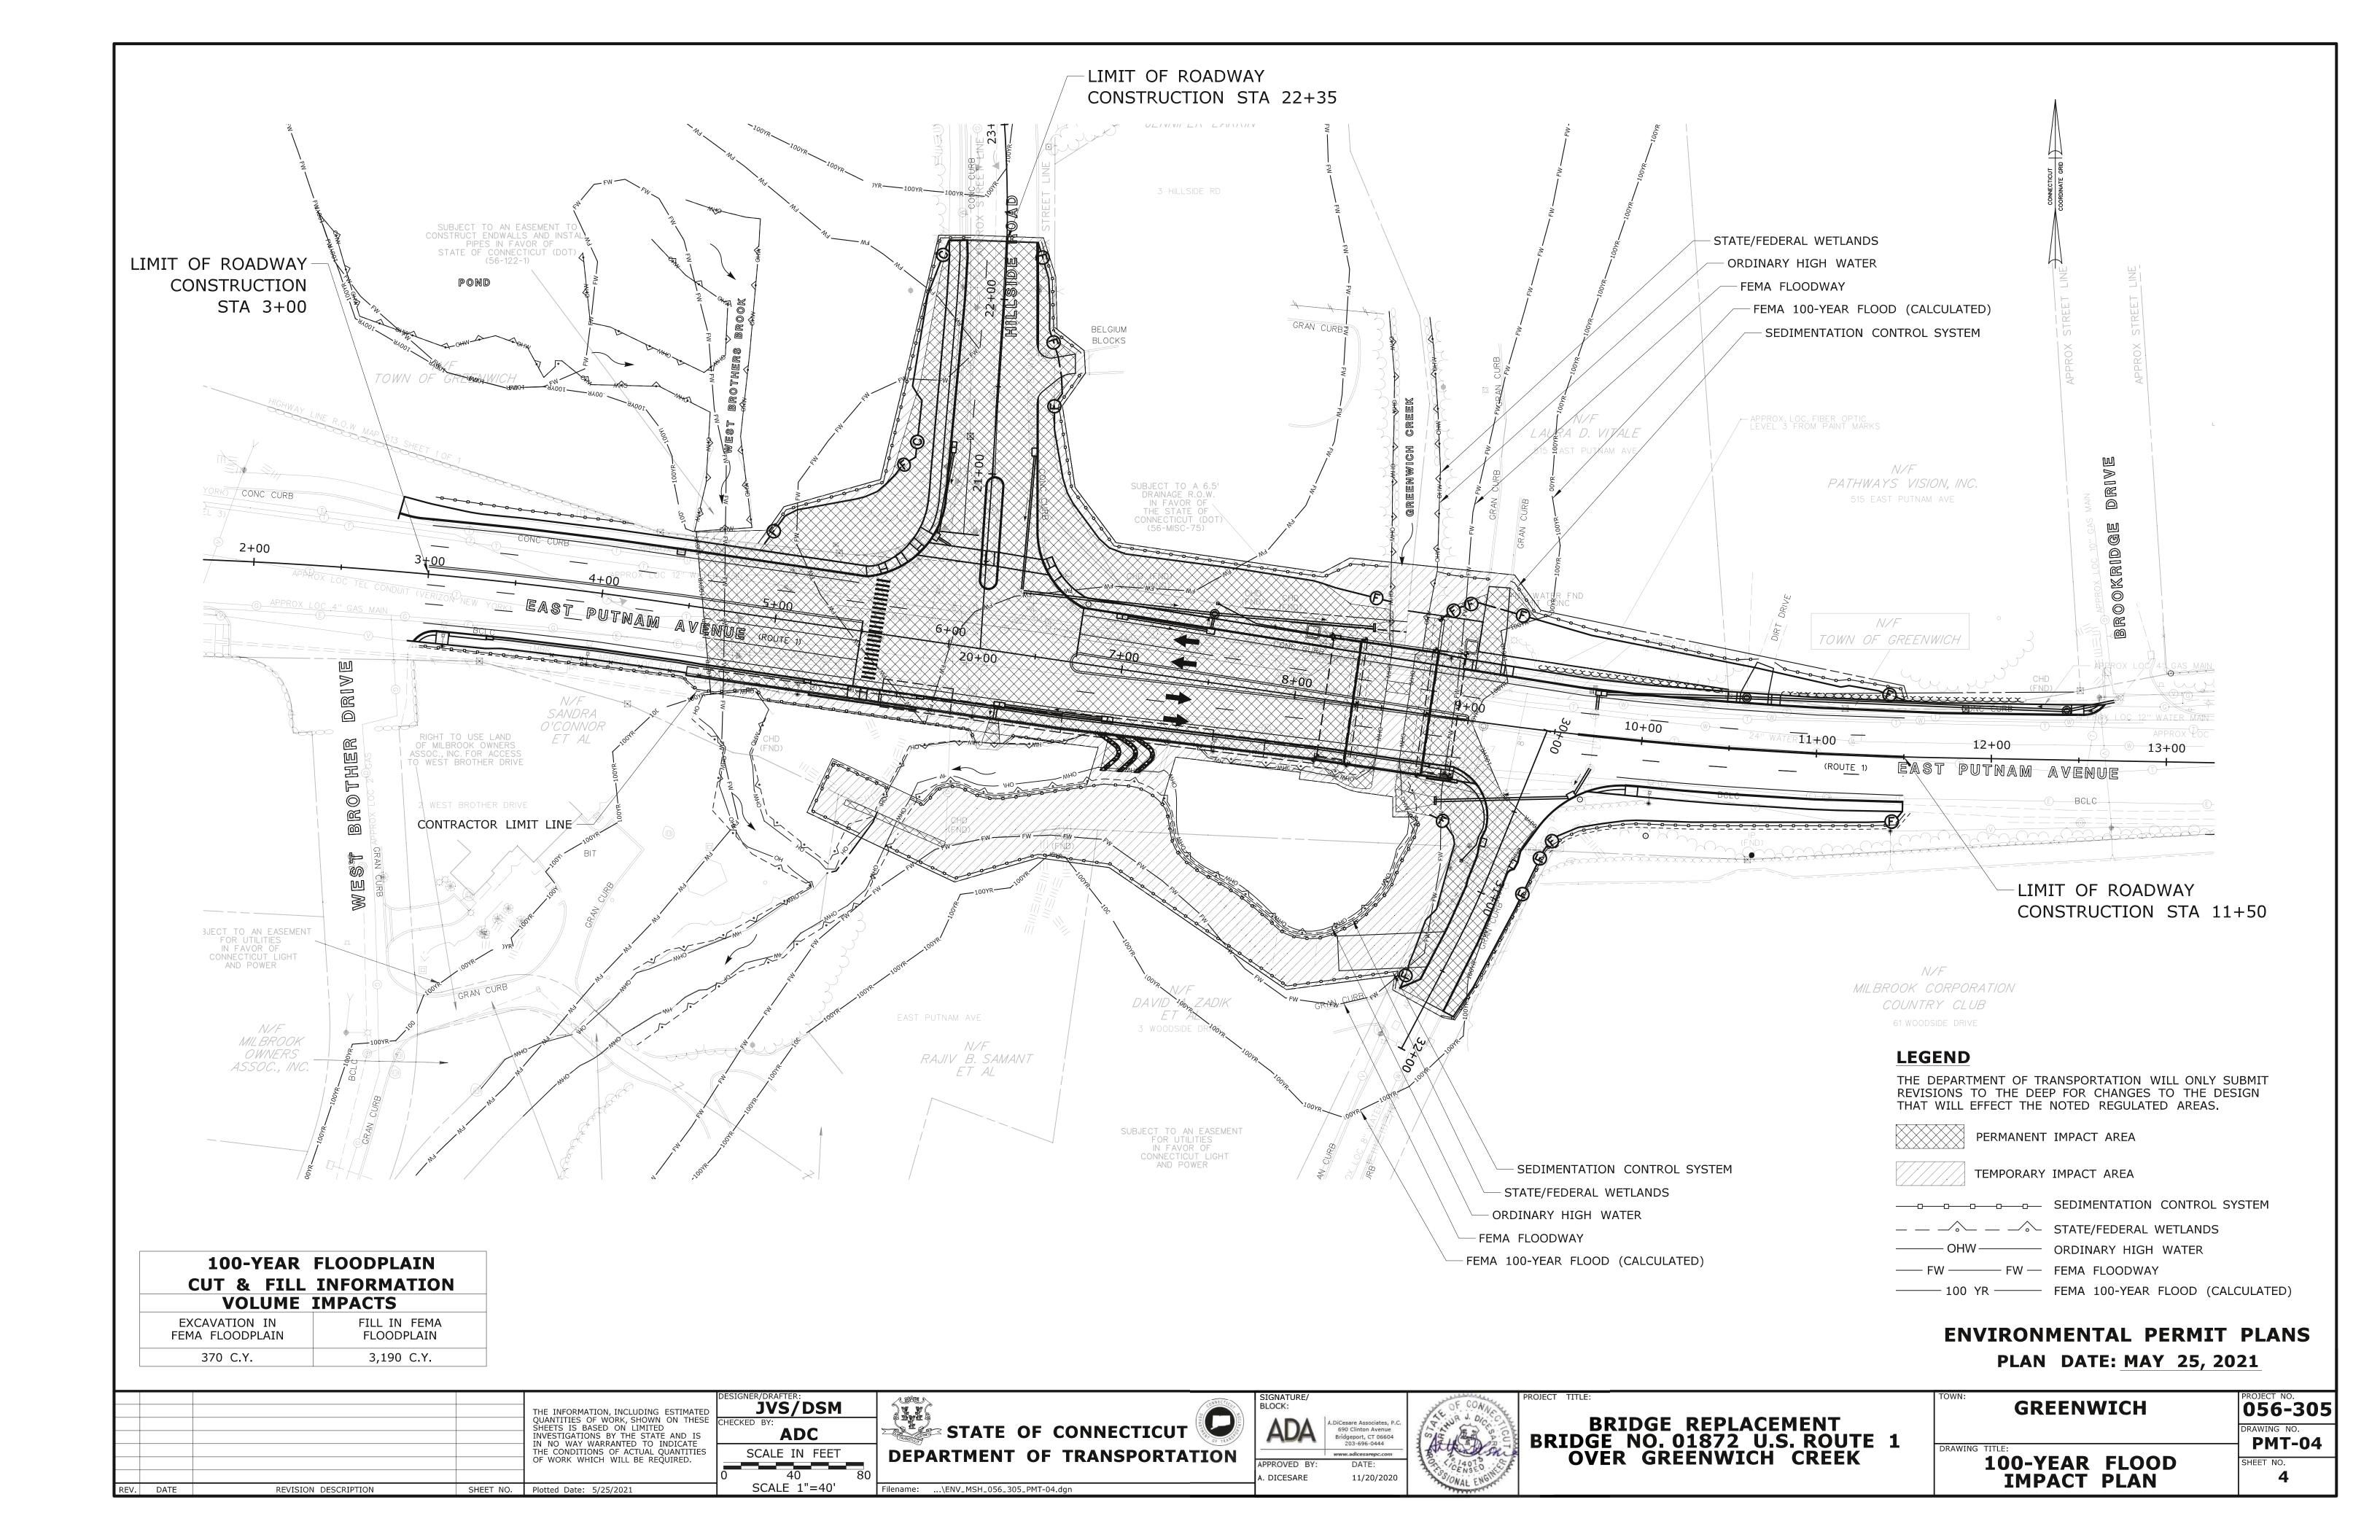


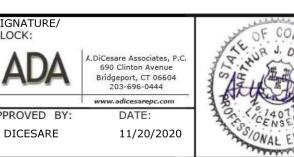



WN:	GREENWICH	PROJECT NO. 056-305
		DRAWING NO. PMT-01
RAWING		PM1-01
	TITLE SHEET	SHEET NO.




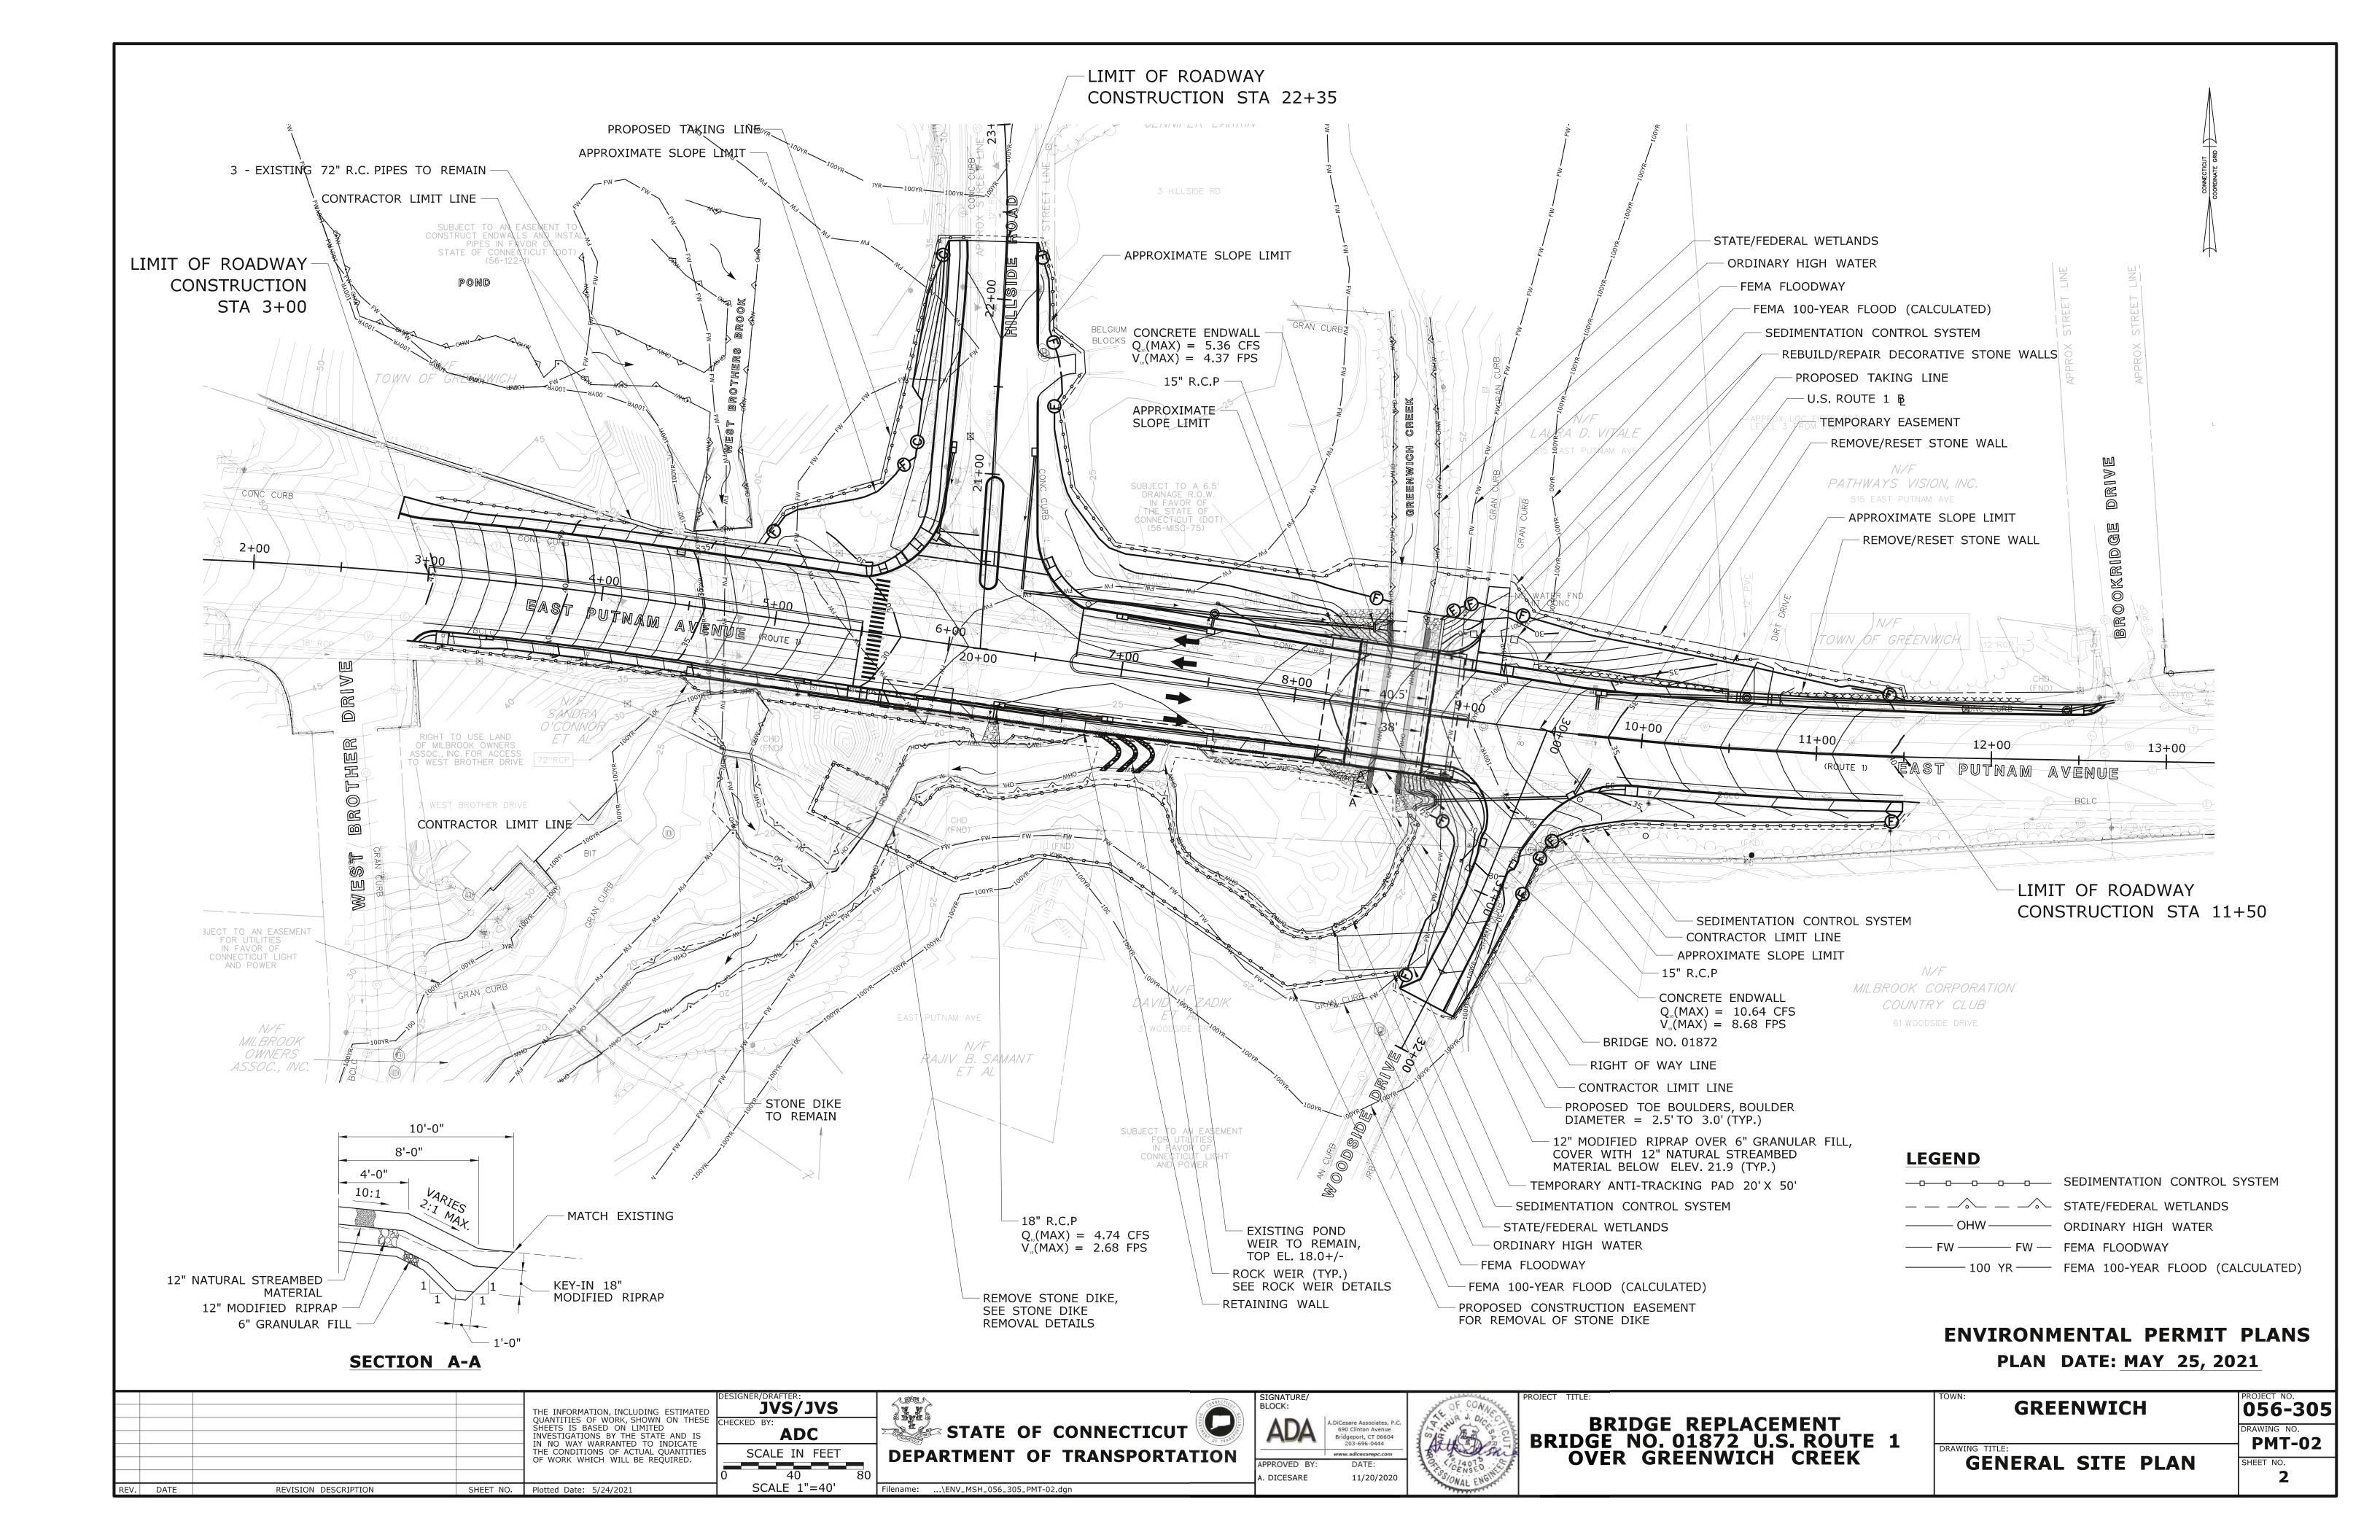

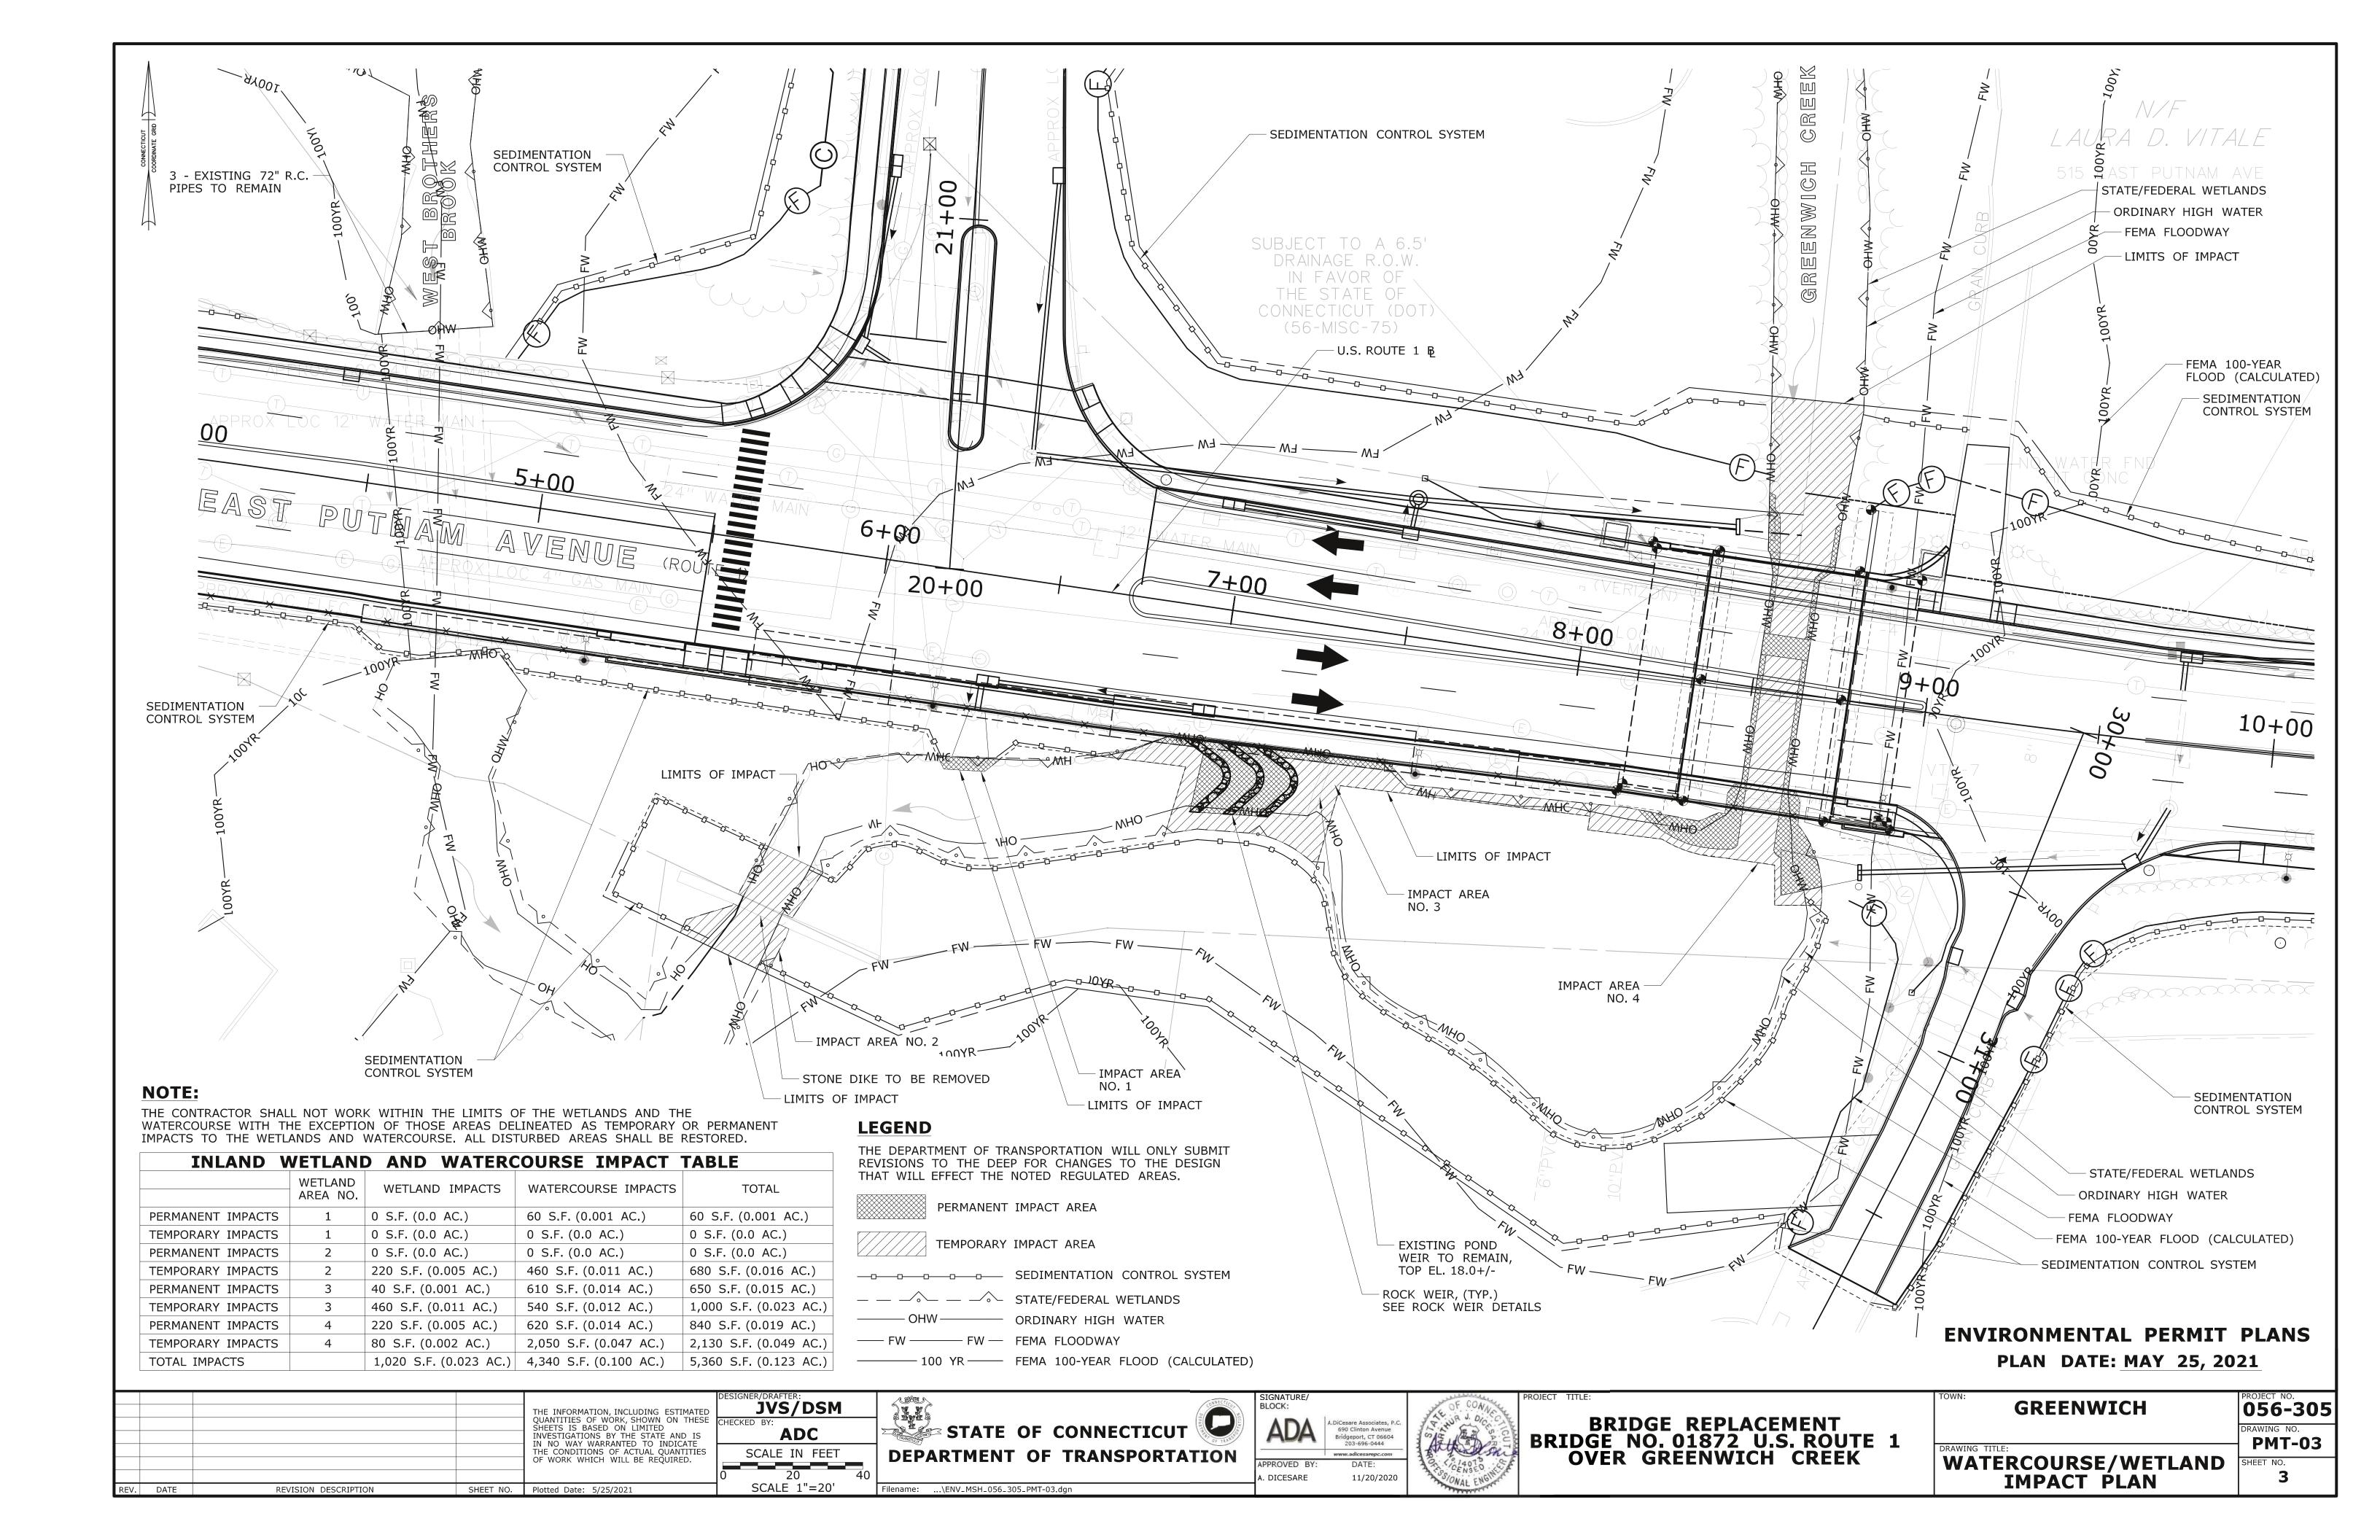

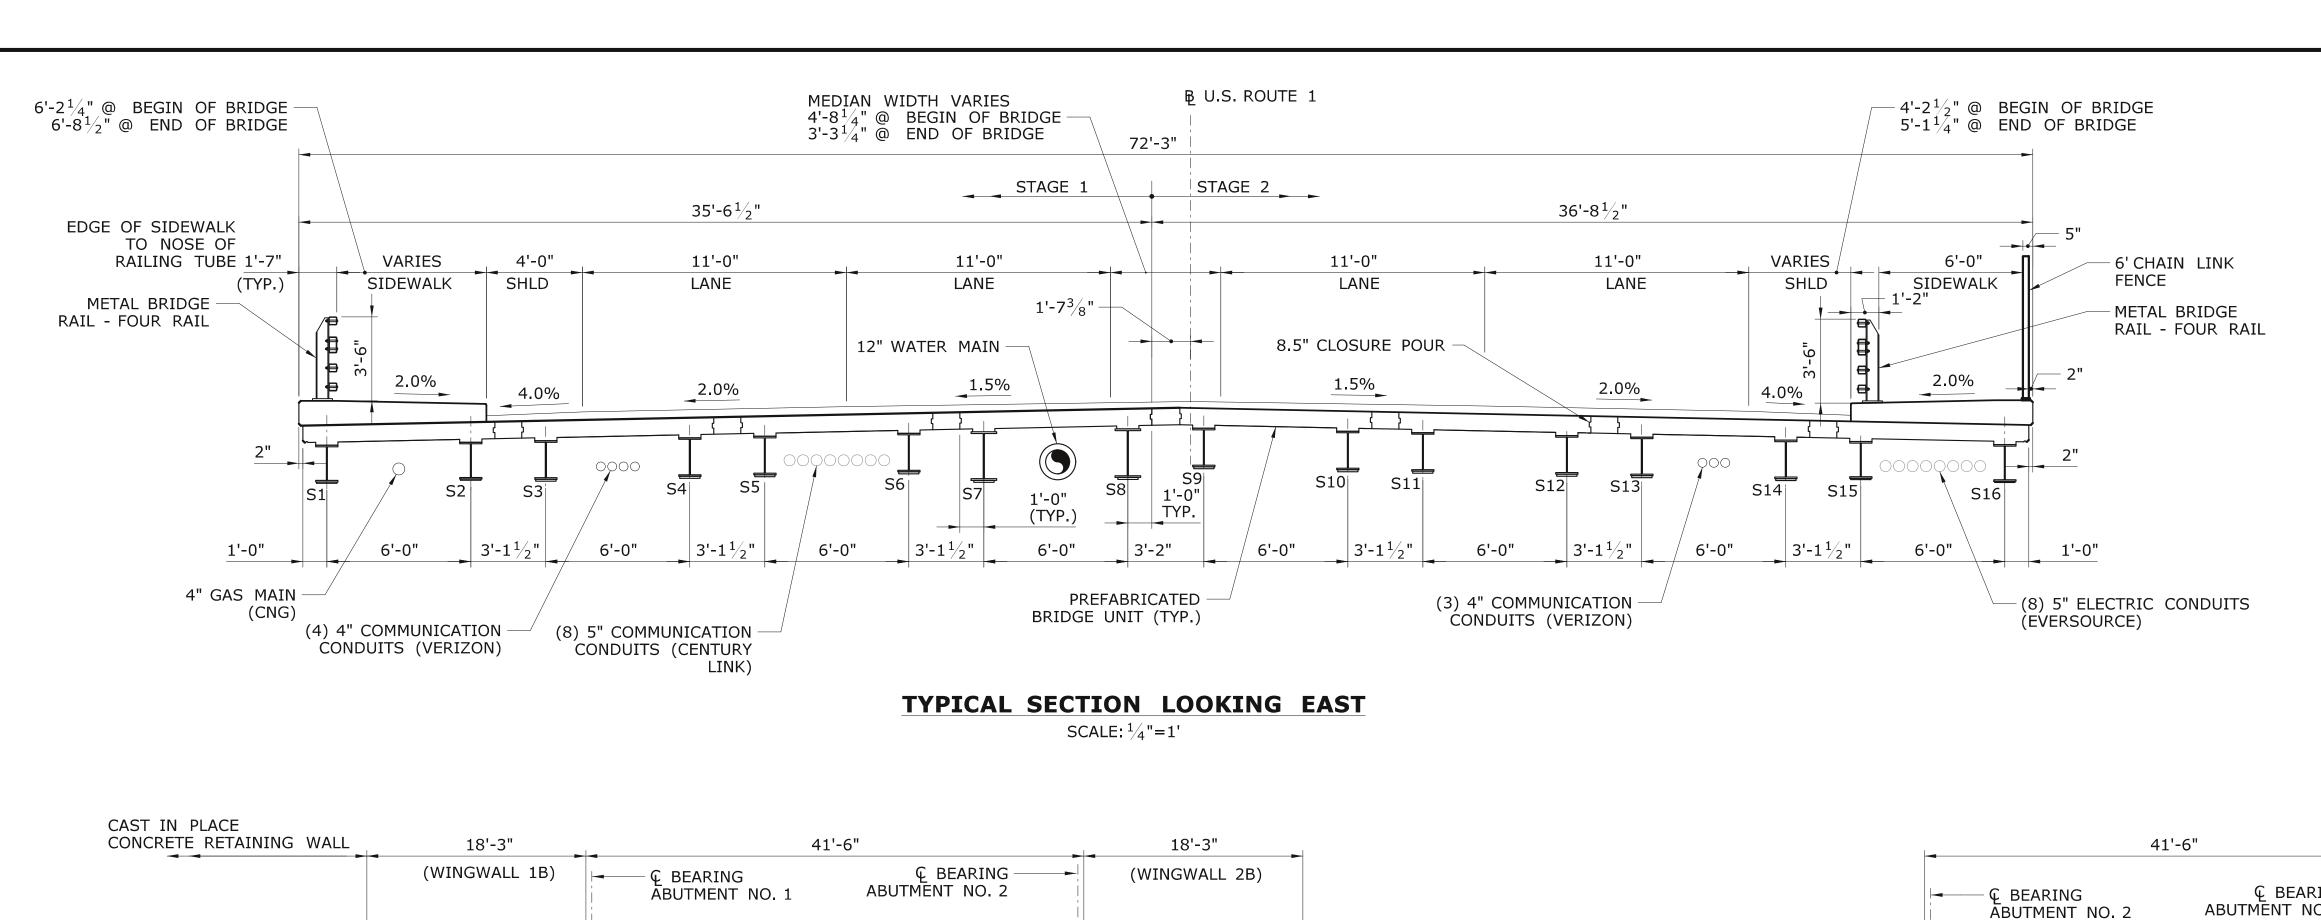

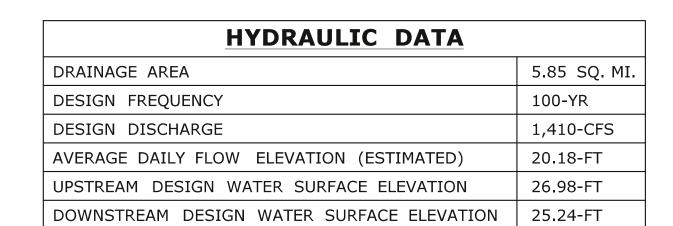

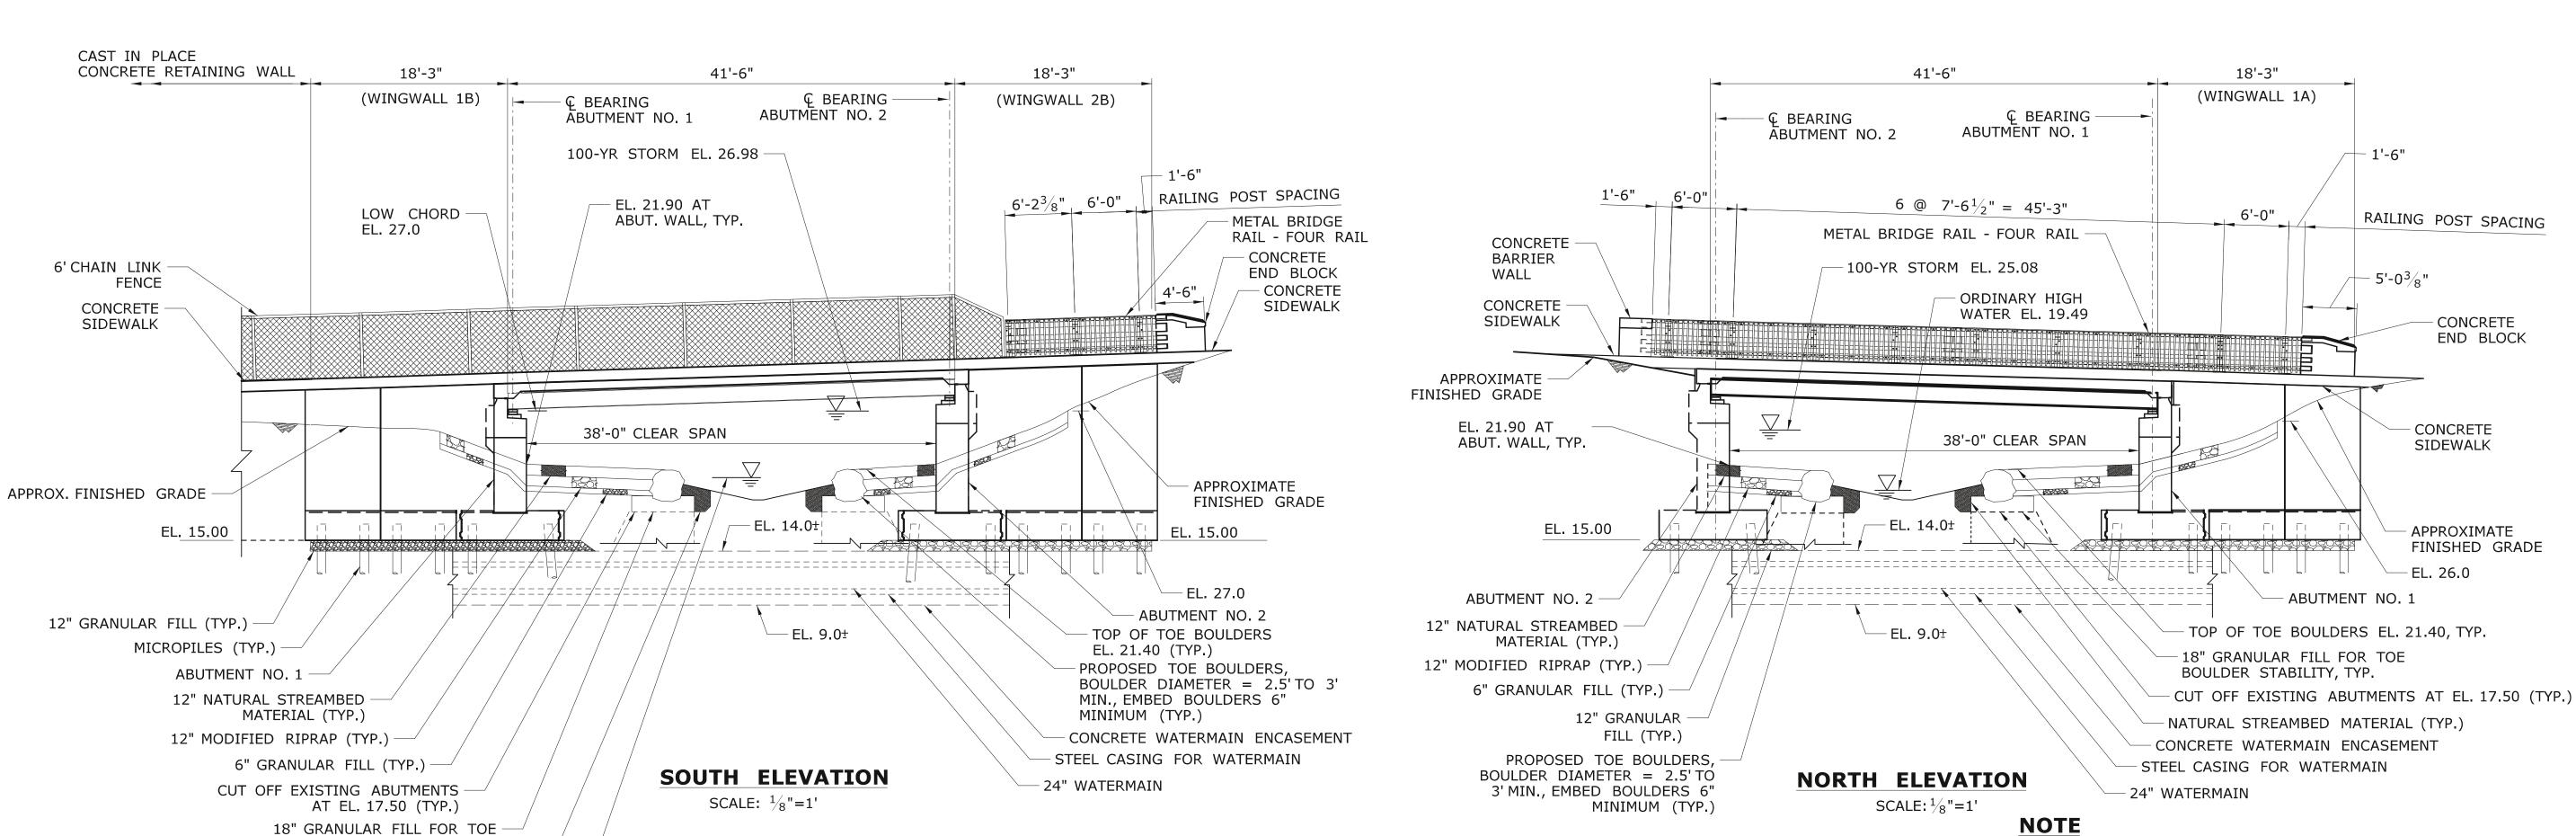

ENVIRONMENTAL PERMIT PLANS PLAN DATE: MAY 25, 2021

056-305

PMT-05

GREENWICH

BRIDGE SECTION

AND ELEVATIONS

1. PROVIDE TOE BOULDERS THROUGHOUT EXTENT OF CHANNEL UNDER BRIDGE.

REFER TO GENERAL SITE PLAN FOR EXTENTS OUTBOARD OF BRIDGE FASCIA.


STATE OF CONNECTICUT SIGNATURE, BLOCK: JVS/DSM THE INFORMATION, INCLUDING ESTIMATED QUANTITIES OF WORK, SHOWN ON THESE SHEETS IS BASED ON LIMITED INVESTIGATIONS BY THE STATE AND IS IN NO WAY WARRANTED TO INDICATE THE CONDITIONS OF ACTUAL QUANTITIES BRIDGE REPLACEMENT BRIDGE NO. 01872 U.S. ROUTE 1 A.DiCesare Associates, P.C 690 Clinton Avenue Bridgeport, CT 06604 203-696-0444 ADC THE CONDITIONS OF ACTUAL QUANTITIES OF WORK WHICH WILL BE REQUIRED. **DEPARTMENT OF TRANSPORTATION OVER GREENWICH CREEK** SCALE AS NOTED DICESARE 11/20/2020 SHEET NO. Plotted Date: 5/24/2021 REVISION DESCRIPTION Filename: ...\ENV_MSH_056_305_PMT-05.dgn REV. DATE


BOULDER STABILITY (TYP.)

NATURAL STREAMBED -

MATERIAL (TYP.)

ORDINARY HIGH WATER EL. 20.81

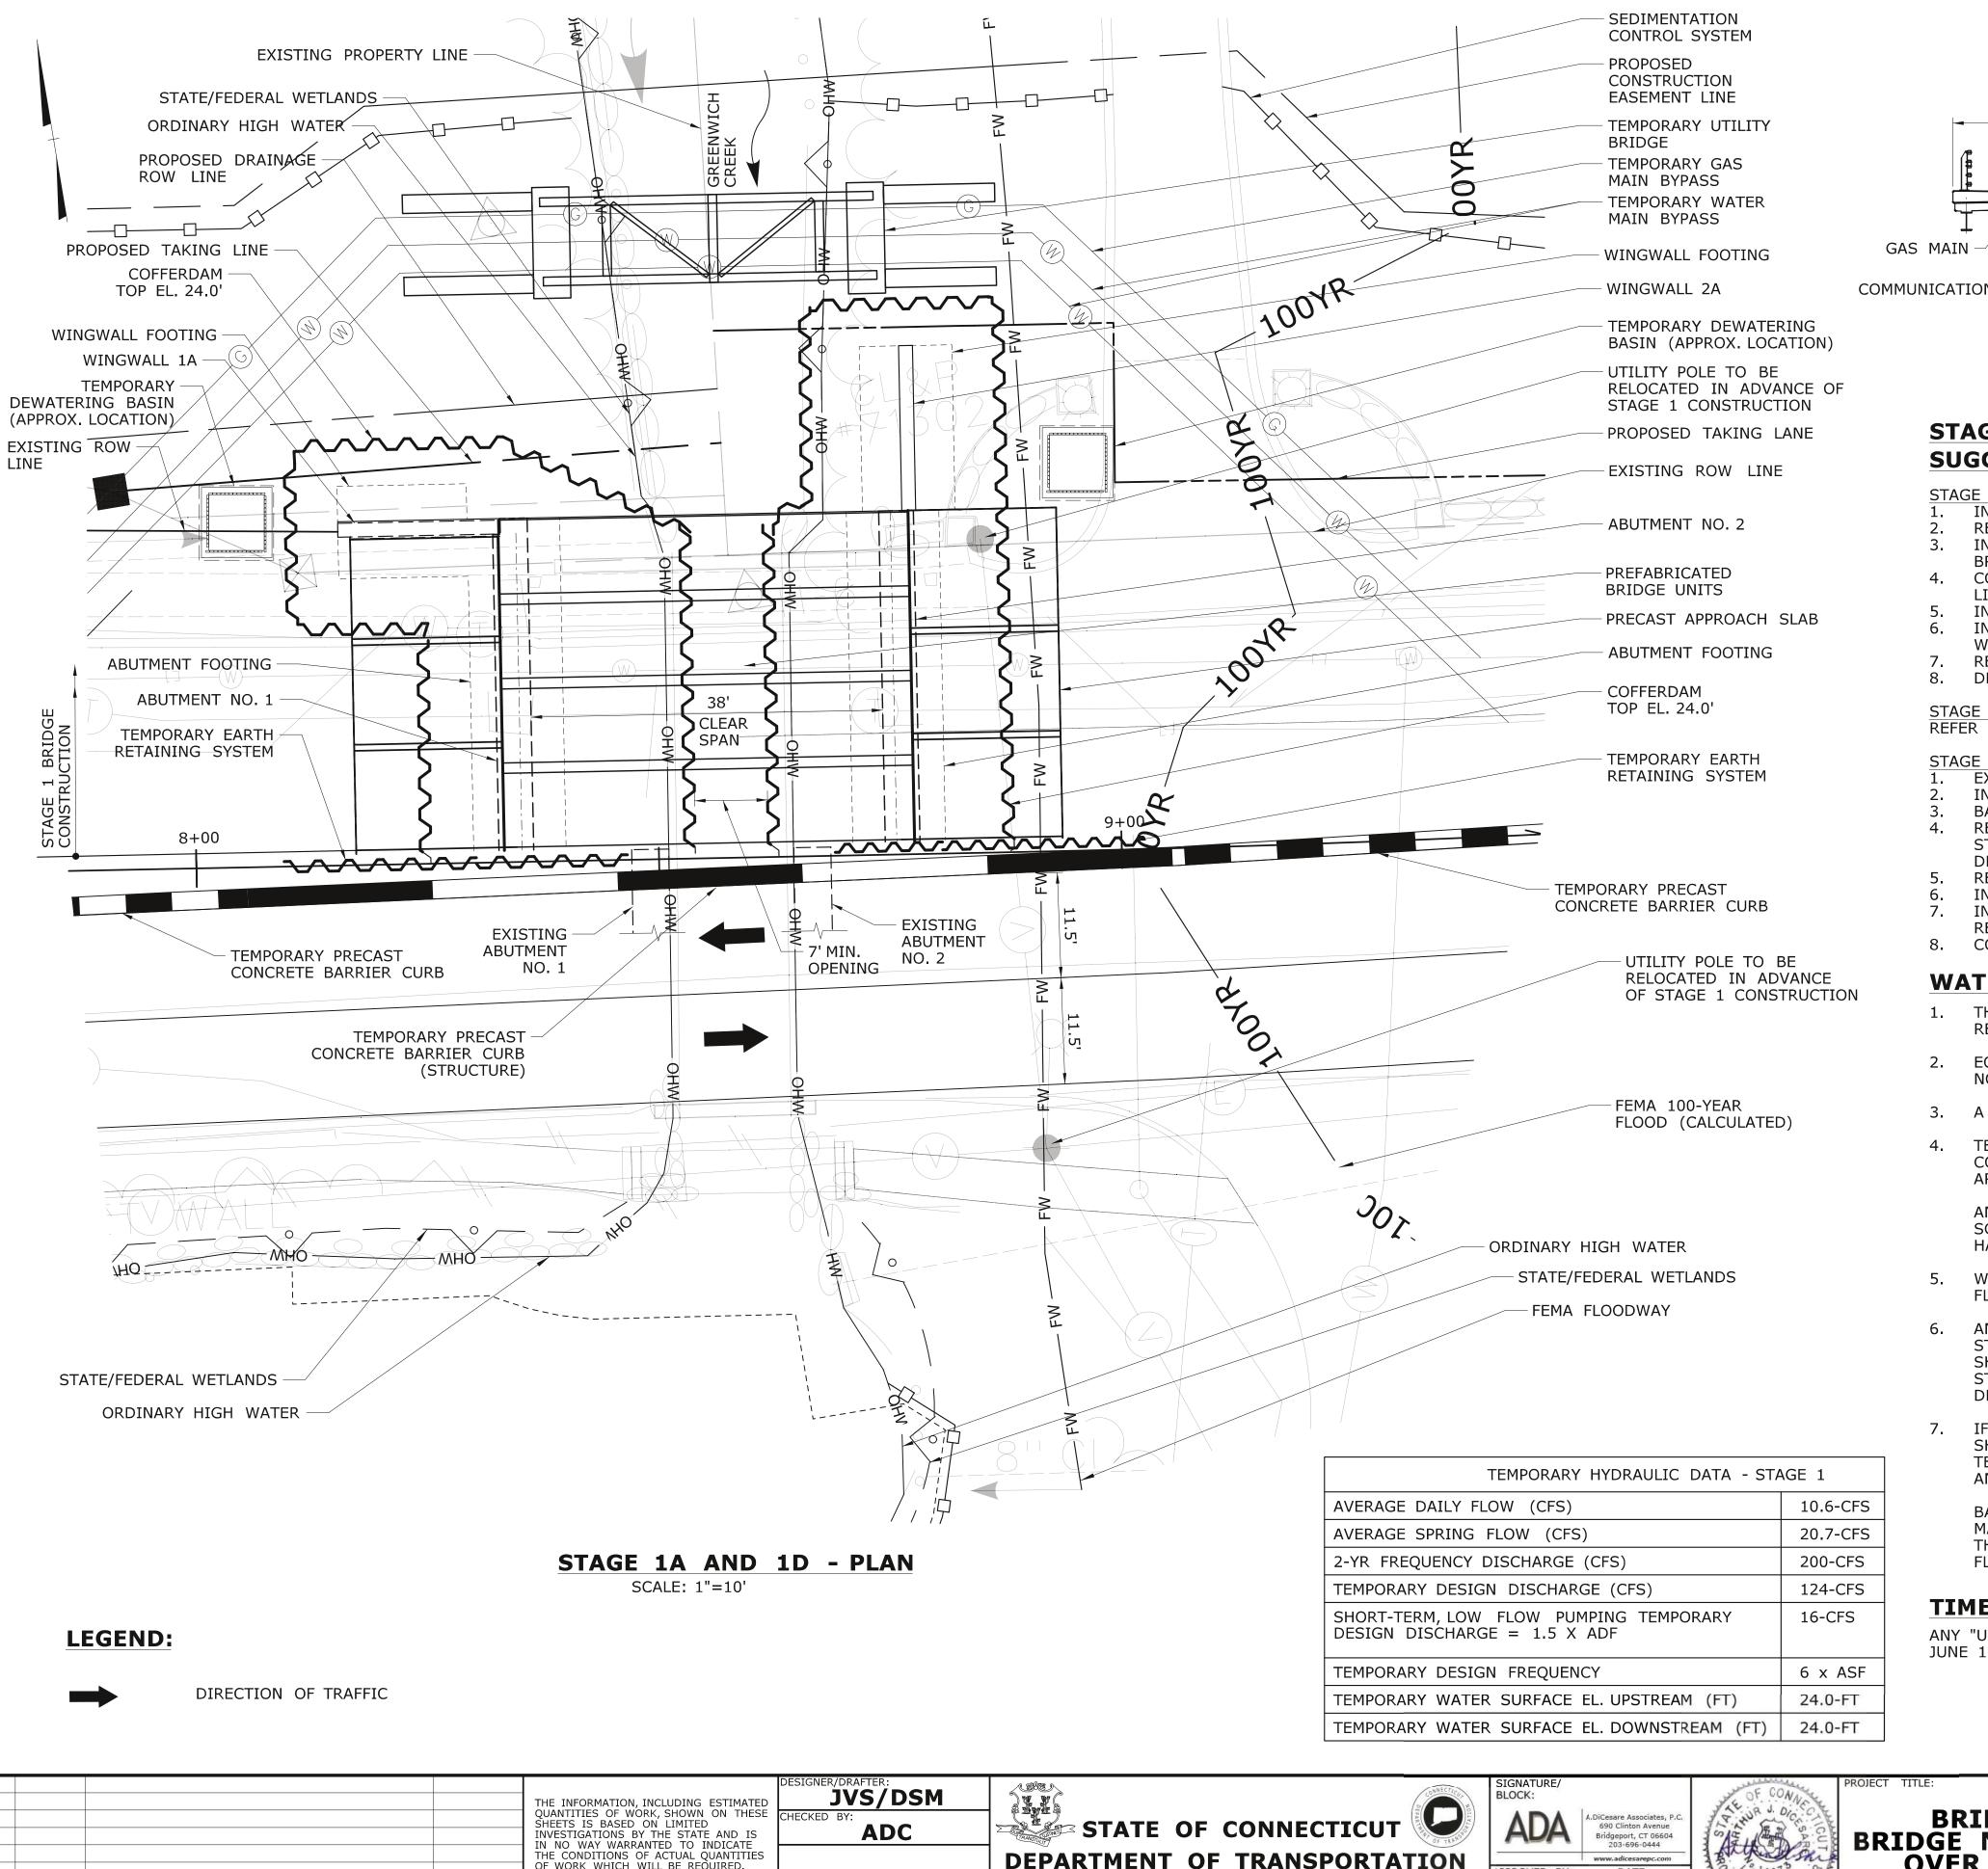

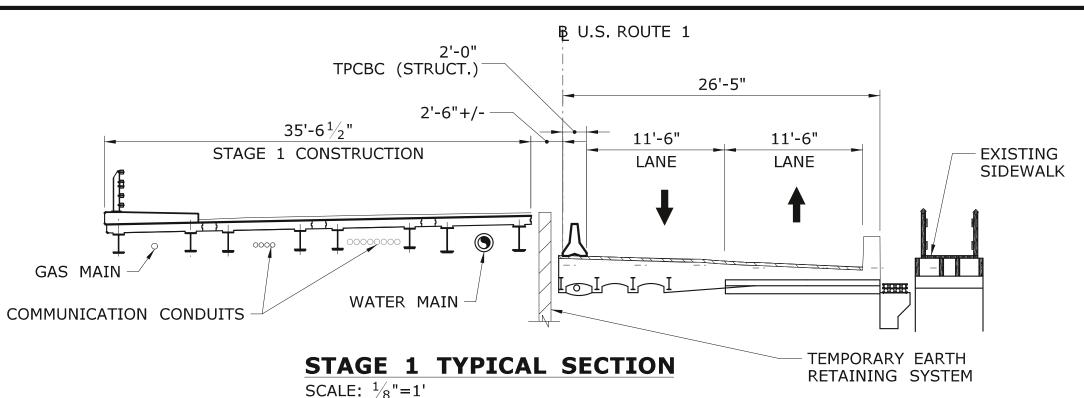

STAGE 1 - BRIDGE

SUGGESTED CONSTRUCTION SEQUENCE

STAGE 1A CONSTRUCTION

- INSTALL TEMPORARY UTILITY BRIDGE NORTH OF EXISTING BRIDGE
- RELOCATE EXISTING WATER MAINS AND GAS MAIN ONTO TEMPORARY UTILITY BRIDGE. INSTALL DEBRIS SHIELD (BOTTOM EL. 25.0, MIN.), REMOVE EXISTING SUPERSTRUCTURE AT NORTH SIDE OF
- BRIDGE AND LEAVE ABUTMENT STEMS IN PLACE.
- CONSTRUCT TEMPORARY UTILITY SUPPORT ACROSS WATERWAY AND SUPPORT EXISTING COMMUNICATION
- LINES (CENTURY LINK AND VERIZON) IN PLACE. INSTALL TEMPORARY EARTH RETAINING SYSTEM AT STAGE CONSTRUCTION LINE.
- INSTALL COFFERDAM WITHIN CHANNEL AND AROUND PROPOSED PRECAST SUBSTRUCTURE ELEMENTS
- WITHIN STAGE 1 CONSTRUCTION LIMITS AS SHOWN
- REMOVE AND STOCKPILE NATURAL STREAM BED MATERIAL DEWATER WORK AREA AND REMOVE EXISTING ABUTMENTS WITHIN COFFERDAM TO EL. 17.50.

STAGE 1B AND 1C REFER TO PMT-07

- EXCAVATE WITHIN COFFERDAM AND INSTALL PILES.
- INSTALL PRECAST CONCRETE ABUTMENTS, BRIDGE SEATS AND WINGWALLS.
- BACKFILL ABUTMENTS AND WINGWALLS.
- REGRADE AROUND ABUTMENTS, WINGWALLS AND PLACE CHANNEL TOE BOULDERS, RIPRAP AND NATURAL STREAM BED MATERIAL. THE INSTALLATION OF TOE BOULDERS SHALL BE DIRECTED IN THE FIELD BY CT DEEP FISHERIES OR DOT OEP STAFF.
- REMOVE COFFERDAM.
- INSTALL PREFABRICATED BRIDGE UNITS.
- INSTALL WATER MAIN, GAS MAIN AND COMMUNICATION LINES WITHIN BRIDGE AND AT APPROACHES AND REMOVE TEMPORARY UTILITY BRIDGE.
- COMPLETE ROADWAY CONSTRUCTION.

WATER HANDLING NOTES:

- 1. THE CONTRACTOR SHALL MAINTAIN WATER THROUGH THE TEMPORARY WATER HANDLING SYSTEM AS REQUIRED DURING CONSTRUCTION OF THE NEW STRUCTURE.
- EQUIPMENT SHALL NOT BE PERMITTED IN THE STREAM WHEN TEMPORARY WATER HANDLING SYSTEM IS NOT IN PLACE WITHOUT APPROVAL FROM THE ENGINEER.
- 3. A DEWATERING BASIN SHALL BE ESTABLISHED OUTSIDE OF THE WETLAND LIMITS.
- 4. TEMPORARY WATER-HANDLING COFFERDAM SHALL CONSIST OF AN APPROVED SYSTEM THAT THE CONTRACTOR ELECTS TO USE WHICH WILL SAFELY CONVEY WATER FLOWS AROUND THE CONSTRUCTION AREA, SHALL BE ABLE TO SUPPORT CONSTRUCTION ACTIVITIES AND SHALL CONFORM TO PERMITS.

ANY WATER HANDLING SCHEME DEPICTED WITHIN THE DEPARTMENT'S 'HANDLING WATER TYPICAL SCHEMATICS' MAY BE UTILIZED UNLESS SPECIFICALLY PROHIBITED. A MEANS AND METHOD FOR WATER HANDLING SYSTEM SHALL BE SUBMITTED BY THE CONTRACTOR TO THE ENGINEER FOR APPROVAL.

- WATER HANDLING MEASURES SHALL NOT EXCEED IMPACT AREAS SHOWN ON THE WETLAND AND FLOODPLAIN IMPACT SHEETS OF THE PERMIT PLANS.
- ANY STORM DRAINAGE DISCHARGING INTO A CONFINED WORK AREA FROM EXISTING OR PROPOSED STORM DRAINAGE PIPES SHALL BE DIVERTED OR PUMPED OUTSIDE OF THE CONFINED AREAS. PUMPS/PIPES SHALL BE SIZED BY THE CONTRACTOR TO HANDLE THE EXPECTED FLOWS AND BE DISCHARGED TO A STABLE LOCATION. THE CONTRACTOR SHALL SUBMIT THE MEANS AND METHODS OF HANDLING STORM DRAINAGE TO ENGINEER FOR APPROVAL AND IS INCLUDED AS PART OF WATER HANDLING.
- IF A SHORT DURATION PUMP SYSTEM IS PROPOSED DURING LOW FLOW CONDITIONS, THE PUMP SYSTEM SHALL BE DESIGNED BY THE CONTRACTOR AND HAVE A MINIMUM CAPACITY AS SHOWN IN THE TEMPORARY HYDRAULIC TABLE. PUMP SYSTEM PLAN SHALL BE SUBMITTED TO THE ENGINEER FOR REVIEW AND APPROVAL.

BASED UPON FIELD CONDITIONS, WORK DURATION, AND EXPECTED WEATHER CONDITIONS THE ENGINEER MAY APPROVE A CONSTRUCTION WATER HANDLING PLAN WITH LOWER PUMPING FLOWS, PROVIDED THAT THIS INCLUDES A CONTINGENCY PLAN, WHICH MINIMIZES NEGATIVE IMPACTS AND SAFELY CONVEYS LARGER FLOWS THROUGH THE WORK AREA.

TIME-OF-YEAR NOTE:


ANY "UNCONFINED" INSTREAM WORK WITHIN THE WATERCOURSE SHALL BE RESTRICTED TO THE PERIOD FROM JUNE 1 TO SEPTEMBER 30, INCLUSIVE.


> **ENVIRONMENTAL PERMIT PLANS PLAN DATE: MAY 25, 2021**


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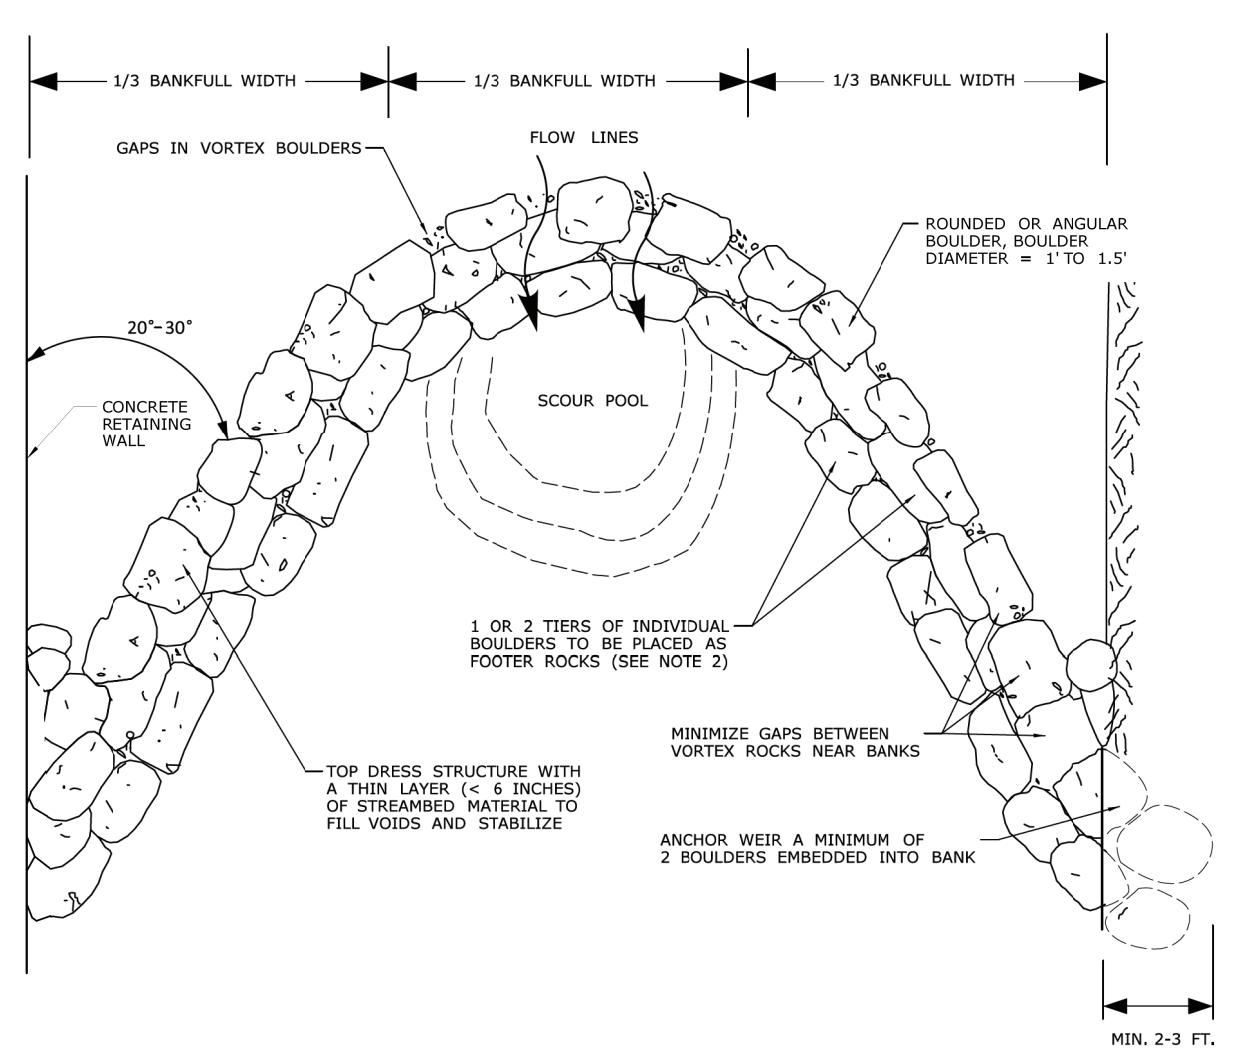
PMT-06

GREENWICH BRIDGE REPLACEMENT BRIDGE NO. 01872 U.S. ROUTE 1 THE CONDITIONS OF ACTUAL QUANTITIES OF WORK WHICH WILL BE REQUIRED. **DEPARTMENT OF TRANSPORTATION OVER GREENWICH CREEK** STAGE 1A AND 1D SCALE AS NOTED DICESARE 11/20/2020 **BRIDGE CONSTRUCTION** REVISION DESCRIPTION Filename: ...\ENV_MSH_056_305_PMT-06.dan SHEET NO. Plotted Date: 5/24/2021 EFV. DATE



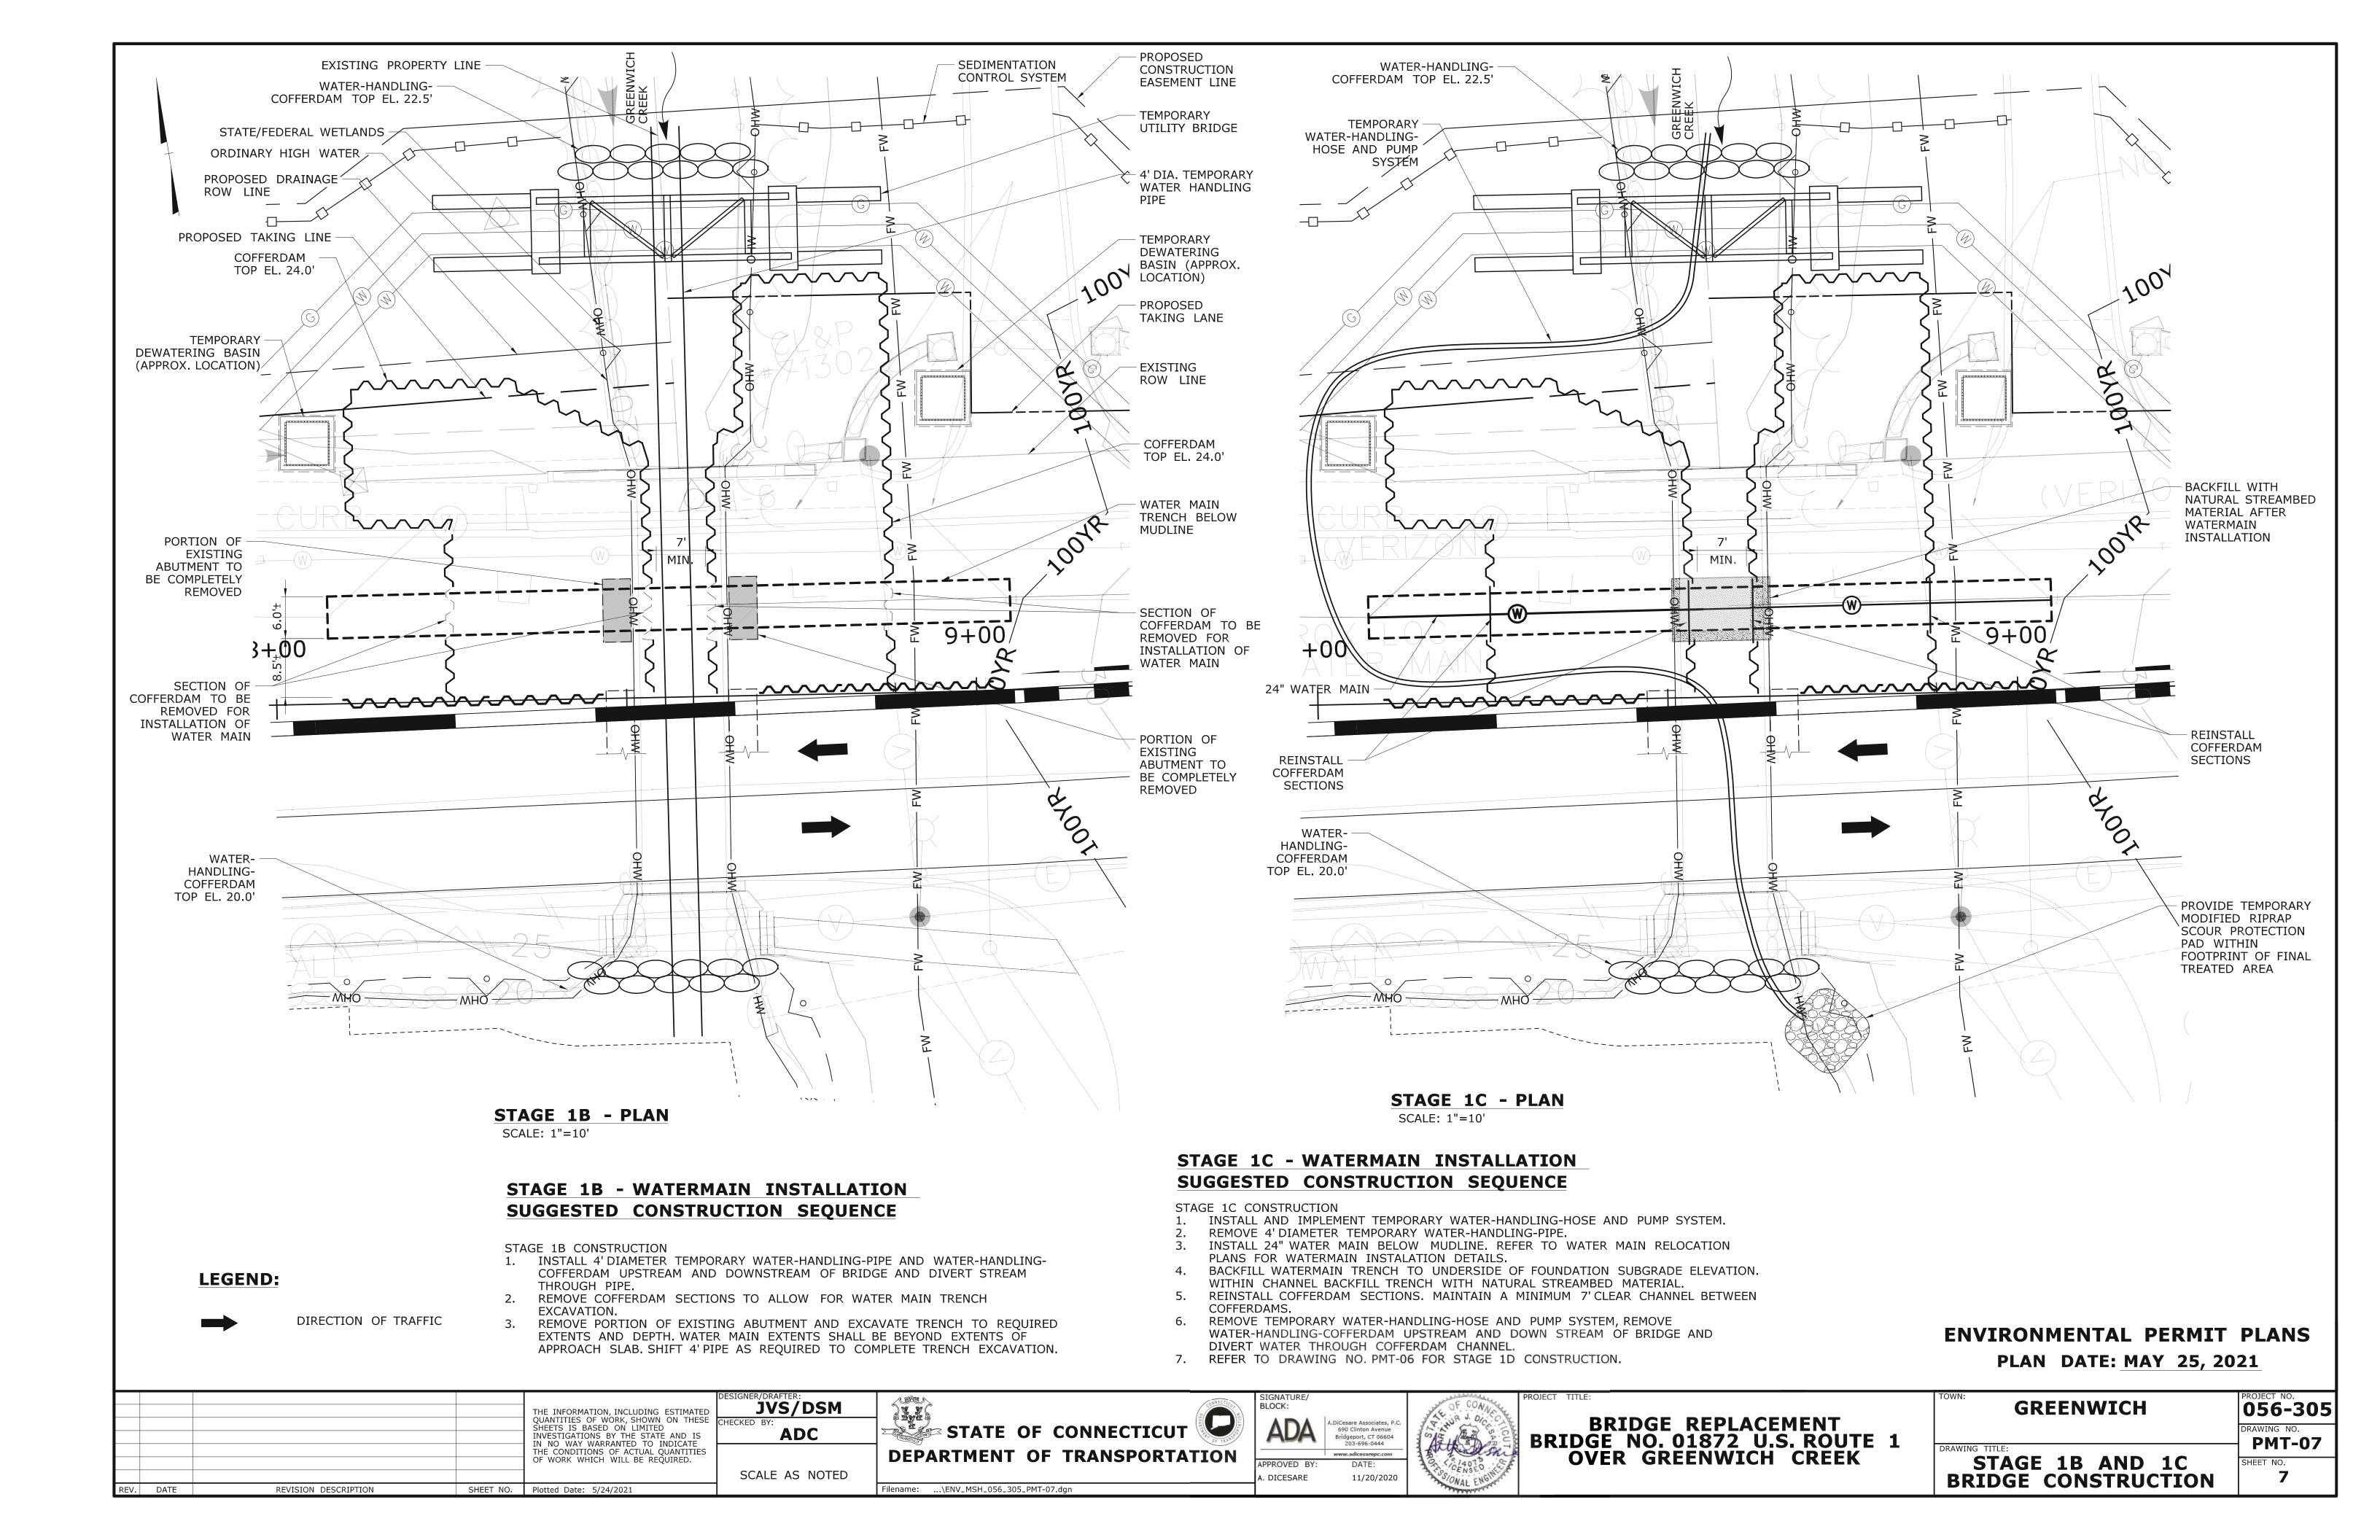


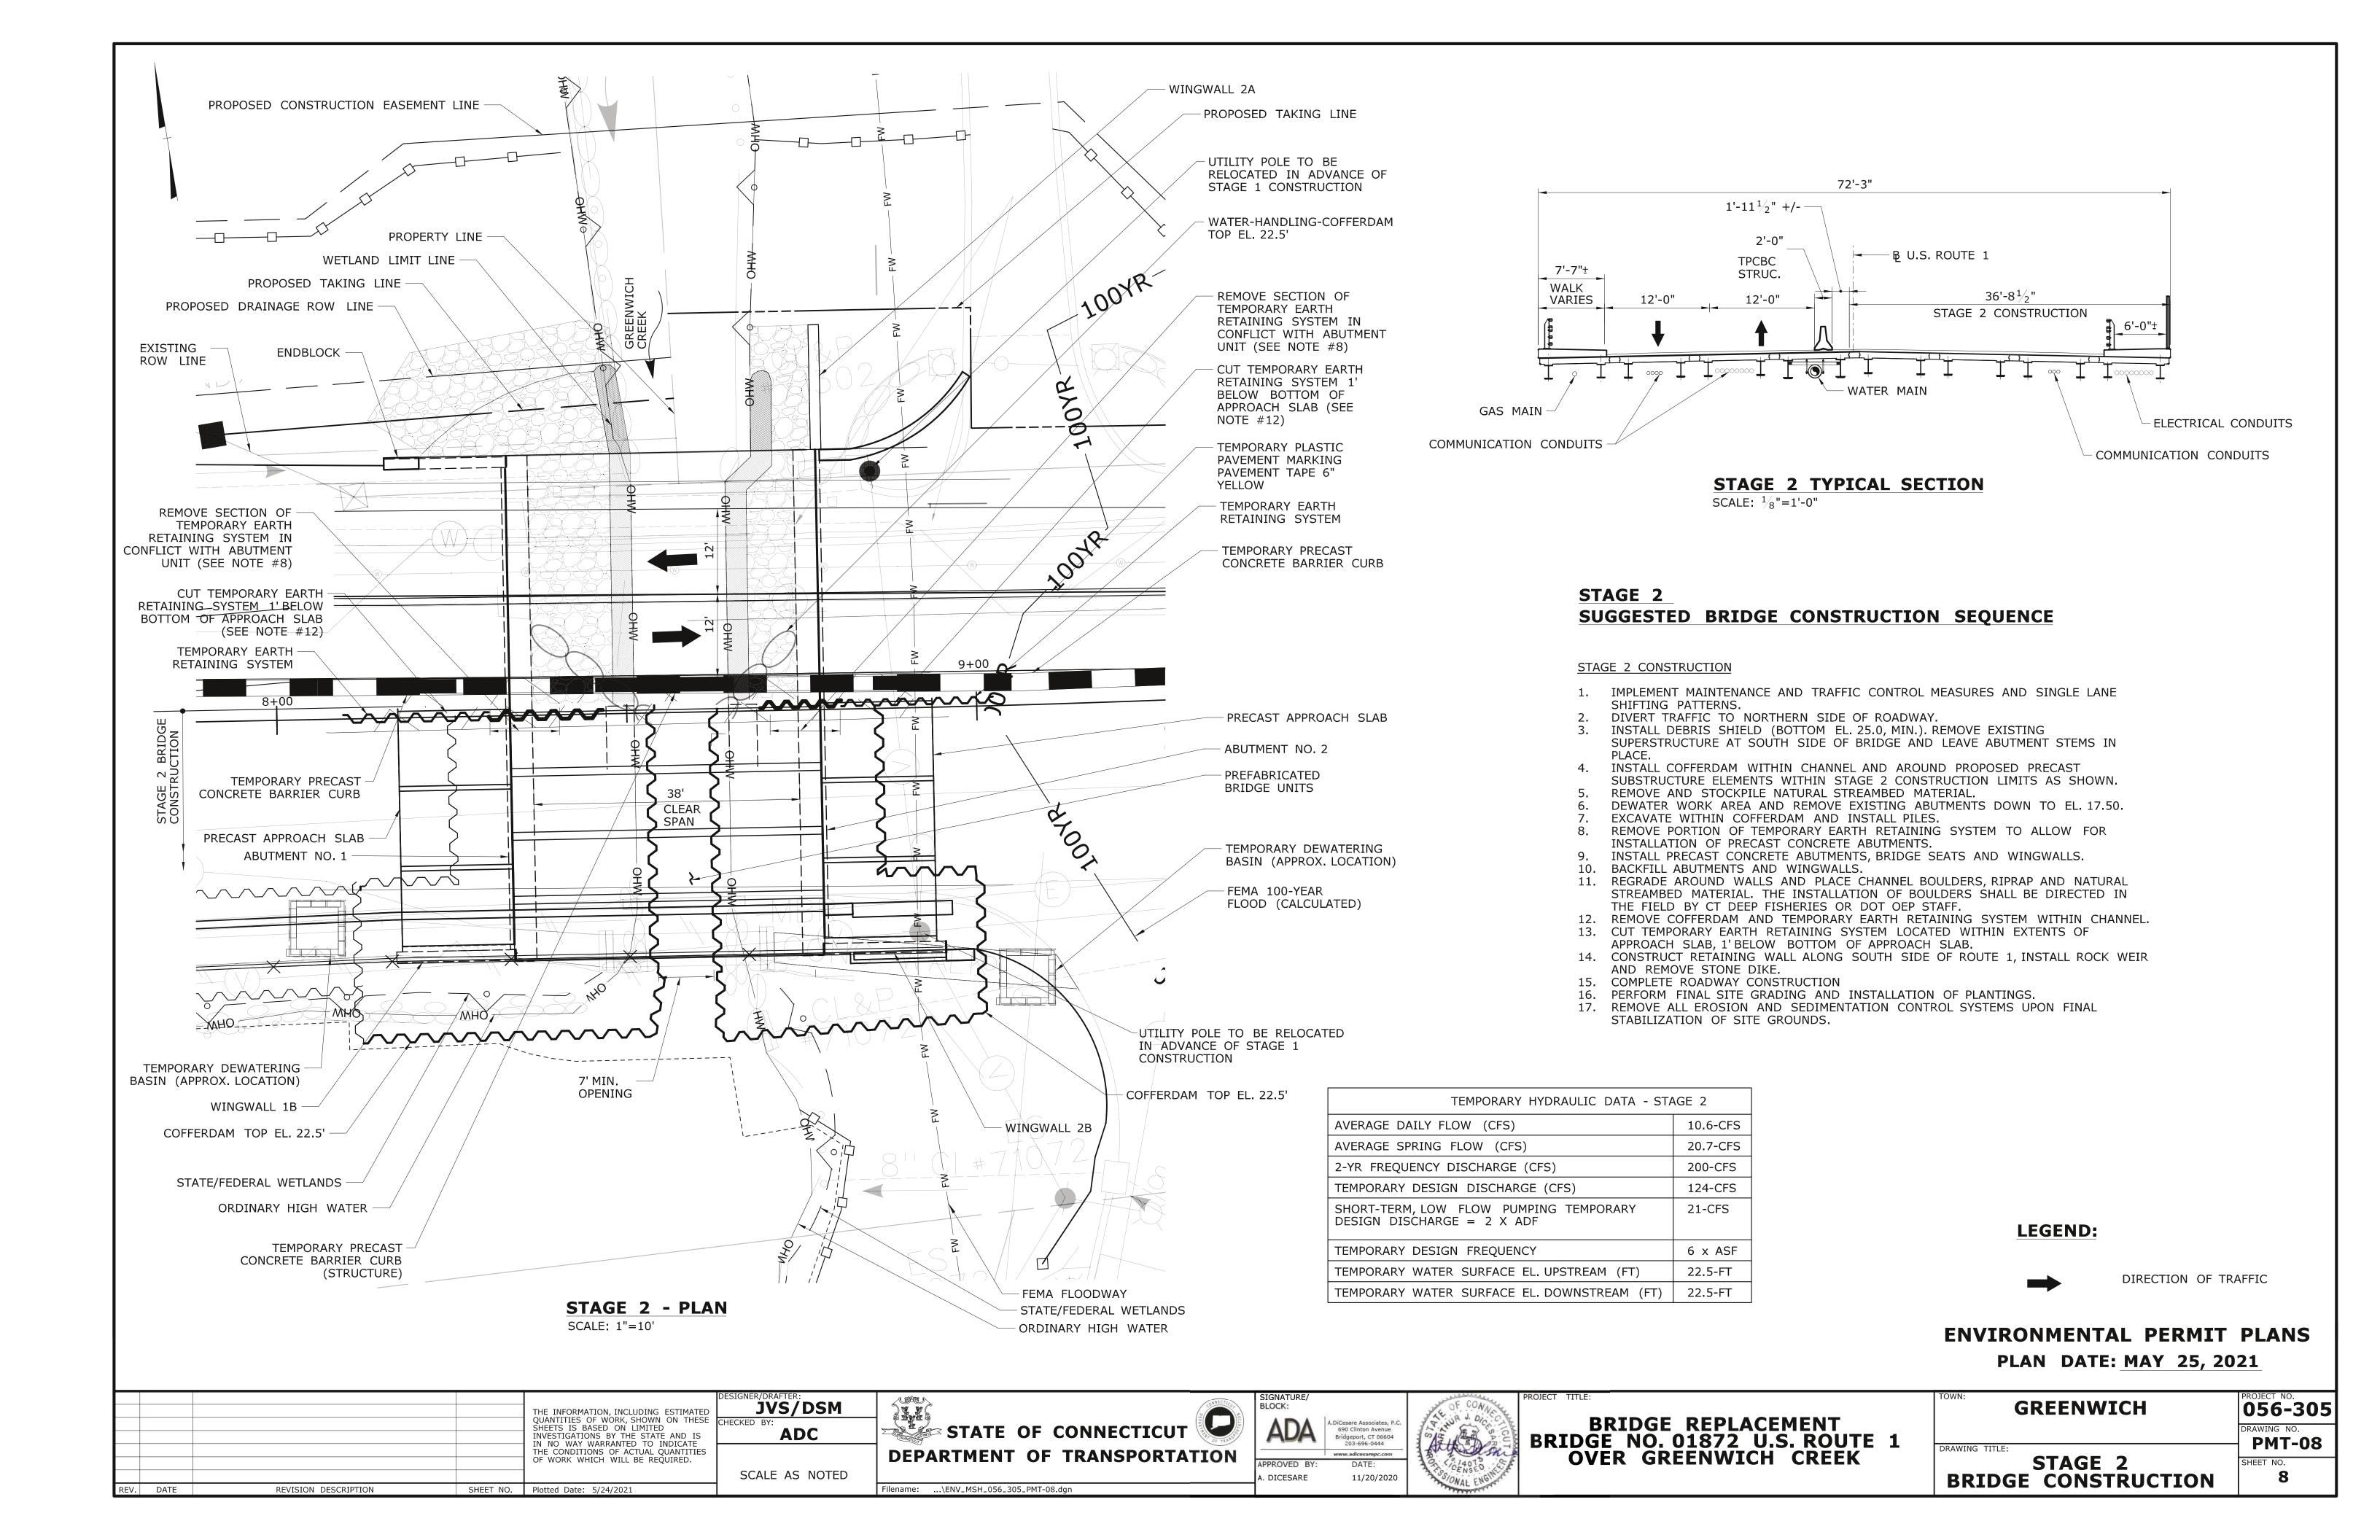

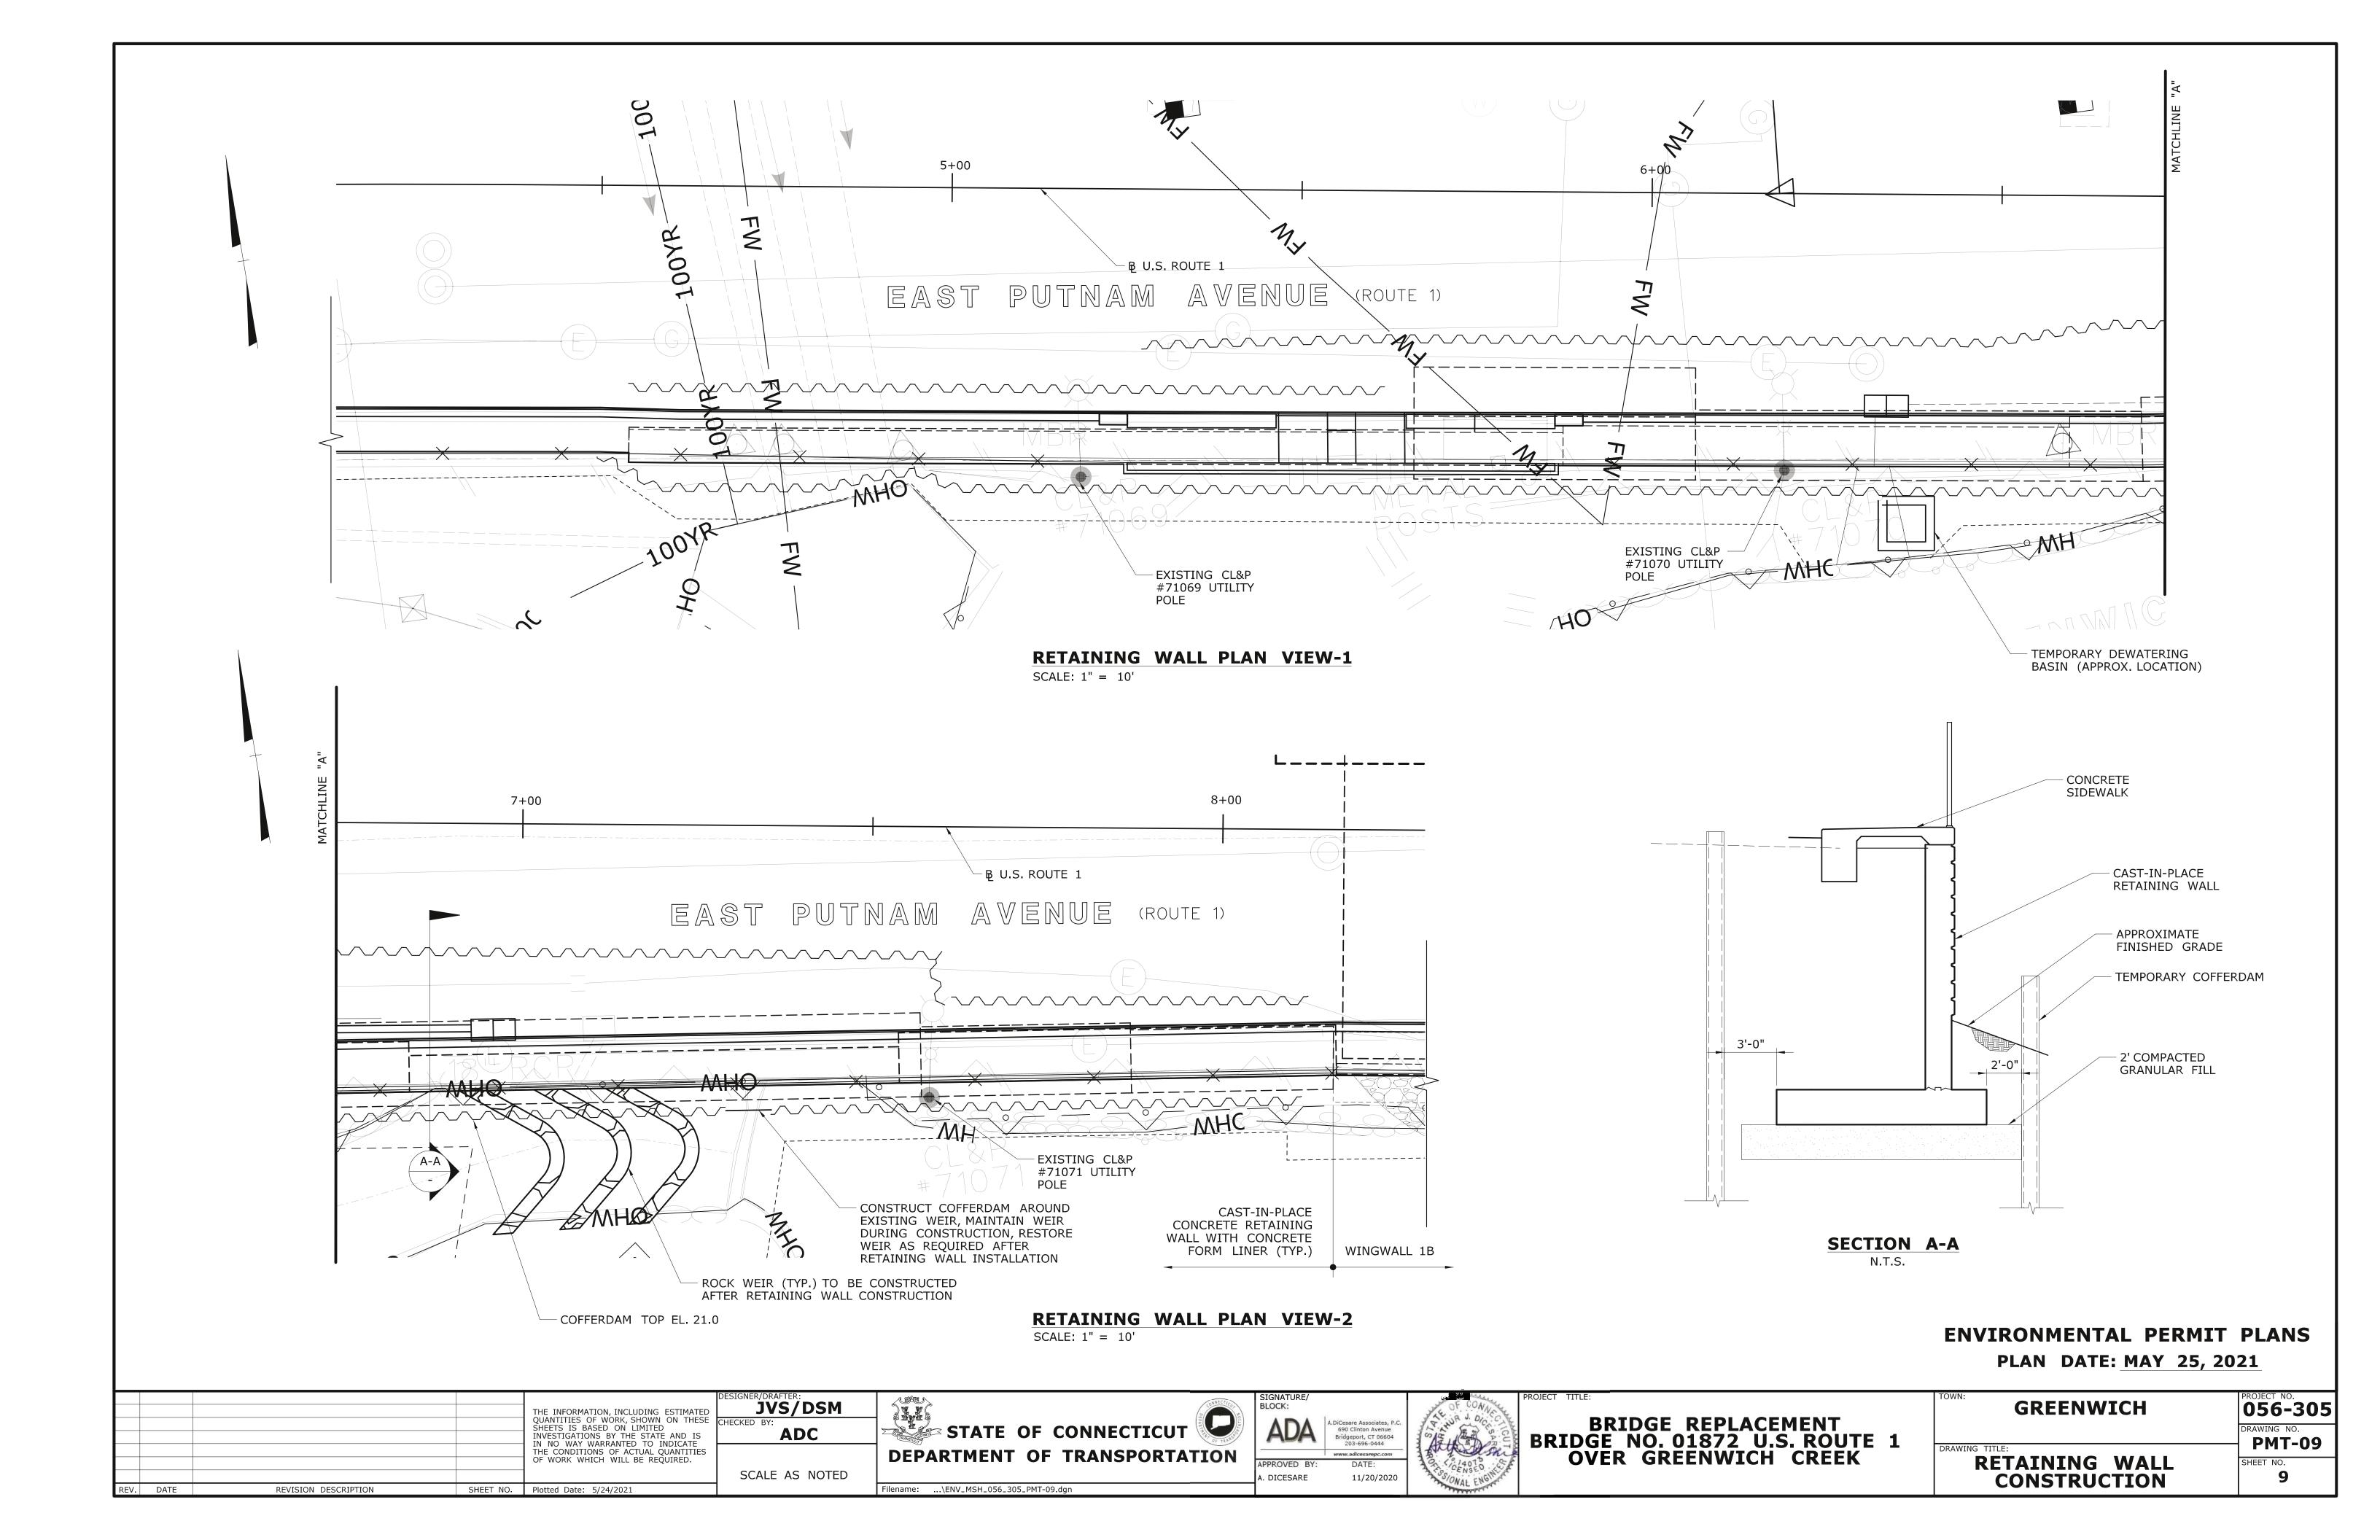


ROCK WEIR - PLAN VIEW

N.T.S.

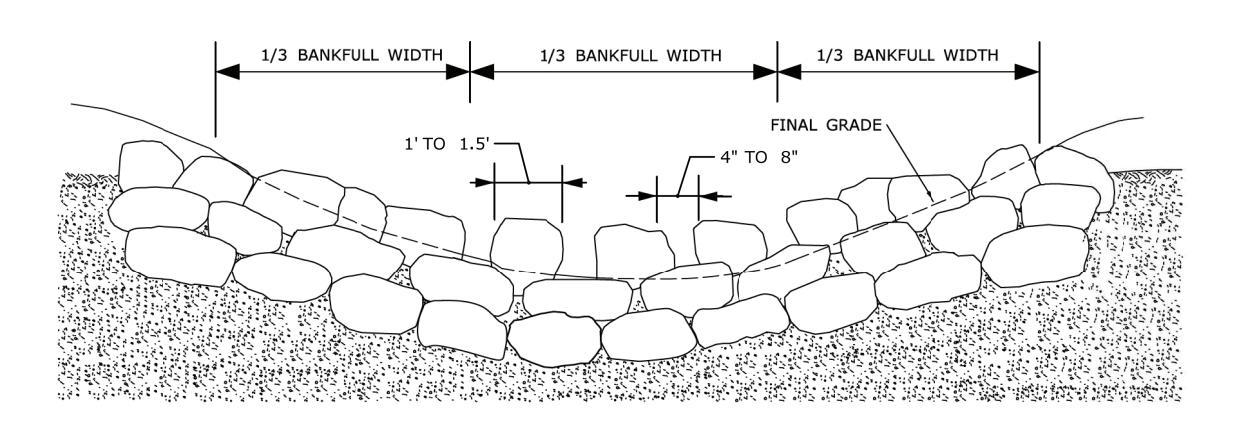


ROCK WEIR - SECTION VIEW (UPSTREAM)

N.T.S.

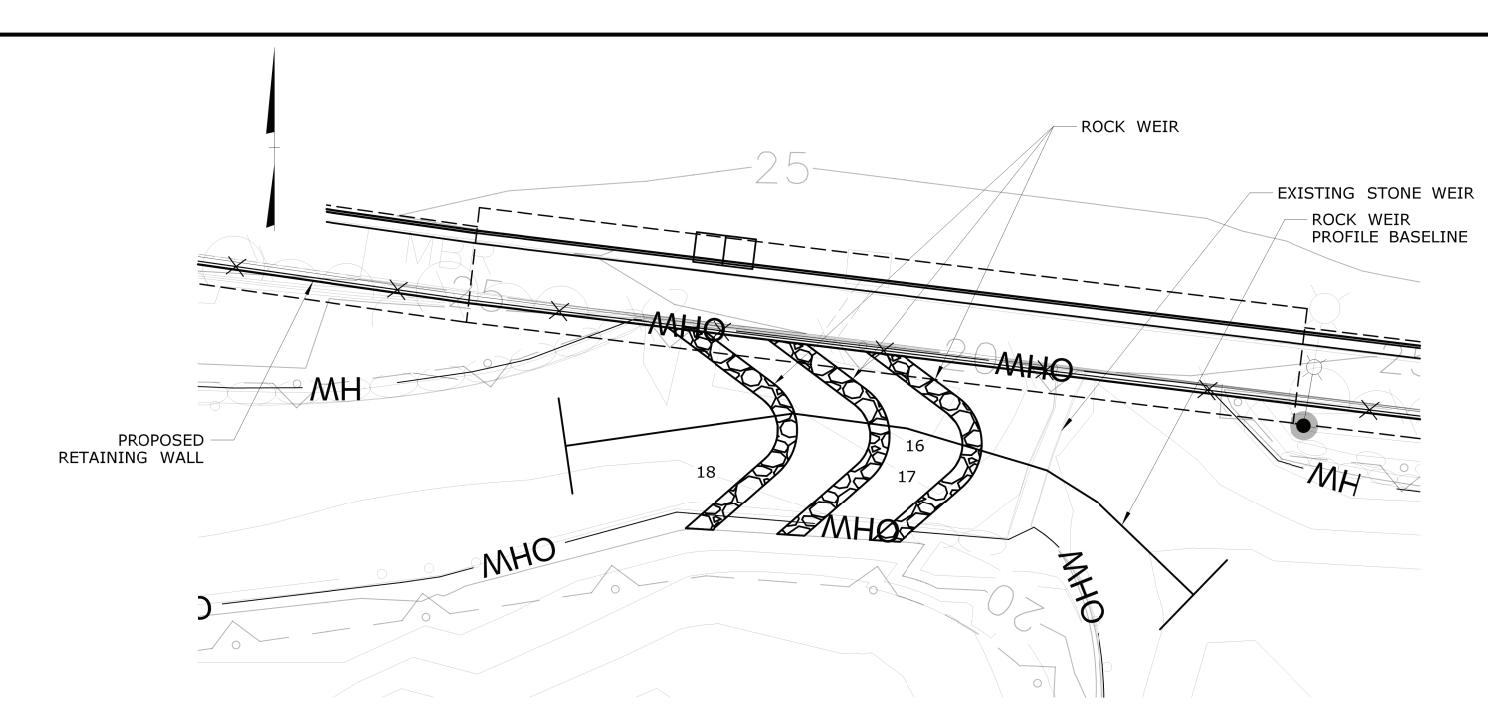

ROCK WEIR PLAN

N.T.S.

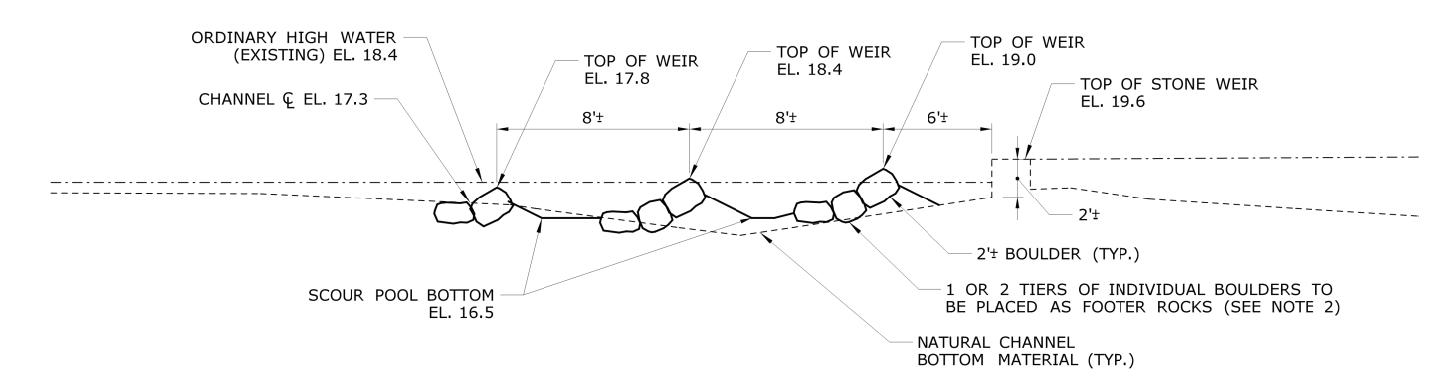

ROCK WEIR PROFILE


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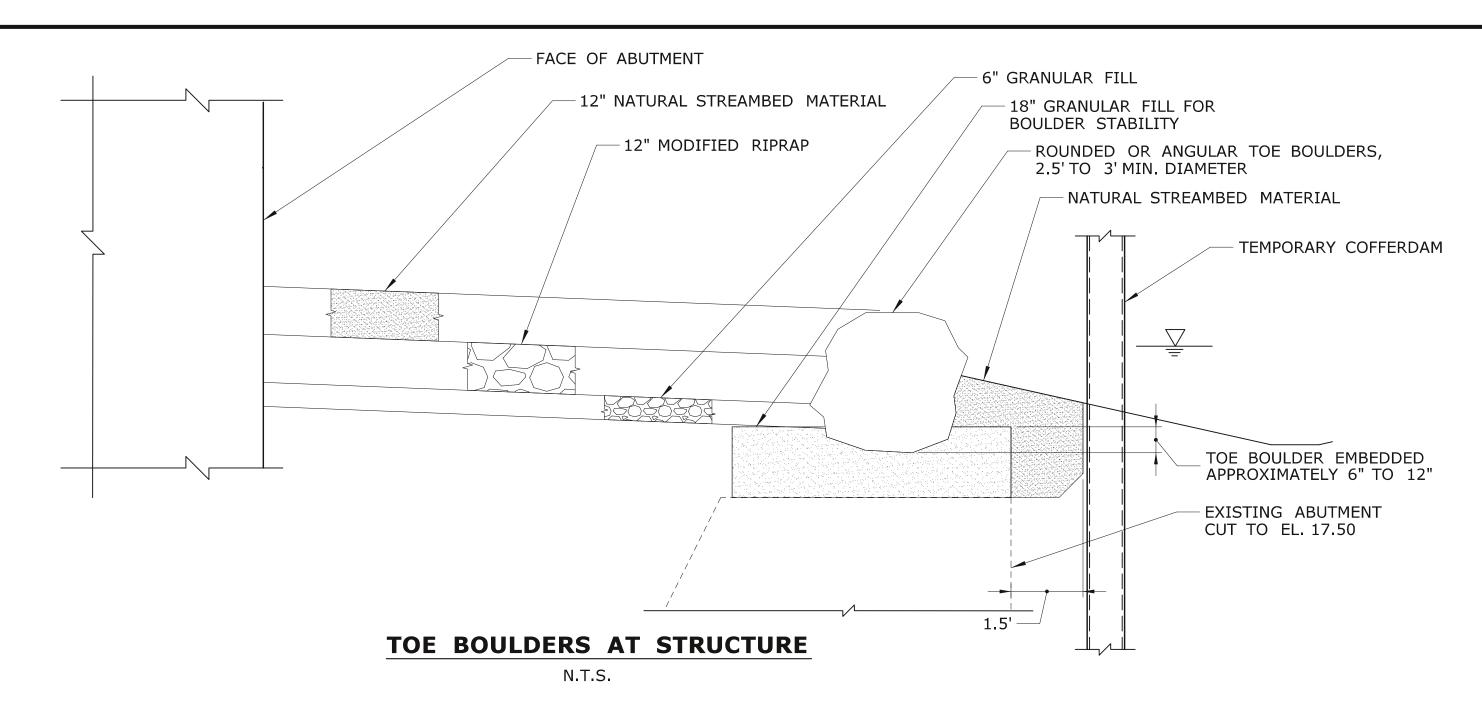
ROCK WEIR NOTES:


- 1. PLACEMENT OF THE ROCK WEIR SHALL BE UNDER THE SUPERVISION OF CTDEEP FISHERIES DIVISION STAFF (OR THEIR AUTHORIZED DELEGATE). THE CONTRACTOR SHALL COORDINATE THROUGH THE ENGINEER A MINIMUM OF 10-DAYS IN ADVANCE OF THE WEIR INSTALLATION TO ALLOW FOR CTDEEP FISHERIES DIVISION TO BE PRESENT ON SITE.
- 2. FOOTER ROCKS SHALL SERVE AS THE FOUNDATION FOR THE TOP LAYER OF THE WEIR. FOOTER ROCKS SHALL HAVE REASONABLE FLAT TOPS AND BOTTOMS TO ENABLE BETTER PLACEMENT OF THE TOP LAYER OF THE WEIR.
- 3. BOULDER TYPE (ROUNDED OR ANGULAR) AND SIZE (MINIMUM DIAMETER OR RANGE) SHALL BE AS SPECIFIED BY DEEP FISHERIES OR AS RECOMMENDED BY THE OFFICE OF ENVIRONMENTAL PLANNING (OEP). CONTRACTOR SHALL COORDINATE TYPE AND SIZE WITH DEEP FISHERIES OR OEP.
- 4. ALL WORK ASSOCIATED WITH THE INSTALLATION OF THE ROCK WEIR SHALL BE PAID FOR UNDER THE ITEM FOR "ROCK WEIR". EXISTING OR NATURAL STREAMBED MATERIAL SHALL BE PAID FOR UNDER THE ITEM FOR "EXCAVATION AND REUSE OF EXISTING CHANNEL BOTTOM MATERIAL" AND "SUPPLEMENTAL STREAMBED CHANNEL MATERIAL."
- 5. BOULDERS SHALL BE PLACED WITHIN THE DEPARTMENT'S RIGHT-OF-WAY OR EASEMENT.

ENVIRONMENTAL PERMIT PLANS PLAN DATE: MAY 25, 2021

JVS/JVS **GREENWICH** 056-305 BLOCK: THE INFORMATION, INCLUDING ESTIMATED QUANTITIES OF WORK, SHOWN ON THESE SHEETS IS BASED ON LIMITED INVESTIGATIONS BY THE STATE AND IS IN NO WAY WARRANTED TO INDICATE THE CONDITIONS OF ACTUAL QUANTITIES OF WORK WHICH WILL BE REQUIRED. BRIDGE REPLACEMENT BRIDGE NO. 01872 U.S. ROUTE 1 OVER GREENWICH CREEK STATE OF CONNECTICUT A.DiCesare Associates, P.C 690 Clinton Avenue Bridgeport, CT 06604 203-696-0444 **ADC PMT-10 DEPARTMENT OF TRANSPORTATION** www.adicesarepc.com **ROCK WEIR DETAILS** SCALE AS NOTED 10 DICESARE 11/20/2020 Filename: ...\ENV_MSH_056_305_PMT-10.dgn REVISION DESCRIPTION SHEET NO. Plotted Date: 5/24/2021 REV. DATE




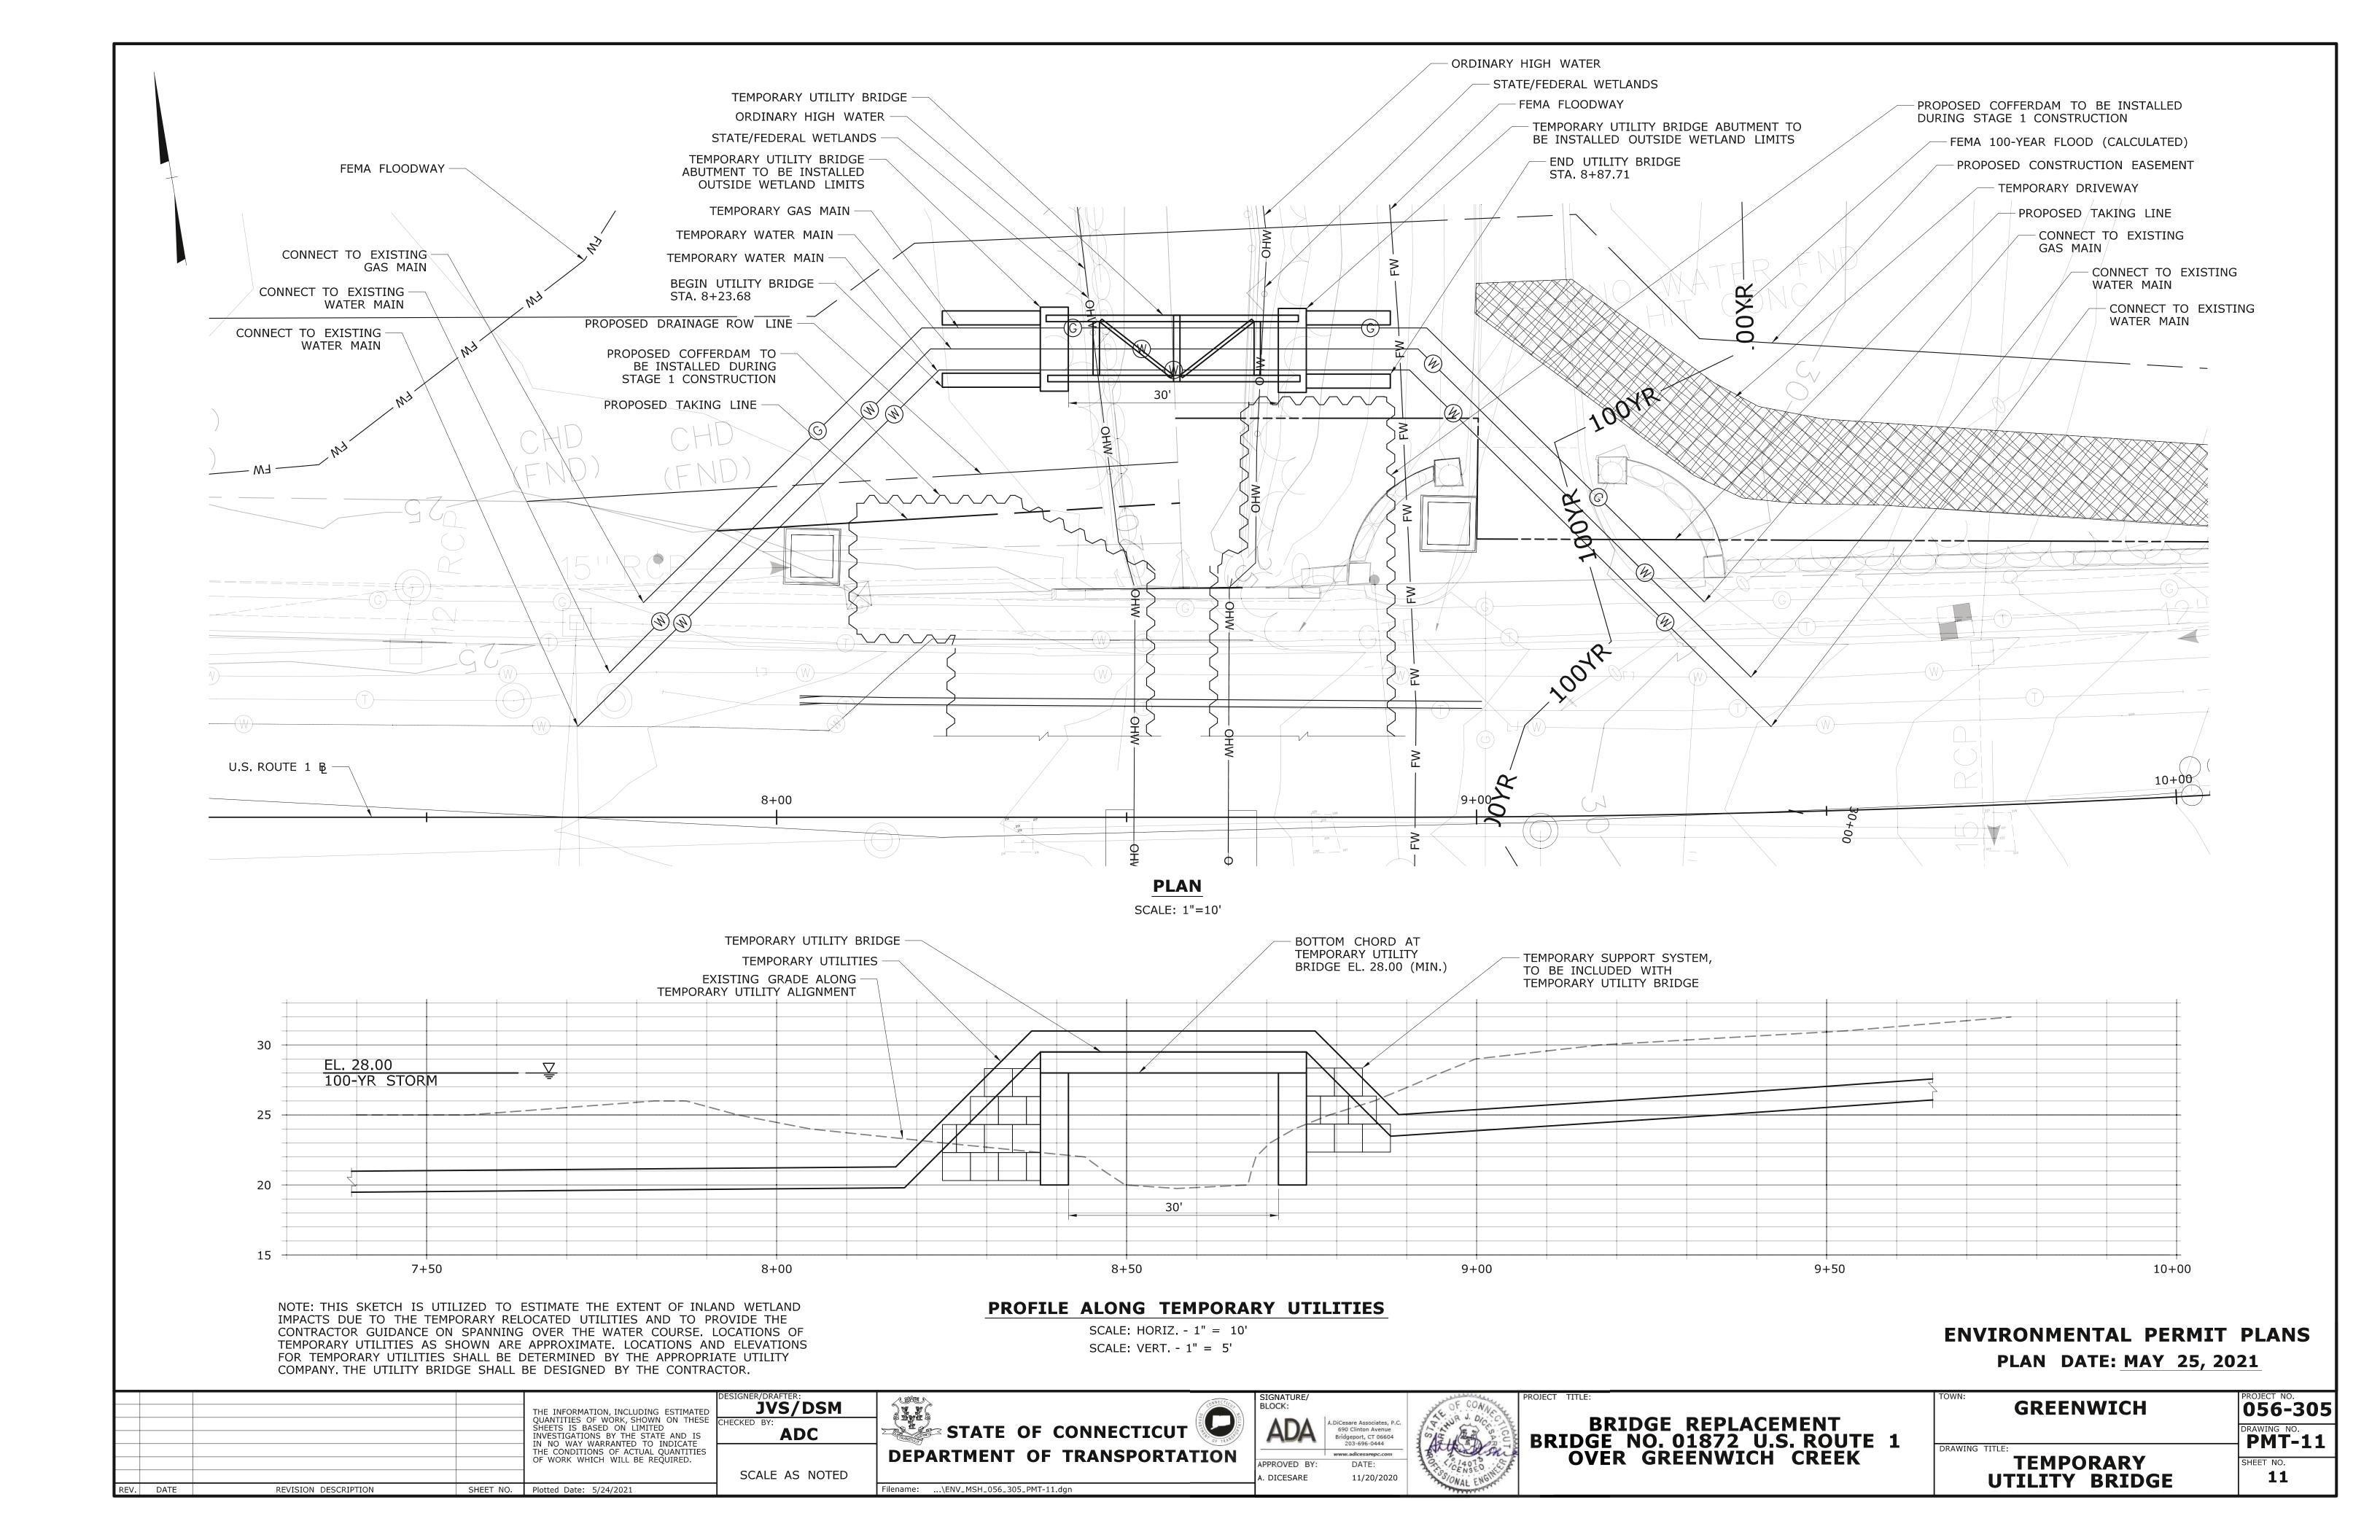

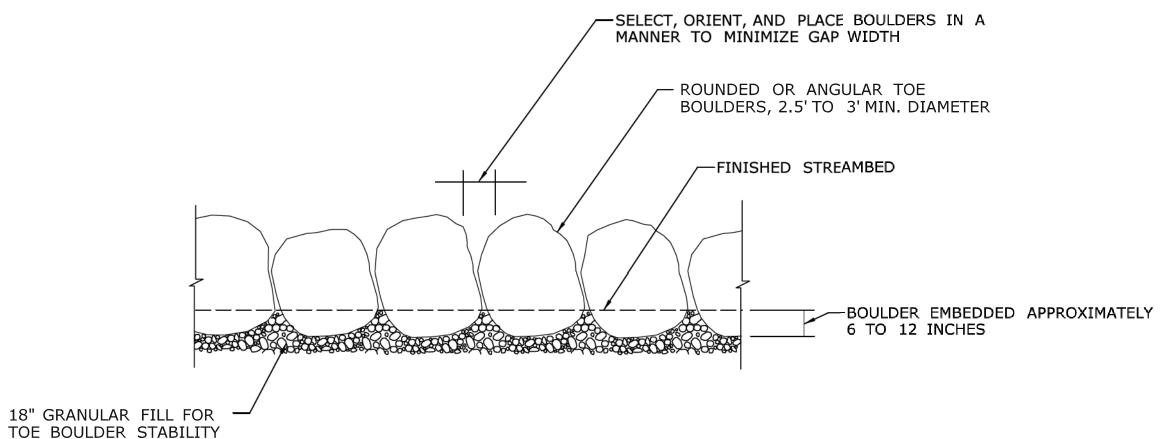

32.6' +/-REMOVE ALL STONE MASONRY REMOVE ALL STONE MASONRY REMOVE ALL STONE MASONRY TO 1'BELOW EXISTING GRADE TO 1'BELOW EXISTING GRADE TO EL. 19.0+/-EXISTING FOOTING 12" TOPSOIL, TURF STONES TO REMAIN, ESTABLISHMENT AND TOP EL. 19.0, TYP. **EROSION CONTROL** - DEBRIS SHIELD MATTING TYPE D AFTER MATCH FINISHED GRADE EL. 25.6 EXISTING EL. 19.0+/-TO EXISTING GRADE, TYP. STONE DIKE REMOVAL, GRADE — EL. 23.1 TYP. 12.0' +/-6.0' MIN. SUPPORT, TYP. STONE DIKE REMOVAL N.T.S.

TOE BOULDERS PROFILE VIEW

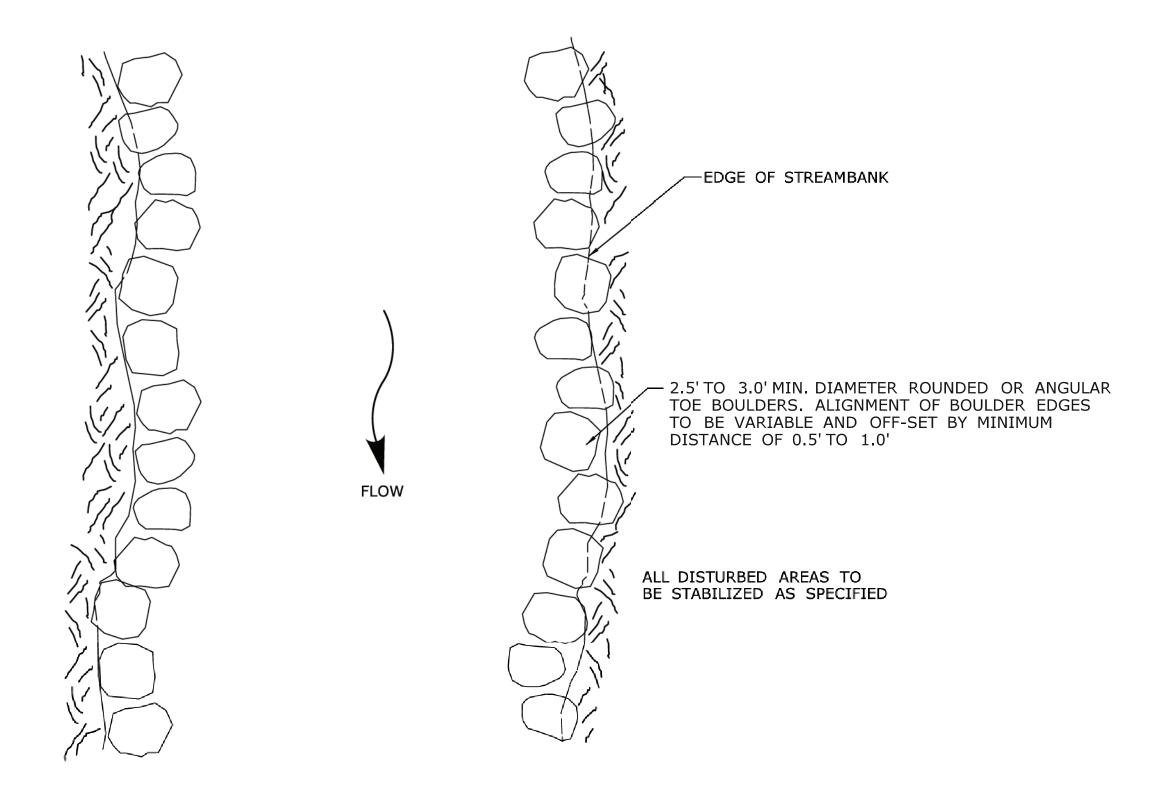

TOE BOULDERS PLAN VIEW

N.T.S.

NOTES:

- 1. PLACEMENT OF TOE BOULDERS SHALL BE DIRECTED IN THE FIELD BY THE ENGINEER OR THE AUTHORIZED DELEGATE. SEE SPECIAL PROVISIONS "PLACEMENT OF TOE BOULDERS".
- 2. BOULDERS SHALL BE PLACED WITHIN THE DEPARTMENT'S RIGHT-OF-WAY OR EASEMENT.
- 3. ALL WORK ASSOCIATED WITH THE PLACEMENT OF TOE BOULDERS SHALL BE PAID FOR UNDER "PLACEMENT OF TOE BOULDERS." EXISTING OR NATURAL STREAMBED MATERIAL SHALL BE PAID FOR UNDER SPECIAL PROVISION "EXCAVATION AND REUSE OF EXISTING CHANNEL BOTTOM MATERIAL", AND SUPPLEMENTAL STREAMBED CHANNEL MATERIAL."

NATIVE STREAMBED MATERIAL NOTES:


- 1. NATIVE STREAMBED MATERIAL EXCAVATED DURING THE BRIDGE INSTALLATION SHALL BE STOCKPILED AND THEN REPLACED WITHIN THE WATERWAY CHANNEL TO THE DEPTH SHOWN ON THE PLANS OR AS DIRECTED BY THE ENGINEER IN ACCORDANCE WITH THE SPECIAL PROVISION "EXCAVATION AND REUSE OF EXISTING CHANNEL BOTTOM MATERIAL."
- 2. ADDITIONAL STREAMBED MATERIAL IF REQUIRED, SHALL BE IN ACCORDANCE WITH SPECIAL PROVISION "SUPPLEMENTAL STREAMBED CHANNEL MATERIAL."
- 3. THE STOCKPILE SHALL BE LOCATED OUTSIDE OF THE WETLAND LIMITS AND PROTECTED WITH SEDIMENTATION CONTROL SYSTEM.

STONE DIKE REMOVAL NOTES:

- 1. REMOVAL OF STONE DIKE SHALL BE PAID FOR UNDER ITEM REMOVAL OF EXISTING MASONRY.
- 2. STONE DIKE IS 3'+/- WIDE. STONE DIKE DIMENSIONS AND ELEVATIONS ARE APPROXIMATE FOR ESTIMATING PURPOSES ONLY AND SHALL BE FIELD VERIFIED.
- 3. REMOVAL OF THE STONE DIKE SHALL OCCUR DURING LOW FLOW PERIODS.
- 4. IF THE WATER SURFACE ELEVATION APPROACHES THE TOP OF THE DEBRIS SHIELD (WITHIN 3 INCHES), THE CONTRACTOR SHALL STOP WORK, REMOVE ACCUMULATED DEBRIS, AND REMOVE THE DEBRIS SHIELD AND SANDBAG SUPPORTS UNTIL FLOW BEGINS TO RECEDE.
- 5. THE DEBRIS SHIELD SHALL EXTEND A MINIMUM OF 4-FEET UPSTREAM AND DOWNSTREAM OF THE LIMITS OF THE STONE DIKE.
- 6. THE WATERCOURSE AREA SHALL BE RESTORED TO EXISTING CONDITIONS WITH NATURAL STREAMBED MATERIAL.

ENVIRONMENTAL PERMIT PLANS PLAN DATE: MAY 25, 2021

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GREENWICH STATE OF CONNECTICUT 56-305 MR THE INFORMATION, INCLUDING ESTIMATED QUANTITIES OF WORK, SHOWN ON THESE SHEETS IS BASED ON LIMITED INVESTIGATIONS BY THE STATE AND IS IN NO WAY WARRANTED TO INDICATE THE CONDITIONS OF ACTUAL QUANTITIES BRIDGE REPLACEMENT BRIDGE NO. 01872 U.S. ROUTE 1 OVER GREENWICH CREEK OFFICE OF ENGINEERING **PMT-13** THE CONDITIONS OF ACTUAL QUANTITIES OF WORK WHICH WILL BE REQUIRED. SCALE IN FEET **DEPARTMENT OF TRANSPORTATION** PERMIT PLANTING PLAN 13 SCALE 1"=40' REVISION DESCRIPTION SHEET NO. Plotted Date: 4/29/2021 Filename: ...\Landscape\HW_56-305_LND_01.dgn REV. DATE

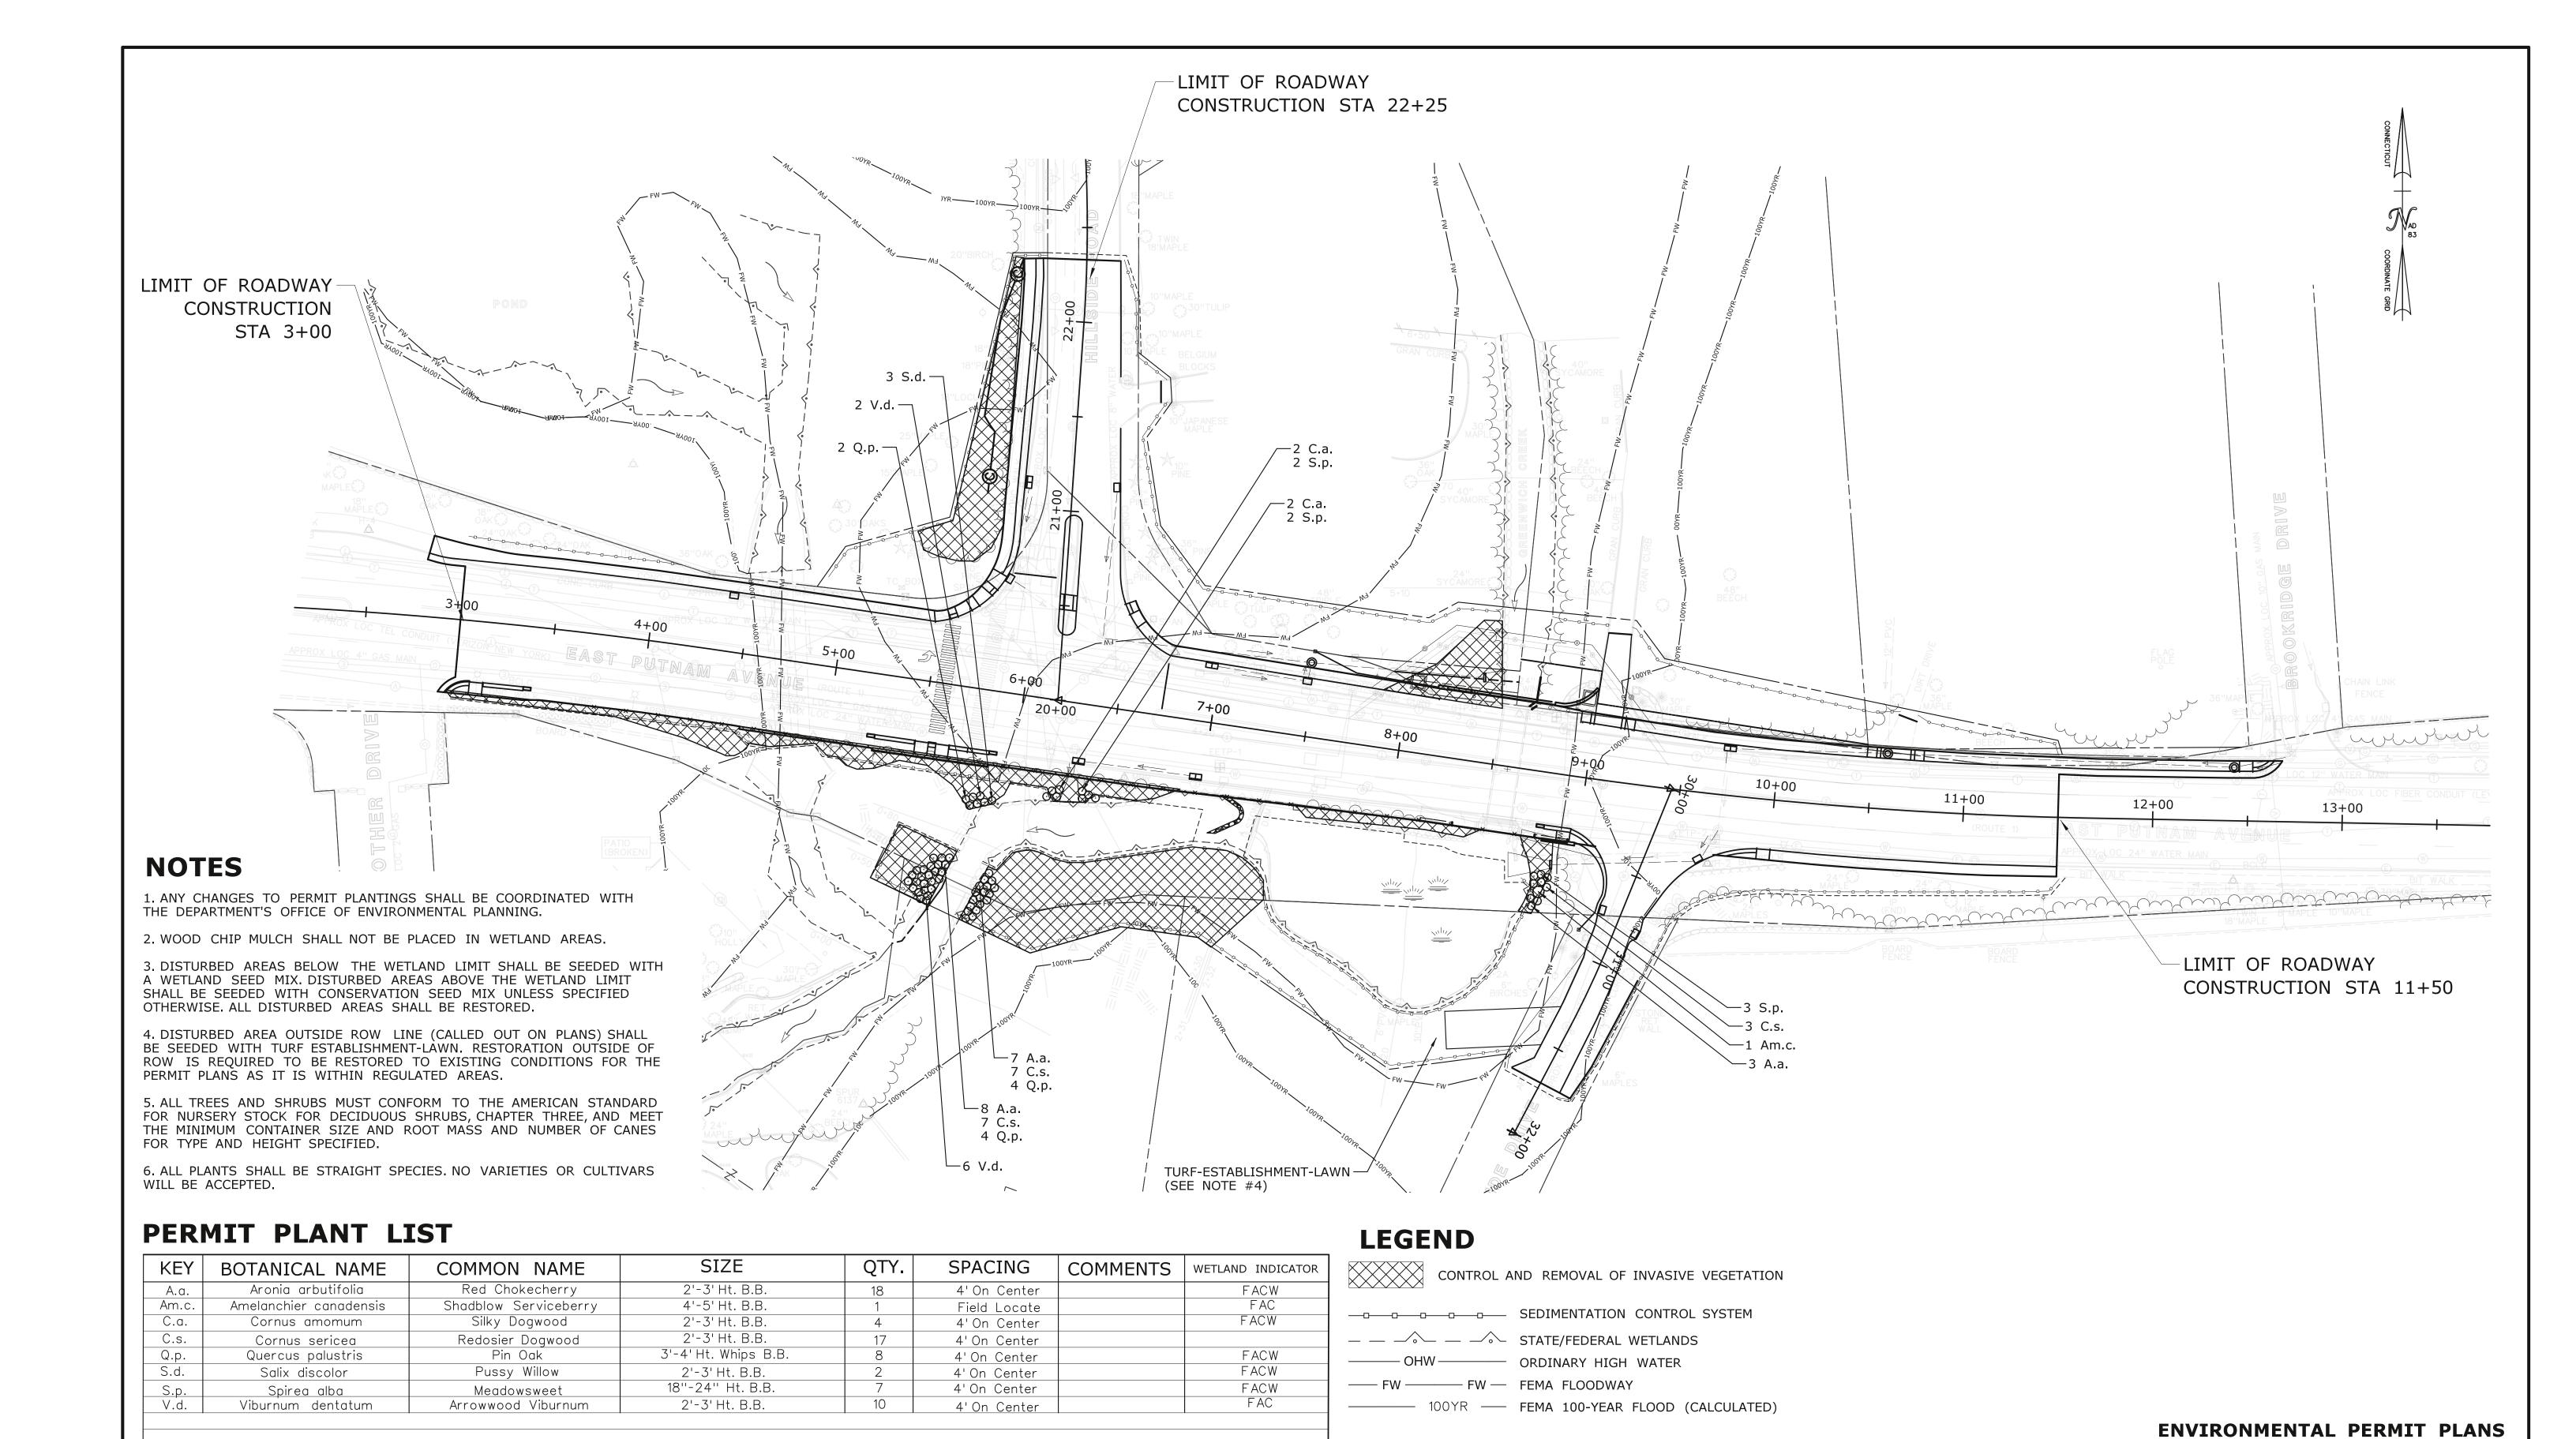1,780 S.Y.

90 S.Y.

Control and Removal of Invasive Vegetation

Wood Chip Mulch

APRIL 28, 2021