



Connecticut Department of Energy and Environmental Protection License*

Structures, Dredging & Fill Permit

Licensee(s): Seaview Bridgeport, LLC

Licensee Address(s): 10 East Main Street, suite 201
Bridgeport, CT 06608

License Number(s): 202502257-SDFWQ

Municipality: Bridgeport

Project Description: Install riprap for flood & erosion control

Project Address/Location: 837 Seaview Avenue

Waters: Yellow Mill Channel

Authorizing CT Statute(s) and/or Federal Law: CGS Section 22a-359 to 363g; CGS Section 22a-90 to 112; Section 401 CWA (33 USC 1341)

Applicable Regulations of CT State Agencies:

Agency Contact: Land & Water Resources Division,
Bureau of Water Protection & Land Reuse, 860-424-3019

License Expiration: Five (5) years from the date of issuance of this license.

Project Site Plan Set: 12 Sheets of plans prepared by Luchs Consulting Engineers dated June 3, 2025, and revised, July 29, 2025, except for sheet SH-2 which is revised July 9, 2025.

License Enclosures: LWRD General Conditions; Site Plan Set; Land Record Filing; LWRD Work Commencement Form; LWRD Compliance Certification Form

*Connecticut's Uniform Administrative Procedure Act defines License to include, "the whole or part of any agency permit, certificate, approval, registration, charter or similar form of permission required by law . . ."

Authorized Activities:

The Licensee is hereby authorized to conduct the following work as described in application # 202502257-SDFWQ and as depicted on any site plan sheets / sets cited herein:

install scour protection for a new stormwater outlet by:

1. placing up to 5 cubic yards of riprap over an approximately 280 square foot area of the armored shoreline as shown sheet SH-5 of the plans, attached hereto; and,
2. excavating stone and earth from an approximately 110 square foot area and replacing with riprap.

Failure to comply with the terms and conditions of this license shall subject the Licensee and / or the Licensee's contractor(s) to enforcement actions and penalties as provided by law.

This license is subject to the following Terms and Conditions:

1. **License Enclosure(s) and Conditions.** The Licensee shall comply with all applicable terms and conditions as may be stipulated within the License Enclosure(s) listed above.
2. **Turbidity Curtain.** Prior to the commencement of work authorized herein, the Licensee shall install turbidity curtains extending from the water surface to the substrate around the work area. Such erosion and sediment control structures shall be maintained in optimal operating condition until project completion at which time the erosion and sediment controls shall be removed to an upland location.
3. **Inspection and Maintenance.** The Licensee shall inspect the scour hole as shown on sheets SH-5 and SH-7, attached hereto, and remove all sediment and debris when accumulated sediment exceeds a depth of 1'.

Issued under the authority of the Commissioner of Energy and Environmental Protection on:

Date

Emma Cimino
Deputy Commissioner
Department of Energy & Environmental Protection

LWRD General Conditions

- 1. Land Record Filing (for *Structures Dredging & Fill, Tidal Wetlands, Certificate of Permission, and Long Island Sound General Permit* Licenses only).** The Licensee shall file the Land Record Filing on the land records of the municipality in which the subject property is located not later than thirty (30) days after license issuance pursuant to Connecticut General Statutes (CGS) Section 22a-363g. A copy of the Notice with a stamp or other such proof of filing with the municipality shall be submitted to DEEP.LWRDRegulatory@ct.gov no later than sixty (60) days after license issuance. If a Land Record Filing form is not enclosed and the work site is not associated with an upland property, no filing is required.
- 2. Contractor Notification.** The Licensee shall give a copy of the license and its attachments to the contractor(s) who will be carrying out the authorized activities prior to the start of construction and shall receive a written receipt for such copy, signed and dated by such contractor(s). The Licensee's contractor(s) shall conduct all operations at the site in full compliance with the license and, to the extent provided by law, may be held liable for any violation of the terms and conditions of the license. At the work site, the contractor(s) shall, whenever work is being performed, have on site and make available for inspection a copy of the license and the authorized plans.
- 3. Work Commencement¹.** Not later than two (2) weeks prior to the commencement of any work authorized herein, the Licensee shall submit to DEEP.LWRDRegulatory@ct.gov, on the Work Commencement Form attached hereto, the name(s) and address(es) of all contractor(s) employed to conduct such work and the expected date for commencement and completion of such work, if any.
 - For water diversion activities authorized pursuant to 22a-377(c)-1 of the Regulations of Connecticut State Agencies, the Licensee shall also notify the Commissioner in writing two weeks prior to initiating the authorized diversion.
 - For emergency activities authorized Connecticut General Statutes Section 22a-6k, the Licensee shall notify the Commissioner, in writing, of activity commencement at least one (1) day prior to construction and of activity completion no later than five (5) days after conclusion.
- 4. For Coastal Licenses Only - License Notice.** The Licensee shall post the first page of the License in a conspicuous place at the work area while the work authorized therein is undertaken.
- 5. Unauthorized Activities.** Except as specifically authorized, no equipment or material, including but not limited to, fill, construction materials, excavated material or debris, shall be deposited, placed or stored in any wetland or watercourse on or off-site. The Licensee may not

¹ The Work Commencement condition and the need for a Work Commencement Form is not applicable to Flood Management Certification approvals.

conduct work within wetlands or watercourses other than as specifically authorized, unless otherwise authorized in writing by the Commissioner. Tidal wetlands means “wetland” as defined by section 22a-29 and “freshwater wetlands and watercourses” means “wetlands” and “watercourses” as defined by section 22a-38.

- 6. Management of Materials.** Any materials removed from the site shall be managed in accordance with all federal, state, and local requirements, including Chapter 446K Water Pollution Control, Chapter 445 Hazardous Waste, and Chapter 446d Solid Waste of the Connecticut General Statutes.
- 7. Unconfined Instream Work.** Unless otherwise noted in a condition of the license, the following conditions apply to projects in non-coastal waters:
 - Unconfined instream work is limited to the period June 1 through September 30.
 - Confinement of a work area by cofferdam techniques using sand bag placement, sheet pile installation (vibratory method only), portadam, or similar confinement devices is allowed any time of the year. The removal of such confinement devices is allowed any time of the year.
 - Once a work area has been confined, in-water work within the confined area is allowed any time of the year.
 - The confinement technique used shall completely isolate and protect the confined area from all flowing water. The use of silt boom/curtain or similar technique as a means for confinement is prohibited.
- 8. For State Actions Only - Material or Equipment Storage in the Floodplain.** Unless approved by a Flood Management Exemption, the storage of any materials at the site which are buoyant, hazardous, flammable, explosive, soluble, expansive, radioactive, or which could in the event of a flood be injurious to human, animal or plant life, below the elevation of the five-hundred (500) year flood is prohibited. Any other material or equipment stored at the site below said elevation by the Licensee or the Licensee's contractor must be firmly anchored, restrained or enclosed to prevent flotation. The quantity of fuel stored below such elevation for equipment used at the site shall not exceed the quantity of fuel that is expected to be used by such equipment in one day. In accordance with the licensee's Flood Contingency Plan, the Licensee shall remove equipment and materials from the floodplain during periods when flood warnings have been issued or are anticipated by a responsible federal, state or local agency. It shall be the Licensee's responsibility to obtain such warnings when flooding is anticipated.
- 9. Temporary Hydraulic Facilities for Water Handling.** If not reviewed and approved as a part of the license application, temporary hydraulic facilities shall be designed by a qualified professional and in accordance with the *Connecticut Guidelines for Soil Erosion and Sediment Control*, the *2004 Connecticut Stormwater Quality Manual*, or the *Department of Transportation's ConnDOT Drainage Manual*, as applicable. Temporary hydraulic facilities may include channels, culverts or bridges which are required for haul roads, channel relocations, culvert installations, bridge construction, temporary roads, or detours.
- 10. Excavated Materials.** Unless otherwise authorized, all excavated material shall be staged and

managed in a manner which prevents additional impacts to wetlands and watercourses.

11. Best Management Practices. The Licensee shall not cause or allow pollution of any wetlands or watercourses, including pollution resulting from sedimentation and erosion. In constructing or maintaining any authorized structure or facility or conducting any authorized activity, or in removing any such structure or facility, the Licensee shall employ best management practices to control storm water discharges, to prevent erosion and sedimentation, and to otherwise prevent pollution of wetlands and other waters of the State. For purposes of the license, “pollution” means “pollution” as that term is defined by CGS section 22a-423. Best Management Practices include, but are not limited, to practices identified in the *Connecticut Guidelines for Soil Erosion and Sediment Control* as revised, *2004 Connecticut Stormwater Quality Manual*, Department of Transportation’s *ConnDOT Drainage Manual* as revised, and the Department of Transportation Standard Specifications as revised.

12. In-Water Work Vessel Staging and Storage. (for Structures Dredging & Fill, Tidal Wetlands, Certificate of Permission, and Long Island Sound General Permit Licenses only). For any barge, vessel, skiff or floating work platform (“work vessels”) utilized in the execution of the work authorized herein, the Licensee shall ensure that such work vessels:

- do not rest on, or come in contact with, the substrate at any time, unless specifically authorized in the license.
- are not stored over intertidal flats, submerged aquatic vegetation or tidal wetland vegetation or in a location that interferes with navigation. In the event any work vessel is grounded, no dragging or prop dredging shall occur to free it.

13. Work Site Restoration. Upon completion of any authorized work, the Licensee shall restore all areas temporarily impacted by construction, or used as a staging area or accessway in connection with such work, to their condition prior to the commencement of such work.

14. Inspection. The Licensee shall allow any representative of the Commissioner to inspect the project location at reasonable times to ensure that work is being or has been conducted in accordance with the terms and conditions of this license.

15. Change of Use. (Applies only if a use is specified within the License “*Project Description*”)

- a. The work specified in the license is authorized solely for the purpose set forth in the license. No change in purpose or use of the authorized work or facilities as set forth in the license may occur without the prior written approval of the Commissioner. The Licensee shall, prior to undertaking or allowing any change in use or purpose from that which is authorized by this license, request permission from the Commissioner for such change. Said request shall be in writing and shall describe the proposed change and the reason for the change.
- b. A change in the form of ownership of any structure authorized herein from a rental/lease commercial marina to a wholly-owned common interest community or dockominium may constitute a change in purpose as specified in paragraph (a) above.

16. De Minimis Alteration. The Licensee shall not deviate from the authorized activity without prior written approval from the Commissioner. The Licensee may request a de minimis change

to any authorized structure, facility, or activity. A de minimis alteration means a change in the authorized design, construction or operation that individually and cumulatively has minimal additional environmental impact and does not substantively alter the project as authorized.

- For diversion activities authorized pursuant to 22a-377(c)-2 of the Regulations of Connecticut State Agencies, a de minimis alteration means an alteration which does not significantly increase the quantity of water diverted or significantly change the capacity to divert water.

17. Extension Request. The Licensee may request an extension of the license expiration date. Such request shall be in writing and shall be submitted to DEEP.LWRDRegulatory@ct.gov at least thirty (30) days prior to the license expiration. Such request shall describe the work done to date, what work still needs to be completed, and the reason for such extension. The Commissioner may extend the expiration date of this license for a period of up to one year, in order for the Licensee to complete the authorized activities. It shall be at the Commissioner's sole discretion to grant or deny such request. No more than three (3) one-year extensions will be granted under this license.

18. Compliance Certification². Not later than 90 days after completion of the authorized work, the Licensee shall prepare and submit to DEEP.LWRDRegulatory@ct.gov, the attached Compliance Certification Form. Such Compliance Certification shall be completed, signed, and sealed by the Licensee and a Connecticut Licensed Design Professional. If non-compliance is indicated on the form, or the Commissioner has reason to believe the activities and/or structures were conducted in non-compliance with the license, the Commissioner may require the Licensee to submit as-built plans as a condition of this license.

19. Maintenance. The Licensee shall maintain all authorized structures or work in optimal condition or shall remove such structures or facility and restore the affected waters to their pre-work condition. Any such maintenance or removal activity shall be conducted in accordance with applicable law and any additional approvals required by law.

20. No Work After License Expiration. Work conducted after the license expiration date is a violation of the license and may subject the licensee to enforcement action, including penalties, as provided by law.

21. License Transfer. The license is not transferable without prior written authorization of the Commissioner. A request to transfer a license shall be submitted in writing and shall describe the proposed transfer and the reason for such transfer. The Licensee's obligations under the license shall not be affected by the passage of title to the license site to any other person or municipality until such time as a transfer is approved by the Commissioner.

22. Document Submission. Any document required to be submitted to the Commissioner under the license or any contact required to be made with the Commissioner shall, unless otherwise specified in writing by the Commissioner, be directed to:

DEEP.LWRDRegulatory@ct.gov or

² The Work Commencement condition and the need for a Work Commencement Form is not applicable to Flood Management Certification approvals.

Regulatory Section
Land & Water Resources Division
Department of Energy and Environmental Protection
79 Elm Street
Hartford, Connecticut 06106-5127
860-424-3019

23. Date of Document Submission. The date of submission to the Commissioner of any document required by the license shall be the date such document is received by the Commissioner. The date of any notice by the Commissioner under the license, including but not limited to notice of approval or disapproval of any document or other action, shall be the date such notice is personally delivered or the date three (3) days after it is mailed by the Commissioner, whichever is earlier. Except as otherwise specified in the license, the word "day" as used in the license means calendar day. Any document or action which is required by the license to be submitted or performed by a date which falls on a Saturday, Sunday or a Connecticut or federal holiday shall be submitted or performed on or before the next day which is not a Saturday, Sunday, or a Connecticut or federal holiday.

24. Certification of Documents. Any document, including but not limited to any notice, which is required to be submitted to the Commissioner under the license shall be signed by the Licensee and by the individual or individuals responsible for actually preparing such document, each of whom shall certify in writing as follows: "I have personally examined and am familiar with the information submitted in this document and all attachments and certify that based on reasonable investigation, including my inquiry of those individuals responsible for obtaining the information, the submitted information is true, accurate and complete to the best of my knowledge and belief, and I understand that any false statement made in this document or its attachments may be punishable as a criminal offense."

25. Accuracy of Documentation. In evaluating the application for the license, the Commissioner has relied on information and data provided by the Licensee and on the Licensee's representations concerning site conditions, design specifications and the proposed work, including but not limited to representations concerning the commercial, public or private nature of the work or structures, the water-dependency of said work or structures, its availability for access by the general public, and the ownership of regulated structures or filled areas. If such information proves to be false, deceptive, incomplete or inaccurate, the license may be modified, suspended or revoked, and any unauthorized activities may be subject to enforcement action.

26. Limits of Liability. In granting the license, the Commissioner has relied on all representations of the Licensee, including information and data provided in support of the Licensee's application. Neither the Licensee's representations nor the issuance of the license shall constitute an assurance by the Commissioner as to the structural integrity, the engineering feasibility or the efficacy of such design.

27. Reporting of Violations. In the event that the Licensee becomes aware that they did not or may not comply, or did not or may not comply on time, with any provision of this license or

of any document incorporated into the license, the Licensee shall immediately notify the agency contact specified within the license and shall take all reasonable steps to ensure that any noncompliance or delay is avoided or, if unavoidable, is minimized to the greatest extent possible. In so notifying the agency contact, the Licensee shall provide, for the agency's review and written approval, a report including the following information:

- a. the provision(s) of the license that has been violated;
- b. the date and time the violation(s) was first observed and by whom;
- c. the cause of the violation(s), if known;
- d. if the violation(s) has ceased, the duration of the violation(s) and the exact date(s) and times(s) it was corrected;
- e. if the violation(s) has not ceased, the anticipated date when it will be corrected;
- f. steps taken and steps planned to prevent a reoccurrence of the violation(s) and the date(s) such steps were implemented or will be implemented; and
- g. the signatures of the Licensee and of the individual(s) responsible for actually preparing such report.

If the violation occurs outside of normal business hours, the Licensee shall contact the Department of Energy and Environmental Protection Emergency Dispatch at 860-424-3333. The Licensee shall comply with any dates which may be approved in writing by the Commissioner.

28. Revocation/Suspension/Modification. The license may be revoked, suspended, or modified in accordance with applicable law.

29. Other Required Approvals. License issuance does not relieve the Licensee of their obligations to obtain any other approvals required by applicable federal, state and local law.

30. Rights. The license is subject to and does not derogate any present or future property rights or powers of the State of Connecticut, and conveys no property rights in real estate or material nor any exclusive privileges, and is further subject to any and all public and private rights and to any federal, state or local laws or regulations pertinent to the property or activity affected hereby.

31. Condition Conflicts. In the case where a project specific special condition listed on the license differs from, or conflicts with, one of the general conditions listed herein, the project specific special condition language shall prevail. It is the licensee's responsibility to contact the agency contact person listed on the license for clarification if needed prior to conducting any further regulated activities.

SEAVIEW BRIDGEPORT, LLC

STEELPOINTE EAST - STORM OUTFALL #3


DRAWING LIST	
DWG. NO.	DRAWING TITLE
1	COVER SHEET
2	LOCATION MAP
3	TAX ASSESSOR'S MAP
4	COASTAL AREA MANAGEMENT PLAN
5	GRADING AND DRAINAGE AT OUTFALL #3
6	EXISTING CROSS SECTION
7	PROPOSED CROSS SECTION
8	PRE-FORMED SCOUR HOLE AND HW DETAILS
9	HEAD WALL #3 DETAIL
10	DUCK BILL FLAP VALVE AND PERFORATED PIPE DETAILS
11	EROSION CONTROL NOTES
12	SEDIMENT AND EROSION CONTROL DETAIL

PROJECT TIDAL ELEVATIONS (NAVD 88)	
DATUM	ELEVATION (FT.)
HIGH TIDE LINE (HTL)	+6.6
COASTAL JURISTRCTION LINE (CJL)	+5.0
MEAN HIGHER HIGH WATER (MHHW)	+3.48
MEAN HIGH WATER (MHW)	+3.0
NAVD 1988	0.0
NVGD 1929	1.09
MEAN LOW WATER (MLW)	-3.60
MEAN LOWER LOW WATER (MLLW)	-3.84

GENERAL NOTES

1. THESE PLATES ARE FOR CONNECTICUT DEEP PERMIT REVIEW APPLICATION #202502257-SDF, NOT FOR CONSTRUCTION.
2. ELEVATIONS SHOWN ARE ON NORTH AMERICAN VERTICAL DATUM 1988 (NAVD88) UNLESS NOTED OTHERWISE. REFER TO SURVEYS PREPARED BY CABEZAS DEANGEL IS FOR ADDITIONAL INFORMATION.
3. TIDAL ELEVATION DATA TAKEN FROM STATION 8467150, BRIDGEPORT CT (HARBOR) FROM THE NATIONAL OCEANIC AND ATMOSPHERIC ADMINISTRATION TIDES AND CURRENT WEBSITE.

 89 COLONY STREET MERIDEN, CT 06451	PREPARED FOR:	SEAVIEW BRIDGEPORT, LLC 10 EAST MAIN STREET, SUITE 201 BRIDGEPORT, CT 06608		SEAL:	DATE:	REV.:
	PROJECT:	STEELPOINTE EAST STORM OUTFALL 837 SEAVIEW AVENUE BRIDGEPORT, CT 06607		 #14882	6/03/2025	7/29/2025
		DRAWN BY:	TERRENCE M. GALLAGHER		DRAWN BY:	CHECKED BY:
		RM			TG	
		DATUM:	NAVD 88		SCALE:	-
		PROJECT NO.:	16014.40		DRAWING NO.:	SH-1
NOT FOR CONSTRUCTION FOR PERMIT REVIEW ONLY NOT VALID WITHOUT ENGINEER'S SEAL						

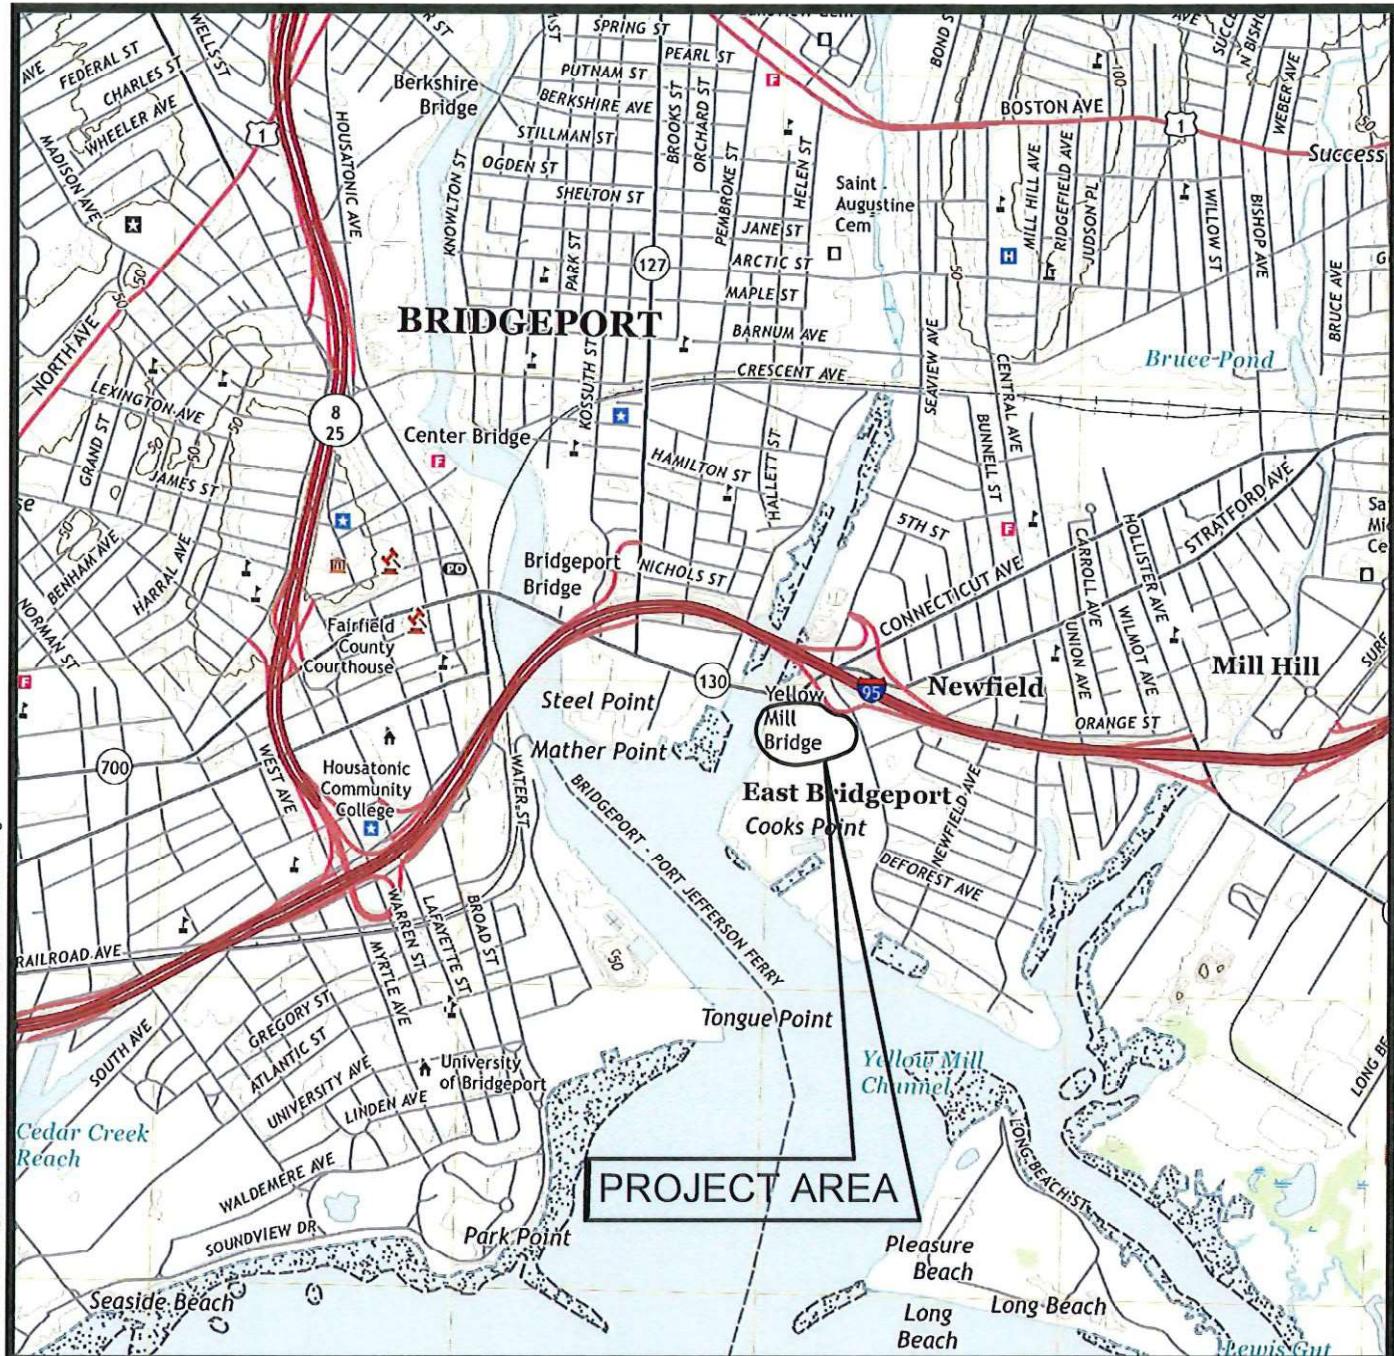


LOCATION MAP

SOURCE:
USGS QUADRANGLE MAP
BRIDGEPORT, CT
7.5 MINUTES SERIES

0 2,000 4,000
SCALE: 1" = 2000'

PROJECT LOCATION:
41° 10' 31.512" N
-73° 10' 26.0976" W

 Luchs CONSULTING ENGINEERS 89 COLONY STREET MERIDEN, CT 06451	PREPARED FOR: SEAVIEW BRIDGEPORT, LLC 10 EAST MAIN STREET, SUITE 201 BRIDGEPORT, CT 06608	SEAL:  LICENSED PROFESSIONAL ENGINEER TERRANCE M. GALLAGHER #14882	DATE: 6/03/2025	REV.: 7/09/2025
	PROJECT: STEELPOINTE EAST STORM OUTFALL 837 SEAVIEW AVENUE BRIDGEPORT, CT 06607	DRAWN BY: RM	CHECKED BY: TG	
NOT FOR CONSTRUCTION FOR PERMIT REVIEW ONLY		DATUM: NAVD 88	SCALE: 1"=2000'	
ALL RIGHTS RESERVED LUCHS CONSULTING ENGINEERS		PROJECT NO.:	DRAWING NO.:	
				16014.40 SH-2

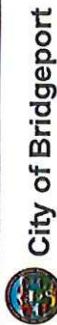

City of Bridgeport

Tax Assessor's Map, 837 Seaview Ave, Bridgeport CT




WES:1984, Web, Mercator,Auxiliary_Sphere
Created by Connecticut Metropolitan Council of Governments

This map is a user generated static output from an internet mapping site and is for reference only. Data layers that appear on this map may or may not be accurate, current, or otherwise reliable.
THIS MAP IS NOT TO BE USED FOR NAVIGATION



TAX ASSESSOR'S MAP
SCALE: 1" = 400'


PREPARED FOR:	SEAVIEW BRIDGEPORT, LLC 10 EAST MAIN STREET, SUITE 201 BRIDGEPORT, CT 06608		
PROJECT:	STEELPOINTE EAST STORM OUTFALL 837 SEAVIEW AVENUE BRIDGEPORT, CT 06607		
NOT FOR CONSTRUCTION ALL RIGHTS RESERVED LUCHS CONSULTING ENGINEERS		NOT FOR PERMIT REVIEW ONLY	
SEAL:			
DATE:	6/03/2025	REV.:	07/29/2025
DRAWN BY:	RM	CHECKED BY:	TG
DATE:	6/03/2025	SCALE:	1" = 400'
PROJECT NO.:	NAVD 88	DRAWING NO.:	16014.40
NOTES:	NOT VALID WITHOUT ENGINEER'S SEAL		

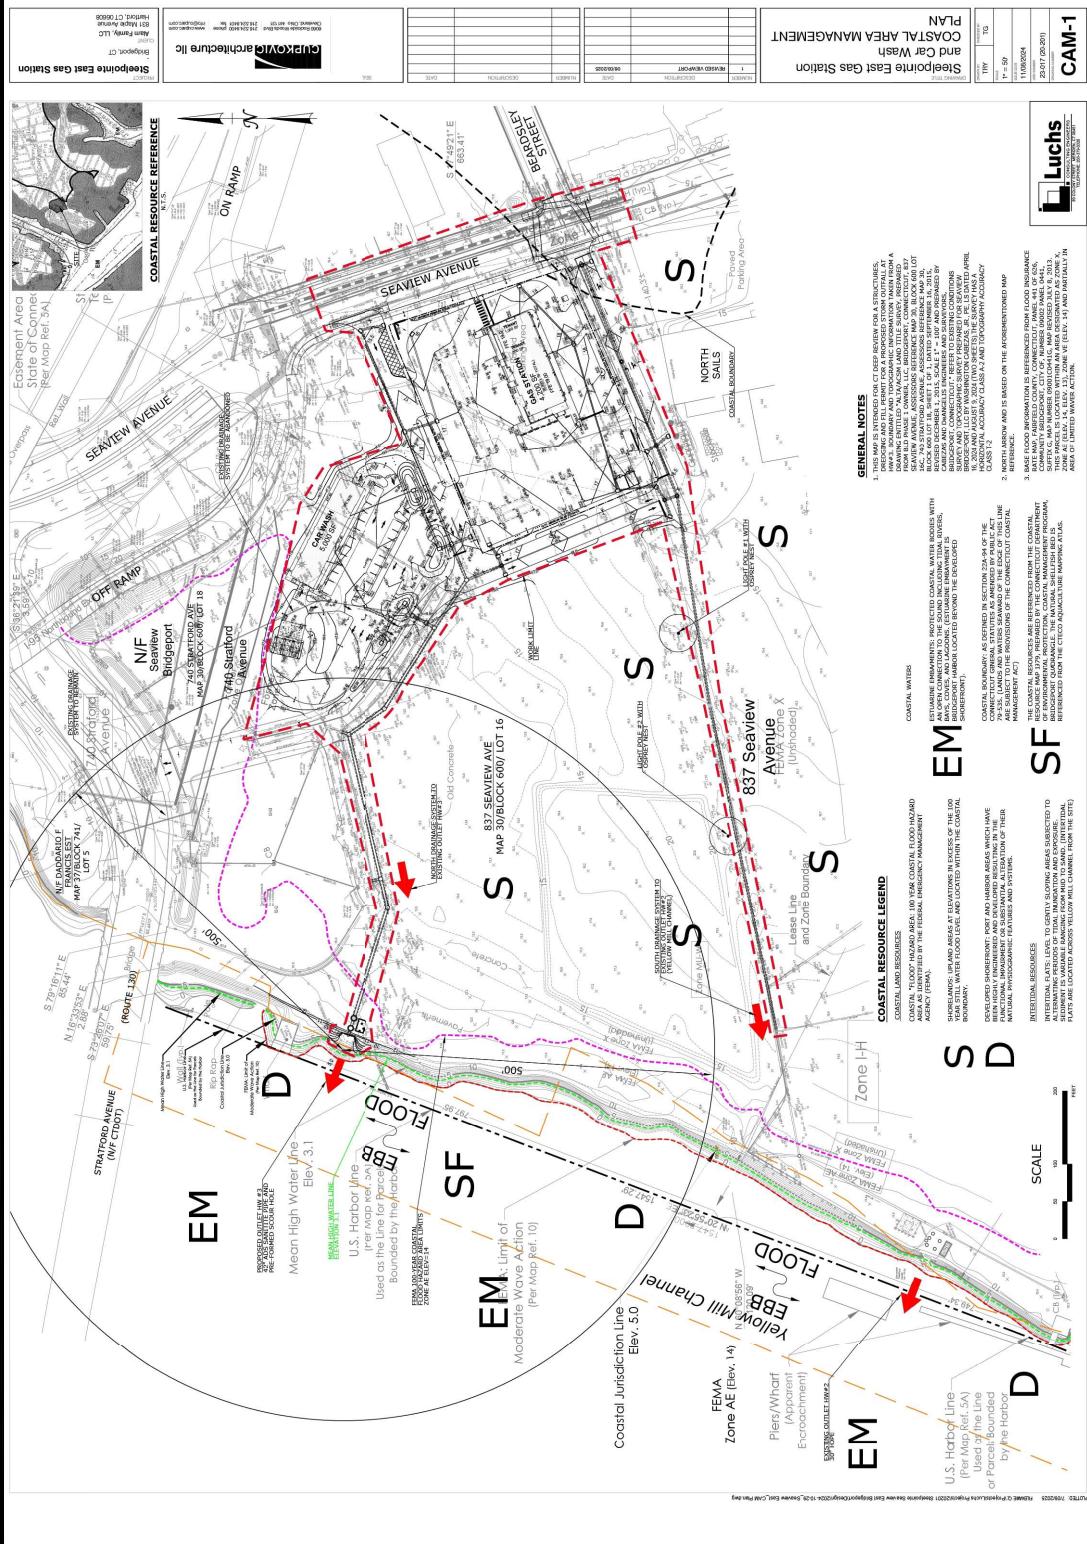

COASTAL AREA MANAGEMENT PLAN
ORIGINAL SCALE 1"=50'
(REDUCED)

PREPARED FOR:		SEAVIEW BRIDGEPORT, LLC 10 EAST MAIN STREET, SUITE 201 BRIDGEPORT, CT 06608	
PROJECT:		STEELPOINTE EAST STORM OUTFALL 837 SEAVIEW AVENUE BRIDGEPORT, CT 06607	
		NOT FOR CONSTRUCTION FOR PERMIT REVIEW ONLY	
 Luchs <small>CONSULTING ENGINEERS</small>		89 COLONY STREET MERIDEN, CT 06451 ALL RIGHTS RESERVED LUCHS CONSULTING ENGINEERS	

DATE:	6/03/2025	REV.:	07/29/2025
DRAWN BY:	RM	CHECKED BY:	TG
DATUM:	NAVD 88	SCALE:	
PROJECT NO.:	16014.40	DRAWING NO.:	SH-4
WITHOUT ENGINEER'S SEAL			

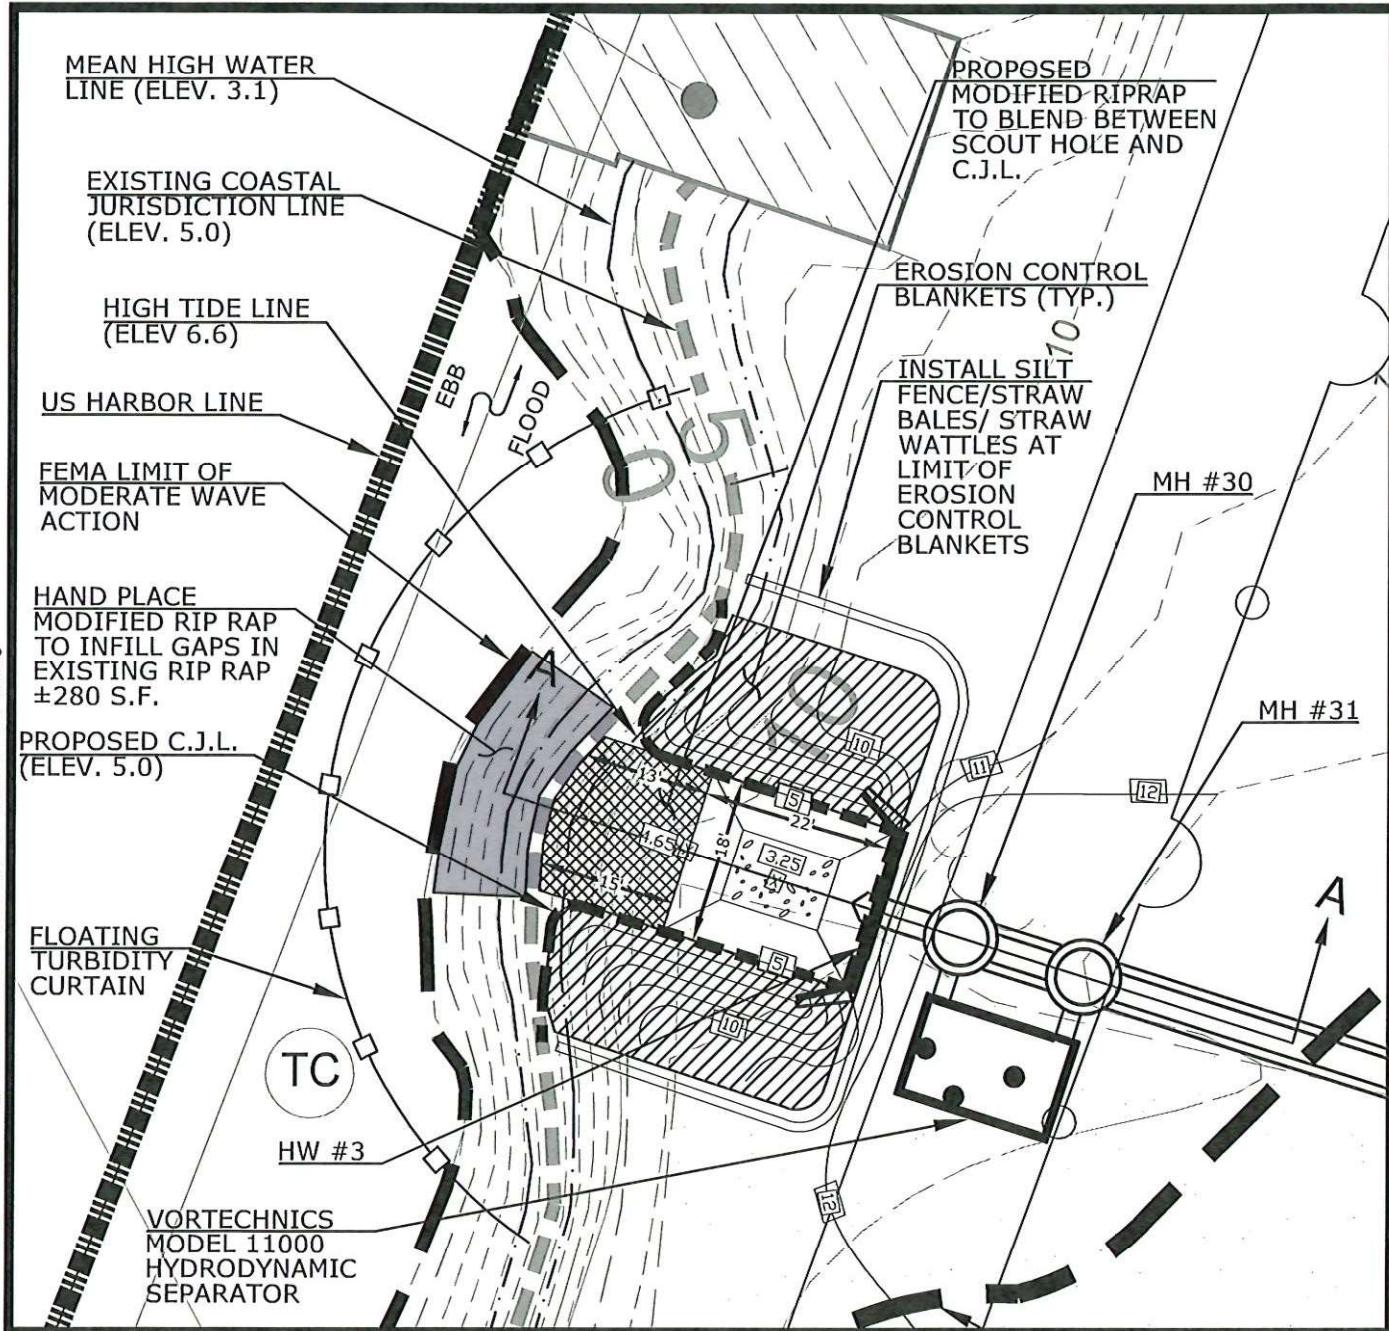


15-

EXISTING GRADE

10-

EXISTING SLOPE RIPRAP
(TYP.)

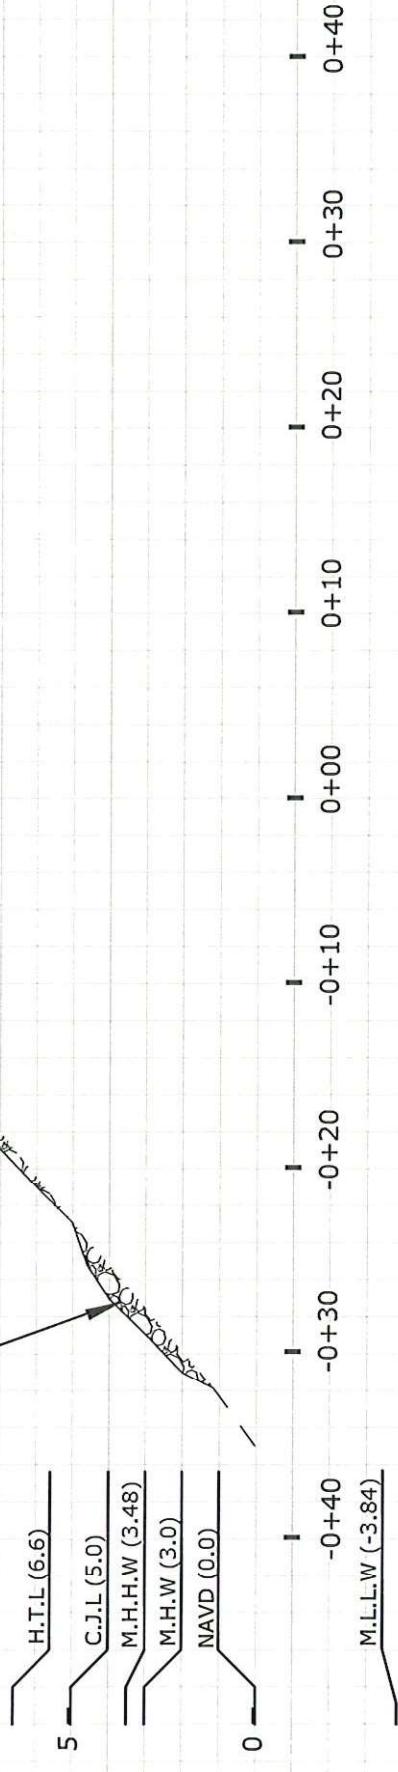


STORM OUTFALL- EXISTING CROSS SECTION

SCALE : 1"=10' HORIZONTAL AND 1"=5' VERTICAL

SEAL		DATE: 6/03/2025	REV.: 07/29/2025
STATE OF CONNECTICUT TERMINAL OFFICE M. GALLAGHER #14882		DRAWN BY: RM	CHECKED BY: TG
LICENSING BOARD #14882		SCALE: 1" = 10' H 1" = 5' V	PROJECT NO.: NAVD 88
LUCHS CONSULTING ENGINEERS 89 COLONY STREET MERIDEN, CT 06451		NOT FOR CONSTRUCTION FOR PERMIT REVIEW ONLY	NOT VALID WITHOUT ENGINEERS SEAL DRAFTING NO.: 16014.40 DRAWING NO.: SH-6
ALL RIGHTS RESERVED LUCHS CONSULTING ENGINEERS			


Handwritten signature over the seal and stamp area.

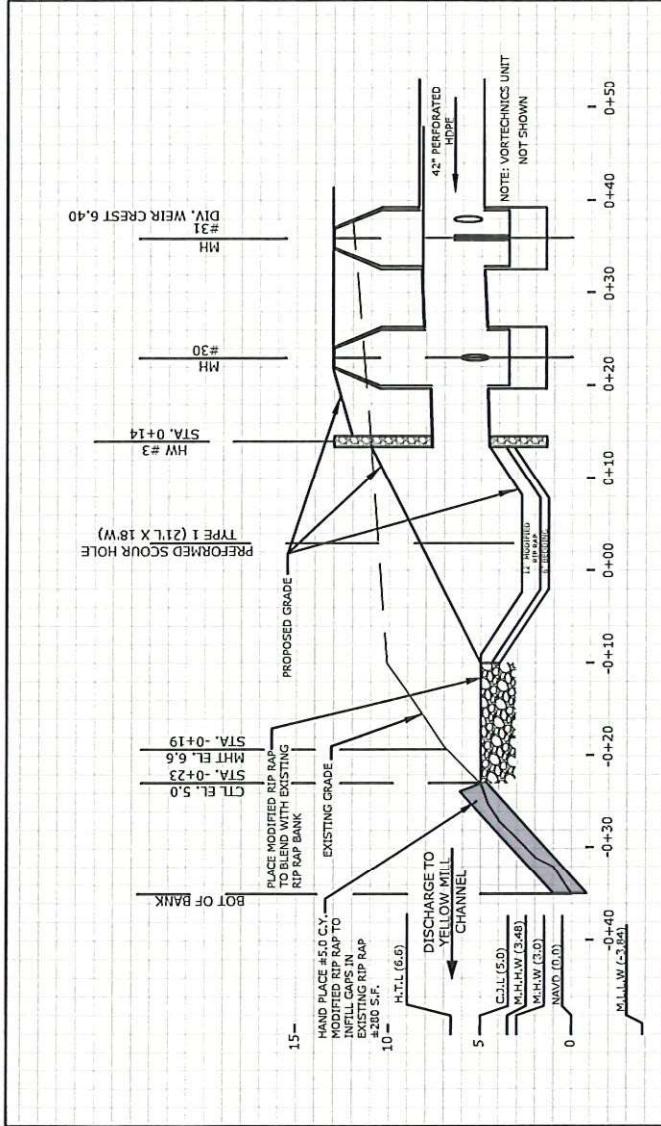

STORM OUTFALL- HEAD WALL #3-SECTION VIEW A-A

ORIGINAL SCALE : 1"=10' HORIZONTAL AND 1"=5' VERTICAL
NEW REDUCED SCALE : 1"=20' HORIZONTAL AND 1"=10' VERTICAL




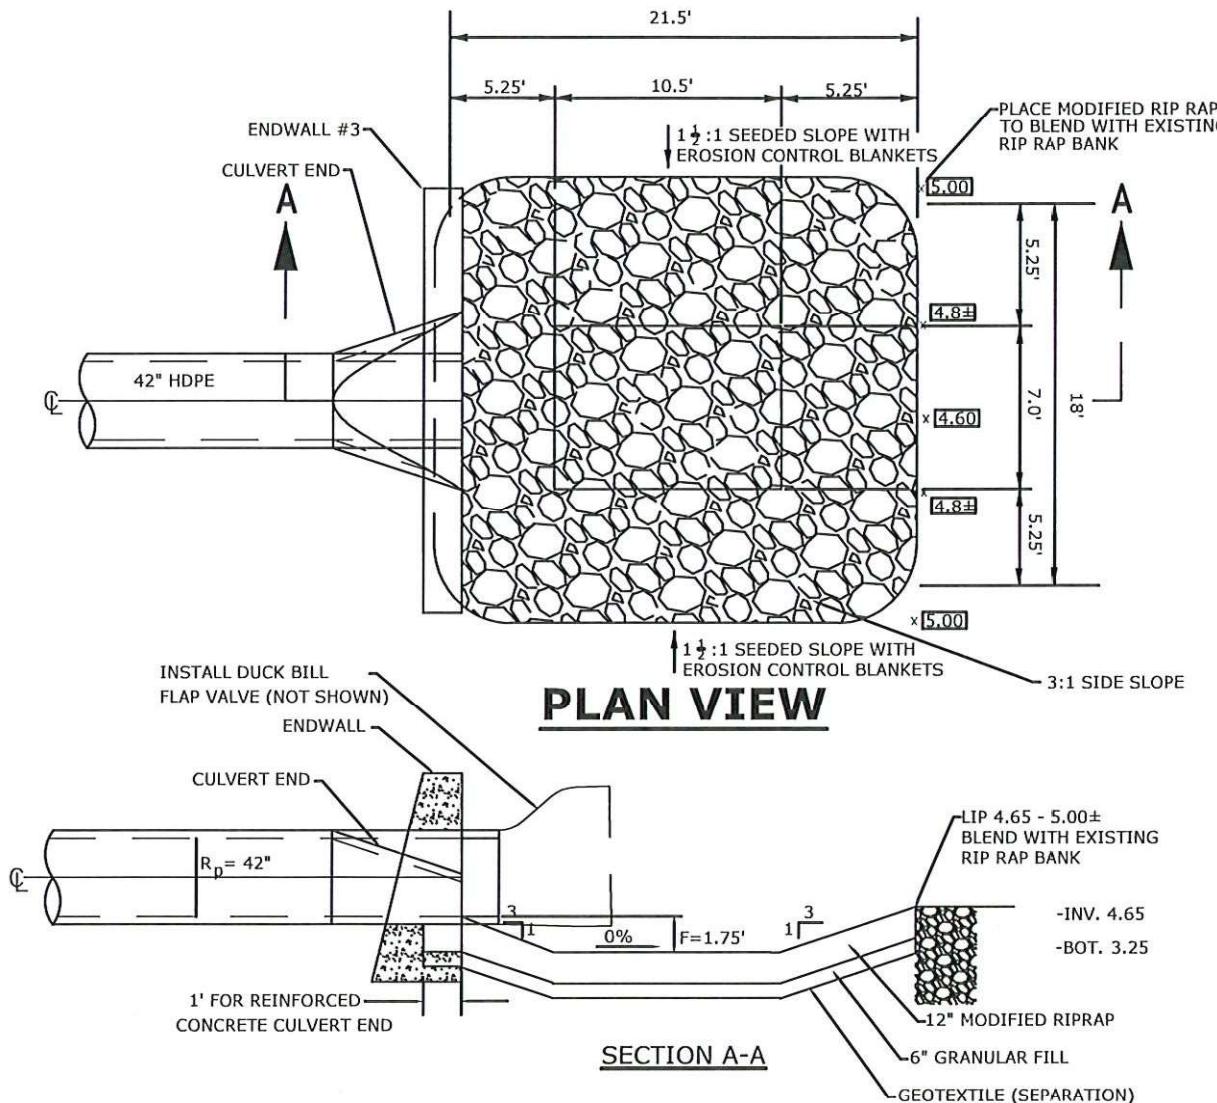

PREFORMED SCOUR HOLE -TYPE I- AT HEAD WALL #3

NOT TO SCALE

 <p>Luchs CONSULTING ENGINEERS</p> <p>89 COLONY STREET MERIDEN, CT 06451</p>	<p>PREPARED FOR:</p> <p>SEAVIEW BRIDGEPORT, LLC 10 EAST MAIN STREET, SUITE 201 BRIDGEPORT, CT 06608</p>	 <p>STATE OF CONNECTICUT TERRENCE M. GALLAGHER #14882 PROFESSIONAL ENGINEER LICENCED</p> <p><i>[Handwritten signature over seal]</i></p>	<p>DATE:</p> <p>6/03/2025</p>	<p>REV.:</p> <p>7/29/2025</p>
	<p>PROJECT:</p> <p>STEELPOINTE EAST STORM OUTFALL 837 SEAVIEW AVENUE BRIDGEPORT, CT 06607</p>		<p>DRAWN BY:</p> <p>RM</p>	<p>CHECKED BY:</p> <p>TG</p>
			<p>DATUM:</p> <p>NAVD 88</p>	<p>SCALE:</p>
			<p>PROJECT NO.:</p> <p>16014.40</p>	<p>DRAWING NO.:</p> <p>SH-8</p>
ALL RIGHTS RESERVED LUCHS CONSULTING ENGINEERS	NOT FOR CONSTRUCTION FOR PERMIT REVIEW ONLY	NOT VALID WITHOUT ENGINEER'S SEAL		

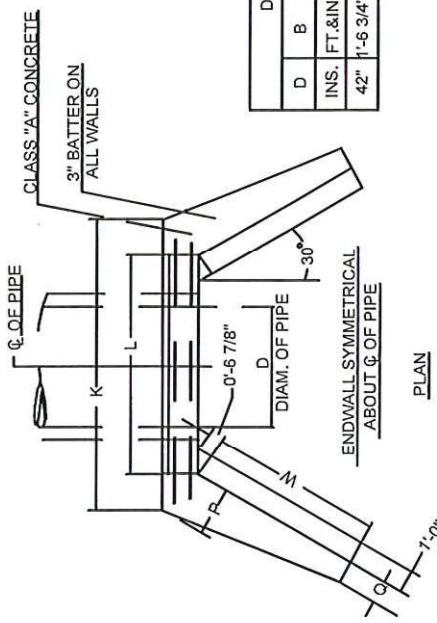


DIMENSIONS AND QUANTITIES FOR ONE WING TYPE ENDWALL

D	B	C	G	H	K	L	P	Q	R	W	VOL.
INS.	FT.&IN	FT.&IN	FT.&IN	FT.&IN	FT.&IN	FT.&IN	FT.&IN	FT.&IN	FT.&IN	FT.&IN	CU.YD.
42"	1'-6 3/4"	2'-0"	3'-3"	7'-0"	19'-1"	16'-10"	11'-5 3/4"	0'-9 3/4"	4'-0"	6'-7 3/4"	4.8

NOTE

ALL CONSTRUCTION DIMENSIONS ARE NOMINAL.
WHEN ONE ENDWALL IS TO BE USED FOR TWO PIPES, THE DIMENSIONS OF THAT
ENDWALL SHALL CONFORM TO THAT REQUIRED FOR THE LARGER PIPE, EXCEPT
THE DIMENSION "L" SHALL BE INCREASED BY THE OUTSIDE DIAMETER OF THE
SMALLER PIPE PLUS ONE FOOT.

THESE ENDWALLS WILL BE USED ONLY AT LOCATIONS WHERE THEY WILL NOT
BE A HAZARD TO VEHICLES THAT RUN OFF THE ROAD. IN NO CASE WILL THE
LOCATION OF THESE ENDWALLS BE LESS THAN 30' FROM THE EDGE OF THE
TRAVELED WAY.

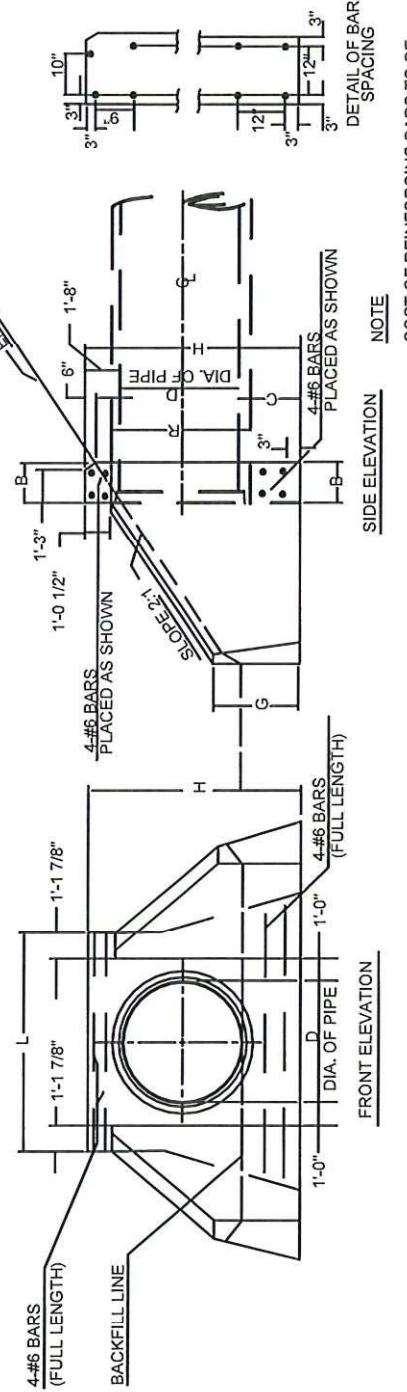


NOTE
COST OF REINFORCING BARS TO BE
INCLUDED IN THE CONTRACT UNIT
PRICE FOR CLASS "A" CONCRETE.

STANDARD WING TYPE ENDWALL-AT HEAD WALL #3

NOT TO SCALE

SEAL:	PREPARED FOR: SEAVIEW BRIDGEPORT, LLC 10 EAST MAIN STREET, SUITE 201 BRIDGEPORT, CT 06608	DATE: 6/03/2025	REV.: 07/29/2025
PROJECT: Luchs CONSULTING ENGINEERS	TERMINATE M. GALLAGHER #14882 LICENSED PROFESSIONAL ENGINEER NOT FOR CONSTRUCTION	DRAWN BY: RM	CHECKED BY: TG
89 COLONY STREET MERIDEN, CT 06451	STATE OF CONNECTICUT #14882 LICENSED PROFESSIONAL ENGINEER NOT FOR CONSTRUCTION	SATUM: NAVD 88	SCALE: SH-9
ALL RIGHTS RESERVED LUCHS CONSULTING ENGINEERS	FOR PERMIT REVIEW ONLY	PROJECT NO.: 16014.40	DRAWING NO.: SH-9

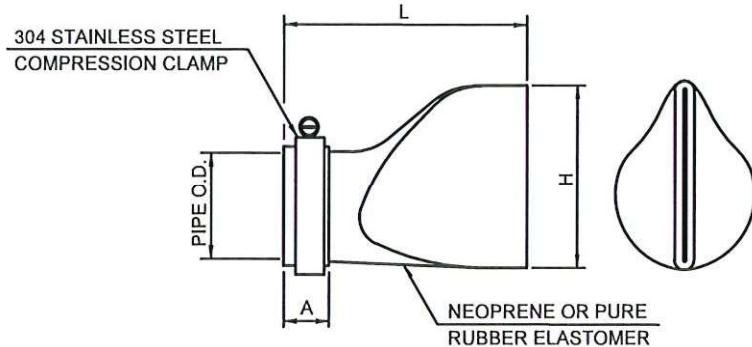


PIPE SIZE	PIPE O.D.	CUFF SLIP-ON LENGTH (A)	MAX. LENGTH (L)	MAX. HEIGHT (H)
36" RCP	42"+/-	10"	59 1/2"	70 1/2"
42" RCP	48"+/-	10"	71"	91"
42" HDPE	48"+/-	12"	67"	69"

NOTE:

1. INSTALL TIDEFLEX TF-1 (48" OD.) DUCK BILL CHECK VALVE BY RED VALVE, ON END OF 42" SANITITE PIPE IN ACCORDANCE WITH MANUFACTURERS REQUIREMENTS.


DUCK BILL FLAP VALVE

NOT TO SCALE

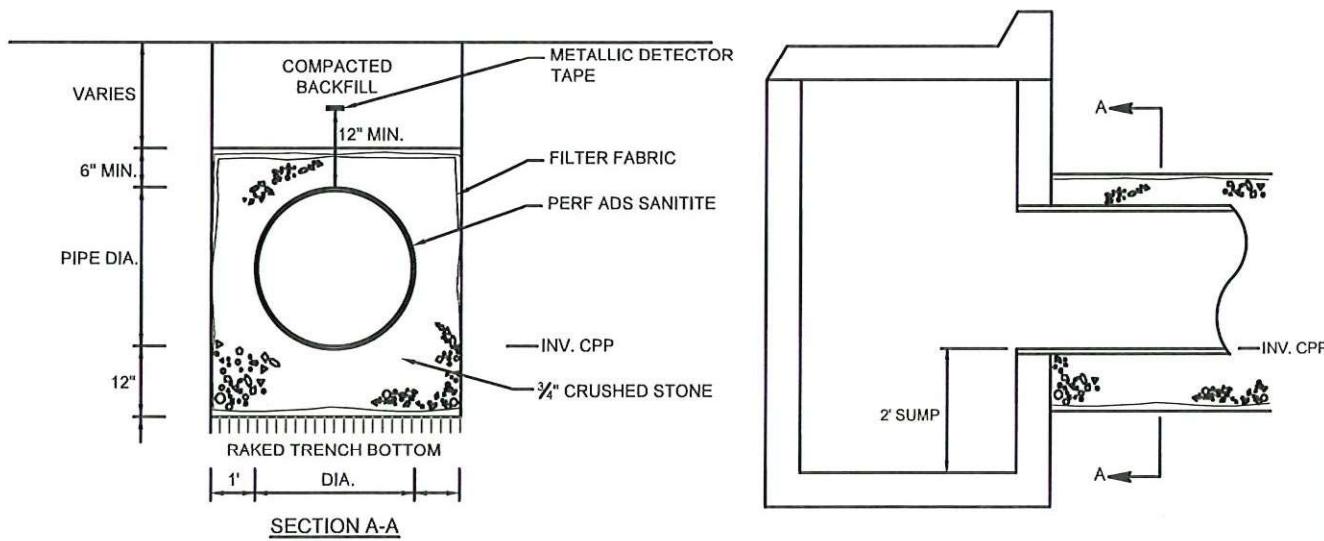

PERFORATED HDPE CPP PIPE (TYP.)




NOT TO SCALE

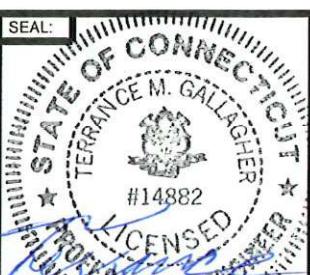 Luchs CONSULTING ENGINEERS 89 COLONY STREET MERIDEN, CT 06451	PREPARED FOR: SEAVIEW BRIDGEPORT, LLC 10 EAST MAIN STREET, SUITE 201 BRIDGEPORT, CT 06608	SEAL:  TERRENCE M. GALLAGHER #14882 LICENCED NOTARIAL PRACTICER NOT VALID WITHOUT ENGINEER'S SEAL	DATE: 6/03/2025	REV.: 7/29/2025
PROJECT: STEELPOINTE EAST STORM OUTFALL 837 SEAVIEW AVENUE BRIDGEPORT, CT 06607			DRAWN BY: RM	CHECKED BY: TG
ALL RIGHTS RESERVED LUCHS CONSULTING ENGINEERS	NOT FOR CONSTRUCTION FOR PERMIT REVIEW ONLY		DATUM: NAVD 88	SCALE: SH-10
			PROJECT NO.: 16014.40	DRAWING NO.: SH-10

EROSION CONTROL NOTES:

1. INSTALL FLOATING TURBIDITY CURTAIN IN HARBOR AROUND OUTFALL #3 CONSTRUCTION AREA. THIS IS THE ONLY CONSTRUCTION ACTIVITY IN BRIDGEPORT HARBOR.
2. ENDWALL #3 AND THE 18'X21' MODIFIED PRE-FORMED SCOUR HOLE HAVE BEEN RELOCATED EAST APPROXIMATELY 14' FROM THE EARLIER PROPOSED LOCATIONS. RELOCATE ANY EXISTING STORM PIPE AND MANHOLES PREVIOUSLY CONSTRUCTED ACCORDINGLY. THE EW AND SCOUR HOLE SHALL BE CONSTRUCTED "IN-THE-DRY" CONDITION, DURING LOW TIDE PERIODS, PER PERMIT REQUIREMENTS. DO NOT DEWATER EXCAVATIONS INTO HARBOR. ANY DEWATERING, IF NECESSARY, TO BE DISCHARGED TO A DIRT BAG AND TEMPORARY PUMP DISCHARGE BASIN LOCATED IN UPLAND AREAS.
3. CONSTRUCT PRE-FORMED SCOUR HOLE AS SHOWN. LIMIT OF EXCAVATION ON HARBOR BANK TO DAYLIGHT AT ELEVATION 5.0 COASTAL JURISDICTION LINE (C.J.L.). BLEND END OF PROPOSED SCOUR HOLE WITH EXISTING RIP RAP HARBOR BANK USING MODIFIED RIP RAP.
4. GRADE SIDE SLOPES ABOVE ELEVATION 5.0 AT SCOUR HOLE AND BANK AT 1 1/2:1 SLOPE. REMOVE RANDOM DEBRIS, CONCRETE, REBAR, PAVEMENT, ETC. PRIOR TO PLACING 6" OF TOPSOIL ON SLOPE AND SEEDING.
5. INSTALL EXCEL CC-4 REGULAR EROSION CONTROL BLANKET (ECB) BY WESTERN EXCELSIOR, [HTTPS://WESTERNEXCELSIOR.COM](https://WESTERNEXCELSIOR.COM) (1-866-540-9810). EXCEL CC-4 IS A DOUBLE NET SYNTHETIC/COCONUT BLANKET, 9 OZ./SY, MEDIUM DUTY, 36 MONTH LONGEVITY. ANCHOR ENDS OF ROLLS AT RIP RAP AND BLANKET LIMITS AS SHOWN. INSTALL BLANKET PER MANUFACTURER'S RECOMMENDATIONS. STAPLE PATTERN 3 STAPLES/SY MINIMUM.
6. SEED SIDE SLOPES AND ALL DISTURBED AREAS AROUND OUTFALL AND HARBOR WITH NEW ENGLAND COASTAL SALT TOLERANT GRASS MIX BY NEW ENGLAND WETLAND PLANTS, INC., WWW.NEWP.COM (1-413-548-8000). SEED AT 35LBS/ACRE, OR HEAVIER RATE, PRIOR TO INSTALLING ECB. WATER SEEDED AREAS WEEKLY, OR AS NECESSARY, UNTIL FULL GERMINATION. OVERSEED AS NECESSARY, TO COVER ANY BARE AREAS. REMOVE ANY WEEDS OR INVASIVE PLANTS AS PERMANENT COVER GROWS IN.
7. INSTALL SILT FENCE, STRAW BALES, OR STRAW WATTLES ALONG UPPER LIMITS OF ECB.
8. REMOVE FLOATING TURBIDITY CURTAIN AND ALL TEMPORARY EROSION CONTROLS AT THE END OF CONSTRUCTION AFTER ALL UPLAND AREAS ARE FULLY LANDSCAPED AND STABILIZED.

 Luchs CONSULTING ENGINEERS 89 COLONY STREET MERIDEN, CT 06451	PREPARED FOR:	SEAL:		DATE:	REV.:
	10 EAST MAIN STREET, SUITE 201 BRIDGEPORT, CT 06608	 #14882 TERRENCE M. GALLAGHER PROFESSIONAL ENGINEER		6/03/2025	7/29/2025
PROJECT:	STEELPOINTE EAST STORM OUTFALL 837 SEAVIEW AVENUE BRIDGEPORT, CT 06607	DRAWN BY:	RM	CHECKED BY:	TG
ALL RIGHTS RESERVED LUCHS CONSULTING ENGINEERS	NOT FOR CONSTRUCTION FOR PERMIT REVIEW ONLY	DATUM:	NAVD 88	SCALE:	
	NOT VALID WITHOUT ENGINEER'S SEAL	PROJECT NO.:	16014.40	DRAWING NO.:	SH-11

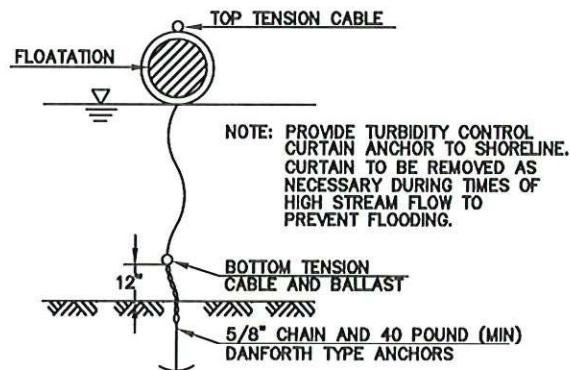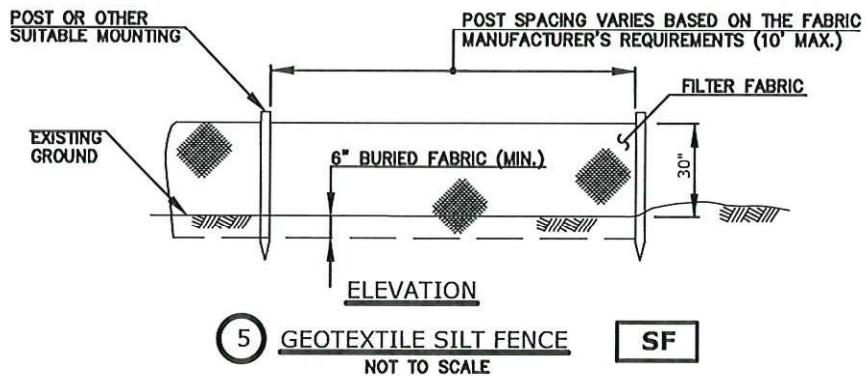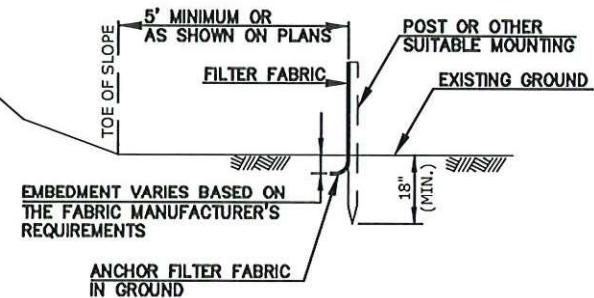

7 TURBIDITY CONTROL CURTAIN

NOT TO SCALE

TC

SEDIMENT AND EROSION
CONTROL DETAILS



PREPARED FOR:
SEAVIEW BRIDGEPORT, LLC
10 EAST MAIN STREET, SUITE 201
BRIDGEPORT, CT 06608

PROJECT:
STEELPOINTE EAST
STORM OUTFALL
837 SEAVIEW AVENUE
BRIDGEPORT, CT 06607

ALL RIGHTS RESERVED
LUCHS CONSULTING ENGINEERS

NOT FOR CONSTRUCTION
FOR PERMIT REVIEW ONLY



DATE:	REV.:
6/03/2025	7/29/2025
DRAWN BY:	CHECKED BY:
RM	TG
DATUM:	SCALE:
NAVD 88	
PROJECT NO.:	DRAWING NO.:
16014.40	SH-12

Land Record Filing*

To: DO NOT FILE

Signature and

NOTE: Due to the electronic delivery of this license and the legal requirement to have a live signature on this document, the “Land Record Filing” as detailed in General Condition #1 will be sent to the Licensee via U.S. Mail for the Licensee to file with the city/town clerk.

Date:

Subject: _____
License # _____

If you have any questions pertaining to this matter, please contact the Land & Water Resources Division at 860-424-3019.

Return to:

Land & Water Resources Division
State of Connecticut
Department of Energy & Environmental Protection
79 Elm Street
Hartford, CT 06106-5127

*The Licensee shall file the Land Record Filing on the land records of the municipality in which the subject property is located not later than thirty (30) days after license issuance pursuant to Connecticut General Statutes (CGS) Section 22a-363g. A copy of the Notice with a stamp or other such proof of filing with the municipality shall be submitted to the Commissioner no later than sixty (60) days after license issuance.



LWRD Work Commencement Form

To: DEEP.LWRDRegulatory@ct.gov or
Regulatory Section
Department of Energy and Environmental Protection
Land & Water Resources Division
79 Elm Street
Hartford, CT 06106-5127

Licensee Name: Seaview Bridgeport, LLC

Municipality in which the project is occurring: Bridgeport

DEEP License No(s): 202502257-SDF

CONTRACTOR(s):

1 Name: _____
Address: _____
Telephone: _____
E-mail: _____

2 Name: _____
Address: _____
Telephone: _____
E-mail: _____

3 Name: _____
Address: _____

Date Contractor(s) received a copy
of the license and approved plans: _____

EXPECTED DATE OF COMMENCEMENT OF WORK: _____

EXPECTED DATE OF COMPLETION OF WORK: _____

LICENSEE: _____
(Signature) _____ (Date) _____



Compliance Certification Form

The following certification must be signed by the licensee working in consultation with a Connecticut-licensed design professional and must be submitted to the address indicated at the end of this form within ninety (90) days of completion of the authorized work.

1. Licensee Name:	Seaview Bridgeport, LLC
DEEP License Number(s):	202502257-SDF
Municipality in which project is occurring:	Bridgeport
2. Check one:	
(a)	<input type="checkbox"/> "I certify that the final site conditions and / or structures are in general conformance with the approved site plans". Identify and describe any deviations and attach to this form.
(b)	<input type="checkbox"/> "The final site conditions and / or structures are not in general conformance with the approved site plans. The enclosed "as-built" plans note the modifications".
3. "I understand that any false statement in this certification is punishable as a criminal offence under section 53a-157b of the General Statutes and under any other applicable law."	
Signature of Licensee	Date
Name of Licensee (print or type)	
Signature of CT-Licensed Design Professional	Date
Name of CT-Licensed Design Professional (print or type)	
Professional License Number (if applicable)	Affix Stamp Here
<ul style="list-style-type: none"> As-built plans shall include: elevations or tidal datums, as applicable, and structures, including any proposed elevation views and cross sections included in the approved license plans. Such as-built plans shall be the original ones and be signed and sealed by an engineer, surveyor or architect, as applicable, who is licensed in the State of Connecticut. The Licensee will be notified by staff of the Land and Water Resources Division (LWRD) if further compliance review is necessary. Lack of response by LWRD staff does not imply compliance. 	
Submit this completed form to :	
DEEP.LWRDRegulatory@ct.gov or	
Regulatory Section	
Department of Energy and Environmental Protection	
Land & Water Resources Division	
79 Elm Street	
Hartford, CT 06106-5127	