



Connecticut Department of Energy and Environmental Protection License*

Flood Management Certification & Exemption Request Approval

Licensee(s):	CT Dept. of Housing
Licensee Address(s):	505 Hudson Ave.
	Hartford, CT 06106
License Numb <mark>er(s):</mark>	202400895-FME
Municipality:	Naugatuck
Project Description:	Brownfield remediation and residential/retail construction
Project Address/Location:	0 Maple Ave., Naugatuck
Waters:	Long Meadow Pond Brook, Naugatuck River
Authorizing CT Statute(s)	CGS Section 25-68b to h, with approved exemption from 25-
and/or Federal Law:	68d.(b)(4)
Applicable Regulations of	25-68h-1 to 3
CT State Agencies:	
Agency Contact:	Land & Water Resources Division,
	Bureau of Water Protection & Land Reuse, 860-424-3019
License Expiration:	Five (5) years from the date of issuance of this license.
Project Site Plan Set:	"Proposed Site Plan Documents for Pennrose, LLC, Proposed
	Development Parcel 'B', Maple Street, Borough of Naugatuck,
	New Haven County, Connecticut," 13 Sheets, Prepared by Bohler
	Engineering, and last revised 04/12/2024.
License Enclosures:	LWRD General Conditions; Site Plan Set

*Connecticut's Uniform Administrative Procedure Act defines License to include, "the whole or part of any agency permit, certificate, approval, registration, charter or similar form of permission required by law . . ."

An Affirmative Action/Equal Opportunity Employer



Authorized Activities:

The Licensee is hereby authorized to conduct the following work as described in application # 202400895 and as depicted on any site plan sheets / sets cited herein:

- 1. Funding of some or all of the following activities within the floodplain:
 - a. Soil Management Activities Material Management of 3,750 cubic yards of soil for the preparation of building foundations, 75% reuse and 25% import/delivery of clean fill, transportation & disposal of any excavated, contaminated soils, asbestos monitoring, Potential TSCA Disposal Contingency;
 - b. Post Remediation Groundwater Monitoring Installation of Groundwater Monitoring Wells, Groundwater Sampling, Groundwater Reporting;
 - c. Construction of Phase I mixed use development, including:
 - i. 60 residential units and retail space within a single four-story building;
 - ii. Reconfigure streets, sidewalks, and parking;
 - iii. Landscape improvements;
 - iv. Construct new utilities and stormwater management systems.

Failure to comply with the terms and conditions of this license shall subject the Licensee and / or the Licensee's contractor(s) to enforcement actions and penalties as provided by law.

This license is subject to the following Terms and Conditions:

1. License Enclosure(s) and Conditions. The Licensee shall comply with all applicable terms and conditions as may be stipulated within the License Enclosure(s) listed above.

Issued under the authority of the Commissioner of Energy and Environmental Protection on:

Date

Emma Cimino Deputy Commissioner Department of Energy & Environmental Protection



LWRD General Conditions

- 1. Land Record Filing (for Structures Dredging & Fill, Tidal Wetlands, Certificate of *Permission*, and Long Island Sound General Permit Licenses only). The Licensee shall file the Land Record Filing on the land records of the municipality in which the subject property is located not later than thirty (30) days after license issuance pursuant to Connecticut General Statutes (CGS) Section 22a-363g. A copy of the Notice with a stamp or other such proof of filing with the municipality shall be submitted to <u>DEEP.LWRDRegulatory@ct.gov</u> no later than sixty (60) days after license issuance. If a Land Record Filing form is not enclosed and the work site is not associated with an upland property, no filing is required.
- 2. Contractor Notification. The Licensee shall give a copy of the license and its attachments to the contractor(s) who will be carrying out the authorized activities prior to the start of construction and shall receive a written receipt for such copy, signed and dated by such contractor(s). The Licensee's contractor(s) shall conduct all operations at the site in full compliance with the license and, to the extent provided by law, may be held liable for any violation of the terms and conditions of the license. At the work site, the contractor(s) shall, whenever work is being performed, have on site and make available for inspection a copy of the license and the authorized plans.
- **3.** Work Commencement¹. Not later than two (2) weeks prior to the commencement of any work authorized herein, the Licensee shall submit to <u>DEEP.LWRDRegulatory@ct.gov</u>, on the Work Commencement Form attached hereto, the name(s) and address(es) of all contractor(s) employed to conduct such work and the expected date for commencement and completion of such work, if any.
 - For water diversion activities authorized pursuant to 22a-377(c)-1 of the Regulations of Connecticut State Agencies, the Licensee shall also notify the Commissioner in writing two weeks prior to initiating the authorized diversion.
 - For emergency activities authorized pursuant Connecticut General Statutes Section 22a-6k, the Licensee shall notify the Commissioner, in writing, of activity commencement at least one (1) day prior to construction and of activity completion no later than five (5) days after conclusion.
- 4. For Coastal Licenses Only License Notice. The Licensee shall post the first page of the License in a conspicuous place at the work area while the work authorized therein is undertaken.
- **5.** Unauthorized Activities. Except as specifically authorized, no equipment or material, including but not limited to, fill, construction materials, excavated material or debris, shall be deposited, placed or stored in any wetland or watercourse on or off-site. The Licensee may not

An Affirmative Action/Equal Opportunity Employer



¹ The Work Commencement condition and the need for a Work Commencement Form is not applicable to Flood Management Certification approvals.

conduct work within wetlands or watercourses other than as specifically authorized, unless otherwise authorized in writing by the Commissioner. Tidal wetlands means "wetland" as defined by section 22a-29 and "freshwater wetlands and watercourses" means "wetlands" and "watercourses" as defined by section 22a-38.

- 6. Management of Materials. Any materials removed from the site shall be managed in accordance with all federal, state, and local requirements, including Chapter 446K Water Pollution Control, Chapter 445 Hazardous Waste, and Chapter 446d Solid Waste of the Connecticut General Statutes.
- **7. Unconfined Instream Work.** Unless otherwise noted in a condition of the license, the following conditions apply to projects in non-coastal waters:
 - Unconfined instream work is limited to the period June 1 through September 30.
 - Confinement of a work area by cofferdam techniques using sand bag placement, sheet pile installation (vibratory method only), portadam, or similar confinement devices is allowed any time of the year. The removal of such confinement devices is allowed any time of the year.
 - Once a work area has been confined, in-water work within the confined area is allowed any time of the year.
 - The confinement technique used shall completely isolate and protect the confined area from all flowing water. The use of silt boom/curtain or similar technique as a means for confinement is prohibited.
- 8. For State Actions Only Material or Equipment Storage in the Floodplain. Unless approved by a Flood Management Exemption, the storage of any materials at the site which are buoyant, hazardous, flammable, explosive, soluble, expansive, radioactive, or which could in the event of a flood be injurious to human, animal or plant life, below the elevation of the five-hundred (500) year flood is prohibited. Any other material or equipment stored at the site below said elevation by the Licensee or the Licensee's contractor must be firmly anchored, restrained or enclosed to prevent flotation. The quantity of fuel stored below such elevation for equipment used at the site shall not exceed the quantity of fuel that is expected to be used by such equipment in one day. In accordance with the licensee's Flood Contingency Plan, the Licensee shall remove equipment and materials from the floodplain during periods when flood warnings have been issued or are anticipated by a responsible federal, state or local agency. It shall be the Licensee's responsibility to obtain such warnings when flooding is anticipated.
- **9. Temporary Hydraulic Facilities for Water Handling.** If not reviewed and approved as a part of the license application, temporary hydraulic facilities shall be designed by a qualified professional and in accordance with the *Connecticut Guidelines for Soil Erosion and Sediment Control*, the 2004 Connecticut Stormwater Quality Manual, or the Department of Transportation's ConnDOT Drainage Manual, as applicable. Temporary hydraulic facilities may include channels, culverts or bridges which are required for haul roads, channel relocations, culvert installations, bridge construction, temporary roads, or detours.
- 10. Excavated Materials. Unless otherwise authorized, all excavated material shall be staged and

managed in a manner which prevents additional impacts to wetlands and watercourses.

- **11. Best Management Practices.** The Licensee shall not cause or allow pollution of any wetlands or watercourses, including pollution resulting from sedimentation and erosion. In constructing or maintaining any authorized structure or facility or conducting any authorized activity, or in removing any such structure or facility, the Licensee shall employ best management practices to control storm water discharges, to prevent erosion and sedimentation, and to otherwise prevent pollution of wetlands and other waters of the State. For purposes of the license, "pollution" means "pollution" as that term is defined by CGS section 22a-423. Best Management Practices include, but are not limited, to practices identified in the *Connecticut Guidelines for Soil Erosion and Sediment Control* as revised, 2004 Connecticut Stormwater Quality Manual, Department of Transportation's ConnDOT Drainage Manual as revised, and the Department of Transportation Standard Specifications as revised.
- 12. In-Water Work Vessel Staging and Storage. (for Structures Dredging & Fill, Tidal *Wetlands, Certificate of Permission*, and *Long Island Sound General Permit* Licenses only). For any barge, vessel, skiff or floating work platform ("work vessels") utilized in the execution of the work authorized herein, the Licensee shall ensure that such work vessels:
 - do not rest on, or come in contact with, the substrate at any time, unless specifically authorized in the license.
 - are not stored over intertidal flats, submerged aquatic vegetation or tidal wetland vegetation or in a location that interferes with navigation. In the event any work vessel is grounded, no dragging or prop dredging shall occur to free it.
- **13. Work Site Restoration.** Upon completion of any authorized work, the Licensee shall restore all areas temporarily impacted by construction, or used as a staging area or accessway in connection with such work, to their condition prior to the commencement of such work.
- **14. Inspection.** The Licensee shall allow any representative of the Commissioner to inspect the project location at reasonable times to ensure that work is being or has been conducted in accordance with the terms and conditions of this license.

15. Change of Use. (Applies only if a use is specified within the License "Project Description")

- a. The work specified in the license is authorized solely for the purpose set forth in the license. No change in purpose or use of the authorized work or facilities as set forth in the license may occur without the prior written approval of the Commissioner. The Licensee shall, prior to undertaking or allowing any change in use or purpose from that which is authorized by this license, request permission from the Commissioner for such change. Said request shall be in writing and shall describe the proposed change and the reason for the change.
- b. A change in the form of ownership of any structure authorized herein from a rental/lease commercial marina to a wholly-owned common interest community or dockominium may constitute a change in purpose as specified in paragraph (a) above.
- **16. De Minimis Alteration.** The Licensee shall not deviate from the authorized activity without prior written approval from the Commissioner. The Licensee may request a de minimis change

to any authorized structure, facility, or activity. A de minimis alteration means a change in the authorized design, construction or operation that individually and cumulatively has minimal additional environmental impact and does not substantively alter the project as authorized.

- For diversion activities authorized pursuant to 22a-377(c)-2 of the Regulations of Connecticut State Agencies, a de minimis alteration means an alteration which does not significantly increase the quantity of water diverted or significantly change the capacity to divert water.
- 17. Extension Request. The Licensee may request an extension of the license expiration date. Such request shall be in writing and shall be submitted to <u>DEEP.LWRDRegulatory@ct.gov</u> at least thirty (30) days prior to the license expiration. Such request shall describe the work done to date, what work still needs to be completed, and the reason for such extension. The Commissioner may extend the expiration date of this license for a period of up to one year, in order for the Licensee to complete the authorized activities. It shall be at the Commissioner's sole discretion to grant or deny such request. No more than three (3) one-year extensions will be granted under this license.
- **18. Compliance Certification².** Not later than 90 days after completion of the authorized work, the Licensee shall prepare and submit to <u>DEEP.LWRDRegulatory@ct.gov</u>, the attached Compliance Certification Form. Such Compliance Certification shall be completed, signed, and sealed by the Licensee and a Connecticut Licensed Design Professional. If non-compliance is indicated on the form, or the Commissioner has reason to believe the activities and/or structures were conducted in non-compliance with the license, the Commissioner may require the Licensee to submit as-built plans as a condition of this license.
- **19. Maintenance.** The Licensee shall maintain all authorized structures or work in optimal condition or shall remove such structures or facility and restore the affected waters to their prework condition. Any such maintenance or removal activity shall be conducted in accordance with applicable law and any additional approvals required by law.
- **20. No Work After License Expiration.** Work conducted after the license expiration date is a violation of the license and may subject the licensee to enforcement action, including penalties, as provided by law.
- **21. License Transfer.** The license is not transferable without prior written authorization of the Commissioner. A request to transfer a license shall be submitted in writing and shall describe the proposed transfer and the reason for such transfer. The Licensee's obligations under the license shall not be affected by the passage of title to the license site to any other person or municipality until such time as a transfer is approved by the Commissioner.
- **22. Document Submission.** Any document required to be submitted to the Commissioner under the license or any contact required to be made with the Commissioner shall, unless otherwise specified in writing by the Commissioner, be directed to:

DEEP.LWRDRegulatory@ct.gov or

² The Work Commencement condition and the need for a Work Commencement Form is not applicable to Flood Management Certification approvals.

Regulatory Section Land & Water Resources Division Department of Energy and Environmental Protection 79 Elm Street Hartford, Connecticut 06106-5127 860-424-3019

- **23. Date of Document Submission.** The date of submission to the Commissioner of any document required by the license shall be the date such document is received by the Commissioner. The date of any notice by the Commissioner under the license, including but not limited to notice of approval or disapproval of any document or other action, shall be the date such notice is personally delivered or the date three (3) days after it is mailed by the Commissioner, whichever is earlier. Except as otherwise specified in the license, the word "day" as used in the license means calendar day. Any document or action which is required by the license to be submitted or performed by a date which falls on a Saturday, Sunday or a Connecticut or federal holiday shall be submitted or performed on or before the next day which is not a Saturday, Sunday, or a Connecticut or federal holiday.
- **24. Certification of Documents.** Any document, including but not limited to any notice, which is required to be submitted to the Commissioner under the license shall be signed by the Licensee and by the individual or individuals responsible for actually preparing such document, each of whom shall certify in writing as follows: "I have personally examined and am familiar with the information submitted in this document and all attachments and certify that based on reasonable investigation, including my inquiry of those individuals responsible for obtaining the information, the submitted information is true, accurate and complete to the best of my knowledge and belief, and I understand that any false statement made in this document or its attachments may be punishable as a criminal offense."
- **25.** Accuracy of Documentation. In evaluating the application for the license, the Commissioner has relied on information and data provided by the Licensee and on the Licensee's representations concerning site conditions, design specifications and the proposed work, including but not limited to representations concerning the commercial, public or private nature of the work or structures, the water-dependency of said work or structures, its availability for access by the general public, and the ownership of regulated structures or filled areas. If such information proves to be false, deceptive, incomplete or inaccurate, the license may be modified, suspended or revoked, and any unauthorized activities may be subject to enforcement action.
- **26. Limits of Liability.** In granting the license, the Commissioner has relied on all representations of the Licensee, including information and data provided in support of the Licensee's application. Neither the Licensee's representations nor the issuance of the license shall constitute an assurance by the Commissioner as to the structural integrity, the engineering feasibility or the efficacy of such design.
- **27. Reporting of Violations.** In the event that the Licensee becomes aware that they did not or may not comply, or did not or may not comply on time, with any provision of this license or


of any document incorporated into the license, the Licensee shall immediately notify the agency contact specified within the license and shall take all reasonable steps to ensure that any noncompliance or delay is avoided or, if unavoidable, is minimized to the greatest extent possible. In so notifying the agency contact, the Licensee shall provide, for the agency's review and written approval, a report including the following information:

- a. the provision(s) of the license that has been violated;
- b. the date and time the violation(s) was first observed and by whom;
- c. the cause of the violation(s), if known;
- d. if the violation(s) has ceased, the duration of the violation(s) and the exact date(s) and times(s) it was corrected;
- e. if the violation(s) has not ceased, the anticipated date when it will be corrected;
- f. steps taken and steps planned to prevent a reoccurrence of the violation(s) and the date(s) such steps were implemented or will be implemented; and
- g. the signatures of the Licensee and of the individual(s) responsible for actually preparing such report.

If the violation occurs outside of normal business hours, the Licensee shall contact the Department of Energy and Environmental Protection Emergency Dispatch at 860-424-3333. The Licensee shall comply with any dates which may be approved in writing by the Commissioner.

- **28. Revocation/Suspension/Modification.** The license may be revoked, suspended, or modified in accordance with applicable law.
- **29. Other Required Approvals.** License issuance does not relieve the Licensee of their obligations to obtain any other approvals required by applicable federal, state and local law.
- **30. Rights.** The license is subject to and does not derogate any present or future property rights or powers of the State of Connecticut, and conveys no property rights in real estate or material nor any exclusive privileges, and is further subject to any and all public and private rights and to any federal, state or local laws or regulations pertinent to the property or activity affected hereby.
- **31. Condition Conflicts.** In the case where a project specific special condition listed on the license differs from, or conflicts with, one of the general conditions listed herein, the project specific special condition language shall prevail. It is the licensee's responsibility to contact the agency contact person listed on the license for clarification if needed prior to conducting any further regulated activities.

LOCATION OF SITE: MAPLE STREET & OLD FIREHOUSE ROAD, BOROUGH OF NAUGATUCK **NEW HAVEN COUNTY, CT** MAP #AM13, BLOCK #2W1

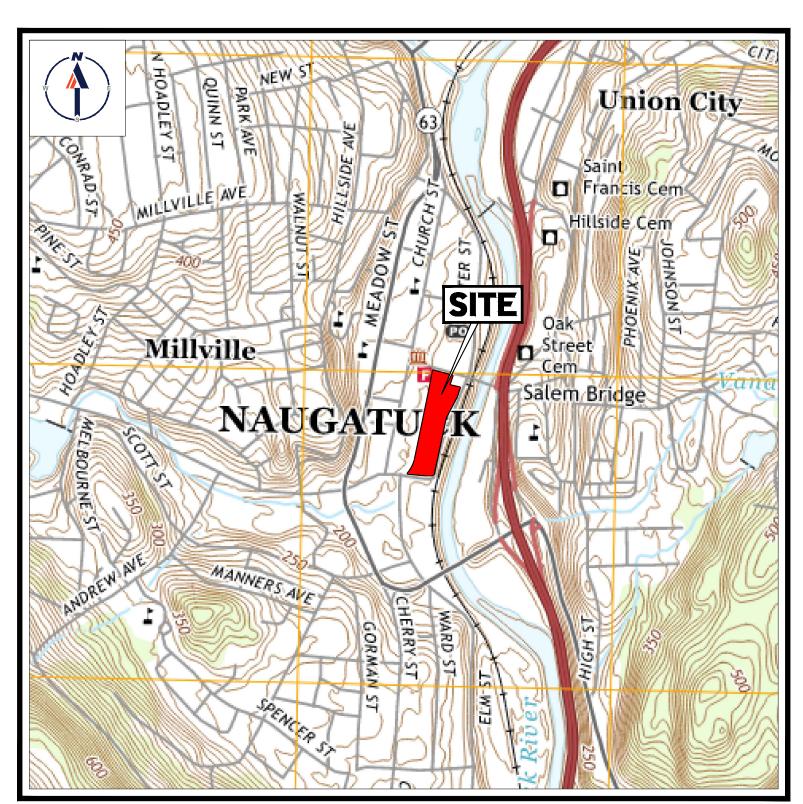


USGS MAP SCALE: 1" = 1,000' SOURCE: NAUGATUCK QUADRANGLE

PROPOSED SITE PLAN DOCUMENTS

– FOR –

PENNROSE, LLC

PROPOSED MIXED USE DEVELOPMENT

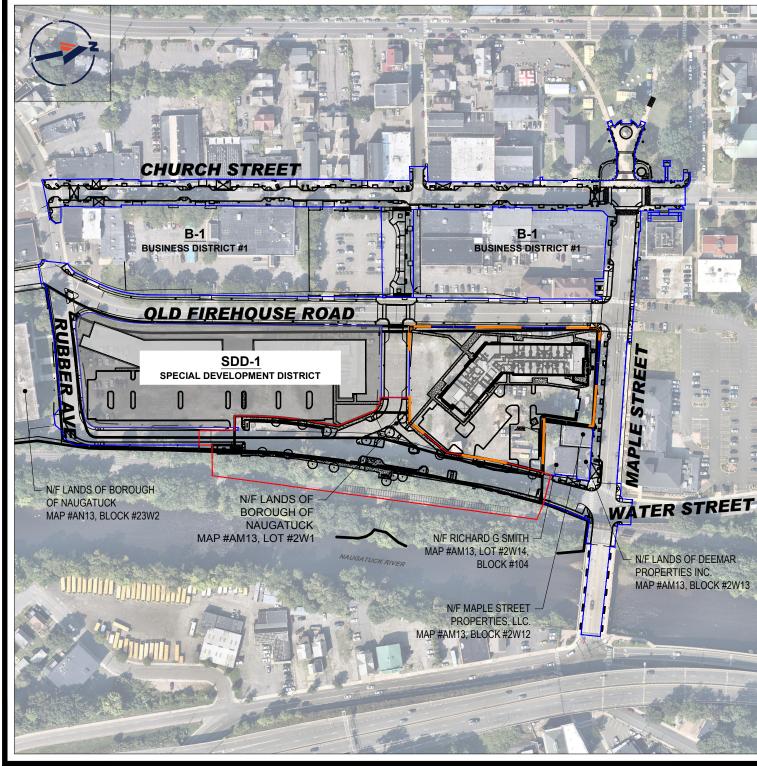

SITE MAP SCALE: 1" = 200' SOURCE: 2022 MICROSOFT CORPORATION



PREPARED BY

REFERENCES

- . BOUNDARY & TOPOGRAPHIC INFORMATION: CONTROL POINT ASSOCIATES, INC. 352 TURNPIKE ROAD, SOUTHBOROUGH, MA 01772 DATE: 12/20/2022 REVISED: 02/16/2023
- 2. <u>ARCHITECTURAL PLAN:</u> WALLACE, ROBERTS & TODD, LLC 1700 MARKET STREET, PHILADELPHIA, PA, 19103 DATE: 09/25/2023
- 3. ADDITIONAL REFERENCES: A. CONNECTICUT DEPARTMENT OF TRANSPORTATION NAUGATUCK RAILROAD STATION DATE: 09/2023
- B. KLEINFELDER, INC. 1500 MAIN STREET, SPRINGFIELD, MA 01115 DATE: 10/10/2023

* THE ABOVE REFERENCED DOCUMENTS ARE INCORPORATED BY REFERENCE AS PART OF THESE PLANS, HOWEVER, BOHLER ENGINEERING DOES NOT CERTIFY THE ACCURACY OF THE WORK REFERENCED OR DERIVED FROM THESE DOCUMENTS, BY OTHERS.

DRAWING SHEET INDE	X
--------------------	---

SHEET INDEX	
SHEET TITLE	NUMBER
COVER SHEET	C-101
GENERAL NOTES SHEET	C-102
EXISTING CONDITIONS PLAN	C-201
SITE LAYOUT PLAN	C-301
GRADING & DRAINAGE PLAN	C-401
UTILITY PLAN	C-501
EROSION & SEDIMENT CONTROL PLAN	C-601
EROSION & SEDIMENT CONTROL NOTES & DETAILS	C-602
FIRE TRUCK TURN EXHIBIT	C-801
SITE DETAIL SHEET	C-901
SITE DETAIL SHEET	C-902
UTILITY DETAIL SHEET	C-903
UTILITY DETAIL SHEET	C-904
REFERENCE PLANS	
LANDSCAPE PLAN	BY OTHERS
LIGHTING PLAN	BY OTHERS



REVISION 9 - 04/12/2024

GENERAL NOTES

1.	THESE PLANS ARE SOLELY BASED ON INFORMATION THE OWNER AND OTHERS PROVIDED TO BOHLER ENGINEERING, (HEREIN "BOHLER") PRIOR TO THE DATE ON WHICH THE ENGINEER OF RECORD AND BOHLER PREPARED THESE PLANS. THE CONTRACTOR MUST FIELD VERIFY ALL EXISTING CONDITIONS AND IMMEDIATELY NOTIFY BOHLER, IN WRITING, IF ANY ACTUAL SITE CONDITIONS DIFFER FROM THOSE SHOWN ON THESE PLANS, OR IF THE PROPOSED WORK CONFLICTS WITH	1.	TH Af BE
	ANY OTHER SITE FEATURES.	2.	Τŀ

- THE CONTRACTOR MUST STRICTLY COMPLY WITH THESE NOTES AND ALL SPECIFICATIONS/REPORTS CONTAINED HEREIN. THE CONTRACTOR MUST ENSURE THAT ALL SUBCONTRACTORS FULLY AND COMPLETELY CONFORM TO AND COMPLY WITH THESE REQUIREMENTS, THESE NOTES, AND THE REQUIREMENTS ARTICULATED IN THE NOTES CONTAINED IN ALL THE OTHER DRAWINGS THAT COMPRISE THE PLAN SET OF DRAWINGS. ADDITIONAL NOTES AND SPECIFIC PLAN NOTES MAY BE FOUND ON THE INDIVIDUAL PLANS. THESE GENERAL NOTES APPLY TO THIS ENTIRE DOCUMENT PACKAGE. IT IS THE CONTRACTOR'S RESPONSIBILITY TO REVIEW ALL CONSTRUCTION CONTRACT DOCUMENTS INCLUDING, BUT NOT LIMITED TO, ALL OF THE DRAWINGS AND SPECIFICATIONS ASSOCIATED WITH THE PROJECT WORK SCOPE, PRIOR TO THE INITIATION AND COMMENCEMENT OF CONSTRUCTION.
- PRIOR TO THE COMMENCEMENT OF CONSTRUCTION, THE CONTRACTOR MUST CONFIRM WITH THE ENGINEER OF RECORD AND BOHLER THAT THE LATEST EDITION OF THE DOCUMENTS AND/OR REPORTS REFERENCED WITHIN THE PLAN REFERENCES ARE BEING USED FOR CONSTRUCTION. THIS IS THE CONTRACTOR'S SOLE AND COMPLETE RESPONSIBILITY.
- PRIOR TO THE COMMENCEMENT OF CONSTRUCTION, THE CONTRACTOR MUST ENSURE THAT ALL REQUIRED PERMITS AND APPROVALS HAVE BEEN OBTAINED. NO CONSTRUCTION OR FABRICATION IS TO BEGIN UNTIL THE CONTRACTOR HAS RECEIVED AND THOROUGHLY REVIEWED THE CONDITIONS OF APPROVAL TO ALL PLANS AND OTHER DOCUMENTS REVIEWED AND APPROVED BY THE PERMITTING AUTHORITIES AND HAS ALSO CONFIRMED THAT ALL NECESSARY AND REQUIRED PERMITS HAVE BEEN OBTAINED. THE CONTRACTOR MUST HAVE COPIES OF ALL PERMITS AND APPROVALS ON SITE AT ALL TIMES.

THE CONTRACTOR MUST ENSURE THAT ALL WORK IS PERFORMED IN ACCORDANCE WITH THESE PLANS. SPECIFICATIONS/REPORTS AND CONDITIONS OF

- APPROVAL, AND ALL APPLICABLE REQUIREMENTS, RULES, REGULATIONS, STATUTORY REQUIREMENTS, CODES, LAWS AND STANDARDS OF ALL GOVERNMENTAL ENTITIES WITH JURISDICTION OVER THIS PROJECT, AND ALL PROVISIONS IN AND CONDITIONS OF THE CONSTRUCTION CONTRACT WITH THE OWNER/DEVELOPER INCLUDING ALL EXHIBITS, ATTACHMENTS AND ADDENDA TO SAME PRIOR TO THE COMMENCEMENT OF CONSTRUCTION, THE CONTRACTOR MUST COORDINATE THE BUILDING LAYOUT BY CAREFULLY REVIEWING THE MOST
- CURRENT ARCHITECTURAL, CIVIL AND STRUCTURAL CONSTRUCTION DOCUMENTS (INCLUDING, BUT NOT LIMITED TO, MECHANICAL, ELECTRICAL, PLUMBING AND FIRE SUPPRESSION PLANS, WHERE APPLICABLE). THE CONTRACTOR MUST IMMEDIATELY NOTIFY OWNER, ARCHITECT AND ENGINEER OF RECORD AND BOHLER, IN WRITING. OF ANY CONFLICTS. DISCREPANCIES OR AMBIGUITIES WHICH EXIST BETWEEN THESE PLANS AND ANY OTHER PLANS THAT COMPRISE THE CONSTRUCTION DOCUMENTS.
- CONTRACTOR MUST REFER TO AND ENSURE COMPLIANCE WITH THE APPROVED ARCHITECTURAL/BUILDING PLANS OF RECORD FOR EXACT LOCATIONS AND DIMENSIONS OF ENTRY/EXIT POINTS, ELEVATIONS, PRECISE BUILDING DIMENSIONS, AND EXACT BUILDING UTILITY LOCATIONS THE CONTRACTOR MUST FIELD VERIEVALL DIMENSIONS AND MEASUREMENTS SHOWN ON THESE PLANS, PRIOR TO THE COMMENCEMENT OF CONSTRUCTION
- THE CONTRACTOR MUST IMMEDIATELY NOTIFY ENGINEER OF RECORD AND BOHLER. IN WRITING, IF ANY CONFLICTS, DISCREPANCIES, OR AMBIGUITIES EXIST PRIOR TO PROCEEDING WITH CONSTRUCTION. NO EXTRA COMPENSATION WILL BE PAID TO THE CONTRACTOR FOR WORK WHICH HAS TO BE RE-DONE OR REPAIRED DUE TO DIMENSIONS, MEASUREMENTS OR GRADES SHOWN INCORRECTLY ON THESE PLANS PRIOR TO BOTH (A) THE CONTRACTOR GIVING ENGINEER OF RECORD AND BOHLER WRITTEN NOTIFICATION OF SAME AND (B) ENGINEER OF RECORD AND BOHLER. THEREAFTER, PROVIDING THE CONTRACTOR WITH WRITTEN AUTHORIZATION TO PROCEED WITH SUCH ADDITIONAL WORK.
- THE CONTRACTOR MUST VERIFY ALL DIMENSIONS AND MEASUREMENTS INCLUDED ON DESIGN DOCUMENTS HEREIN AND MUST NOT SCALE OFF THE DRAWINGS DUE TO POTENTIAL PRINTING INACCURACIES. ALL DIMENSIONS AND MEASUREMENTS ARE TO BE CHECKED AND CONFIRMED BY THE GENERAL CONTRACTOR PRIOR TO PREPARATION OF SHOP DRAWINGS, FABRICATION/ORDERING OF PARTS AND MATERIALS AND COMMENCEMENT OF SITE WORK. SITE PLAN DRAWINGS ARE NOT INTENDED AS SURVEY DOCUMENTS. DIMENSIONS SUPERSEDE GRAPHICAL REPRESENTATIONS. THE CONTRACTOR MUST MAKE CONTRACTOR'S OWN MEASUREMENTS FOR LAYOUT OF IMPROVEMENTS.
- THE OWNER AND CONTRACTOR MUST BE FAMILIAR WITH AND RESPONSIBLE FOR THE PROCUREMENT OF ANY AND ALL CERTIFICATIONS REQUIRED FOR THE ISSUANCE OF A CERTIFICATE OF OCCUPANCY.
- WHEN INCLUDED AS ONE OF THE REFERENCED DOCUMENTS, THE GEOTECHNICAL REPORT, SPECIFICATIONS AND RECOMMENDATIONS SET FORTH THEREIN ARE A PART OF THE REQUIRED CONSTRUCTION DOCUMENTS AND IN CASE OF CONFLICT. DISCREPANCY OR AMBIGUITY. THE MORE STRINGENT REQUIREMENTS AND/OR RECOMMENDATIONS CONTAINED IN: (A) THE PLANS: AND (B) THE GEOTECHNICAL REPORT AND RECOMMENDATIONS. MUST TAKE PRECEDENCE UNLESS SPECIFICALLY NOTED OTHERWISE ON THE PLANS. THE CONTRACTOR MUST NOTIFY THE ENGINEER OF RECORD AND BOHLER, IN WRITING, OF ANY SUCH CONFLICT, DISCREPANCY OR AMBIGUITY BETWEEN THE GEOTECHNICAL REPORT AND PLANS AND SPECIFICATIONS, PRIOR TO PROCEEDING WITH ANY FURTHER WORK IF A GEOTECHNICAL REPORT WAS NOT CREATED. THEN THE CONTRACTOR MUST FOLLOW AND COMPLY WITH ALL OF THE REQUIREMENTS OF ANY AND ALL MUNICIPAL, COUNTY, STATE, AND FEDERAL LAWS AND APPLICABLE SPECIFICATIONS WHICH HAVE JURISDICTION OVER THIS PROJECT.
- ENGINEER OF RECORD AND BOHLER ARE NEITHER LIABLE NOR RESPONSIBLE FOR ANY SUBSURFACE CONDITIONS AND FURTHER. HAS NO LIABILITY FOR ANY HAZARDOUS MATERIALS. HAZARDOUS SUBSTANCES. OR POLLUTANTS ON. ABOUT OR UNDER THE PROPERTY THE CONTRACTOR IS RESPONSIBLE FOR IDENTIFYING WHEN AND WHERE SHORING IS REQUIRED AND FOR INSTALLING ALL SHORING REQUIRED DURING EXCAVATION (TO BE PERFORMED IN ACCORDANCE WITH CURRENT OSHA STANDARDS) AND ANY ADDITIONAL PRECAUTIONS TO BE TAKEN TO ASSURE THE
- STABILITY OF ADJACENT, NEARBY AND CONTIGUOUS STRUCTURES AND PROPERTIES. ALL OF THIS WORK IS TO BE PERFORMED AT CONTRACTOR'S SOLE COST AND EXPENSE THE CONTRACTOR MUST EXERCISE EXTREME CAUTION WHEN PERFORMING ANY WORK ACTIVITIES ADJACENT TO PAVEMENT, STRUCTURES, ETC. WHICH ARE TO REMAIN EITHER FOR AN INITIAL PHASE OF THE PROJECT OR AS PART OF THE FINAL CONDITION. THE CONTRACTOR IS RESPONSIBLE FOR TAKING ALL APPROPRIATE MEASURES REQUIRED TO ENSURE THE STRUCTURAL STABILITY OF SIDEWALKS AND PAVEMENT. UTILITIES. BUILDINGS, AND INFRASTRUCTURE
- DEBRIS MUST NOT BE BURIED ON THE SUBJECT SITE. ALL DEMOLITION AND CONSTRUCTION WASTES, UNSUITABLE EXCAVATED MATERIAL, EXCESS SOIL AND DEBRIS (SOLID WASTE) MUST BE DISPOSED OF IN ACCORDANCE WITH THE REQUIREMENTS OF ANY AND ALL MUNICIPAL, COUNTY, STATE, AND FEDERAL LAWS AND APPLICABLE CODES WHICH HAVE JURISDICTION OVER THIS PROJECT OR OVER THE CONTRACTOR.
- IT IS THE CONTRACTOR'S SOLE RESPONSIBILITY TO MAINTAIN RECORDS TO DEMONSTRATE PROPER AND FULLY COMPLIANT DISPOSAL ACTIVITIES, TO BE PROMPTLY PROVIDED TO THE OWNER UPON REQUEST.

WHICH ARE TO REMAIN. AND TO PROVIDE A SAFE WORK AREA FOR THIRD PARTIES. PEDESTRIANS AND ANYONE INVOLVED WITH THE PROJECT.

- THE CONTRACTOR MUST REPAIR, AT CONTRACTOR'S SOLE COST, ALL DAMAGE DONE TO ANY NEW OR EXISTING CONSTRUCTION OR PROPERTY DURING THE COURSE OF CONSTRUCTION, INCLUDING BUT NOT LIMITED TO DRAINAGE, UTILITIES, PAVEMENT, STRIPING, CURB, ETC, AND MUST BEAR ALL COSTS ASSOCIATED WITH SAME TO INCLUDE, BUT NOT BE LIMITED TO, REDESIGN, RE-SURVEY, RE-PERMITTING AND CONSTRUCTION. THE CONTRACTOR IS RESPONSIBLE FOR AND MUST REPLACE ALL SIGNAL INTERCONNECTION CABLE, WIRING CONDUITS, AND ANY UNDERGROUND ACCESSORY EQUIPMENT DAMAGED DURING CONSTRUCTION AND MUST BEAR ALL COSTS ASSOCIATED WITH SAME. THE REPAIR OF ANY SUCH NEW OR EXISTING CONSTRUCTION OR PROPERTY MUST RESTORE SUCH CONSTRUCTION OR PROPERTY TO A CONDITION EQUIVALENT TO OR BETTER THAN THE CONDITIONS PRIOR TO COMMENCEMENT OF THE STRUCTION, AND IN CONFORMANCE WITH APPLICABLE CODES, LAWS, RULES, REGULATIONS, STATUTORY REQUIREMENTS AND STATUTES. THE CONTRACTOR MUST BEAR ALL COSTS ASSOCIATED WITH SAME. THE CONTRACTOR MUST, PROMPTLY, DOCUMENT ALL EXISTING DAMAGE AND NOTIFY, IN WRITING, THE OWNER AND THE CONSTRUCTION MANAGER PRIOR TO THE START OF CONSTRUCTION.
- THE ENGINEER OF RECORD AND BOHLER ARE NOT RESPONSIBLE FOR AND HAVE NO CONTRACTUAL, LEGAL OR OTHER RESPONSIBILITIES FOR JOB SITE SAFETY JOB SITE SUPERVISION, OR ANYTHING RELATED TO SAME. THE ENGINEER OF RECORD AND BOHLER HAVE NOT BEEN RETAINED TO PERFORM OR TO BE RESPONSIBLE FOR JOB SITE SAFETY, SAME BEING WHOLLY OUTSIDE OF ENGINEER OF RECORD'S AND BOHLER SERVICES AS RELATED TO THE PROJECT. THE ENGINEER OF RECORD AND BOHLER ARE NOT RESPONSIBLE TO IDENTIFY OR REPORT ANY JOB SITE SAFETY ISSUES OR ANY JOB SITE CONDITIONS, AT ANY TIME. THE CONTRACTOR MUST IMMEDIATELY IDENTIFY IN WRITING, TO THE ENGINEER OF RECORD AND BOHLER , ANY DISCREPANCIES THAT MAY OR COULD AFFECT
- THE PUBLIC SAFETY, HEALTH OR GENERAL WELFARE, OR PROJECT COST. IF THE CONTRACTOR PROCEEDS WITH CONSTRUCTION WITHOUT PROVIDING PROPER WRITTEN NOTIFICATION AS DESCRIBED ABOVE, IT WILL BE AT THE CONTRACTOR'S OWN RISK AND, FURTHER, THE CONTRACTOR MUST INDEMNIFY, DEFEND AND HOLD HARMLESS THE ENGINEER OF RECORD AND BOHLER FOR ANY AND ALL DAMAGES. COSTS, INJURIES, ATTORNEY'S FEES AND THE LIKE WHICH RESULT FROM OR ARE IN ANY WAY RELATED TO SAME INCLUDING, BUT NOT LIMITED TO, ANY THIRD PARTY AND FIRST PARTY CLAIMS.
- THE ENGINEER OF RECORD AND BOHLER ARE NOT RESPONSIBLE FOR ANY IN JURY OR DAMAGES RESULTING FROM THE CONTRACTOR'S FAILURE TO BUILD OR WNER FAIL TO BUILD OR CONSTRUCT IN STRICT ACCORDANCE WITH APPROVED PLANS, RULES, STATUTES, CODES AND THE LIKE, THE CONTRACTOR AND/OR OWNER AGREE TO AND MUST JOINTLY, INDEPENDENTLY, SEPARATELY, AND SEVERALLY INDEMNIFY AND HOLD THE ENGINEER OF RECORD AND BOHLER HARMLESS FOR AND FROM ALL INJURIES. CLAIMS AND DAMAGES THAT ENGINEER AND BOHLER SUFFER AND ANY AND ALL COSTS THAT ENGINEER AND BOHLER INCUR AS RELATED TO SAME
- ALL CONTRACTORS MUST CARRY AT LEAST THE MINIMUM AMOUNT OF THE SPECIFIED AND COMMERCIALLY REASONABLE STATUTORY WORKER'S COMPENSATION INSURANCE EMPLOYER'S LIABILITY INSURANCE AND COMMERCIAL GENERAL LIABILITY INSURANCE (CGL) INCLUDING ALSO ALL UMBRELLA COVERAGES ALL CONTRACTORS MUST HAVE THEIR CGL POLICIES ENDORSED TO NAME BOHLER, AND ITS PAST, PRESENT AND FUTURE OWNERS, OFFICERS, DIRECTORS, PARTNERS, SHAREHOLDERS, MEMBERS, PRINCIPALS, COMMISSIONERS, AGENTS, SERVANTS, EMPLOYEES, AFFILIATES, SUBSIDIARIES, AND RELATED ENTITIES, AND ITS SUBCONTRACTORS AND SUBCONSULTANTS AS ADDITIONAL NAMED INSUREDS AND TO PROVIDE CONTRACTUAL LIABILITY COVERAGE SUFFICIENT TO INSURE (DEFEND, IF APPLICABLE) AND HOLD HARMLESS AND INDEMNITY OBLIGATIONS ASSUMED AND AGREED TO BY THE CONTRACTOR HEREIN. ALL CONTRACTORS MUST FURNISH BOHLER WITH CERTIFICATIONS OF INSURANCE OR CERTIFICATES OF INSURANCE AS EVIDENCE OF THE REQUIRED INSURANCE COVERAGES PRIOR TO COMMENCING ANY WORK AND UPON RENEWAL OF EACH POLICY DURING THE ENTIRE PERIOD OF CONSTRUCTION AND FOR TWO YEARS AFTER THE COMPLETION OF CONSTRUCTION AND AFTER ALL PERMITS ARE ISSUED, WHICHEVER DATE IS LATER. IN ADDITION, ALL CONTRACTORS AGREE THAT THEY WILL, TO THE FULLEST EXTENT PERMITTED UNDER THE LAW, INDEMNIFY, DEFEND AND HOLD HARMLESS BOHLER AND ITS PAST, PRESENT AND FUTURE OWNERS, OFFICERS, DIRECTORS, PARTNERS, SHAREHOLDERS, MEMBERS, PRINCIPALS, COMMISSIONERS, AGENTS, SERVANTS, EMPLOYEES, AFFILIATES, SUBSIDIARIES, AND RELATED ENTITIES, AND ITS SUBCONTRACTORS AND SUBCONSULTANTS FROM AND AGAINST ANY DAMAGES, INJURIES, CLAIMS, ACTIONS PENALTIES, EXPENSES, PUNITIVE DAMAGES, TORT DAMAGES, STATUTORY CLAIMS, STATUTORY CAUSES OF ACTION, LOSSES, CAUSES OF ACTION, LIABILITIES OR OSTS, INCLUDING, BUT NOT LIMITED TO, REASONABLE ATTORNEYS' FEES AND DEFENSE COSTS, ARISING OUT OF OR IN ANY WAY CONNECTED WITH OR TO THE
- THE ENGINEER OF RECORD AND BOHLER ARE NOT RESPONSIBLE FOR CONSTRUCTION METHODS. MEANS, TECHNIQUES OR PROCEDURES, GENERALLY OR FOR THE CONSTRUCTION MEANS, METHODS, TECHNIQUES OR PROCEDURES FOR COMPLETION OF THE WORK DEPICTED BOTH ON THESE PLANS, AND FOR ANY CONFLICTS IN SCOPE AND REVISIONS THAT RESULT FROM SAME. THE CONTRACTOR IS FULLY AND SOLELY RESPONSIBLE FOR DETERMINING THE MEANS AND METHODS FOR COMPLETION OF THE WORK, PRIOR TO THE COMMENCEMENT OF CONSTRUCTION. . NEITHER THE PROFESSIONAL ACTIVITIES OF BOHLER, NOR THE PRESENCE OF BOHLER AND/OR ITS PAST, PRESENT AND FUTURE OWNERS, OFFICERS,

PROJECT. INCLUDING ALL CLAIMS BY EMPLOYEES OF THE CONTRACTOR(S). ALL CLAIMS BY THIRD PARTIES AND ALL CLAIMS RELATED TO THE PROJECT. THE CONTRACTOR MUST NOTIFY ENGINEER. IN WRITING, AT LEAST THIRTY (30) DAYS PRIOR TO ANY TERMINATION. SUSPENSION OR CHANGE OF ITS INSURANCE

DIRECTORS, PARTNERS, SHAREHOLDERS, MEMBERS, PRINCIPALS, COMMISSIONERS, AGENTS, SERVANTS, EMPLOYEES, AFFILIATES, SUBSIDIARIES, AND RELATED ENTITIES, AND ITS SUBCONTRACTORS AND SUBCONSULTANTS AT A CONSTRUCTION/PROJECT SITE (HEREIN "BOHLER PARTIES"), RELIEVES OR WILL RELIEVE THE CONTRACTOR OF AND FROM CONSTRUCTION MEANS, METHODS, SEQUENCE, TECHNIQUES OR PROCEDURES NECESSARY FOR PERFORMING, OVERSEEING, SUPERINTENDING AND COORDINATING THE WORK IN ACCORDANCE WITH THE CONTRACT DOCUMENTS AND COMPLIANCE WITH ALL HEALTH AND SAFETY PRECAUTIONS REQUIRED BY ANY REGULATORY AGENCIES WITH JURISDICTION OVER THE PROJECT AND/OR PROPERTY. BOHLER PARTIES HAVE NO AUTHORITY TO EXERCISE ANY CONTROL OVER (OR ANY RESPONSIBILITY FOR) ANY CONSTRUCTION, THE CONTRACTOR OR ITS EMPLOYEES RELATING TO THEIR WORK AND ANY AND ALL HEALTH AND SAFETY PROGRAMS OR PROCEDURES. THE CONTRACTOR IS SOLELY RESPONSIBLE FOR JOB SITE SAFETY. THE CONTRACTOR MUST INDEMNIFY, DEFEND, PROTECT AND HOLD HARMLESS BOHLER PARTIES FOR AND FROM ANY LIABILITY TO BOHLER PARTIES RESULTING FROM THE CONTRACTOR'S WORK. SERVICES AND/OR VIOLATIONS OF THIS NOTE. THESE NOTES OR ANY NOTES IN THE PLAN SET AND, FURTHER, THE CONTRACTOR MUST

NAME BOHLER AS AN ADDITIONAL INSURED UNDER THE GENERAL CONTRACTOR'S POLICIES OF GENERAL LIABILITY INSURANCE AS DESCRIBED ABOVE

- WHEN IT IS CLEARLY AND SPECIFICALLY WITHIN BOHLER'S SCOPE OF SERVICES CONTRACT WITH THE OWNER/DEVELOPER, BOHLER WILL REVIEW OR TAKE OTHER APPROPRIATE ACTION ON THE CONTRACTOR SUBMITTALS, SUCH AS SHOP DRAWINGS, PRODUCT DATA, SAMPLES, AND OTHER DATA, WHICH THE CONTRACTOR IS REQUIRED TO SUBMIT, BUT ONLY FOR THE LIMITED PURPOSE OF EVALUATING CONFORMANCE WITH THE DESIGN INTENT AND THE INFORMATION SHOWN IN THE CONSTRUCTION CONTRACT DOCUMENTS. CONSTRUCTION MEANS AND METHODS AND/OR TECHNIQUES OR PROCEDURES. COORDINATION OF THE WORK WITH OTHER TRADES, AND CONSTRUCTION SAFETY PRECAUTIONS ARE THE SOLE RESPONSIBILITY OF THE CONTRACTOR AND BOHLER HAS NO RESPONSIBILITY OR LIABILITY FOR SAME. BOHLER WILL PERFORM ITS SHOP DRAWING REVIEW WITH REASONABLE PROMPTNESS, AS CONDITIONS PERMIT. ANY DOCUMENT, DOCUMENTING BOHLER'S REVIEW OF A SPECIFIC ITEM OR LIMITED SCOPE, MUST NOT INDICATE THAT BOHLER HAS REVIEWED THE ENTIRE ASSEMBLY OF WHICH THE ITEM IS A COMPONENT, BOHLER IS NOT RESPONSIBLE FOR ANY DEVIATIONS FROM THE CONSTRUCTION DOCUMENTS. THE CONTRACTOR MUST, IN WRITING, PROMPTLY AND IMMEDIATELY BRING ANY DEVIATIONS FROM THE CONSTRUCTION DOCUMENTS TO BOHLER'S ATTENTION. 30HLER IS NOT REQUIRED TO REVIEW PARTIAL SUBMISSIONS OR THOSE FOR WHICH SUBMISSIONS OF CORRELATED ITEMS HAVE NOT BEEN RECEIVED.
- IF THE CONTRACTOR DEVIATES FROM THESE PLANS AND/OR SPECIFICATIONS. INCLUDING THE NOTES CONTAINED HEREIN, WITHOUT FIRST OBTAINING THE PRIOR WRITTEN AUTHORIZATION OF THE ENGINEER OF RECORD AND BOHLER FOR ALL DEVIATIONS WITHIN ENGINEER'S SCOPE, THE CONTRACTOR IS SOLELY RESPONSIBLE FOR THE PAYMENT OF ALL COSTS INCURRED IN CORRECTING ANY WORK PERFORMED WHICH DEVIATES FROM THE PLANS, ALL FINES AND/OR PENALTIES ASSESSED WITH RESPECT THERETO AND ALL COMPENSATORY OR PUNITIVE DAMAGES RESULTING THEREFROM AND, FURTHER, MUST DEFEND. INDEMNIFY, PROTECT, AND HOLD HARMLESS THE ENGINEER OF RECORD AND BOHLER PARTIES TO THE FULLEST EXTENT PERMITTED UNDER THE LAW, FOR AND FROM ALL FEES, ATTORNEYS' FEES, DAMAGES, COSTS, JUDGMENTS, CLAIMS, INJURIES, PENALTIES AND THE LIKE RELATED TO SAME
- THE CONTRACTOR IS RESPONSIBLE FOR A MAINTAINING AND PROTECTING THE TRAFFIC CONTROL PLAN AND ELEMENTS IN ACCORDANCE WITH FEDERAL, STATE. AND LOCAL REQUIREMENTS, FOR ALL WORK THAT AFFECTS PUBLIC TRAVEL EITHER IN THE RIGHT OF WAY OR ON SITE. THE COST FOR THIS ITEM MUST BE INCLUDED IN THE CONTRACTOR'S PRICE AND IS THE CONTRACTOR'S SOLE RESPONSIBILITY. OWNER MUST MAINTAIN AND PRESERVE ALL PHYSICAL SITE FEATURES AND DESIGN FEATURES DEPICTED ON THE PLANS AND RELATED DOCUMENTS IN STRICT
- ACCORDANCE WITH THE APPROVED PLAN(S) AND DESIGN; AND, FURTHER, THE ENGINEER OF RECORD AND BOHLER ARE NOT RESPONSIBLE FOR ANY FAILURE TO SO MAINTAIN OR PRESERVE SITE AND/OR DESIGN FEATURES. IF OWNER FAILS TO MAINTAIN AND/OR PRESERVE ALL PHYSICAL SITE FEATURES AND/OR DESIGN FEATURES DEPICTED ON THE PLANS AND RELATED DOCUMENTS, OWNER AGREES TO INDEMNIFY AND HOLD THE ENGINEER OF RECORD AND BOHLER PARTIES. IARMLESS FOR ALL INJURIES, DAMAGES AND COSTS THAT ENGINEER OF RECORD AND BOHLER INCUR AS A RESULT OF SAID FAILURE OR FAILURE TO PRESERVE THE CONTRACTOR IS SOLELY RESPONSIBLE FOR ENSURING THAT ALL CONSTRUCTION ACTIVITIES AND MATERIALS COMPLY WITH AND CONFORM TO APPLICABLE

FEDERAL, STATE AND LOCAL RULES AND REGULATIONS, LAWS, ORDINANCES, AND CODES, AND ALL APPLICABLE REQUIREMENTS OF THE OCCUPATIONAL SAFETY

- AND HEALTH ACT OF 1970, (29 U.S.C. 651 ET SEQ.) AS AMENDED, AND ANY MODIFICATIONS, AMENDMENTS OR REVISIONS TO SAME. THE CONTRACTOR MUST STRICTLY COMPLY WITH THE LATEST AND CURRENT OSHA STANDARDS AND REGULATIONS, AND/OR ANY OTHER AGENCY WITH ISDICTION OVER EXCAVATION AND TRENCHING PROCEDURES. ENGINEER OF RECORD AND BOHLER HAS NO RESPONSIBILITY FOR OR AS RELATED TO EXCAVATION AND TRENCHING PROCEDURES AND WORK.
- THE CONTRACTOR AND THE OWNER MUST INSTALL ALL ELEMENTS AND COMPONENTS IN STRICT COMPLIANCE WITH AND IN ACCORDANCE WITH MANUFACTURER'S STANDARDS AND RECOMMENDED INSTALLATION CRITERIA AND SPECIFICATIONS. IF THE CONTRACTOR AND/OR OWNER FAIL TO DO SO, THEY AGREE TO JOINTLY, INDEPENDENTLY, SEPARATELY, COLLECTIVELY, AND SEVERALLY INDEMNIFY, DEFEND, PROTECT AND HOLD ENGINEER OF RECORD AND BOHLER PARTIES HARMLESS FOR ALL INJURIES AND DAMAGES THAT ENGINEER SUFFERS AND COSTS THAT ENGINEER INCURS AS A RESULT OF SAID FAILURE.
- THE CONTRACTOR IS RESPONSIBLE TO MAINTAIN AN ON-SITE STORMWATER POLITUTION PREVENTION PLAN (SWPPP) IN COMPLIANCE WITH THE ENVIRONMENTAL PROTECTION AGENCY (EPA) REQUIREMENTS OR LOCAL GOVERNING AGENCY FOR SITES WHERE ONE (1) ACRE OR MORE IS DISTURBED BY CONSTRUCTION ACTIVITIES (UNLESS THE LÓCAL JURISDICTION REQUIRES A DIFFERENT THRESHOLD). THE CONTRACTOR MUST ENSURE THAT ALL ACTIVITIES, INCLUDING THOSE OF ALL SUBCONTRACTORS, ARE IN COMPLIANCE WITH THE SWPPP, INCLUDING BUT NOT LIMITED TO LOGGING ACTIVITIES (MINIMUM ONCE PER WEEK AND AFTER RAINFALL EVENTS) AND CORRECTIVE MEASURES. AS APPROPRIATE AND FURTHER. THE CONTRACTOR IS SOLELY AND COMPLETELY RESPONSIBLE FOR FAILING
- AS CONTAINED IN THESE DRAWINGS AND ASSOCIATED DOCI IMENTS PREPARED BY THE ENGINEER OF RECORD AND BOHLER. THE USE OF THE WORDS "CERTIEV" OR 'CERTIFICATION' CONSTITUTE(S) AN EXPRESSION ONLY OF PROFESSIONAL OPINION REGARDING THE INFORMATION WHICH IS THE SUBJECT OF THE ENGINEER OF RECORD'S AND BOHLER KNOWLEDGE OR BELIEF AND IN ACCORDANCE WITH COMMON AND ACCEPTED PROCEDURE CONSISTENT WITH THE APPLICABLE STANDARDS OF PRACTICE, AND DOES NOT CONSTITUTE A WARRANTY OR GUARANTEE OF ANY NATURE OR TYPE, EITHER EXPRESSED OR IMPLIED, UNDER ANY CIRCUMSTANCES.

N	GENERAL DEMOLITION NOTES 1. THE GENERAL NOTES MUST BE INCLUDED AS PART OF THIS ENTIRE DOCUMENT PACKAGE AND ARE PART OF THE CONTRACT DOCUMENTS. THE GENERAL NOTES	1. 1	ENERAL GRADING NOTES	AD
Y	ARE REFERENCED HEREIN, AND THE CONTRACTOR MUST REFER TO THEM AND FULLY COMPLY WITH THESE NOTES, IN THEIR ENTIRETY. THE CONTRACTOR MUST BE FAMILIAR WITH AND ACKNOWLEDGE FAMILIARITY WITH ALL OF THE GENERAL NOTES AND ALL OF THE PLANS' SPECIFIC NOTES. 2. THE CONTRACTOR MUST CONDUCT DEMOLITION/REMOVALS ACTIVITIES IN SUCH A MANNER AS TO ENSURE MINIMUM INTERFERENCE WITH ROADS, STREETS,	E	ARE REFERENCED HEREIN, AND THE CONTRACTOR MUST REFER TO THEM AND FULLY COMPLY WITH THESE NOTES, IN THEIR ENTIRETY. THE CONTRACTOR MUST 3E FAMILIAR WITH AND ACKNOWLEDGE FAMILIARITY WITH ALL OF THE GENERAL NOTES AND ALL OF THE PLANS' SPECIFIC NOTES. 3ITE GRADING MUST BE PERFORMED IN ACCORDANCE WITH THESE PLANS AND SPECIFICATIONS AND THE RECOMMENDATIONS SET FORTH IN THE GEOTECHNICAL	REC LOC 2. THE . GUI
AT	SIDEWALKS, WALKWAYS, AND ALL OTHER ADJACENT FACILITIES. THE CONTRACTOR MUST OBTAIN ALL APPLICABLE PERMITS FROM THE APPROPRIATE GOVERNMENTAL AUTHORITY(IES) PRIOR TO THE COMMENCEMENT OF ANY ROAD OPENING OR DEMOLITION ACTIVITIES IN OR ADJACENT TO THE RIGHT-OF-WAY. 3. WHEN DEMOLITION-RELATED ACTIVITIES IMPACT ROADWAYS AND/OR ROADWAY RIGHT-OF-WAY, THE CONTRACTOR MUST PROVIDE TRAFFIC CONTROL AND	F	REPORT AS REFERENCED IN THIS PLAN SET. IF NO GEOTECHNICAL REPORT HAS BEEN REFERENCED, THE CONTRACTOR MUST HAVE A GEOTECHNICAL ENGINEER PROVIDE WRITTEN SPECIFICATIONS AND RECOMMENDATIONS PRIOR TO THE CONTRACTOR COMMENCING THE GRADING WORK. THE CONTRACTOR MUST FOLLOW THE REQUIREMENTS OF ALL MUNICIPAL, COUNTY, STATE, AND FEDERAL LAWS, WHICH HAVE JURISDICTION OVER THIS PROJECT.	3. THE THE INTE
	GENERALLY ACCEPTED SAFE PRACTICES IN CONFORMANCE WITH THE CURRENT FEDERAL HIGHWAY ADMINISTRATION "MANUAL ON UNIFORM TRAFFIC CONTROL DEVICES" (MUTCD), AND THE FEDERAL, STATE, AND LOCAL REGULATIONS.	F	THE CONTRACTOR IS REQUIRED TO SECURE ALL NECESSARY AND/OR REQUIRED PERMITS AND APPROVALS FOR ALL OFF-SITE MATERIAL SOURCES AND DISPOSAL ACILITIES. THE CONTRACTOR MUST SUPPLY A COPY OF APPROVALS TO THE ENGINEER OF RECORD AND THE OWNER PRIOR TO THE CONTRACTOR COMMENCING ANY WORK.	. 3.1.
	 THE DEMOLITION (AND/OR REMOVALS) PLAN IS INTENDED TO PROVIDE GENERAL INFORMATION AND TO IDENTIFY ONLY CONDITIONS REGARDING ITEMS TO BE DEMOLISHED, REMOVED, AND/OR TO REMAIN. THE CONTRACTOR MUST ALSO REVIEW ALL CONSTRUCTION DOCUMENTS AND INCLUDE WITHIN THE DEMOLITION ACTIVITIES ALL INCIDENTAL WORK 	C	THE CONTRACTOR IS FULLY RESPONSIBLE FOR VERIFYING EXISTING TOPOGRAPHIC INFORMATION AND UTILITY INVERT ELEVATIONS PRIOR TO COMMENCING ANY CONSTRUCTION. SHOULD DISCREPANCIES BETWEEN THE PLANS AND INFORMATION OBTAINED THROUGH FIELD VERIFICATIONS BE IDENTIFIED OR EXIST, THE CONTRACTOR MUST IMMEDIATELY NOTIFY THE ENGINEER OF RECORD, IN WRITING.	
NO ED	NECESSARY FOR THE CONSTRUCTION OF THE NEW SITE IMPROVEMENTS. 4.2. THIS PLAN IS NOT INTENDED TO AND DOES NOT PROVIDE DIRECTION REGARDING THE MEANS, METHODS, SEQUENCING, TECHNIQUES AND PROCEDURES TO BE EMPLOYED TO ACCOMPLISH THE WORK. ALL MEANS, METHODS, SEQUENCING, TECHNIQUES AND PROCEDURES TO BE USED MUST BE IN STRICT ACCORDANCE AND CONFORMANCE WITH ALL STATE, FEDERAL, LOCAL, AND JURISDICTIONAL REQUIREMENTS. THE CONTRACTOR MUST COMPLY WITH ALL	(THE CONTRACTOR IS RESPONSIBLE FOR REMOVING AND REPLACING ALL UNSUITABLE MATERIALS WITH SUITABLE MATERIALS AS SPECIFIED IN THE SEOTECHNICAL REPORT. THE CONTRACTOR MUST COMPACT ALL EXCAVATED OR FILLED AREAS IN STRICT ACCORDANCE WITH THE GEOTECHNICAL REPORT'S SUIDANCE. MOISTURE CONTENT AT TIME OF PLACEMENT MUST BE SUBMITTED IN A COMPACTION REPORT PREPARED BY A QUALIFIED GEOTECHNICAL ENGINEER,	3.3.
_	OSHA AND OTHER SAFETY PRECAUTIONS NECESSARY TO PROVIDE A SAFE WORK SITE FOR THE CONTRACTOR AND THE PUBLIC. 5. THE CONTRACTOR MUST PROVIDE ALL "METHODS AND MEANS" NECESSARY TO PREVENT MOVEMENT, SETTLEMENT, OR COLLAPSE OF EXISTING STRUCTURES,	E	REGISTERED WITH THE STATE WHERE THE WORK IS PERFORMED. THIS REPORT MUST VERIFY THAT ALL FILLED AREAS AND SUBGRADE AREAS WITHIN THE BUILDING PAD AREA AND AREAS TO BE PAVED HAVE BEEN COMPACTED IN ACCORDANCE WITH THESE PLANS, SPECIFICATIONS AND THE RECOMMENDATIONS SET FORTH IN THE GEOTECHNICAL REPORT AND ALL APPLICABLE REQUIREMENTS, RULES, STATUTES, LAWS, ORDINANCES AND CODES WHICH ARE IN EFFECT AND CORTH IN THE GEOTECHNICAL REPORT AND ALL APPLICABLE REQUIREMENTS, RULES, STATUTES, LAWS, ORDINANCES AND CODES WHICH ARE IN EFFECT AND CORTH IN THE GEOTECHNICAL REPORT AND ALL APPLICABLE REQUIREMENTS, RULES, STATUTES, LAWS, ORDINANCES AND CODES WHICH ARE IN EFFECT AND CORTH IN THE GEOTECHNICAL REPORT AND ALL APPLICABLE REQUIREMENTS. RULES, STATUTES, LAWS, ORDINANCES AND CODES WHICH ARE IN EFFECT AND CORTH IN THE GEOTECHNICAL REPORT AND ALL APPLICABLE REQUIREMENTS. RULES, STATUTES, LAWS, ORDINANCES AND CODES WHICH ARE IN EFFECT AND CORTH IN THE GEOTECHNICAL REPORT AND ALL APPLICABLE REQUIREMENTS. RULES, STATUTES, LAWS, ORDINANCES AND CODES WHICH ARE IN EFFECT AND CORTH IN THE GEOTECHNICAL REPORT AND ALL APPLICABLE REQUIREMENTS. RULES, STATUTES, LAWS, ORDINANCES AND CODES WHICH ARE IN EFFECT AND CORTH IN THE GEOTECHNICAL REPORT AND ALL APPLICABLE REQUIREMENTS. RULES, STATUTES, LAWS, ORDINANCES AND CODES WHICH ARE IN EFFECT AND CONTRACT.	3.4.
L R	AND ANY OTHER IMPROVEMENTS THAT ARE REMAINING ON OR OFF SITE. THE CONTRACTOR, AT THE CONTRACTOR'S SOLE COST, MUST REPAIR ALL DAMAGE TO ALL ITEMS AND FEATURES THAT ARE TO REMAIN. CONTRACTOR MUST USE NEW MATERIAL FOR ALL REPAIRS. CONTRACTOR'S REPAIRS MUST INCLUDE THE RESTORATION OF ALL ITEMS AND FEATURES REPAIRED TO THEIR PRE-DEMOLITION CONDITION, OR BETTER. CONTRACTOR MUST PERFORM ALL REPAIRS AT THE CONTRACTOR'S SOLE EXPENSE.	N F	WHICH ARE APPLICABLE TO THE PROJECT. SUBBASE MATERIAL FOR SIDEWALKS, CURB, OR ASPHALT MUST BE FREE OF ORGANICS AND OTHER UNSUITABLE MATERIALS. SHOULD SUBBASE BE DEEMED UNSUITABLE BY OWNER/DEVELOPER, OR OWNER/DEVELOPER'S REPRESENTATIVE, SUBBASE MUST BE REMOVED AND FILLED WITH APPROVED FILL MATERIAL, COMPACTED AS THE GEOTECHNICAL REPORT DIRECTS. EARTHWORK ACTIVITIES INCLUDING, BUT NOT LIMITED TO, SXCAVATION, BACKFILL, AND COMPACTING MUST COMPLY WITH THE RECOMMENDATIONS IN THE GEOTECHNICAL REPORT AND ALL APPLICABLE REQUIREMENTS.	3.5.
) ,	6. ENGINEER OF RECORD AND BOHLER ARE NOT RESPONSIBLE FOR JOB SITE SAFETY OR SUPERVISION. THE CONTRACTOR MUST PROCEED WITH THE DEMOLITION IN A SYSTEMATIC AND SAFE MANNER, COMPLYING WITH ALL OSHA REQUIREMENTS, TO ENSURE PUBLIC AND CONTRACTOR SAFETY AND SAFETY TO ALL PROPERTY	F	RULES, STATUTES, LAWS, ORDINANCES AND CODES. EARTHWORK ACTIVITIES MUST COMPLY WITH THE STANDARD STATE DOT SPECIFICATIONS FOR ROADWAY CONSTRUCTION (LATEST EDITION) AND ANY AMENDMENTS OR REVISIONS THERETO.	3.6.
	ON THE SITE OR ADJACENT OR NEAR TO THE SAME. 7. THE CONTRACTOR IS RESPONSIBLE FOR JOB SITE SAFETY, WHICH MUST INCLUDE, BUT IS NOT LIMITED TO, THE INSTALLATION AND MAINTENANCE OF BARRIERS, FENCING, OTHER APPROPRIATE AND/OR NECESSARY SAFETY FEATURES AND ITEMS NECESSARY TO PROTECT THE PUBLIC FROM AREAS OF CONSTRUCTION AND	(N THE EVENT OF A DISCREPANCY(IES) AND/OR A CONFLICT(S) BETWEEN PLANS, OR RELATIVE TO OTHER PLANS, THE GRADING PLAN TAKES PRECEDENCE AND CONTROLS. THE CONTRACTOR MUST IMMEDIATELY NOTIFY THE ENGINEER OF RECORD, IN WRITING, OF ANY DISCREPANCY(IES) AND/OR CONFLICT(S). THE CONTRACTOR IS RESPONSIBLE TO IMPORT FILL OR EXPORT EXCESS MATERIAL AS NECESSARY TO CONFORM TO THE PROPOSED GRADING, AND TO BACKFILL	
	CONSTRUCTION ACTIVITIES. THE CONTRACTOR MUST SAFEGUARD THE SITE AS NECESSARY TO PERFORM THE DEMOLITION IN SUCH A MANNER AS TO PREVENT THE ENTRY OF ALL UNAUTHORIZED PERSONS AT ANY TIME, TO OR NEAR THE DEMOLITION AREA.	E	PROPOSED TOP OF CURB ELEVATIONS ARE GENERALLY 6" ABOVE PAVEMENT GRADE UNLESS OTHERWISE NOTED.	3.7.
R	8. PRIOR TO THE COMMENCEMENT OF ANY SITE ACTIVITY AND ANY DEMOLITION ACTIVITY, THE CONTRACTOR MUST, IN WRITING, RAISE ANY QUESTIONS CONCERNING THE ACCURACY OR INTENT OF THESE PLANS AND/OR SPECIFICATIONS, ALL CONCERNS OR QUESTIONS REGARDING THE APPLICABLE SAFETY STANDARDS, AND/OR THE SAFETY OF THE CONTRACTOR AND/OR THIRD PARTIES IN PERFORMING THE WORK ON THIS PROJECT. ANY SUCH CONCERNS MUST BE CONVEYED TO THE ENGINEER OF RECORD AND BOHLER, IN WRITING AND MUST ADDRESS ALL ISSUES AND ITEMS RESPONDED TO, BY THE ENGINEER OF RECORD AND BY BOHLER, IN WRITING. ALL DEMOLITION ACTIVITIES MUST BE PERFORMED IN ACCORDANCE WITH THE REQUIREMENTS OF THESE PLANS AND	F	THE CONTRACTOR MUST CONFIRM AND ENSURE THAT AS CONSTRUCTED IMPROVEMENTS CREATE THE FOLLOWING MINIMUM SLOPES (EXCEPT WHERE ADA REQUIREMENTS LIMIT THEM): 1.0% ON ALL CONCRETE SURFACES, 1.5% ON ASPHALT SURFACES, 1.5% IN LANDSCAPED AREAS AND 0.75% SLOPE AGAINST ALL SLANDS, GUTTERS, AND CURBS TO PROVIDE POSITIVE DRAINAGE.	4. IT IS COI
5	SPECIFICATIONS AND ALL APPLICABLE FEDERAL, STATE AND LOCAL REGULATIONS, RULES, REQUIREMENTS, STATUTES, ORDINANCES AND CODES. 9. THE CONTRACTOR MUST BECOME FAMILIAR WITH THE APPLICABLE UTILITY SERVICE PROVIDER REQUIREMENTS AND IS RESPONSIBLE FOR ALL COORDINATION REGARDING UTILITY DEMOLITION AND/OR DISCONNECTION AS IDENTIFIED OR REQUIRED FOR THE PROJECT. THE CONTRACTOR MUST PROVIDE THE OWNER WITH WRITTEN NOTIFICATION THAT THE EXISTING UTILITIES AND SERVICES HAVE BEEN TERMINATED, REMOVED AND/OR ABANDONED IN ACCORDANCE WITH THE JURISDICTION AND UTILITY COMPANY REQUIREMENTS AND ALL OTHER APPLICABLE REQUIREMENTS, RULES, STATUTES, LAWS, ORDINANCES AND CODES.	T V E C E	WHERE RETAINING WALLS ARE IDENTIFIED ON THE PLANS, TOP AND BOTTOM OF WALL ELEVATIONS (TW & BW) REPRESENT THE PROPOSED FINISHED GRADE AT THE FACE OF THE TOP AND BOTTOM OF THE WALL AND DO NOT REPRESENT THE ELEVATION OF THE PROPOSED WALL (INCLUDING THE CAP UNIT OR FOOTING). WALL FOOTINGS/FOUNDATION ELEVATIONS ARE NOT IDENTIFIED HEREIN AND ARE TO BE SET/DETERMINED BY THE CONTRACTOR OR WALL DESIGNER, AND MUST BE SET BASED UPON FINAL STRUCTURAL DESIGN SHOP DRAWINGS PREPARED BY THE APPROPRIATE PROFESSIONAL LICENSED IN THE STATE WHERE THE CONSTRUCTION OCCURS. THE CONTRACTOR MUST ENSURE THAT THERE ARE NO UTILITIES ON THE PASSIVE SIDE OF THE RETAINING WALL. NO EXCAVATION MAY BE PERFORMED ON THE PASSIVE SIDE OF THE RETAINING WALL WITHOUT APPROPRIATELY AND SAFELY SUPPORTING THE WALL IN ACCORDANCE WITH THE STANDARD OF CARE AND ALL APPLICABLE RULES, REGULATIONS, CODES, ORDINANCES, LAWS AND STATUTES.	
	 PRIOR TO COMMENCING ANY DEMOLITION, THE CONTRACTOR MUST: 01.1. OBTAIN ALL REQUIRED PERMITS AND MAINTAIN THE SAME ON SITE FOR REVIEW BY THE ENGINEER AND ALL PUBLIC AGENCIES WITH JURISDICTION THROUGHOUT THE DURATION OF THE PROJECT, SITE WORK, AND DEMOLITION WORK. 10.2. NOTIFY, AT A MINIMUM, THE MUNICIPAL ENGINEER, DESIGN ENGINEER, AND LOCAL SOIL CONSERVATION JURISDICTION, AT LEAST 72 BUSINESS HOURS PRIOR 		ISE OR GRAVITY BLOCK WALLS SHALL BE CONSTRUCTED SUCH THAT UPON COMPLETION OF CONSTRUCTION THERE IS NO UNFINISHED SURFACE OR LIFTING RINGS VISIBLE (E.G. USE OF FINISHED TOP BLOCK OR CAP STONES)	
5 5	 10.2. NOTHER, AT A MINIMUM, AT LEAST 12 BUSINESS HOURS PRIOR TO THE COMMENCEMENT OF WORK. 10.3. INSTALL THE REQUIRED SOIL EROSION AND SEDIMENT CONTROL MEASURES PRIOR TO SITE DISTURBANCE, AND MAINTAIN SAID CONTROLS UNTIL SITE IS STABILIZED 	٦	STORMWATER RUNOFF WITHIN PROPERTY MUST BE COLLECTED ON-SITE WITH NO OVERLAND RUNOFF ONTO THE RIGHT-OF-WAY OR ADJACENT PROPERTIES TO THE MAXIMUM EXTENT POSSIBLE OR IN THE MANNER SHOWN ON THE CONSTRUCTION DRAWINGS. STORMWATER RUNOFF ONTO ADJACENT PROPERTIES SHALL BE CONTROLLED AS TO NOT ADVERSLY IMPACT SAID PROPERTIES.	Ξ
२	 IN ACCORDANCE WITH STATE LAW, THE CONTRACTOR MUST CALL THE STATE ONE-CALL DAMAGE PROTECTION SYSTEM FOR UTILITY MARK OUT, IN ADVANCE OF ANY EXCAVATION. LOCATE AND PROTECT ALL UTILITIES AND SERVICES, INCLUDING BUT NOT LIMITED TO GAS, WATER, ELECTRIC, SANITARY AND STORM SEWER, TELEPHONE, 		BEFORE COMMENCING GRADING WORK, CONTRACTOR SHALL SUBMIT SAMPLES OF ALL NATIVE AND IMPORTED MATERIALS WITH THEIR INTENDED FOR STRUCTURAL USES TO THE GEOTECHNICAL ENGINEER OF RECORD.	
	CABLE, FIBER OPTIC CABLE, ETC. WITHIN AND ADJACENT TO THE LIMITS OF PROJECT ACTIVITIES. THE CONTRACTOR MUST USE AND COMPLY WITH THE REQUIREMENTS OF THE APPLICABLE UTILITY NOTIFICATION SYSTEM TO LOCATE ALL UNDERGROUND UTILITIES. PROTECT AND MAINTAIN IN OPERATION, ALL ACTIVE UTILITIES AND SYSTEMS THAT ARE NOT BEING REMOVED DURING ANY DEMOLITION ACTIVITIES. ARRANGE FOR AND COORDINATE WITH THE APPLICABLE UTILITY SERVICE PROVIDER(S) FOR THE TEMPORARY OR PERMANENT TERMINATION OF SERVICE		REFER TO GENERAL NOTES SHEET FOR ADDITIONAL ADA GUIDELINES AND REQUIREMENTS.	
	REQUIRED BY THE PROJECT PLANS AND SPECIFICATIONS REGARDING THE METHODS AND MEANS TO CONSTRUCT SAME. THESE ARE NOT THE ENGINEER OF RECORD'S RESPONSIBILITY. IN THE EVENT OF ABANDONMENT, THE CONTRACTOR MUST PROVIDE THE UTILITY ENGINEER AND OWNER WITH IMMEDIATE WRITTEN NOTIFICATION THAT THE EXISTING UTILITIES AND SERVICES HAVE BEEN TERMINATED AND ABANDONED IN ACCORDANCE WITH JURISDICTIONAL AND UTILITY COMPANY REQUIREMENTS.	15.1	. THE OWNER OR THE OWNER'S CONTRACTOR IS TO PROVIDE A SITE-SPECIFIC RETAINING WALL DESIGN PREPARED BY THE APPROPRIATE PROFESSIONAL LICENSED (E.G. STRUCTURAL ENGINEER) IN THE STATE WHERE THE CONSTRUCTION OCCURS. SOIL TYPES, WATER TABLE ELEVATION, EXISTING & PROPOSED SURROUNDING IMPROVEMENTS/CONDITIONS (INCLUDING BUT NOT LIMITED TO SLOPES, DRIVE AISLES, ROADS, FENCING, GUIDERAILS, UTILITIES, DRAINAGE FACILITIES, STRUCTURES, FOUNDATIONS), LIVE LOADS AND OTHER SITE AMENITIES THAT COULD HAVE AN INFLUENCE OR IMPACT ON THE RETAINING WALL(S) CONSTRUCTABILITY AND/OR LONGEVITY SHALL BE CONSIDERED AND INCORPORATED INTO THE RETAINING WALL DESIGN AS WELL AS THE GLOBAL STABILITY	
0	 ARRANGE FOR AND COORDINATE WITH THE APPLICABLE UTILITY SERVICE PROVIDER(S) REGARDING WORKING "OFF-PEAK" HOURS OR ON WEEKENDS AS NECESSARY OR AS REQUIRED TO MINIMIZE THE IMPACT ON, OF, AND TO THE AFFECTED PARTIES. WORK REQUIRED TO BE PERFORMED "OFF-PEAK" IS TO BE PERFORMED AT NO ADDITIONAL COST TO THE OWNER. IN THE EVENT THE CONTRACTOR DISCOVERS ANY HAZARDOUS MATERIAL, THE REMOVAL OF WHICH IS NOT ADDRESSED IN THE PROJECT PLANS AND 	15.2	ANALYSIS. PEER REVIEW AND GLOBAL STABILITY ANALYSIS OF THE RETAINING WALL DESIGN MUST BE COMPLETED BY THE OWNER'S GEOTECHNICAL ENGINEER TO CERTIFY THE DESIGN MEETS INDUSTRY STANDARDS FOR FACTOR OF SAFETY. SOIL TYPES, WATER TABLE ELEVATION AND DESIGN PROPERTIES AS NOTED	
	SPECIFICATIONS OR THE CONTRACT WITH THE OWNER/DEVELOPER, THE CONTRACTOR MUST IMMEDIATELY CEASE ALL WORK IN THE AREA OF DISCOVERY, AND IMMEDIATELY NOTIFY, IN WRITING AND VERBALLY, THE OWNER AND ENGINEER OF RECORD AND BOHLER, THE DISCOVERY OF SUCH MATERIALS TO PURSUE PROPER AND COMPLIANT REMOVAL OF SAME.		ABOVE SHALL BE FIELD CONFIRMED AND APPROVED BY THE GEOTECHNICAL ENGINEER PRIOR TO WALL CONSTRUCTION.	
	11. THE CONTRACTOR MUST NOT PERFORM ANY EARTH MOVEMENT ACTIVITIES, DEMOLITION OR REMOVAL OF FOUNDATION WALLS, FOOTINGS, OR OTHER MATERIALS WITHIN THE LIMITS OF DISTURBANCE, UNLESS SAME IS IN STRICT ACCORDANCE AND CONFORMANCE WITH THE PROJECT PLANS AND SPECIFICATIONS, OR PURSUANT TO THE WRITTEN DIRECTION OF THE OWNER'S STRUCTURAL OR GEOTECHNICAL ENGINEER.	17. (ACCESSIBLE RAMP AND RAMP LANDING TO MEET ADA/AAB REQUIREMENTS. CONTRACTOR SHALL REVIEW RETAINING WALL LOCATIONS VERSUS APPLICABLE STATE AND LOCAL CODES AND PROVIDE FALL PROTECTION (E.G. FENCING OR RAILING) IN ACCORDANCE WITH SAID CODE.	KEY
	12. DEMOLITION ACTIVITIES AND EQUIPMENT MUST NOT USE OR INCLUDE AREAS OUTSIDE THE DEFINED PROJECT LIMIT LINE, WITHOUT SPECIFIC WRITTEN PERMISSION AND AUTHORITY OF AND FROM THE OWNER AND ALL GOVERNMENTAL AGENCIES WITH JURISDICTION.		CONTRACTOR SHALL COORDINATE WITH OWNER/OPERATOR TO REVIEW EXISTING DEPRESSIONS WITHIN EXISTING PAVEMENT AREAS TO REMAIN AND SHALL CONFIRM THAT THE SCOPE OF WORK SHALL PROVIDE POSITIVE DRAINAGE BY FIXING ANY EXISTING AREAS OF PONDING.	AG / AI ARCH BC
D	13. THE CONTRACTOR MUST BACKFILL ALL EXCAVATION RESULTING FROM, OR INCIDENTAL TO, DEMOLITION ACTIVITIES. BACKFILL MUST BE ACCOMPLISHED WITH APPROVED BACKFILL MATERIALS AND MUST BE SUFFICIENTLY COMPACTED TO SUPPORT ALL NEW IMPROVEMENTS AND MUST BE PERFORMED IN COMPLIANCE WITH THE RECOMMENDATIONS AND GUIDANCE ARTICULATED IN THE GEOTECHNICAL REPORT. BACKFILLING MUST OCCUR IMMEDIATELY AFTER DEMOLITION ACTIVITIES AND MUST BE PERFORMED SO AS TO PREVENT WATER ENTERING THE EXCAVATION. FINISHED SURFACES MUST BE GRADED TO PROMOTE POSITIVE	5	BEFORE COMMENCING GRADING WORK, CONTRACTOR SHALL SUBMIT SAMPLES OF ALL NATIVE AND IMPORTED MATERIALS WITH THEIR INTENDED FOR	BCC BM
	DRAINAGE. THE CONTRACTOR IS RESPONSIBLE FOR COMPACTION TESTING AND MUST SUBMIT SUCH REPORTS AND RESULTS TO THE ENGINEER OF RECORD AND THE OWNER.		ENERAL DRAINAGE & UTILITY NOTES	BOC BW BLDG
Y	14. EXPLOSIVES MUST NOT BE USED WITHOUT PRIOR WRITTEN CONSENT FROM BOTH THE OWNER AND ALL APPLICABLE, NECESSARY AND REQUIRED GOVERNMENTAL AUTHORITIES. PRIOR TO COMMENCING ANY EXPLOSIVE PROGRAM AND/OR ANY DEMOLITION ACTIVITIES, THE CONTRACTOR MUST ENSURE AND OVERSEE THE INSTALLATION OF ALL OF THE REQUIRED PERMIT AND EXPLOSIVE CONTROL MEASURES THAT THE FEDERAL, STATE, AND LOCAL GOVERNMENTS REQUIRE. THE CONTRACTOR IS ALSO RESPONSIBLE TO CONDUCT AND PERFORM ALL INSPECTION AND SEISMIC VIBRATION TESTING THAT IS REQUIRED TO	Æ	ARE REFERENCED HEREIN, AND THE CONTRACTOR MUST REFER TO THEM AND FULLY COMPLY WITH THESE NOTES, IN THEIR ENTIRETY. THE CONTRACTOR MUST BE FAMILIAR WITH AND ACKNOWLEDGE FAMILIARITY WITH ALL OF THE GENERAL NOTES AND ALL OF THE PLANS' SPECIFIC NOTES.	CC CCB CONC.
IE.	MONITOR THE EFFECTS ON ALL LOCAL STRUCTURES AND THE LIKE. 15. IN ACCORDANCE WITH FEDERAL, STATE, AND/OR LOCAL STANDARDS, THE CONTRACTOR MUST USE DUST CONTROL MEASURES TO LIMIT AIRBORNE DUST AND	L	.OCATIONS OF ALL EXISTING AND PROPOSED SERVICES ARE APPROXIMATE, AND THE CONTRACTOR MUST INDEPENDENTLY VERIFY AND CONFIRM THOSE .OCATIONS AND SERVICES WITH LOCAL UTILITY COMPANIES PRIOR TO COMMENCING ANY CONSTRUCTION OR EXCAVATION. THE CONTRACTOR MUST NDEPENDENTLY VERIFY AND CONFIRM ALL SANITARY CONNECTION POINTS AND ALL OTHER UTILITY SERVICE CONNECTION POINTS IN THE FIELD, PRIOR TO COMMENCING ANY CONSTRUCTION. THE CONTRACTOR MUST REPORT ALL DISCREPANCIES. ERRORS AND OMISSIONS IN WRITING. TO THE ENGINEER OF RECORD.	DEC °
R D M	DIRT RISING AND SCATTERING IN THE AIR. AFTER THE DEMOLITION IS COMPLETE, THE CONTRACTOR MUST CLEAN ALL ADJACENT STRUCTURES AND IMPROVEMENTS TO REMOVE ALL DUST AND DEBRIS WHICH THE DEMOLITION OPERATIONS CAUSE. THE CONTRACTOR IS RESPONSIBLE FOR RETURNING ALL ADJACENT AREAS TO THEIR "PRE-DEMOLITION" CONDITION AT CONTRACTOR'S SOLE COST.	5	THE CONTRACTOR MUST VERTICALLY AND HORIZONTALLY LOCATE ALL UTILITIES AND SERVICES INCLUDING, BUT NOT LIMITED TO, GAS, WATER, ELECTRIC, SANITARY AND STORM, TELEPHONE, CABLE, FIBER OPTIC CABLE, ETC. WITHIN THE LIMITS OF DISTURBANCE OR WORK SPACE, WHICHEVER IS GREATER. THE	DEP Ø / DIA DMH
	16. PAVEMENT MUST BE SAW CUT IN STRAIGHT LINES. ALL DEBRIS FROM REMOVAL OPERATIONS MUST BE REMOVED FROM THE SITE AT THE TIME OF EXCAVATION. STOCKPILING OF DEBRIS OUTSIDE OF APPROVED AREAS WILL NOT BE PERMITTED, INCLUDING BUT NOT LIMITED TO, THE PUBLIC RIGHT-OF-WAY.	L A	CONTRACTOR MUST USE, REFER TO, AND COMPLY WITH THE REQUIREMENTS OF THE APPLICABLE UTILITY NOTIFICATION SYSTEM TO LOCATE ALL OF THE INDERGROUND UTILITIES. THE CONTRACTOR IS RESPONSIBLE FOR REPAIRING ALL DAMAGE TO ANY EXISTING UTILITIES WHICH OCCUR DURING CONSTRUCTION, AT NO COST TO THE OWNER AND AT CONTRACTOR'S SOLE COST AND EXPENSE. THE CONTRACTOR MUST BEAR ALL COSTS ASSOCIATED WITH DAMAGE TO ANY EXISTING UTILITIES WHICH OCCURS DURING CONSTRUCTION.	DIP ECC EOP
)	17. THE CONTRACTOR MUST MAINTAIN A RECORD SET OF PLANS WHICH INDICATES THE LOCATION OF EXISTING UTILITIES THAT ARE CAPPED, ABANDONED IN PLACE, OR RELOCATED DUE TO DEMOLITION ACTIVITIES. THIS RECORD DOCUMENT MUST BE PREPARED IN A NEAT AND WORKMAN-LIKE MANNER AND TURNED OVER TO THE OWNER/DEVELOPER UPON COMPLETION OF THE WORK, ALL OF WHICH IS AT THE CONTRACTOR'S SOLE COST.		THE CONTRACTOR MUST FIELD VERIFY THE PROPOSED INTERFACE POINTS (CROSSINGS) WITH EXISTING UNDERGROUND UTILITIES BY USING A TEST PIT TO CONFIRM EXACT DEPTH, PRIOR TO COMMENCEMENT OF CONSTRUCTION.	EUP ELEV EXIST.
ON	18. THE CONTRACTOR MUST EMPTY, CLEAN AND REMOVE FROM THE SITE ALL UNDERGROUND STORAGE TANKS, IF ENCOUNTERED, IN ACCORDANCE WITH FEDERAL, STATE, COUNTY AND LOCAL REQUIREMENTS, PRIOR TO CONTINUING CONSTRUCTION IN THE AREA AROUND THE TANK WHICH EMPTYING, CLEANING AND REMOVAL ARE AT THE CONTRACTOR'S SOLE COST.		STORMWATER ROOF DRAIN LOCATIONS ARE BASED ON ARCHITECTURAL PLANS. THE CONTRACTOR IS RESPONSIBLE FOR VERIFYING LOCATIONS OF SAME BASED JPON FINAL ARCHITECTURAL PLANS.	FF FFE GC
	19. THE CONTRACTOR MUST LOCATE AND CLEARLY DEFINE VERTICALLY AND HORIZONTALLY ALL ACTIVE AND INACTIVE UTILITY AND/OR SERVICE SYSTEMS THAT ARE TO BE REMOVED. THE CONTRACTOR IS RESPONSIBLE TO PROTECT AND MAINTAIN ALL ACTIVE SYSTEMS THAT ARE NOT BEING REMOVED/RELOCATED DURING SITE ACTIVITY.	L 1	THE CONTRACTOR IS RESPONSIBLE FOR COORDINATING SITE PLAN DOCUMENTS AND ARCHITECTURAL PLANS FOR EXACT BUILDING UTILITY CONNECTION .OCATIONS; GREASE TRAP REQUIREMENTS; AND DETAILS, DOOR ACCESS, AND EXTERIOR GRADING. THE ARCHITECT WILL DETERMINE THE UTILITY SERVICE SIZES THE CONTRACTOR MUST COORDINATE INSTALLATION OF UTILITY SERVICES WITH THE INDIVIDUAL COMPANIES TO AVOID CONFLICTS AND TO ENSURE THAT	HDPE
	20. CONTRACTOR SHALL FIELD LOCATE EXISTING UTILITIES PRIOR TO CONSTRUCTION AND IF REQUIRED, DIG EXPLORATORY TEST PITS TO CONFIRM EXACT LOCATION AND DEPTH OF UTILITIES. CONTRACTOR SHALL NOTIFY DESIGN ENGINEER WITH ANY CONFLICTS AS NEEDED TO COORDINATE FINAL LOCATION OF ALL PROPOSED	F	PROPER DEPTHS ARE ACHIEVED. THE CONTRACTOR IS RESPONSIBLE FOR ENSURING THAT INSTALLATION OF ALL IMPROVEMENTS COMPLIES WITH ALL UTILITY REQUIREMENTS OF THE APPLICABLE JURISDICTION AND REGULATORY AGENCIES AND ALL OTHER APPLICABLE REQUIREMENTS, RULES, STATUTES, LAWS, ORDINANCES AND CODES AND, FURTHER, IS RESPONSIBLE FOR COORDINATING THE UTILITY TIE-INS/CONNECTIONS PRIOR TO CONNECTING TO THE EXISTING UTILITY/SERVICE. WHERE A CONFLICT(S) EXISTS BETWEEN THESE DOCUMENTS AND THE ARCHITECTURAL PLANS, OR WHERE ARCHITECTURAL PLAN UTILITY	HP INT INV
	IMPROVEMENTS. 21. CONTRACTOR SHALL INSPECT ALL EXISTING UTILITY STRUCTURES THAT ARE TO REMAIN FOR THE PROJECTS RE-USE TO VERIFY SUITABILITY FOR SAME. IF STRUCTURES CAN NOT BE REUSED THEN THE CONTRACTOR SHALL PROVIDE A NEW STRUCTURE. THE CONTRACTOR SHALL COORDINATE SUCH WORK WITH THE	F	CONNECTION POINTS DIFFER, THE CONTRACTOR MUST IMMEDIATELY NOTIFY THE ENGINEER OF RECORD, IN WRITING, AND PRIOR TO CONSTRUCTION, MUST RESOLVE SAME.	L.S.A. LOD LOW
)R E	APPLICABLE UTILITY PROVIDER. 22. CONTRACTOR TO REMOVE ANY BUILDING FOUNDATION REMAINS OR ASSOCIATED IMPROVEMENTS, DELETERIOUS MATERIALS, AND/OR DEBRIS THAT IMPEDE THE	C N	ALL FILL, COMPACTION, AND BACKFILL MATERIALS REQUIRED FOR UTILITY INSTALLATION MUST BE EXACTLY AS PER THE RECOMMENDATIONS PROVIDED IN THE SEOTECHNICAL REPORT AND THE CONTRACTOR MUST COORDINATE SAME WITH THE APPLICABLE UTILITY COMPANY SPECIFICATIONS. WHEN THE PROJECT DOES NOT HAVE GEOTECHNICAL RECOMMENDATIONS, FILL AND COMPACTION MUST COMPLY WITH APPLICABLE REQUIREMENTS AND SPECIFICATIONS. ENGINEER OF RECORD AND BOHLER ARE NOT RESPONSIBLE FOR DESIGN OF TRENCH BACKFILL OR FOR COMPACTION REQUIREMENTS	LF LP
	WORK SHOWN ON THESE PLANS. 23. THE CONTRACTOR SHALL REVIEW THE PLANS VERSUS THE LOCATION OF EXISTING STRUCTURES, UTILITIES AND APPURTENANCES IN THE FIELD TO CONFIRM ACCURACY OF SAME AND VERIFY ITEMS TO BE REMOVED. THE CONTRACTOR SHALL CARRY COSTS FOR REMOVAL OF ANY EXISTING STRUCTURES,	(DURING THE INSTALLATION OF SANITARY, STORM, AND ALL UTILITIES, THE CONTRACTOR MUST MAINTAIN A CONTEMPORANEOUS AND THOROUGH RECORD OF CONSTRUCTION TO IDENTIFY THE AS-INSTALLED LOCATIONS OF ALL UNDERGROUND INFRASTRUCTURE. THE CONTRACTOR MUST CAREFULLY NOTE ANY NSTALLATIONS THAT DEVIATE. IN ANY RESPECT. FROM THE INFORMATION CONTAINED IN THESE PLANS. THIS RECORD MUST BE KEPT ON A CLEAN COPY OF THE	MAX MEP
	APPURTENANCES, AND UNDERGROUND UTILITIES, INCLUDING BUT NOT LIMITED TO, DRAIN, WATER, SEWER, STEAM, IRRIGATION, GAS, TELECOM AND ELECTRIC.	Å	APPROPRIATE PLANS, WHICH THE CONTRACTOR MUST PROMPTLY PROVIDE TO THE OWNER IMMEDIATELY UPON THE COMPLETION OF WORK.	ME MIN No. / #
ED	CONSULTANT (TYP.) 25. WHERE THE LIMIT OF WORK COINCIDES WITH PROPERTY LINE, TREE LINE, PROPOSED SAWCUT OR COMBINATION THEREOF IT IS SHOWN ADJACENT TO THESE FEATURES FOR GRAPHICAL CLARITY.	I	ARE REPAIRED IN ACCORDANCE WITH REFERENCED MUNICIPAL, COUNTY AND OR STATE DOT DETAILS AS APPLICABLE. THE CONTRACTOR MUST COORDINATE NSPECTION AND APPROVAL OF COMPLETED WORK WITH THE AGENCY WITH JURISDICTION OVER SAME.	± PC
,	26. EXISTING TREES TO REMAIN ARE TO BE PROTECTED DURING CONSTRUCTION UNLESS CLEARLY INDICATED OTHERWISE. REASONABLE CARE AND CAUTION SHALL BE TAKEN DURING CONSTRUCTION TO PREVENT DAMAGE AND SELECTIVE PRUNING MAY BE REQUIRED TO ENSURE THAT TREES DO NOT CONFLICT WITH THE	F	INAL LOCATIONS OF PROPOSED UTILITY POLES, AND/ OR POLES TO BE RELOCATED ARE AT THE SOLE DISCRETION OF THE RESPECTIVE UTILITY COMPANY, REGARDLESS OF WHAT THIS PLAN DEPICTS. WATER SERVICE MATERIALS, BURIAL DEPTH, AND COVER REQUIREMENTS MUST BE SPECIFIED BY THE LOCAL UTILITY COMPANY. THE CONTRACTOR MUST	PT PT PVI
	DEVELOPMENT. 27. CONTRACTOR SHALL REPAIR/REPLACE ANY TRAFFIC LOOP DETECTORS THAT ARE DAMAGED DURING CONSTRUCTION WITHIN EXISTING OR PROPOSED RIGHTS OF WAYS. ANY SUCH WORK SHALL BE PERFORMED BY A LICENSED / DOT APPROVED SIGNAL CONTRACTOR. ANY DAMAGED LOOPS OR OTHER SIGNAL EQUIPMENT	12. 1	CONTACT THE APPLICABLE MUNICIPALITY TO CONFIRM THE PROPER WATER METER AND VAULT, PRIOR TO COMMENCING CONSTRUCTION. THE TOPS OF EXISTING MANHOLES, INLET STRUCTURES, AND SANITARY CLEANOUT MUST BE ADJUSTED, AS NECESSARY, TO MATCH PROPOSED FINISHED GRADES WITH NO TRIPPING OR SAFETY HAZARD IN ACCORDANCE WITH ALL APPLICABLE STANDARDS. REQUIREMENTS. RULES. STATUTES. LAWS. ORDINANCES AND CODES	
	SHALL BE REPAIRED IMMEDIATELY AFTER THE WORK IS COMPLETE. THE SIGNAL CONTRACTOR SHALL BE AVAILABLE TO MAKE ANY TEMPORARY SIGNAL CHANGES IF REQUESTED BY DOT AND/OR THE MUNICIPALITY. 28. THE CONTRACTOR MUST FIELD VERIFY THE LOCATIONS WHERE PROPOSED UTILITIES CROSS EXISTING UNDERGROUND UTILITIES BY USING A TEST PIT TO	13. 1	THE CONTRACTOR'S PRICE FOR WATER AND SEWER SERVICE INSTALLATIONS MUST INCLUDE ALL FEES, COSTS, AND APPURTENANCES REQUIRED BY THE UTILITY PROVIDER (AND OTHER AGENCIES HAVING JURISDICTION OVER THE WORK) TO PROVIDE FULL AND COMPLETE WORKING SERVICE, INCLUDING (BUT NOT LIMITED	RCP R.O.W.
ON HE	DETERMINE THE EXACT SIZE, DEPTH AND LOCATION, PRIOR TO COMMENCEMENT OF CONSTRUCTION. 29. CONTRACTOR SHALL LOCATE ANY EXISTING UTILITY SERVICES THAT ARE TO BE TERMINATED AT THE EXISTING MAIN AND/OR PROPERTY LINE. THESE SERVICES	E	TO) NECESSARY FEES, TESTING, DISINFECTING, INSPECTIONS, ROAD OPENING & BACKFILL REQUIREMENTS, TRAFFIC CONTROL AND SURETY BONDS AS DEFINED BY THE PROVIDER (AND OTHER AGENCIES HAVING JURISDICTION OVER THE WORK). ALL WORK ASSOCIATED WITH UTILITY POLES. OVERHEAD WIRES AND ANY/ALL APPURTENANCES SHALL BE COORDINATED BY THE GC WITH THE LOCAL UTILITY	SAN SMH S
	ARE TO BE TERMINATED IN ACCORDANCE WITH MUNICIPAL / STATE TRANSPORTATION DEPARTMENT REQUIREMENTS. GENERAL SITE NOTES	(COMPANIES PRIOR TO THE ORDERING OF ANY MATERIALS. THIS MAY INCLUDE BUT IS NOT LIMITED TO THE REMOVAL, INSTALLATION, RELOCATION OR PROTECTION OF ANY BRACING, GUY WIRES, OVERHEAD WIRES, ETC. AS MAY BE REQUIRED TO ACCOMMODATE THE PROJECT.	SF SGC STA
	1. THE GENERAL NOTES MUST BE INCLUDED AS PART OF THIS ENTIRE DOCUMENT PACKAGE AND ARE PART OF THE CONTRACT DOCUMENTS. THE GENERAL NOTES ARE REFERENCED HEREIN, AND THE CONTRACTOR MUST REFER TO THEM AND FULLY COMPLY WITH THESE NOTES, IN THEIR ENTIRETY. THE CONTRACTOR MUST BE FAMILIAR WITH AND ACKNOWLEDGE FAMILIARITY WITH ALL OF THE GENERAL NOTES AND ALL OF THE PLANS' SPECIFIC NOTES.	5	SEWERS CONVEYING SANITARY FLOW, OR INDUSTRIAL FLOW MUST BE SEPARATED FROM WATER MAINS BY A DISTANCE OF AT LEAST 10 FEET HORIZONTALLY. IF SUCH LATERAL SEPARATION IS NOT POSSIBLE, THE PIPES MUST, AT A MINIMUM, BE IN SEPARATE TRENCHES WITH THE AT LEAST 18 INCHES OF VERTICAL SEPARATION FROM THE BOTTOM OF THE WATER MAIN TO THE TOP OF THE SEWER LINE. WHERE APPROPRIATE SEPARATION FROM A WATER MAIN IS NOT OSSIBLE. THE SEWER MUST BE ENCASED IN CONCRETE. OR CONSTRUCTED OF DUCTILE IRON PIPE USING MECHANICAL OR SLIP-ON JOINTS FOR A DISTANCE OF	STM TBR
	2. PRIOR TO THE COMMENCEMENT OF GENERAL CONSTRUCTION, THE CONTRACTOR MUST INSTALL SOIL EROSION CONTROL AND ANY STORMWATER POLLUTION PREVENTION PLAN (SWPPP) MEASURES NECESSARY, AS INDICATED ON THE APPROVED SOIL EROSION AND SEDIMENT CONTROL PLAN AND IN ACCORDANCE WITH	A F	T LEAST 10 FEET ON EITHER SIDE OF THE CROSSING. IN ADDITION, ONE FULL LENGTH OF SEWER PIPE SHOULD BE LOCATED SO BOTH JOINTS WILL BE AS FAR ROM THE WATER LINE AS POSSIBLE. WHERE A WATER MAIN CROSSES UNDER A SANITARY SEWER, ADEQUATE STRUCTURAL SUPPORT FOR THE SANITARY SEWER MUST BE PROVIDED. ALL CROSSINGS SHALL BE IN ACCORDANCE WITH JURISDICTIONAL PERMITTING/UTILITY AUTHORITIES REGULATIONS.	TBR/R TC TW
D F	APPLICABLE AND/OR APPROPRIATE AGENCIES' GUIDELINES TO PREVENT SEDIMENT AND/OR LOOSE DEBRIS FROM WASHING ONTO ADJACENT PROPERTIES OR THE RIGHT OF WAY.	I	WHEN THESE PLANS INVOLVE MULTIPLE BUILDINGS, SOME OF WHICH MAY BE BUILT AT A LATER DATE, THE CONTRACTOR MUST EXTEND ALL UTILITY SERVICES, NCLUDING BUT NOT LIMITED TO STORM, SANITARY, UTILITIES, AND IRRIGATION LINES, TO A POINT AT LEAST FIVE (5) FEET BEYOND THE PAVED AREAS FOR WHICH THE CONTRACTOR IS RESPONSIBLE. THE CONTRACTOR MUST CAP ENDS OF INSTALLED UTILITIES AS APPROPRIATE. MARK UTILITY ENDS WITH MAGENTIC TRACER	TPF TRANS TYP.
,	 ALL DIRECTIONAL/TRAFFIC SIGNING AND PAVEMENT STRIPING MUST CONFORM TO THE LATEST STANDARDS OF THE MANUAL ON UNIFORM TRAFFIC CONTROL DEVICES (MUTCD) AND ANY APPLICABLE STATE OR LOCALLY APPROVED SUPPLEMENTS, GUIDELINES, RULES, REGULATIONS, STANDARDS AND THE LIKE. THE LOCATIONS OF PROPOSED UTILITY POLES AND TRAFFIC SIGNS SHOWN ON THE PLANS ARE SCHEMATIC AND PRELIMINARY. THE CONTRACTOR IS SOLELY 	1 [THE CONTRACTOR IS RESPONSIBLE. THE CONTRACTOR MOST CAP ENDS OF INSTALLED UTILITIES AS APPROPRIATE, MARK UTILITY ENDS WITH A 2X4 STAKE, AND MUST NOTE THE LOCATION OF ALL UTILITY STUBS ON A CLEAN COPY OF THE PLAN. THIS RECORD DOCUMENT MUST BE PREPARED IN A NEAT AND WORKMAN-LIKE MANNER AND TURNED OVER TO THE OWNER/DEVELOPER UPON COMPLETION OF THE WORK, ALL DF WHICH IS AT THE CONTRACTOR'S SOLE COST.	UG / U V.I.F.
то	RESPONSIBLE FOR FIELD-VERIFYING THEIR LOCATION. THE CONTRACTOR MUST COORDINATE THE RELOCATION OF TRAFFIC SIGNS WITH THE ENTITY WITH JURISDICTION OVER THE PROJECT.		STORM AND SANITARY PIPE LENGTHS INDICATED ARE NOMINAL AND ARE MEASURED FROM CENTER OF STRUCTURE TO CENTER OF STRUCTURE UNLESS NDICATED ON THE PLANS OTHERWISE.	VGC W
/E. _E		L 19. S	UNLESS INDICATED OTHERWISE, ALL NEW UTILITIES/SERVICES, INCLUDING ELECTRIC, TELEPHONE, CABLE TV, ETC., MUST BE INSTALLED UNDERGROUND. ALL NEW UTILITY SERVICES MUST BE INSTALLED IN ACCORDANCE WITH THE UTILITY SERVICE PROVIDER INSTALLATION SPECIFICATIONS AND STANDARDS. SANITARY PIPE MUST BE POLYVINYL CHLORIDE (PVC) SDR 35 EXCEPT WHERE CLEARLY INDICATED OTHERWISE. SANITARY LATERAL(S) MUST BE PVC SDR 26	,
ΙY	START OF CONSTRUCTION. LAND DISTURBING ACTIVITIES MUST NOT COMMENCE UNTIL APPROVAL TO DO SO HAS BEEN RECEIVED FROM GOVERNING AUTHORITIES (INCLUDING STORMWATER POLLUTION PREVENTION PLAN). THE CONTRACTOR MUST STRICTLY ADHERE TO THE APPROVED SWPPP PLAN DURING CONSTRUCTION OPERATIONS (IF PROVIDED).	20. L	JNLESS CLEARLY INDICATED OTHERWISE. JNLESS CLEARLY INDICATED OTHERWISE, ALL STORM PIPE MUST BE REINFORCED CONCRETE PIPE (RCP) CLASS III WITH SILT/SOIL TIGHT JOINTS. WHEN HIGH-DENSITY POLYETHYLENE PIPE (HDPE) IS CALLED FOR ON THE PLANS, IT MUST CONFORM TO AASHTO M252 FOR PIPES 4" TO 10" AND TO AASHTO M294 FOR	
	 ALL CONCRETE MUST BE AIR ENTRAINED AND INCLUDE THE MINIMUM COMPRESSIVE STRENGTH OF JURISDICTIONAL STANDARD PSI AT 28 DAYS (OR 4,000 PSI) UNLESS OTHERWISE NOTED ON THE PLANS, DETAILS AND/OR GEOTECHNICAL REPORT. 	F	HIGH-DENSITY POLYETHYLENE PIPE (HDPE) IS CALLED FOR ON THE PLANS, IT MUST CONFORM TO AASHTO M252 FOR PIPES 4" TO 10" AND TO AASHTO M294 FOR PIPES 12" TO 60" AND TYPE S (SMOOTH INTERIOR WITH ANGULAR CORRUGATIONS) WITH GASKET FOR SILT/SOIL TIGHT JOINT. PIPE FOR ROOF DRAIN CONNECTION MUST BE SDR 26 PVC OR SCHEDULE 40 UNLESS INDICATED OTHERWISE. HDPE PIPE JOINT GASKETS MUST BE PROVIDED AND CONFORM TO ASTM F477. DRAIN PIPE NSTALLED WITH OVER TEN (10) FEET OVER COVER AND/OR IN HIGH GROUNDWATER CONDITIONS SHALL BE SANITITE HP POLYPROPOPYLENE PIPE (PP), OR	E
/	8. THE CONTRACTOR MUST FILE SITE SIGNAGE APPLICATION OR PERMIT UNDER SEPARATE APPLICATION UNLESS DONE SO AS PART OF JURISDICTIONAL PERMITTING PROCEDURES. 9. THE CONTRACTOR MUST PERAIR OR PERIAD OR PERIAD OF PERMIT PROCEDURES AND EXPENSE	4 21. l	APPROVED EQUIVALENT.	
٩L	 THE CONTRACTOR MUST REPAIR OR REPLACE, AT THE CONTRACTOR'S SOLE COST AND EXPENSE, ALL SIDEWALKS, CURBS, PAVEMENT MARKINGS, AND PAVEMENT DAMAGED BY CONSTRUCTION ACTIVITIES WHETHER SPECIFIED ON THIS PLAN OR NOT. WORK WITHIN THE RIGHT-OF-WAY MUST BE PERFORMED IN ACCORDANCE WITH ALL APPLICABLE REQUIREMENTS AND STANDARDS OF THE DEPARTMENT OF 	21.2 21.3	 FOR PIPES LESS THAN 12 FEET DEEP: POLYVINYL CHLORIDE (PVC) SDR 35 PER ASTM D3034. FOR PIPES GREATER THAN 12 FEET DEEP: POLYVINYL CHLORIDE (PVC) SDR 26 PER ASTM D3034. UNLESS LOCAL OR STATE BUILDING / PLUMBING CODE CLEARLY SPECIFIES DIFFERENTLY, SANITARY LATERALS MUST BE PVC SDR 26. FOR ALL UTILITY PIPING (INCLUDING DRAIN) WITHIN 10 FT OF A BUILDING, PIPE MATERIAL SHALL COMPLY WITH APPLICABLE LOCAL OR STATE BUILDING AND 	
E R	PUBLIC WORKS, ENGINEERING DEPARTMENT, HIGHWAY DIVISION, AND/OR STATE DOT HIGHWAY DEPARTMENT. 11. WHERE RETAINING WALLS ARE IDENTIFIED ON THE PLANS, TOP AND BOTTOM OF WALL WIDTHS DO NOT REPRESENT THE ACTUAL WIDTH OF THE PROPOSED WALL, RATHER THEY ARE AN ASSUMPTION BASED ON WALL TYPE AND WALL HEIGHT. WALL FOOTINGS AND /OR FOUNDATIONS ARE NOT IDENTIFIED HEREIN AND ARE TO		PLUMBING CODES. CONTRACTOR SHALL RÉFER TO PLUMBING ENGINEERING PLANS AND VERIFY PIPE MATERIAL WITH LOCAL OFFICIAL PRIOR TO ORDERING OF MATERIALS. 5. CONTRACTOR SHALL VERIFY THE CONNECTION OF EXTERIOR PIPING TO ANY FIXTURES (SUCH AS AN EXTERIOR GREASE INTERCEPTOR) OR OTHER DRAINAGE	
ſ' ER	BE SET/DETERMINED BY THE CONTRACTOR OR WALL DESIGNER, AND MUST BE SET BASED UPON FINAL STRUCTURAL DESIGN SHOP DRAWINGS PREPARED BY THE APPROPRIATE PROFESSIONAL LICENSED IN THE STATE WHERE THE CONSTRUCTION OCCURS. THE CONTRACTOR MUST ENSURE THAT AN APPROPRIATELY LICENSED PROFESSIONAL DESIGNS ALL WALLS SHOWN HEREON AND PRIOR TO CONSTRUCTION. REFER TO GRADING NOTES REGARDING RETAINING WALL	5	SYSTEMS WITH LOCAL OFFICIALS FOR COMPLIANCE WITH APPLICABLE LOCAL OR STATE BUILDING AND PLUMBING CODES PRIOR TO ORDERING OF MATERIALS WATER MAIN PIPING MUST BE INSTALLED IN ACCORDANCE WITH THE REQUIREMENTS AND SPECIFICATIONS OF THE LOCAL WATER COMPANY. IN THE ABSENCE OF SUCH REQUIREMENTS, WATER MAIN PIPING MUST BE CEMENT-LINED DUCTILE IRON (DIP) MINIMUM CLASS 52 THICKNESS. ALL PIPE AND APPURTENANCES MUST	
	DESIGN. 12. CONTRACTOR IS CAUTIONED OF EXISTING UTILITY SERVICES TO REMAIN IN PROXIMITY TO PROPOSED BOLLARDS AND SIGNS. CONTRACTOR SHALL PROVIDE FIELD MODIFICATION LOCATIONS OF BOLLARDS AND BOLLARDS WITH SIGNAGE AS NEEDED TO AVOID CONFLICTS WITH EXISTING UTILITY SERVICES TO REMAIN.		COMPLY WITH THE APPLICABLE AWWA STANDARDS IN EFFECT AT THE TIME OF APPLICATION. GAS METERS MUST BE PROTECTED AS REQUIRED BY THE JURISDICTIONAL GAS PROVIDER.	

- MODIFICATION LOCATIONS OF BOLLARDS AND BOLLARDS WITH SIGNAGE AS NEEDED TO AVOID CONFLICTS WITH EXISTING UTILITY SERVICES TO REMAIN

ADA INSTRUCTIONS TO CONTRACTOR:

INCLUDE, BUT ARE NOT LIMITED TO THE FOLLOWING:

ALL ACCESSIBLE (A.K.A. ADA) COMPONENTS AND ACCESSIBLE ROUTES MUST BE CONSTRUCTED TO MEET, AT A MINIMUM, THE MORE STRINGENT OF: (A) THE REQUIREMENTS OF THE "AMERICANS WITH DISABILITIES ACT" (ADA) CODE (42 U.S.C. § 12101 ET SEQ. AND 42 U.S.C. § 4151 ET SEQ.); AND (B) ANY APPLICABLE LOCAL AND STATE GUIDELINES, AND ANY AND ALL AMENDMENTS TO BOTH, WHICH ARE IN EFFECT WHEN THESE PLANS WERE COMPLETED. THE CONTRACTOR MUST REVIEW ALL DOCUMENTS REFERENCED IN THESE NOTES FOR ACCURACY, COMPLIANCE AND CONSISTENCY WITH INDUSTRY

GUIDELINES THE CONTRACTOR MUST EXERCISE APPROPRIATE CARE AND PRECISION IN CONSTRUCTION OF ACCESSIBLE (ADA) COMPONENTS AND ACCESSIBLE ROUTES FOR THE SITE. FINISHED SURFACES ALONG THE ACCESSIBLE ROUTE OF TRAVEL FROM PARKING SPACES, PUBLIC TRANSPORTATION, PEDESTRIAN ACCESS, AND INTER-BUILDING ACCESS, TO POINTS OF ACCESSIBLE BUILDING ENTRANCE/EXIT, MUST COMPLY WITH THE ACCESSIBLE GUIDELINES AND REQUIREMENTS WHICH

ACCESSIBLE PARKING SPACES AND ACCESS AISLES SLOPES MUST NOT EXCEED 1:50 (2.0%) IN ANY DIRECTION. PATH OF TRAVEL ALONG ACCESSIBLE ROUTE MUST PROVIDE A 36-INCHES MINIMUM WIDTH (48-INCHES PREFERRED), OR AS SPECIFIED BY THE GOVERNING AGENCY, UNOBSTRUCTED WIDTH OF TRAVEL (CAR OVERHANGS AND/OR HANDRAILS) MUST NOT REDUCE THIS MINIMUM WIDTH. THE SLOPE MUST NOT EXCEED 1:20 (5.0%) IN THE DIRECTION OF TRAVEL AND MUST NOT EXCEED 1:50 (2.0%) IN CROSS SLOPE. WHERE ACCESSIBLE PATH OF TRAVEL IS GREATER THAN 1:20 (5.0%), AN ACCESSIBLE RAMP MUST BE PROVIDED. ALONG THE ACCESSIBLE PATH OF TRAVEL, OPENINGS MUST NOT EXCEED 1/2-INCH IN WIDTH. VERTICAL CHANGES OF UP TO 1/2-INCH ARE PERMITTED ONLY IF THEY INCLUDES A 1/4-INCH BEVEL AT A SLOPE NOT STEEPER THAN 1:2. NO VERTICAL

CHANGES OVER 1/4-INCH ARE PERMITTED. ACCESSIBLE RAMPS MUST NOT EXCEED A SLOPE OF 1:12 (8.3%) AND A RISE OF 30-INCHES. LEVEL LANDINGS MUST BE PROVIDED AT EACH END OF ACCESSIBLE RAMPS. LANDING MUST PROVIDE POSITIVE DRAINAGE AWAY FROM STRUCTURES, AND MUST NOT EXCEED 1:50 (2.0%) SLOPE IN ANY DIRECTION. RAMPS THAT CHANGE DIRECTION BETWEEN RUNS AT LANDINGS MUST HAVE A CLEAR LANDING OF A MINIMUM OF 60-INCHES BY 60-INCHES. HAND RAILS ON BOTH SIDES OF THE RAMP MUST BE PROVIDED ON AN ACCESSIBLE RAMP WITH A RISE GREATER THAN 6-INCHES. ACCESSIBLE CURB RAMPS MUST NOT EXCEED A SLOPE OF 1:12 (8.3%). WHERE FLARED SIDES ARE PROVIDED, THEY MUST NOT EXCEED 1:10 (10%) SLOPE. LEVEL LANDING MUST BE PROVIDED AT RAMPS TOP AT A MINIMUM OF 36-INCHES LONG (48-INCHES PREFERRED). IN ALTERATIONS, WHEN THERE IS NO LANDING AT THE TOP. FLARE SIDES SLOPES MUST NOT EXCEED A SLOPE OF 1:12 (8.3%). DOORWAY LANDINGS AREAS MUST BE PROVIDED ON THE EXTERIOR SIDE OF ANY DOOR LEADING TO AN ACCESSIBLE PATH OF TRAVEL. THIS LANDING MUST


BE SLOPED AWAY FROM THE DOOR NO MORE THAN 1:50 (2.0%) FOR POSITIVE DRAINAGE. THIS LANDING AREA MUST BE NO FEWER THAN 60-INCHES (5 FEET) LONG, EXCEPT WHERE OTHERWISE CLEARLY PERMITTED BY ACCESSIBLE STANDARDS FOR ALTERNATIVE DOORWAY OPENING CONDITIONS. (SEE ICC/ANSI A117.1-2009 AND OTHER REFERENCES INCORPORATED BY CODE). WHEN THE PROPOSED CONSTRUCTION INVOLVES RECONSTRUCTION, MODIFICATION, REVISION OR EXTENSION OF OR TO ACCESSIBLE COMPONENTS FROM EXISTING DOORWAYS OR SURFACES, THE CONTRACTOR MUST VERIFY ALL EXISTING ELEVATIONS SHOWN ON THE PLAN. NOTE THAT TABLE 405.2 OF THE DEPARTMENT OF JUSTICE'S ADA STANDARDS FOR ACCESSIBLE DESIGN ALLOWS FOR STEEPER RAMP SLOPES. IN RARE CIRCUMSTANCES. THE CONTRACTO MUST IMMEDIATELY NOTIFY THE ENGINEER OF RECORD, IN WRITING, OF ANY DISCREPANCIES AND/OR FIELD CONDITIONS THAT DIFFER IN ANY WAY OR IN ANY RESPECT FROM WHAT IS SHOWN ON THE PLANS BEFORE COMMENCING ANY WORK. CONSTRUCTED IMPROVEMENTS MUST FALL WITHIN THE MAXIMUM AND MINIMUM LIMITATIONS IMPOSED BY THE BARRIER FREE REGULATIONS AND THE ACCESSIBLE GUIDELINES. THE CONTRACTOR MUST VERIFY ALL OF THE SLOPES OF THE CONTRACTOR'S FORMS PRIOR TO POURING CONCRETE. IF ANY NON-CONFORMANCE EXISTS OR IS OBSERVED OR DISCOVERED, THE CONTRACTOR MUST IMMEDIATELY NOTIFY THE ENGINEER OF RECORD, IN WRITING, PRIOR TO POURING CONCRETE. THE

EXISTIN

PROPOSED

PROPERTY LINE

CONTRACTOR IS SOLELY RESPONSIBLE FOR ALL COSTS TO REMOVE, REPAIR AND/OR REPLACE NON-CONFORMING CONCRETE AND/OR PAVEMENT SURFACES. IT IS STRONGLY RECOMMENDED THAT THE CONTRACTOR REVIEW THE INTENDED CONSTRUCTION TO ENSURE SAME IS CONSISTENT WITH THE LOCAL BUILDING CODE PRIOR TO COMMENCING CONSTRUCTION.

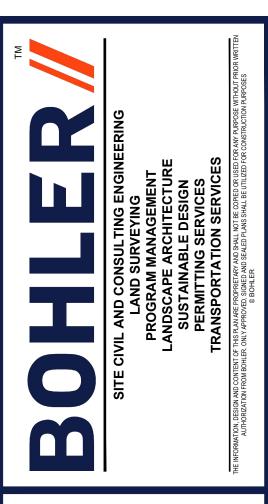

	F	REVISIONS	
REV	DATE	COMMENT	DRAWN BY
	DATE	COMMENT	CHECKED B
1	12/05/2022	PER ARCHITECT	TJN
'	12/05/2022	COORDINATION	CWE
2	12/21/2022	40% DESIGN	CAM
2	12/21/2022	DOCUMENTS	CWE
3	12/21/2022	PER DOT COMMENTS	TJN
3	12/21/2022	FER DOT COMMENTS	CWE
4	09/29/2023	DOT & BOROUGH	BTJ
4	09/29/2023	COORDINATION	CWE
5	11/22/2023	75% DESIGN	BTJ
5	11/22/2023	DOCUMENTS	CWE
6	01/11/2024	95% CONSTRUCTION	BTJ
0	01/11/2024	DOCUMENTS	CWE
7	02/13/2024	PER EVERSOURCE	TJN
'	02/13/2024	COORDINATION	CWE
8	02/27/2024	PER CHFA COMMENTS	BTJ
0	02/21/2024		GPF
9	04/12/2024	FMC APPLICATION	BTJ
9	04/12/2024	COMMENTS	CWE



ALWAYS CALL 811

It's fast. It's free. It's the law.

PERMIT SET

	OR MUNICIPAL AND/OR AGENCY
	OT INTENDED AS A CONSTRUCTION
DOCUMENT UNLESS I	NDICATED OTHERWISE.
PROJECT No.:	CTA220068.00
DRAWN BY:	BTJ
CHECKED BY:	GPF
DATE:	12/05/2022
CAD I.D.:	CTA220068.00-SPPD-7A

PROJECT:

PROPOSED SITE **PLAN DOCUMENTS**

— FOR —

PENNROSE. LLC

PROPOSED DEVELOPMENT


PARCEL 'B'

MAPLE STREET, BOROUGH OF NAUGATUCK, **NEW HAVEN COUNTY**,



65 LaSALLE ROAD, SUITE 401 WEST HARTFORD, CT 06107 Phone: (860) 333-8900

www.BohlerEngineering.com

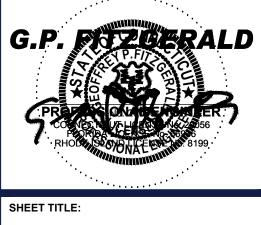

GENERAL NOTES SHEET

SHEET NUMB **C-102**

REVISION 9 - 04/12/2024


TYPICAL LINE TYPE LEGEND **ABBREVIATIONS**


AD	DRL VIA I IVINS
EY	DESCRIPTION
6 / ABVG	ABOVE GROUND
СН	ARCHITECT BACK OF CURB
C	BITUMINOUS CONCRETE CURB
1	BENCHMARK
C	BOTTOM OF CURB
/	BOTTOM OF WALL
DG	BUILDING
;	
B	CAPE COD BERM CONCRETE
NC. C	DECORATIVE
C	DEGREE
Р	DEPRESSED
' DIA	DIAMETER
1H	DRAIN MANHOLE
) 	
P	EXTRUDED CONCRETE CURB EDGE OF PAVEMENT
r EV	ELEVATION
ST.	EXISTING
	FINISH FLOOR
	FINISH FLOOR ELEVATION
	GENERAL CONTRACTOR
T	
PE	HIGH DENSITY POLYETHYLENE PIPE HIGH POINT
-	INTERSECTION
/	INVERT
.A.	LANDSCAPE AREA
D	LIMIT OF DISTURBANCE
W	LIMIT OF WORK
	LINEAR FOOT / FEET
X	LOW POINT MAXIMUM
	MECHANICAL, ELECTRICAL,
P	PLUMBING
	MEET OR MATCH EXISTING
N (#	MINIMUM
./#	NUMBER PLUS OR MINUS
	POINT OF CURVATURE
	POINT OF INTERSECTION
	POINT OF TANGENCY
	POINT OF VERTICAL INTERSECTION
C	POLYVINYL CHLORIDE PIPE
OP.	PROPOSED RADIUS OR RADII
P	REINFORCED CONCRETE PIPE
.W.	RIGHT-OF-WAY
N	SANITARY
IH	SEWER MANHOLE
	SLOPE
0	SQUARE FOOT
iC 4	SLOPED GRANITE CURB
N.	STORM
R	TO BE REMOVED
R/R	TO BE REMOVED AND REPLACED
	TOP OF CURB
/	TOP OF WALL
F	TREE PROTECTION FENCE
ANS P.	TRANSITION TYPICAL
/ UNDG	UNDERGROUND
.F.	VERIFY IN FIELD
C	VERTICAL GRANITE CURB
	WIDTH


	PROPOSED	
ADJACENT PROPERTY	EXISTING	
LINE	PROPOSED	
	EXISTING	
RIGHT-OF-WAY LINE		
	PROPOSED	
SETBACK OR BUFFER	EXISTING	
	PROPOSED	
	EXISTING	
EASEMENT LINE	PROPOSED	
	EXISTING	· · · · · ·
WETLAND BOUNDARY	PROPOSED	
WETLAND BUFFER	EXISTING	
	PROPOSED	
WATER WAY BOUNDARY	EXISTING	· · ·
WATER WAT BOONDART	PROPOSED	
	EXISTING	
WATERWAY BUFFER	PROPOSED	
		Λ
WETLAND OR WATERWAY FLAG	EXISTING	
RIGHT-OF-WAY CENTER	EXISTING	
OR BASE LINE	PROPOSED	
APPROX. LIMIT OF WORK	EXISTING	
OR DISTURBANCE	PROPOSED	
	EXISTING	
APPROX. SAWCUT LINE		
	PROPOSED	
TREE LINE	EXISTING	~~~~~~~~~~~~~~~~~~~~~~~~~~~~~~~~~~~~~~~
	PROPOSED	
SURFACE OR	EXISTING	
SUBSURFACE BASIN	PROPOSED	
	EXISTING	OH _OH
OVERHEAD WIRES		
	PROPOSED	ОНОНОНОН
	EXISTING	
CURBING	EXISTING PROPOSED	
CURBING	PROPOSED	CC/BCC MONOLITHIC VGC SGC TRANS/FLUSH CCB
	PROPOSED EXISTING	CC/BCC MONOLITHIC VGC SGC TRANS/FLUSH CCB
CURBING FENCE OR RAILING	PROPOSED	CC/BCC MONOLITHIC VGC SGC TRANS/FLUSH CCB
FENCE OR RAILING	PROPOSED EXISTING	X
FENCE OR RAILING	PROPOSED EXISTING PROPOSED EXISTING	X
FENCE OR RAILING	PROPOSED EXISTING PROPOSED EXISTING PROPOSED	X
FENCE OR RAILING	PROPOSED EXISTING PROPOSED EXISTING PROPOSED EXISTING	
FENCE OR RAILING	PROPOSED EXISTING PROPOSED EXISTING PROPOSED EXISTING PROPOSED	X
FENCE OR RAILING RETAINING WALL CONTOURS	PROPOSED EXISTING PROPOSED EXISTING PROPOSED EXISTING PROPOSED EXISTING	
FENCE OR RAILING RETAINING WALL CONTOURS	PROPOSED EXISTING PROPOSED EXISTING PROPOSED EXISTING PROPOSED	
FENCE OR RAILING RETAINING WALL CONTOURS SWALE	PROPOSED EXISTING PROPOSED EXISTING PROPOSED EXISTING PROPOSED EXISTING	CHAIN LINK STOCKADE RAILING
FENCE OR RAILING RETAINING WALL CONTOURS SWALE	PROPOSED EXISTING PROPOSED EXISTING PROPOSED EXISTING PROPOSED EXISTING PROPOSED	CHAIN LINK STOCKADE RAILING
FENCE OR RAILING RETAINING WALL CONTOURS SWALE BERM	PROPOSED EXISTING PROPOSED EXISTING PROPOSED EXISTING PROPOSED EXISTING PROPOSED EXISTING PROPOSED	CHAIN LINK STOCKADE RAILING
FENCE OR RAILING RETAINING WALL CONTOURS SWALE BERM	PROPOSED EXISTING PROPOSED EXISTING PROPOSED EXISTING PROPOSED EXISTING PROPOSED EXISTING PROPOSED EXISTING	CHAIN LINK STOCKADE RAILING
FENCE OR RAILING RETAINING WALL CONTOURS SWALE BERM	PROPOSED EXISTING PROPOSED EXISTING PROPOSED EXISTING PROPOSED EXISTING PROPOSED EXISTING PROPOSED EXISTING PROPOSED	
FENCE OR RAILING RETAINING WALL CONTOURS SWALE BERM RIDGE	PROPOSED EXISTING PROPOSED EXISTING PROPOSED EXISTING PROPOSED EXISTING PROPOSED EXISTING PROPOSED EXISTING PROPOSED EXISTING	CHAIN LINK STOCKADE RAILING 49 50 50 50 50 50
FENCE OR RAILING RETAINING WALL CONTOURS SWALE BERM RIDGE	PROPOSED EXISTING PROPOSED EXISTING PROPOSED EXISTING PROPOSED EXISTING PROPOSED EXISTING PROPOSED EXISTING PROPOSED	
FENCE OR RAILING RETAINING WALL CONTOURS SWALE BERM RIDGE DRAIN PIPE	PROPOSED EXISTING PROPOSED EXISTING PROPOSED EXISTING PROPOSED EXISTING PROPOSED EXISTING PROPOSED EXISTING PROPOSED EXISTING	CHAIN LINK STOCKADE RAILING 49 50 50 50 50 50
FENCE OR RAILING RETAINING WALL CONTOURS SWALE BERM RIDGE	PROPOSED EXISTING PROPOSED EXISTING PROPOSED EXISTING PROPOSED EXISTING PROPOSED EXISTING PROPOSED EXISTING PROPOSED EXISTING PROPOSED	CHAIN LINK STOCKADE RAILING 49 50 50 50 50 50
FENCE OR RAILING RETAINING WALL CONTOURS SWALE BERM RIDGE DRAIN PIPE SEWER PIPE	PROPOSED EXISTING PROPOSED EXISTING PROPOSED EXISTING PROPOSED EXISTING PROPOSED EXISTING PROPOSED EXISTING PROPOSED EXISTING PROPOSED EXISTING	CHAIN LINK STOCKADE RAILING CHAIN LINK STOCKADE 49 50 50 50 $$
FENCE OR RAILING RETAINING WALL CONTOURS SWALE BERM RIDGE DRAIN PIPE	PROPOSED EXISTING PROPOSED EXISTING PROPOSED EXISTING PROPOSED EXISTING PROPOSED EXISTING PROPOSED EXISTING PROPOSED EXISTING PROPOSED EXISTING PROPOSED EXISTING PROPOSED EXISTING	CHAIN LINK STOCKADE RAILING CHAIN LINK STOCKADE RAILING $ \begin{array}{c ccccccccccccccccccccccccccccccccccc$
FENCE OR RAILING RETAINING WALL CONTOURS SWALE BERM RIDGE DRAIN PIPE SEWER PIPE	PROPOSED EXISTING PROPOSED EXISTING PROPOSED EXISTING PROPOSED EXISTING PROPOSED EXISTING PROPOSED EXISTING PROPOSED EXISTING PROPOSED EXISTING PROPOSED EXISTING PROPOSED	CHAIN LINK STOCKADE RAILING CHAIN LINK STOCKADE RAILING 49 50 50 50 50 50 50 50 50 50 50 50
FENCE OR RAILING RETAINING WALL CONTOURS SWALE BERM RIDGE DRAIN PIPE SEWER PIPE	PROPOSED EXISTING PROPOSED EXISTING PROPOSED EXISTING PROPOSED EXISTING PROPOSED EXISTING PROPOSED EXISTING PROPOSED EXISTING PROPOSED EXISTING PROPOSED EXISTING PROPOSED EXISTING PROPOSED EXISTING	CHAIN LINK STOCKADE RAILING CHAIN LINK STOCKADE RAILING 49 50 50 50 50 50 50 50 50 50 50 50
FENCE OR RAILING RETAINING WALL CONTOURS SWALE BERM RIDGE DRAIN PIPE SEWER PIPE SEWER FORCE MAIN	PROPOSED EXISTING PROPOSED EXISTING PROPOSED EXISTING PROPOSED EXISTING PROPOSED EXISTING PROPOSED EXISTING PROPOSED EXISTING PROPOSED EXISTING PROPOSED EXISTING PROPOSED	$\begin{array}{c c c c c c c c c c c c c c c c c c c $
FENCE OR RAILING RETAINING WALL CONTOURS SWALE BERM RIDGE DRAIN PIPE SEWER PIPE SEWER FORCE MAIN ELECTRIC	PROPOSED EXISTING PROPOSED EXISTING PROPOSED EXISTING PROPOSED EXISTING PROPOSED EXISTING PROPOSED EXISTING PROPOSED EXISTING PROPOSED EXISTING PROPOSED EXISTING PROPOSED EXISTING PROPOSED EXISTING	CHAIN LINK STOCKADE RAILING CHAIN LINK STOCKADE RAILING 49 50 50 50 50 50 50 50 50 50 50 50
FENCE OR RAILING RETAINING WALL CONTOURS SWALE BERM RIDGE DRAIN PIPE SEWER PIPE SEWER FORCE MAIN	PROPOSED EXISTING PROPOSED EXISTING PROPOSED EXISTING PROPOSED EXISTING PROPOSED EXISTING PROPOSED EXISTING PROPOSED EXISTING PROPOSED EXISTING PROPOSED EXISTING PROPOSED EXISTING PROPOSED EXISTING PROPOSED	$\begin{array}{c c c c c c c c c c c c c c c c c c c $
FENCE OR RAILING RETAINING WALL CONTOURS SWALE BERM RIDGE DRAIN PIPE SEWER PIPE SEWER FORCE MAIN ELECTRIC TELECOMMUNICATIONS	PROPOSED EXISTING PROPOSED EXISTING PROPOSED EXISTING PROPOSED EXISTING PROPOSED EXISTING PROPOSED EXISTING PROPOSED EXISTING PROPOSED EXISTING PROPOSED EXISTING PROPOSED EXISTING PROPOSED EXISTING PROPOSED EXISTING PROPOSED	$\begin{array}{c c c c c c c c c c c c c c c c c c c $
FENCE OR RAILING RETAINING WALL CONTOURS SWALE BERM RIDGE DRAIN PIPE SEWER PIPE SEWER FORCE MAIN ELECTRIC	PROPOSED EXISTING PROPOSED EXISTING PROPOSED EXISTING PROPOSED EXISTING PROPOSED EXISTING PROPOSED EXISTING PROPOSED EXISTING PROPOSED EXISTING PROPOSED EXISTING PROPOSED EXISTING PROPOSED EXISTING PROPOSED EXISTING PROPOSED EXISTING PROPOSED EXISTING	$\begin{array}{c c c c c c c c c c c c c c c c c c c $
FENCE OR RAILING RETAINING WALL CONTOURS SWALE BERM RIDGE DRAIN PIPE SEWER PIPE SEWER FORCE MAIN ELECTRIC TELECOMMUNICATIONS	PROPOSED EXISTING PROPOSED EXISTING PROPOSED EXISTING PROPOSED EXISTING PROPOSED EXISTING PROPOSED EXISTING PROPOSED EXISTING PROPOSED EXISTING PROPOSED EXISTING PROPOSED EXISTING PROPOSED EXISTING PROPOSED EXISTING PROPOSED EXISTING PROPOSED EXISTING PROPOSED	$\begin{array}{c c c c c c c c c c c c c c c c c c c $
FENCE OR RAILING RETAINING WALL CONTOURS SWALE BERM RIDGE DRAIN PIPE SEWER PIPE SEWER FORCE MAIN ELECTRIC TELECOMMUNICATIONS CABLE TV	PROPOSED EXISTING PROPOSED EXISTING PROPOSED EXISTING PROPOSED EXISTING PROPOSED EXISTING PROPOSED EXISTING PROPOSED EXISTING PROPOSED EXISTING PROPOSED EXISTING PROPOSED EXISTING PROPOSED EXISTING PROPOSED EXISTING PROPOSED EXISTING PROPOSED EXISTING PROPOSED EXISTING PROPOSED EXISTING	$\begin{array}{c c c c c c c c c c c c c c c c c c c $
FENCE OR RAILING RETAINING WALL CONTOURS SWALE BERM RIDGE DRAIN PIPE SEWER PIPE SEWER FORCE MAIN ELECTRIC TELECOMMUNICATIONS	PROPOSED EXISTING PROPOSED EXISTING PROPOSED EXISTING PROPOSED EXISTING PROPOSED EXISTING PROPOSED EXISTING PROPOSED EXISTING PROPOSED EXISTING PROPOSED EXISTING PROPOSED EXISTING PROPOSED EXISTING PROPOSED EXISTING PROPOSED EXISTING PROPOSED EXISTING PROPOSED	$\begin{array}{c c c c c c c c c c c c c c c c c c c $
FENCE OR RAILING RETAINING WALL CONTOURS SWALE BERM RIDGE DRAIN PIPE SEWER PIPE SEWER FORCE MAIN ELECTRIC TELECOMMUNICATIONS CABLE TV GAS	PROPOSED EXISTING PROPOSED EXISTING PROPOSED EXISTING PROPOSED EXISTING PROPOSED EXISTING PROPOSED EXISTING PROPOSED EXISTING PROPOSED EXISTING PROPOSED EXISTING PROPOSED EXISTING PROPOSED EXISTING PROPOSED EXISTING PROPOSED EXISTING PROPOSED EXISTING PROPOSED EXISTING PROPOSED EXISTING	$\begin{array}{c c c c c c c c c c c c c c c c c c c $
FENCE OR RAILING RETAINING WALL CONTOURS SWALE BERM RIDGE DRAIN PIPE SEWER PIPE SEWER FORCE MAIN ELECTRIC TELECOMMUNICATIONS CABLE TV	PROPOSED EXISTING PROPOSED EXISTING PROPOSED EXISTING PROPOSED EXISTING PROPOSED EXISTING PROPOSED EXISTING PROPOSED EXISTING PROPOSED EXISTING PROPOSED EXISTING PROPOSED EXISTING PROPOSED EXISTING PROPOSED EXISTING PROPOSED EXISTING PROPOSED EXISTING PROPOSED EXISTING PROPOSED EXISTING PROPOSED	$\begin{array}{c c c c c c c c c c c c c c c c c c c $


REFER TO SITE LAYOUT PLAN FOR ZONING ANALYSIS TABLE AND LAND **USE / ZONING INFORMATION & NOTES**

REFER TO EROSION AND SEDIMENT CONTROL NOTES & DETAILS SHEET FOR TYPICAL EROSION NOTES AND DETAILS

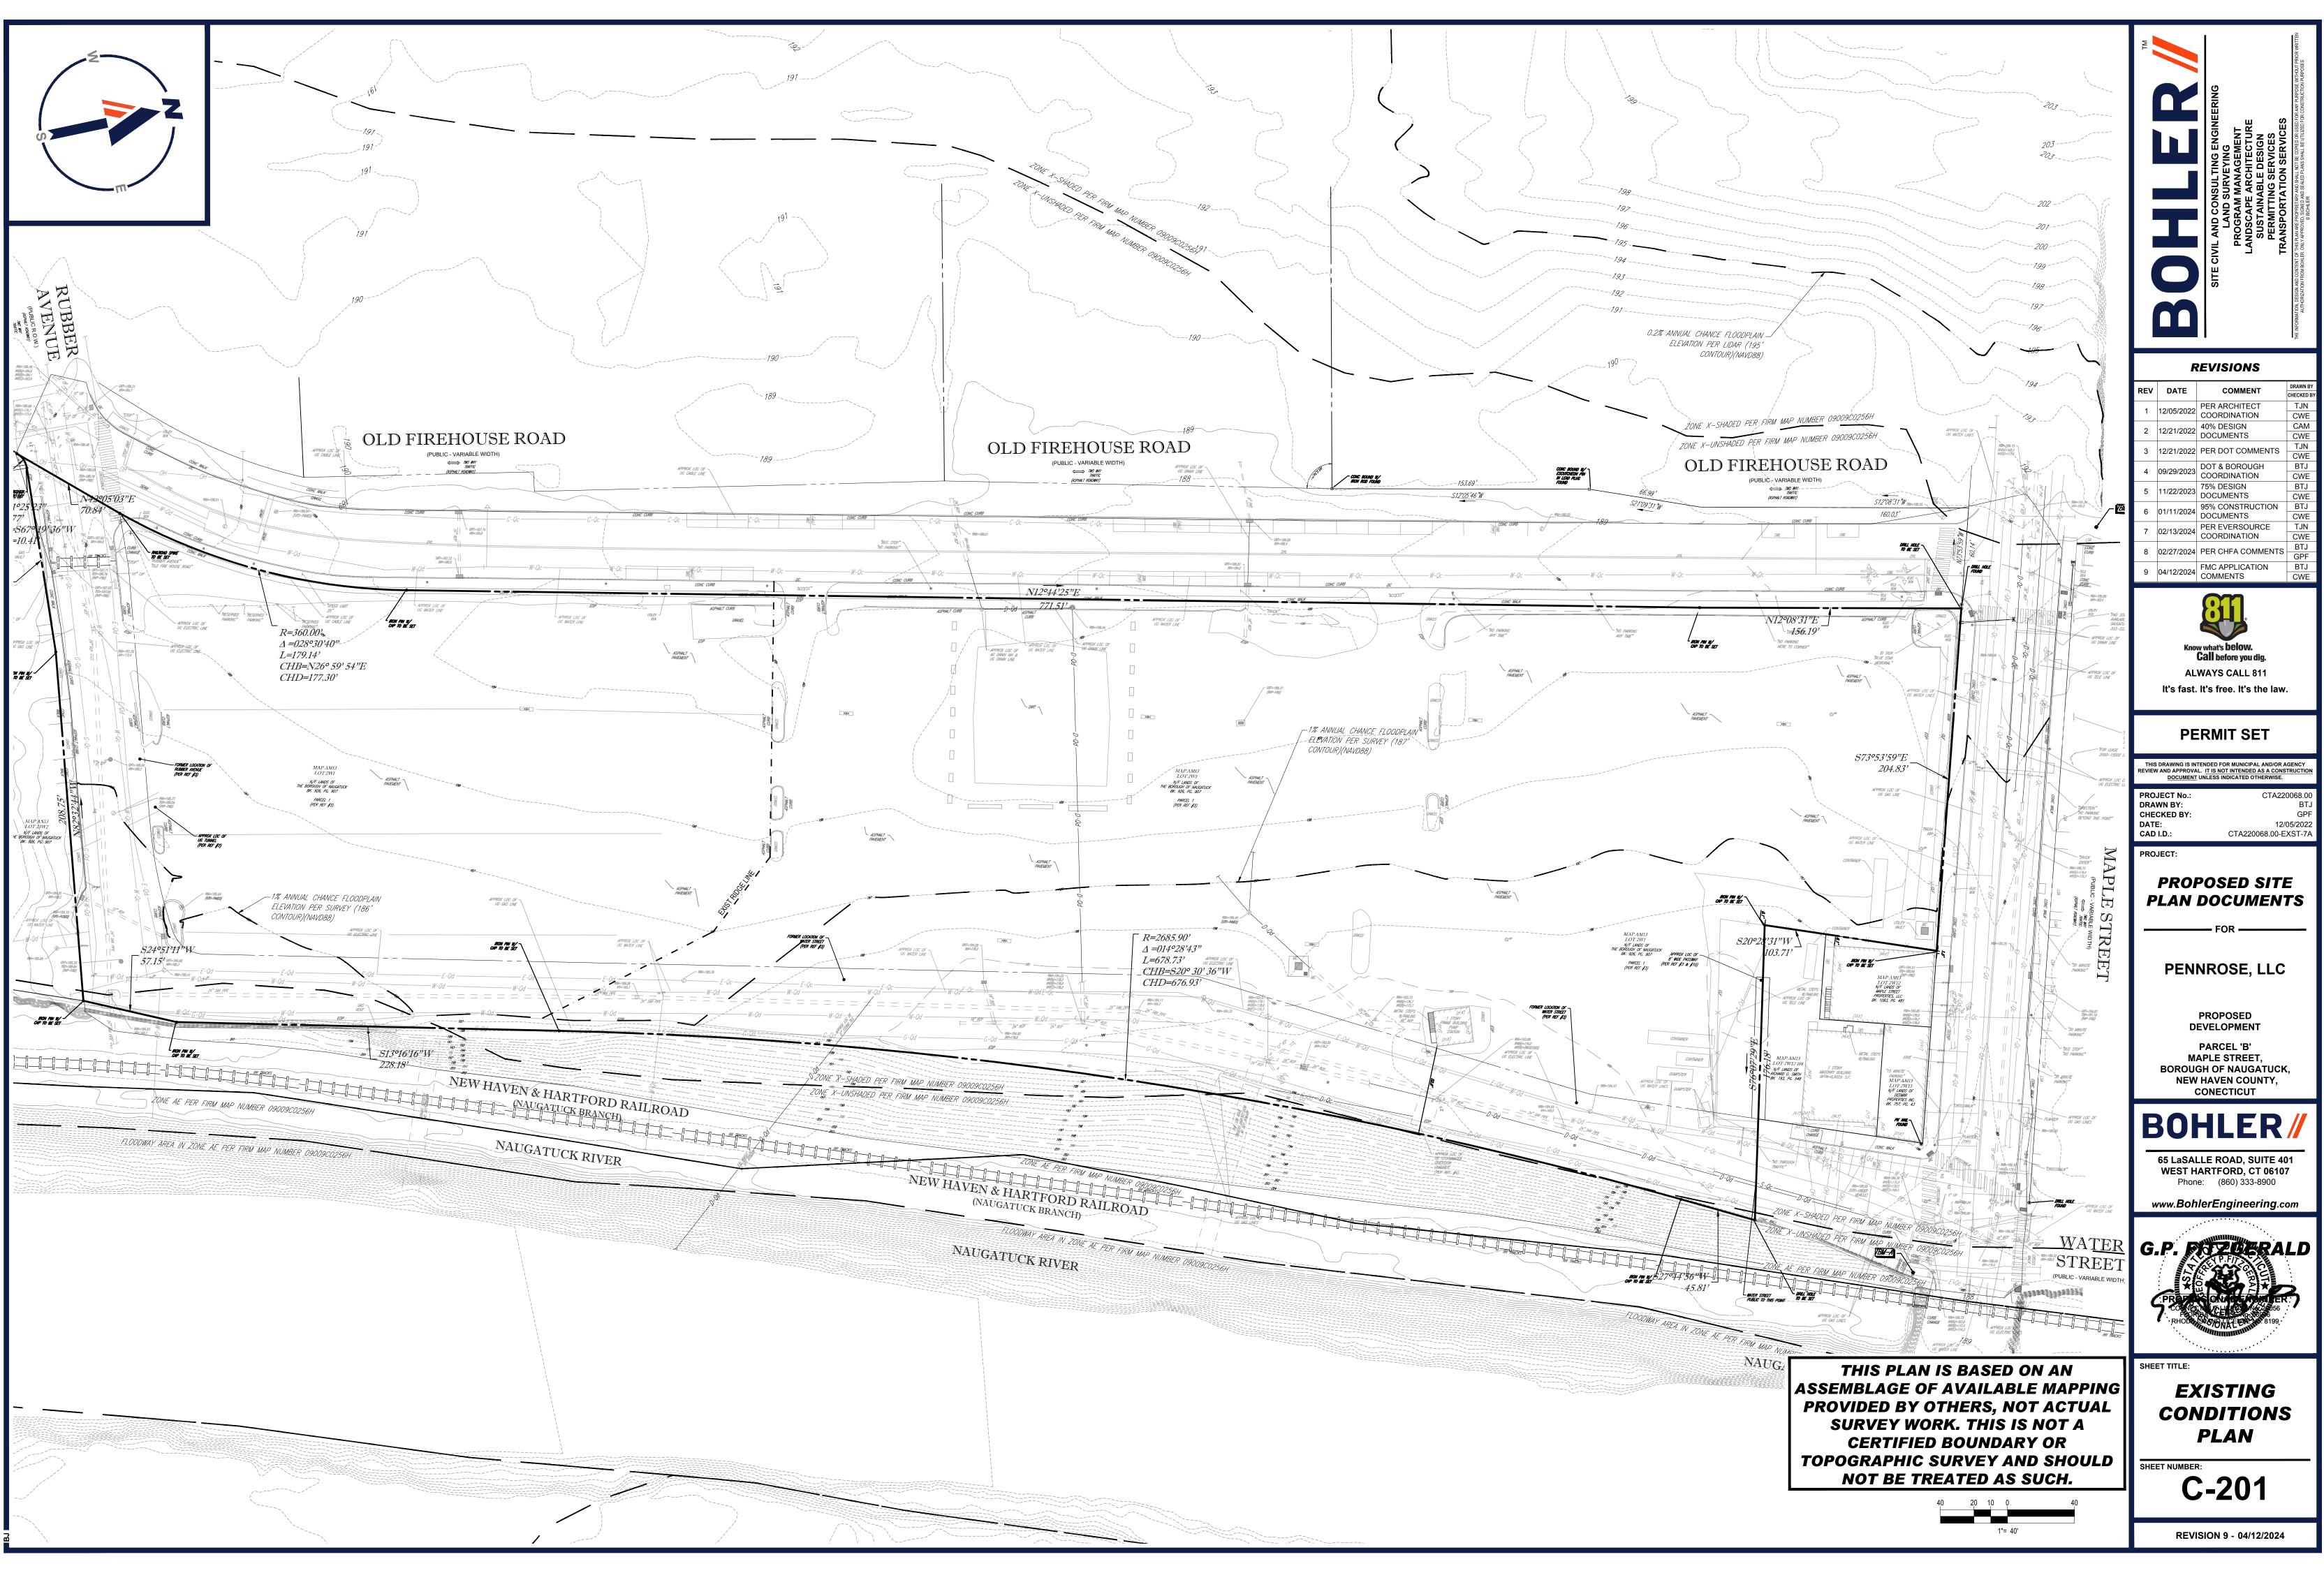


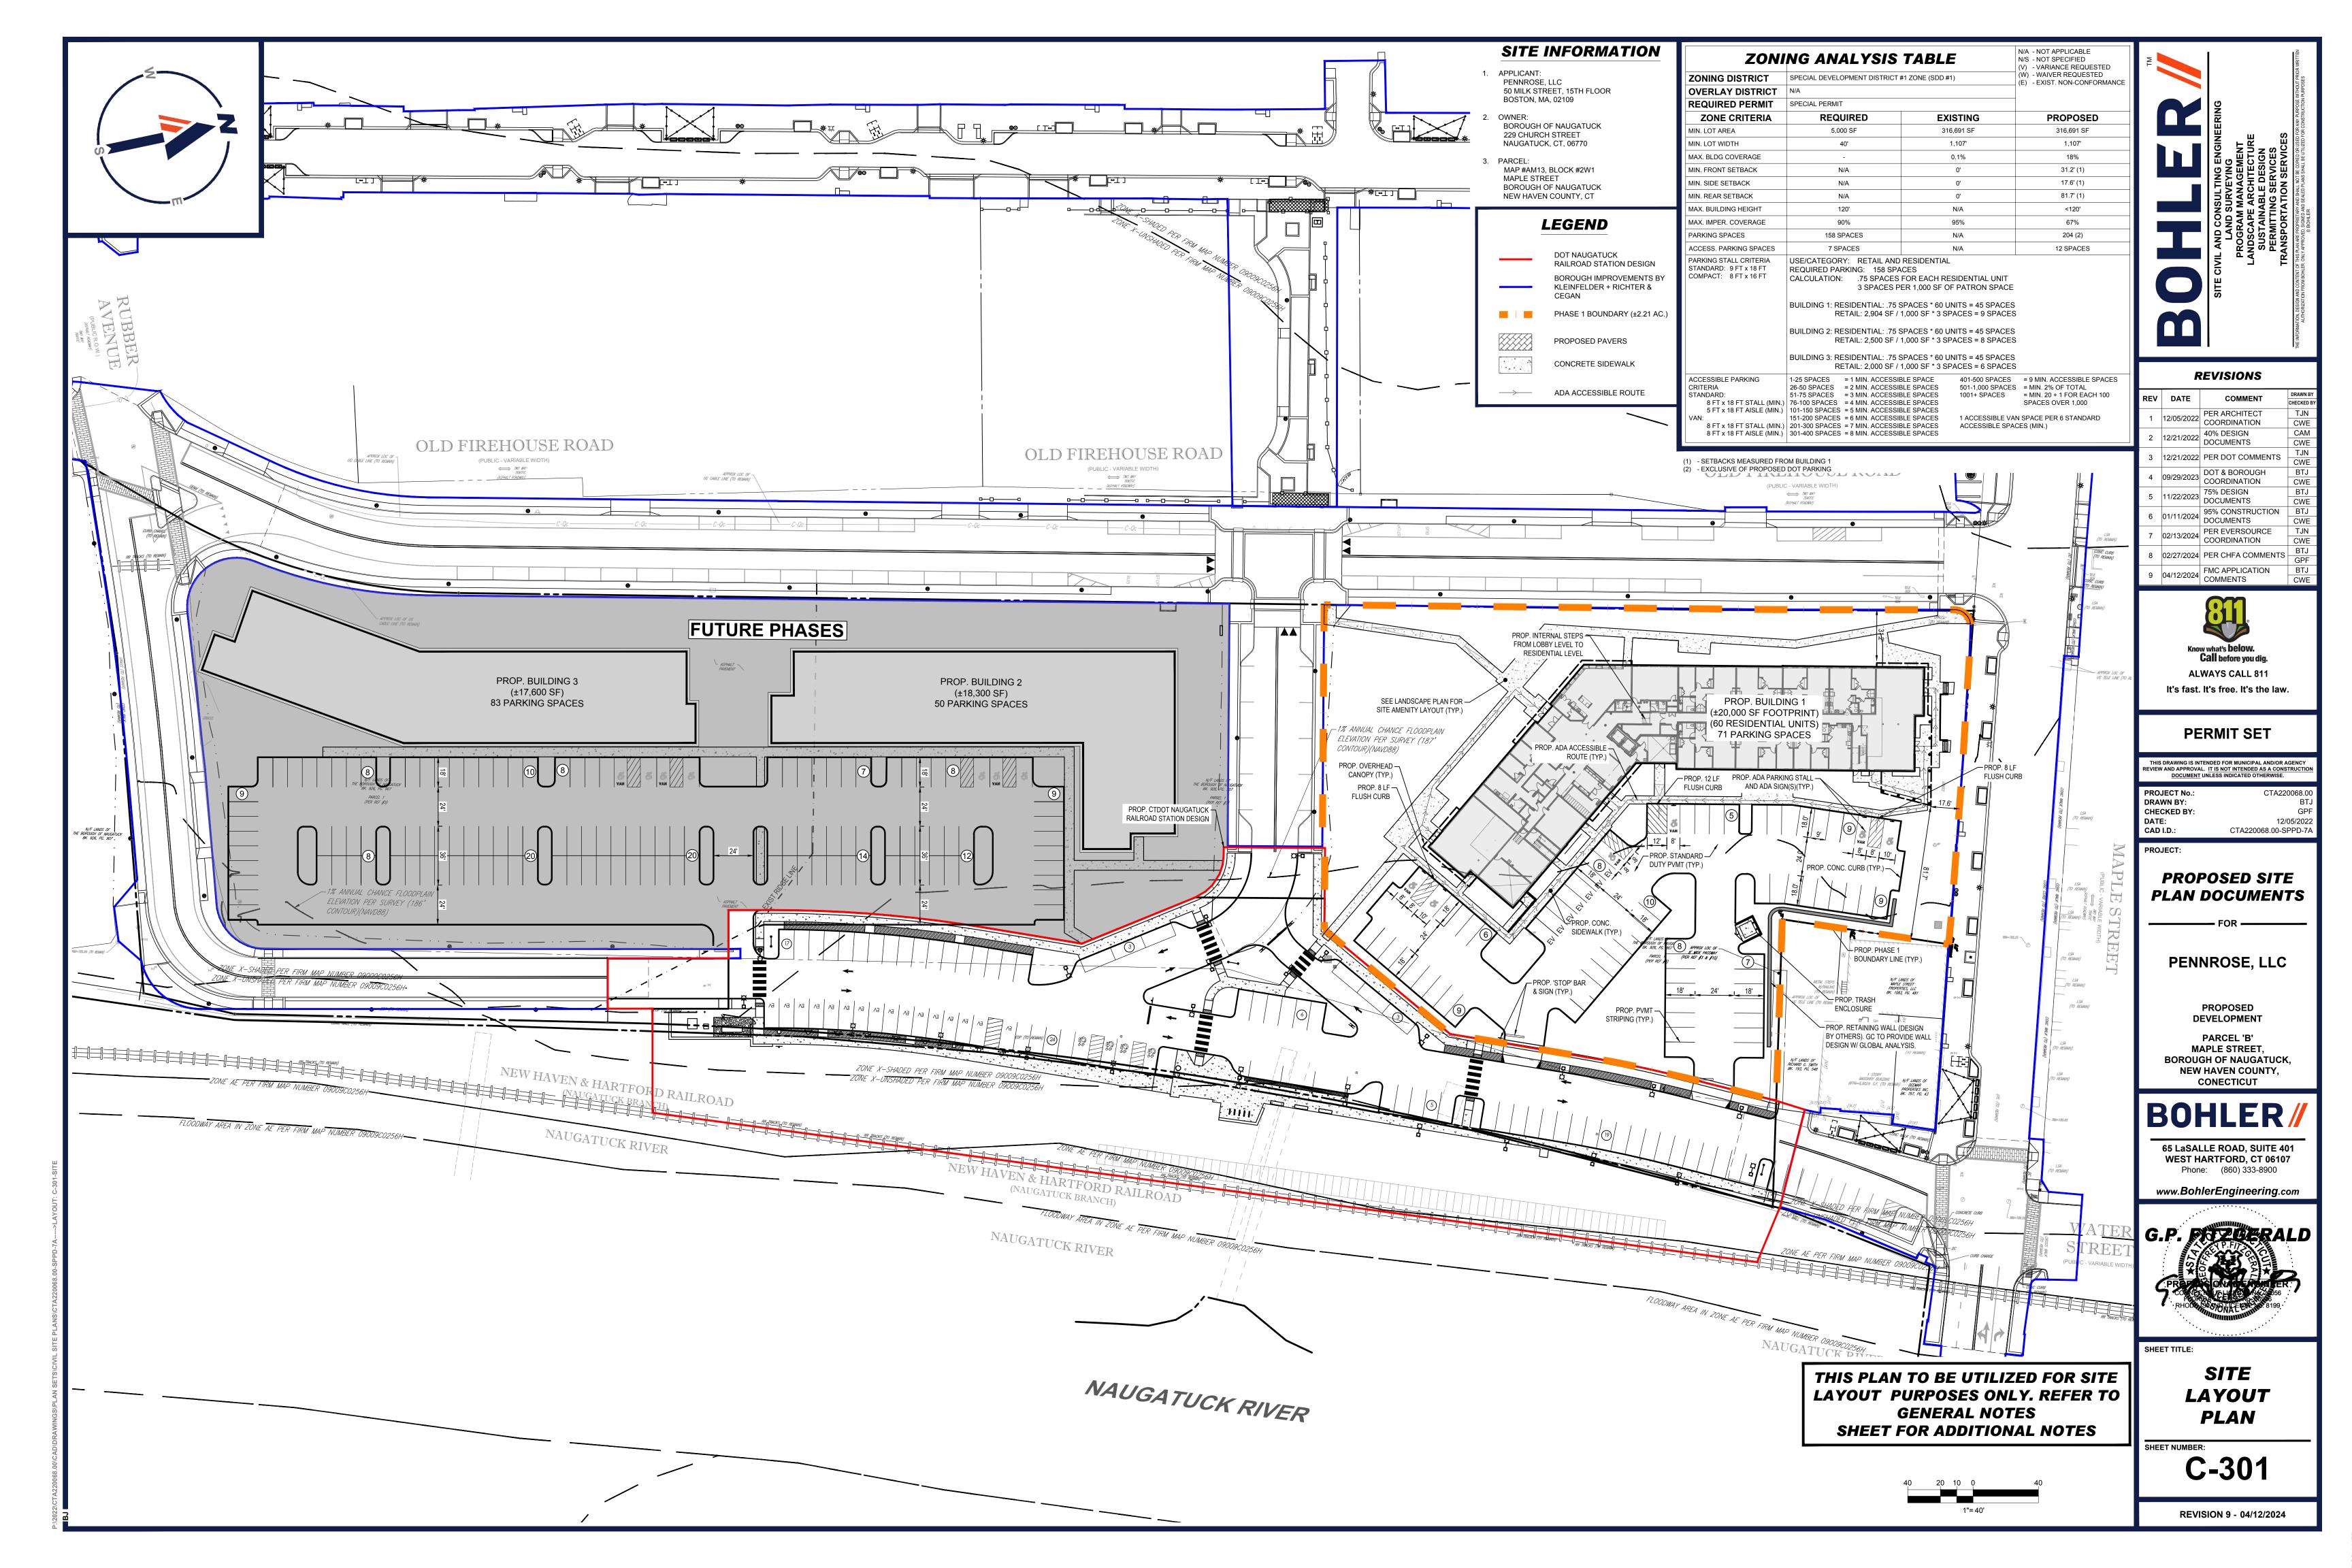

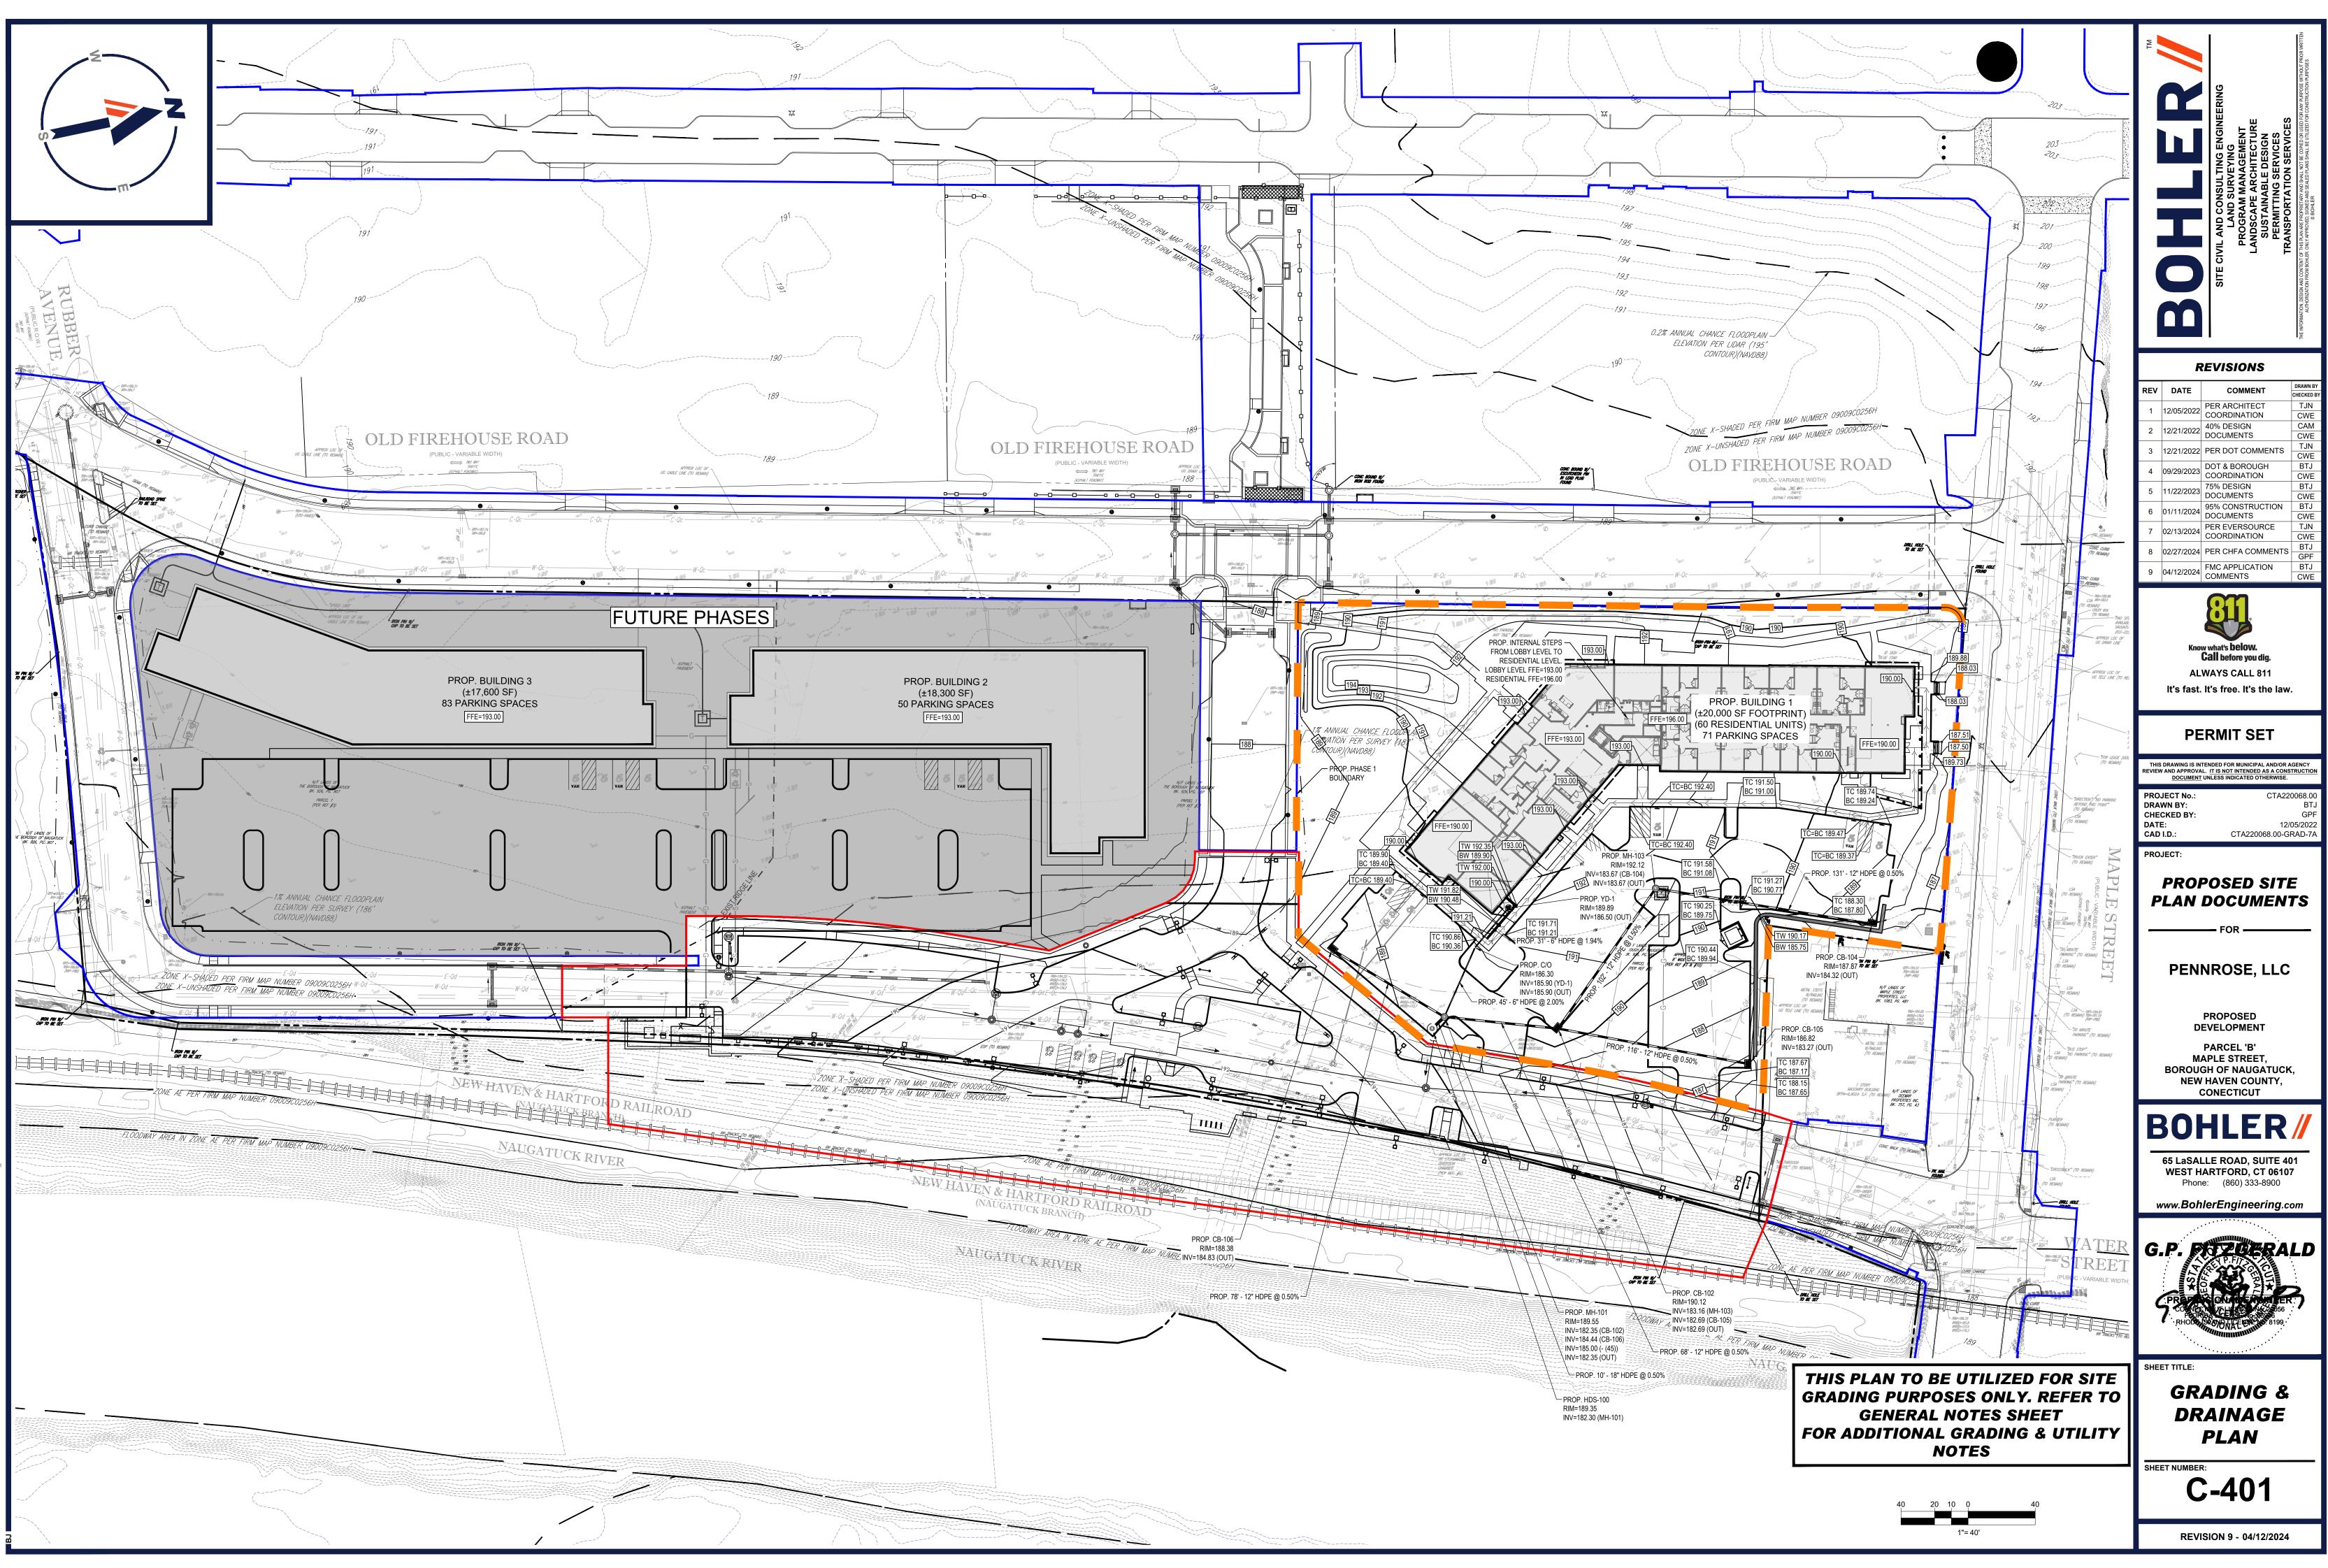

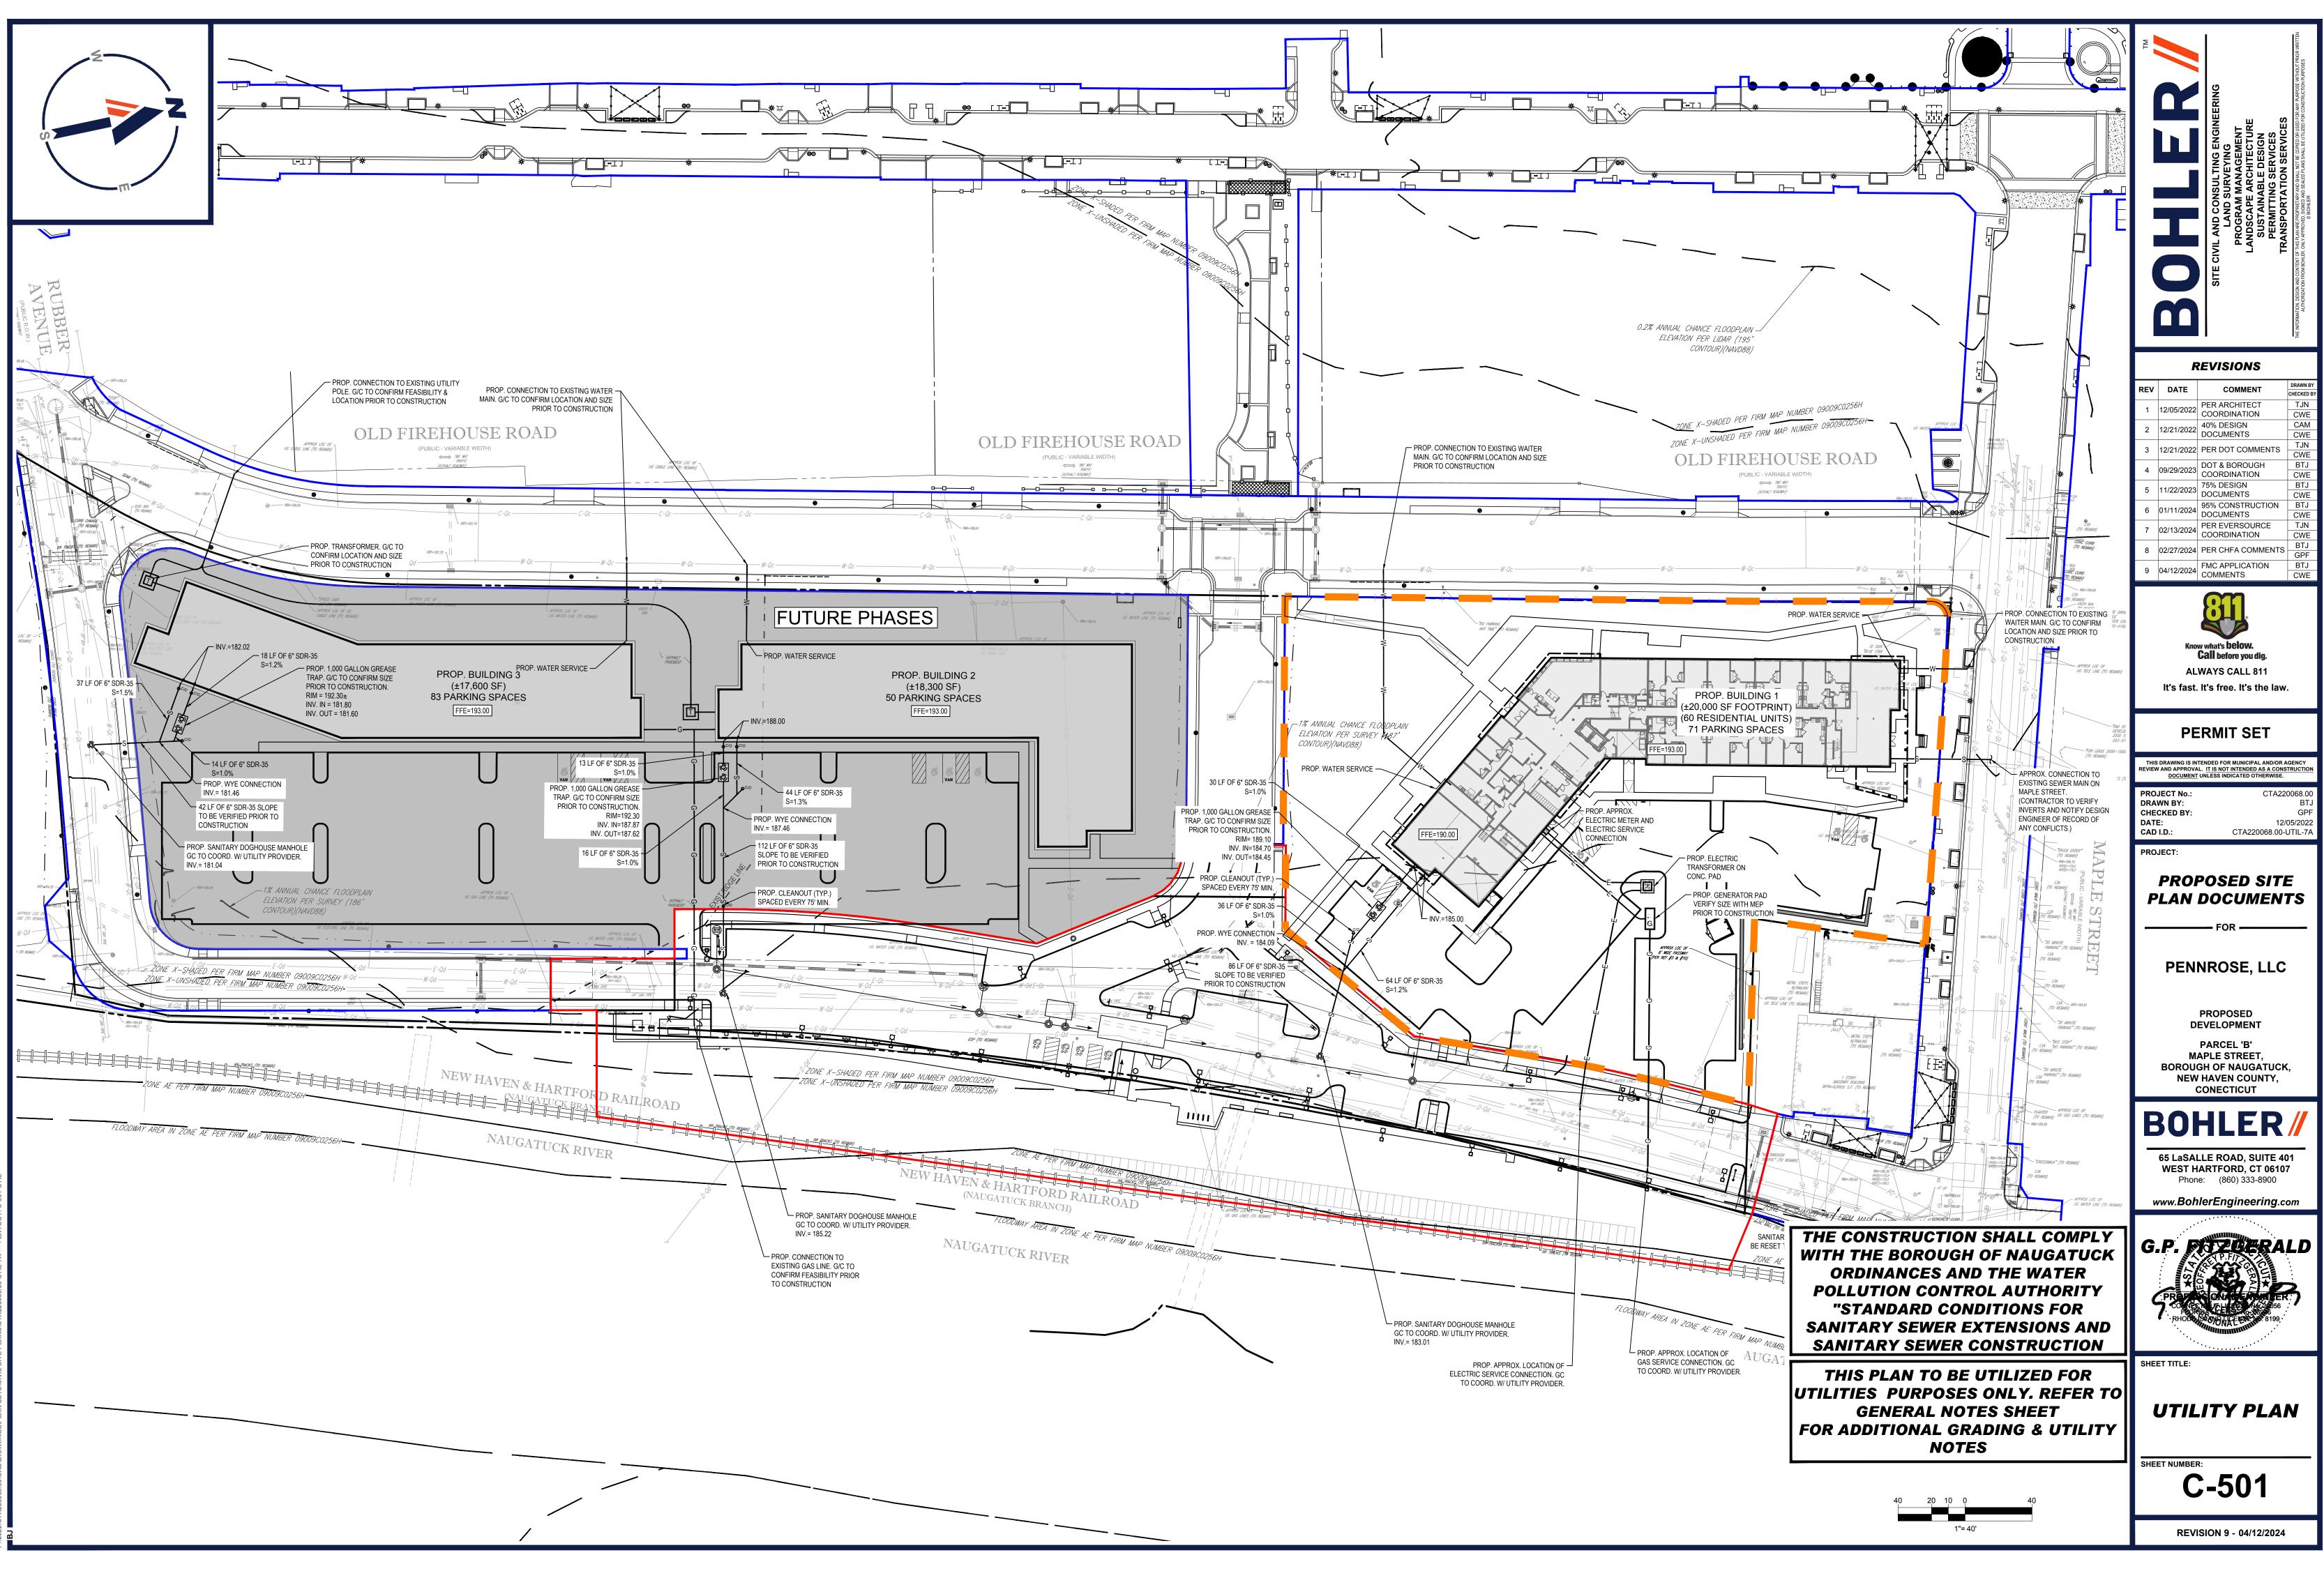

2\CTA220068.00\CAD\DRAWINGS\PLAN SETS\CIVIL SITE PLANS\CTA220068.00-UTIL-7A----->LAYOUT: C-50

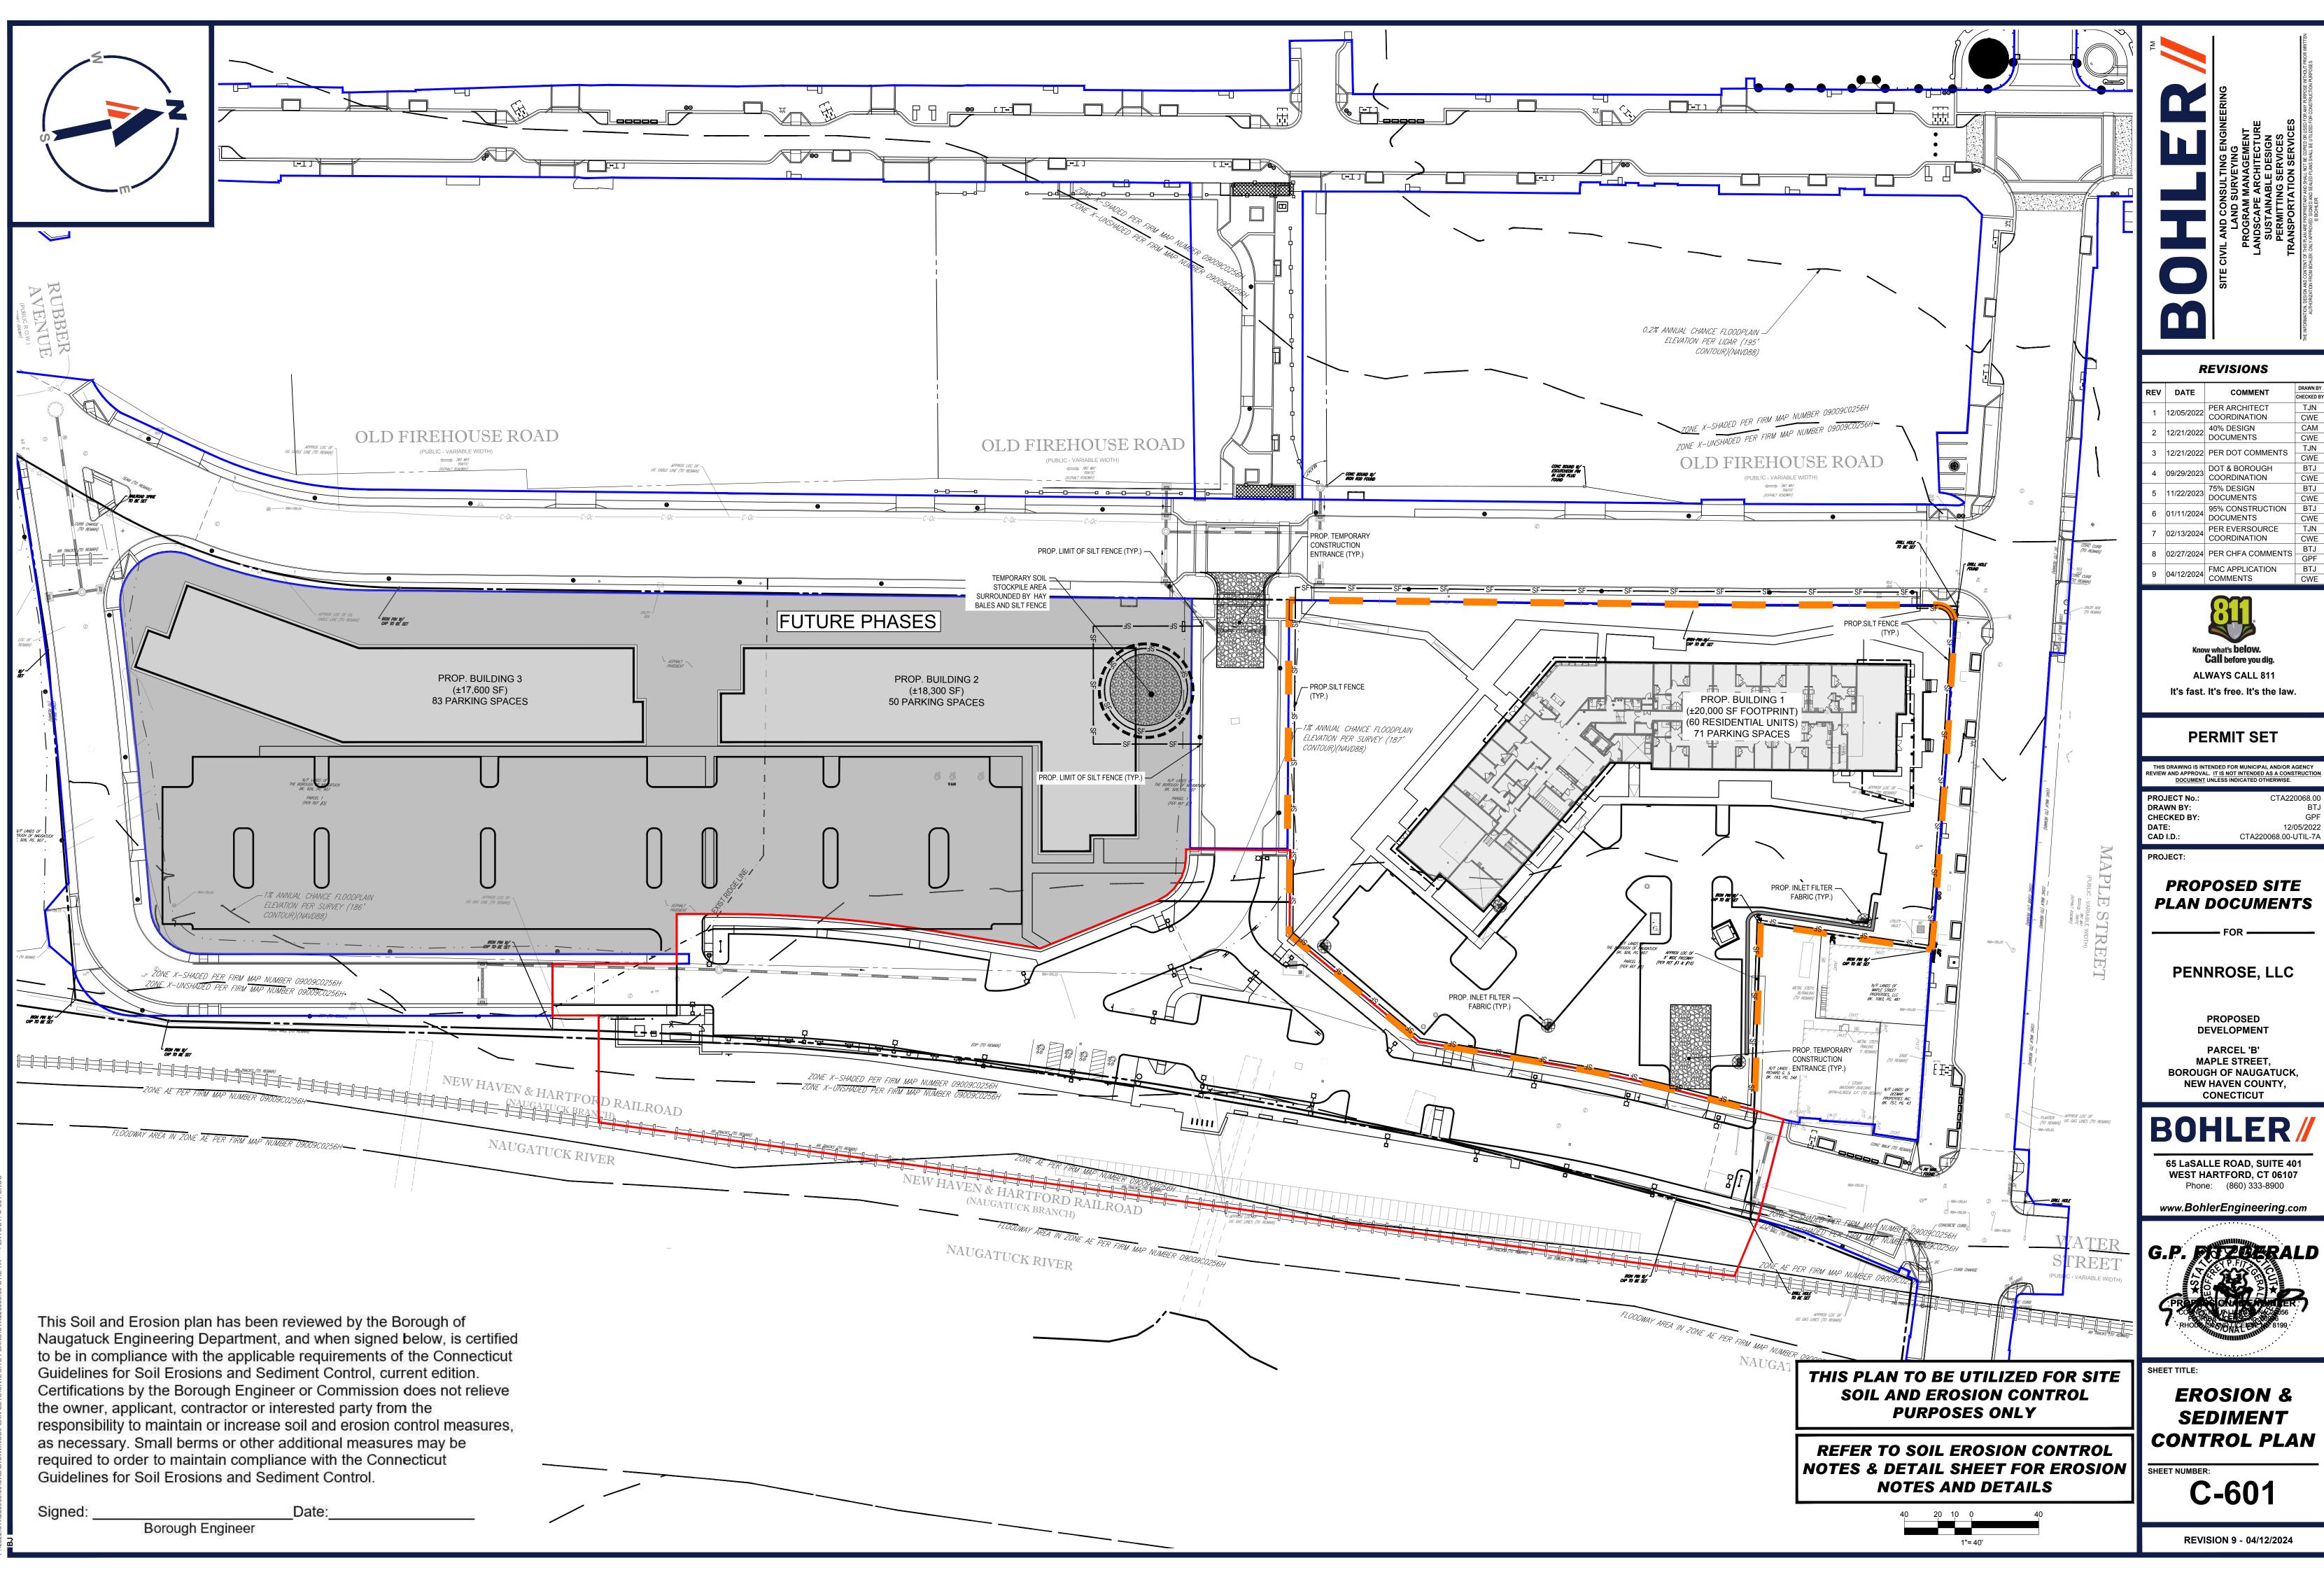

EROSION AND SEDIMENT CONTROL NOTES

BE PERMANENTLY STABILIZED IN ACCORDANCE WITH LOCAL, STATE, AND FEDERAL REQUIREMENTS.

ALL SEDIMENT AND EROSION CONTROL MEASURES SHALL BE DONE AS SET FORTH IN THE MOST CURRENT STATE SEDIMENT AND EROSION CONTROL MANUAL.

- THOSE AREAS UNDERGOING ACTUAL CONSTRUCTION WILL BE LEFT IN AN UNTREATED OR UNVEGETATED CONDITION FOR A MINIMUM TIME. AREAS SHALL
- SEDIMENT BARRIERS (SILT FENCE, STRAW BARRIERS, ETC.) SHOULD BE INSTALLED PRIOR TO ANY SOIL DISTURBANCE OF THE CONTRIBUTING DRAINAGE AREA ABOVE THEM, MULCH NETTING SHALL BELISED TO ANCHOR MULCH IN ALL AREAS WITH SLOPES GREATER THAN 8%
- INSTALL SILTATION BARRIER AT TOE OF SLOPE TO FILTER SILT FROM RUNOFF. SEE SILTATION BARRIER DETAILS FOR PROPER INSTALLATION. SILTATION BARRIER WILL REMAIN IN PLACE PER NOTE #5
- ALL EROSION CONTROL STRUCTURES WILL BE INSPECTED, REPLACED AND/OR REPAIRED EVERY 7 DAYS AND IMMEDIATELY FOLLOWING ANY SIGNIFICANT RAINFALL OR SNOW MELT OR WHEN NO LONGER SERVICEABLE DUE TO SEDIMENT ACCUMULATION OR DECOMPOSITION. SEDIMENT DEPOSITS SHOULD BE REMOVED AFTER EACH STORM EVENT. THEY MUST BE REMOVED WHEN DEPOSITS REACH APPROXIMATELY ONE HALF THE HEIGHT OF THE BARRIER. SEDIMENT CONTROL DEVICES SHALL REMAIN IN PLACE AND BE MAINTAINED BY THE CONTRACTOR UNTIL AREAS UPSLOPE ARE PERMANENTLY STABILIZED. FOR SEDIMENT CONTROL DEVICES THAT ARE WITHIN AREAS SUBJECT TO CONSERVATION COMMISSION JURISDICTION, THE DEVICES SHALL REMAIN IN PLACE AND BE REMOVED IN ACCORDANCE WITH THE ORDER OF CONDITIONS
- NO SLOPES, EITHER PERMANENT OR TEMPORARY, SHALL BE STEEPER THAN TWO TO ONE (2:1) UNLESS OTHERWISE INDICATED ON THE PLANS. SLOPE PROTECTION FOR SLOPES GREATER THAN 2:1 SHALL BE DESIGNED BY A GEOTECHNICAL ENGINEER.
- IF FINAL SEEDING OF THE DISTURBED AREAS IS NOT COMPLETED 45 DAYS PRIOR TO THE FIRST KILLING FROST, USE TEMPORARY MULCH (DORMANT SEEDING MAY BE ATTEMPTED AS WELL) TO PROTECT THE SITE AND DELAY SEEDING UNTIL THE NEXT RECOMMENDED SEEDING PERIOD.
- TEMPORARY SEEDING OF DISTURBED AREAS THAT HAVE NOT BEEN FINAL GRADED SHALL BE COMPLETED 45 DAYS PRIOR TO THE FIRST KILLING FROST TO PROTECT FROM SPRING RUNOFF PROBLEMS. DURING THE CONSTRUCTION PHASE, INTERCEPTED SEDIMENT SHALL BE REMOVED AND DISPOSED OF IN ACCORDANCE WITH LOCAL, STATE, AND FEDERAL
- STANDARDS 10. REVEGETATION MEASURES WILL COMMENCE UPON COMPLETION OF CONSTRUCTION EXCEPT AS NOTED ABOVE. ALL DISTURBED AREAS NOT OTHERWISE STABILIZED WILL BE GRADED, SMOOTHED, AND PREPARED FOR FINAL SEEDING AS FOLLOWS:
- 10.1. SIX INCHES, OR DEPTH SPECIFIED ON THE LANDSCAPE PLAN, OF LOAM WILL BE SPREAD OVER DISTURBED AREAS AND SMOOTHED TO A UNIFORM SURFACE 10.2. APPLY LIMESTONE AND FERTILIZER ACCORDING TO SOIL TEST. IF SOIL TESTING IS NOT FEASIBLE ON SMALL OR VARIABLE SITES, OR WHERE TIMING IS
- CRITICAL, FERTILIZER MAY BE APPLIED AT THE RATE OF 800 LB PER ACRE OR 18.4 LBS PER 1,000 SF USING 10-20-20 OR EQUIVALENT. APPLY GROUND LIMESTONE (EQUIVALENT TO 50% CALCIUM PLUS MAGNESIUM OXIDE) AT A RATE OF 3 TONS PER ACRE (138 LB PER1,000 SF). FOLLOWING SEED BED PREPARATION, DITCHES AND BACK SLOPES WILL BE SEEDED TO A MIXTURE OF 47% CREEPING RED FESCUE, 5% REDTOP, AND 10.3. 48% TALL FESCUE. THE LAWN AREAS WILL BE SEEDED TO A PREMIUM TURF MIXTURE OF 44% KENTUCKY BLUE-GRASS, 44% CREEPING RED FESCUE, AND
- 12% PERENNIAL RYEGRASS: SEEDING RATE IS 1.03 LBS PER 1,000 SF LAWN. QUALITY SOD MAY BE SUBSTITUTED FOR SEED WHERE SLOPES DO NOT EXCEED 2:1. SOD ON SLOPES STEEPER THAN 3:1 SHOULD BE PEGGED. 10.4. STRAW MULCH AT THE RATE OF 70-90 LBS PER 1,000 SF. A HYDRO-APPLICATION OF WOOD OR PAPER FIBER SHALL BE APPLIED FOLLOWING SEEDING. A SUITABLE NON-TOXIC BINDER WILL BE USED ON STRAW MULCH FOR WIND CONTROL.
- ALL TEMPORARY EROSION CONTROL MEASURES SHALL BE REMOVED ONCE THE SITE IS 70% PERMANENTLY STABILIZED. FOR EROSION CONTROL MEASURES THAT ARE WITHIN AREAS SUBJECT TO CONSERVATION COMMISSION JURISDICTION. THE MEASURES SHALL REMAIN IN PLACE AND BE REMOVED IN ACCORDANCE WITH THE ORDER OF CONDITIONS.
- WETLANDS WILL BE PROTECTED WITH BARRIERS CONSISTING OF STRAW BALES, BIODEGRADABLE COMPOST TUBES, SILT FENCE OR A COMBINATION THEREOF.
- TEMPORARY SEDIMENT TRAPS SHALL BE SIZED PER THE CURRENT EDITION OF THE "CONNECTICUT GUIDELINES FOR SOIL EROSION AND SEDIMENT CONTROL" AND PROVIDE A MINIMUM STORAGE AREA OF 134 CY PER ACRE OF DRAINAGE AREA WITH A MAXIMUM TRIBUTARY AREA OF 5 ACRES. MAINTAIN A 2:1 LENGTH TO WIDTH RATIO. AND NOT EXCEED AND EMBANKMENT HEIGHT OF 5 FT. HALF OF THE STORAGE VOLUME SHALL BE IN THE FORM OF WET STORAGE TO PROVIDE A STABLE SETTLING MEDIUM. UPON SITE STABILIZATION, ACCUMULATED SEDIMENT SHALL BE REMOVED AND THE TEMPORARY SEDIMENT TRAP EXCAVATED TO 1 FOOT BELOW THE TRAP. THE AREA SHALL THEN BE SCARIFIED TO PREVENT COMPACTION AND PROMOTE INFILTRATION AND GRADED AND STABILIZED IN ACCORDANCE WITH THE GRADING AND LANDSCAPE PLANS.
- 14. STOCKPILES THAT ARE NOT TO BE USED WITHIN 30 DAYS NEED TO BE SEEDED AND MULCHED IMMEDIATELY AFTER FORMATION OF THE STOCKPILE.
- 15. EXISTING CATCH BASIN STRUCTURES SHALL BE PROTECTED UNTIL SUCH TIME AS THEY ARE REMOVED.
- 16. THE CONTRACTOR MUST PERFORM DEWATERING (IF REQUIRED), IN ACCORDANCE WITH STATE AND LOCAL REGULATIONS. IT IS THE CONTRACTOR'S RESPONSIBILITY TO OBTAIN AND PAY FOR THE COSTS ASSOCIATED WITH ANY AND ALL NECESSARY DISCHARGE PERMITS ASSOCIATED WITH SAME.
- THE CONTRACTOR MUST LOCATE CONSTRUCTION WASTE MATERIAL STORAGE AREAS TO MINIMIZE EXPOSURE TO STORMWATER. THE CONTRACTOR MUST IMMEDIATELY PLACE CONSTRUCTION WASTE IN ON-SITE STORAGE CONTAINERS UNTIL THAT CONSTRUCTION WASTE IS READY FOR OFF-SITE DISPOSAL. THE CONTRACTOR MUST MAINTAIN SPILL PREVENTION AND RESPONSE FOUIPMENT AND MAKE SAME CONTINUOUSLY AVAILABLE ON-SITE FOR USE BY THE CONTRACTOR'S EMPLOYEES WHO MUST BE PROPERLY TRAINED IN THE APPLICATION OF SPILL PREVENTION AND RESPONSE PROCEDURES.
- 18. WINTER CONSTRUCTION PERIOD: NOVEMBER 1 THROUGH APRIL 15.
- WINTER EXCAVATION AND EARTHWORK SHALL BE DONE SUCH THAT THE AMOUNT OF AREA OPEN AT ONE TIME IS MINIMIZED TO THE MAXIMUM EXTENT PRACTICABLE AND IN CONFORMANCE WITH THE STORMWATER POLLUTION PREVENTION PLAN SUCH THAT ADEQUATE PROVISIONS ARE EMPLOYED TO CONTROL STORMWATER RUNOFF
- 20. CONTINUATION OF EARTHWORK OPERATION ON ADDITIONAL AREAS SHALL NOT BEGIN UNTIL THE EXPOSED SOIL SURFACE ON THE AREA BEING WORKED HAS BEEN STABILIZED SUCH THAT NO LARGER AREA OF THE SITE IS WITHOUT EROSION CONTROL PROTECTION AS LISTED IN ITEM 2 ABOVE. AN AREA SHALL BE CONSIDERED TO HAVE BEEN TEMPORARILY STABILIZED WHEN EXPOSED SURFACES HAVE BEEN EITHER MULCHED WITH STRAW OR STRAW AT A RATE OF 100 LB. PER 1,000 SQUARE FEET (WITH OR WITHOUT SEEDING) OR DORMANT SEEDED, MULCHED AND ADEQUATELY ANCHORED BY AN APPROVED ANCHORING TECHNIQUE.
- 22. FOR AREAS WHERE CONSTRUCTION ACTIVITIES HAVE CEASED FOR A PERIOD EXCEEDING 14 DAYS BETWEEN THE DATES OF NOVEMBER 1ST AND APRIL 1ST, LOAM OR SEED WILL NOT BE REQUIRED. THE SLOPES SHALL BE FINE GRADED AND EITHER PROTECTED WITH MULCH OR TEMPORARILY SEEDED. IF THE EXPOSED AREA HAS BEEN LOAMED, FINAL GRADED AND IS SMOOTH, THEN THE AREA MAY BE DORMANT SEEDED AT A RATE OF 200-300% HIGHER THAN SPECIFIED FOR PERMANENT SEED AND THEN MULCHED AS APPLICABLE. SLOPES SHALL NOT BE LEFT UNSTABILIZED OVER THE WINTER OR IN AREAS WHERE WORK HAS CEASED FOR MORE THAN 14 DAYS UNLESS TREATED IN THE ABOVE MANNER. UNTIL SUCH TIME AS WEATHER CONDITIONS ALLOW DITCHES TO BE FINISHED WITH THE PERMANENT SURFACE TREATMENT, EROSION SHALL BE CONTROLLED BY THE INSTALLATION OF SEDIMENT BARRIERS OR STONE CHECK DAMS IN ACCORDANCE WITH THE STANDARD DETAILS
- 23. MULCHING REQUIREMENTS
- 23.1. BETWEEN THE DATES OF NOVEMBER 1ST AND APRIL 15TH ALL MULCH SHALL BE ANCHORED BY EITHER PEG LINE, MULCH NETTING OR WOOD CELLULOSE FIBER. 23.2. MULCH NETTING SHALL BE USED TO ANCHOR MULCH IN ALL DRAINAGE WAYS WITH A SLOPE GREATER THAN 3% FOR SLOPE EXPOSED TO DIRECT
- WINDS AND FOR ALL OTHER SLOPES GREATER THAN 8%. 23.3. MULCH NETTING SHALL BE USED TO ANCHOR MULCH IN ALL AREAS WITH SLOPES GREATER THAN 15%. AFTER OCTOBER 1ST THE SAME APPLIES FOR
- ALL SLOPES GREATER THAN 8%
- 24. ALL DISTURBED AREAS SHALL BE STABILIZED IN ACCORDANCE WITH THE STORMWATER PREVENTION PLAN. 25. DURING THE WINTER CONSTRUCTION PERIOD ALL SNOW SHALL BE REMOVED FROM AREAS OF SEEDING AND MULCHING PRIOR TO PLACEMENT.

EROSION CONTROL NARRATIVE


- .. PURPOSE
- 1.1. THE PROPOSED WORK WILL CONSIST OF CONSTRUCTION NECESSARY TO BUILD A MIXED USE DEVELOPMENT WITH ALL ASSOCIATED PARKING, LANDSCAPING, UTILITIES, AND ACCESSORY STRUCTURES.
- 2. LIMIT OF WORK
- 2.1. THE PROPOSED PROJECT LIMIT OF WORK INCLUDES ±2.21 ACRES OF LAND.
- 3. SITE SPECIFIC CONCERNS
- 3.1. PREVENTION OF POLLUTION AND SEDIMENT ENTERING DOWNSTREAM WATERCOURSE(S) BY MEANS OF STORMWATER QUALITY UNIT BEFORE ENTERING THE WETLANDS. CONSTRUCTION PHASING SHALL BE COMPLETED IN ONE PHASE AS INDICATED IN THE SEQUENCE BELOW (6.1) OR DESCRIBE THE PHASED CONSTRUCTION (IF
- MORE THAN ONE PHASE). CONSTRUCTION SCHEDULE (SUBJECT TO CHANGE DEPENDING ON MARKETS, FINANCING, PERMIT APPROVALS AND WEATHER CONDITIONS) 5.1. THE ANTICIPATED CONSTRUCTION START IS SUMMER 2023, WITH COMPLETION ANTICIPATED 18 MONTHS AFTER THE START DATE.
- 5. CONSTRUCTION SEQUENCE
- 6.1. THE FOLLOWING CONSTRUCTION SEQUENCE IS RECOMMENDED:
- 6.1.1. INSTALLATION OF STABILIZED CONSTRUCTION ENTRANCE/EXIT (SEE SHEET C-601) 6.1.2. INSTALLATION OF EROSION CONTROL PERIMETER CONTROLS (SILT FENCE, COMPOST FILTER SOCK) WITHIN THE LIMIT OF DISTURBANCE AS INDICATED ON THE PLANS (SEE SHEET C-601)
- 6.1.3. INSTALLATION OF INLET PROTECTION (FILTER SACKS) IN STREET AND EXISTING INLETS (SEE SHEET C-601)
- 6.1.4. DEMOLITION OF EXISTING SITE STRUCTURES, PAVEMENT, AND AMENITIES (SEE SHEET C-201)
- 6.1.5. CLEARING AND GRUBBING IN AREAS DESIGNATED AS BEING REMOVED AS NECESSARY TO INSTALL TEMPORARY SWALES (SEE SHEET C-601) 6.1.6. INITIATE THE NECESSARY EARTHWORK TO REACH GRADES INDICATED ON THE PLANS. (SEE SHEET C-401). TEMPORARY STABILIZE ANY AREAS WITH SEEDING OR MULCH AS DETAILED IN THESE PLANS WITHIN 7 DAYS AFTER THE SUSPENSION OF GRADING WORK IN DISTURBED AREAS WHERE THE SUSPENSION OF WORK IS EXPECTED TO BE MORE THAN 30 DAYS BUT LESS THAN 1 YEAR. INSTALLATION OF BUILDING FOUNDATION AND CONSTRUCTION OF BUILDING. BUILDING CONSTRUCTION MAY COMMENCE UPON ACCEPTANCE OF
- BUILDING PAD BY THE OWNER. CONCRETE WASHOUT MUST BE INSTALLED PRIOR TO ANY CONCRETE BEING POURED ON SITE. 6.1.8. INSTALLATION OF UTILITIES INCLUDING BUT NOT LIMITED TO STORMWATER, GAS, SANITARY, ELECTRIC, AND WATER. STORMWATER AND SANITARY UTILITIES SHOULD BE INSTALLED IN A DOWNSTREAM TO UPSTREAM MANNER. (SEE SHEET C-401 AND C-501) 6.1.9. CONSTRUCTION OF ALL CURBING AND LANDSCAPE ISLANDS AS INDICTED ON THE PLANS ALONG WITH STONE BASE COURSE IN THE DRIVEWAY AND
- PARKING AREAS (SEE SHEET C-301) 6.1.10. INITIATE FINAL GRADING AND PLACEMENT OF TOPSOIL IN ALL LANDSCAPED AND SLOPES AREAS. AS SOON AS SLOPES, CHANNELS, DITCHES AND
- OTHER DISTURBED AREAS REACH FINAL GRADE THEY MUST BE STABILIZED AS DETAILED ON THE EROSION CONTROL AND/OR LANDSCAPE PLAN DEPENDING ON THE SEASON (SEE SHEET C-601, C-602, C-701). 6.1.11. INSTALL BITUMINOUS PAVEMENT AND CONCRETE INCLUDING SIDEWALKS
- 6.1.12. INSTALL ANY FINAL LANDSCAPE PLANTING WHICH HAVE NOT BEEN PREVIOUSLY INSTALLED. (SEE SHEET C-701) 6.1.13. CLEAR SITE OF DEBRIS IN ACCORDANCE WITH STATE AND LOCAL REGULATIONS. REMOVE EROSION CONTROLS AS DISTURBED AREAS BECOME STABILIZED TO 70% STABILIZATION OR GREATER
- OTHER POSSIBLE LOCAL, STATE AND FEDERAL PERMITS REQUIRED PERMITS 7.1. NONE REQUIRED
- 8. CONSERVATION PRACTICE
- 8.1. CONSERVATION PRACTICES INCLUDE LIMITING THE SCOPE OF THE PROJECT TO MINIMIZE ACTIVITIES WHICH REQUIRES BARE SOILS TO BE EXPOSED. THE LIMIT OF WORK INCLUDES ±2.21 ACRES FOR THIS PROJECT SUPPORT DOCUMENTS
- 9.1. STORMWATER MEMORANDUM
- 10. PERSON RESPONSIBLE FOR MAINTENANCE DURING CONSTRUCTION OF PROJECT CONTRACTOR OR PERSON SHALL BE NAMED AT PRECONSTRUCTION MEETING

GENERAL EROSION AND SEDIMENT CONTROL NOTES

- THE GENERAL NOTES MUST BE INCLUDED AS PART OF THIS ENTIRE DOCUMENT PACKAGE AND ARE PART OF THE CONTRACT DOCUMENTS. THE GENERAL
- 3. THE LIMIT OF WORK OF THIS SITE IS APPROXIMATELY 3.9 ACRES THE FOLLOWING EROSION CONTROL MEASURES ARE PROPOSED FOR THIS SITE:
- SOIL STOCKPILES
- QUANTITY OF SEDIMENT. INSTALL TEMPORARY INLET PROTECTION ON INLETS DOWNSLOPE FROM DISTURBANCE. WHICH MAY BE BEYOND THE LIMITS OF DISTURBED AREA
- HALF THE OF THE EROSION CONTROL BARRIER'S HEIGHT COLLECTED ON THE FILTER FABRIC AND/OR SILT SOCK BARRIERS AND EXCAVATE AND REMOVE ANY SILT FROM DROP INLET PROTECTION
- FABRIC AND MAINTAIN SAME IN STRICT ACCORDANCE WITH BEST MANAGEMENT PRACTICES.
- THE CONTRACTOR MUST INSTALL ADDITIONAL EROSION CONTROL MEASURES IF ENGINEER SO REQUIRES, TO PREVENT ANY, INCLUDING THE INCIDENTAL, DISCHARGE OF SILT-LADEN RUNOFF FROM EXITING THE SITE
- IN THE BID PRICE FOR THE SITE WORK AND THE CONTRACTOR IS RESPONSIBLE FOR ALL SUCH COSTS.
- ESTABLISHMENT OF VEGETATION
- INSTALLING A DIFFERENT. SPECIFIED METHOD OF STABILIZATION
- THIS PLAN REPRESENTS THE MINIMUM LEVEL OF IMPLEMENTATION OF TEMPORARY FROSION AND SEDIMENTATION CONTROL FACILITIES. MEASURES AND
- FOR TREE PROTECTION, FENCE LOCATIONS AND DETAILS.
- 14. THE CONTRACTOR MUST REFER TO GRADING PLANS FOR ADDITIONAL INFORMATION.
- JURISDICTIONAL AGENCY REQUIRES, BOTH AT THE TIME OF SITE STABILIZATION AND AT END OF PROJECT
- 16. SOIL EROSION CONTROL MEASURES MUST BE ADJUSTED OR RELOCATED BY THE CONTRACTOR AS IDENTIFIED DURING SITE OBSERVATION IN ORDER TO MAINTAIN THE COMPLETE EFFECTIVENESS OF ALL CONTROL MEASURES
- OTHER LOCATIONS WHERE HAZARDOUS MATERIALS ARE STORED

OPERATION AND MAINTENANCE

- MAINTENANCE REQUIREMENTS OF MEASURES DURING CONSTRUCTION OF PROJECT SEDIMENT CONTROL MEASURES WILL BE INSPECTED.
- BECOME DAMAGED AND/OR DETERIORATED. AREAS, WHICH ARE MULCHED OR SEEDED FOR TEMPORARY VEGETATIVE COVER, WILL BE INSPECTED FOR PROPER COVER AT THE END OF EACH 1.3.
- SEEDING OR MULCH WILL BE PLACED AS NECESSARY 1.4.
- 2. MAINTENANCE REQUIREMENTS OF PERMANENT MEASURES AFTER PROJECT COMPLETION.
- BEEN DESIGNED TO DISSIPATE AND DISPERSE THE RUNOFF AND PREVENT SCOURING OF THE RECEIVING AREA OPERATION AND MAINTENANCE PLAN
- AND ONCE DURING SPRING CLEANUP
- ARTICULATE MATTER IS OBSERVED.
- 3.4. MANHOLES/JUNCTION BOXES SHALL BE INSPECTED AND REPAIRED ON AN ANNUAL BASIS.
- PIPING SHOULD OCCUR ONCE EVERY TEN YEARS

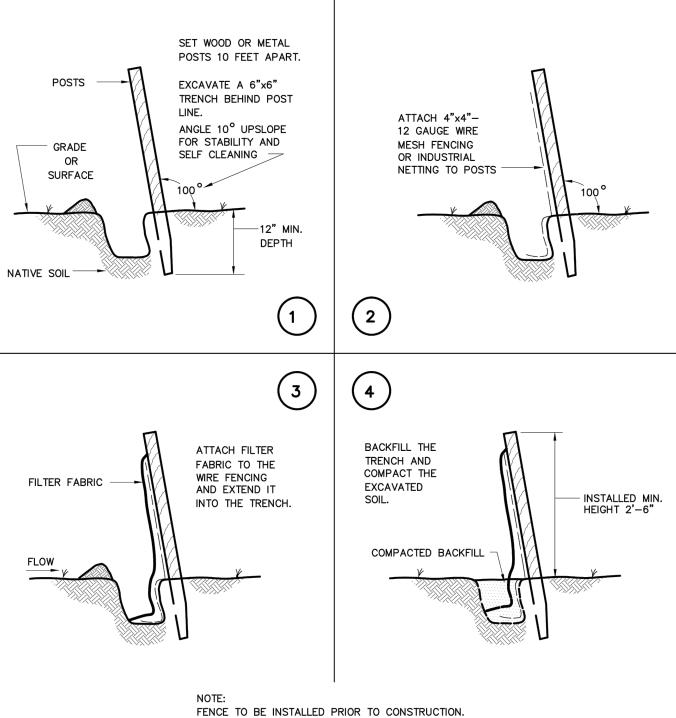

AS INDICATED.





NOTES ARE REFERENCED HEREIN, AND THE CONTRACTOR MUST REFER TO THEM AND FULLY COMPLY WITH THESE NOTES, IN THEIR ENTIRETY. THE CONTRACTOR MUST BE FAMILIAR WITH AND ACKNOWLEDGE FAMILIARITY WITH ALL OF THE GENERAL NOTES AND ALL OF THE PLANS' SPECIFIC NOTES 2. EROSION CONTROL MEASURES MUST CONFORM TO THE STATE. LOCAL, AND FEDERAL GUIDELINES FOR URBAN EROSION AND SEDIMENT CONTROL UNLESS OTHERWISE NOTED OR UNLESS ENGINEER CLEARLY AND SPECIFICALLY IN WRITING DIRECTS OTHERWISE INSTALLATION OF EROSION CONTROL, CLEARING, AND SITE WORK MUST BE PERFORMED EXACTLY AS INDICATED IN THE EROSION CONTROL CONSTRUCTION NOTES.

4.1. STABILIZED CONSTRUCTION ENTRANCE/ EXIT - A TEMPORARY GRAVEL CONSTRUCTION ENTRANCE/EXIT IS TO BE INSTALLED AT THE DESIGNATED LOCATION SHOWN ON THE PLAN. THIS AREA MUST BE GRADED SO THAT RUNOFF WATER WILL BE RETAINED ON-SITE. SEDIMENT FENCE - INSTALL SILT FENCE(S) AND/OR SILT SOCK AROUND ALL OF THE DOWNSLOPE PERIMETERS OF THE SITE, TEMPORARY FILL AND 4.3 INSTALL FILTER FARRIC DROP IN ET PROTECTION AROUND FACH DRAINAGE IN ET AS DRAINAGE STRUCTURES ARE INSTALLED TO REDUCE THE

INSTALLATION OF EROSION CONTROL DEVICES MUST BE IN ACCORDANCE WITH ALL OF THE MANUFACTURER'S RECOMMENDATIONS. 6. THE CONTRACTOR MUST INSPECT EROSION CONTROL MEASURES WEEKLY. THE CONTRACTOR MUST REMOVE ANY SILT DEPOSITS GREATER THAN 6" OR

THE CONTRACTOR MUST APPLY TEMPORARY SEED AND MULCH TO ALL DISTURBED AREAS THAT WILL NOT BE BROUGHT TO FINISHED GRADE AND VEGETATED WITHIN 7 DAYS WHEN AREAS ARE DISTURBED AFTER THE GROWING SEASON. THE CONTRACTOR MUST STABILIZE SAME WITH GEOTEXTILE

THE CONTRACTOR MUST BE RESPONSIBLE FOR INSPECTING AND MAINTAINING ALL EROSION CONTROL MEASURES ON THE SITE UNTIL PERMANENT PAVING AND TURF/LANDSCAPING IS ESTABLISHED. THE COSTS OF INSTALLING AND MAINTAINING THE EROSION CONTROL MEASURES MUST BE INCLUDED

10. THE CONTRACTOR MUST CONTINUE TO MAINTAIN ALL EROSION CONTROL MEASURES UNTIL THE COMPLETION OF CONSTRUCTION AND THE

THE CONTRACTOR MUST REMOVE EROSION CONTROL MEASURES, SILT AND DEBRIS AFTER ESTABLISHING PERMANENT VEGETATION COVER OR OTHER

STRUCTURES ADDITIONAL FACILITIES MEASURES AND STRUCTURES MUST BE INSTALLED WHERE NECESSARY TO COMPLY WITH ALL APPLICABLE CODES AND STANDARDS AND/OR TO PREVENT ANY. INCLUDING THE INCIDENTAL DISCHARGE OF SILT-LADEN RUNOFF FROM EXITING THE SITE. THE CONTRACTOR MUST PROTECT ALL EXISTING TREES AND SHRUBS. THE CONTRACTOR MUST REFER TO THE LANDSCAPE AND/OR DEMOLITION PLAN(S)

15. THE CONTRACTOR MUST CLEAN EXISTING AND PROPOSED DRAINAGE STRUCTURES AND INTERCONNECTING PIPES ON OR OFF-SITE AS THE

17. THE CONTRACTOR MUST IDENTIFY, ON THE PLAN, THE LOCATION OF WASTE CONTAINERS, FUEL STORAGE TANKS, CONCRETE WASHOUT AREAS AND ANY

1.1. THE SPECIFIC EROSION AND SEDIMENTATION CONTROL MEASURES, WHICH INCLUDE A BARRIER OF TRENCHED SILTATION FENCE AND INLET PROTECTION WILL THROUGHOUT ALL PHASES OF CONSTRUCTION. SHALL BE INSPECTED (IN ADDITION TO THE INTERVALS EXPLAINED ABOVE) AT THE END OF EACH WORKDAY IF PRECIPITATION IS FORECAST AND AFTER EACH RAINFALL. AT THE END OF EACH WORKWEEK, PRIOR TO WEEKENDS, ALL EROSION AND

1.2. THROUGHOUT THE CONSTRUCTION PROCESS, EXTRA STOCKS OF HAY BALES AND SILTATION FENCING WILL BE KEPT ON-SITE TO REPLACE THOSE THAT

WORKDAY IF PRECIPITATION IS FORECAST AND ALSO PRIOR TO WEEKENDS. CONTRACTOR SHALL KEEP PAVING CLEAR AT ALL TIMES. ADDITIONAL

TEMPORARY FROSION AND SEDIMENT CONTROL SYSTEMS WILL NOT BE REMOVED UNTIL ALL STORMWATER DRAINAGE SYSTEM COMPONENTS ARE IN PLACE, CLEANED AND WORKING PROPERLY AND UNTIL PERMANENT VEGETATIVE COVER AND OTHER STABILIZATION MEASURES ARE ESTABLISHED.

2.1. POTENTIAL LONG-TERM EROSION AND SEDIMENTATION IMPACTS WILL BE CONTROLLED BY THE USE OF THE BMP'S ON-SITE. THE STORMWATER MANAGEMENT SYSTEM WAS DESIGNED TO CONTROL THE PEAK RATE OF RUNOFF AND THE OUTLETS OF THE STORMWATER COLLECTION SYSTEMS HAVE

3.1. ALL STORMWATER COMPONENTS SHOULD BE CHECKED PERIODICALLY IN A MAINTENANCE LOG AND KEPT IN FULL WORKING ORDER. ULTIMATELY, THE REQUIRED FREQUENCY OF INSPECTION AND SERVICE WILL DEPEND ON RUNOFE QUANTITIES, POLILITANT LOADING, AND CLOGGING DUE TO DEBRIS. AT A MINIMUM. WE RECOMMEND THAT ALL STORMWATER COMPONENTS BE INSPECTED AND SERVICED TWICE PER YEAR. ONCE BEFORE WINTER BEGINS

SWEEPING WILL BE COMPLETED AT LEAST SEMIANNUALLY (ONCE IN THE SPRING AND ONCE IN THE FALL), OR MORE FREQUENTLY IF ACCUMULATED


3.3. CATCH BASIN SUMPS WILL BE INSPECTED SEMIANNUALLY AND CLEANED WHEN SEDIMENT IS WITHIN 12 INCHES OF THE OUTLET INVERT OR HALF THE


DRAINAGE PIPING UNLESS SYSTEM PERFORMANCE INDICATES DEGRADATION OF PIPING, COMPREHENSIVE VIDEO INSPECTION OF STORM DRAINAGE


3.6. CONTROL STRUCTURES (ORIFICE, WEIR, ETC.) SHALL BE COMPLETELY CLEANED OF ACCUMULATED DEBRIS AND SEDIMENTS AT THE COMPLETION OF CONSTRUCTION. ANY REPAIRS SHALL BE PERFORMED. FOR THE FIRST YEAR, CONTROL STRUCTURES SHALL BE INSPECTED ON A QUARTERLY BASIS, THEN TWICE PER YEAR AFTER THE SECOND YEAR (ONCE IN THE SPRING AND ONCE IN THE FALL, AFTER FALL CLEANUP OF LEAVES HAS OCCURRED).


PREASSEMBLED UNITS ALSO MAY BE USED, INSTALLED

EDIMENT CONTROL FENCE	Scale: NTS
AND CONSTRUCTION	Drawing No.
H OF NAUGATUCK	SD-41
RING DEPARTMENT	
NDARD DETAIL	
uck, CT 06770 www.naugatuck-ct.gov	Date:10/2011

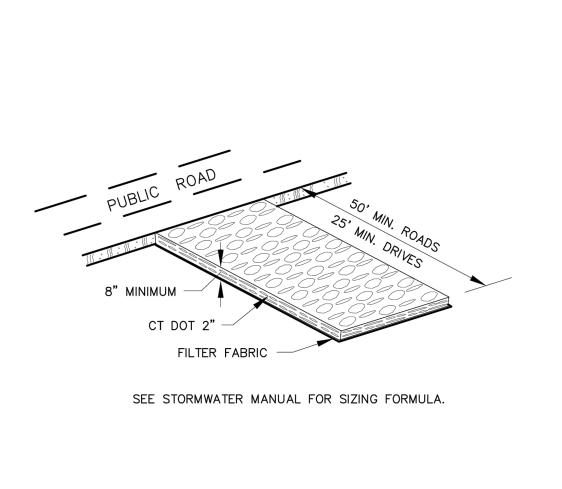


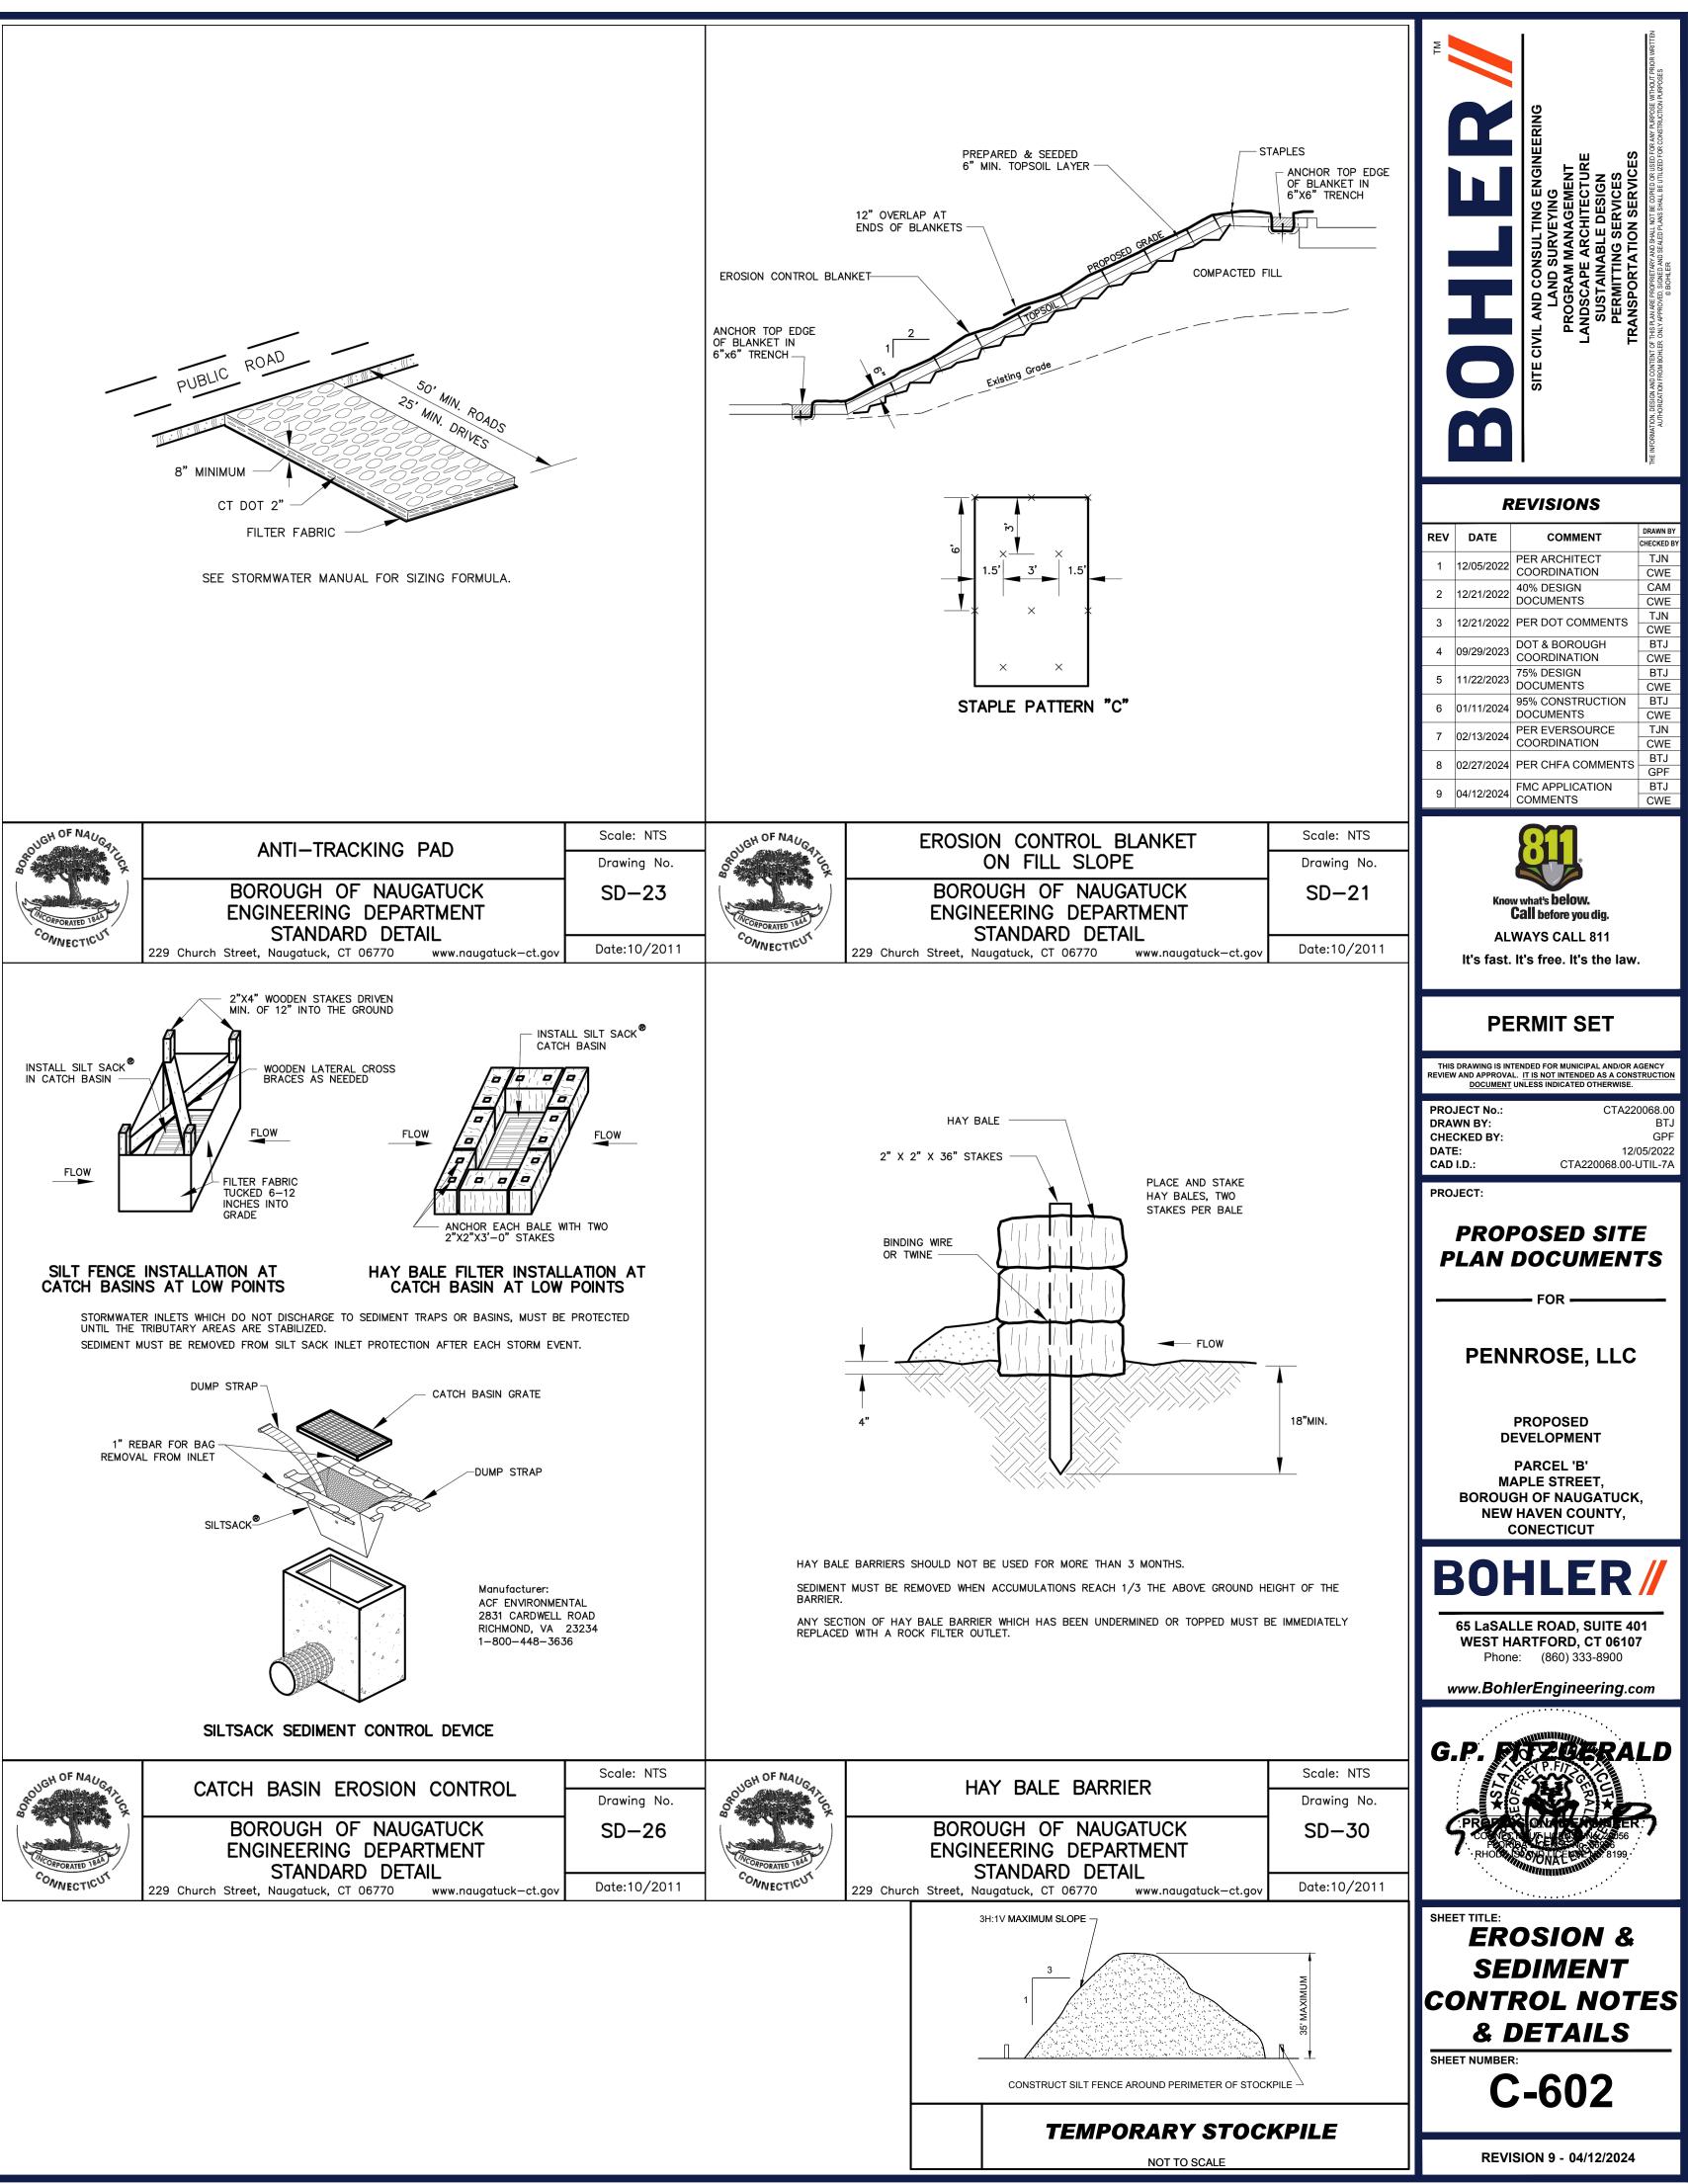


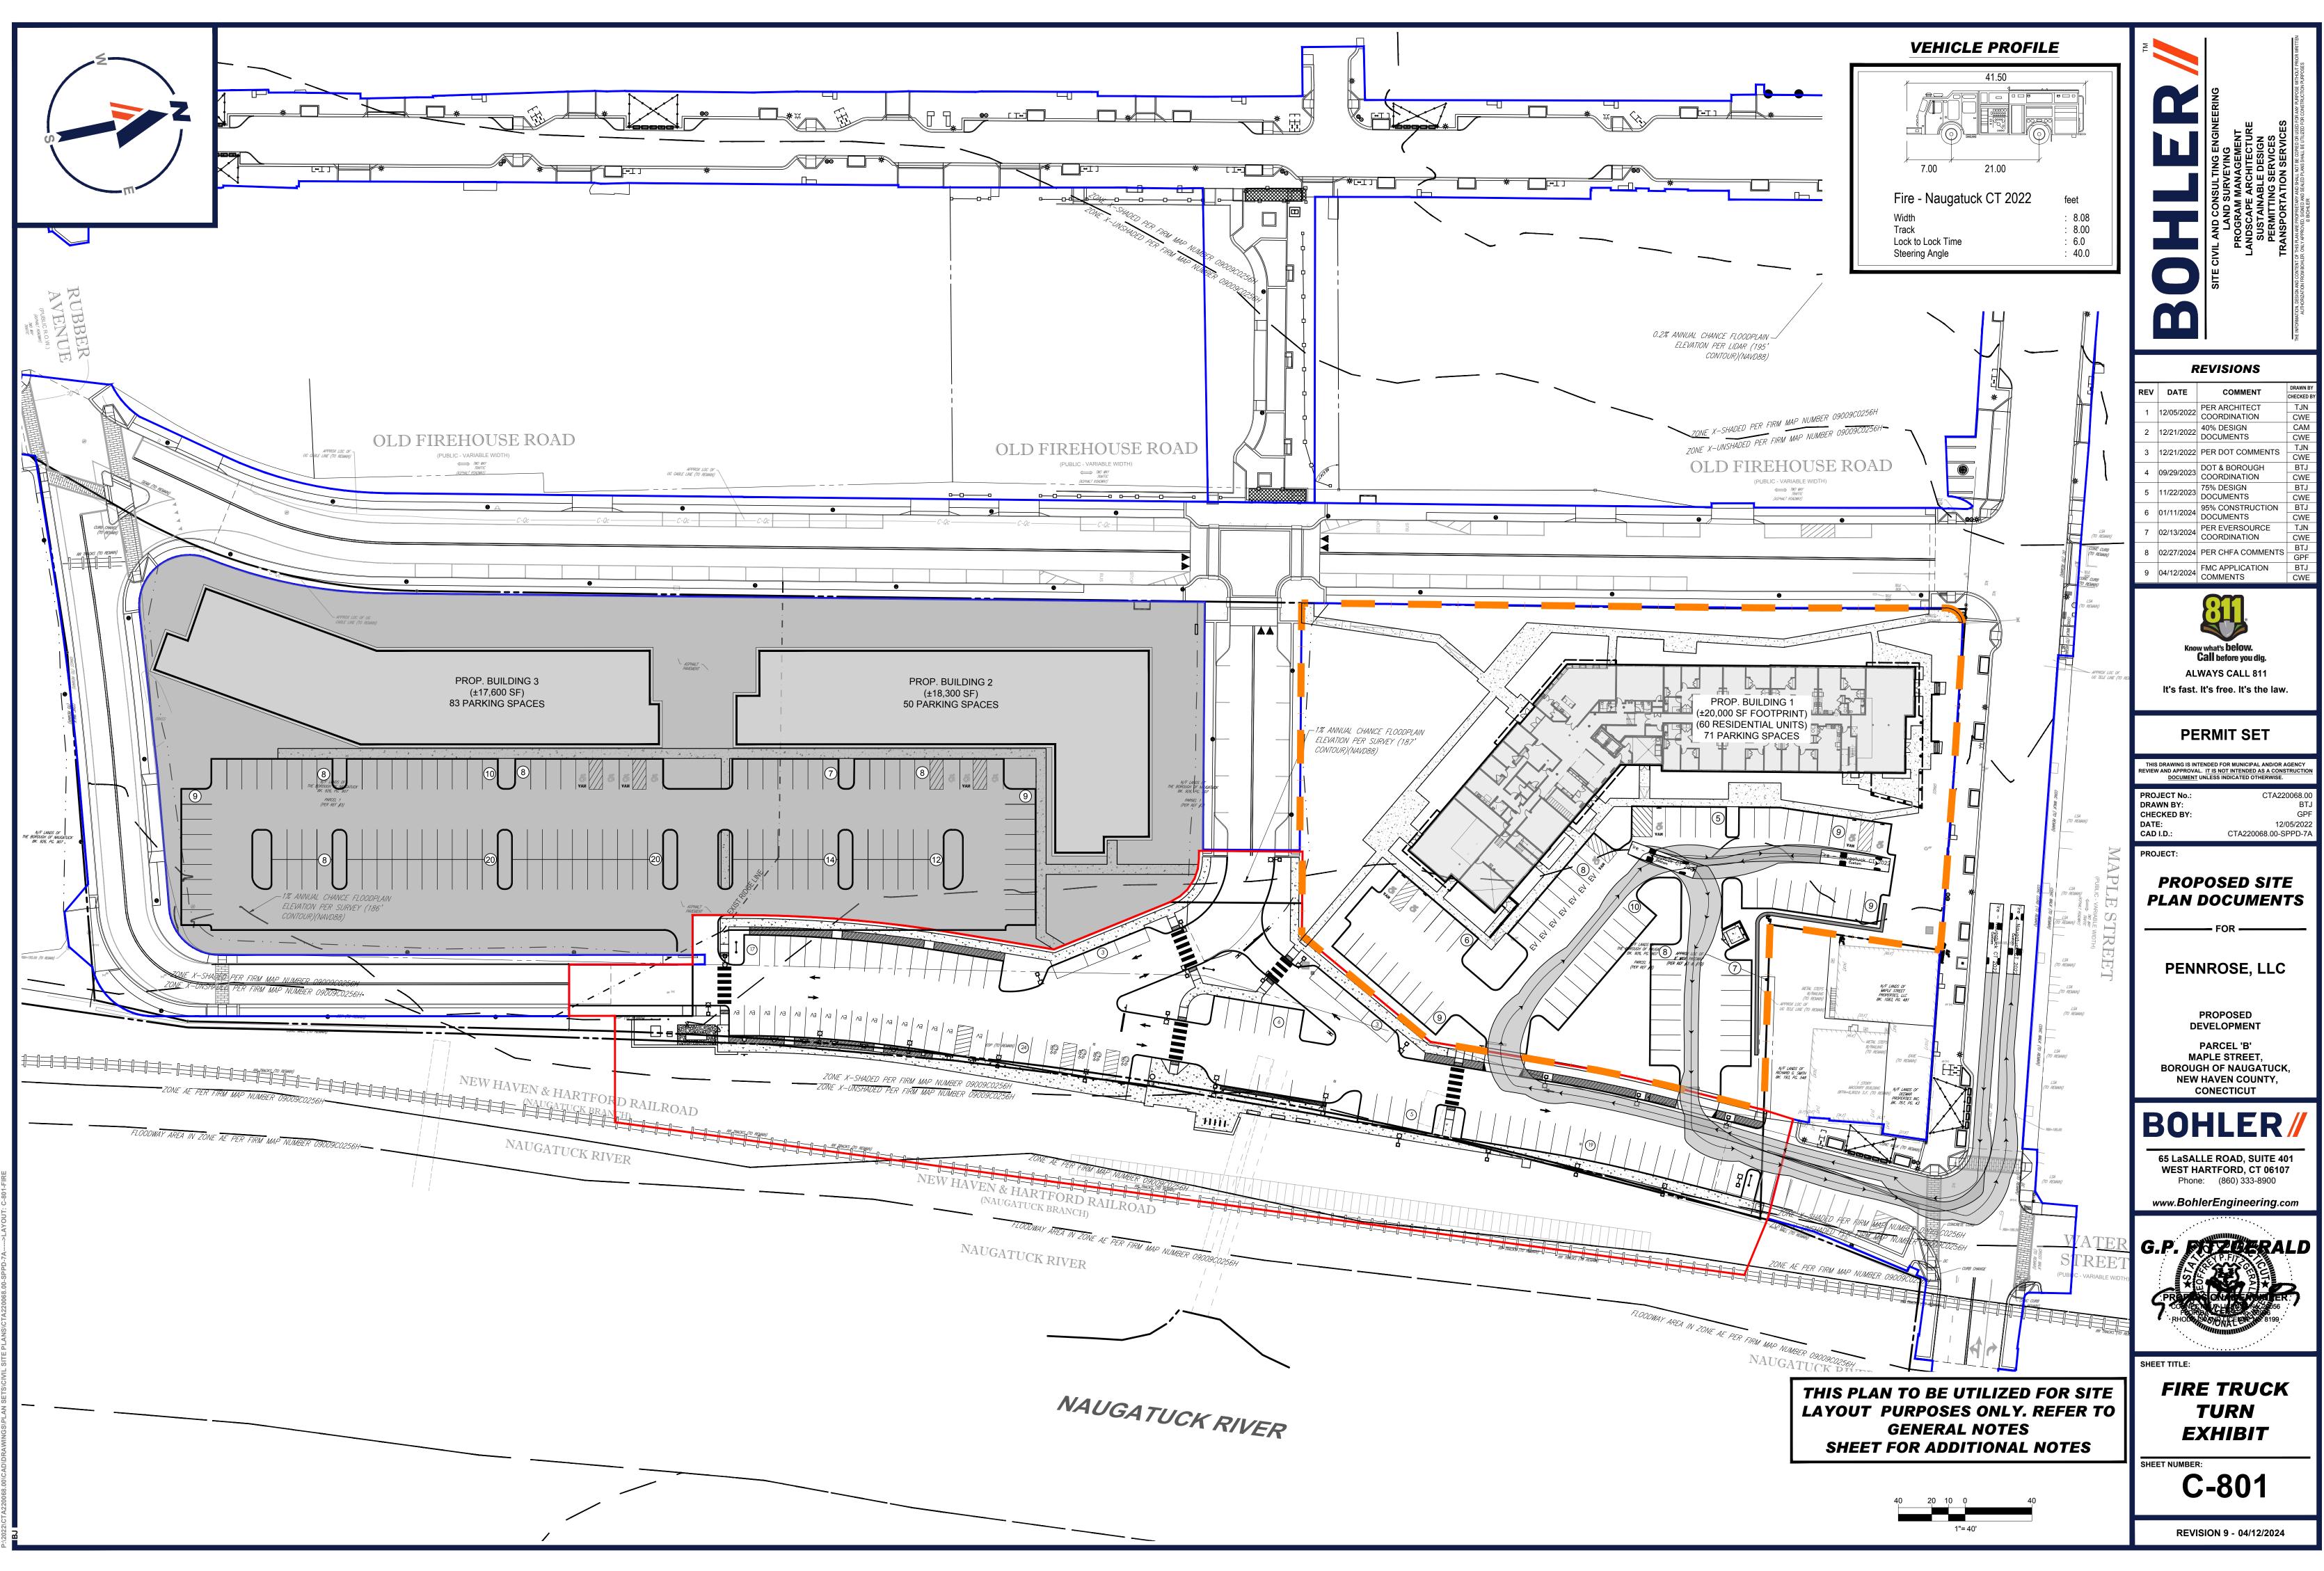


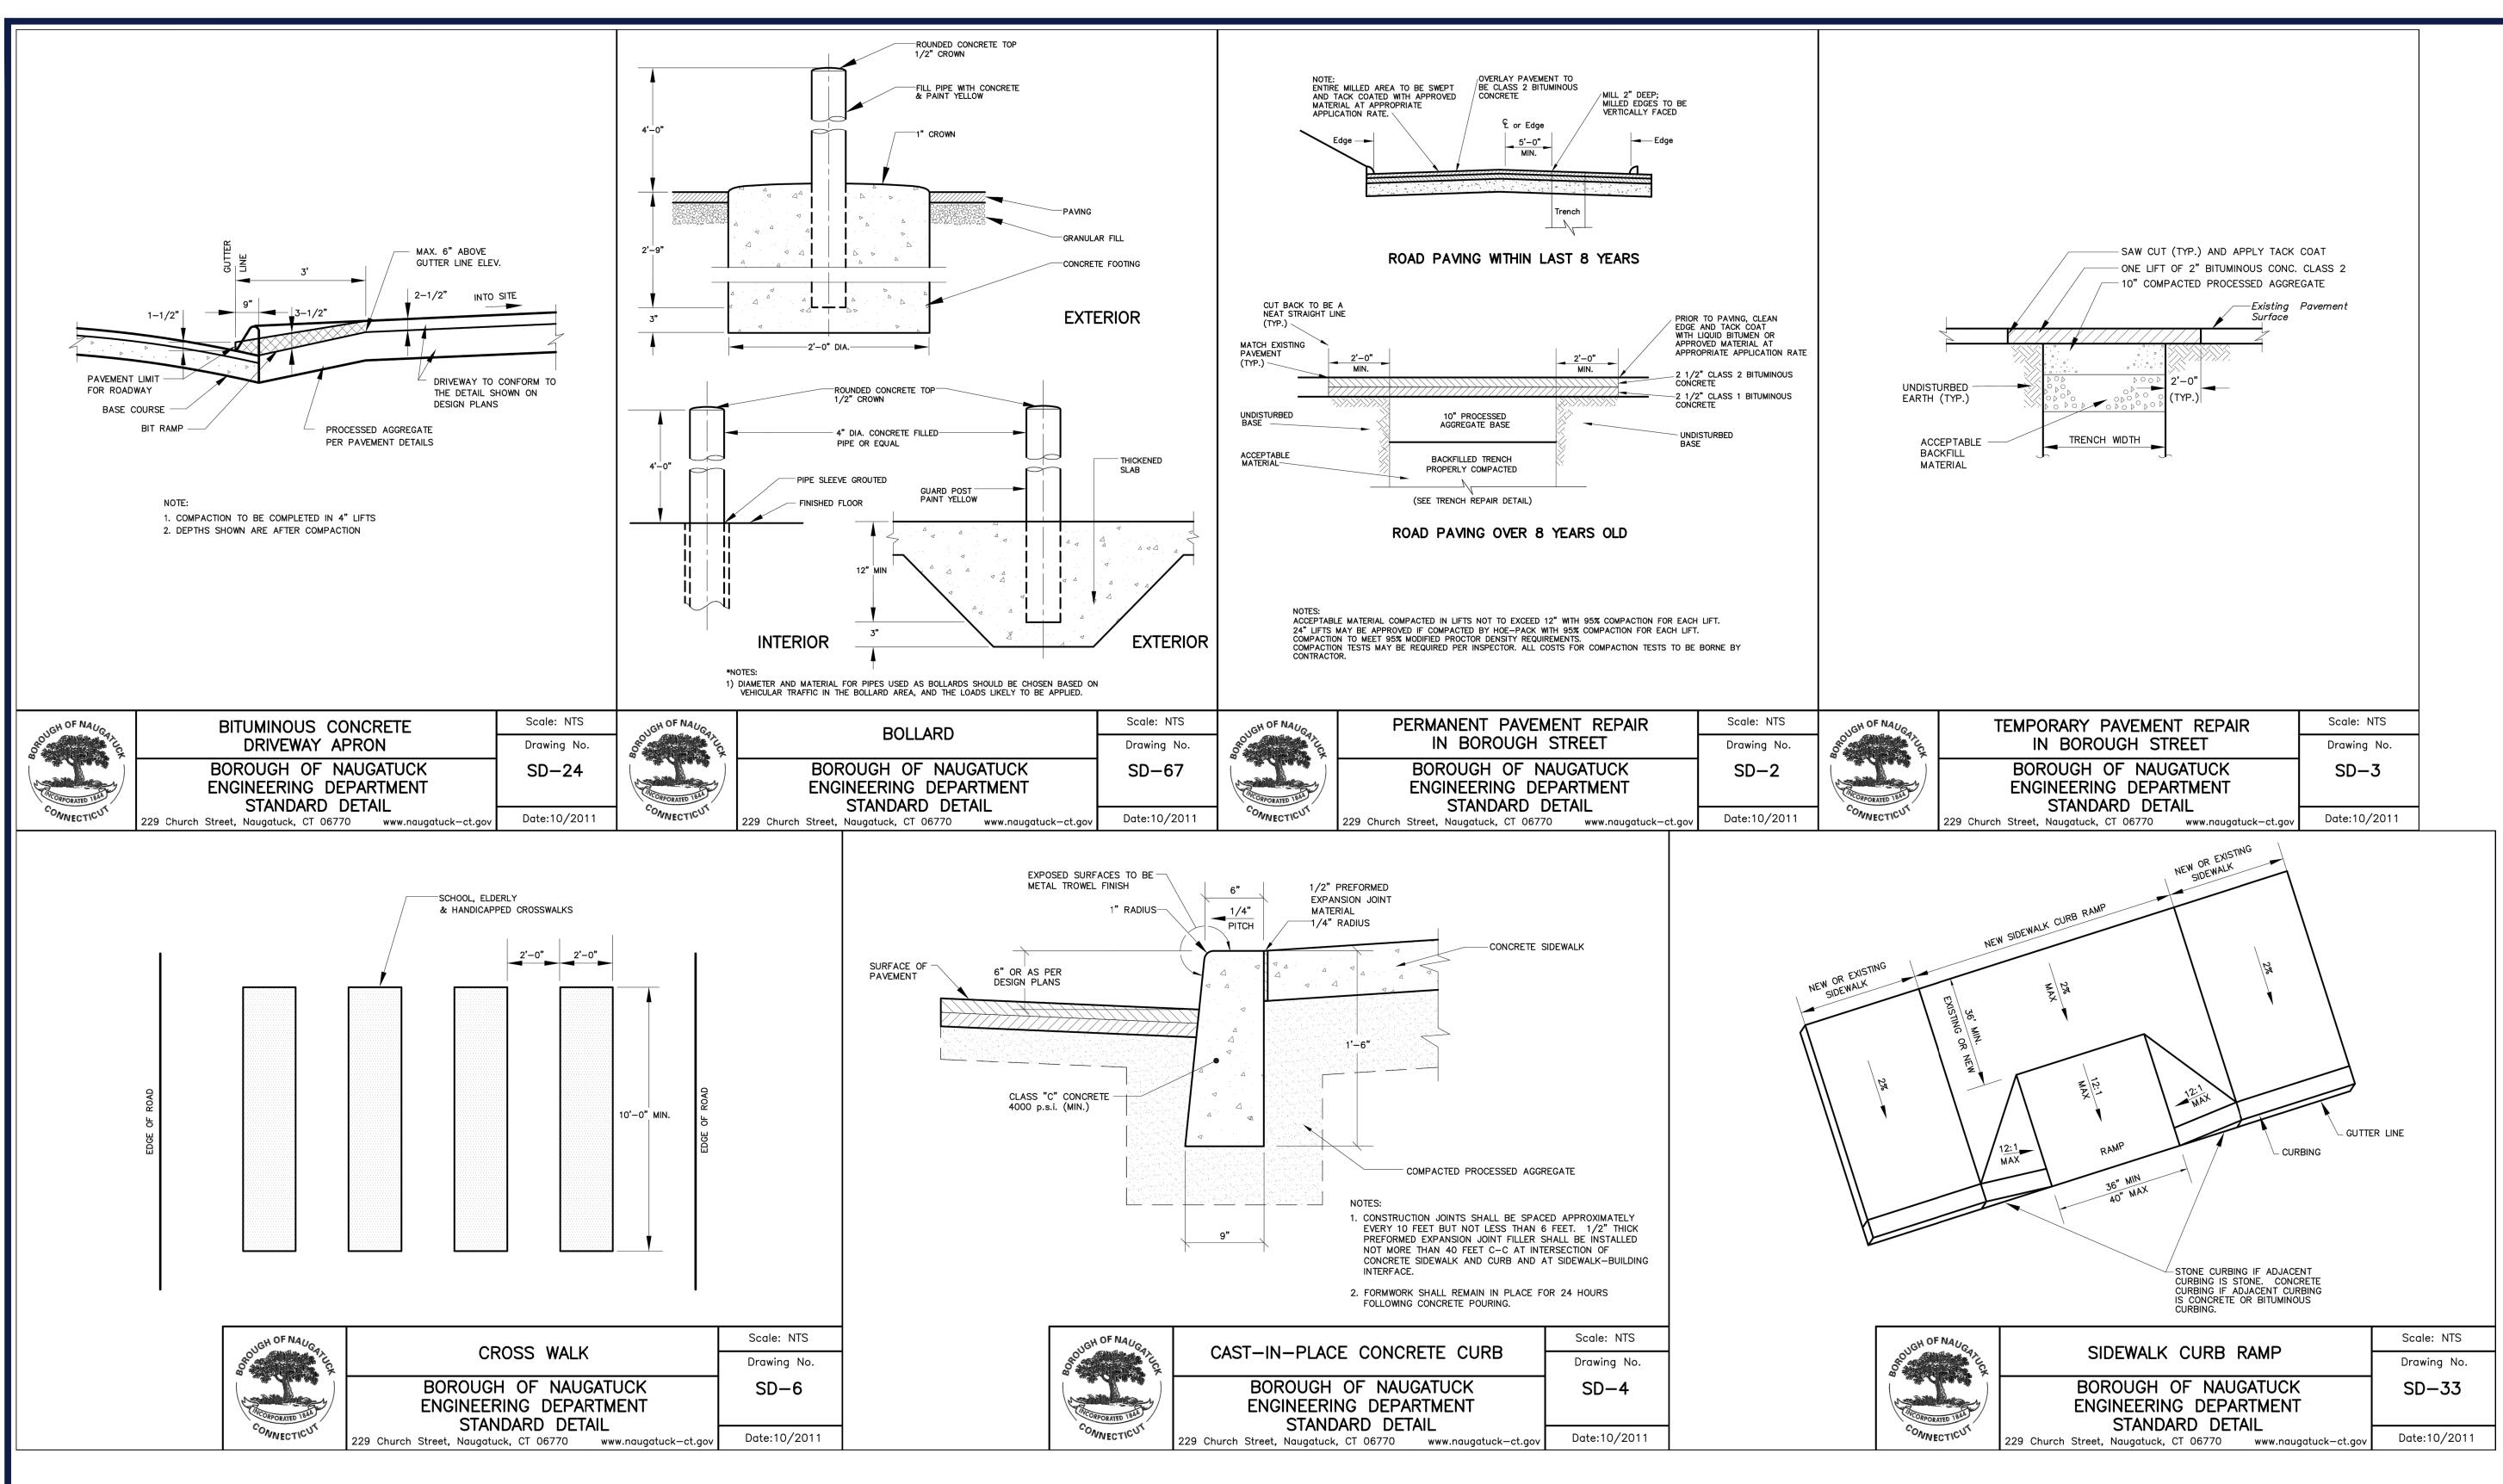


		SITE CIVIL AND CONSULTING ENGINEERING LAND SURVEYING PROGRAM MANAGEMENT LANDSCAPE ARCHITECTURE SUSTAINABLE DESIGN PERMITTING SERVICES TRANSPORTATION SERVICES	THE INFORMATION, DESIGN AND CONTENT OF THIS PLAN ARE PROPRIETARY AND SHALL NOT BE COPIED OR USED FOR ANY PURPOSE WITHOUT PRIOR WRITTEN AUTHORIZATION PROM BOHLER, ONLY APPROVED, SIGNED AND SEALED PLANS SHALL BE UTILIZED FOR CONSTRUCTION PURPOSES © BOHLER
	R	REVISIONS	
REV	DATE	COMMENT PER ARCHITECT	DRAWN BY CHECKED BY TJN
1	12/05/2022	COORDINATION 40% DESIGN DOCUMENTS	CWE CAM
3		PER DOT COMMENTS	CWE TJN CWE
4	09/29/2023	DOT & BOROUGH COORDINATION 75% DESIGN	BTJ CWE BTJ
5	11/22/2023 01/11/2024	DOCUMENTS 95% CONSTRUCTION	CWE BTJ
7	01/11/2024	DOCUMENTS PER EVERSOURCE COORDINATION	CWE TJN CWE
8	02/27/2024	PER CHFA COMMENTS	BTJ GPF
9	04/12/2024	FMC APPLICATION COMMENTS	BTJ CWE
L	AL	w what's below. Call before you dig. WAYS CALL 811 It's free. It's the law	<i>r</i> .
	PE	RMIT SET	
	AND APPROVA	TENDED FOR MUNICIPAL AND/OR /	
PRO		UNLESS INDICATED OTHERWISE.	
CHE DATE CAD	I.D.:	12/ CTA220068.00-E	BTJ GPF /05/2022
CHEC DATE CAD	CKED BY: E: I.D.: JECT: PROI LAN	POSED SIT DOCUMEN FOR FOR NROSE, LLC PROPOSED EVELOPMENT PARCEL 'B'	BTJ GPF /05/2022 DETL-7A
CHEC DATE CAD PRO		POSED SIT DOCUMEN FOR FOR NROSE, LLC PROPOSED EVELOPMENT PARCEL 'B' APLE STREET, GH OF NAUGATUCP HAVEN COUNTY, CONECTICUT	втј GPF /05/2022 DETL-7А
		POSED SIT DOCUMEN FOR FOR NROSE, LLC PROPOSED EVELOPMENT PARCEL 'B' APLE STREET, GH OF NAUGATUCH 'HAVEN COUNTY,	BTJ GPF /05/2022 DETL-7A
		POSED SIT DOCUMENT FOR FOR NROSE, LLC PROPOSED EVELOPMENT PARCEL 'B' APLE STREET, GH OF NAUGATUCH HAVEN COUNTY, CONECTICUT HELERR LLE ROAD, SUITE 44 ARTFORD, CT 0610 e: (860) 333-8900	BTJ GPF /05/2022 DETL-7A
		CTA220068.00-E	

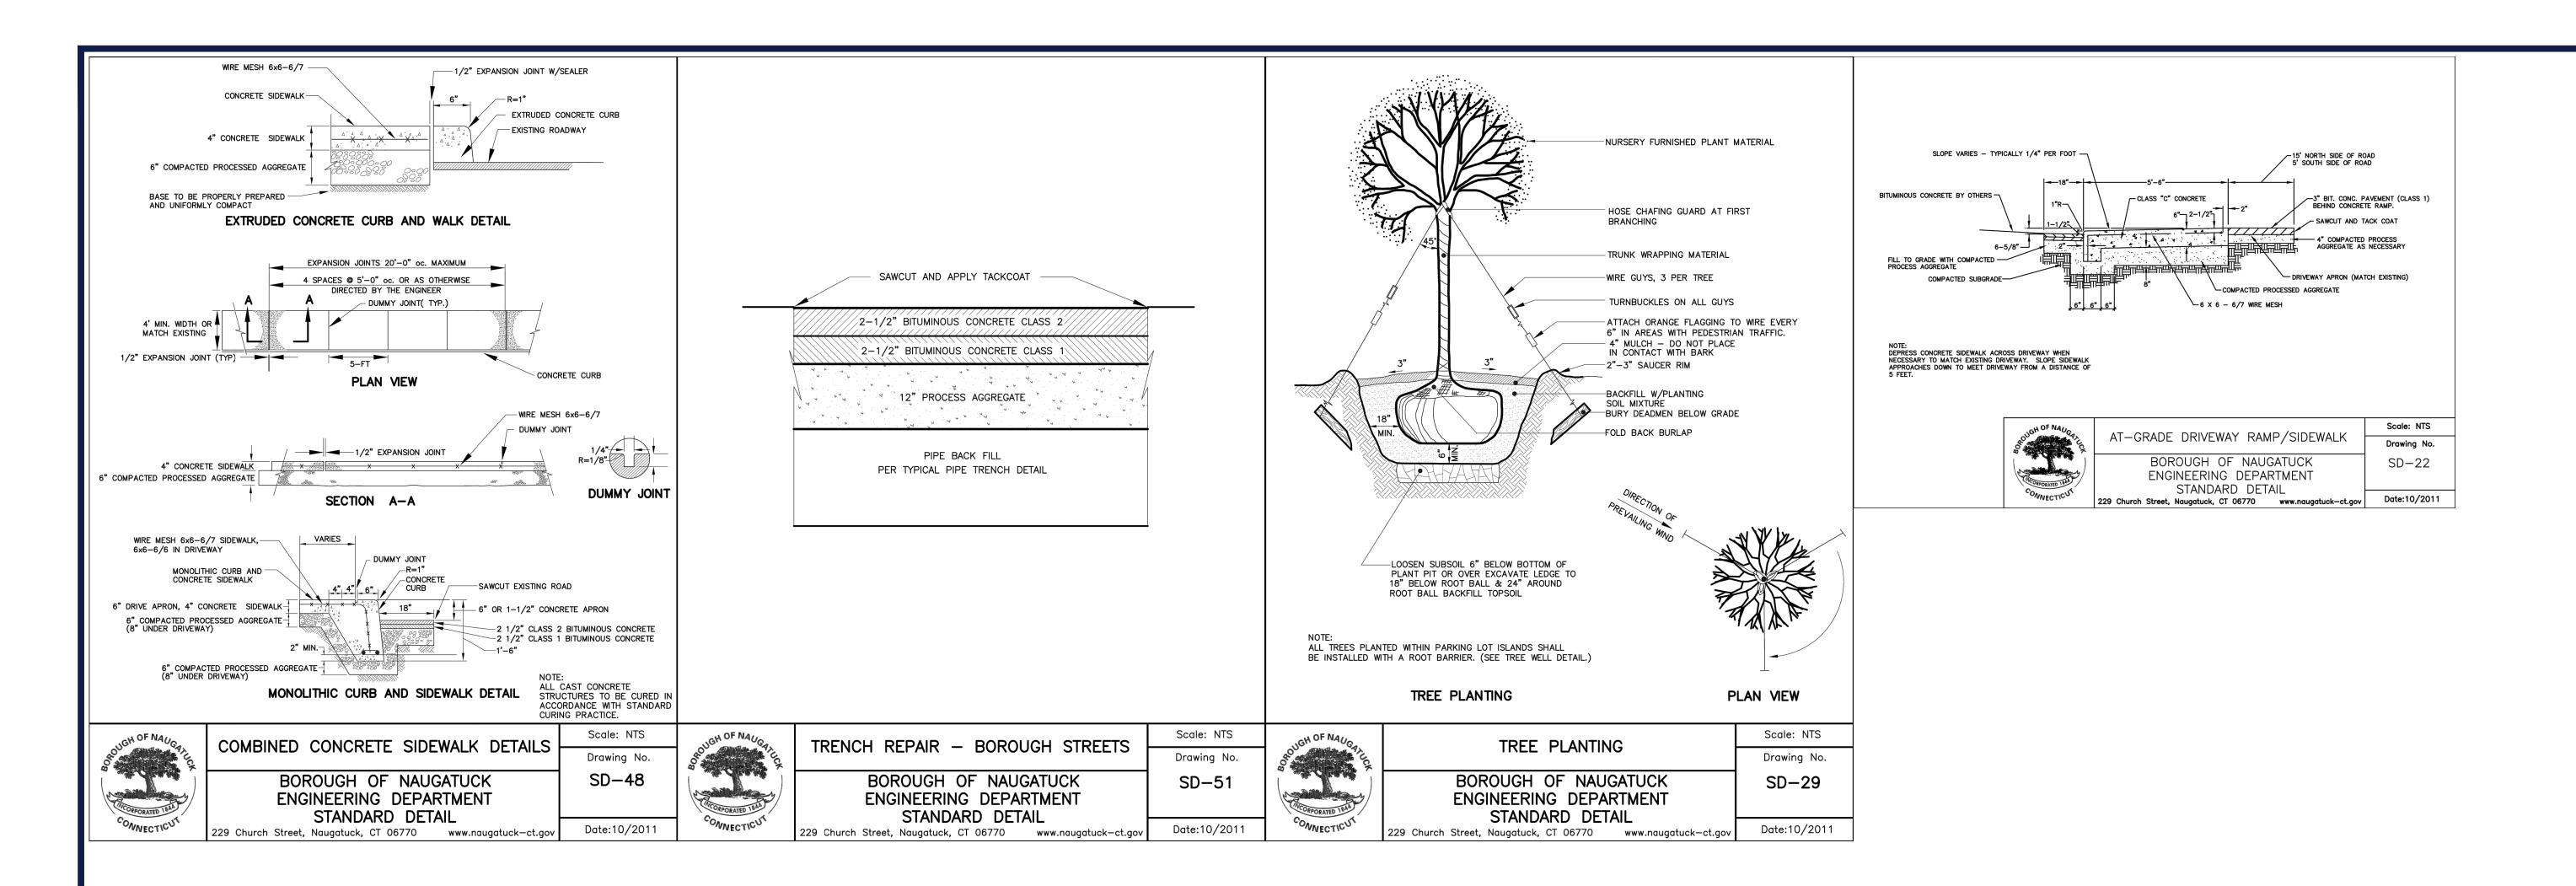


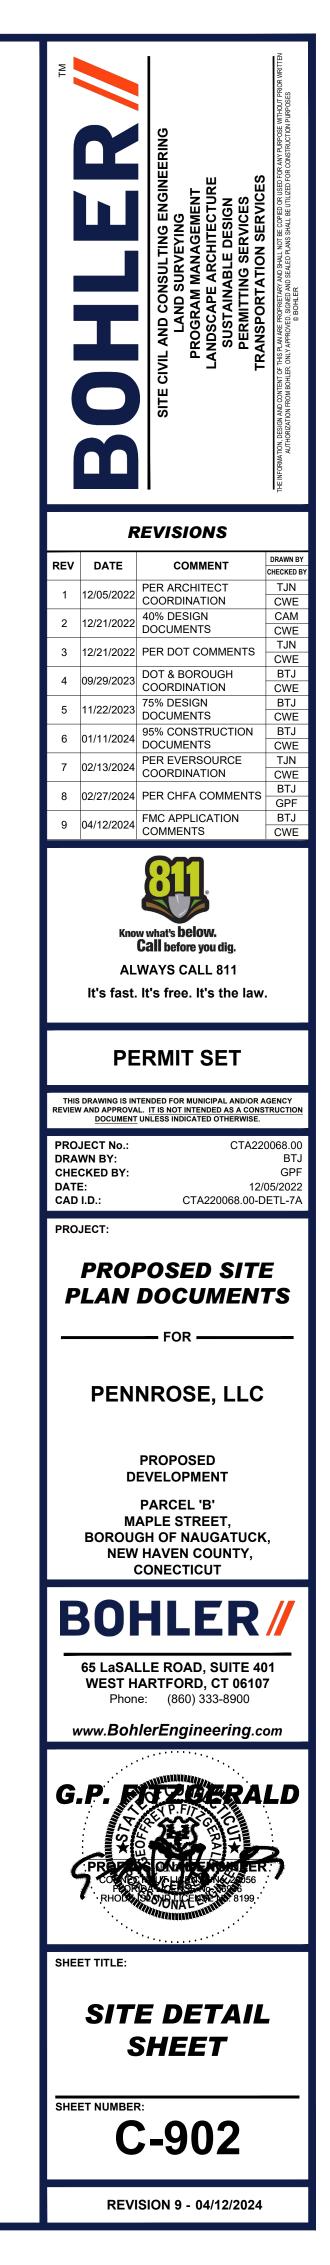

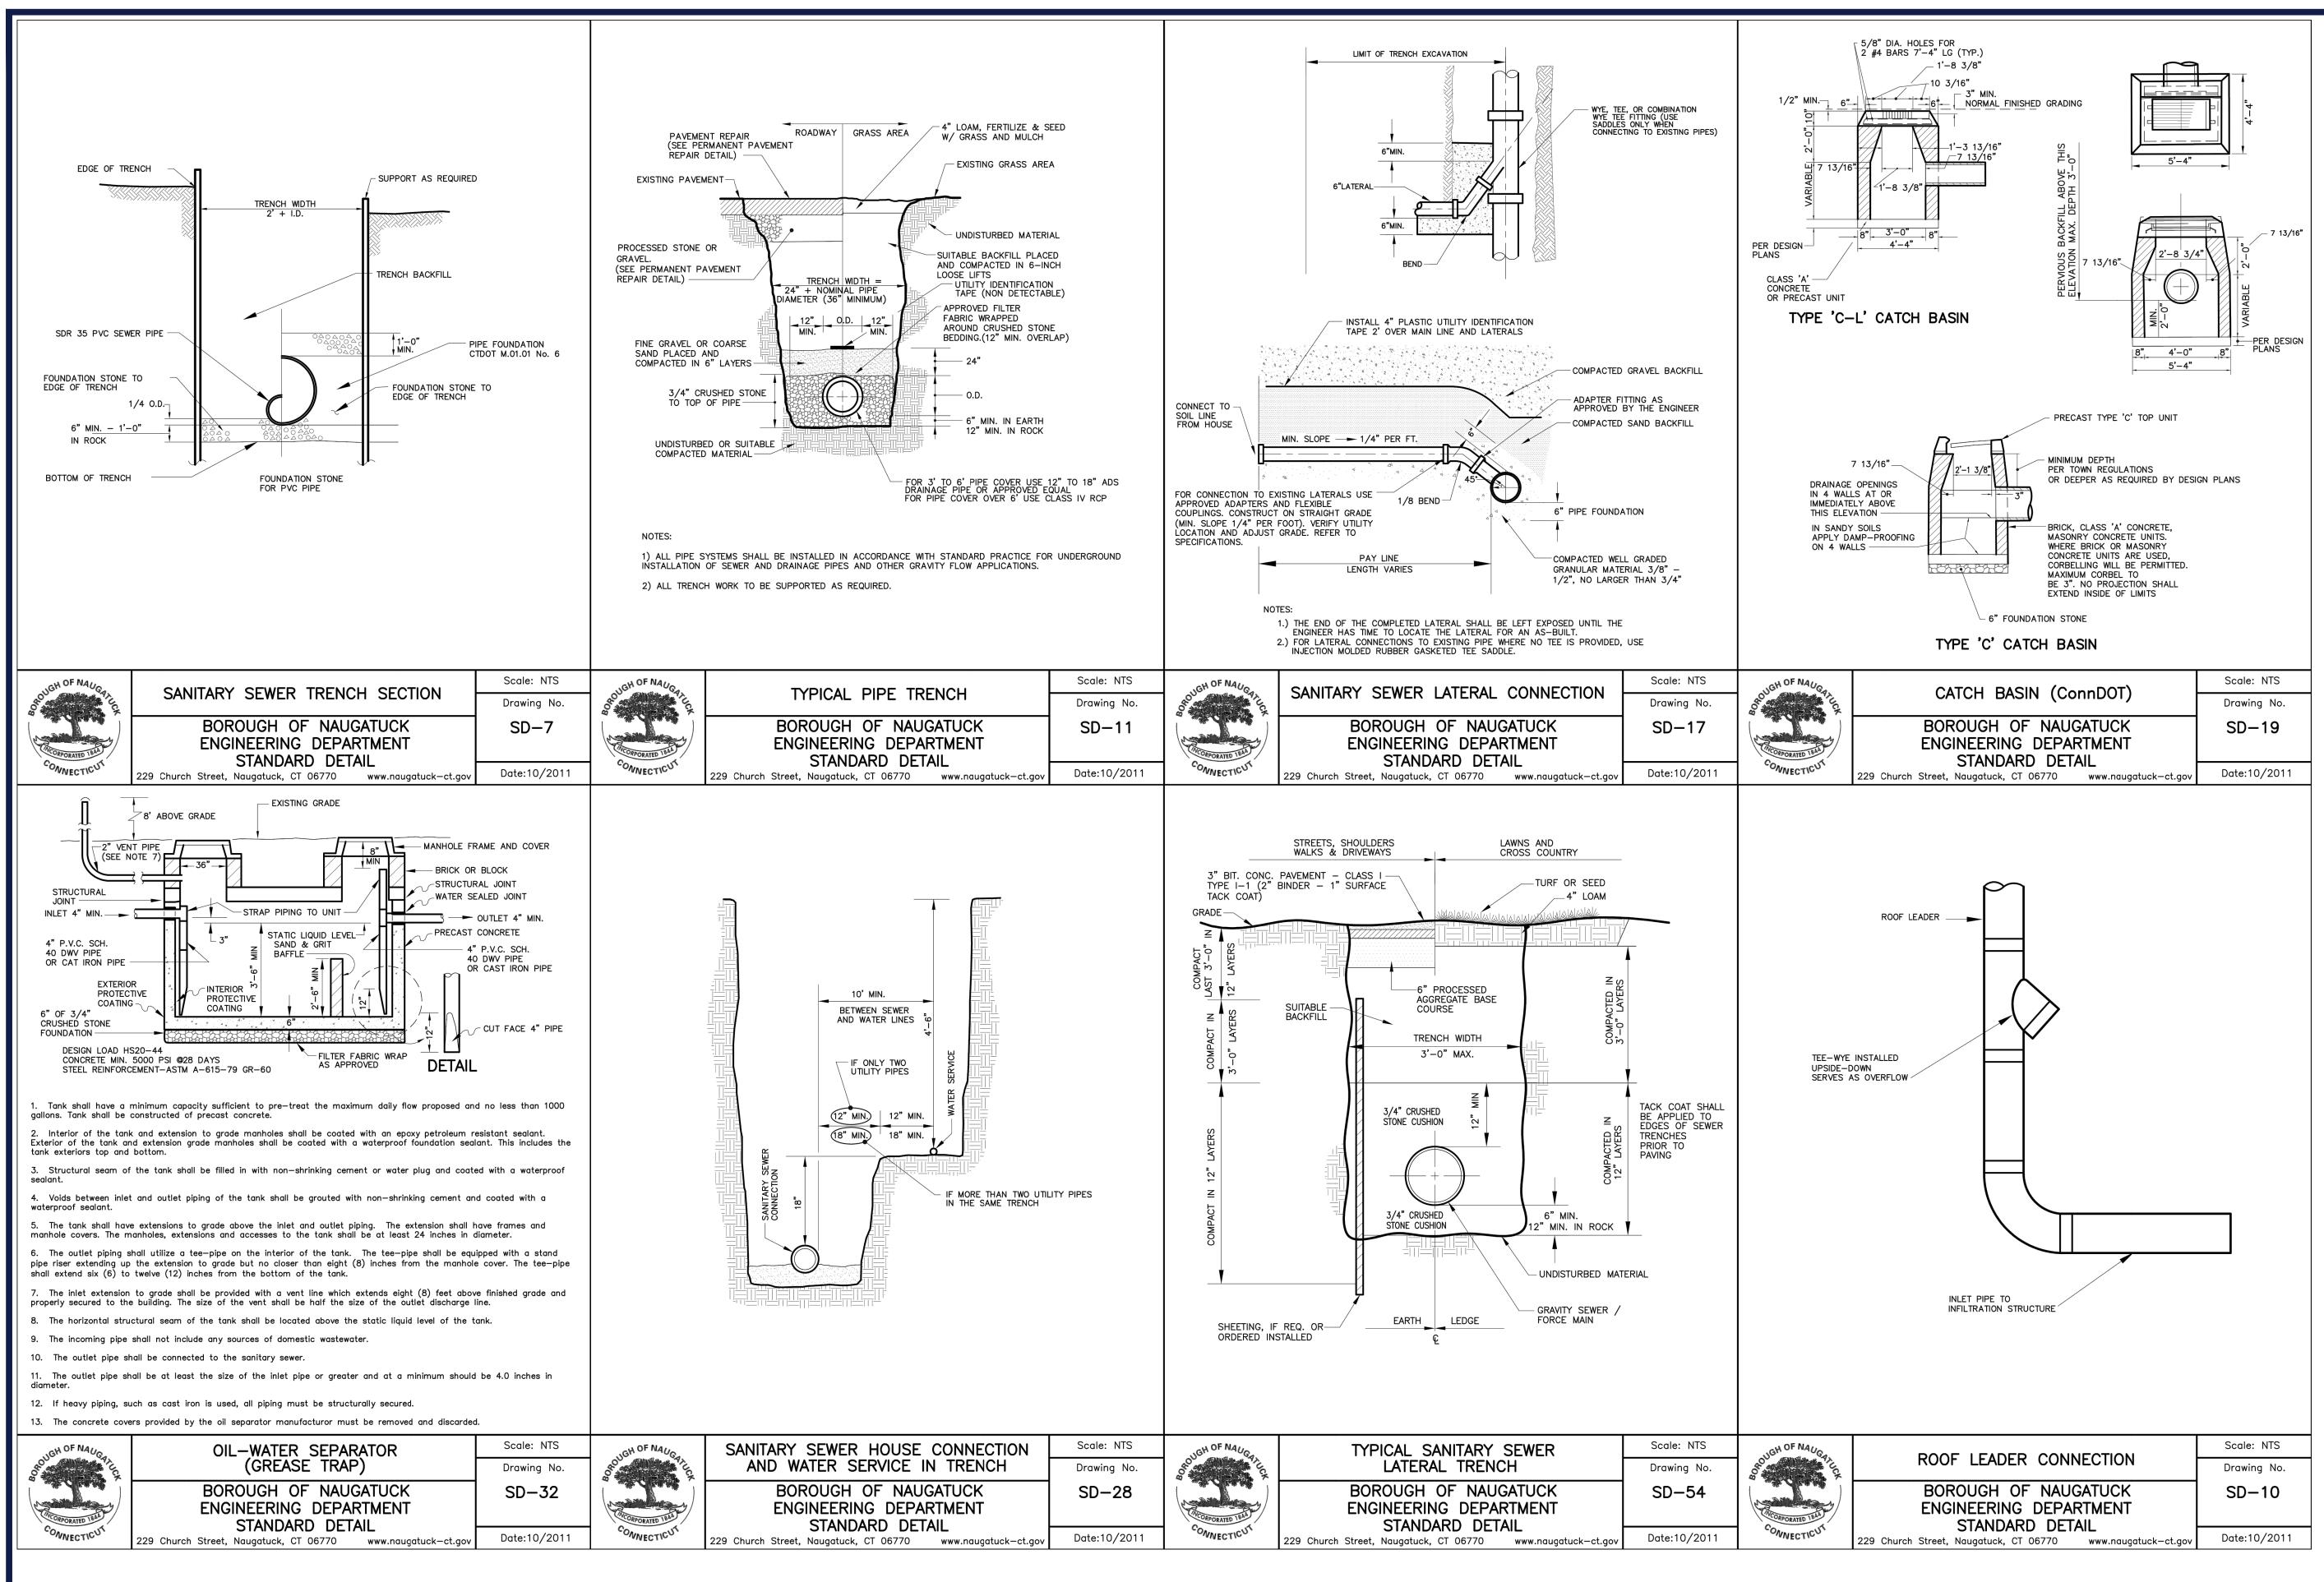

The services of the services o	THE INFORMATION, DESIGN AND CONTENT OF THIS PLAN ARE PROPRIETARY AND SHALL NOT BE COPIED OR USED FOR ANY PURPOSE WITHOUT PROR WRITTEN AUTHORIZATION PROM BOHLER, ONLY APPROVED, SIGNED AND SEALED PLANS SHALL BE UTILIZED FOR CONSTRUCTION PURPOSES © BOHLER
REVISIONS	
REVDATECOMMENT112/05/2022PER ARCHITECT COORDINATION212/21/202240% DESIGN DOCUMENTS312/21/2022PER DOT COMMENTS409/29/2023DOT & BOROUGH COORDINATION511/22/202375% DESIGN DOCUMENTS601/11/202495% CONSTRUCTION DOCUMENTS702/13/2024PER EVERSOURCE COORDINATION802/27/2024PER CHFA COMMENTS904/12/2024FMC APPLICATION 	DRAWN BY CHECKED BY TJN CWE CAM CWE TJN CWE BTJ CWE BTJ CWE BTJ CWE TJN CWE BTJ GPF BTJ GPF BTJ CWE
Know what's below. Call before you dig. ALWAYS CALL 811 It's fast. It's free. It's the law	<u>.</u>
PERMIT SET	
THIS DRAWING IS INTENDED FOR MUNICIPAL AND/OR A REVIEW AND APPROVAL. IT IS NOT INTENDED AS A CONS	
PROJECT No.: CTA22 DRAWN BY: CHECKED BY: DATE: 12/	0068.00 BTJ
CAD I.D.: CTA220068.00-D	GPF 05/2022 DETL-7A
CAD I.D.: CTA220068.00-E PROJECT: PROPOSED SITU PLAN DOCUMENT FOR PROPOSED DEVELOPMENT PARCEL 'B' MAPLE STREET, BOROUGH OF NAUGATUCK NEW HAVEN COUNTY, CONECTICUT	05/2022 DETL-7A
PROJECT: PROPOSED SITE PLAN DOCUMENT FOR FOR PROPOSED DEVELOPMENT PARCEL 'B' MAPLE STREET, BOROUGH OF NAUGATUCK NEW HAVEN COUNTY,	05/2022 DETL-7A
PROJECT: PROPOSED SITUATION OF A COMMENT FOR PRONNROSE, LLC PROPOSED DEVELOPMENT PARCEL 'B' MAPLE STREET, BOROUGH OF NAUGATUCA NEW HAVEN COUNTY, CONECTICUT BOBALLE ROAD, SUITE 40 WEST HARTFORD, CT 0610	05/2022 DETL-7A
PROJECT: PROPOSED SITUATION OF A COMMENT FOR PRONNROSE, LLC PROPOSED DEVELOPMENT PARCEL 'B' MAPLE STREET, BOROUGH OF NAUGATUCA NEW HAVEN COUNTY, CONECTICUT BOBALLE ROAD, SUITE 40 WEST HARTFORD, CT 0610	
PROJECT: PROPOSED SITU FOR FOR PENNROSE, LLCC PROPOSED DEVELOPMENT PARCEL 'B' MAPLE STREET, BOROUGH OF NAUGATUCK NEW HAVEN COUNTY, CONECTICUT BOBHLEROAD, SUITE 44 WEST HARTFORD, CT 0610 Phone: (800) 333-8900 WWW.BOHIERENGINEERING G.P. FOR FOR FOR FOR SHEET TITLE: UTILITY DETTA	

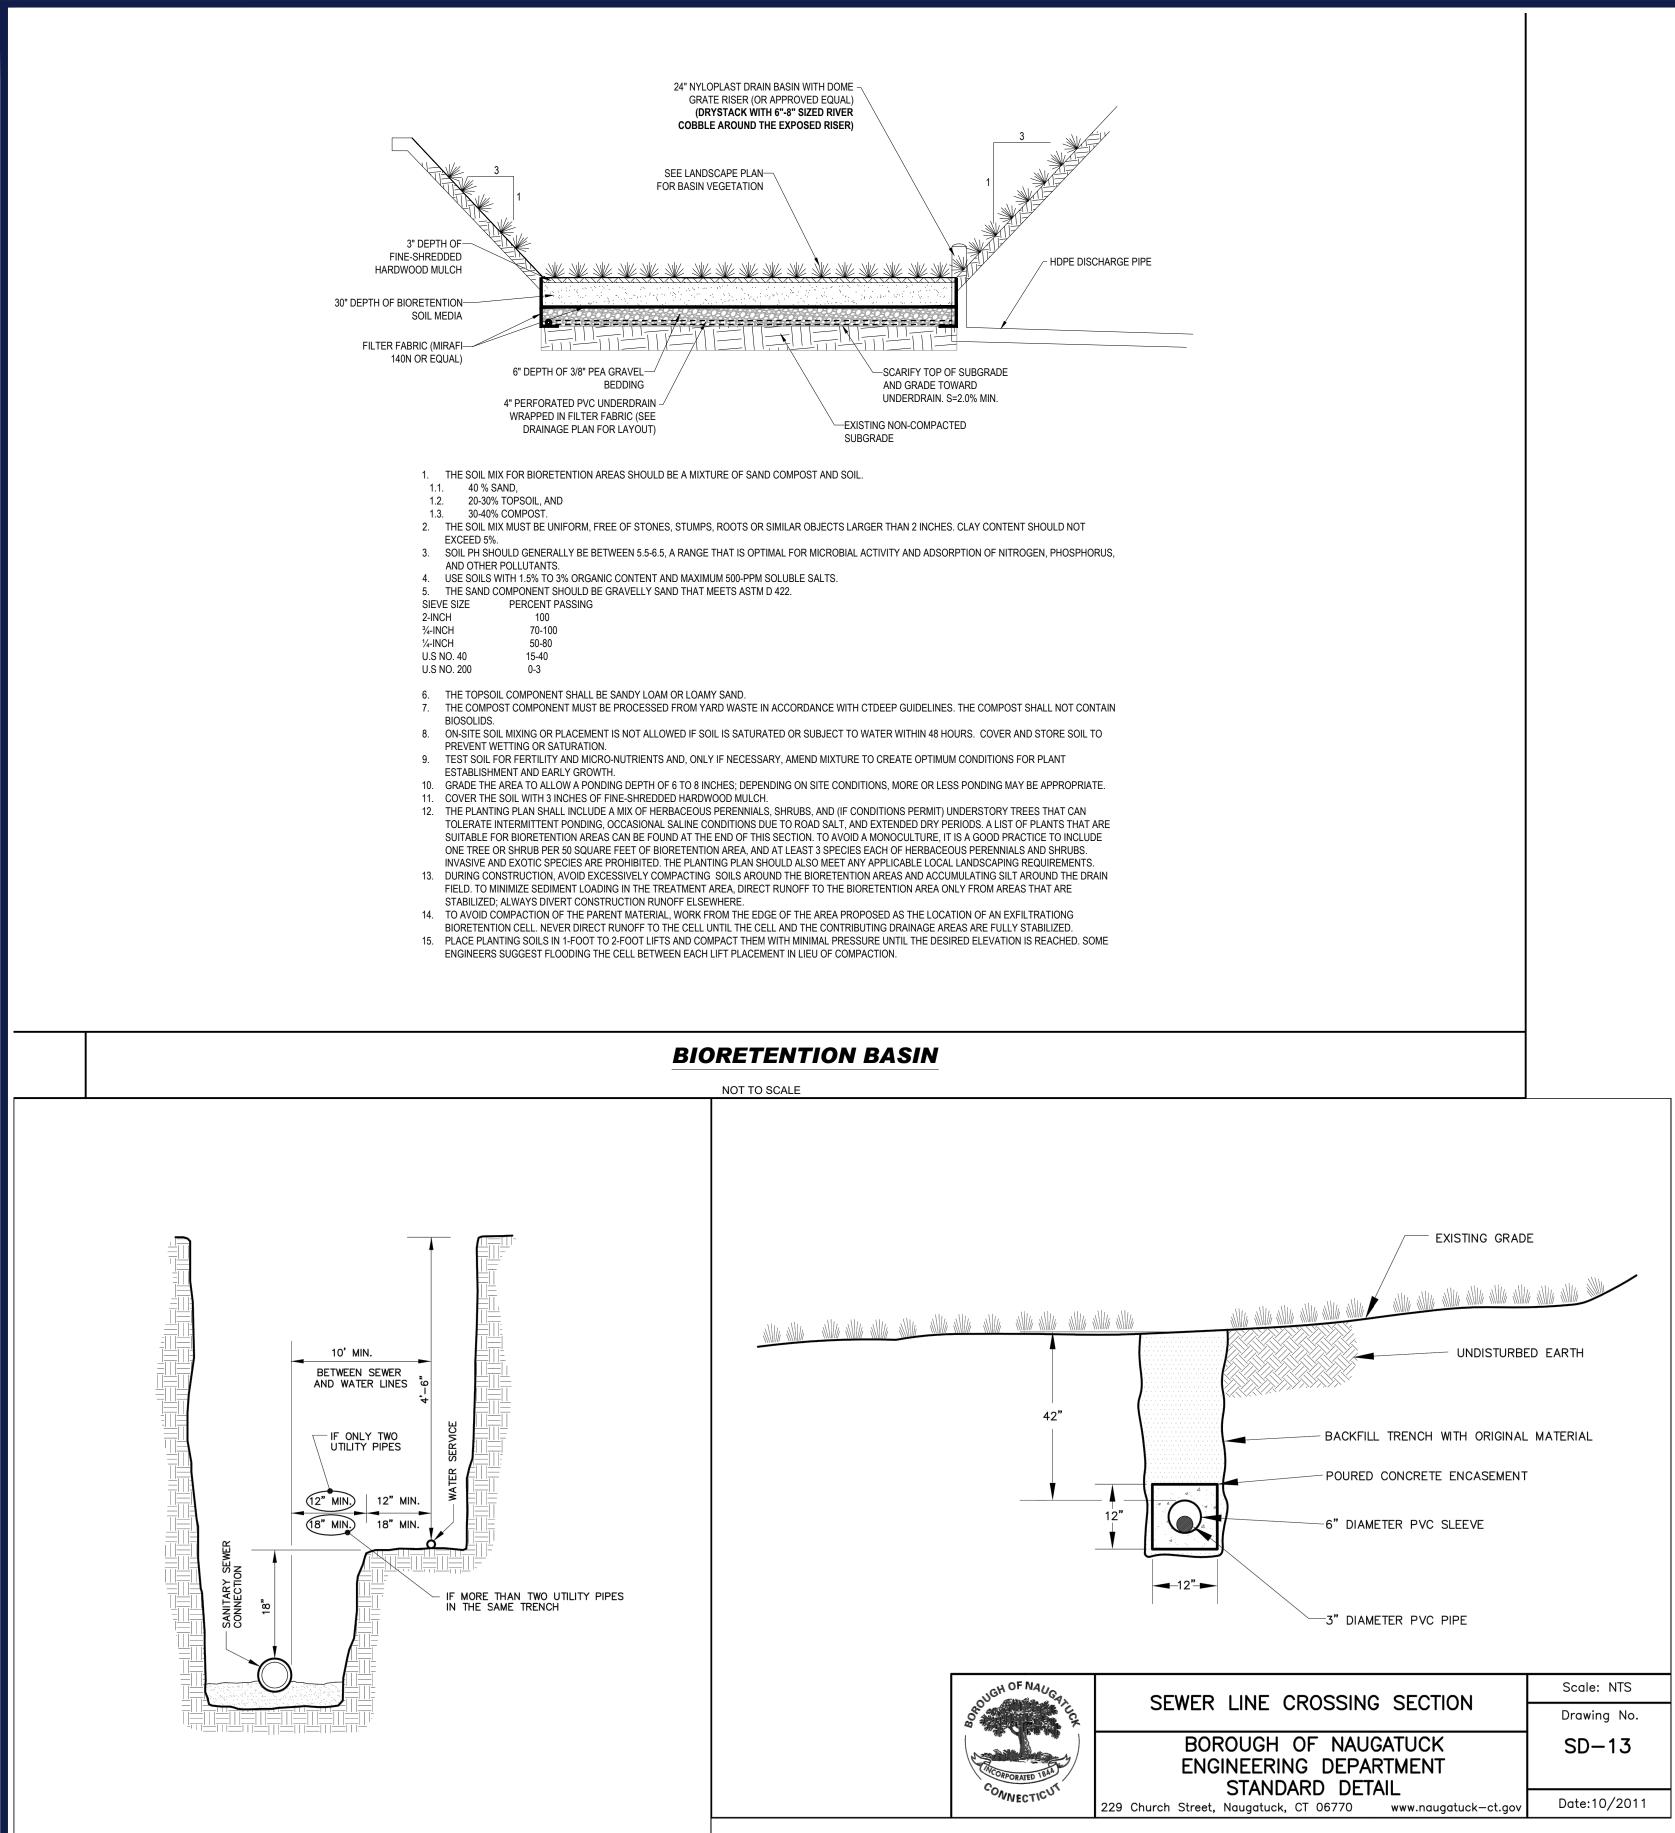

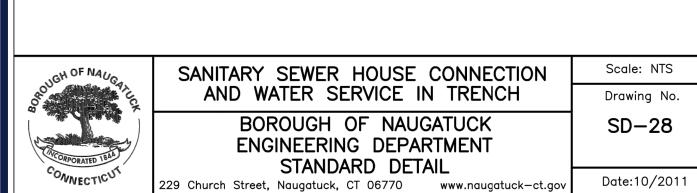

\220068.00\CAD\DRAWINGS\PLAN SETS\CIVIL SITE PLANS\CTA220068.00-DETL-7A----->LAYOUT: C-904-DE

	A CONTRACTOR OF A CONTRACTOR O	THE INFORMATION, DESIGN AND CONTENT OF THIS PLAN ARE PROPRIETARY AND SHALL NOT BE COPIED OR USED FOR ANY PURPOSE WITHOUT PROR WRITTEN AUTHORIZATION PROM BOHLER. ONLY APPROVED. SIGNED AND SEALED PLANS SHALL BE UTILIZED FOR CONSTRUCTION PURPOSES © BOHLER.
	REVISIONS	
	REV DATE COMMENT	DRAWN BY CHECKED BY
	1 12/05/2022 PER ARCHITECT	TJN
	2 12/21/2022 40% DESIGN	CWE CAM
	DOCUMENTS	CWE TJN
	3 12/21/2022 PER DOT COMMENTS	CWE BTJ
	4 09/29/2023 COORDINATION	CWE BTJ
	5 11/22/2023 DOCUMENTS 95% CONSTRUCTION	CWE
	6 01/11/2024 DOCUMENTS	CWE
	7 02/13/2024 PER EVERSOURCE COORDINATION	TJN CWE
	8 02/27/2024 PER CHFA COMMENTS	BTJ GPF
	9 04/12/2024 FMC APPLICATION COMMENTS	BTJ CWE
	000	
	811	
	Know what's below .	
	Call before you dig.	
	ALWAYS CALL 811 It's fast. It's free. It's the law	,
		•
	PERMIT SET	
	THIS DRAWING IS INTENDED FOR MUNICIPAL AND/OR /	AGENCY
- 1	THIS DRAWING IS INTENDED FOR MUNICIPAL AND/OR AGENCY REVIEW AND APPROVAL. IT IS NOT INTENDED AS A CONSTRUCTION <u>DOCUMENT</u> UNLESS INDICATED OTHERWISE.	
		STRUCTION
	PROJECT No.: CTA22	20068.00
	PROJECT No.: CTA22 DRAWN BY: CHECKED BY:	20068.00 BTJ GPF
	PROJECT No.: CTA22 DRAWN BY: CHECKED BY:	20068.00 BTJ GPF /05/2022
	PROJECT No.: CTA22 DRAWN BY: CHECKED BY: DATE: 12/	20068.00 BTJ GPF /05/2022
	PROJECT No.: CTA22 DRAWN BY: CHECKED BY: DATE: 12/ CAD I.D.: CTA220068.00-E PROJECT: 12/	20068.00 BTJ GPF /05/2022 DETL-7A
	PROJECT No.: CTA22 DRAWN BY: CHECKED BY: DATE: 12/ CAD I.D.: CTA220068.00-E PROJECT: PROPOSED SIT	20068.00 BTJ GPF /05/2022 DETL-7A
	PROJECT No.: CTA22 DRAWN BY: CHECKED BY: DATE: 12/ CAD I.D.: CTA220068.00-E PROJECT: 12/	20068.00 BTJ GPF /05/2022 DETL-7A
	PROJECT No.: CTA22 DRAWN BY: CHECKED BY: DATE: 12/ CAD I.D.: CTA220068.00-E PROJECT: PROPOSED SIT	20068.00 BTJ GPF /05/2022 DETL-7A
	PROJECT No.: CTA22 DRAWN BY: CHECKED BY: DATE: 12/ CAD I.D.: CTA220068.00-E PROJECT: PROPOSED SITU PLAN DOCUMEN	20068.00 BTJ GPF /05/2022 DETL-7A
	PROJECT No.: CTA22 DRAWN BY: CHECKED BY: DATE: 12/ CAD I.D.: CTA220068.00-E PROJECT: PROPOSED SITU PLAN DOCUMEN	20068.00 BTJ GPF /05/2022 DETL-7A
	PROJECT No.: CTA22 DRAWN BY: CHECKED BY: DATE: 12/ CAD I.D.: CTA220068.00-E PROJECT: PROPOSED SITU PLAN DOCUMEN	20068.00 BTJ GPF /05/2022 DETL-7A
	PROJECT No.: CTA22 DRAWN BY: CHECKED BY: DATE: 12/ CAD I.D.: CTA220068.00-E PROJECT: PROPOSED SITU PROPOSED SITU PROPOSED SITU PLAN DOCUMENT	20068.00 BTJ GPF /05/2022 DETL-7A
	PROJECT No.: CTA22 DRAWN BY: CHECKED BY: DATE: 12/ CAD I.D.: CTA220068.00-E PROJECT: PROPOSED SITU PLAN DOCUMEN	20068.00 BTJ GPF /05/2022 DETL-7A
	PROJECT No.: CTA22 DRAWN BY: CHECKED BY: DATE: 12/ CAD I.D.: CTA220068.00-E PROJECT: PROPOSED SITU PROPOSED SITU PROPOSED FOR FOR PENNROSE, LLCC PROPOSED DEVELOPMENT PARCEL 'B'	20068.00 BTJ GPF /05/2022 DETL-7A
	PROJECT No.: CTA22 DRAWN BY: CHECKED BY: DATE: 12/ CAD I.D.: CTA220068.00-D PROJECT: PROJECT: PROPOSED SITU FOR FOR PENNROSE, LLCC PROPOSED DEVELOPMENT PARCEL 'B' MAPLE STREET,	20068.00 BTJ GPF 705/2022 DETL-7A
	PROJECT No.: CTA22 DRAWN BY: CHECKED BY: DATE: 12 CAD I.D.: CTA220068.00-E PROJECT: PROJECT: PROPOSED SITU FOR FOR PENNROSE, LLCC PROPOSED DEVELOPMENT PARCEL 'B' MAPLE STREET, BOROUGH OF NAUGATUCK NEW HAVEN COUNTY,	20068.00 BTJ GPF 705/2022 DETL-7A
	PROJECT No.: CTA22 DRAWN BY: CHECKED BY: DATE: 12/ CAD I.D.: CTA220068.00-E PROJECT: PROJECT: PROPOSED SITU FOR FOR PENNROSE, LLCC PROPOSED DEVELOPMENT PARCEL 'B' MAPLE STREET, BOROUGH OF NAUGATUCK	20068.00 BTJ GPF 705/2022 DETL-7A
	PROJECT No.: CTA22 DRAWN BY: CHECKED BY: DATE: 12/ CAD I.D.: CTA220068.00-E PROJECT: PROJECT: PROPOSED SITU FOR FOR PENNROSE, LLCC PROPOSED DEVELOPMENT PARCEL 'B' MAPLE STREET, BOROUGH OF NAUGATUCH NEW HAVEN COUNTY, CONECTICUT	20068.00 BTJ GPF /05/2022 DETL-7A
	PROJECT No.: CTA22 DRAWN BY: CHECKED BY: DATE: 12 CAD I.D.: CTA220068.00-E PROJECT: PROJECT: PROPOSED SITU FOR FOR PENNROSE, LLCC PROPOSED DEVELOPMENT PARCEL 'B' MAPLE STREET, BOROUGH OF NAUGATUCK NEW HAVEN COUNTY,	20068.00 BTJ GPF /05/2022 DETL-7A
	PROJECT NO.: CTA22 DRAWN BY: CHECKED BY: DATE: 12 CAD I.D.: CTA220068.00-E PROJECT: PROJECT: PROPOSED SITU FOR FOR PENNROSE, LLCO PROPOSED DEVELOPMENT PARCEL 'B' MAPLE STREET, BOROUGH OF NAUGATUCK NEW HAVEN COUNTY, CONECTICUT BORDLEROAD, SUITE 44	20068.00 BTJ GPF /05/2022 DETL-7A
	PROJECT NO.: CTA22 DRAWN BY: CHECKED BY: DATE: 12 CAD I.D.: CTA220068.00-E PROJECT: PROJECT: PROPOSED SITU FOR FOR PENNROSE, LLCO PROPOSED DEVELOPMENT PARCEL 'B' MAPLE STREET, BOROUGH OF NAUGATUCH NEW HAVEN COUNTY, CONECTICUT	20068.00 BTJ GPF /05/2022 DETL-7A
	PROJECT NO.: CTA22 DRAWN BY: CHECKED BY: DATE: 12 CAD I.D.: CTA220068.00-E PROJECT: PROJECT: PROPOSED SITUE FOR FOR PENNROSE, LLC PROPOSED DEVELOPMENT PARCEL 'B' MAPLE STREET, BOROUGH OF NAUGATUCH NEW HAVEN COUNTY, CONECTICUT BOBLESSAULE STREET, BOROUGH OF NAUGATUCH NEW HAVEN COUNTY, CONECTICUT	20068.00 BTJ GPF 205/2022 DETL-7A E TS C, C, C, D1 7
	PROJECT NO.: CTA22 DRAWN BY: CHECKED BY: DATE: 12 CAD I.D.: CTA220068.00-E PROJECT: PROPOSED SITU FOR FOR PENNROSE, LLC PROPOSED DEVELOPMENT PARCEL 'B' MAPLE STREET, BOROUGH OF NAUGATUCK NEW HAVEN COUNTY, CONECTICUT BOBLEROAD, SUITE 44 WEST HARTFORD, CT 0610	20068.00 BTJ GPF 205/2022 DETL-7A E TS C, C, C, D1 7
	PROJECT NO.: CTA22 DRAWN BY: CHECKED BY: DATE: 12 CAD I.D.: CTA220068.00-E PROJECT: PROJECT: PROPOSED SITUE FOR FOR PENNROSE, LLC PROPOSED DEVELOPMENT PARCEL 'B' MAPLE STREET, BOROUGH OF NAUGATUCH NEW HAVEN COUNTY, CONECTICUT BOBLESSAULE STREET, BOROUGH OF NAUGATUCH NEW HAVEN COUNTY, CONECTICUT	20068.00 BTJ GPF 205/2022 DETL-7A E TS C, C, C, D1 7
	PROJECT NO.: CTA22 DRAWN BY: CHECKED BY: DATE: 12 CAD I.D.: CTA220068.00-E PROJECT: PROJECT: PROPOSED SITUE FOR FOR PENNROSE, LLC PROPOSED DEVELOPMENT PARCEL 'B' MAPLE STREET, BOROUGH OF NAUGATUCH NEW HAVEN COUNTY, CONECTICUT BOBLESSAULE STREET, BOROUGH OF NAUGATUCH NEW HAVEN COUNTY, CONECTICUT	20068.00 BTJ GPF 205/2022 DETL-7A E TS C, C, C, D1 7
	PROJECT NO.: CTA22 DRAWN BY: CHECKED BY: DATE: 12 CAD I.D.: CTA220068.00-E PROJECT: PROJECT: PROPOSED SITUE FOR FOR PENNROSE, LLC PROPOSED DEVELOPMENT PARCEL 'B' MAPLE STREET, BOROUGH OF NAUGATUCH NEW HAVEN COUNTY, CONECTICUT BOBLESSAULE STREET, BOROUGH OF NAUGATUCH NEW HAVEN COUNTY, CONECTICUT	20068.00 BTJ GPF 205/2022 DETL-7A E TS C, C, C, D1 7
	PROJECT NO.: CTA22 DRAWN BY: CHECKED BY: DATE: 12 CAD I.D.: CTA220068.00-E PROJECT: PROJECT: PROPOSED SITUE FOR FOR PENNROSE, LLC PROPOSED DEVELOPMENT PARCEL 'B' MAPLE STREET, BOROUGH OF NAUGATUCH NEW HAVEN COUNTY, CONECTICUT BOBLESSAULE STREET, BOROUGH OF NAUGATUCH NEW HAVEN COUNTY, CONECTICUT	20068.00 BTJ GPF 205/2022 DETL-7A E TS C, C, C, D1 7
	PROJECT NO.: CTA22 DRAWN BY: CHECKED BY: DATE: 12 CAD I.D.: CTA220068.00-E PROJECT: PROJECT: PROPOSED SITUE FOR FOR PENNROSE, LLC PROPOSED DEVELOPMENT PARCEL 'B' MAPLE STREET, BOROUGH OF NAUGATUCH NEW HAVEN COUNTY, CONECTICUT BOBLESSAULE STREET, BOROUGH OF NAUGATUCH NEW HAVEN COUNTY, CONECTICUT	20068.00 BTJ GPF 205/2022 DETL-7A E TS C, C, C, D1 7
	PROJECT NO.: CTA22 DRAWN BY: CHECKED BY: DATE: 12 CAD I.D.: CTA220068.00-E PROJECT: PROJECT: PROPOSED SITUE FOR FOR PENNROSE, LLC PROPOSED DEVELOPMENT PARCEL 'B' MAPLE STREET, BOROUGH OF NAUGATUCH NEW HAVEN COUNTY, CONECTICUT BOBLESSAULE STREET, BOROUGH OF NAUGATUCH NEW HAVEN COUNTY, CONECTICUT	20068.00 BTJ GPF 205/2022 DETL-7A E TS C, C, C, D1 7
	PROJECT NO.: CTA22 DRAWN BY: CHECKED BY: DATE: 12 CAD I.D.: CTA220068.00-E PROJECT: PROJECT: PROPOSED SITUE FOR FOR PENNROSE, LLC PROPOSED DEVELOPMENT PARCEL 'B' MAPLE STREET, BOROUGH OF NAUGATUCH NEW HAVEN COUNTY, CONECTICUT BOBLESSAULE STREET, BOROUGH OF NAUGATUCH NEW HAVEN COUNTY, CONECTICUT	20068.00 BTJ GPF 205/2022 DETL-7A E TS C, C, C, D1 7
	PROJECT NO.: CTA22 DRAWN BY: CHECKED BY: DATE: 12 CAD I.D.: CTA220068.00-E PROJECT: PROJECT: PROPOSED SITUE FOR FOR PENNROSE, LLC PROPOSED DEVELOPMENT PARCEL 'B' MAPLE STREET, BOROUGH OF NAUGATUCH NEW HAVEN COUNTY, CONECTICUT BOBLESSAULE STREET, BOROUGH OF NAUGATUCH NEW HAVEN COUNTY, CONECTICUT	20068.00 BTJ GPF 205/2022 DETL-7A E TS C, C, C, D1 7
	PROJECT NO.: CTA22 DRAWN BY: CHECKED BY: DATE: 12. CAD ID: CTA220068.00-1 PROJECT: PROPOSED SITU FOR FOR PROPOSED SITU FOR PROPOSED DEVELOPMENT PARCEL 'B' MAPLE STREET, BOROUGH OF NAUGATUCK NEW HAVEN COUNTY, CONECTICUT BBOHLERMA BORDUGH OF NAUGATUCK NEW HAVEN COUNTY, CONECTICUT BBOHLERMA G5 LASALLE ROAD, SUITE 44 WEST HARTFORD, CT 0610 Phone: (860) 333-8900 WW.BohlerEngineering.c	20068.00 BTJ GPF 205/2022 DETL-7A E TS (, (, 01 7 om
	PROJECT NO.: CTA22 DRAWN BY: CHECKED BY: DATE: 12/ CAD I.D.: CTA220068.00-D PROJECT: PROPOSED SITU PROPOSED SITU PLAN DOCUMENT FOR PENNROSE, LLCC PROPOSED DEVELOPMENT PARCEL 'B' MAPLE STREET, BOROUGH OF NAUGATUCH NEW HAVEN COUNTY, CONECTICUT BBCHLEROAD, SUITE 44 WEST HARTFORD, CT 0610 Phone: (860) 333-8900 WWW.BohlerEngineering.c	20068.00 BTJ GPF 205/2022 DETL-7A E TS (, (, 01 7 om
	PROJECT NO.: CTA22 DRAWN BY: CHECKED BY: DATE: 12. CAD ID: CTA220068.00-1 PROJECT: PROPOSED SITU FOR FOR PROPOSED SITU FOR PROPOSED DEVELOPMENT PARCEL 'B' MAPLE STREET, BOROUGH OF NAUGATUCK NEW HAVEN COUNTY, CONECTICUT BBOHLERMA BORDUGH OF NAUGATUCK NEW HAVEN COUNTY, CONECTICUT BBOHLERMA G5 LASALLE ROAD, SUITE 44 WEST HARTFORD, CT 0610 Phone: (860) 333-8900 WW.BohlerEngineering.c	20068.00 BTJ GPF 205/2022 DETL-7A E TS (, (, 01 7 om
	PROJECT No.: CTA22 DRAWN BY: CHECKED BY: DATE: 12 CAD I.D.: CTA220068.00-E PROJECT: PROPOSED SITU PROPOSED SITU PROPOSED SITU PLAN DOCUMENT FOR POROPOSED DEVELOPMENT PARCEL 'B' MAPLE STREET, BOROUGH OF NAUGATUCK NEW HAVEN COUNTY, CONECTICUT BBOHLERRA 65 LASALLE ROAD, SUITE 44 WEST HARTFORD, CT 0610 Phone: (860) 333-8900 WWW.BohlerEngineering.ct G.P. FOR SHEET TITLE: UTTILITY DETTA	20068.00 BTJ GPF 205/2022 DETL-7A E TS (, (, 01 7 om
	PROJECT No.: CTA22 DRAWN BY: CHECKED BY: DATE: 12 CAD I.D.: CTA220068.00-E PROJECT: PROPOSED SITU PROPOSED SITU PROPOSED SITU PLAN DOCUMENT FOR POROPOSED DEVELOPMENT PARCEL 'B' MAPLE STREET, BOROUGH OF NAUGATUCK NEW HAVEN COUNTY, CONECTICUT BBOHLERRA 65 LASALLE ROAD, SUITE 44 WEST HARTFORD, CT 0610 Phone: (860) 333-8900 WWW.BohlerEngineering.ct G.P. FOR SHEET TITLE: UTTILITY DETTA	20068.00 BTJ GPF 205/2022 DETL-7A E TS (, (, 01 7 om
	PROJECT No.: CTA22 DRAWN BY: CHECKED BY: DATE: 12/ CAD I.D.: CTA220068.00-D PROJECT: PROJECT: PROPOSED SITU PROPOSED SITU PLAN DOCUMENT FOR PENNROSE, LLC PROPOSED DEVELOPMENT PARCEL 'B' MAPLE STREET, BOROUGH OF NAUGATUCK NEW HAVEN COUNTY, CONECTICUT BOBHLER 65 LaSALLE ROAD, SUITE 44 WEST HARTFORD, CT 0610 Phone: (860) 333-8900 WWW.BOHIERENGINGER G.P. CONCENTION FOR SHEET TITLE: SHEET TITLE:	20068.00 BTJ GPF 205/2022 DETL-7A E TS (, (, 01 7 om
	PROJECT No.: CTA22 DRAWN BY: CHECKED BY: DATE: 12 CAD I.D.: CTA220068.00-D PROJECT: PROPOSED SITU PROPOSED SITU PROPOSED SITU POR POR PENNROSE, LLCO POR DEVELOPMENT PARCEL 'B' MAPLE STREET, BOROUGH OF NAUGATUCH NEW HAVEN COUNTY, CONECTICUT BBOHLEROAD, SUITE 44 WEST HARTFORD, CT 06100 Phone: (800) 333-8900 WWW.BohlerEngineering.co G.P. CONTACT 06100 Phone: (800) 333-8900 SHEET TITLE: UTILITY DETA	20068.00 BTJ GPF 205/2022 DETL-7A E TS (, (, 01 7 om
	PROJECT No.: CTA22 DRAWN BY: CHECKED BY: DATE: 12/ CAD I.D.: CTA220068.00-D PROJECT: PROJECT: PROPOSED SITU PROPOSED SITU PLAN DOCUMENT FOR PENNROSE, LLC PROPOSED DEVELOPMENT PARCEL 'B' MAPLE STREET, BOROUGH OF NAUGATUCK NEW HAVEN COUNTY, CONECTICUT BOBHLER 65 LaSALLE ROAD, SUITE 44 WEST HARTFORD, CT 0610 Phone: (860) 333-8900 WWW.BOHIERENGINGER G.P. CONCENTION FOR SHEET TITLE: SHEET TITLE:	20068.00 BTJ GPF 205/2022 DETL-7A E TS (, (, 01 7 om