ABBREVIATIONS UTILITY - COMMUNICATIONS AND ELECTRIC ELEC.MH ELECTRIC MANHOLE TELEPHONE/COMMUNICATIONS TEL.MH MANHOI F TRANS. TRANSFORMER UNITED ILLUMINATING SNET SOUTHERN NEW ENGLAND TELEPHONE CI&P CONNECTICUT LIGHT AND POWER UTILITY - GAS GAS GATE STEEL PIPE MATERIALS CAST IRON DUCTILE IRON HIGH PRESSURE LOW PRESSURE PLASTIC POLYVINYL CHLORIDE RCP REINFORCED CONCRETE PIPE CORRUGATED METAL PIPE CMP WRAPPED PIPE 600 PSI 600# <u>STRUCTURES</u> "C" CB CURBED CATCH BASIN "C-L" CB CURBLESS CATCH BASIN MANHOLE SANIT ARY SAN. STM. STORM TOP OF FRAME INVERT BOTTOM NOT AVAILABLE (ABAN.) ABANDONED COMPILED FROM EXISTING MAPPING

UNDERGROUND

DOCKET No. 272

LEGEND Edge Of Road Concrete Pavement Dirt Road Curb (Type As Labeled) Concrete Median Barrier Railroad Tracks Gas Main Water Main Underground Electric Telephone Duct Bank Underground Tele. Conduit Overhead Wires Retaining Wall Highway Line ______ Street Line Property Line Lot Line Of Common Ownership Town Line DUCT BANK Water/RR Crossing Demolition/Clearing

Easement Line

Stone Wall

Riprap &

Shrub 🎇

Transmission Tower

Hedge Row XXXXXXX

Tree Line

All Trees 🛣 ☆ 😜

Pedestrian Signal 🖾

Traffic Controller ⊠

Traffic Signal ⋖⊷

2-Post Sign ——

Utility Pole 🔷

Billboard ⊢——

General Purpose Lamp 💢

Type "C-L" Catch Basin 🔲

Type "C" Catch Basin 🔲

Guy Wire ———

Guy Pole ===

Water Meter ⊠

Hvdrant -∳-

Manhole 🔘

Benchmark •

Marsh ₩

Wetlands Boundary -

Control Point 🛕

Monuments 🔲 🕒

Pin, Pipe, Drillhole •

Utility Pole With Light lacktriangle

Sign □ ○

Mast Arm

Hand Hole 🖂

Span Pole 🖂

GENERAL NOTES

- 1. THE UTILITIES AND NATURAL FEATURES SHOWN HEREON ARE BASED ON FIELD SURVEYS, AERIAL PHOTOGRAPHY AND RECORD DOCUMENTS. OTHER FACILITIES MAY EXIST NOT DISCOVERED THROUGH THE RECORD CHECK. THE CONTRACTOR SHALL VERIFY THE EXACT LOCATION, BOTH HORIZONTAL AND VERTICAL, OF ALL UTILITIES THROUGH THE APPROPRIATE UTILITY COMPANIES. CALL BEFORE YOU DIG.
- 2. ALL VERTICAL RADII ARE 200' UNLESS OTHERWISE NOTED.
- 3. DUCT BANK SHALL MAINTAIN MINIMUM COVER DEPTH OF 2'-6" UNLESS OTHERWISE SHOWN ON DRAWINGS. MAINTAIN 1'-0" VERTICAL CLEARANCE OVER OR UNDER EXISTING UTILITIES UNLESS OTHERWISE SHOWN ON DRAWINGS.
- 4. ALL AREAS DISTURBED BY CONSTRUCTION SHALL BE RETURNED TO THE ORIGINAL CONDITIONS AS DETERMINED BY NORTHEAST UTILITIES.
- 5. COORDINATES AND STATIONING INDICATED ARE AT CENTERLINE OF DUCT BANK.
- 6. SEE DRAWINGS 01149-45003 PG 001, 01149-45003 PG 002, 01149-71003 PG 001 THROUGH 01149-71003 PG 003, 01149-15003 PG 001, AND 01149-15003 PG 002 FOR CONSTRUCTION DETAILS AND EROSION CONTROL DETAILS.
- 7. TREES AND SHRUBS TO BE REMOVED AND REPLACED WITH SIMILAR TYPES AND SIZES TYPICAL OF GENERAL CONSUMER NURSERY STOCK, PROVIDED THAT NO REPLACEMENT TREE SHALL EXCEED TWELVE (12) FEET IN HEIGHT, NOR SHALL ANY REPLACEMENT SHRUB EXCEED A THREE (3) GALLON POT AND PROVIDED THAT NOTHING SHALL BE PLANTED WITHIN FIFTEEN (15) FEET OF AN INSTALLED VAULT OR WITHIN TEN (10) FEET OF AN INSTALLED CABLE DUCT BANK.
- 8. COORDINATES ARE BASED ON THE CONNECTICUT STATE PLANE COORDINATE SYSTEM. (NAD 83)
- 9. VERTICAL DATUM IS BASED ON NAVD 88.
- 10 SILT FENCE SHALL BE USED ALONG THE DOWN SLOPE SIDE OF THE CONSTRUCTION AREA WHERE THERE IS THE POTENTIAL FOR STORM WATER RUNOFF. THIS INCLUDES ANY PERVIOUS AREAS ALONG THE ROUTE. INLET PROTECTION SHALL BE USED IN ROADWAYS WHERE STORM DRAINS ARE PRESENT AND POTENTIAL FOR STORM WATER RUNOFF EXISTS.
- 11. TEMPORARY AND PERMANENT EASEMENTS WILL BE ACQUIRED FOR INSTALLATION OF THE DUCT BANK ALONG PRIVATE PROPERTY TO RISER STRUCTURES.
- 12. VAULT AND DUCT BANK LOCATIONS ARE SUBJECT TO ADJUSTMENT DUE TO UNFORESEEN CONDITIONS.



ONE CALL SYSTEMS

1-800-922-4455

CALL BEFORE YOU DIG......IT'S THE LAW!

48 HOUR NOTICE REQUIRED


FOR REFERENCE ONLY NOT FOR CONSTRUCTION


5	3/29/06	ISSUED TO CSC	СТС		
4	3/01/06	THIRD REVIEW NU	СТС		
3	2/07/06	ISSUED MUNICIPALITY REVIEW	СТС		d
2	1/18/06	ISSUED 60% PRELIMINARY	СТС		
1	1/11/06	ISSUED CIVIL RFP	СТС		d
no.	date	revisions	by	chk	


		Burr McD	ns & _ onnell
C		SINC	E 1898
C			
C		date	detailed
C		01/11/06	L. ROWSE
С		designed C. COURTRIGHT	checked S. NEWLAND
y	chk	C. COURTRIGHT	G. NEWLAND


									l NORTHE <i>l</i>	AST UTILIT	TES SERVI	CE CO.			
									FOD.						
									THE CONNECTICUT LIGHT & POWER COMPANY						
									TITLE MIDDLETOWN-NORWALK 345kV TRANSMISSION PROJECT						
									TOWN OF CHESHIRE GENERAL NOTES AND LEGEND						
_															
					1				BY SEN-BMCD (CHKD	APP	APP			
_					<u> </u>				DATE 2-5-05	DATE	DATE	DATE			
									SCALE AS NOTED	-	DWG. NO.				
	MF	NO.	DATE	REVISIONS	BY	СНК	APP	APP		D	01149-00001 PG 002				


PYRIGHT © 2005 BURNS & McDONNELL ENGINEERING COMPANY, INC.

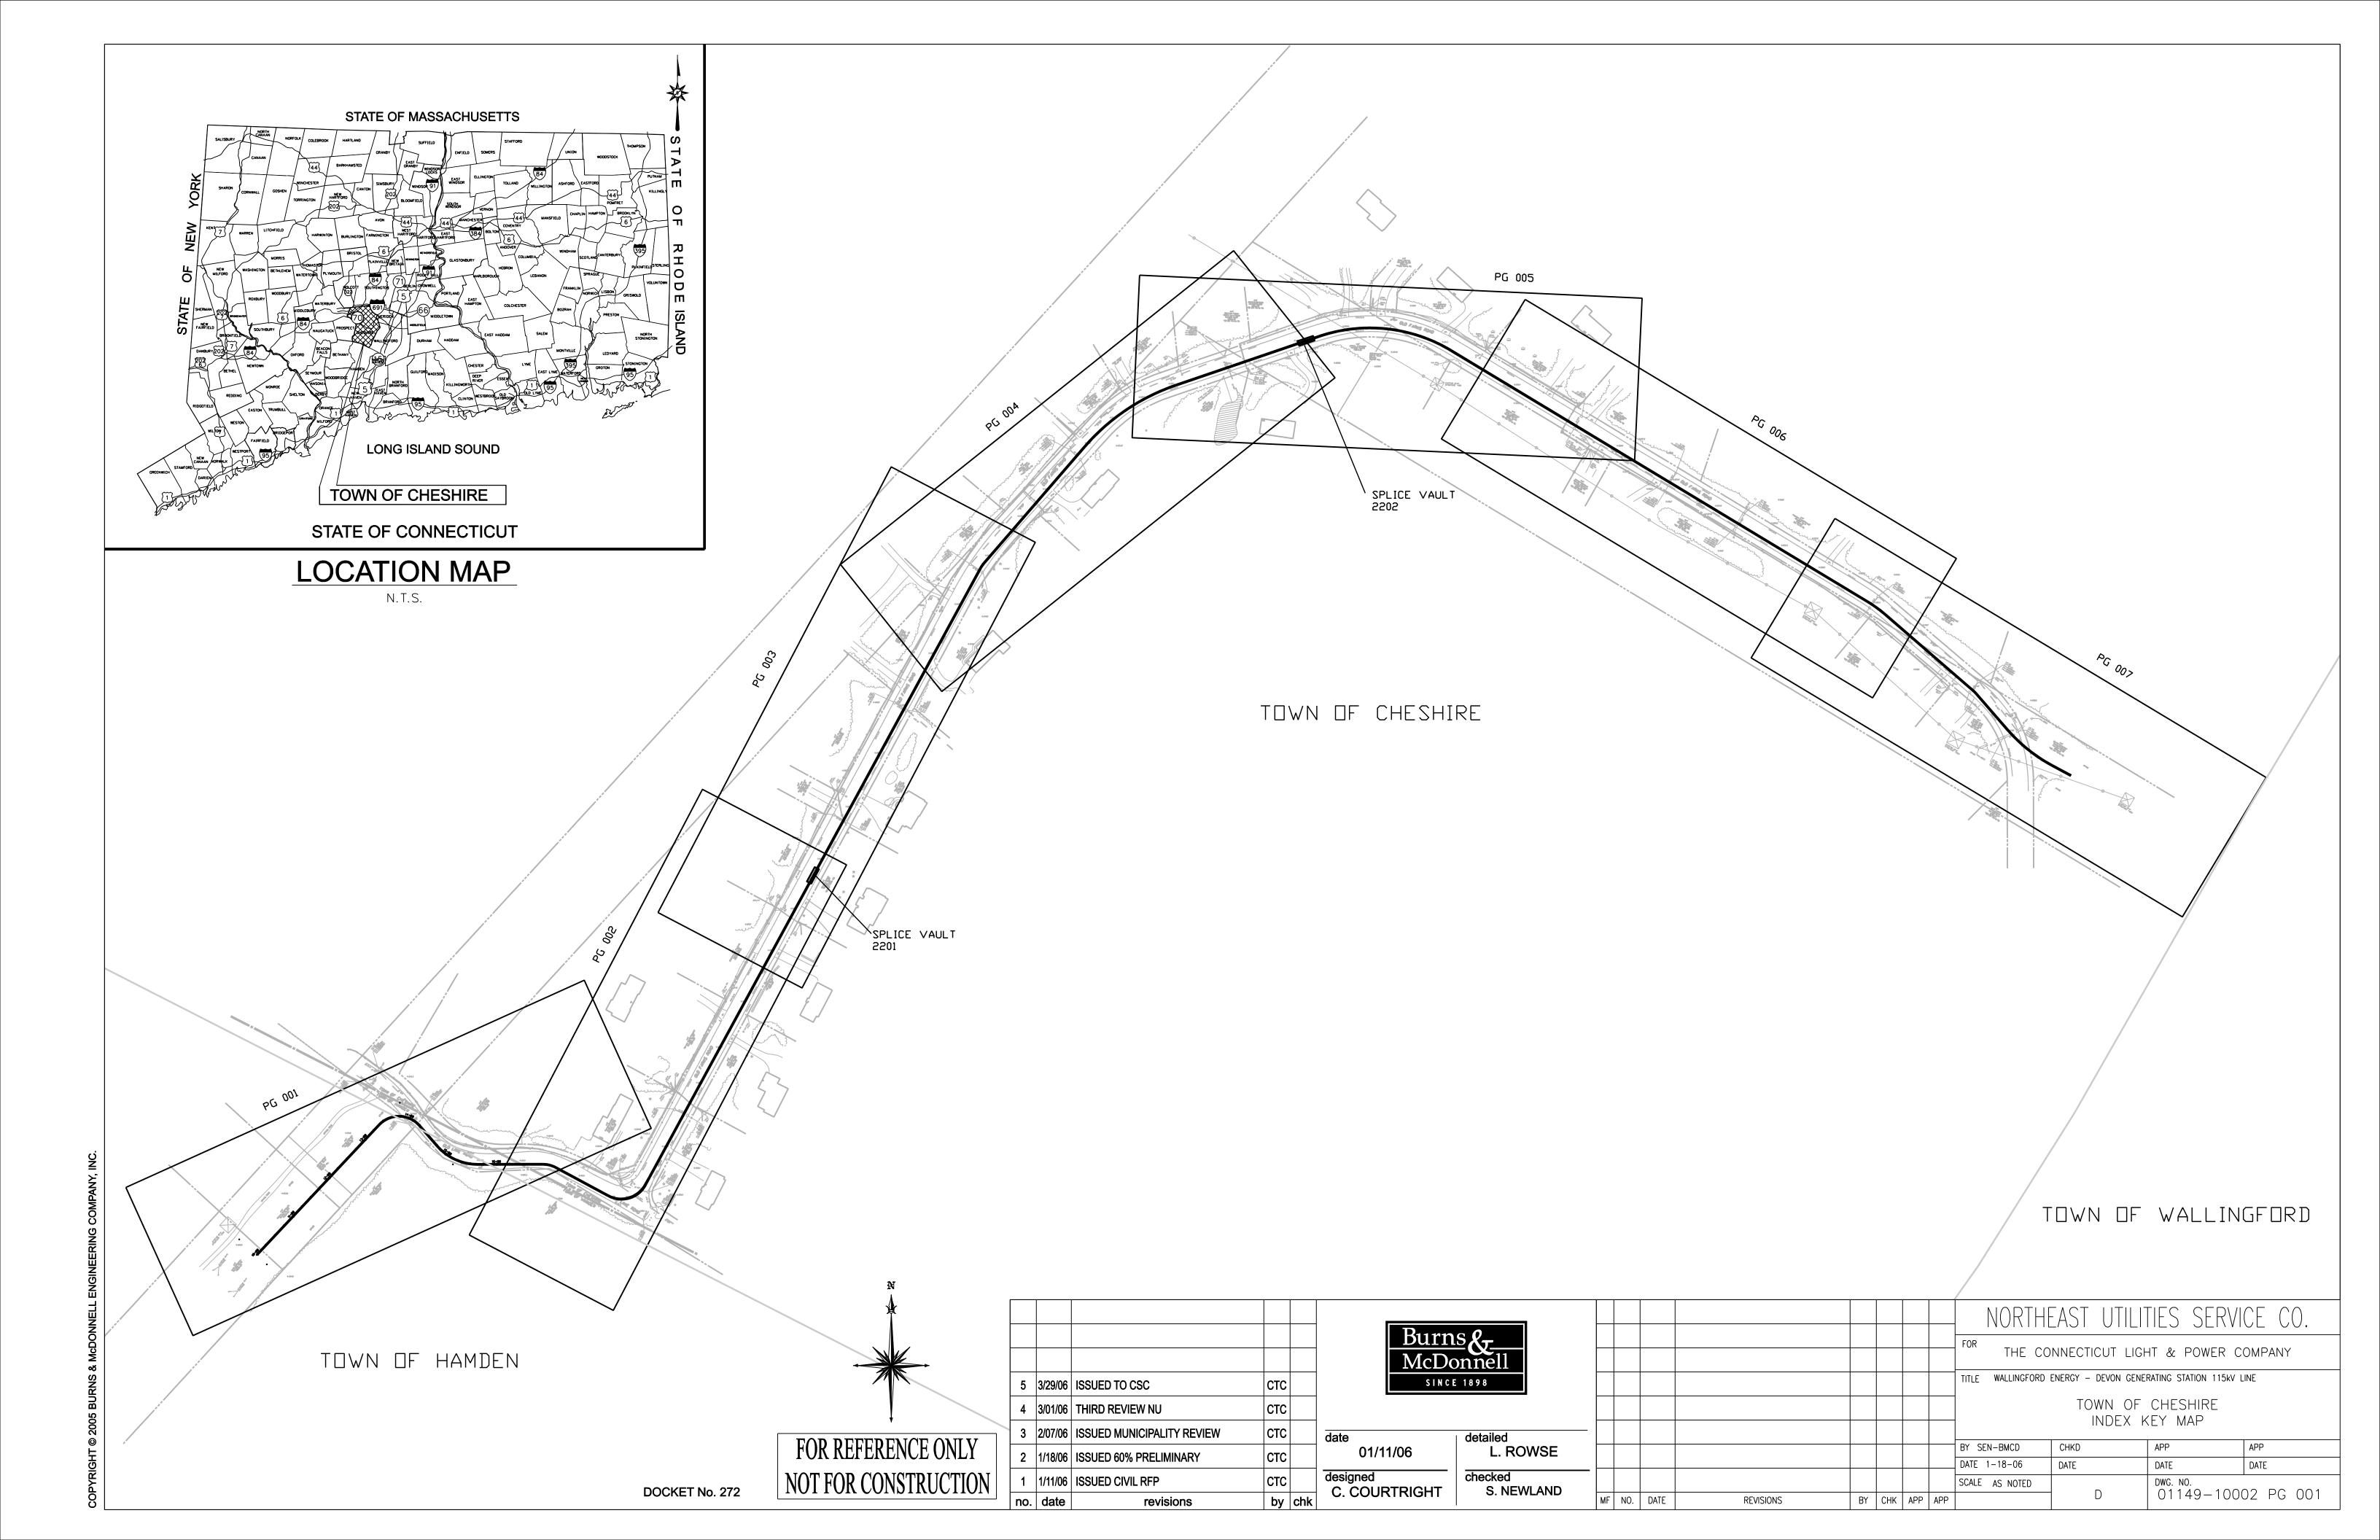


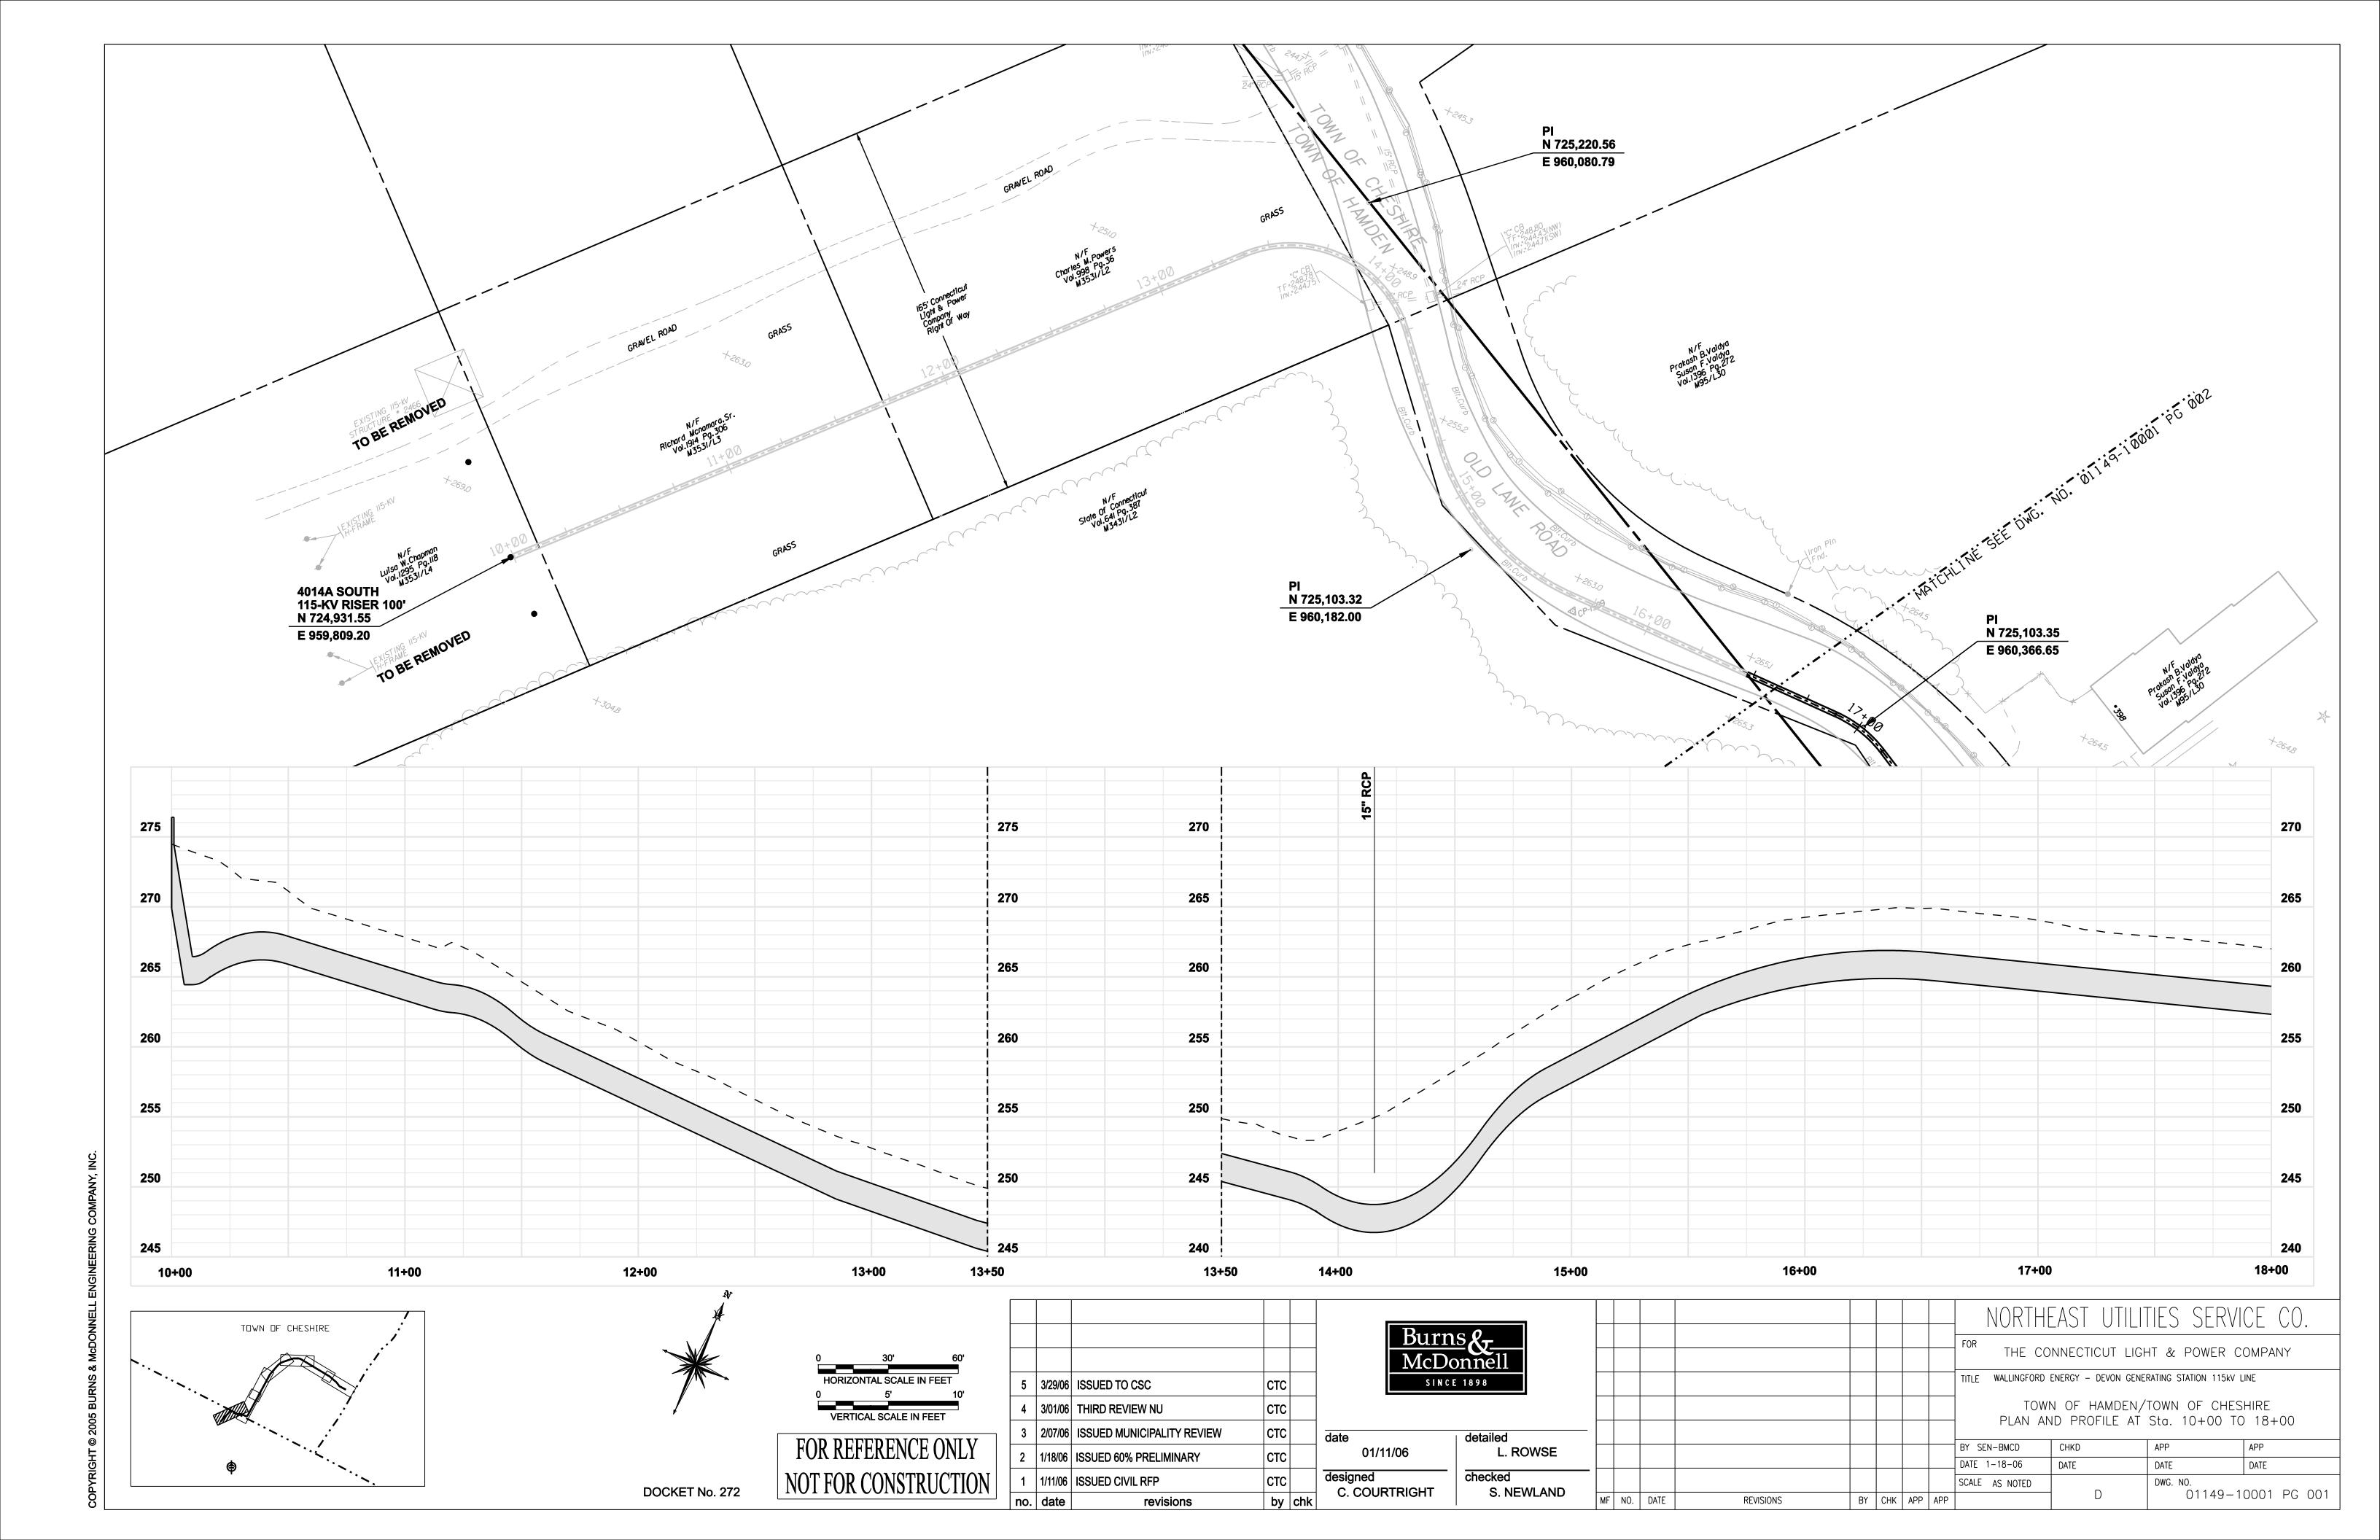


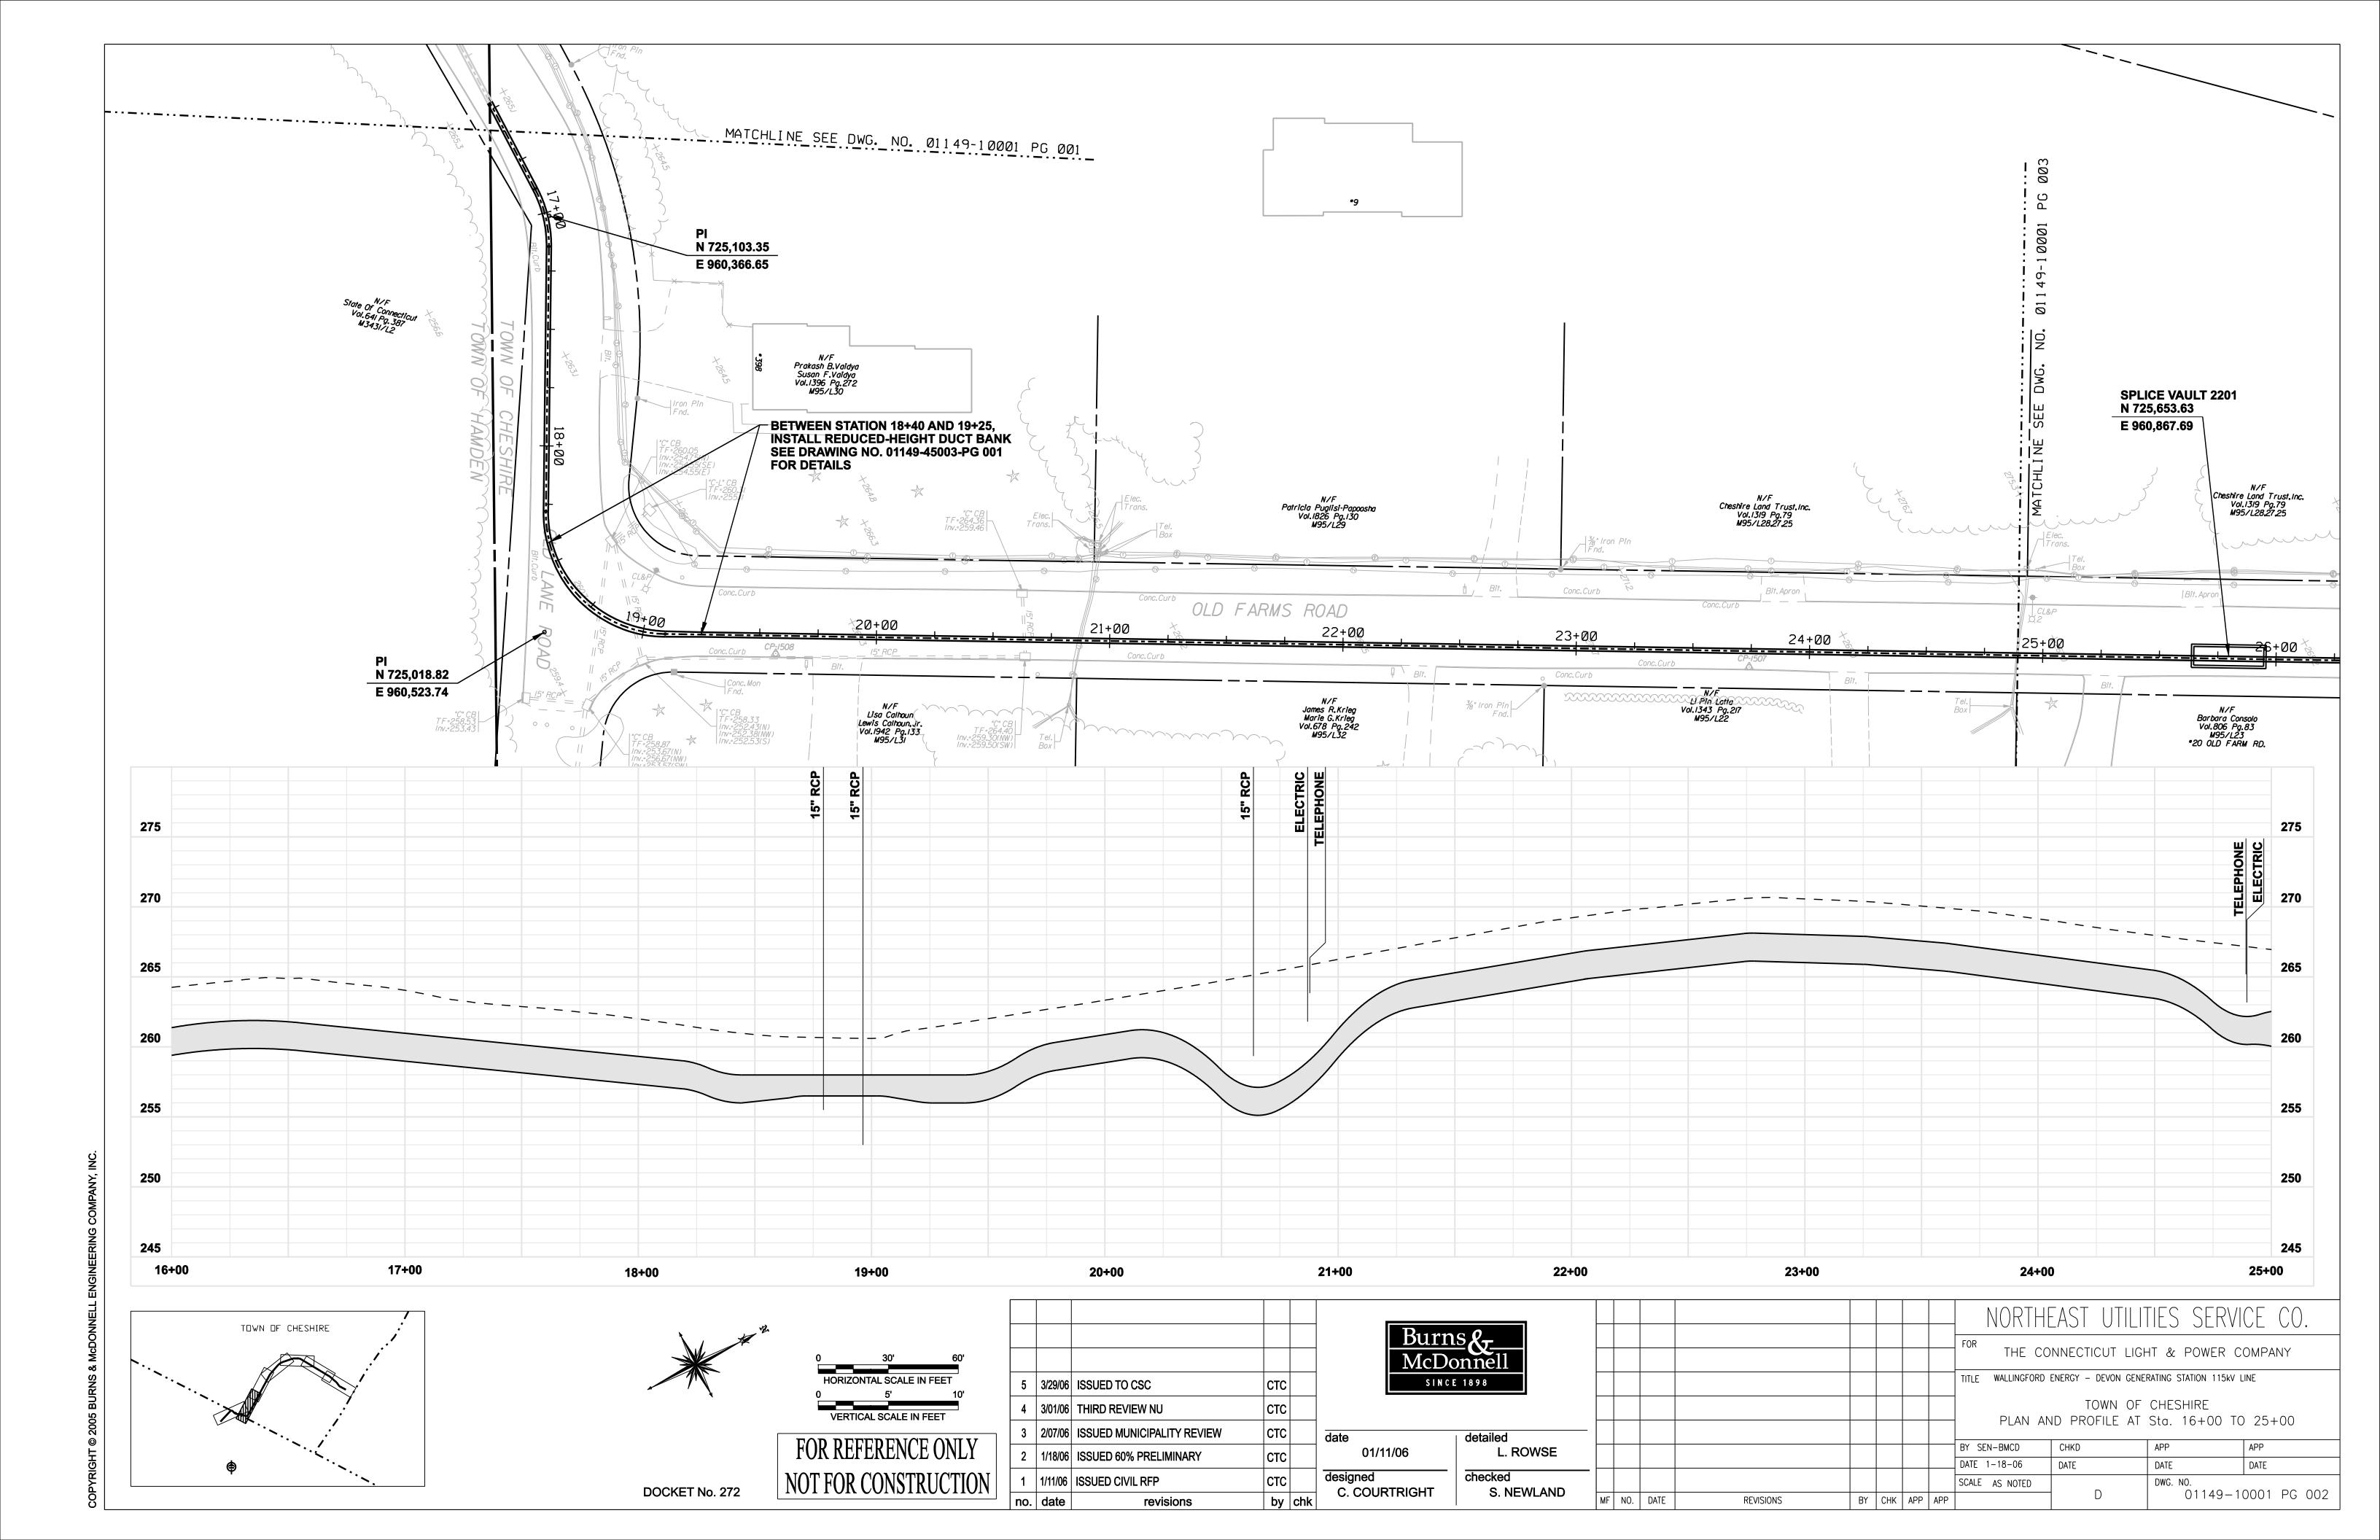


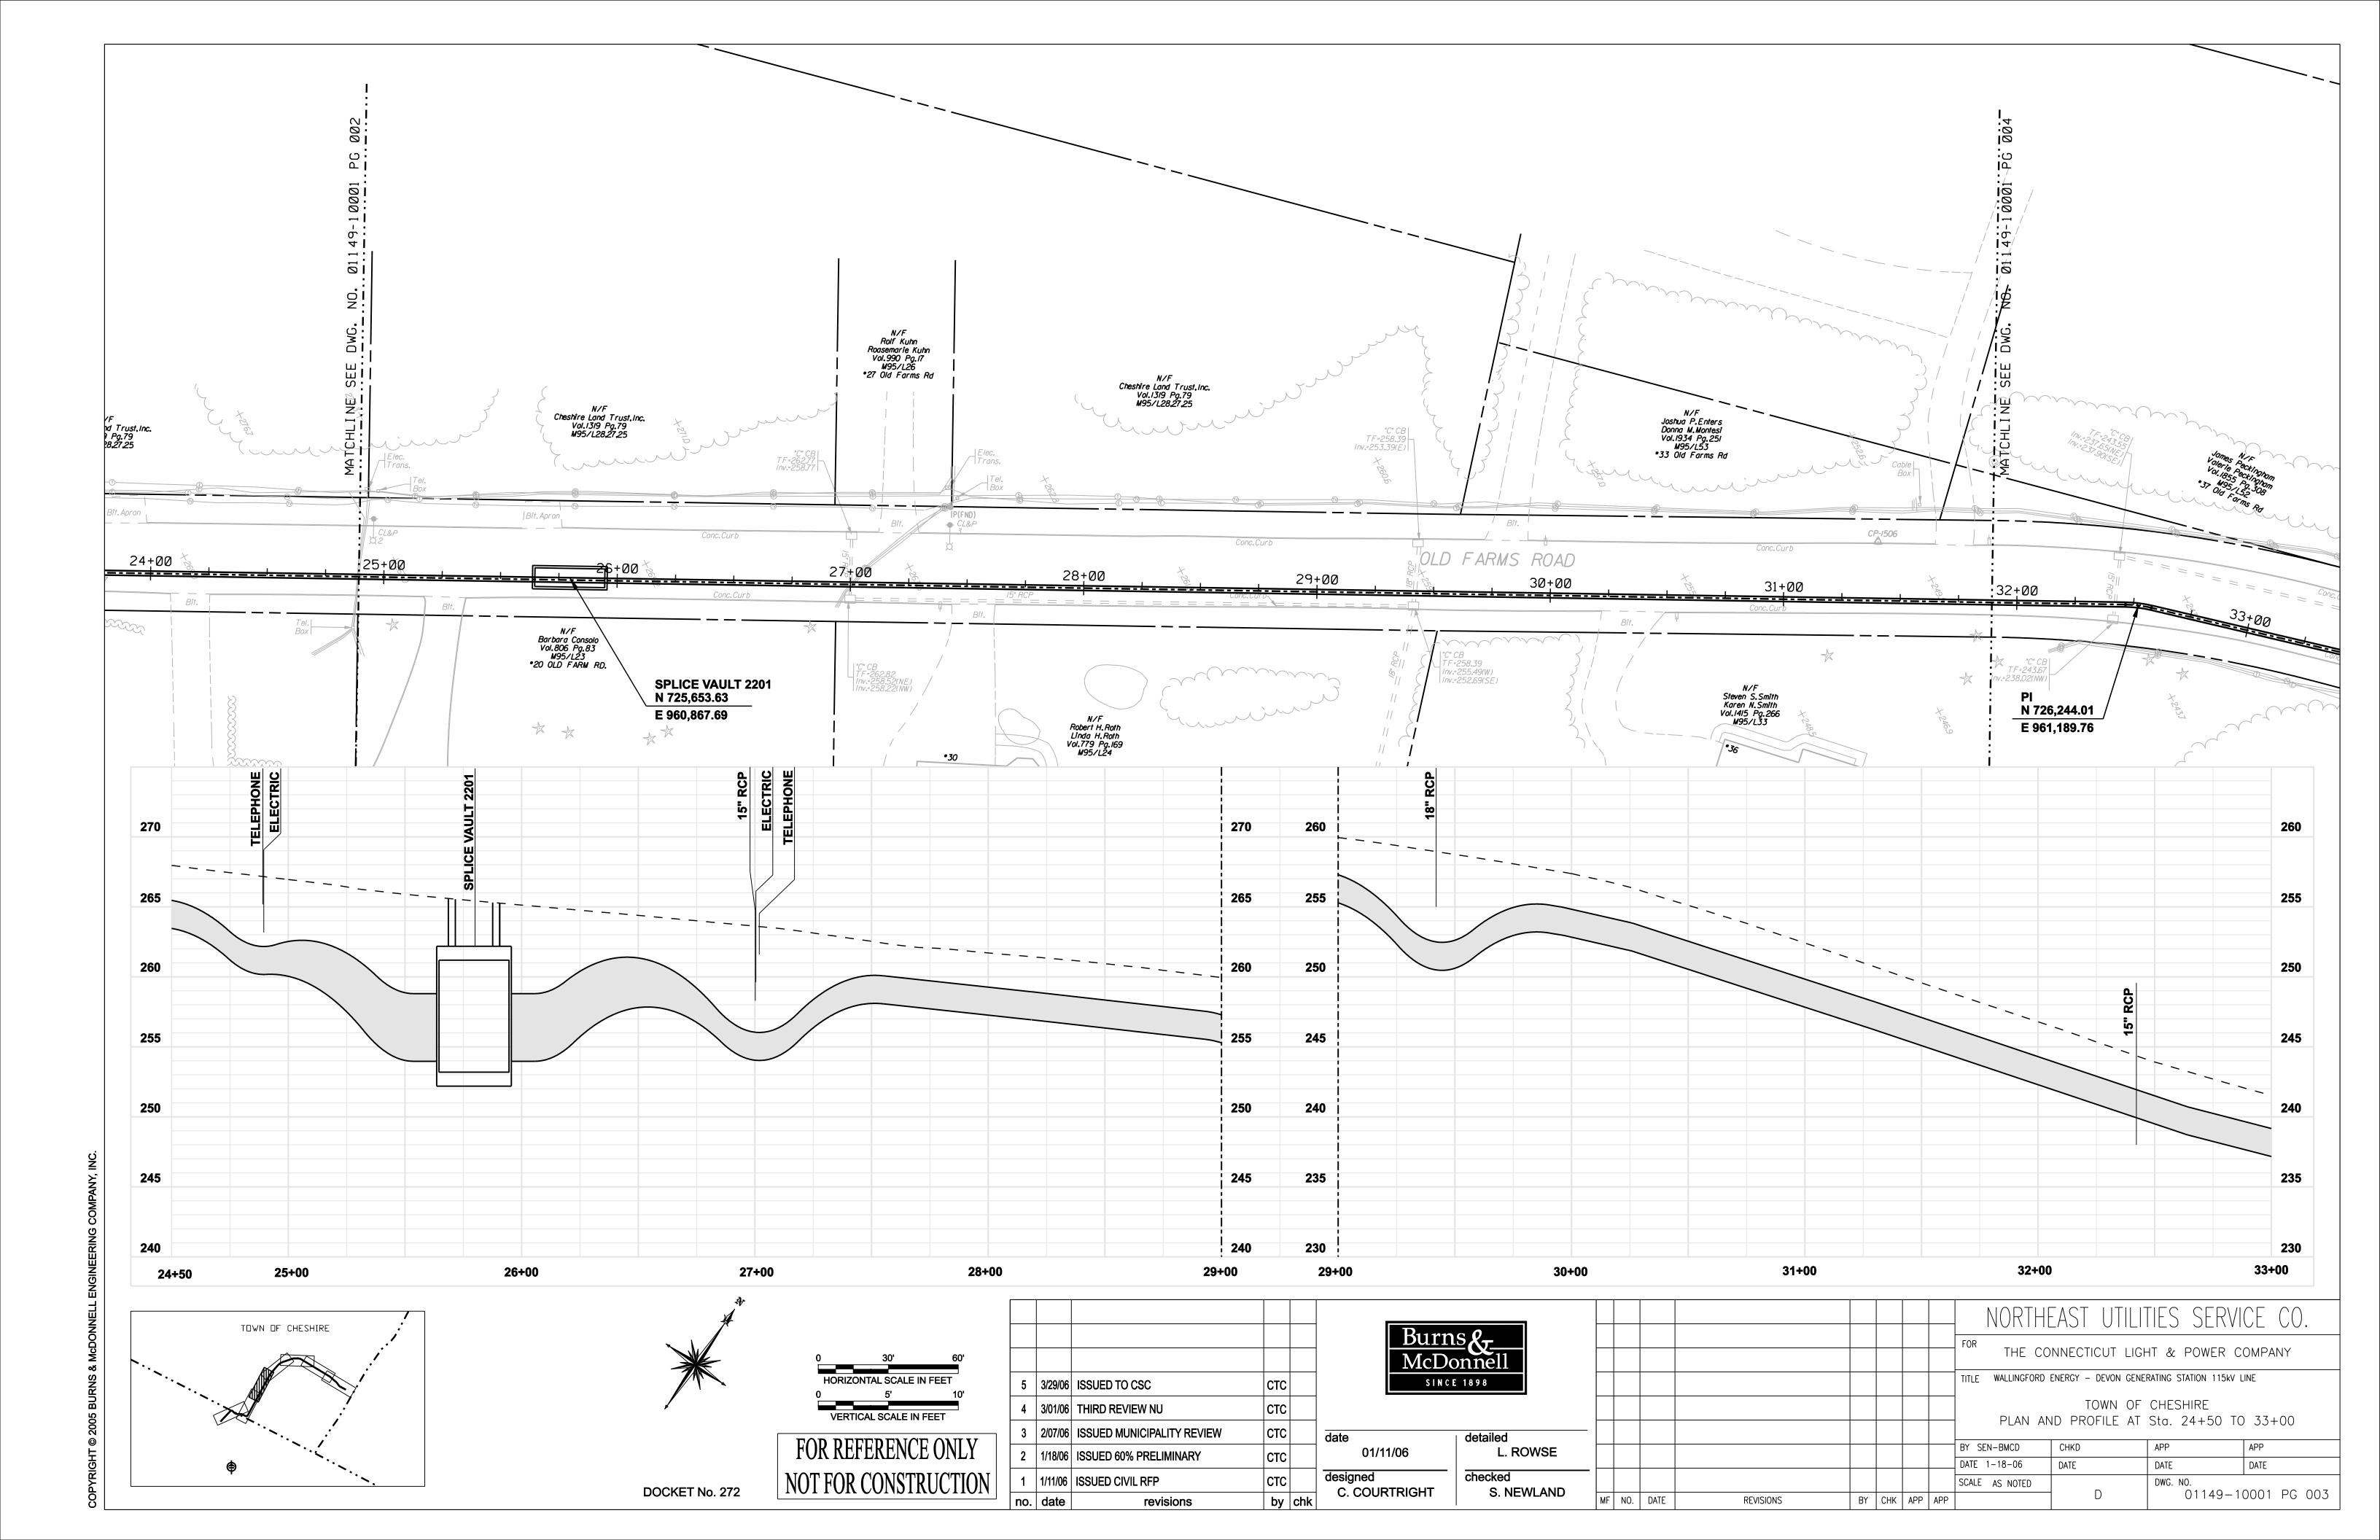


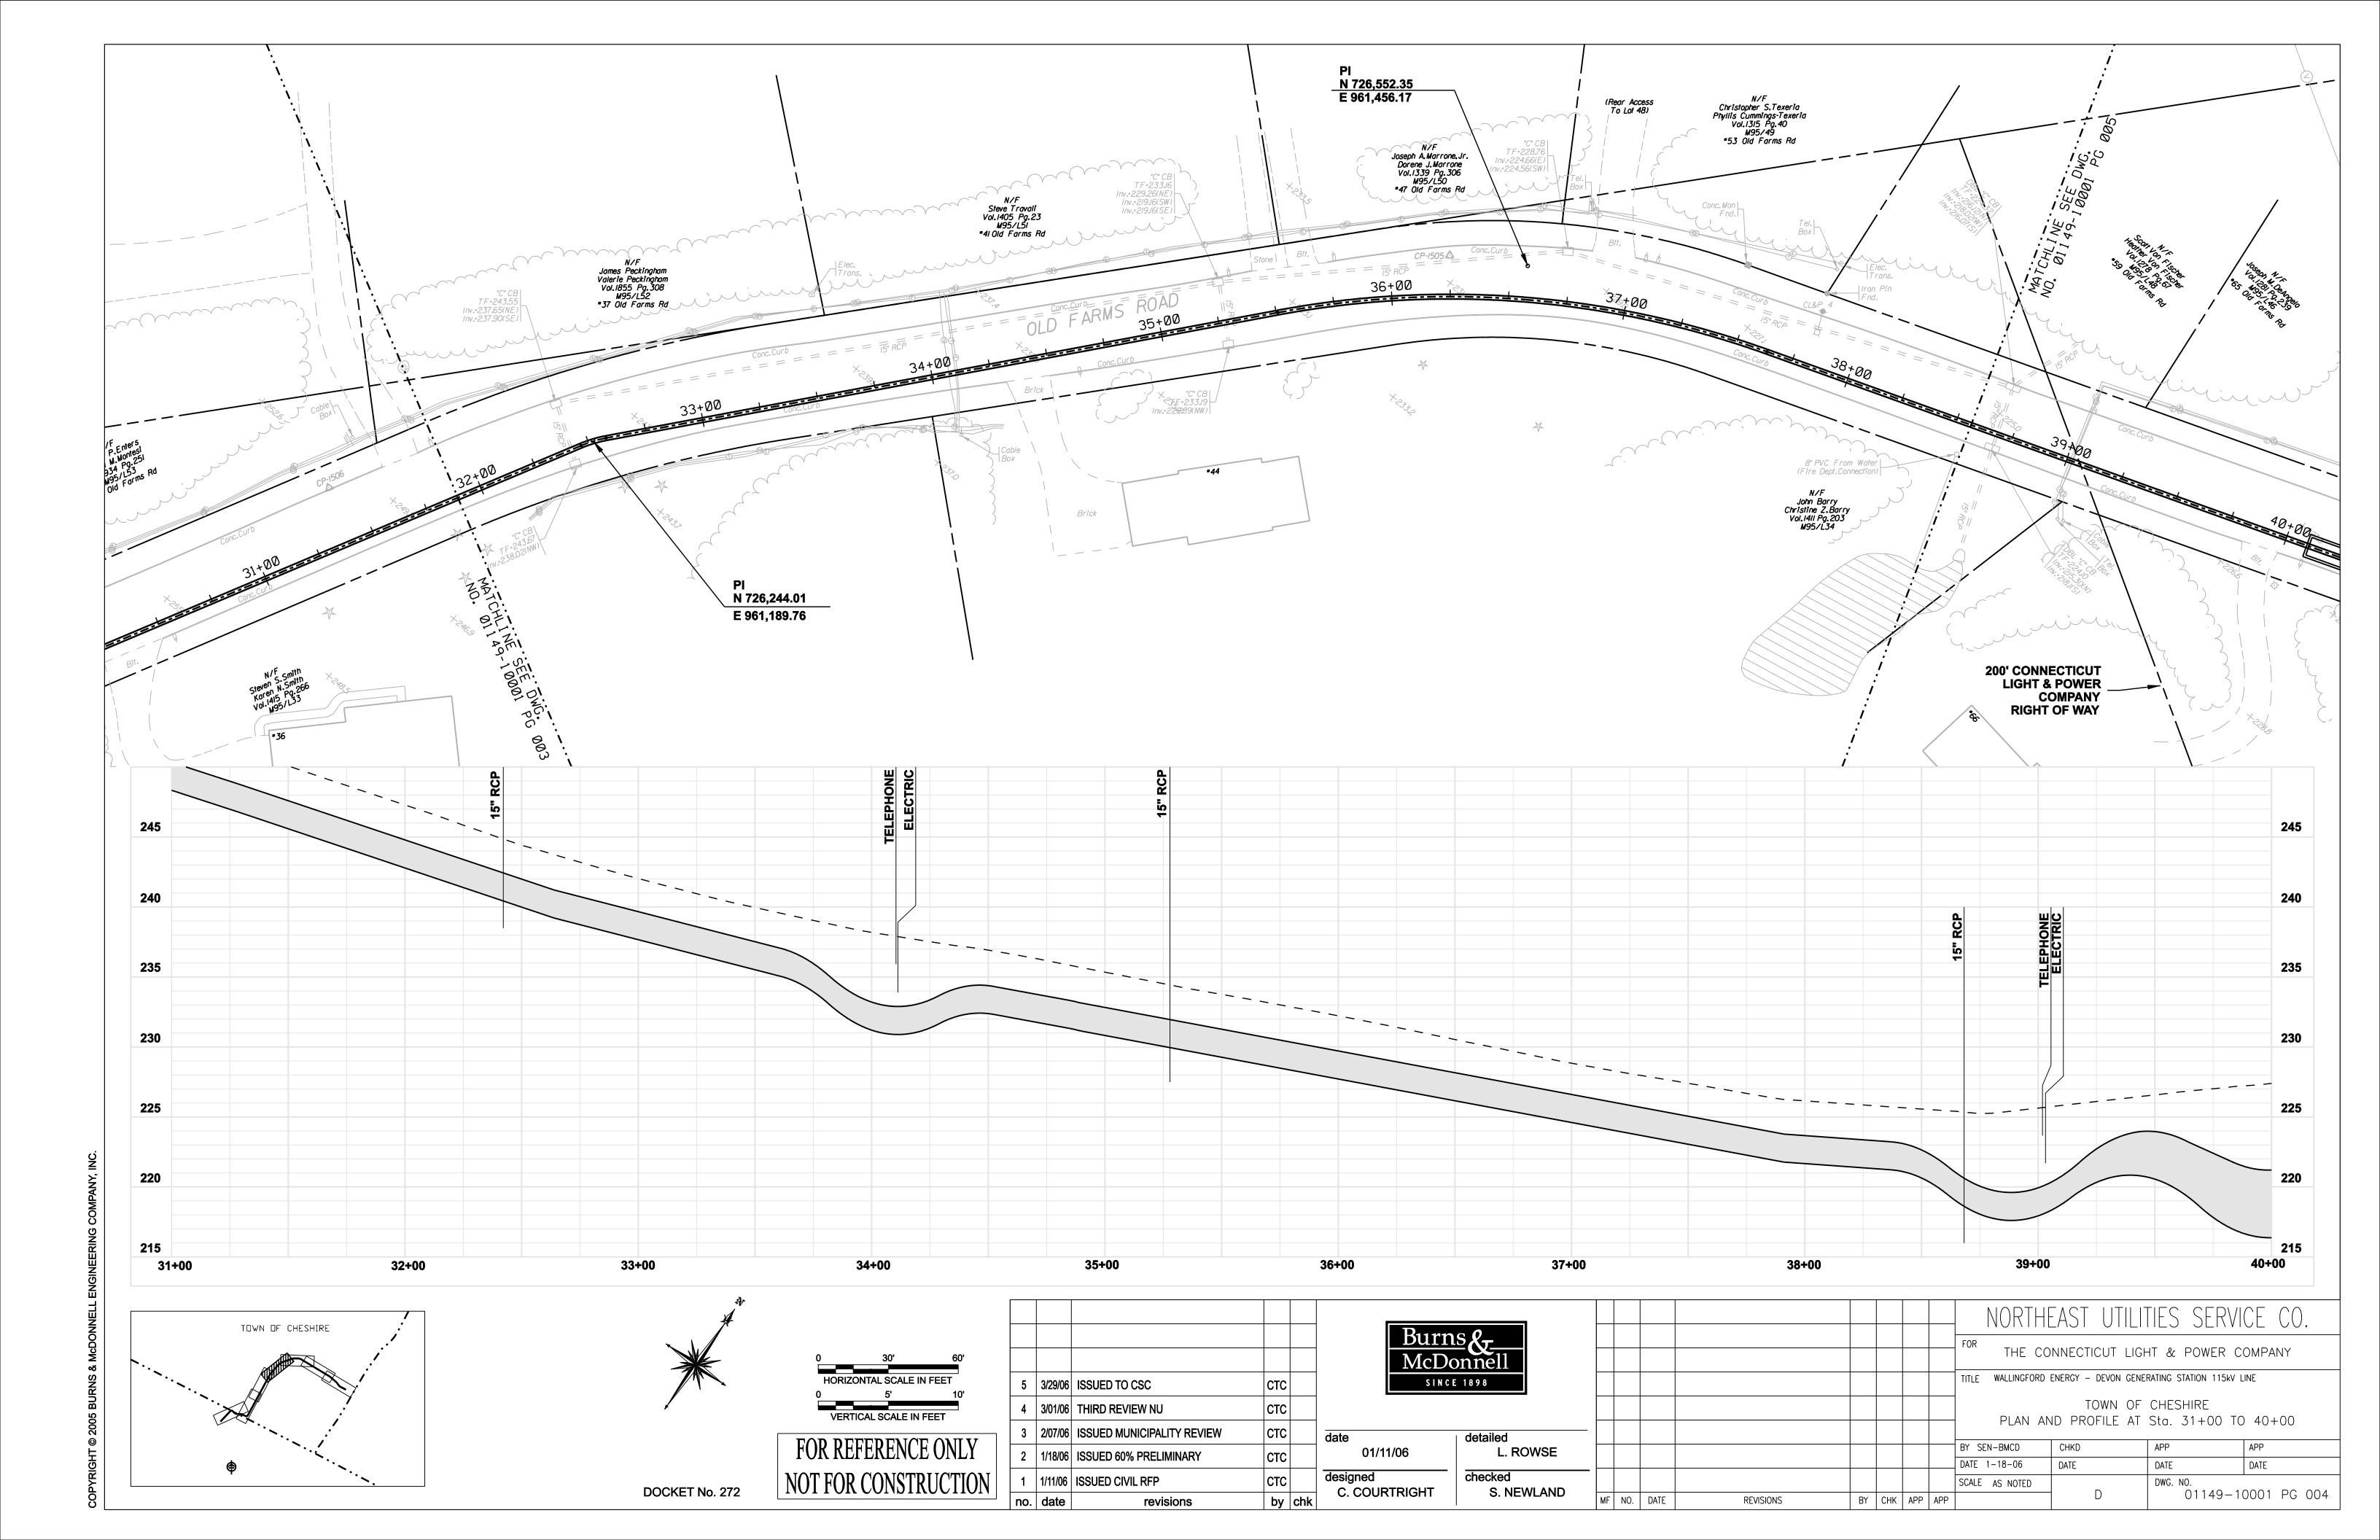


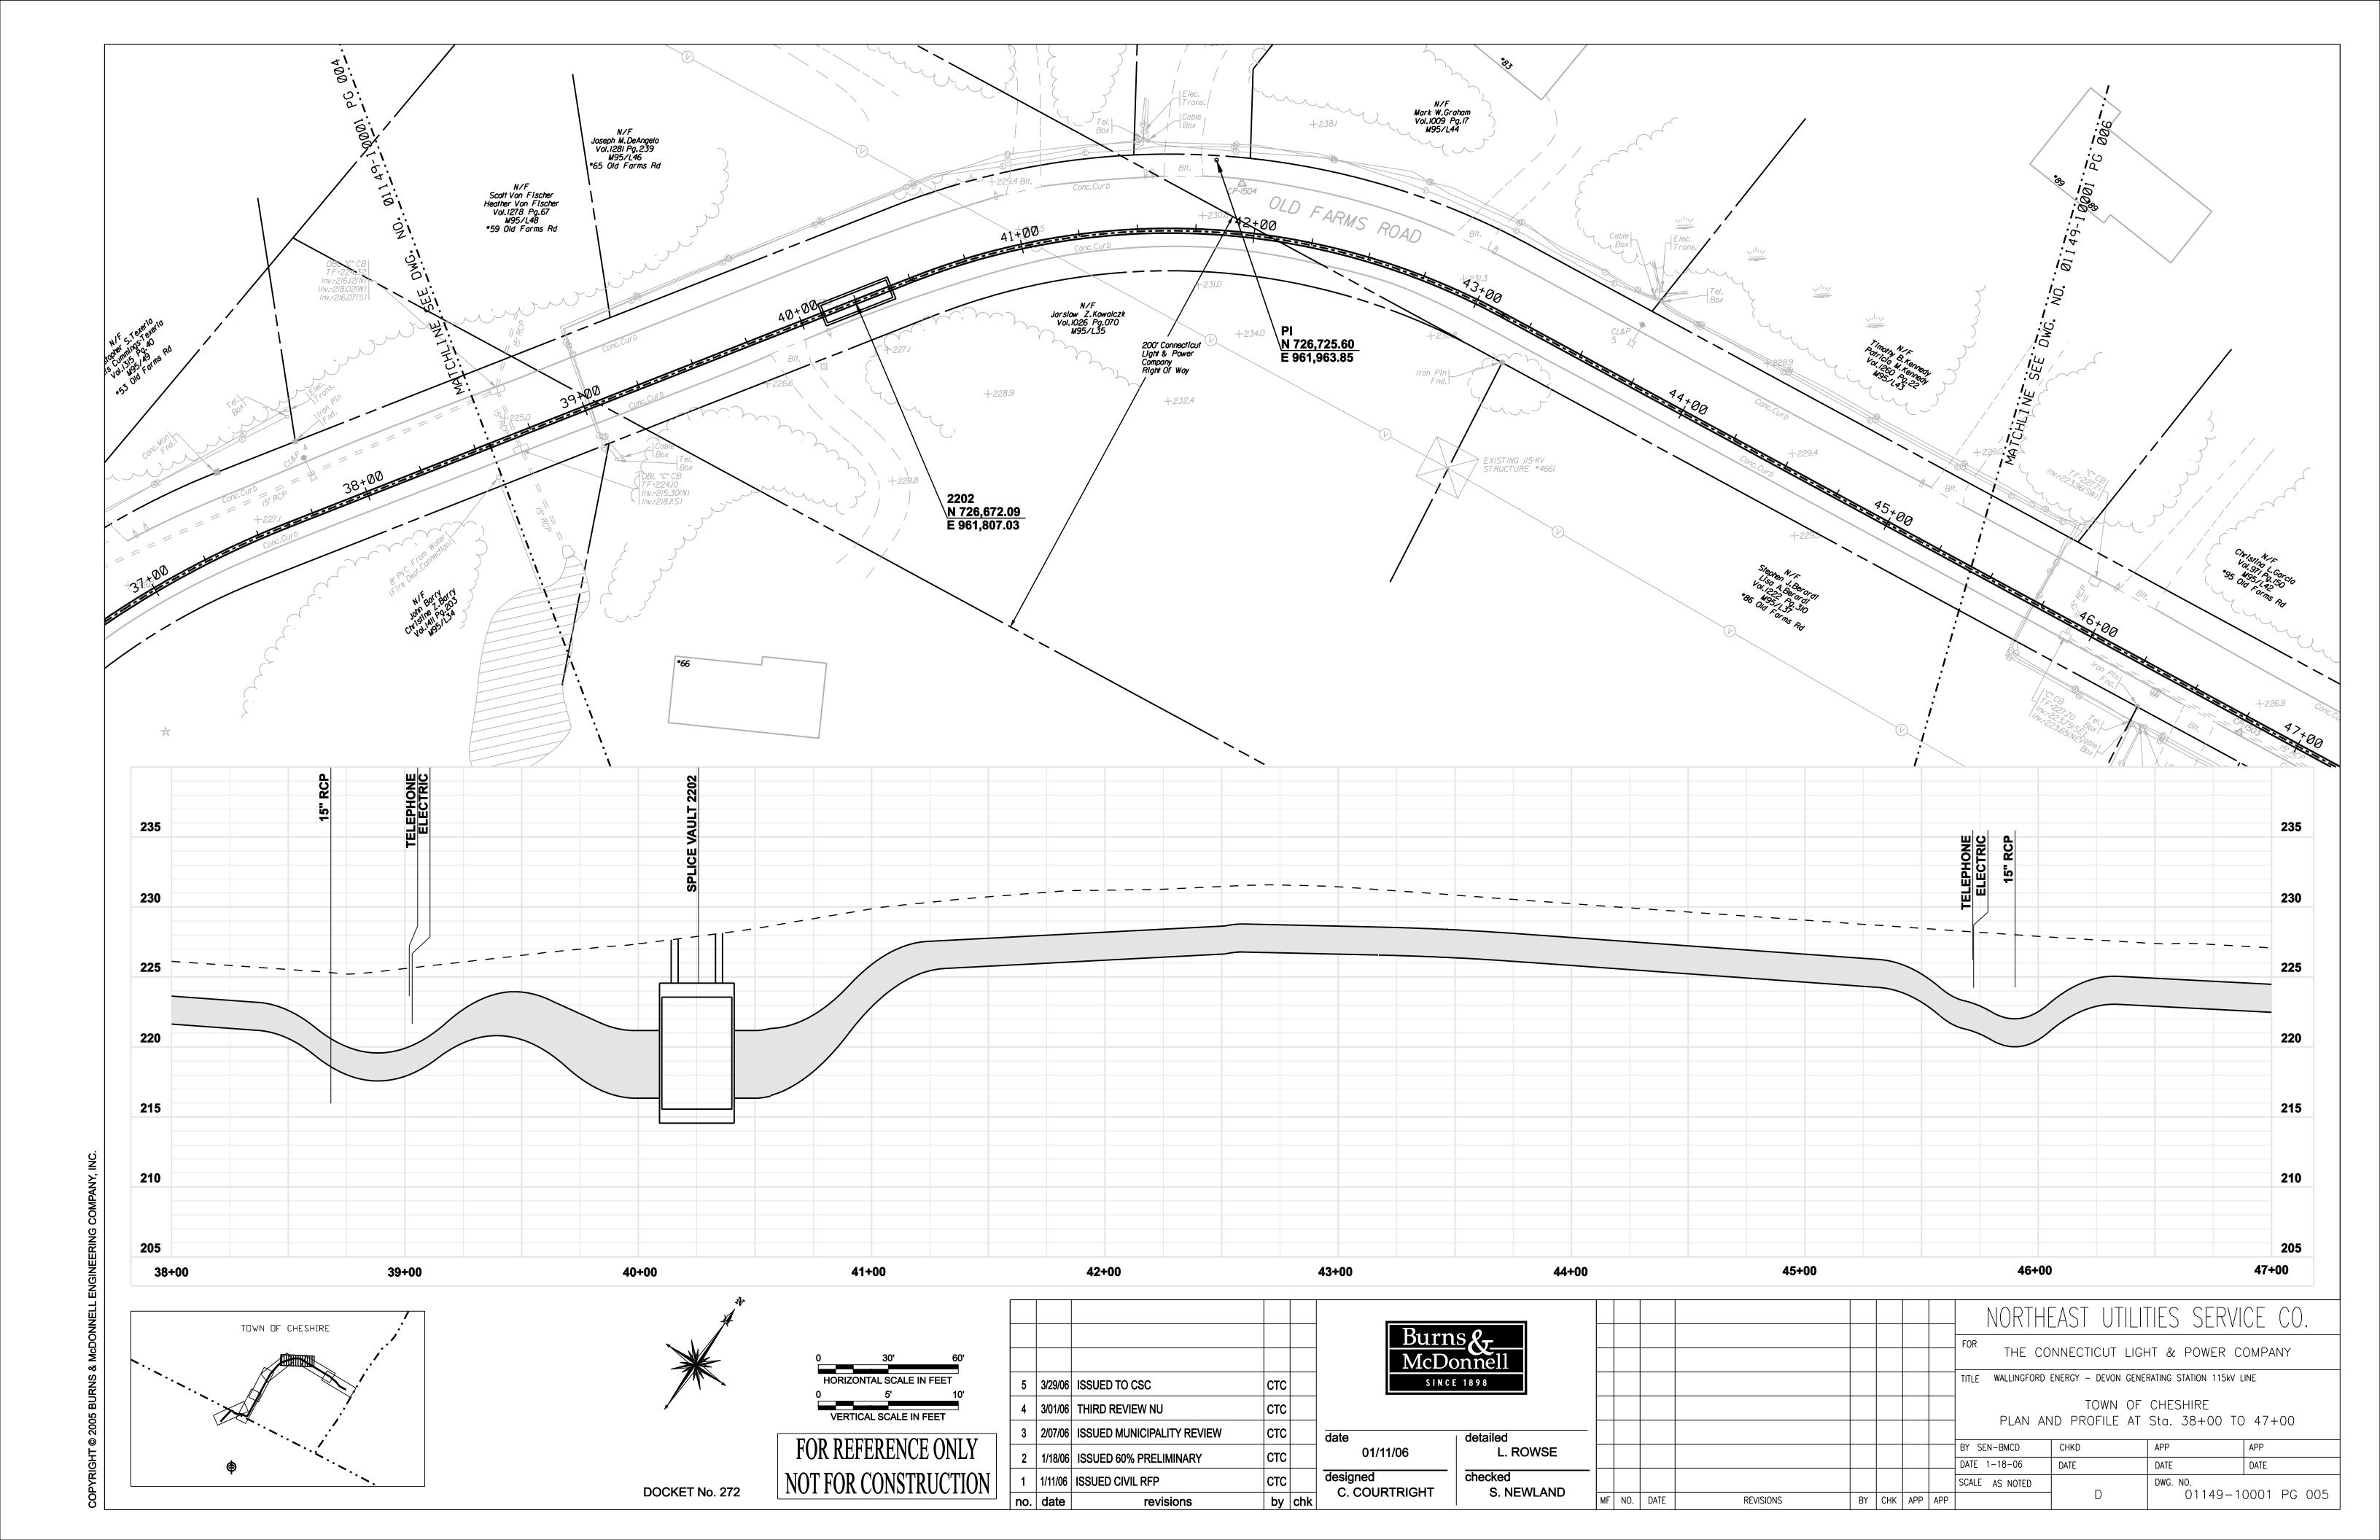

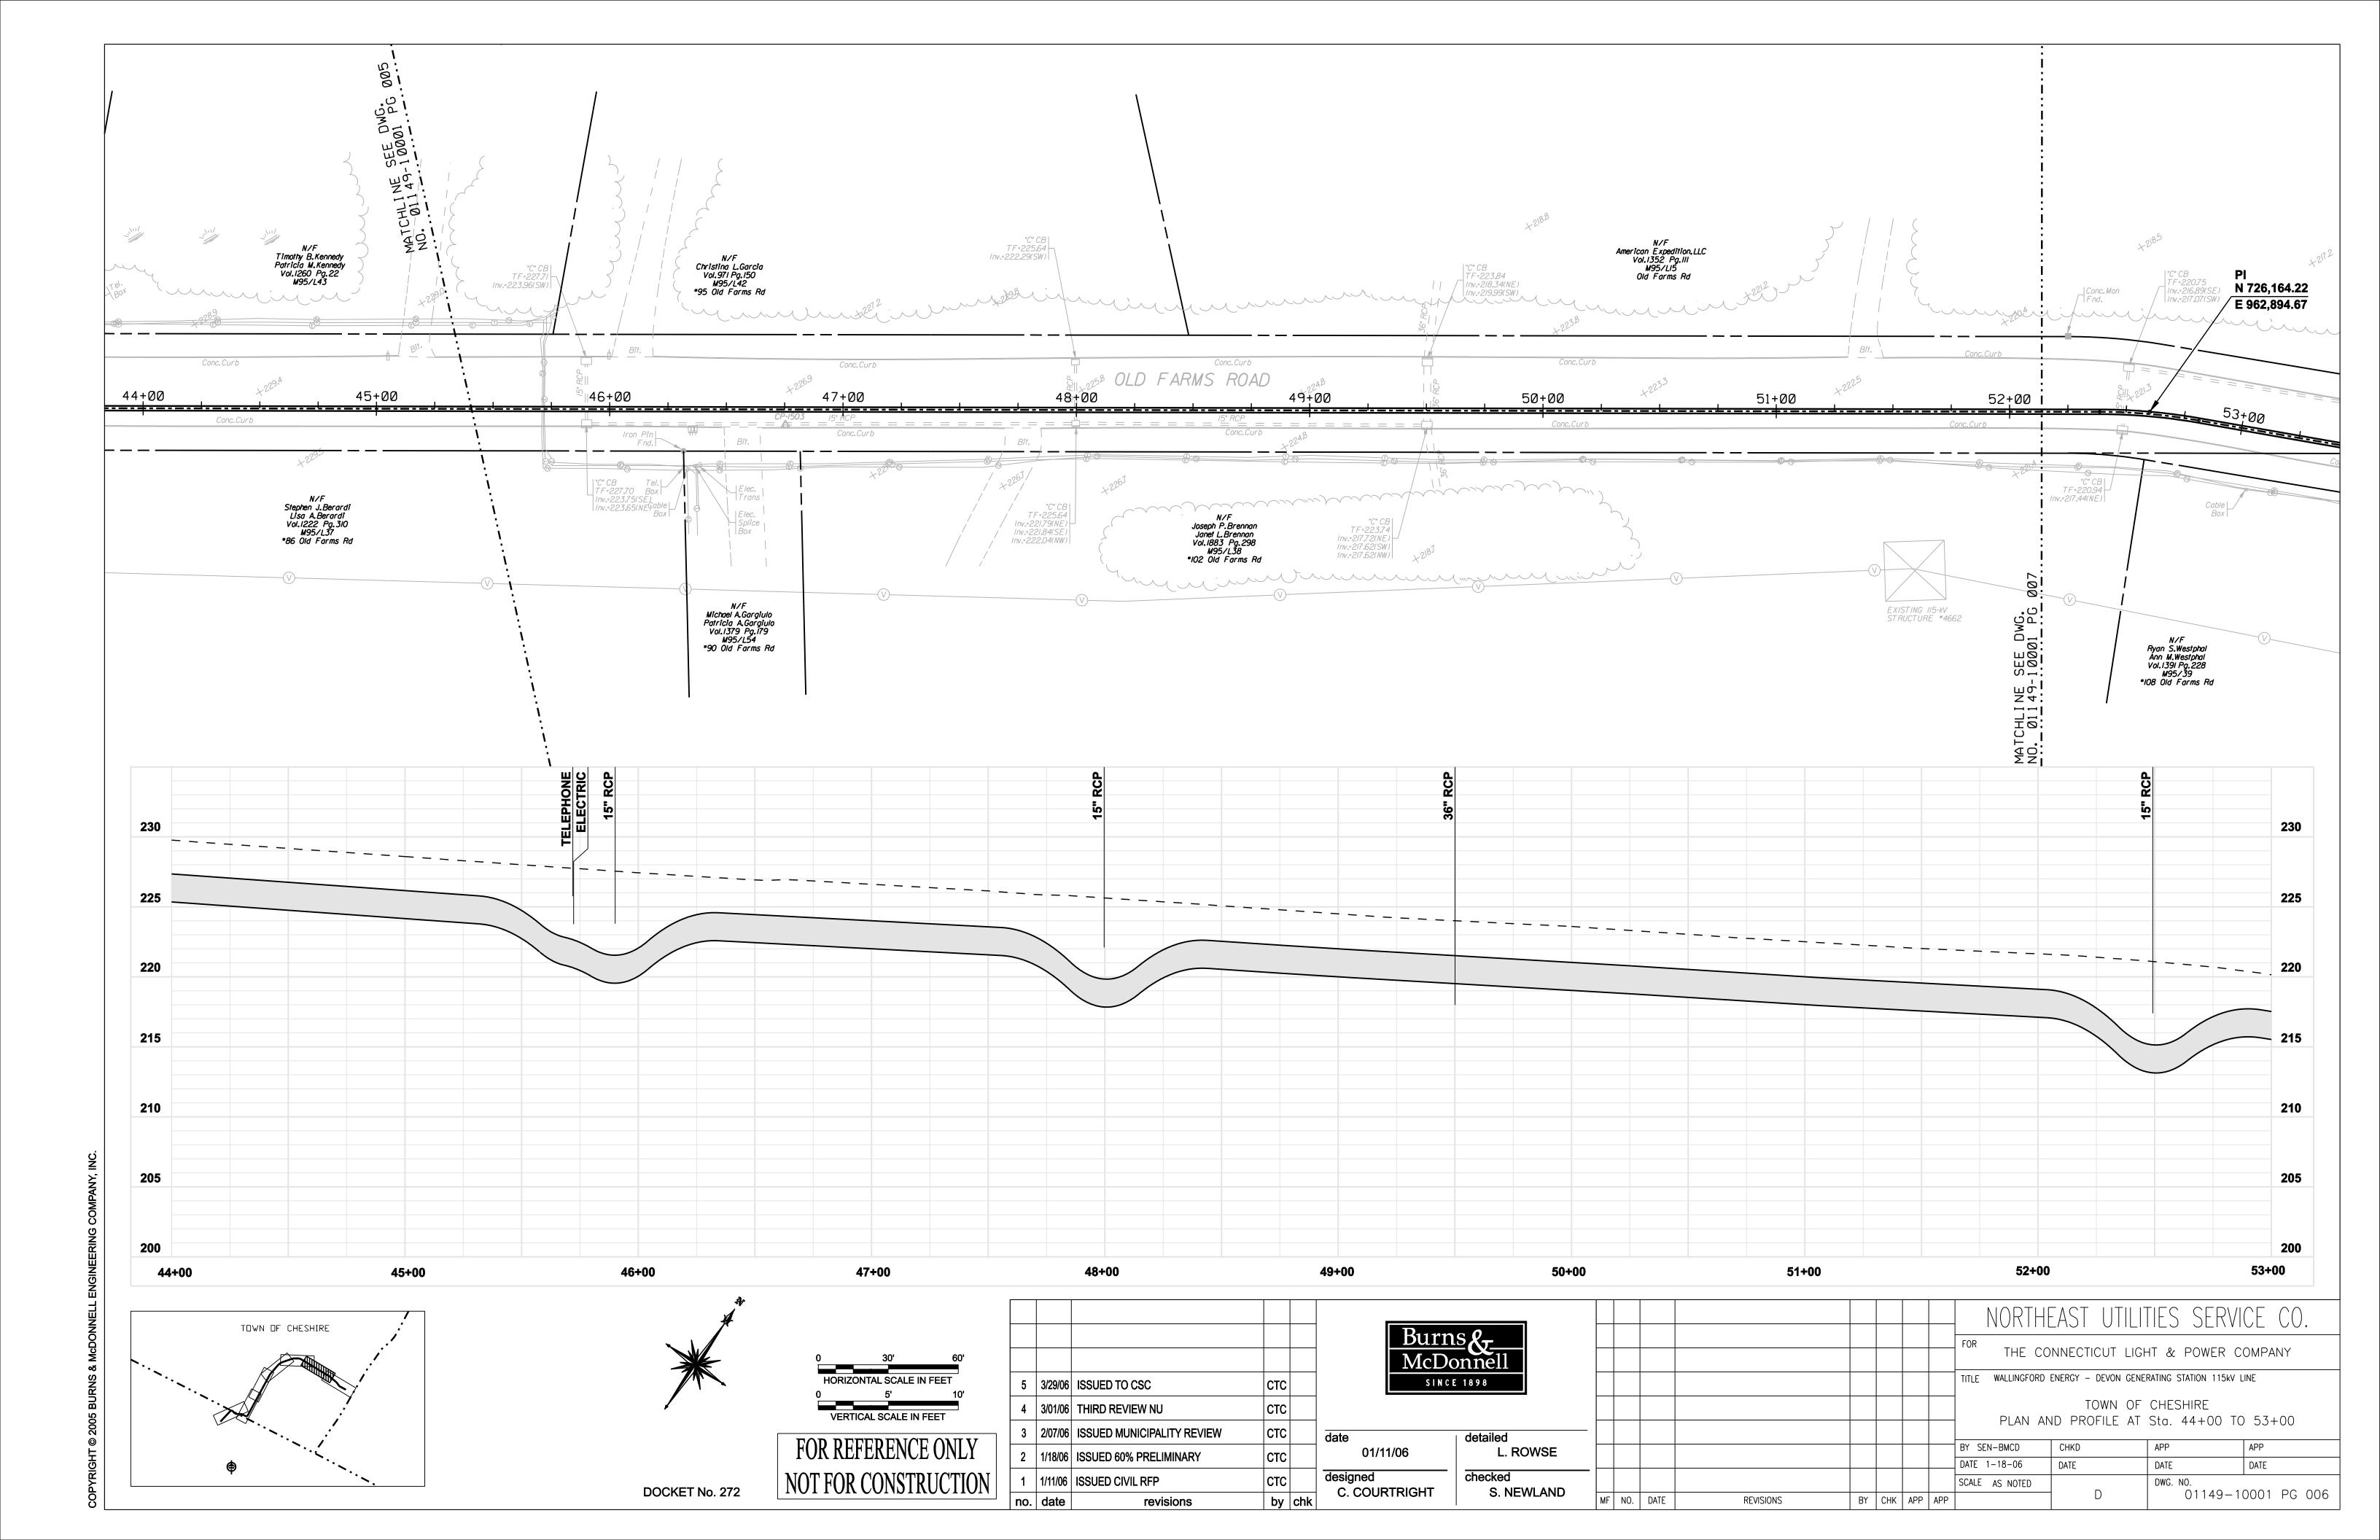

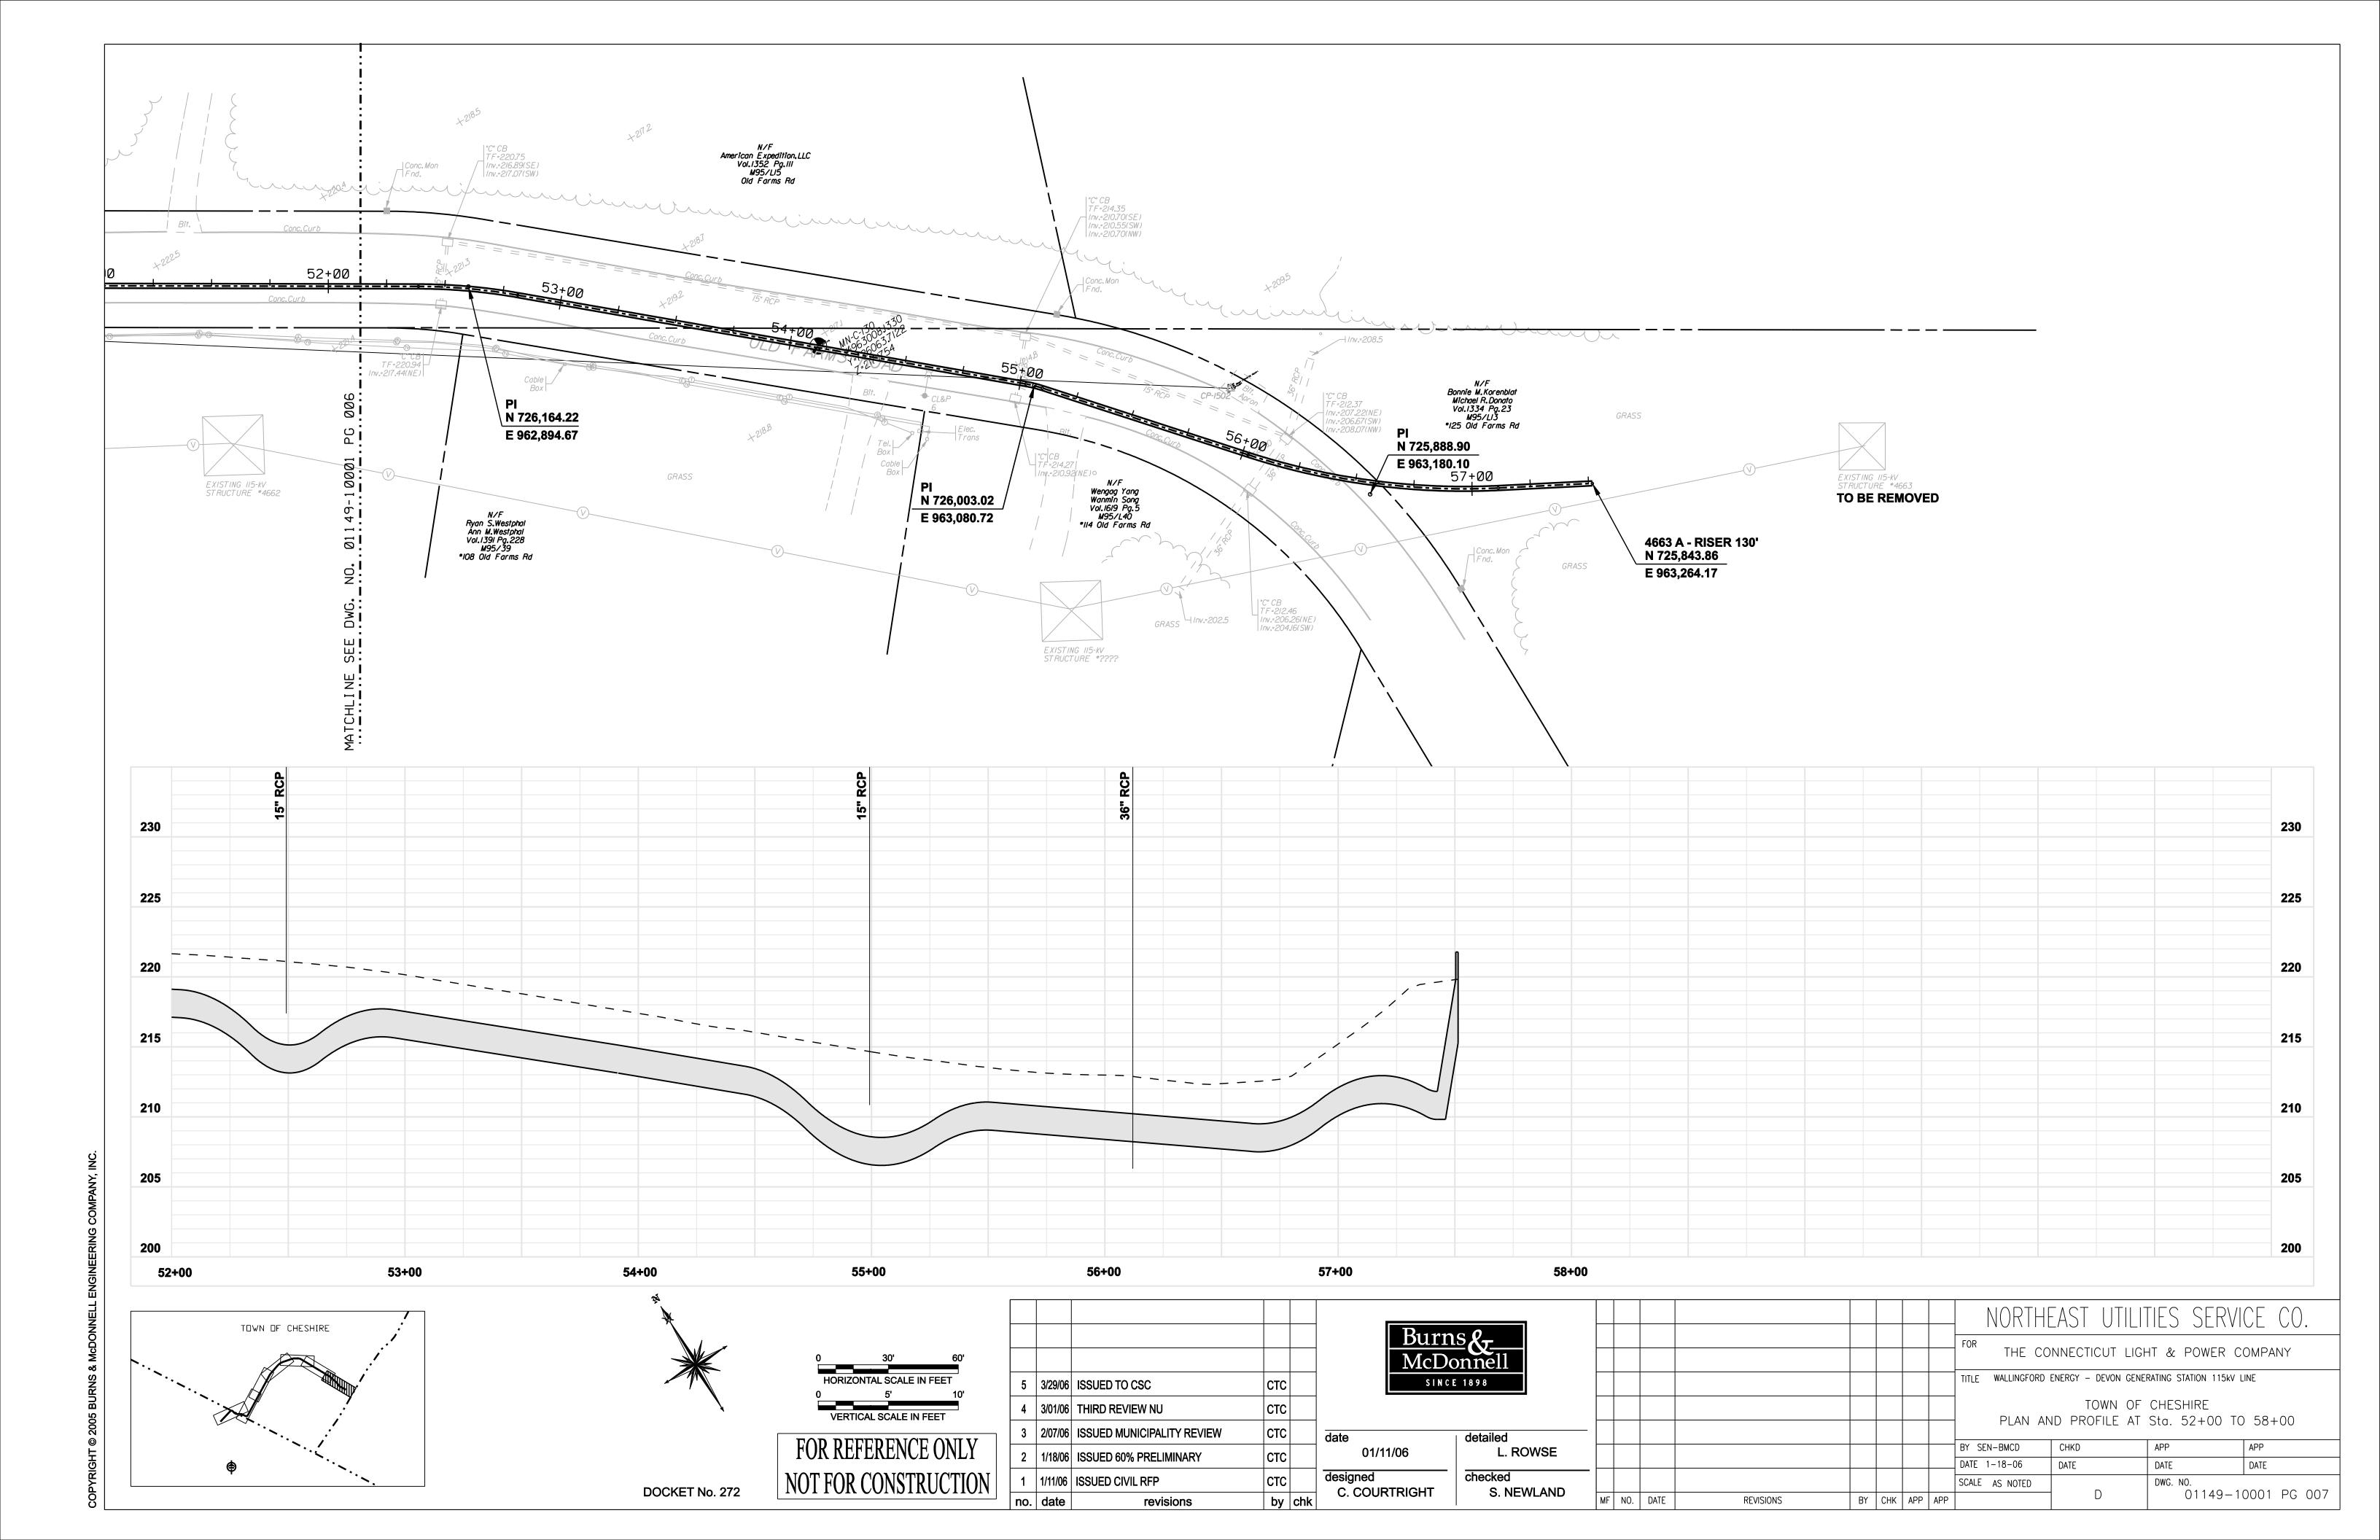

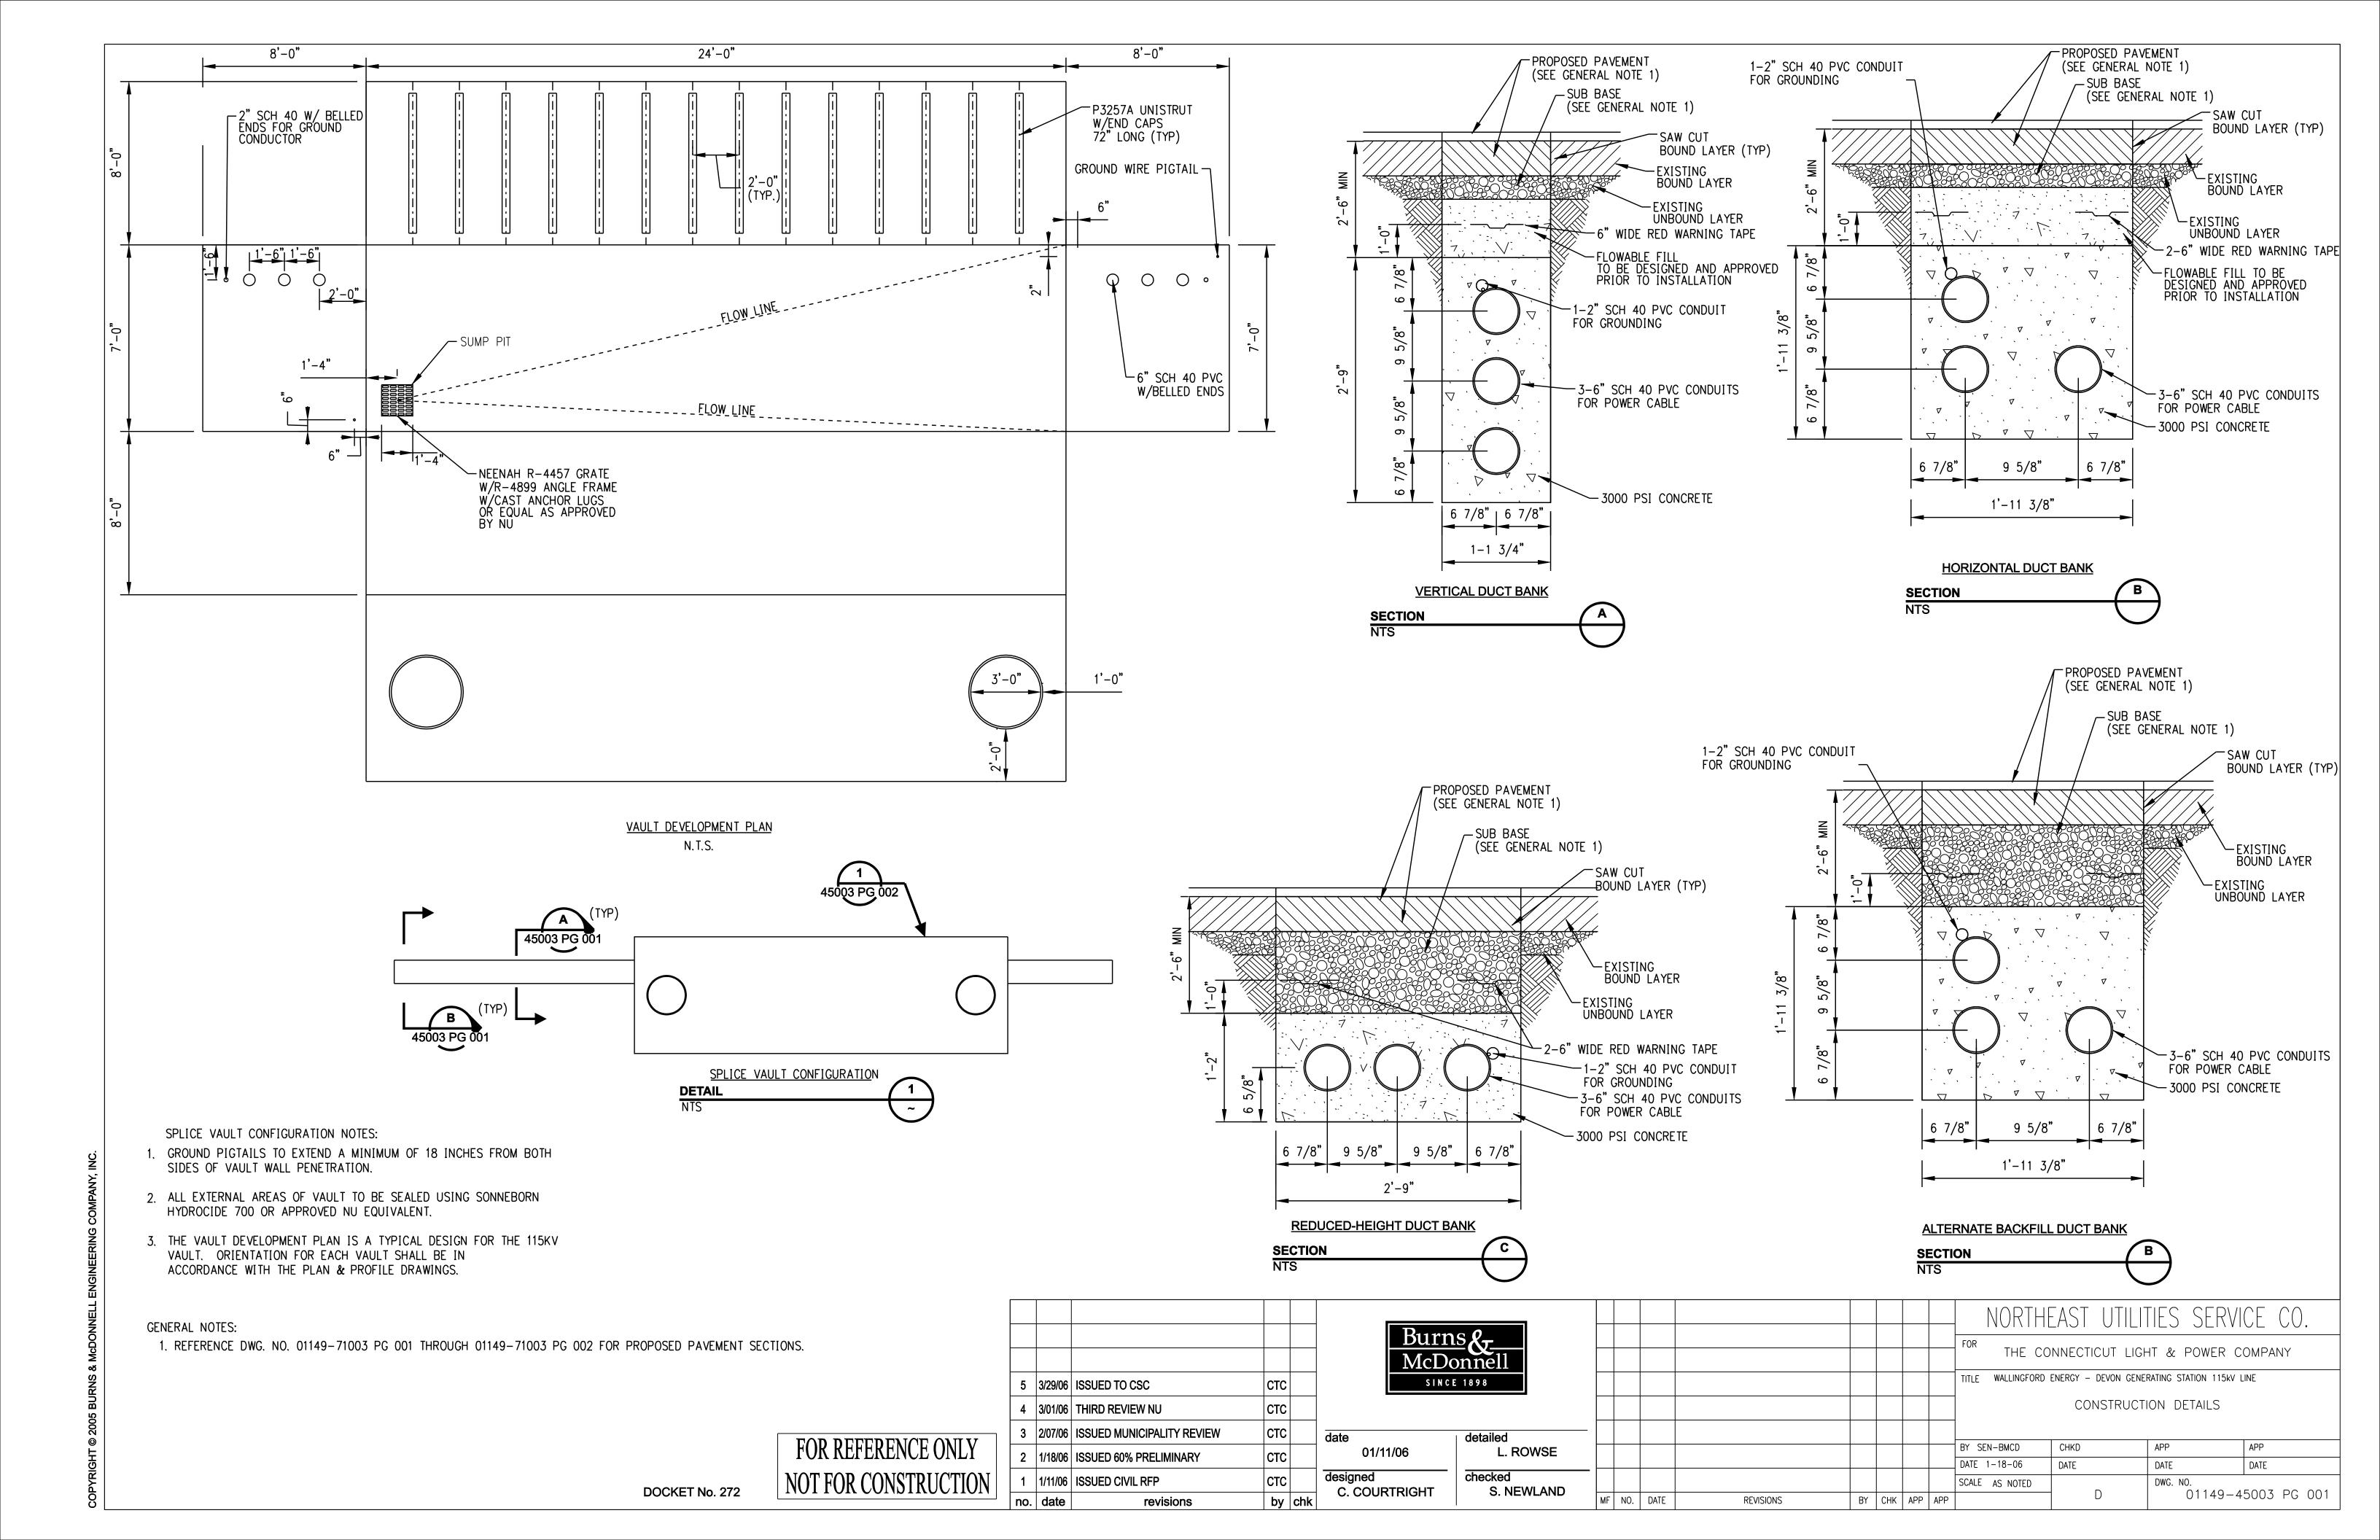


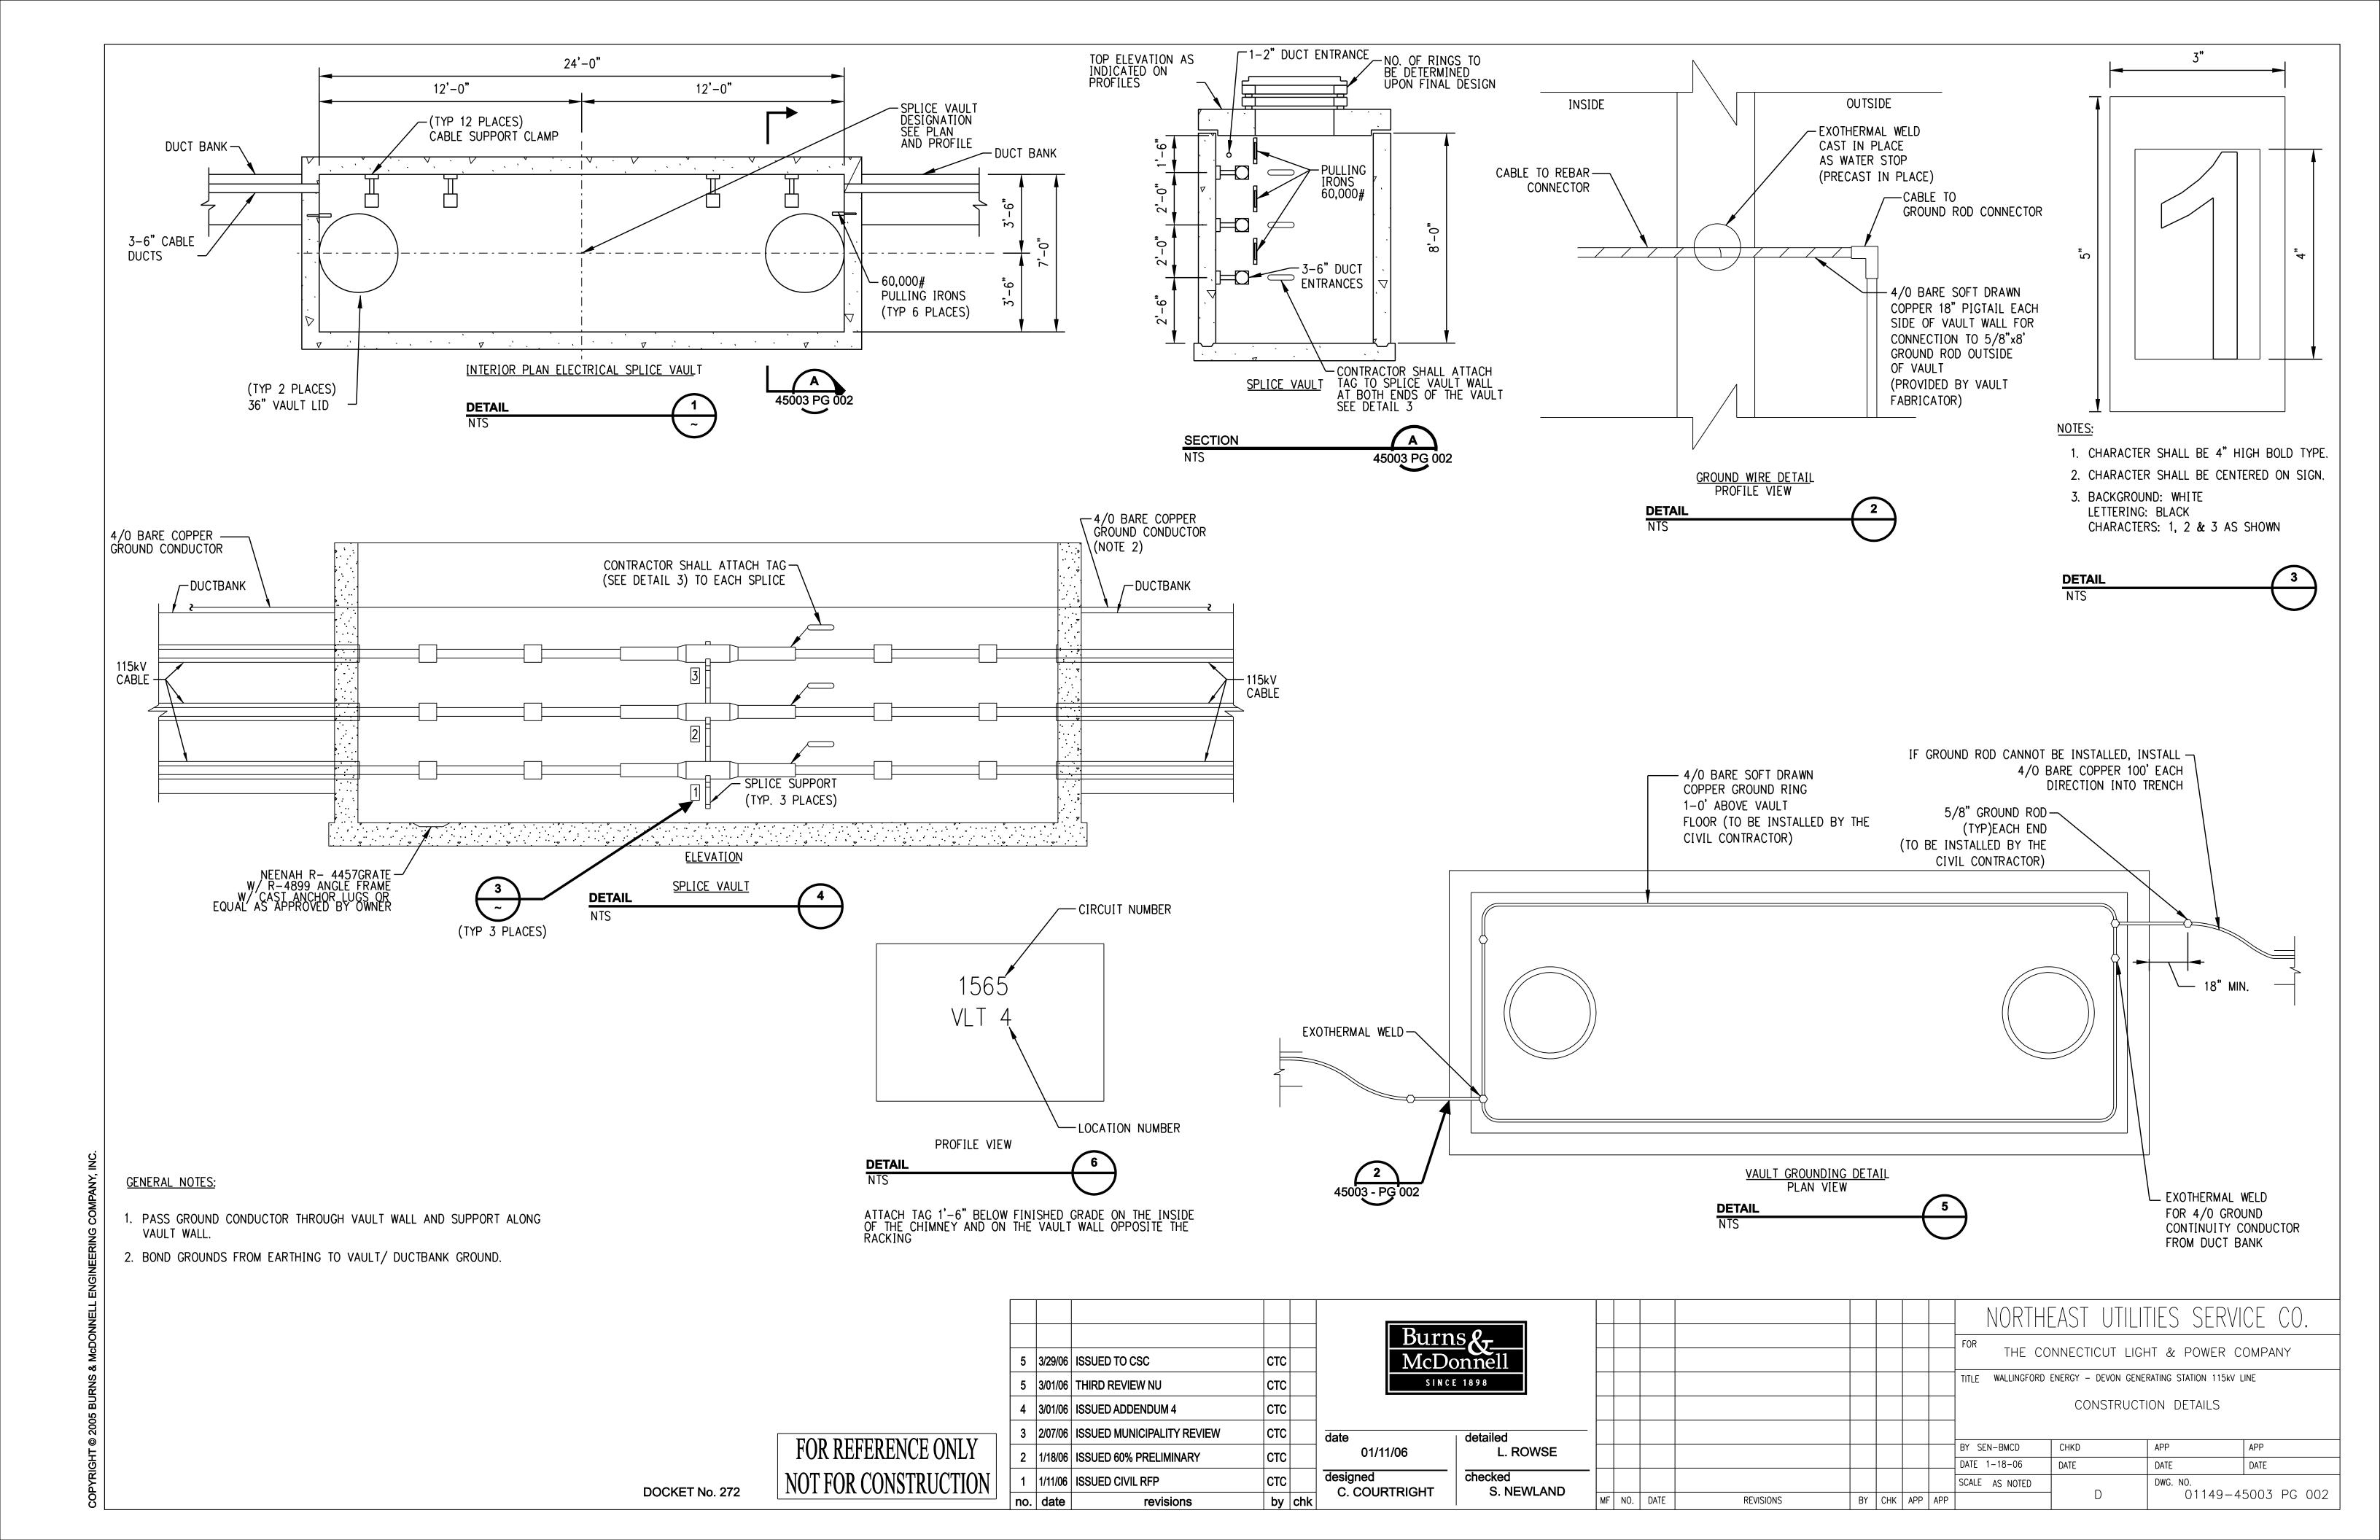


THE 4-AXLE SINGLE UNIT CONSTRUCTION VEHICLE WITH A GROSS VEHICLE WEIGHT OF 76,500 lbs WITH AN OVERALL WHEELBASE OF 18.2 FEET (13.5k ON FRONT AXLE, 18.0k, 22.5k AND 22.5k ON THE REAR THREE AXLES). AXLES ARE SPACED AT 9.6', 4.1' AND 4.5' (FRONT TO REAR)

STEEL PLATING NOTES:

- 1) THE USE OF STEEL PLATES, EXCEPT AS SET FORTH BELOW, SHALL BE CONSISTENT WITH THE GUIDELINES FOR USE OF STEEL PLATES IN STATE HIGHWAY RIGHT-OF-WAY UNLESS FURTHER DEVIATION FROM SUCH GUIDELINES HAS BEEN EXPRESSLY APPROVED BY THE ENGINEER.
- 2) FOR A TRENCH THAT DOES NOT EXCEED 3' IN WIDTH, THE STEEL PLATE MUST BE A MINIMUM OF 1" THICK AND A MAXIMUM OF 12' IN LENGTH.
- 3) FOR A TRENCH THAT EXCEEDS 3' IN WIDTH, A PROFESSIONAL ENGINEER (LICENSED IN CONNECTICUT) MUST DESIGN THE PLATE AND SUPPORT SYSTEM. THE PLATE AND SUPPORT SYSTEM MUST BE CAPABLE OF SUPPORTING A 4-AXLE CONSTRUCTION VEHICLE (SEE LOADING DIAGRAM).
- 4) THE MAXIMUM PLATED TRENCH LENGTH IS 300', OR AS FIELD CONDITIONS WARRANT.
- 5) IF THE TRENCH DEPTH IS GREATER THAN 3', SIDEWALL SHORING MUST BE INSTALLED.
- 6) PLATES MUST HAVE PERMANENT SLIP-RESISTANT SURFACE.
- 7) PLATES MUST BE PINNED AND RAMPED IN PLACE. WHEN PLATES ARE LEFT IN PLACE IN EXCESS OF 48 HOURS, THE PLATES MUST BE RECESSED TO ROAD LEVEL AND PINNED.
- TRAFFIC CONTROL SIGNS MUST BE INSTALLED TO WARN MOTORISTS OF STEEL PLATES.
- PLATES MUST BE IN ACCORDANCE WITH ASTM STANDARDS AND CERTIFICATION MUST BE PROVIDED BY THE PERMITTEE PRIOR TO SECURING PERMISSION.
- 10) WHERE PLATES WILL BE IN PLACE FOR MORE THAN 24 HOURS, THE CONTRACTOR SHALL CONDUCT REGULAR INSPECTION AND REPAIR AS NEEDED.
- 11) STEEL PLATES CAN NOT BE LEFT IN PLACE AT THE FOLLOWING LOCATIONS:
 - APPROACHING STOP BARS OR STOP SIGNS (MINIMUM DISTANCE OF 100'); - AT HANDICAPPED RAMPS;
 - IN AREAS WHERE CROSSWALKS ARE PRESENT INCLUDING SCHOOLS,
 - HOSPITALS, CHURCHES AND ELDERLY HOUSING;
- 12) THE MAXIMUM TRENCH WIDTH-8' OR AS FIELD CONDITIONS WARRANT, IF TRENCH IS WIDER, THE TRENCH WALLS SUPPORT SYSTEM MUST BE DESIGNED BY A PROFESSIONAL ENGINEER.

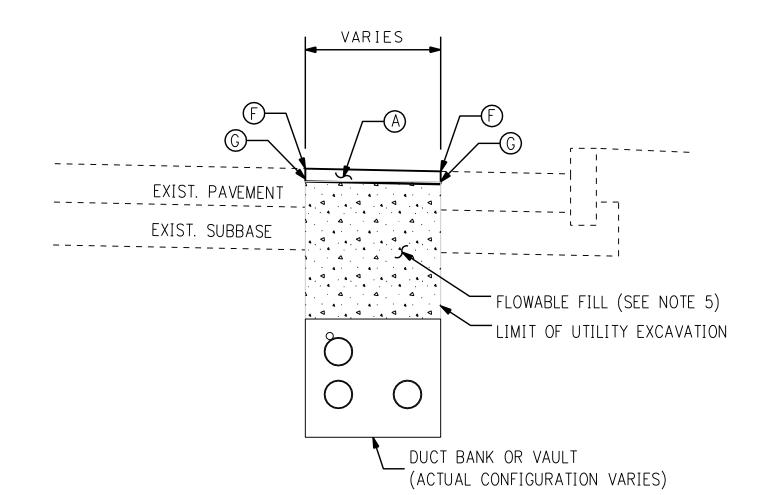

TEMPORARY PAVEMENT REPAIR (DUCT BANK / VAULT CONSTRUCTION)

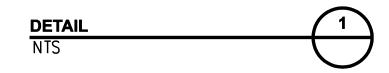


revisions


by chk

LEGEND FOR TYPICAL SECTIONS

TURF ESTABLISHMENT

2" BITUMINOUS CONCRETE PAVEMENT - CLASS 1 2" BITUMINOUS CONCRETE PAVEMENT - CLASS 2 10" PROCESSED AGGREGATE SUBBASE FORMATION OF SUBGRADE CONCRETE CURBING CUT BITUMINOUS CONCRETE PAVEMENT APPLY TACK COAT

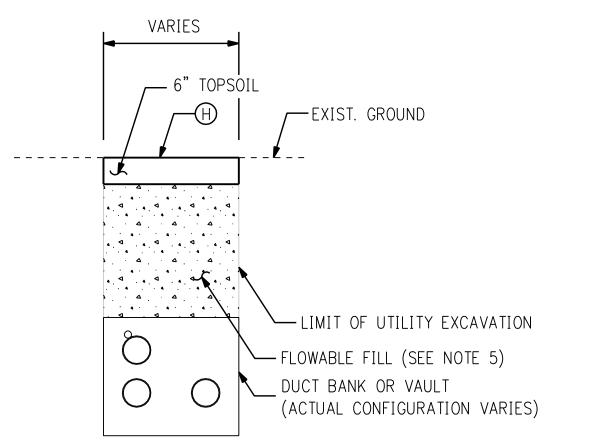

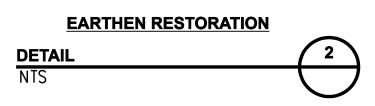

NOTES:

- "TURF ESTABLISHMENT" SHALL BE APPLIED TO ALL AREAS DISTURBED BY THE CONTRACTOR'S ACTIVITIES.
- 2) "MATERIAL FOR TACK COAT" SHALL BE APPLIED BETWEEN PAVEMENT COURSES AND TO ALL PAVEMENT JOINTS.
- THE TEMPORARY PAVEMENT DETAIL SHALL BE APPLIED TO ALL TRENCH EXCAVATIONS IN AREAS OF BITUMINOUS TYPE PAVEMENT. THE PERMANENT PAVEMENT TREATMENTS SHALL BE APPLIED WITHIN A PERIOD OF NOT LESS THAN 60 CALENDER DAYS (EXCLUDING THE WINTER SHUTDOWN).
- 4) SEE STANDARD DRAWING NO. 921-A FOR BITUMINOUS CONCRETE DRIVEWAYS.
- 5) "PROCESSED AGGREGATE SUBBASE" MAY BE USED IN PLACE OF "FLOWABLE FILL" AS THE ALTERNATE BACKFILL. "FLOWABLE FILL" AND "PROCESSED AGGREGATE SUBBASE" MUST BE THERMALLY TESTED AND APPROVED BY THE ENGINEER PRIOR TO INSTALLATION. SEE TECHNICAL SPECIFICATIONS FOR DETAILS.

BY CHK APP APP

CONSTRUCTION DETAILS

DATE

CHKD

DATE

APP

DATE

01149-71003 PG 001

6) SEE MILLING AND OVERLAY DRAWINGS FOR FINAL MILL AND OVERLAY LIMITS.


REVISIONS

NORTHEAST UTILITIES SERVICE CO. Burns THE CONNECTICUT LIGHT & POWER COMPANY McDonnell TITLE WALLINGFORD ENERGY - DEVON GENERATING STATION 115kV LINE SINCE 1898 5 | 3/29/06 | ISSUED TO CSC СТС 4 | 3/01/06 | THIRD REVIEW NU СТС 3 | 2/07/06 | ISSUED MUNICIPALITY REVIEW date detailed СТС BY SEN-BMCD **BL COMPANIES** 1/11/06 2 1/18/06 ISSUED 60% PRELIMINARY DATE 1-18-06 designed checked 1 1/11/06 ISSUED CIVIL RFP SCALE AS NOTED S. NEWLAND **BL COMPANIES**

MF NO. DATE


FOR REFERENCE ONLY NOT FOR CONSTRUCTION


no. date

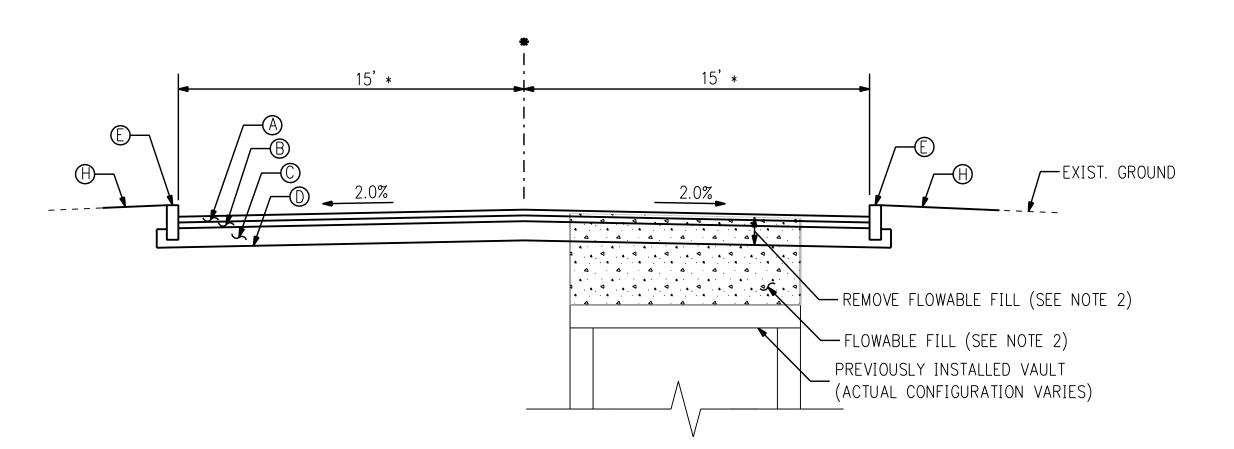

(VAULT CONSTRUCTION) * VARIES, SEE FULL DEPTH PAVEMENT PLANS

PERMANENT PAVEMENT REPAIR

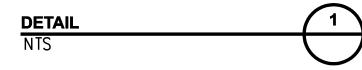

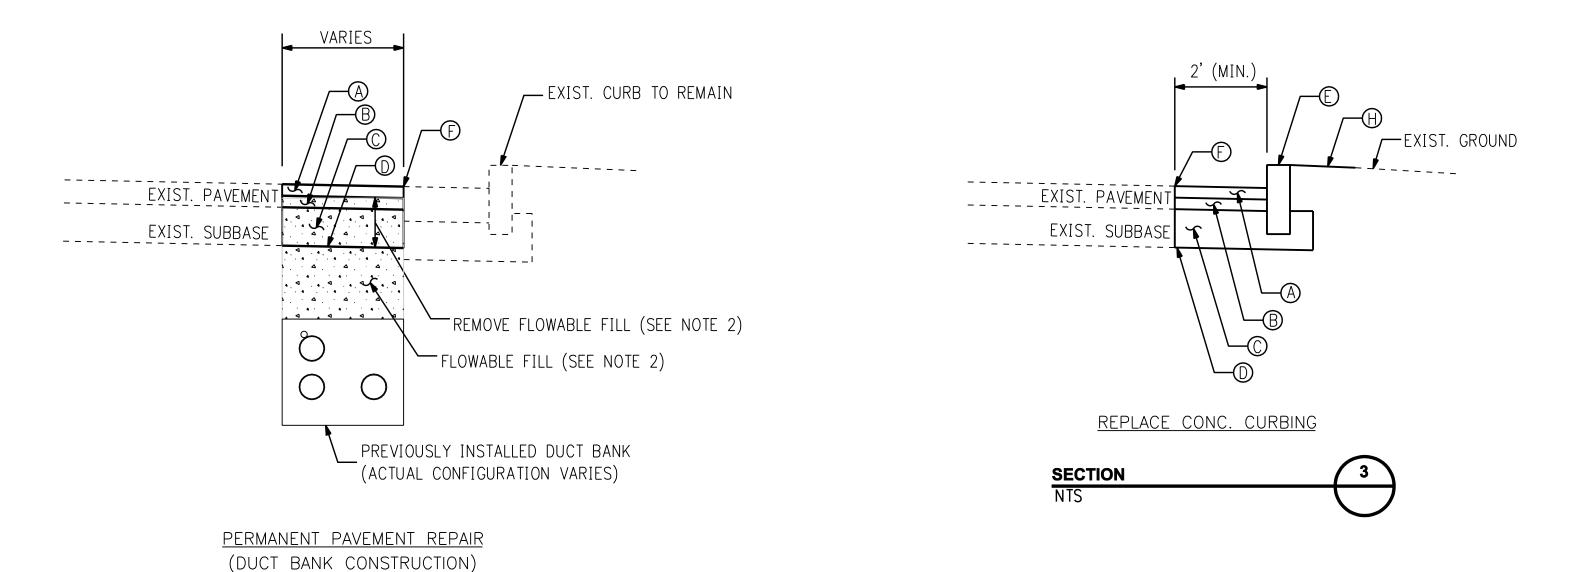

LEGEND FOR TYPICAL SECTIONS

2" BITUMINOUS CONCRETE PAVEMENT - CLASS 1 2" BITUMINOUS CONCRETE PAVEMENT - CLASS 2 10" PROCESSED AGGREGATE SUBBASE FORMATION OF SUBGRADE CONCRETE CURBING CUT BITUMINOUS CONCRETE PAVEMENT APPLY TACK COAT TURF ESTABLISHMENT

NOTES:

- 1) "PROCESSED AGGREGATE SUBBASE" MAY BE USED IN PLACE OF "FLOWABLE FILL" AS THE ALTERNATE BACKFILL. "FLOWABLE FILL" AND "PROCESSED AGGREGATE SUBBASE" MUST BE THERMALLY TESTED AND APPROVED BY THE ENGINEER PRIOR TO INSTALLATION. SEE TECHNICAL SPECIFICATIONS FOR DETAILS.
- SEE MILLING AND OVERLAY DRAWINGS FOR FINAL MILL AND OVERLAY LIMITS.

7 | 3/29/06 | ISSUED TO CSC 6 | 3/01/06 | THIRD REVIEW NU СТС 5 | 3/01/06 | ISSUED ADDENDUM 4 СТС 4 | 3/01/06 | ADDENDUM 4 СТС 3 2/07/06 ISSUED MUNICIPALITY REVIEW СТС 2 | 1/18/06 | ISSUED 60% PRELIMINARY 1 1/11/06 ISSUED CIVIL RFP by chk no. date revisions



date detailed **BL COMPANIES** 1/11/06 designed checked S. NEWLAND **BL COMPANIES**

									L
									L
									L
-									L
									ļ
	MF	NO.	DATE	REVISIONS	BY	CHK	APP	APP	

THE CONNECTICUT LIGHT & POWER COMPANY TITLE WALLINGFORD ENERGY — DEVON GENERATING STATION 115kV LINE CONSTRUCTION DETAILS

CHKD

DATE

BY SEN-BMCD


☐ DATE 1-18-06


SCALE AS NOTED


NORTHEAST UTILITIES SERVICE CO.


DATE DATE 01149-71003 PG 002


FOR REFERENCE ONLY NOT FOR CONSTRUCTION

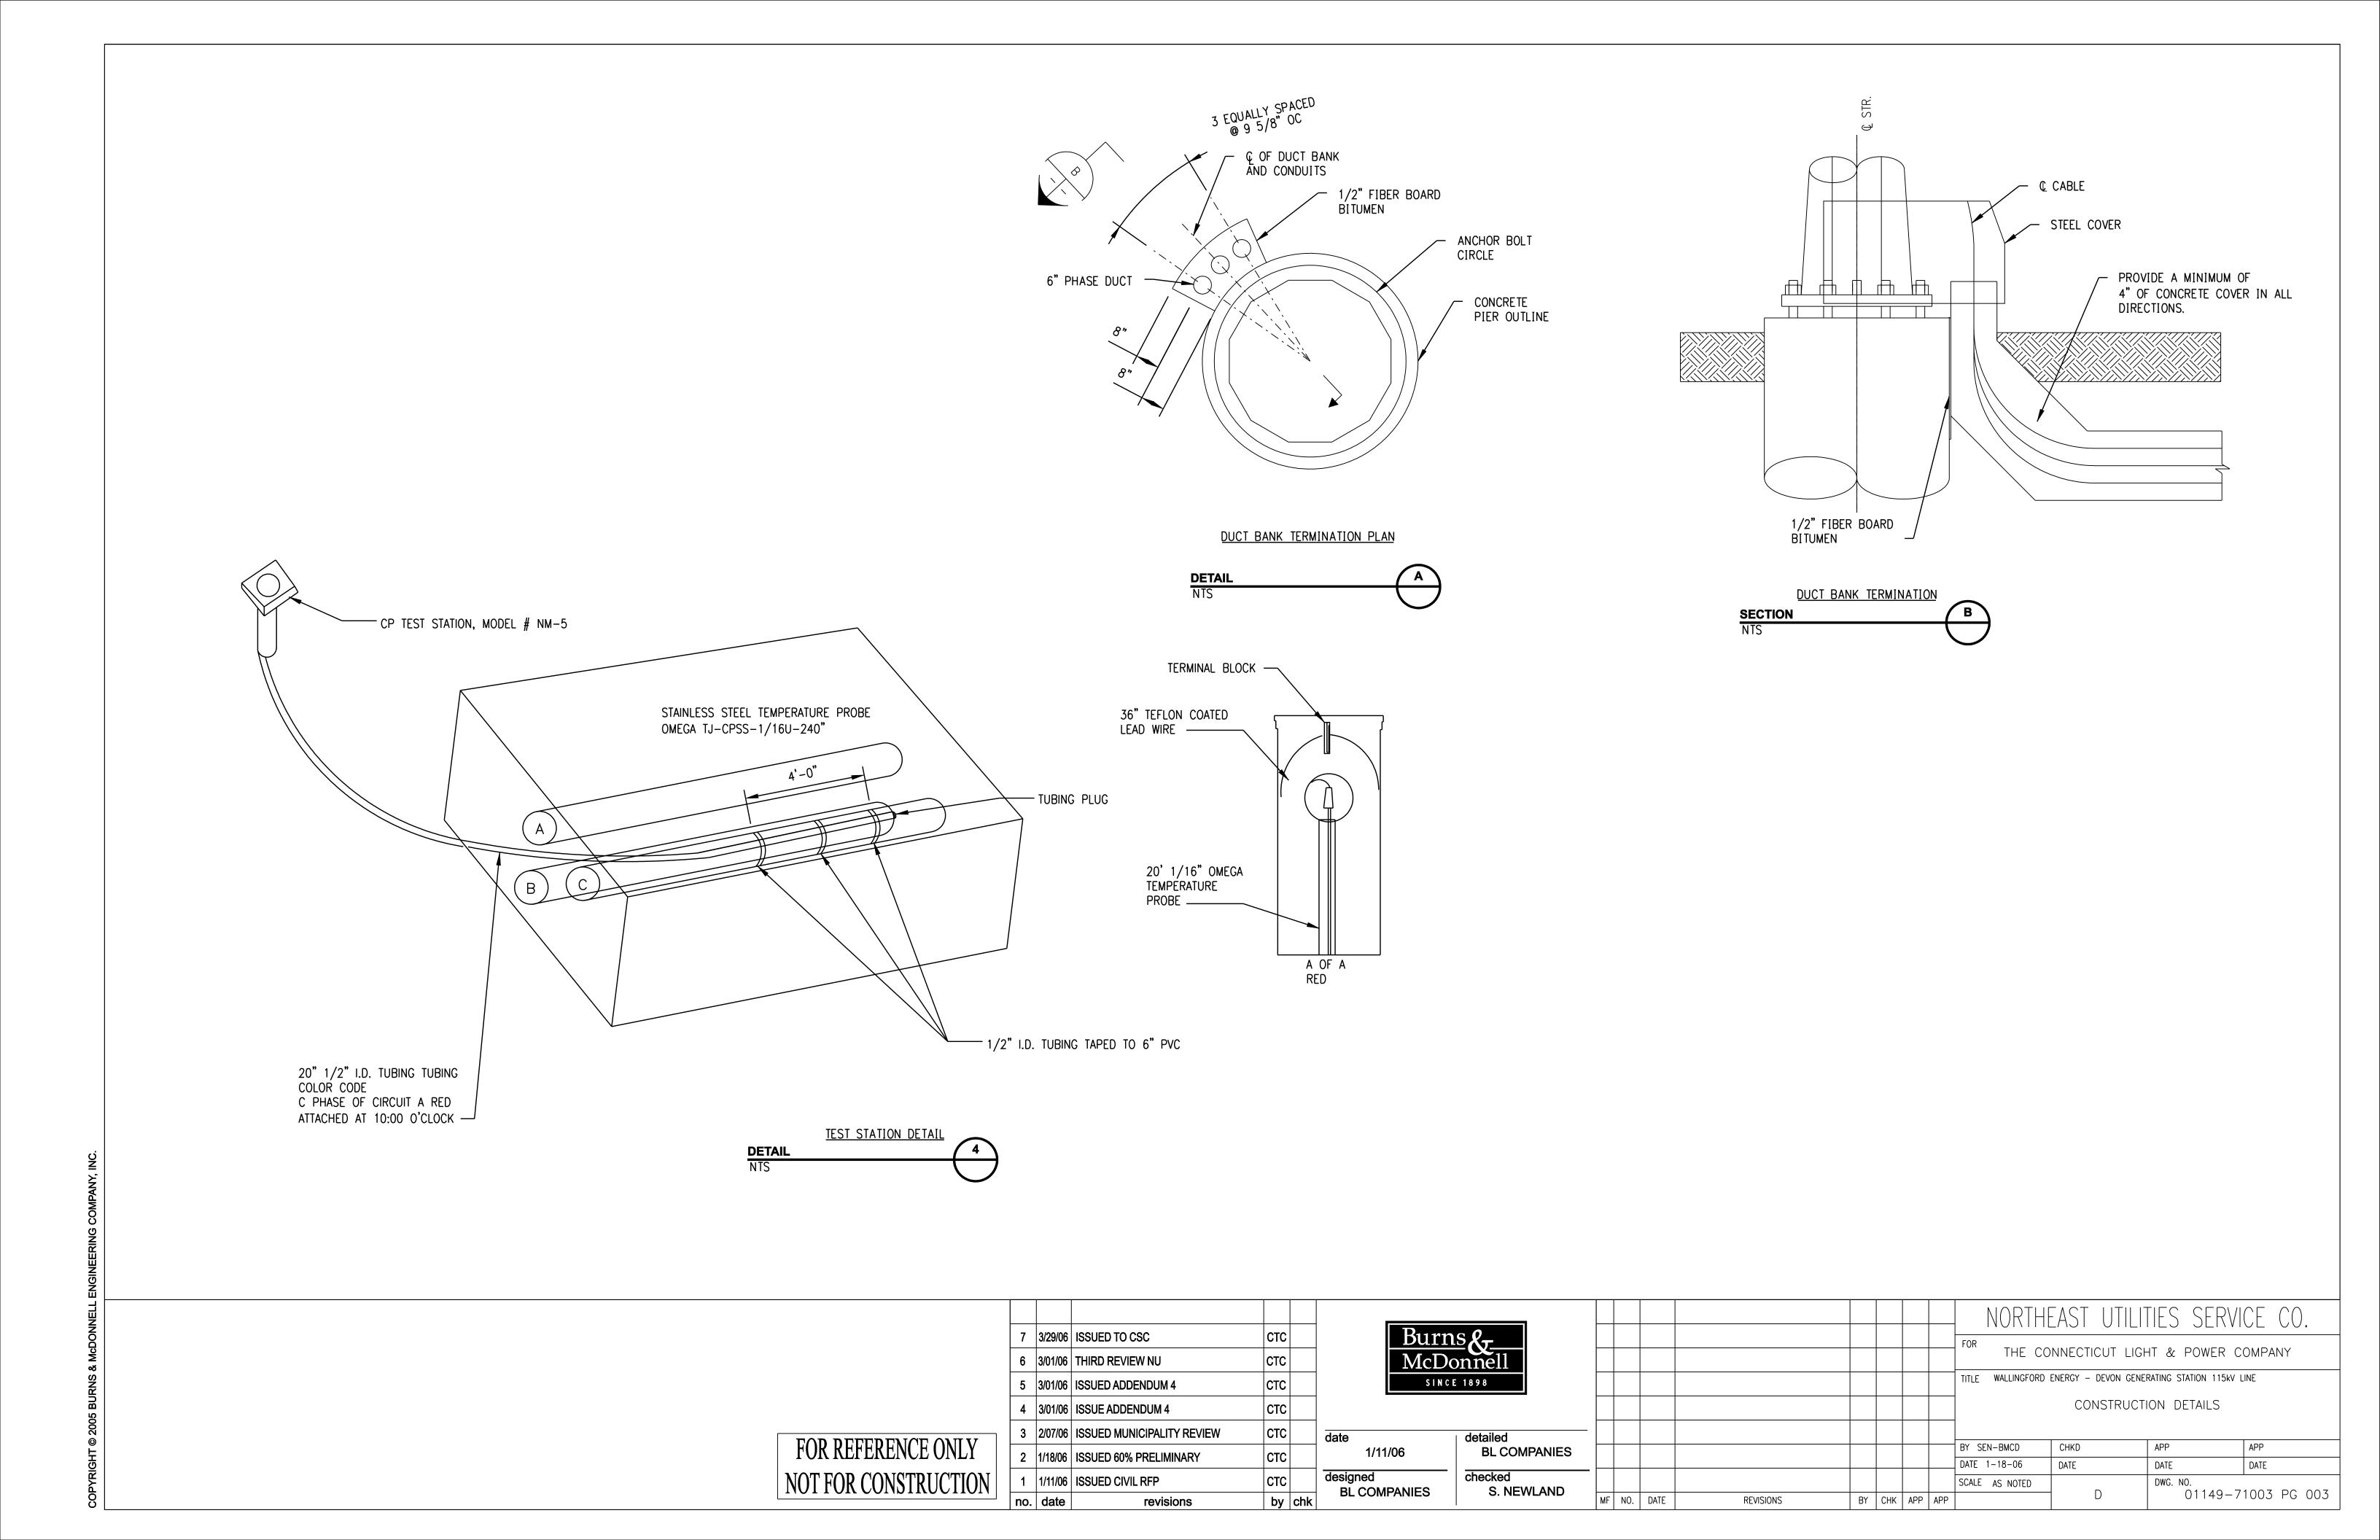

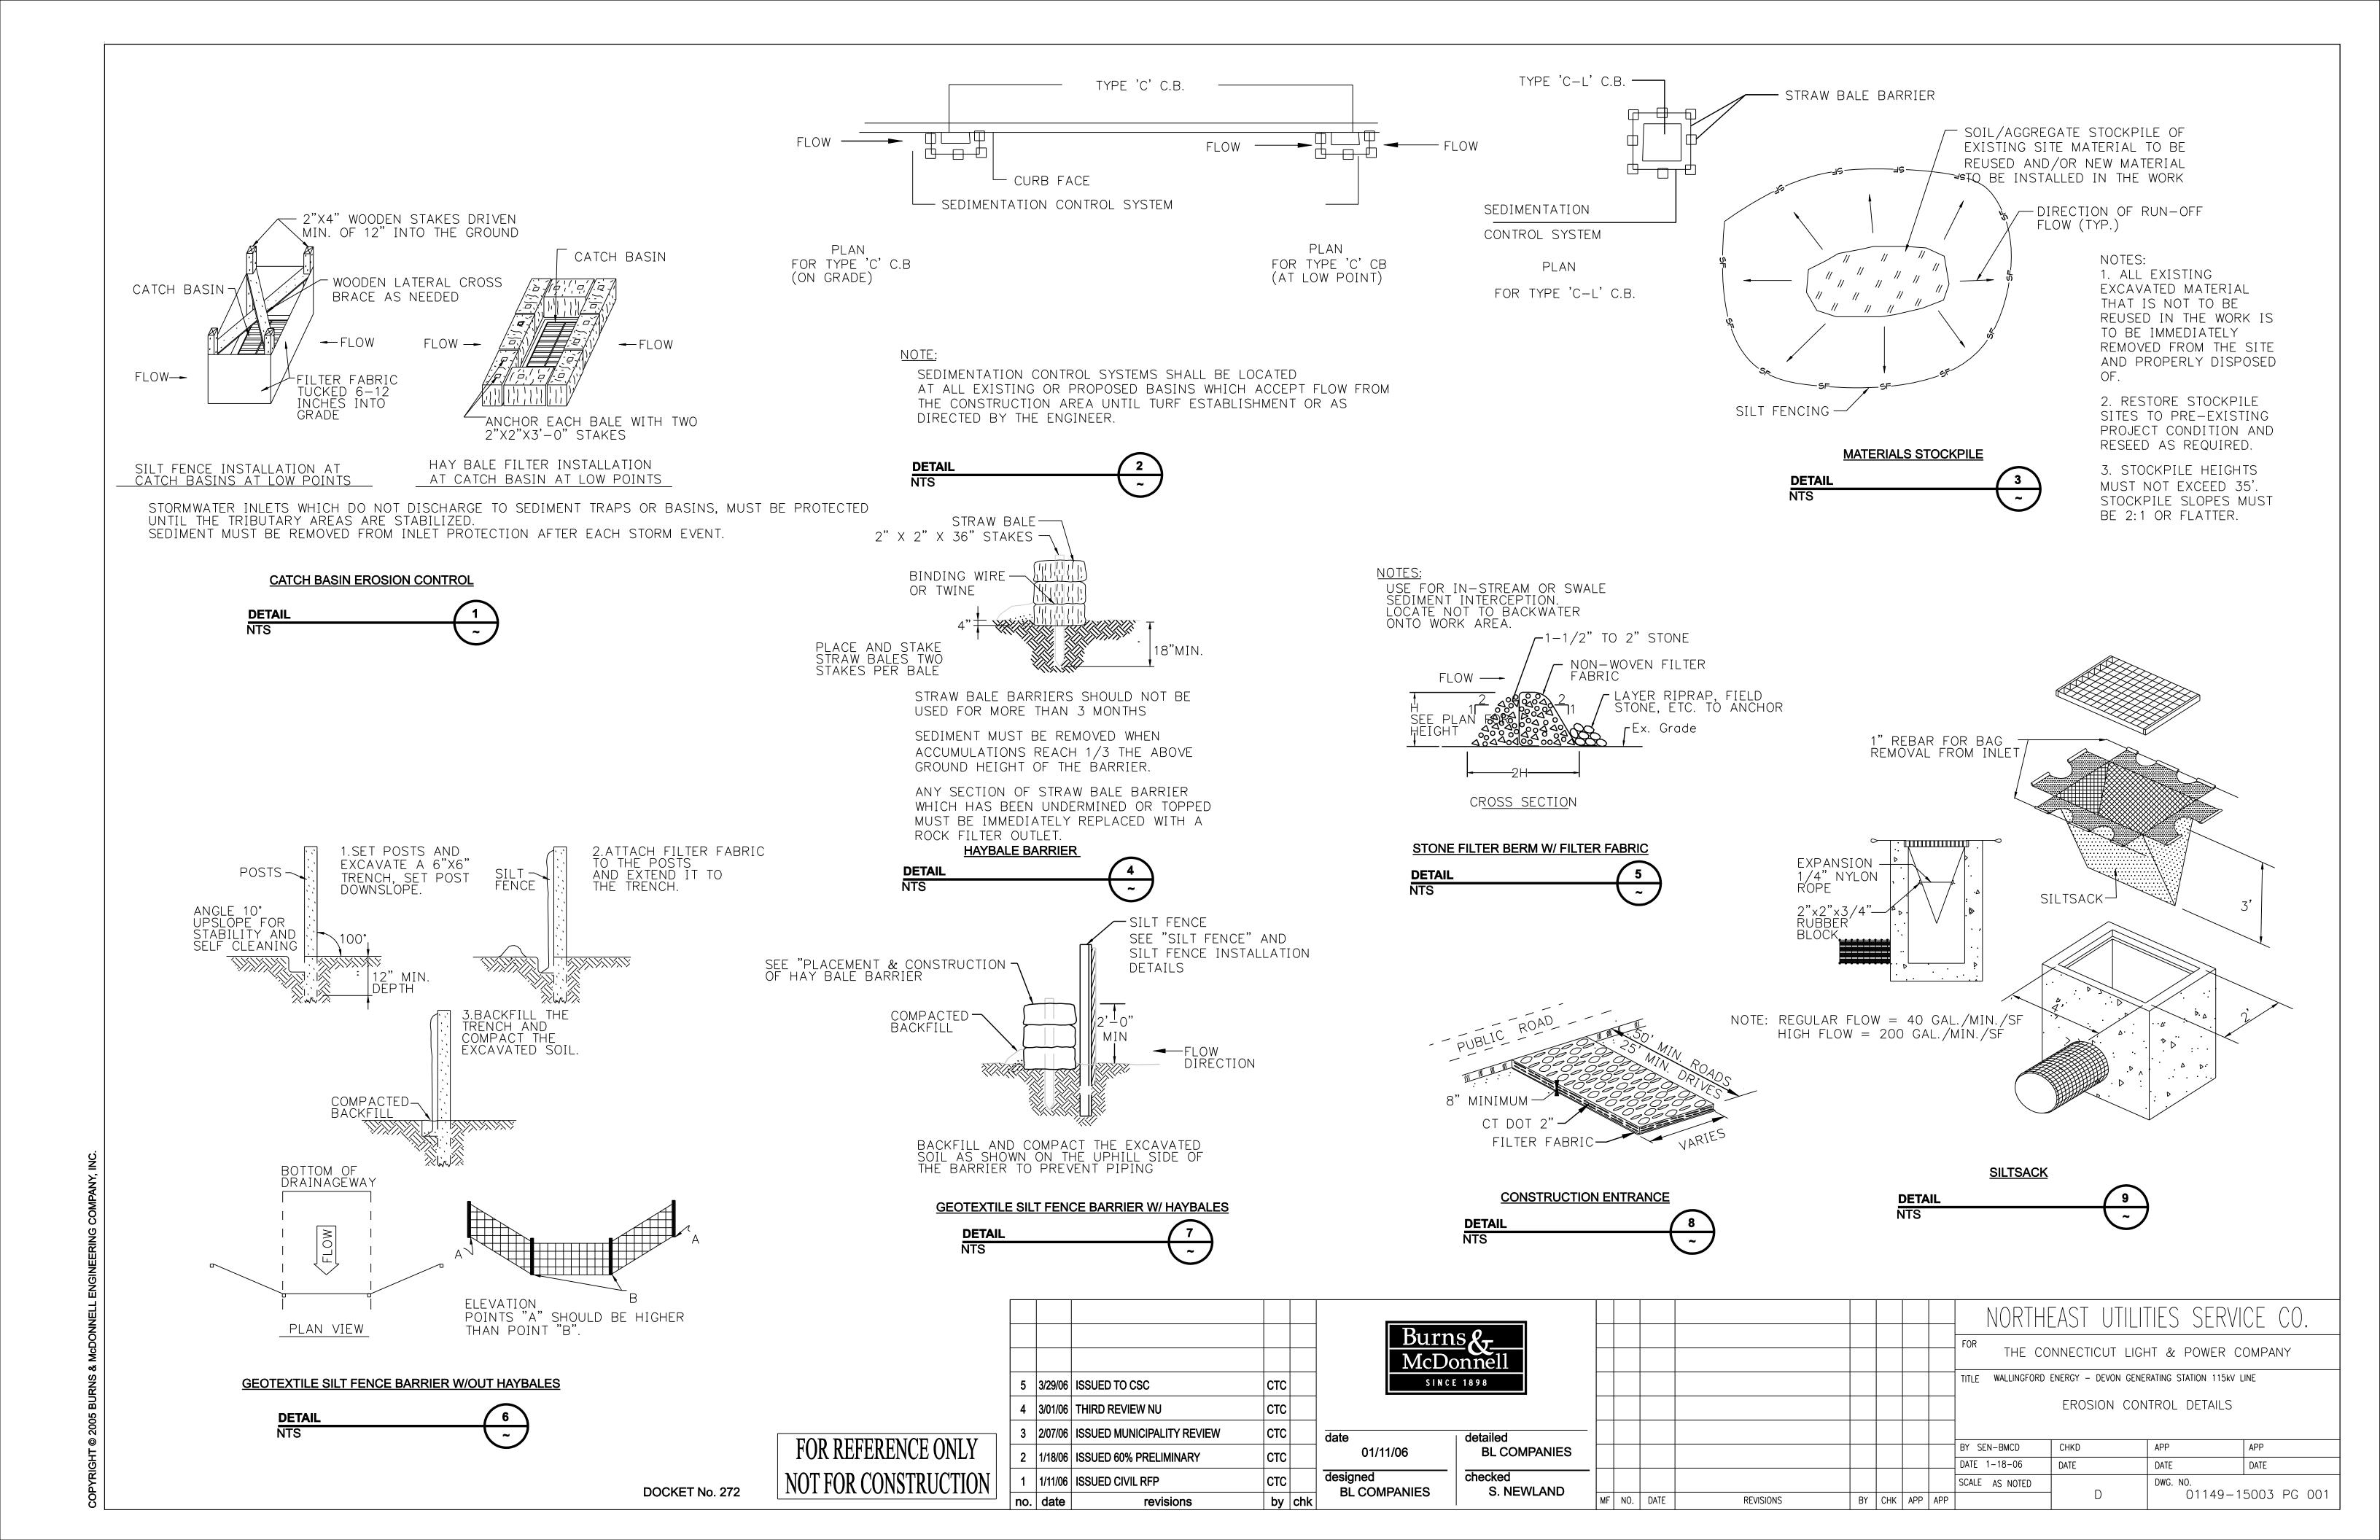

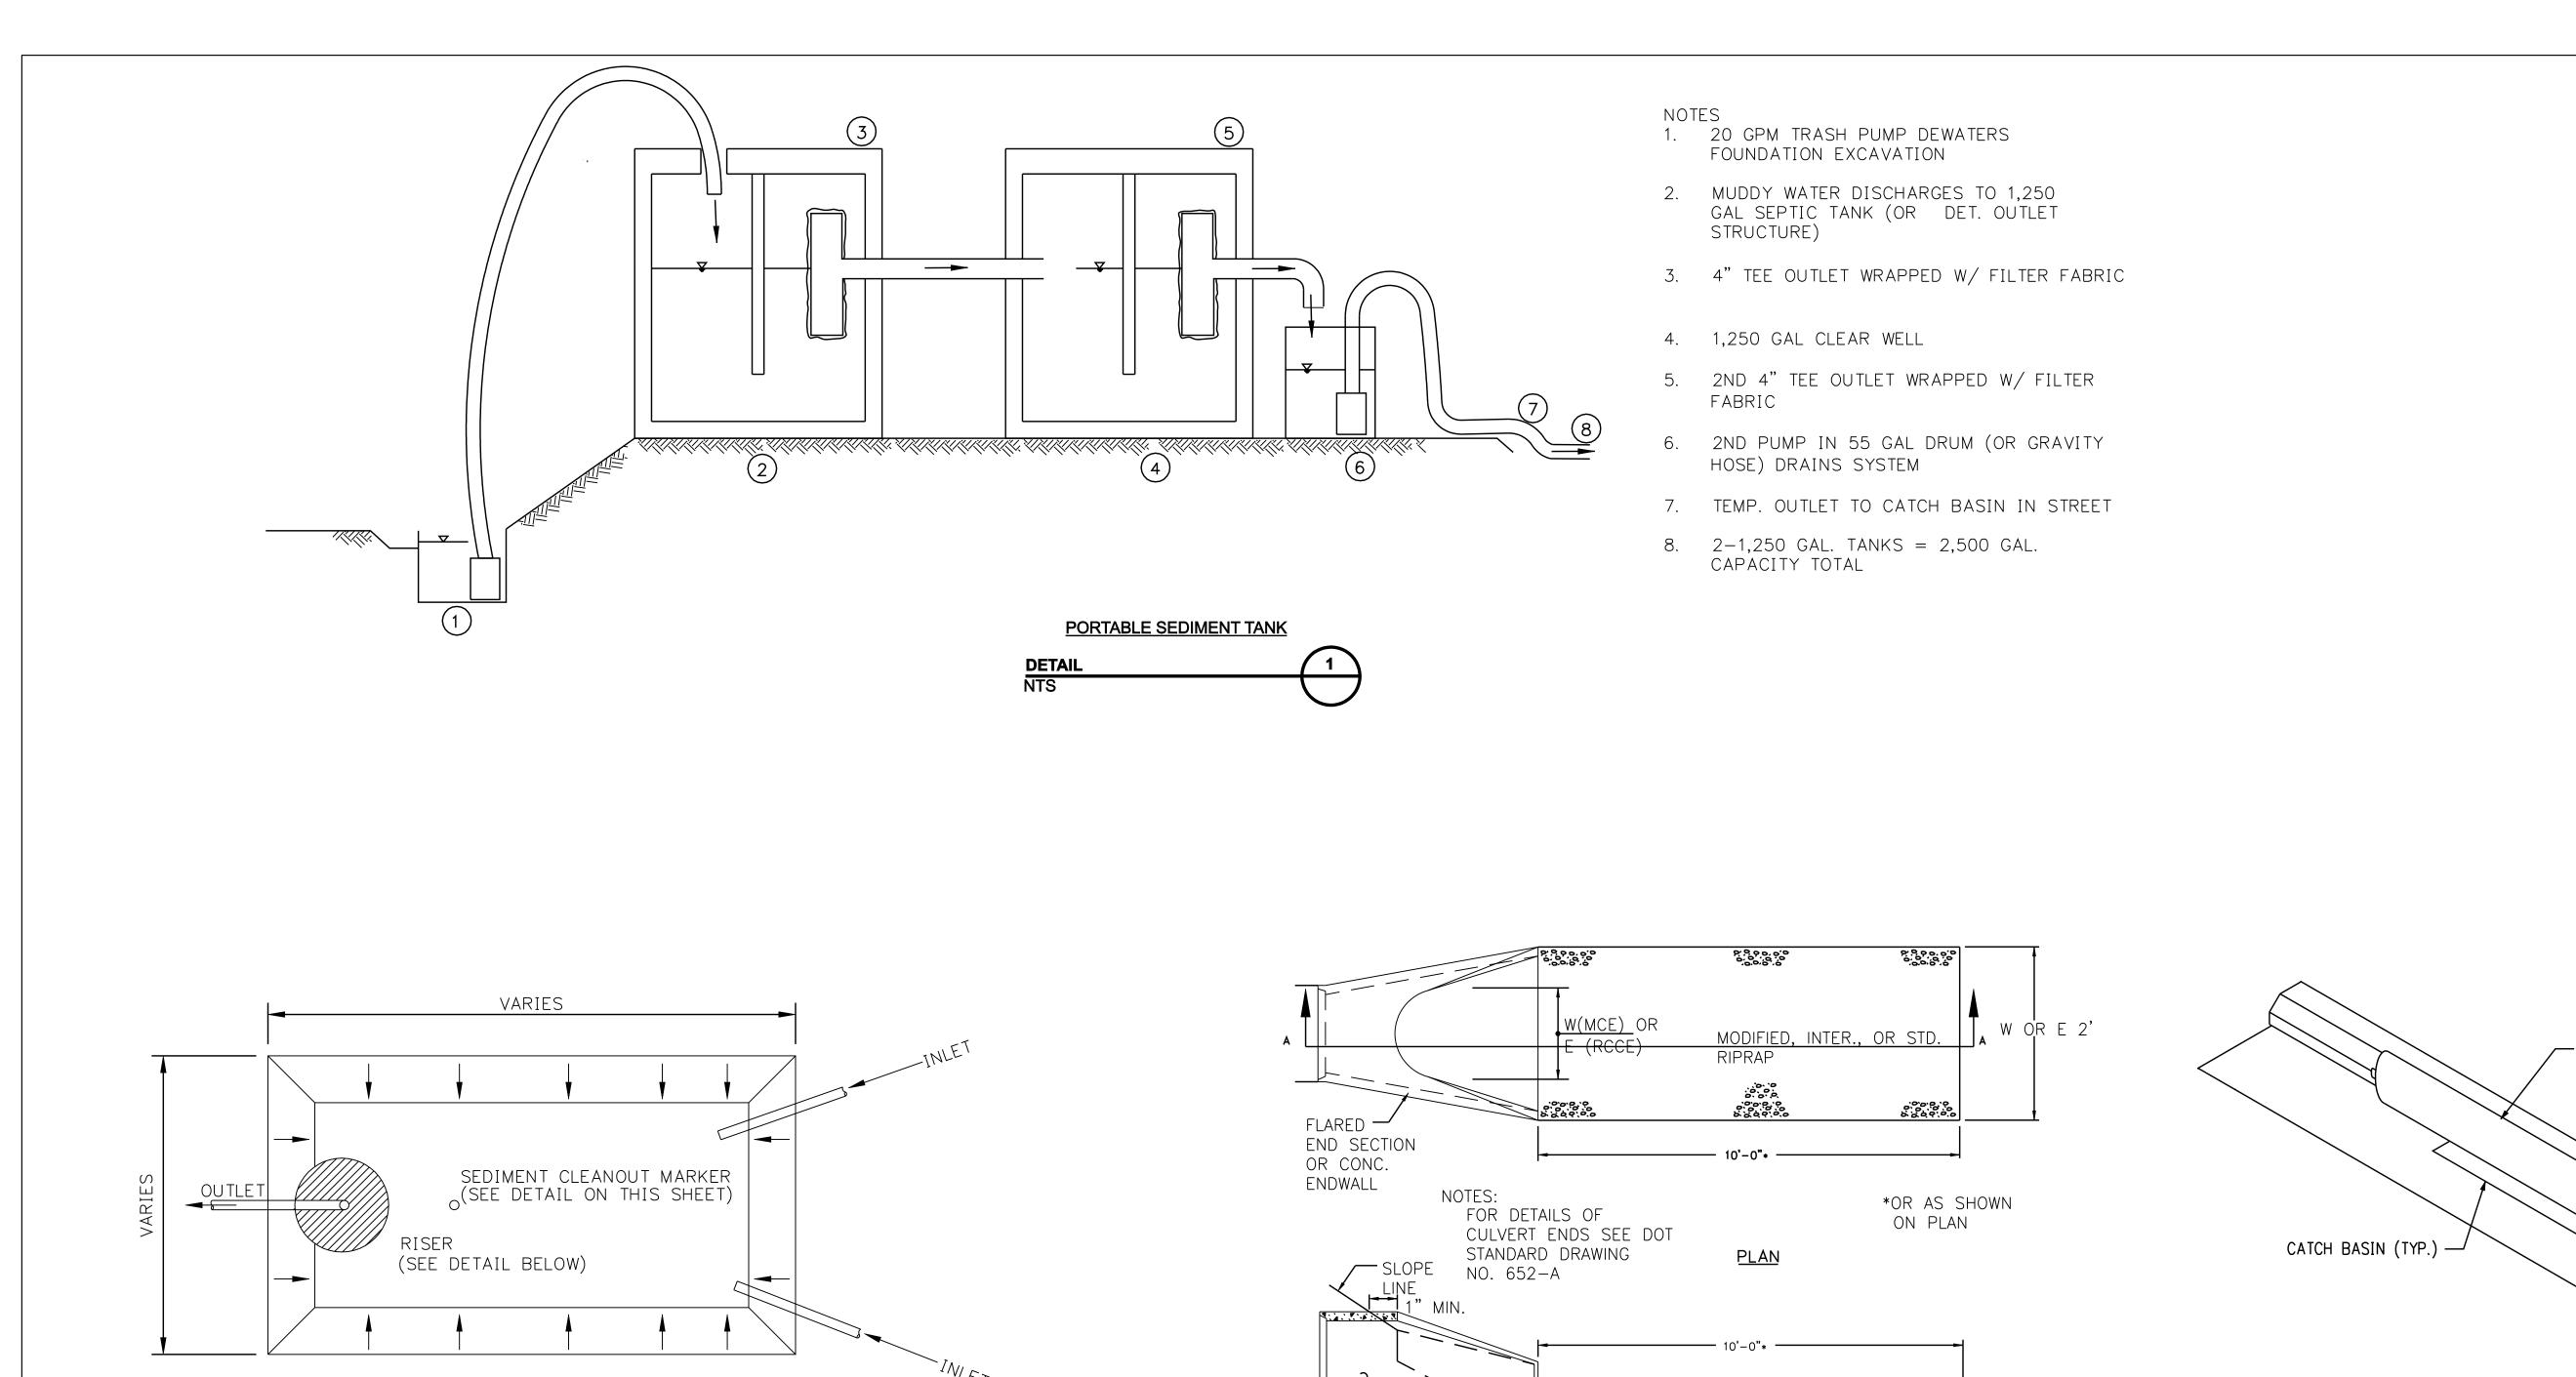

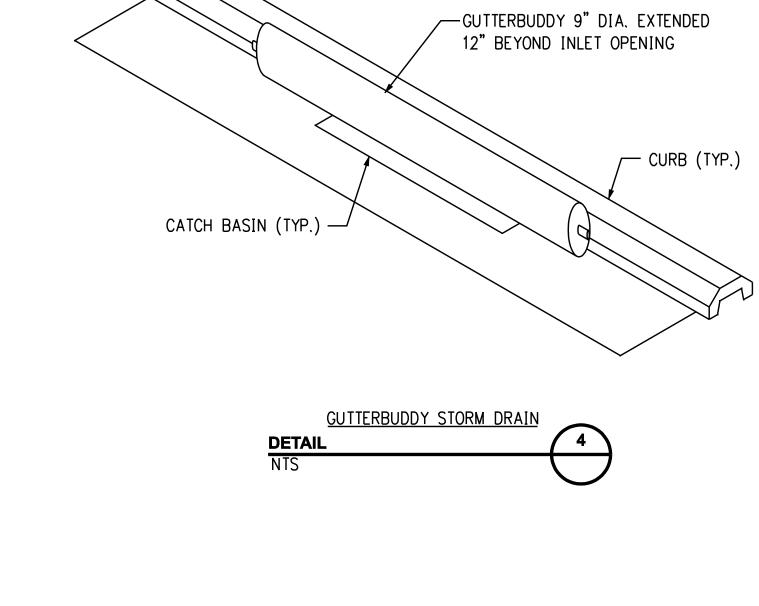

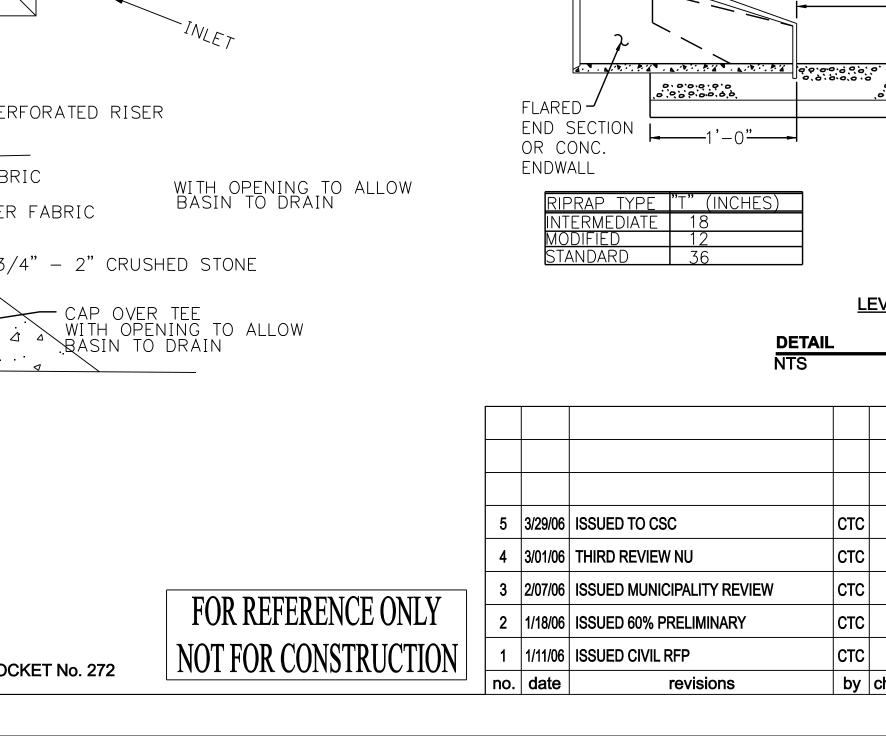

TEMP. SAFETY OR CONSTRUCTION FENCE

TO EXIST.

DRAINAGE

OR OUTFALL

EXIST. GRADE

TEMP. 6" HDPE

TEMPORARY SEDIMENT TRAP

- SLOTTED OR PERFORATED RISER

FILTER FABRIC

DOCKET No. 272

−3/4" − 2" CRUSHED STONE

FILTER FABRIC

Burns & _____ McDonnell 5 | 3/29/06 | ISSUED TO CSC SINCE 1898 СТС 4 3/01/06 THIRD REVIEW NU СТС 3 | 2/07/06 | ISSUED MUNICIPALITY REVIEW detailed СТС **BL COMPANIES** 01/11/06 2 | 1/18/06 | ISSUED 60% PRELIMINARY designed checked 1 1/11/06 ISSUED CIVIL RFP S. NEWLAND **BL COMPANIES** by chk revisions

DETAIL

LEVEL SPREADER

RIPRAP

GRAVEL FILL

12' MOD. 18" INTER.

6" MOD. & INTER —

12" STD.

SECTION A-A

36' STD,

NORTHEAST UTILITIES SERVICE CO. THE CONNECTICUT LIGHT & POWER COMPANY TITLE WALLINGFORD ENERGY - DEVON GENERATING STATION 115kV LINE EROSION CONTROL DETAILS APP BY SEN-BMCD CHKD DATE 1-18-06 DATE DATE DATE SCALE AS NOTED DWG. NO. 01149-15003 PG 002 MF NO. DATE REVISIONS BY CHK APP APP