Robinson+Cole

KENNETH C. BALDWIN

One State Street Hartford, CT 06103 Main (860) 275-8200 Fax (860) 275-8299 kbaldwin@rc.com Direct (860) 275-8345

Also admitted in Massachusetts and New York

December 30, 2024

Via Email and First-Class Mail

Melanie A. Bachman, Esq. Executive Director/Staff Attorney Connecticut Siting Council 10 Franklin Square New Britain, CT 06051

Re: Petition No. 1653 - East Point Energy, LLC – Petition for a Declaratory Ruling that a Certificate of Environmental Compatibility and Public Need is not Required for the Construction, Operation and Maintenance for a 20 MW Battery Storage System Facility and Electrical Interconnection at 1825 South Main Street in Middletown, Connecticut

Dear Attorney Bachman:

Enclosed is a supplemental list of government officials in the Town of Middlefield who received notice of the filing of the above-referenced petition, along with a sample notice letter sent to each official listed and a Certificate of Mailing for each notice letter.

Sincerely,

Kenneth C. Baldwin

Enclosure

EAST POINT ENERGY

1825 SOUTH MAIN STREET MIDDLETOWN, CT

_SUPPLEMENTAL LIST OF LOCAL GOVERNMENT OFFICIALS

MIDDLEFIELD TOWN OFFICIALS:

Robert Yamartino, First Selectman Town of Middlefield 393 Jackson Hill Road Middlefield, CT 06455

Christine Cohen State Senator – 12th District Legislative Office Building 300 Capitol Avenue, Room 3300 Hartford, CT 06106

Jan Hochadel State Senator – 13th District Legislative Office Building 300 Capitol Avenue, Room 3300 Hartford, CT 06106

Craig Fishbein
Representative – 90th District
Legislative Office Building
300 Capitol Avenue, Room 4200
Hartford, CT 06106

Tonya Hogan, Town Clerk Town of Middlefield 393 Jackson Hill Road Middlefield, CT 06455

Robin Newton Consulting Town Planner/Zoning Enforcement Officer Town of Middlefield Community Center Building 405 Main Street Middlefield, CT 06450 William Warner, Chair Planning and Zoning Commission Town of Middlefield Community Center Building 405 Main Street Middlefield, CT 06450

Rebecca Adams, Chair Inland Wetlands Commission Town of Middlefield Community Center Building 405 Main Street Middlefield, CT 06450

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Also admitted in Massachusetts and New York

December 30, 2024

Via Certificate of Mailing

«Name_and_Address»

Re: East Point Energy, LLC –Proposed Battery Energy Storage System Facility at 1825 South Main Street, Middletown, Connecticut

Government Officials Notice Letter

Dear «Salutation»:

This letter is to inform you that East Point Energy filed a Petition for Declaratory Ruling ("Petition") with the Connecticut Siting Council ("Council") on December 20, 2024 for approval to construct, operate and maintain a 20 MW Battery Energy Storage System ("BESS") facility on the central portion of a 9.40-acre parcel at 1825 South Main Street in Middletown, Connecticut ("Property"). You are receiving this notice because the Town of Middlefield is located within 2500 feet of the proposed facility.

A full copy of the Petition will be available for review at the City Hall in Middletown. In addition, an electronic copy of the Petition is available on the Council's website at www.ct.gov/csc/. If you have any questions regarding this matter, please contact me or the Connecticut Siting Council.

Sincerely,

Kenneth C. Baldwin

Kunie gmu-

Attachment

31099278-v1


Certificate of Mailing — Firm

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5.	Robin Newton, Consulting Town Planner/Zoning Enforcement Officer	_			
	Town of Middlefield-Community Center Bldg	_			
	405 Main Street Middlefield, CT 06450				
6.		-			
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Certificate of Mailing — Firm

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USPS® Tracking Number Firm-specific Identifier	Ad (Name, Street, City,	dress State, and ZIP Code™)	Postage	Fee	Special Handling	Parcel Airlift
1.	William Warner, Chair Planning and Zoning Commission Town of Middlefield-Community Center Bld, 405 Main Street Middlefield, CT 06450	g				
2.	Rebecca Adams, Chair Inland Wetlands Commission Town of Middlefield-Community Center Bld 405 Main Street Middlefield, CT 06450	B				
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4.				DEC 3	0 2024 111	
5.				PORI	D, CT 081	
6.				-		



"LONG HILL BESS"

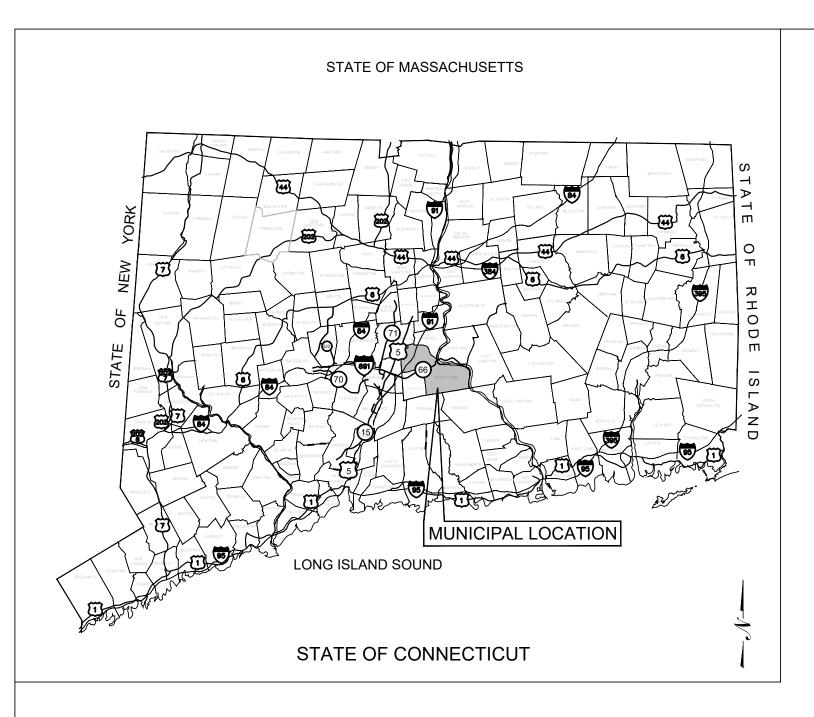EAST POINT ENERGY

1825 SOUTH MAIN STREET MIDDLETOWN, CT 06457

LIST OF DRAWINGS

T-1 TITLE SHEET

VL101 & VL102 ALTA/NSPS LAND TITLE SURVEY

GN-1 GENERAL NOTES & LEGEND

OP-1 OVERALL SITE PLAN

EC-1 EROSION & SEDIMENT CONTROL PLAN

EC-2 & 3 EROSION & SEDIMENT NOTES & DETAILS

SP-1 SITE PLAN

SP-2 SITE PLAN DETAILS

TA-1 VEHICLE TURNING ANALYSIS

GD-1 GRADING & DRAINAGE PLAN

GD-2 GRADING & DRAINAGE DETAILS

SITE INFORMATION

SITE NAME: "LONG HILL BESS"

LOCATION: 1825 SOUTH MAIN STREET

SITE TYPE/DESCRIPTION: ENERGY STORAGE SYSTEM 20 MW

PROPERTY OWNER: SBA PROPERTIES INC.

8051 CONGRESS AVE. BOCA RATON, FL 33487

APPLICANT: EAST POINT ENERGY

310 4TH STREET N.E., 3RD FLOOR CHARLOTTESVILLE, VA 22902

ENGINEER CONTACT: THOMAS E. LITTLE, P.E.


(860) 552-2046

LATITUDE: N 41° 30' 43.16" LONGITUDE: W 72° 40' 14.81"

> MBLU: 17-3 ZONE: R-30

TOTAL SITE ACREAGE: 9.4± AC. TOTAL DISTURBED AREA: 1.99± AC.

APPROX. VOLUME OF CUT: 3,114± CY APPROX. VOLUME OF FILL: 1,603± CY APPROX. NET VOLUME: 1,511± CY OF CUT

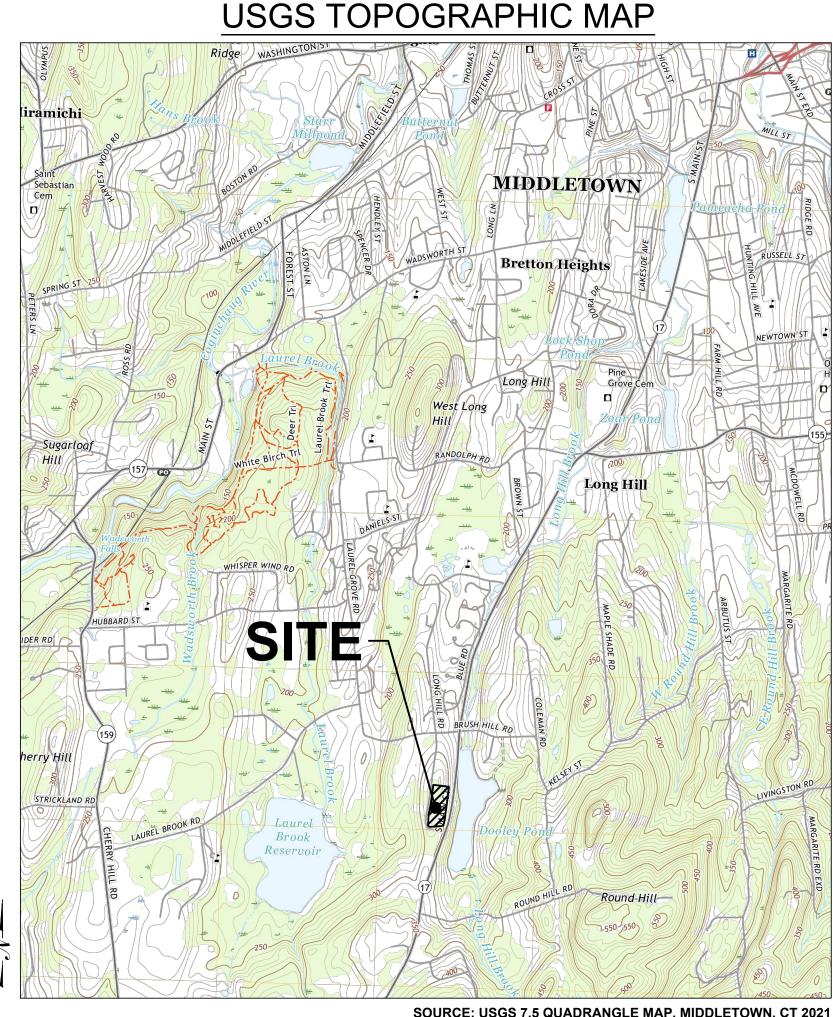

SOURCE: USGS 7.5 QUADRANGLE MAP, MIDDLETOWN, CT 2021

EAST POINT ENERGY AN EQUINOR COMPANY

310 4TH STREET NE - 3RD FLOOR CHARLOTTESVILLE, VA 22902



567 VAUXHALL STREET EXTENSION - SUITE 311 WATERFORD, CT 06385 PHONE: (860)-663-1697 WWW.ALLPOINTSTECH.COM FAX: (860)-663-0935

NO DATE REVISION 1 12/10/24 CLIENT REQUEST:UKA

DESIGN PROFESSIONALS OF RECORD

PROF: THOMAS E. LITTLE, P.E. COMP: ALL-POINTS TECHNOLOGY CORPORATION, P.C. ADD: 567 VAUXHALL STREET **EXTENSION - SUITE 311** WATERFORD, CT 06385

OWNER: SBA PROPERTIES INC.

ADDRESS: 8051 CONGRESS AVE. **BOCA RATON, FL 33487**

LONG HILL BESS

SITE ADDRESS:

1825 SOUTH MAIN STREET MIDDLETOWN, CT 06457


APT FILING NUMBER: CT720110

DRAWN BY: UKA/ELZ DATE: 10/23/24 CHECKED BY: TEL

SHEET TITLE:

TITLE SHEET

T-1

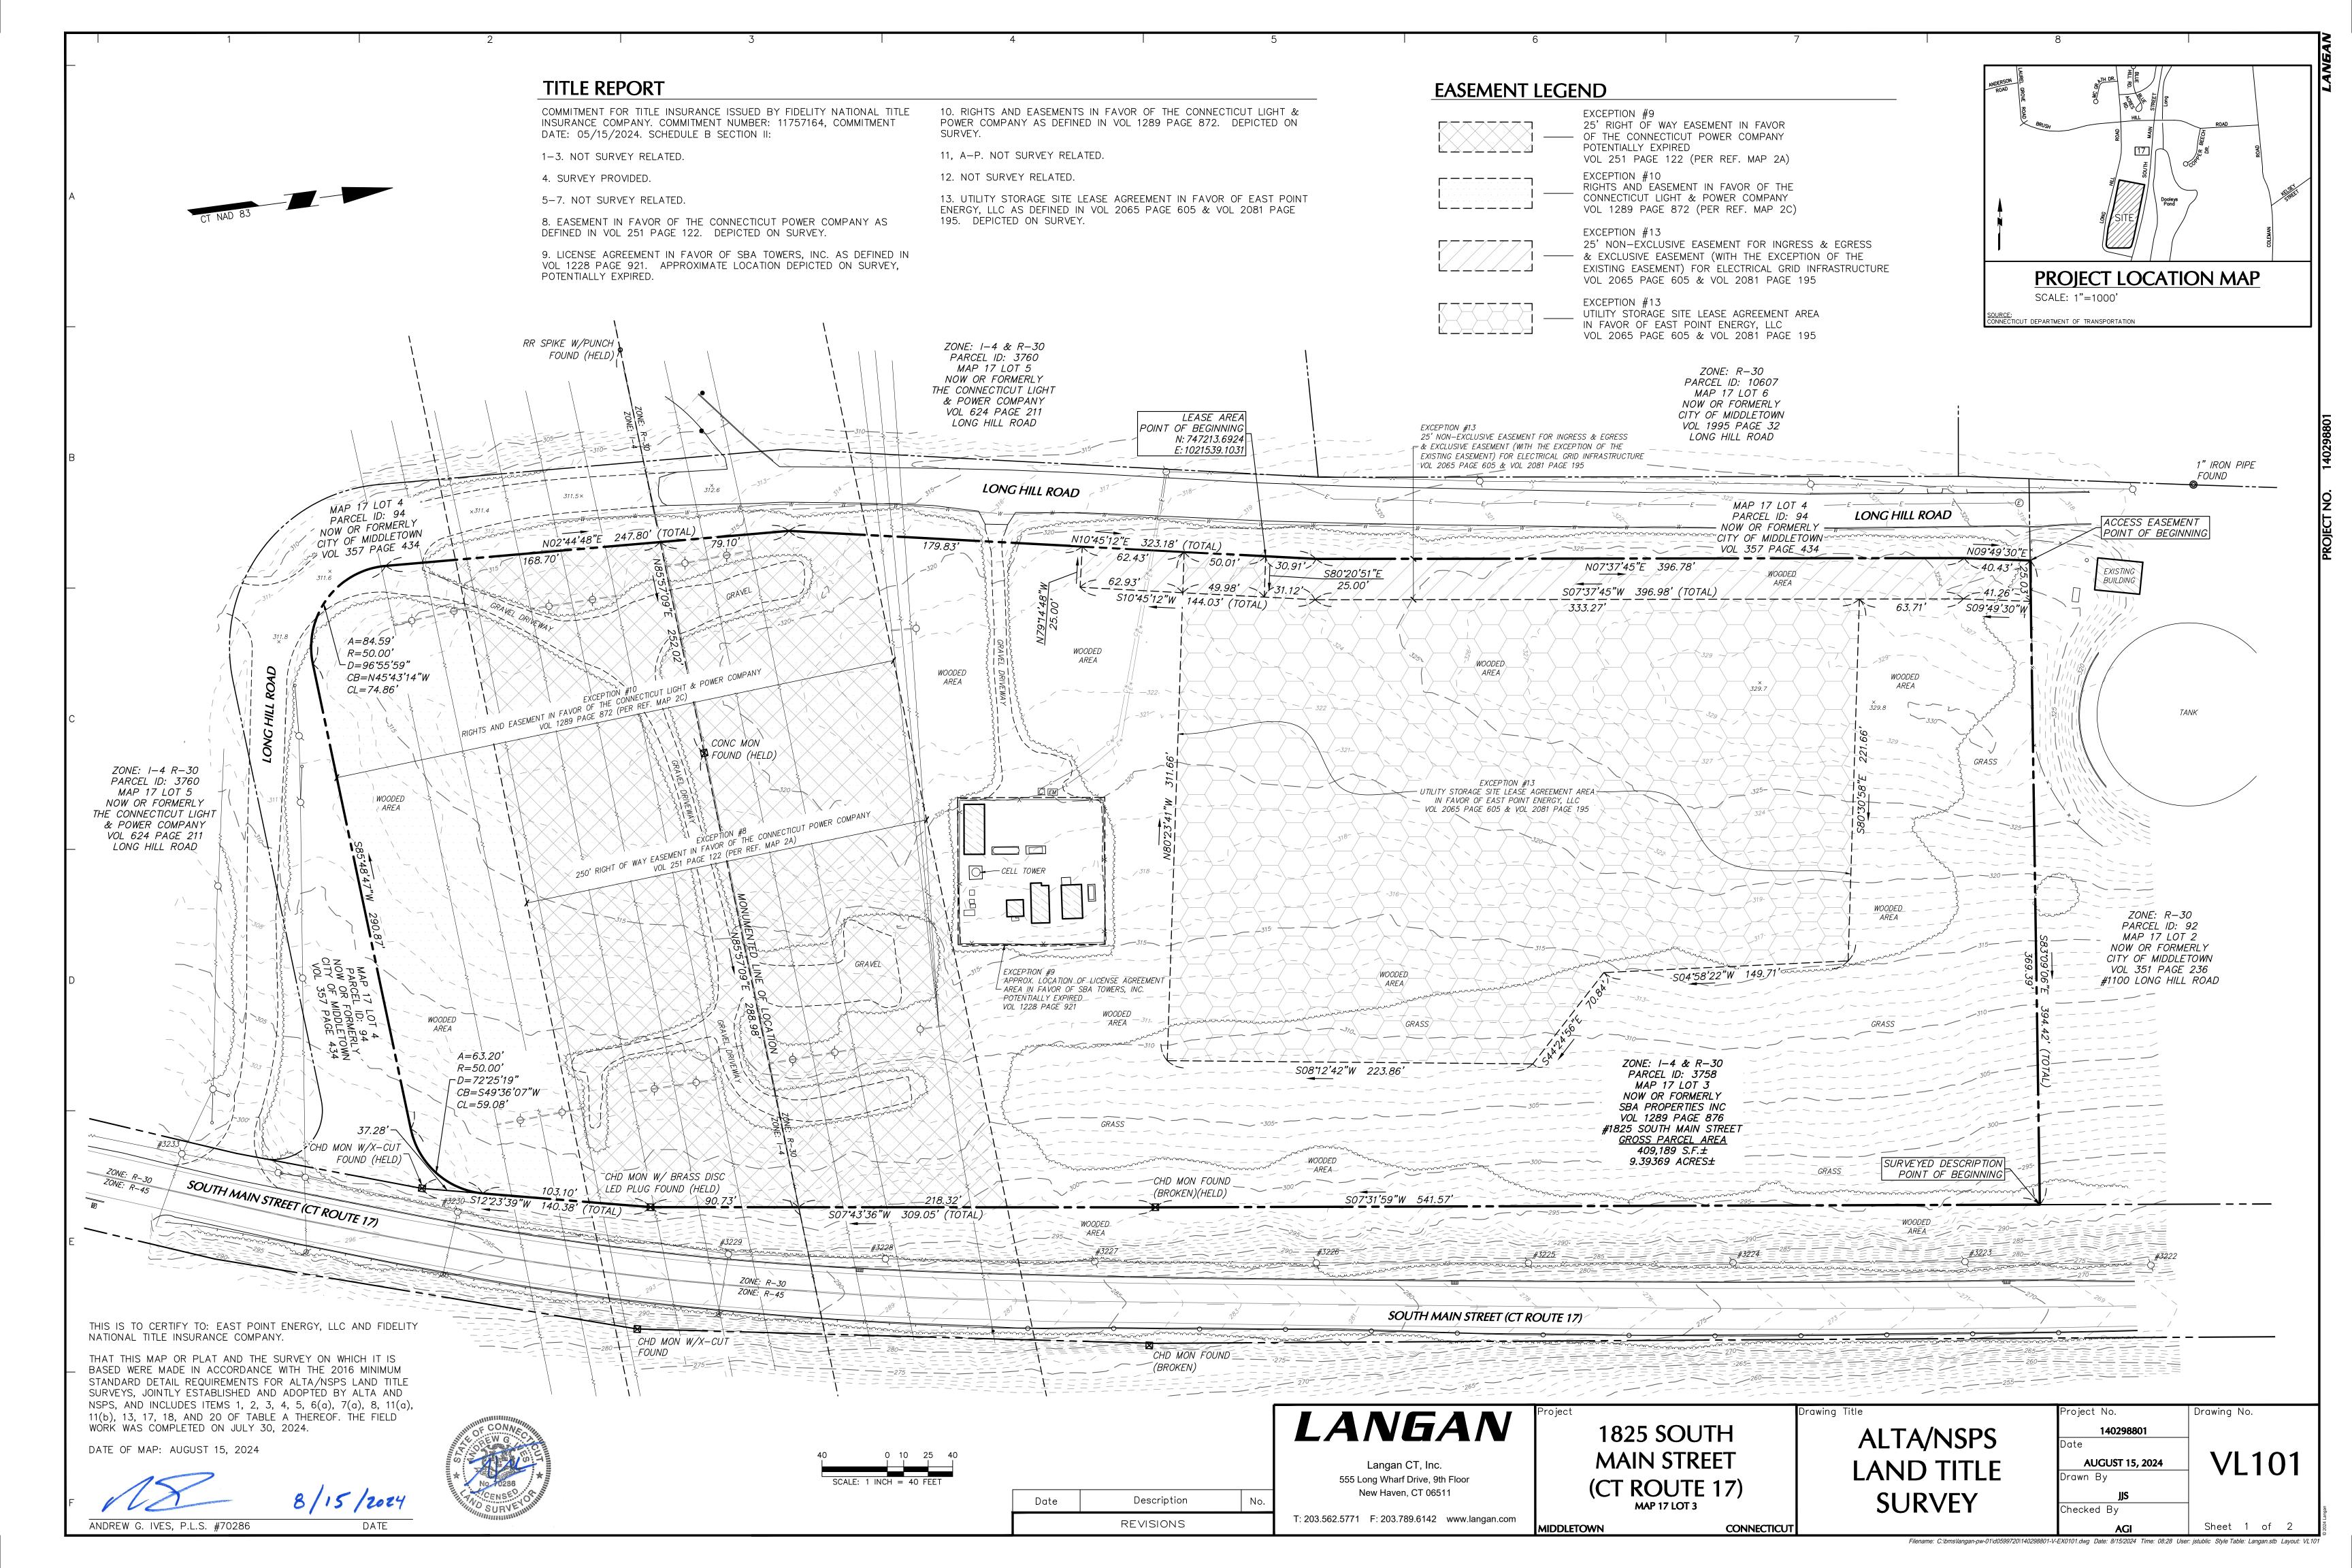

---- GAS VALVE

---- TRAFFIC SIGNAL BOX ----- UNDERGROUND VAULT ---- VALVE UNKNOWN ---- WATER METER ----- WATER VALVE ----- SPOT ELEVATION ---- BITUMINOUS ---- CONCRETE

> ---- CONCRETE PAD ----- LANDSCAPED AREA ----- BUILDING OVERHANG ---- BOTTOM OF WALL ---- EDGE OF PAVEMENT ----- EDGE OF GRAVEL ---- EDGE OF WALK ---- DETECTABLE WARNING

---- BITUMINOUS CURB

---- CONCRETE CURB

---- GRANITE CURB ----- SLOPED GRANITE CURB ---- SINGLE WHITE STRIPE ---- BROKEN WHITE STRIPE SYS —— SINGLE YELLOW STRIPE DYS DOUBLE YELLOW STRIPE

_____ WOOD GUARD RAIL ----- STOCKADE FENCE IRON FENCE ----- TREE LINE

---- OVERHEAD WIRE ---- EASEMENT LINE ----- PROPERTY LINE - - - 322 - - - CONTOUR LINE ---- DRAINAGE MARK OUT LINE

----- ELECTRIC MARK OUT LINE ---- COMMUNICATION MARK OUT LINE ---- GAS MARK OUT LINE

AS NOTED) — PLOTTED FROM EXISTING MAPPING

THIS IS TO CERTIFY TO: EAST POINT ENERGY, LLC AND FIDELITY NATIONAL TITLE INSURANCE COMPANY.

THAT THIS MAP OR PLAT AND THE SURVEY ON WHICH IT IS BASED WERE MADE IN ACCORDANCE WITH THE 2016 MINIMUM STANDARD DETAIL REQUIREMENTS FOR ALTA/NSPS LAND TITLE SURVEYS, JOINTLY ESTABLISHED AND ADOPTED BY ALTA AND NSPS, AND INCLUDES ITEMS 1, 2, 3, 4, 5, 6(a), 7(a), 8, 11(a), 11(b), 13, 17, 18, AND 20 OF TABLE A THEREOF. THE FIELD WORK WAS COMPLETED ON JULY 30, 2024.

DATE OF MAP: AUGUST 15, 2024

ANDREW G. IVES, P.L.S. #70286

DATE

NOTES

1. THIS SURVEY HAS BEEN PREPARED PURSUANT TO THE REGULATIONS OF CONNECTICUT STATE AGENCIES SECTIONS 20-300b-1 THROUGH 20-300b-20 AND THE "STANDARDS FOR SURVEYS AND MAPS IN THE STATE OF CONNECTICUT" AS ADOPTED BY THE CONNECTICUT ASSOCIATION OF LAND SURVEYORS, INC. ON SEPTEMBER 26, 1996. a. THIS SURVEY IS A PROPERTY SURVEY CONFORMING TO A HORIZONTAL ACCURACY OF A-2 AND A TOPOGRAPHIC SURVEY CONFORMING TO A T-2 ACCURACY. THE BOUNDARY DETERMINATION IS A RESURVEY. THE PURPOSE OF THIS SURVEY IS TO PROVIDE A BOUNDARY OPINION AND DEPICT SITE FEATURES FOR FUTURE SITE DEVELOPMENT.

2. THIS SURVEY IS BASED UPON EXISTING PHYSICAL CONDITIONS FOUND AT THE SUBJECT SITE, DEED INFORMATION AND THE FOLLOWING

A. MAP TITLED "THE CONNECTICUT POWER CO. MAP SHOWING RIGHT OF WAY ACROSS PROPERTY OF STEPHEN WICHROWSKI & ALPHONSE F. WICHROWSKI TOWN OF MIDDLETOWN, CONNECTICUT", SCALE: 1"=100', DATED: FEB., 1953, MAP #1492

B. MAP TITLED "LAND TO BE PURCHASED FROM STEPHEN WICHROWSKI AND ALPHONSE F. WICHROWSKI MIDDLETOWN, CONN.", THE HARTFORD ELECTRIC LIGHT CO., SCALE: 1"=60', DATED: 9-17-65, NO. F253A30, MAP #2824

C. MAP TITLED "COMPILATION PLAN SHOWING LAND TO BE CONVEYED TO SBA, INC. RESERVING EASEMENT MIDDLETOWN, CONNECTICUT", SCALE: 1"=100', DATED: 4-17-00, DWG NO. 21941, BY: ELLIOTT F. FULLER, JR., MAP #83-01

D. MAP TITLED "CONNECTICUT STATE HIGHWAY DEPARTMENT RIGHT OF WAY MAP TOWN OF MIDDLETOWN, MIDDLETOWN-NEW HAVEN ROAD FROM BRAZOS ICE HOUSE SOUTHERLY ABOUT 6,500 FEET. ROUTE NO 112", SCALE: 1"=40', DATED: MAY 10, 1927, LAST REVISED: JAN. 31, 1957, NUMBER 37, SHEET NO. 2 & 3 OF 3

3. THE MERIDIAN OF THIS SURVEY IS REFERENCED TO CONNECTICUT STATE PLANE COORDINATE SYSTEM NAD 83 (EPOCH 2011). POSITION WAS DETERMINED BY GLOBAL NAVIGATION SATELLITE SYSTEMS (GNSS) AS PROVIDED BY HXGN SMARTNET CONTINUOUSLY OPERATED REFERENCE STATIONS (CORS).

4. ELEVATIONS SHOWN ARE REFERENCED TO NORTH AMERICAN VERTICAL DATUM OF 1988 (NAVD88) (GEOID 18) AS DETERMINED BY

5. PLANIMETRIC AND TOPOGRAPHIC INFORMATION SHOWN HEREON HAS BEEN OBTAINED FROM GROUND SURVEYS BY LANGAN CT, INC. FIELD WORK COMPLETED DURING THE MONTH OF JULY 2024.

6. AS PER THE NATIONAL FLOOD INSURANCE PROGRAM FIRM MAP ENTITLED "MIDDLESEX COUNTY, CONNECTICUT PANEL 118 OF 450, MAP NUMBER 09007C0118G, EFFECTIVE DATE AUGUST 28, 2008" THE PROJECT AREA IS IN ZONE X (UNSHADED).

7. UNLESS SPECIFICALLY NOTED HEREON, STORM AND SANITARY SEWER INFORMATION (INCLUDING PIPE INVERT, PIPE MATERIAL, AND PIPE SIZE) WAS OBSERVED AND MEASURED AT FIELD LOCATED STRUCTURES (MANHOLES/CATCH BASINS, ETC). CONDITIONS CAN VARY FROM THOSE ENCOUNTERED AT THE TIMES WHEN AND LOCATIONS WHERE DATA IS OBTAINED. DESPITE MEETING THE REQUIRED STANDARD OF CARE, THE SURVEYOR CANNOT, AND DOES NOT WARRANT THAT PIPE MATERIAL AND/OR PIPE SIZE THROUGHOUT THE PIPE RUN ARE THE SAME AS THOSE OBSERVED. AT EACH STRUCTURE, OR THAT THE PIPE RUN IS STRAIGHT BETWEEN THE LOCATED STRUCTURES.

8. ADDITIONAL UTILITY (WATER, GAS, ELECTRIC ETC.) DATA MAY BE SHOWN FROM FIELD LOCATED SURFACE MARKINGS (BY OTHERS), EXISTING STRUCTURES, AND/OR FROM EXISTING DRAWINGS.

9. UNLESS SPECIFICALLY NOTED HEREON, THE SURVEYOR HAS NOT EXCAVATED TO PHYSICALLY LOCATE THE UNDERGROUND UTILITIES. THE SURVEYOR MAKES NO GUARANTEES THAT THE SHOWN UNDERGROUND UTILITIES ARE EITHER IN SERVICE, ABANDONED OR SUITABLE FOR USE, NOR ARE IN THE EXACT LOCATION OR CONFIGURATION INDICATED HEREON.

10. ALL BUILDINGS AND STRUCTURES WERE LOCATED AND MEASURED AT GROUND LEVEL. THE SURVEYOR MAKES NO DETERMINATIONS OR GUARANTEES AS TO THE ABSENCE, EXISTENCE OR LOCATION OF UNDERGROUND STRUCTURES, FOUNDATIONS, FOOTINGS, PROJECTIONS, WALLS, TANKS, SEPTIC SYSTEMS, ETC. NO TEST PITS, EXCAVATIONS OR GROUND PENETRATING RADAR WERE PERFORMED AS PART OF THIS SURVEY.

11. NO EVIDENCE OF STREET RIGHT OF WAY LINE CHANGES OR OBSERVED EVIDENCE OF RECENT STREET OR SIDEWALK CONSTRUCTION OR REPAIRS WAS OBSERVED.

12. THE PREMISES DESCRIBED IN THE SURVEYED DESCRIPTION IS SUBSTANTIALLY THE AS DESCRIBED IN THE RECORD DESCRIPTION AS SHOWN IN THE COMMITMENT FOR TITLE INSURANCE ISSUED BY FIDELITY NATIONAL TITLE INSURANCE COMPANY. COMMITMENT NUMBER: 11757164, COMMITMENT DATE: 05/15/2024.

13. THE SUBJECT PARCEL HAS DIRECT VEHICULAR AND PEDESTRIAN ACCESS TO LONG HILL ROAD AND THE LEASE AREA HAS INDIRECT ACCESS TO LONG HILL ROAD VIA ACCESS EASEMENT. LEASE AREA AND ACCESS EASEMENT ARE DEPICTED ON SURVEY AND RECORDED IN VOL 2065 PAGE 605 & VOL 2081 PAGE 195.

14. PRIOR TO ANY DESIGN OR CONSTRUCTION, THE PROPER UTILITY AGENCIES MUST BE CONTACTED FOR VERIFICATION OF UTILITY TYPE AND FOR FIELD LOCATIONS.

15. THIS SURVEY IS NOT VALID WITHOUT THE EMBOSSED OR INKED SEAL OF THE PROFESSIONAL.

RECORD DESCRIPTION

ALL THAT CERTAIN PIECE OR PARCEL OF LAND, SITUATED IN THE TOWN OF MIDDLETOWN, COUNTY OF MIDDLESEX, STATE OF CONNECTICUT, LOCATED NORTHERLY AND EASTERLY OF LONG HILL ROAD AND WESTERLY OF SOUTH MAIN STREET (AKA CONNECTICUT ROUTE 17). SAID PARCEL OF LAND BEING MORE PARTICULARLY BOUNDED AND DESCRIBED AS FOLLOWS:

NORTHERLY: BY LAND NOW OR FORMERLY OF THE CITY OF MIDDLETOWN; EASTERLY: BY SOUTH MAIN STREET (AKA CONNECTICUT ROUTE 17); AND SOUTHERLY AND WESTERLY: BY LONG HILL ROAD.

SURVEYED DESCRIPTION

BEGINNING AT A POINT ON THE WESTERLY SIDE OF SOUTH MAIN STREET (CT ROUTE 17), SAID POINT BEING THE SOUTHEASTERLY CORNER OF LAND NOW OR FORMERLY OF CITY OF MIDDLETOWN AND ALSO BEING THE NORTHEASTERLY CORNER OF HEREIN DESCRIBED PARCEL;

THENCE SOUTH 07°31'59" WEST ALONG SAID WESTERLY SIDE OF SOUTH MAIN STREET (CT ROUTE 17) A DISTANCE OF 541.57' TO A POINT MARKED BY A CHD MONUMENT FOUND (BROKEN) (HELD);

THENCE SOUTH 07°43'36" WEST ALONG THE WESTERLY SIDE OF SOUTH MAIN STREET (CT ROUTE 17) A DISTANCE OF 309.05' TO A POINT MARKED BY A CHD MONUMENT WITH BRASS DISC LED PLUG FOUND

THENCE SOUTH 12°23'39" WEST ALONG THE WESTERLY SIDE OF SOUTH MAIN STREET (CT ROUTE 17) A DISTANCE OF 103.10' TO A POINT OF CURVATURE;

THENCE ALONG A CURVE BOUNDED SOUTHWESTERLY BY LAND NOW OR FORMERLY OF CITY OF MIDDLETOWN (ALSO KNOWN AS LONG HILL ROAD), CURVING TO THE RIGHT, WITH AN ARC LENGTH OF 63.20', A RADIUS OF 50.00', AN INCLUDED ANGLE OF 72°25'19" AND A CHORD LENGTH OF 59.08' BEARING SOUTH 49°36'07" WEST TO A POINT OF TANGENCY;

THENCE SOUTH 85°48'47" WEST BOUNDED SOUTHERLY BY LAND NOW OR FORMERLY OF CITY OF MIDDLETOWN (ALSO KNOWN AS LONG HILL ROAD), A DISTANCE OF 290.87' TO A POINT OF CURVATURE;

THENCE ALONG A CURVE BOUNDED SOUTHWESTERLY BY LAND NOW OR FORMERLY OF CITY OF MIDDLETOWN (ALSO KNOWN AS LONG HILL ROAD), CURVING TO THE RIGHT, WITH AN ARC LENGTH OF 84.59', A RADIUS OF 50.00', AN INCLUDED ANGLE OF 96°55'59" AND A CHORD LENGTH OF 74.86' BEARING NORTH 45°43'14" WEST TO A POINT OF TANGENCY;

THENCE NORTH 02°44'48" EAST BOUNDED WESTERLY BY LAND NOW OR FORMERLY OF CITY OF MIDDLETOWN (ALSO KNOWN AS LONG HILL ROAD) A DISTANCE OF 247.80' TO A POINT;

THENCE NORTH 10°45'12" EAST BOUNDED WESTERLY BY LAND NOW OR FORMERLY OF CITY OF MIDDLETOWN (ALSO KNOWN AS LONG HILL ROAD), A DISTANCE OF 323.18' TO A POINT;

THENCE NORTH 07°37'45" EAST BOUNDED WESTERLY BY LAND NOW OR FORMERLY OF CITY OF MIDDLETOWN (ALSO KNOWN AS LONG HILL ROAD), A DISTANCE OF 396.78' TO A POINT;

THENCE NORTH 09°49'30" EAST BOUNDED WESTERLY BY LAND NOW OR FORMERLY OF CITY OF MIDDLETOWN (ALSO KNOWN AS LONG HILL ROAD), A DISTANCE OF 40.43' TO A POINT;

THENCE SOUTH 83°09'06" EAST BOUNDED NORTHERLY BY LAND NOW OR FORMERLY OF CITY OF MIDDLETOWN, A DISTANCE OF 394.42' TO THE POINT OF BEGINNING;

CONTAINING APPROXIMATELY 409,189 SQUARE FEET (9.39369 ACRES).

ACCESS EASEMENT DESCRIPTION

BEGINNING AT A POINT BOUNDED WESTERLY BY LAND NOW OR FORMERLY OF CITY OF MIDDLETOWN (ALSO KNOWN AS LONG HILL ROAD) AND BOUNDED NORTHERLY BY LAND NOW OR FORMERLY OF CITY OF MIDDLETOWN, ALSO BEING THE NORTHWESTERLY CORNER OF HEREIN DESCRIBED ACCESS EASEMENT;

THENCE SOUTH 8309'06" EAST BOUNDED NORTHERLY BY LAND NOW OR FORMERLY OF CITY OF MIDDLETOWN, A DISTANCE OF 25.03' TO A POINT;

THENCE SOUTH 09°49'30" WEST THROUGH LAND NOW OR FORMERLY OF SBA PROPERTIES INC A DISTANCE OF 41.26; TO A POINT;

THENCE SOUTH 07°37'45" WEST THROUGH LAND NOW OR FORMERLY OF SBA PROPERTIES INC A DISTANCE OF 396.98' TO A POINT;

SBA PROPERTIES INC A DISTANCE OF 144.03' TO A POINT; THENCE NORTH 79°14'48" WEST THROUGH LAND NOW OR FORMERLY OF SBA PROPERTIES INC A DISTANCE OF 25.00' TO A POINT BOUNDED

WESTERLY BY LAND NOW OR FORMERLY OF CITY OF MIDDLETOWN (ALSO

THENCE SOUTH 10°45'12" WEST THROUGH LAND NOW OR FORMERLY OF

THENCE NORTH 10°45'12" EAST BOUNDED WESTERLY BY LAND NOW OR FORMERLY OF CITY OF MIDDLETOWN (ALSO KNOWN AS LONG HILL ROAD) A DISTANCE OF 143.35' TO A POINT;

THENCE NORTH 07°37'45" EAST BOUNDED WESTERLY BY LAND NOW OR FORMERLY OF CITY OF MIDDLETOWN (ALSO KNOWN AS LONG HILL ROAD) A DISTANCE OF 396.78' TO A POINT;

THENCE NORTH 09°49'30" EAST BOUNDED WESTERLY BY LAND NOW OR FORMERLY OF CITY OF MIDDLETOWN (ALSO KNOWN AS LONG HILL ROAD) A DISTANCE OF 40.43' TO THE POINT OF BEGINNING;

CONTAINING APPROXIMATELY 14,535 SQUARE FEET (0.33368 ACRES).

LEASE AREA DESCRIPTION

KNOWN AS LONG HILL ROAD);

BEGINNING AT A POINT BOUNDED WESTERLY BY LAND NOW OR FORMERLY OF CITY OF MIDDLETOWN (ALSO KNOWN AS LONG HILL ROAD), SAID POINT BEING COORDINATE N: 747213.6924, E: 1021539.1031:

THENCE SOUTH 80°20'51" EAST THROUGH LAND NOW OR FORMERLY OF SBA PROPERTIES INC A DISTANCE OF 25.00' TO A POINT;

THENCE NORTH 10°45'12" EAST THROUGH LAND NOW OR FORMERLY OF SBA PROPERTIES INC A DISTANCE OF 31.12' TO A POINT;

THENCE NORTH 07°37'45" EAST THROUGH LAND NOW OR FORMERLY OF SBA PROPERTIES INC A DISTANCE OF 333.27' TO A POINT;

THENCE SOUTH 80°30'58" EAST THROUGH LAND NOW OR FORMERLY OF SBA PROPERTIES INC A DISTANCE OF 221.66' TO A POINT:

THENCE SOUTH 04°58'22" WEST THROUGH LAND NOW OR FORMERLY OF

SBA PROPERTIES INC A DISTANCE OF 149.71' TO A POINT;

THENCE SOUTH 44°24'56" EAST THROUGH LAND NOW OR FORMERLY OF SBA PROPERTIES INC A DISTANCE OF 70.84' TO A POINT;

THENCE SOUTH 08°12'42" WEST THROUGH LAND NOW OR FORMERLY OF SBA PROPERTIES INC A DISTANCE OF 223.86' TO A POINT;

THENCE NORTH 80°23'41" WEST THROUGH LAND NOW OR FORMERLY OF SBA PROPERTIES INC A DISTANCE OF 311.66' TO A POINT BOUNDED WESTERLY BY LAND NOW OR FORMERLY OF CITY OF MIDDLETOWN (ALSO KNOWN AS LONG HILL ROAD);

THENCE NORTH 10°45'12" EAST BOUNDED WESTERLY BY LAND NOW OR FORMERLY OF CITY OF MIDDLETOWN (ALSO KNOWN AS LONG HILL ROAD) A DISTANCE OF 50.01' TO THE POINT OF BEGINNING;

CONTAINING APPROXIMATELY 109,065 SQUARE FEET (2.50379 ACRES).

17 Dooleys Pond

PROJECT LOCATION MAP

SCALE: 1"=1000'

LANGAN

Langan CT, Inc. 555 Long Wharf Drive, 9th Floor New Haven, CT 06511

T: 203.562.5771 F: 203.789.6142 www.langan.com

1825 SOUTH MAIN STREET (CT ROUTE 17) MAP 17 LOT 3

ALTA/NSPS LAND TITLE **SURVEY**

roject No. 140298801 **AUGUST 15, 2024** Drawn By Checked By

VL102

MIDDLETOWN

REVISIONS

Description

Date

CONNECTICUT

rawing Title

Sheet 2 of 2 Filename: C:\bms\langan-pw-01\d0599720\140298801-V-EX0101.dwg Date: 8/15/2024 Time: 08:28 User: jstublic Style Table: Langan.stb Layout: VL102

Drawing No.

GENERAL NOTES

- . ALL CONSTRUCTION SHALL COMPLY WITH PROJECT DEVELOPER STANDARDS, CITY OF MIDDLETOWN STANDARDS, CONNECTICUT DEPARTMENT OF TRANSPORTATION STANDARDS AND SPECIFICATIONS IN THE ABOVE REFERENCED INCREASING HIERARCHY. IF SPECIFICATIONS ARE IN CONFLICT, THE MORE STRINGENT SPECIFICATION SHALL APPLY.
- 2. IF NO PROJECT CONSTRUCTION SPECIFICATION PACKAGE IS PROVIDED BY THE PROJECT DEVELOPER OR THEIR REPRESENTATIVE, THE CONTRACTOR SHALL COMPLY WITH THE MANUFACTURER, CITY OF MIDDLETOWN, OR CONNECTICUT DEPARTMENT OF TRANSPORTATION STANDARD SPECIFICATIONS, AND BE IN ACCORDANCE WITH ALL APPLICABLE OSHA, FEDERAL, STATE AND LOCAL REGULATIONS.
- 3. THE PROJECT DEVELOPER IS RESPONSIBLE FOR OBTAINING ALL NECESSARY ZONING AND STORMWATER PERMITS REQUIRED BY GOVERNMENT AGENCIES PRIOR TO CONSTRUCTION. THE CONTRACTOR SHALL OBTAIN ALL CITY OF MIDDLETOWN CONSTRUCTION PERMITS. THE CONTRACTOR SHALL POST ALL BONDS, PAY ALL FEES, PROVIDE PROOF OF INSURANCE AND PROVIDE TRAFFIC CONTROL NECESSARY FOR THIS WORK.
- 4. REFER TO PLANS, DETAILS AND REPORTS PREPARED BY ALL-POINTS TECHNOLOGY CORPORATION FOR ADDITIONAL INFORMATION. THE CONTRACTOR SHALL VERIFY ALL SITE CONDITIONS IN THE FIELD AND CONTACT THE PROJECT DEVELOPER IF THERE ARE ANY QUESTIONS OR CONFLICTS REGARDING THE CONSTRUCTION DOCUMENTS AND/OR FIELD CONDITIONS SO THAT APPROPRIATE REVISIONS CAN BE MADE PRIOR TO BIDDING/CONSTRUCTION. ANY CONFLICT BETWEEN THE DRAWINGS AND SPECIFICATIONS SHALL BE CONFIRMED WITH THE PROJECT DEVELOPERS CONSTRUCTION MANAGER PRIOR TO CONSTRUCTION.
- 5. THE CONTRACTOR SHALL SUBMIT SHOP DRAWINGS OF ALL PRODUCTS, MATERIALS PER PLANS, AND SPECIFICATIONS TO THE PROJECT DEVELOPER FOR REVIEW AND APPROVAL PRIOR TO FABRICATION OR DELIVERY TO THE SITE. ALLOW A MINIMUM OF 14 WORKING DAYS FOR REVIEW.
- 6. SHOULD ANY UNKNOWN OR INCORRECTLY LOCATED EXISTING PIPING OR OTHER UTILITY BE UNCOVERED DURING EXCAVATION, CONSULT THE PROJECT DEVELOPER IMMEDIATELY FOR DIRECTIONS BEFORE PROCEEDING FURTHER WITH WORK IN THIS AREA.
- 7. DO NOT INTERRUPT EXISTING UTILITIES SERVICING FACILITIES OCCUPIED AND USED BY THE PROJECT DEVELOPER OR OTHERS DURING OCCUPIED HOURS, EXCEPT WHEN SUCH INTERRUPTIONS HAVE BEEN AUTHORIZED IN WRITING BY THE PROJECT DEVELOPER AND THE LOCAL MUNICIPALITY. INTERRUPTIONS SHALL ONLY OCCUR AFTER ACCEPTABLE TEMPORARY SERVICE HAS BEEN PROVIDED.
- 8. THE CONTRACT LIMIT IS THE PROPERTY LINE UNLESS OTHERWISE SPECIFIED OR SHOWN ON THE CONTRACT DRAWINGS.
- 9. THE CONTRACTOR SHALL ABIDE BY ALL OSHA, FEDERAL, STATE AND LOCAL REGULATIONS WHEN OPERATING CRANES, BOOMS, HOISTS, ETC. IN CLOSE PROXIMITY TO OVERHEAD ELECTRIC LINES. IF CONTRACTOR MUST OPERATE EQUIPMENT CLOSE TO ELECTRIC LINES, CONTACT POWER COMPANY TO MAKE ARRANGEMENTS

FOR PROPER SAFEGUARDS. ANY UTILITY COMPANY FEES SHALL BE PAID FOR BY THE CONTRACTOR.

- 10. THE CONTRACTOR SHALL COMPLY WITH OSHA CFR 29 PART 1926 FOR EXCAVATION TRENCHING AND TRENCH PROTECTION REQUIREMENTS.
- 11. THE ENGINEER IS NOT RESPONSIBLE FOR SITE SAFETY MEASURES TO BE EMPLOYED DURING CONSTRUCTION. THE ENGINEER HAS NO CONTRACTUAL DUTY TO CONTROL THE SAFEST METHODS OR MEANS OF THE WORK, JOB SITE RESPONSIBILITIES, SUPERVISION OF PERSONNEL OR TO SUPERVISE SAFETY AND DO NOT VOLUNTARILY ASSUME ANY SUCH DUTY OR RESPONSIBILITY.
- 12. THE CONTRACTOR SHALL RESTORE ANY DRAINAGE STRUCTURE, PIPE, CONDUIT, PAVEMENT, CURBING, SIDEWALKS, LANDSCAPED AREAS OR SIGNAGE DISTURBED DURING CONSTRUCTION TO THEIR ORIGINAL CONDITION OR BETTER, AS APPROVED BY THE PROJECT DEVELOPER OR CITY OF MIDDLETOWN.
- 13. THE CONTRACTOR SHALL PROVIDE AS-BUILT RECORDS OF ALL CONSTRUCTION (INCLUDING UNDERGROUND UTILITIES) TO THE PROJECT DEVELOPER AT THE END OF CONSTRUCTION.
- 14. ALTERNATIVE METHODS AND PRODUCTS, OTHER THAN THOSE SPECIFIED, MAY BE USED IF REVIEWED AND APPROVED BY THE PROJECT DEVELOPER, ENGINEER, AND APPROPRIATE REGULATORY AGENCY <u>PRIOR</u> TO INSTALLATION DURING THE BIDDING/CONSTRUCTION PROCESS.
- 15. INFORMATION ON EXISTING UTILITIES AND STORM DRAINAGE SYSTEMS HAS BEEN COMPILED FROM AVAILABLE INFORMATION INCLUDING UTILITY PROVIDER AND MUNICIPAL RECORD MAPS AND/OR FIELD SURVEY AND IS NOT GUARANTEED CORRECT OR COMPLETE. UTILITIES AND STORM DRAINAGE SYSTEMS ARE SHOWN TO ALERT THE CONTRACTOR TO THEIR PRESENCE AND THE CONTRACTOR IS SOLELY RESPONSIBLE FOR DETERMINING ACTUAL LOCATIONS AND ELEVATIONS OF ALL UTILITIES AND STORM DRAINAGE SYSTEMS INCLUDING SERVICES. PRIOR TO DEMOLITION OR CONSTRUCTION, THE CONTRACTOR SHALL CONTACT "CALL BEFORE YOU DIG" 72 HOURS BEFORE COMMENCEMENT OF WORK AT "811" AND VERIFY ALL UTILITY AND STORM DRAINAGE SYSTEM LOCATIONS.
- 16. NO CONSTRUCTION OR DEMOLITION SHALL BEGIN UNTIL APPROVAL OF THE FINAL PLANS AND PERMITS ARE

SITE PLAN NOTES

- . THE ALTA/NSPS LAND TITLE SURVEY WAS PROVIDED BY LANGAN CT, INC. DATED AUGUST 15, 2024.
- 2. THERE ARE NO WETLANDS PRESENT ON THE PROPERTY. THIS HAS BEEN VERIFIED BY ALL-POINTS TECHNOLOGY CORPORATION, JULY 27, 2023.
- 3. THE CONTRACTOR SHALL FOLLOW THE RECOMMENDED SEQUENCE OF CONSTRUCTION NOTES PROVIDED ON THE EROSION CONTROL PLAN OR SUBMIT AN ALTERNATE PLAN FOR APPROVAL BY THE ENGINEER AND/OR PERMITTING AGENCIES PRIOR TO THE START CONSTRUCTION. ALLOW A MINIMUM OF 14 WORKING DAYS FOR REVIEW.
- 4. PROPER CONSTRUCTION PROCEDURES SHALL BE FOLLOWED ON ALL IMPROVEMENTS WITHIN THIS PARCEL SO AS TO PREVENT THE SILTING OF ANY WATERCOURSE OR BVWS IN ACCORDANCE WITH FEDERAL, STATE, AND LOCAL REGULATIONS. IN ADDITION, THE CONTRACTOR SHALL ADHERE TO THE "SEDIMENTATION EROSION CONTROL PLAN" CONTAINED HEREIN. THE CONTRACTOR SHALL BE RESPONSIBLE TO POST ALL BONDS AS REQUIRED BY GOVERNMENT AGENCIES WHICH WOULD GUARANTEE THE PROPER IMPLEMENTATION OF THE
- 5. ALL SITE WORK, MATERIALS OF CONSTRUCTION, AND CONSTRUCTION METHODS FOR EARTHWORK AND STORM DRAINAGE WORK, SHALL CONFORM TO THE SPECIFICATIONS AND DETAILS AND APPLICABLE SECTIONS OF THE PROJECT SPECIFICATIONS MANUAL. OTHERWISE THIS WORK SHALL CONFORM TO THE STATE OF CONNECTICUT DEPARTMENT OF TRANSPORTATION AND PROJECT GEOTECHNICAL REPORT IF THERE IS NO PROJECT SPECIFICATIONS MANUAL. ALL FILL MATERIAL UNDER STRUCTURES AND PAVED AREAS SHALL BE PER THE ABOVE STATED APPLICABLE SPECIFICATIONS, AND/OR PROJECT GEOTECHNICAL REPORT, AND SHALL BE PLACED IN ACCORDANCE WITH THE APPLICABLE SPECIFICATIONS UNDER THE SUPERVISION OF A QUALIFIED PROFESSIONAL ENGINEER. MATERIAL SHALL BE COMPACTED IN 8" LIFTS TO 95% OF THE MAXIMUM DRY DENSITY AS DETERMINED BY ASTM D 1557 AT 95% PERCENT OF OPTIMUM MOISTURE CONTENT.
- 6. ALL DISTURBANCE INCURRED TO PUBLIC, MUNICIPAL, COUNTY, STATE PROPERTY DUE TO CONSTRUCTION SHALL BE RESTORED TO ITS PREVIOUS CONDITION OR BETTER, TO THE SATISFACTION OF THE CITY OF MIDDLETOWN AND STATE OF CONNECTICUT.
- 7. IF IMPACTED OR CONTAMINATED SOIL IS ENCOUNTERED BY THE CONTRACTOR, THE CONTRACTOR SHALL SUSPEND EXCAVATION WORK OF IMPACTED SOIL AND NOTIFY THE PROJECT DEVELOPER AND/OR PROJECT DEVELOPER'S ENVIRONMENTAL CONSULTANT PRIOR TO PROCEEDING WITH FURTHER WORK IN THE IMPACTED SOIL LOCATION UNTIL FURTHER INSTRUCTED BY THE PROJECT DEVELOPER AND/OR PROJECT DEVELOPER'S ENVIRONMENTAL CONSULTANT.

CONSTRUCTION SEQUENCE NOTES

CONSTRUCTION ACTIVITIES ARE EXPECTED TO TAKE UP TO EIGHT MONTHS

THE GENERAL CONSTRUCTION NOTES ARE AS FOLLOWS:

1. THE SITE CONTRACTOR SHALL BE FULLY RESPONSIBLE TO CONTROL CONSTRUCTION SUCH THAT SEDIMENTATION SHALL NOT AFFECT ROADS/HIGHWAYS AND THEIR DRAINAGE SYSTEM, NEIGHBORING PROPERTIES, WETLANDS AND REGULATORY PROTECTED AREAS, WHETHER SUCH SEDIMENTATION IS CAUSED BY WATER, WIND, OR DIRECT DEPOSIT. DESIGNATED ACCESS DRIVES MUST BE USED TO THE MAXIMUM EXTENTS POSSIBLE. IT IS REQUIRED THAT THE SITE CONTRACTOR PERFORM A DAILY INSPECTION OF ALL EROSION AND SEDIMENT CONTROL MEASURES EMPLOYED AT THE SITE.

- 2. A CTDEEP-APPROVED QUALIFIED INSPECTOR SHALL BE ASSIGNED TO BE RESPONSIBLE FOR PERFORMING INSPECTIONS AND PREPARING REPORTS IN ACCORDANCE WITH SECTION 5(B)(4)(B) OF THE CONSTRUCTION GENERAL PERMIT. THESE INSPECTIONS SHALL TAKE PLACE WEEKLY, AT A MINIMUM, AND SHALL BE REQUIRED WITHIN 24 HOURS OF A RAINFALL EVENT EXCEEDING 0.5 INCHES. THE ENGINEER OF RECORD SHALL BE REQUIRED TO REVIEW AND COUNTER-SIGN THE PREPARED WEEKLY REPORTS.
- 3. ENGINEER OF RECORD WILL PERFORM MONTHLY PLAN IMPLEMENTATION INSPECTIONS UNTIL EROSION CONTROLS ARE IN PLACE, OR THE FIRST THREE MONTHS (WHICHEVER IS GREATER) AND WILL PREPARE REPORTS OF THE FINDINGS.
- I. THROUGHOUT THE COURSE OF THE CONSTRUCTION PROJECT, ADDITIONAL SEDIMENT AND EROSION CONTROL MEASURES MAY BE WARRANTED AT THE DISCRETION OF THE QUALIFIED INSPECTOR AND/OR DESIGN ENGINEER. THESE IMPROVEMENTS MUST BE IMPLEMENTED IN A TIMELY FASHION IN ACCORDANCE WITH THE REQUIREMENTS OF THE CONSTRUCTION GENERAL PERMIT.
- 5. PRIOR TO CONSTRUCTION, THE APPLICANT SHALL PROVIDE THE CITY OF MIDDLETOWN WITH THE NAME OF CONTACT AND 24-HOUR CONTACT INFORMATION.
- 6. CONTRACTOR SHALL ADHERE TO 2024 CONNECTICUT GUIDELINES FOR EROSION AND SEDIMENT CONTROL, AS AMENDED.
- 7. THE CONTRACTOR SHALL HOLD PRE-CONSTRUCTION MEETING(S). ATTENDEES SHALL INCLUDE, BUT NOT BE LIMITED TO, REPRESENTATIVES OF THE GENERAL CONTRACTOR, SITE CONTRACTOR, CTDEEP, CITY OF MIDDLETOWN, ENGINEER OF RECORD, AND QUALIFIED SWPPP INSPECTOR.
- 8. THE CONTRACTOR SHALL CONTACT CALL-BEFORE-YOU-DIG (1-800-922-4455) PRIOR TO ENGAGING IN ANY EXCAVATION ACTIVITIES AT THE SITE.
- 9. NO CONSTRUCTION OF SITE IMPROVEMENTS MAY BEGIN UNTIL THE PROPER EROSION CONTROL MEASURES SERVING THE AREA TO BE DISTURBED ARE IN PLACE.
- 10. ANTICIPATED WORK HOURS WILL BE BETWEEN 7:00 AM AND 5:00 PM MONDAY THROUGH FRIDAY. IF ANY VARIATION FROM THIS SCHEDULE IS TEMPORARILY REQUIRED, THE PROJECT TEAM SHALL PROVIDE NOTICE TO CONNECTICUT SITING COUNCIL.
- 11. HIGH FLOTATION TIRE EQUIPMENT SHALL BE USED TO THE MAXIMUM EXTENTS PRACTICABLE IN LIEU OF TRACK CONSTRUCTION EQUIPMENT IN AN EFFORT TO AVOID COMPACTION OF THE NATIVE SOILS.

PRE-CONSTRUCTION SITE PROTECTION SEQUENCE

1. SURVEY AND MARK ALL WOODLAND CLEARING LIMITS.

- 2. EXISTING AND PROPOSED ACCESS ROADS SHALL BE DESIGNATED AS EARLY AS FEASIBLE AND USED PRIMARILY FOR CONSTRUCTION TRAFFIC.
- 3. FIELD SURVEY AND MARK BOUNDARY BETWEEN CLEARING LIMITS AND GRUBBING LIMITS.
- 4. INSTALL EROSION AND SEDIMENT CONTROLS FOLLOWING THE CT GUIDELINES AND MANUFACTURER'S DIRECTIONS. DURING CONSTRUCTION, THE CONTRACTOR SHALL INSTALL MEASURES AS REQUIRED BY THE ENGINEER OF RECORD OR QUALIFIED INSPECTOR, TO PREVENT SEDIMENT-LADEN RUNOFF FROM REACHING WETLANDS OR DISCHARGING OFFSITE.
- 5. INSTALL STORMWATER BASIN AND SEDIMENT TRAP AS EARLY AS FEASIBLE IN ACCORDANCE WITH THE APPROVED SITE-SPECIFIC SWPCP AND CT GUIDELINES. DISCHARGE AREAS BELOW OUTFALLS MUST BE INSPECTED TO CONFIRM FLOW WILL BE OVER STABLE GROUND AND SHEET FLOW IS ENCOURAGED. IF DISTURBED SOILS ARE PRESENT, THE ENGINEER OF RECORD TO PROVIDE CORRECT MEASURES TO ADDRESS CONDITION.
- 6. SEED AND PROTECT DISTURBED SOILS AROUND SEDIMENT TRAPS AND BASINS WITHIN 72 HOURS OF COMPLETION.
- 7. CLEAR AND GRUB VEGETATION PER SITE PLANS.
- 8. THE USE OF A TUB GRINDER IS RECOMMENDED FOR THE MULCHING OF FELLED TREES IF CHIPPED ON SITE. MULCH SHALL NOT BE CAST WIDESPREAD ACROSS SITE AS IT WILL INHIBIT VEGETATIVE GROWTH.
- PERFORM EARTHWORK AND SHAPING ON THE SITE. TOPSOIL SHALL BE STRIPPED AND STOCKPILED FROM AREAS PROPOSED FOR REGRADING. EXCESS SOIL WHICH IS NOT REUSED IN PROPOSED SITE GRADING AS DEPICTED ON PLANS CAN BE HAULED OFF-SITE.
- 10. TOPSOIL SHALL BE REPLACED OVER REGRADED AREAS UPON COMPLETION OF MASS EARTHWORK ACTIVITIES AND AREAS WHICH WERE DISTURBED BY MASS EARTHWORK OPERATIONS SHALL BE RESEEDED WITHIN 72 HOURS OF COMPLETION.
- 11. THROUGHOUT CONSTRUCTION, THE CONTRACTOR SHALL ADDRESS ONGOING EROSION PROBLEMS USING TEMPORARY DIVERSIONS AND FILLING AND GRADING GULLIES.

CONSTRUCTION SEQUENCE

1. INSTALL STABILIZED GRAVEL ROADS.

- 2. INSTALL ELECTRICAL COMPONENTS AND INTERCONNECTION.
- 3. INSTALL SITE FENCING AND/OR SOUND WALL.
- 4. RESEED, REPAVE, AND/OR REPLANT ANY AREAS DISTURBED BY CONSTRUCTION.
- 5. AFTER SITE IS STABILIZED, AND AFTER INSPECTION BY DESIGN ENGINEER, OR OTHER OWNER'S REPRESENTATIVE, REMOVE TEMPORARY EROSION AND SEDIMENT CONTROLS. ENTIRE SITE SHALL BE CHECKED FOR AND CLEANED OF SEDIMENT AS NEEDED

UTILITY NOTES

- . CONTRACTOR IS RESPONSIBLE FOR CONTACTING THE CITY OF MIDDLETOWN TO SECURE CONSTRUCTION PERMITS AND FOR PAYMENT OF FEES FOR STREET CUTS AND CONNECTIONS TO EXISTING UTILITIES.
- 2. REFER TO DRAWINGS BY PROJECT DEVELOPER FOR THE ONSITE ELECTRICAL DRAWINGS AND INTERCONNECTION TO EXISTING ELECTRICAL GRID. SITE CONTRACTOR SHALL SUPPLY AND INSTALL PIPE ADAPTERS AS NECESSARY AT BUILDING CONNECTION POINT OR AT EXISTING UTILITY OR PIPE CONNECTION POINT. THESE DETAILS ARE NOT INCLUDED IN THESE PLANS.
- UTILITY LOCATIONS AND PENETRATIONS ARE SHOWN FOR THE CONTRACTOR'S INFORMATION AND SHALL BE VERIFIED WITH THE ELECTRICAL ENGINEER AND THE PROJECT DEVELOPER'S CONSTRUCTION MANAGER PRIOR TO THE START OF CONSTRUCTION.
- 4. THE CONTRACTOR SHALL VISIT THE SITE AND VERIFY THE ELEVATION AND LOCATION OF ALL UTILITIES BY VARIOUS MEANS PRIOR TO BEGINNING ANY EXCAVATION. TEST PITS SHALL BE DUG AT ALL LOCATIONS WHERE PROP. SANITARY SEWERS AND WHERE PROP. STORM PIPING WILL CROSS EXISTING UTILITIES, AND THE HORIZONTAL AND VERTICAL LOCATIONS OF THE UTILITIES SHALL BE DETERMINED. THE CONTRACTOR SHALL CONTACT THE PROJECT DEVELOPER IN THE EVENT OF ANY DISCOVERED OR UNFORESEEN CONFLICTS BETWEEN EXISTING AND PROPOSED SANITARY SEWERS, STORM PIPING AND UTILITIES SO THAT AN APPROPRIATE MODIFICATION MAY BE MADE.
- 5. UTILITY CONNECTION DESIGN AS REFLECTED ON THE PLAN MAY CHANGE SUBJECT TO UTILITY PROVIDER AND GOVERNING AUTHORITY STAFF REVIEW.
- 6. THE CONTRACTOR SHALL ENSURE THAT ALL UTILITY PROVIDERS AND GOVERNING AUTHORITY STANDARDS FOR MATERIALS AND CONSTRUCTION METHODS ARE MET. THE CONTRACTOR SHALL PERFORM PROPER COORDINATION WITH THE RESPECTIVE UTILITY PROVIDER.
- 7. THE CONTRACTOR SHALL ARRANGE FOR AND COORDINATE WITH THE RESPECTIVE UTILITY PROVIDERS FOR SERVICE INSTALLATIONS AND CONNECTIONS. THE CONTRACTOR SHALL COORDINATE WORK TO BE PERFORMED BY THE VARIOUS UTILITY PROVIDERS AND SHALL PAY ALL FEES FOR CONNECTIONS, DISCONNECTIONS, RELOCATIONS, INSPECTIONS, AND DEMOLITION UNLESS OTHERWISE STATED IN THE PROJECT SPECIFICATIONS MANUAL AND/OR GENERAL CONDITIONS OF THE CONTRACT.
- 8. ALL EXISTING PAVEMENT WHERE UTILITY PIPING IS TO BE INSTALLED SHALL BE SAW CUT. AFTER UTILITY INSTALLATION IS COMPLETED, THE CONTRACTOR SHALL INSTALL TEMPORARY AND/OR PERMANENT PAVEMENT REPAIR AS DETAILED ON THE DRAWINGS OR AS REQUIRED BY THE CITY OF MIDDLETOWN.
- 9. ALL PIPES SHALL BE LAID ON STRAIGHT ALIGNMENTS AND EVEN GRADES USING A PIPE LASER OR OTHER ACCURATE METHOD.
- RELOCATION OF UTILITY PROVIDER FACILITIES, SUCH AS POLES, SHALL BE DONE IN ACCORDANCE WITH THE REQUIREMENTS OF THE UTILITY PROVIDER.
- 11. THE CONTRACTOR SHALL COMPACT PIPE BACKFILL IN 8" LIFTS ACCORDING TO THE PIPE BEDDING DETAILS. TRENCH BOTTOM SHALL BE STABLE IN HIGH GROUNDWATER AREAS. A PIPE FOUNDATION SHALL BE USED PER THE TRENCH DETAILS AND IN AREAS OF ROCK EXCAVATION.
- 12. CONTRACTOR TO PROVIDE STEEL SLEEVES AND ANNULAR SPACE SAND FILL FOR UTILITY PIPE AND CONDUIT CONNECTIONS UNDER FOOTINGS.
- 13. ALL UTILITY CONSTRUCTION IS SUBJECT TO INSPECTION FOR APPROVAL PRIOR TO BACKFILLING, IN ACCORDANCE WITH THE APPROPRIATE UTILITY PROVIDER REQUIREMENTS.
- 14. A ONE-FOOT MINIMUM VERTICAL CLEARANCE BETWEEN WATER, GAS, ELECTRICAL, AND TELEPHONE LINES AND STORM PIPING SHALL BE PROVIDED. A SIX-INCH MINIMUM CLEARANCE SHALL BE MAINTAINED BETWEEN STORM PIPING AND SANITARY SEWER. A 6-INCH TO 18-INCH VERTICAL CLEARANCE BETWEEN SANITARY SEWER PIPING AND STORM PIPING SHALL REQUIRE CONCRETE ENCASEMENT OF THE SANITARY PIPING.
- 15. THE CONTRACTOR SHALL RESTORE ANY UTILITY STRUCTURE, PIPE, CONDUIT, PAVEMENT, CURBING, SIDEWALKS, DRAINAGE STRUCTURE, SWALE OR LANDSCAPED AREAS DISTURBED DURING CONSTRUCTION, TO THEIR ORIGINAL CONDITION OR BETTER TO THE SATISFACTION OF THE PROJECT DEVELOPER AND CITY OF MIDDLETOWN.
- 16. INFORMATION ON EXISTING UTILITIES AND STORM DRAINAGE HAS BEEN COMPILED FROM AVAILABLE INFORMATION INCLUDING UTILITY PROVIDER AND MUNICIPAL RECORD MAPS AND/OR FIELD SURVEY, AND IS NOT GUARANTEED CORRECT OR COMPLETE. UTILITIES AND STORM DRAINAGE ARE SHOWN TO ALERT THE CONTRACTOR TO THEIR PRESENCE. THE CONTRACTOR IS SOLELY RESPONSIBLE FOR DETERMINING ACTUAL LOCATIONS AND ELEVATIONS OF ALL UTILITIES AND STORM DRAINAGE INCLUDING SERVICES. CONTACT "CALL BEFORE YOU DIG" AT 811 72 HOURS PRIOR TO CONSTRUCTION AND VERIFY ALL UNDERGROUND AND OVERHEAD UTILITY AND STORM DRAINAGE LOCATIONS. THE CONTRACTOR SHALL EMPLOY THE USE OF A UTILITY LOCATING COMPANY TO PROVIDE SUBSURFACE UTILITY ENGINEERING CONSISTING OF DESIGNATING UTILITIES AND STORM PIPING ON PRIVATE PROPERTY WITHIN THE CONTRACT LIMIT AND CONSISTING OF DESIGNATING AND LOCATING WHERE PROP. UTILITIES AND STORM PIPING CROSS EXISTING UTILITIES AND STORM PIPING WITHIN THE CONTRACT LIMITS.
- 17. THE CONTRACTOR SHALL ARRANGE AND COORDINATE WITH UTILITY PROVIDERS FOR WORK TO BE PERFORMED BY UTILITY PROVIDERS. THE CONTRACTOR SHALL PAY ALL UTILITY FEES UNLESS OTHERWISE STATED IN THE PROJECT SPECIFICATION MANUAL AND GENERAL CONDITIONS, AND REPAIR PAVEMENTS AS NECESSARY.
- 18. ELECTRIC DRAWINGS AND REQUIREMENTS ARE NOT INCLUDED AS PART OF THIS DRAWING SET AND SHOULD BE OBTAINED FROM THE PROJECT DEVELOPER.
- 19. ALTERNATIVE METHODS AND PRODUCTS OTHER THAN THOSE SPECIFIED MAY BE USED IF REVIEWED AND APPROVED BY THE PROJECT DEVELOPER, ENGINEER, AND APPROPRIATE REGULATORY AGENCIES PRIOR TO INSTALLATION.
- 20. THE CONTRACTOR SHALL MAINTAIN ALL FLOWS AND UTILITY CONNECTIONS TO EXISTING BUILDINGS WITHOUT INTERRUPTION UNLESS/UNTIL AUTHORIZED TO DISCONNECT BY THE PROJECT DEVELOPER, CITY OF MIDDLETOWN, UTILITY PROVIDERS AND GOVERNING AUTHORITIES.

GENERAL LEGEND EXISTING PROPOSED PROPERTY LINE **BUILDING SETBACK** EASEMENT TREE LINE WETLAND _v___v___ WETLAND BUFFER ______ **VERNAL POOL** VERNAL POOL BUFFE WATERCOURSE WATERCOURSE BUFFER MAJOR CONTOUR MINOR CONTOUR UNDERGROUND ELECTRIC OVERHEAD ELECTRIC BASIN _.._.. SWALE FENCE — x— x— x— LIMIT OF DISTURBANCE $-\!\!\!-$ LOD $-\!\!\!\!-$ LOD $-\!\!\!\!-$ FILTER SOCK — FS —— FS — SILT FENCE BAFFLE



310 4TH STREET NE - 3RD FLOOR CHARLOTTESVILLE, VA 22902



567 VAUXHALL STREET EXTENSION - SUITE 311

WATERFORD, CT 06385 PHONE: (860)-663-1697 WWW.ALLPOINTSTECH.COM FAX: (860)-663-0935

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DESIGN PROFESSIONALS OF RECORD

PROF: THOMAS E. LITTLE, P.E.
COMP: ALL-POINTS TECHNOLOGY
CORPORATION, P.C.
ADD: 567 VAUXHALL STREET
EXTENSION - SUITE 311
WATERFORD, CT 06385

OWNER: SBA PROPERTIES INC.

ADDRESS: 8051 CONGRESS AVE. BOCA RATON, FL 33487

LONG HILL BESS

SITE ADDRESS:

1825 SOUTH MAIN STREET MIDDLETOWN, CT 06457

APT FILING NUMBER: CT720110

DRAWN BY: UKA/ELZ


SHEET TITLE:

GENERAL NOTES & LEGEND

DATE: 10/23/24 CHECKED BY: TEL

SHEET NUMBER:

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310 4TH STREET NE - 3RD FLOOR CHARLOTTESVILLE, VA 22902

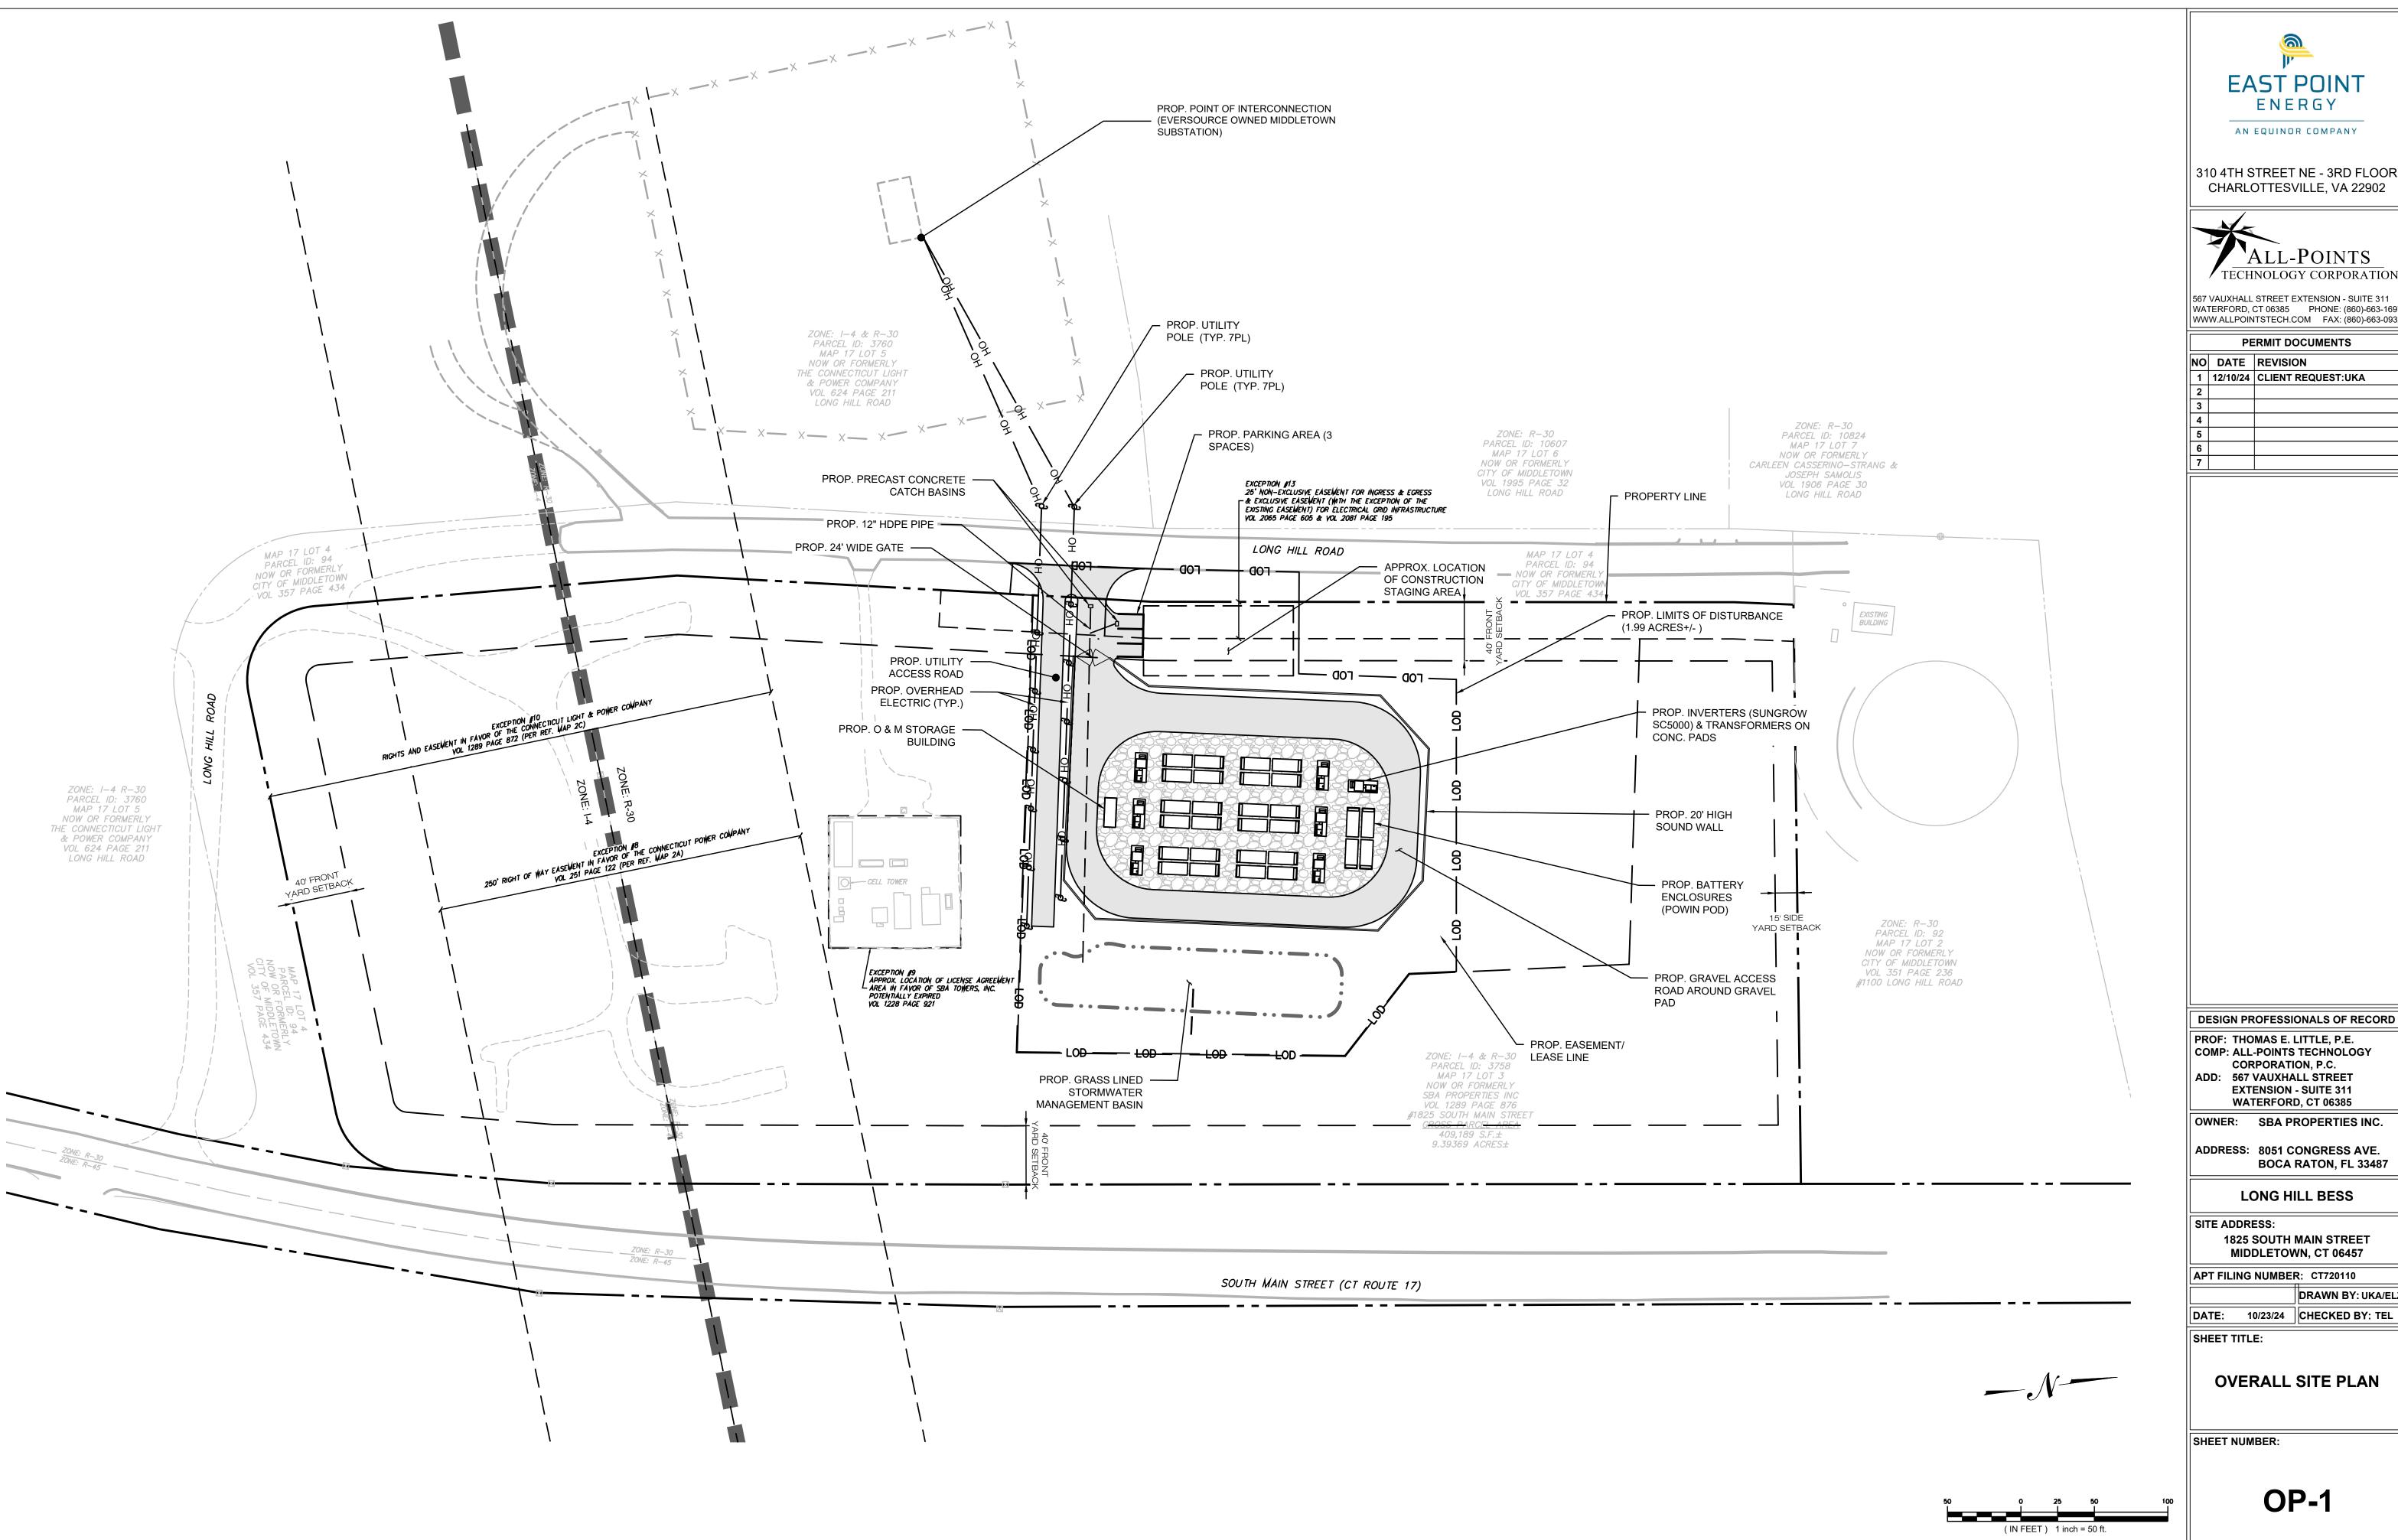

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DESIGN PROFESSIONALS OF RECORD

COMP: ALL-POINTS TECHNOLOGY CORPORATION, P.C. ADD: 567 VAUXHALL STREET **EXTENSION - SUITE 311** WATERFORD, CT 06385

OWNER: SBA PROPERTIES INC.

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LONG HILL BESS

SITE ADDRESS:

1825 SOUTH MAIN STREET MIDDLETOWN, CT 06457


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OVERALL SITE PLAN

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EROSION CONTROL NOTES

EROSION AND SEDIMENT CONTROL PLAN NOTES

- 1. THE CONTRACTOR SHALL CONSTRUCT ALL SEDIMENT AND EROSION CONTROLS IN ACCORDANCE WITH THE 2024 CONNECTICUT GUIDELINES FOR SOIL EROSION AND SEDIMENT CONTROL, LATEST EDITION, IN ACCORDANCE WITH THE CONTRACT DOCUMENTS, AND AS DIRECTED BY THE CITY OF MIDDLETOWN, PERMITTEE, AND/OR SWPCP MONITOR. ALL PERIMETER SEDIMENTATION AND EROSION CONTROL MEASURES SHALL BE INSTALLED PRIOR TO THE START OF CLEARING AND GRUBBING AND DEMOLITION OPERATIONS.
- 2. THESE DRAWINGS ARE ONLY INTENDED TO DESCRIBE THE SEDIMENT AND EROSION CONTROL MEASURES FOR THIS SITE. SEE CONSTRUCTION SEQUENCE FOR ADDITIONAL INFORMATION. ALL TEMPORARY EROSION AND SEDIMENT CONTROL MEASURES SHOWN ON THE EROSION & SEDIMENT CONTROL PLAN ARE SHOWN AS REQUIRED BY THE ENGINEER. THE CONTRACTOR SHALL BE RESPONSIBLE FOR ENSURING THAT ALL EROSION CONTROL MEASURES ARE CONFIGURED AND CONSTRUCTED IN A MANNER THAT WILL MINIMIZE EROSION OF SOILS AND PREVENT THE TRANSPORT OF SEDIMENTS AND OTHER POLLUTANTS TO STORM DRAINAGE SYSTEMS AND/OR WATERCOURSES. ACTUAL SITE CONDITIONS OR SEASONAL AND CLIMATIC CONDITIONS MAY WARRANT ADDITIONAL CONTROLS OR CONFIGURATIONS, AS REQUIRED, AND AS DIRECTED BY THE PERMITTEE AND/OR SWPCP MONITOR. REFER TO SITE PLAN FOR GENERAL INFORMATION AND OTHER CONTRACT PLANS FOR APPROPRIATE INFORMATION.
- 3. A BOND OR LETTER OF CREDIT MAY BE REQUIRED TO BE POSTED WITH THE GOVERNING AUTHORITY FOR THE EROSION CONTROL INSTALLATION AND MAINTENANCE.
- 4. THE CONTRACTOR SHALL APPLY THE MINIMUM EROSION & SEDIMENT CONTROL MEASURES SHOWN ON THE PLAN IN CONJUNCTION WITH CONSTRUCTION SEQUENCING, SUCH THAT ALL ACTIVE WORK ZONES ARE PROTECTED. ADDITIONAL AND/OR ALTERNATIVE SEDIMENT AND EROSION CONTROL MEASURES MAY BE INSTALLED DURING THE CONSTRUCTION PERIOD IF FOUND NECESSARY BY THE CONTRACTOR, OWNER, SITE ENGINEER, MUNICIPAL OFFICIALS, OR ANY GOVERNING AGENCY. THE CONTRACTOR SHALL CONTACT THE OWNER AND APPROPRIATE GOVERNING AGENCIES FOR APPROVAL IF ALTERNATIVE CONTROLS OTHER THAN THOSE SHOWN ON THE PLANS ARE PROPOSED BY THE CONTRACTOR.
- 5. THE CONTRACTOR SHALL TAKE EXTREME CARE DURING CONSTRUCTION SO AS NOT TO DISTURB UNPROTECTED WETLAND AREAS OR INSTALLED SEDIMENTATION AND EROSION CONTROL MEASURES. THE CONTRACTOR SHALL INSPECT ALL SEDIMENT AND EROSION CONTROLS WEEKLY AND WITHIN 24 HOURS OF A STORM WITH A RAINFALL AMOUNT OF 0.25 INCHES OR GREATER TO VERIFY THAT THE CONTROLS ARE OPERATING PROPERLY AND MAKE REPAIRS AS NECESSARY IN A TIMELY MANOR.
- 6. THE CONTRACTOR SHALL KEEP A SUPPLY OF EROSION CONTROL MATERIAL (SILT FENCE, COMPOST FILTER SOCK, EROSION CONTROL BLANKET, ETC.) ON-SITE FOR PERIODIC MAINTENANCE AND EMERGENCY REPAIRS.
- 7. ALL FILL MATERIAL PLACED ADJACENT TO ANY WETLAND AREA SHALL BE GOOD QUALITY, WITH LESS THAN 5% FINES PASSING THROUGH A #200 SIEVE (BANK RUN), SHALL BE PLACED IN MAXIMUM ONE FOOT LIFTS, AND SHALL BE COMPACTED TO 95% MAX. DRY DENSITY MODIFIED PROCTOR OR AS SPECIFIED IN THE CONTRACT SPECIFICATIONS.
- 8. PROTECT EXISTING TREES THAT ARE TO BE SAVED BY FENCING, ORANGE SAFETY FENCE, CONSTRUCTION TAPE, OR EQUIVALENT FENCING/TAPE. ANY LIMB TRIMMING SHOULD BE DONE AFTER CONSULTATION WITH AN ARBORIST AND BEFORE CONSTRUCTION BEGINS IN THAT AREA; FENCING SHALL BE MAINTAINED AND REPAIRED DURING CONSTRUCTION.
- 9. CONSTRUCTION ENTRANCES (ANTI-TRACKING PADS) SHALL BE INSTALLED PRIOR TO ANY SITE EXCAVATION OR CONSTRUCTION ACTIVITY AND SHALL BE MAINTAINED THROUGHOUT THE DURATION OF ALL CONSTRUCTION IF REQUIRED. THE LOCATION OF THE TRACKING PADS MAY CHANGE AS VARIOUS PHASES OF CONSTRUCTION ARE COMPLETED. CONTRACTOR SHALL ENSURE THAT ALL VEHICLES EXITING THE SITE ARE PASSING OVER THE ANTI-TRACKING PADS PRIOR TO EXITING.
- 10. ALL CONSTRUCTION SHALL BE CONTAINED WITHIN THE LIMIT OF DISTURBANCE, WHICH SHALL BE MARKED WITH SILT FENCE, SAFETY FENCE, HAY BALES, RIBBONS, OR OTHER MEANS PRIOR TO CLEARING. CONSTRUCTION ACTIVITY SHALL REMAIN ON THE UPHILL SIDE OF THE SEDIMENT BARRIER UNLESS WORK IS SPECIFICALLY CALLED FOR ON THE DOWNHILL SIDE OF THE BARRIER.
- 11. NO CUT OR FILL SLOPES SHALL EXCEED 2:1 EXCEPT WHERE STABILIZED BY ROCK FACED EMBANKMENTS OR EROSION CONTROL BLANKETS. ALL SLOPES SHALL BE SEEDED AND BANKS WILL BE STABILIZED IMMEDIATELY UPON COMPLETION OF FINAL GRADING UNTIL TURF IS ESTABLISHED.
- 12. DIRECT ALL DEWATERING PUMP DISCHARGE TO A SEDIMENT CONTROL DEVICE CONFORMING TO THE GUIDELINES WITHIN THE APPROVED LIMIT OF DISTURBANCE IF REQUIRED. DISCHARGE TO STORM DRAINS OR SURFACE WATERS FROM SEDIMENT CONTROLS SHALL BE CLEAR AND APPROVED BY THE PERMITTEE OR MUNICIPALITY.
- 13. THE CONTRACTOR SHALL MAINTAIN A CLEAN CONSTRUCTION SITE AND SHALL NOT ALLOW THE ACCUMULATION OF RUBBISH OR CONSTRUCTION DEBRIS ON THE SITE. PROPER SANITARY DEVICES SHALL BE MAINTAINED ON-SITE AT ALL TIMES AND SECURED APPROPRIATELY. THE CONTRACTOR SHALL TAKE ALL NECESSARY PRECAUTIONS TO AVOID THE SPILLAGE OF FUEL OR OTHER POLLUTANTS ON THE CONSTRUCTION SITE AND SHALL ADHERE TO ALL APPLICABLE POLICIES AND REGULATIONS RELATED TO SPILL PREVENTION AND RESPONSE/CONTAINMENT.
- 14. MINIMIZE LAND DISTURBANCES. SEED AND MULCH DISTURBED AREAS WITH TEMPORARY MIX AS SOON AS PRACTICABLE (2 WEEK MAXIMUM UNSTABILIZED PERIOD) USING PERENNIAL RYEGRASS AT 40 LBS PER ACRE. MULCH ALL CUT AND FILL SLOPES AND SWALES WITH LOOSE HAY AT A RATE OF 2 TONS PER ACRE. IF NECESSARY, REPLACE LOOSE HAY ON SLOPES WITH EROSION CONTROL BLANKETS OR JUTE CLOTH. MODERATELY GRADED AREAS, ISLANDS, AND TEMPORARY CONSTRUCTION STAGING AREAS MAY BE HYDROSEEDED WITH TACKIFIER.
- 15. SWEEP AFFECTED PORTIONS OF OFF SITE ROADS ONE OR MORE TIMES A DAY (OR LESS FREQUENTLY IF TRACKING IS NOT A PROBLEM) DURING CONSTRUCTION. FOR DUST CONTROL, PERIODICALLY MOISTEN EXPOSED SOIL SURFACES WITH WATER ON UNPAVED TRAVELWAYS TO KEEP THE TRAVELWAYS DAMP. CALCIUM CHLORIDE MAY ALSO BE APPLIED TO ACCESS ROADS. DUMP TRUCK LOADS EXITING THE SITE SHALL BE COVERED.
- 16. VEGETATIVE ESTABLISHMENT SHALL OCCUR ON ALL DISTURBED SOIL, UNLESS THE AREA IS UNDER ACTIVE CONSTRUCTION, IT IS COVERED IN STONE OR SCHEDULED FOR PAVING WITHIN 30 DAYS. TEMPORARY SEEDING OR NON-LIVING SOIL PROTECTION OF ALL EXPOSED SOILS AND SLOPES SHALL BE INITIATED WITHIN THE FIRST 7 DAYS OF SUSPENDING WORK IN AREAS TO BE LEFT LONGER THAN 30 DAYS.
- 17. MAINTAIN ALL PERMANENT AND TEMPORARY SEDIMENT CONTROL DEVICES IN EFFECTIVE CONDITION THROUGHOUT THE CONSTRUCTION PERIOD. UPON COMPLETION OF WORK SWEEP CONCRETE PADS, CLEAN THE STORMWATER MANAGEMENT SYSTEMS AND REMOVE ALL TEMPORARY SEDIMENT CONTROLS ONCE THE SITE IS FULLY STABILIZED AND APPROVAL HAS BEEN RECEIVED FROM PERMITTEE OR THE MUNICIPALITY.
- 18. THE SITE WAS DESIGNED TO COMPLY WITH FEDERAL, STATE, AND, IF APPLICABLE, LOCAL STANDARDS, PLUS CURRENT ACCEPTED PRACTICES FOR THE INDUSTRY. ADDITIONAL CONTROLS AND ACTIVITIES MAY BE DEEMED NECESSARY BY THE SWPCP MONITOR DURING CONSTRUCTION AS A RESULT OF UNFORESEEN CONDITIONS AND/OR MEANS AND METHODS. SUCH ITEMS MAY INCLUDE, BUT ARE NOT LIMITED TO: ADDITIONAL FOREBAYS, BASINS, OR UPSTREAM STRUCTURAL CONTROLS, THE USE OF FLOCCULANTS OF FLOCK LOGS TO DECREASE SEDIMENT, DISCHARGE MANAGEMENT SUCH AS ADDITIONAL ARMORING AND FILTERING MEASURES (I.E. STRAW BALES, WATTLES, ETC.), AND HYDROSEEDING WITH RAPIDLY GERMINATING SEED.
- 19. SEEDING MIXTURES SHALL BE ERNST SUN/SHADE SEED MIX (SEE SITE DETAILS SHEET SP-2), OR APPROVED EQUAL BY OWNER

- 1. THE PROJECT INVOLVES THE CONSTRUCTION OF A BATTERY ENERGY STORAGE FACILITY WITH ASSOCIATED EQUIPMENT ON APPROXIMATELY 1.99± ACRES OF AN EXISTING FORESTED/ OPEN SPACE AREA
- 2. THE PROJECT SITE, AS MAPPED IN THE SOIL SURVEY OF STATE OF CONNECTICUT (NRCS, VERSION 1, SEP 15, 2023), CONTAINS TYPE 87B (HYDROLOGIC SOIL GROUP C).
- 3. STORMWATER MANAGEMENT DESIGN CRITERIA UTILIZES THE APPLICABLE SECTIONS OF THE 2024 CONNECTICUT STORMWATER QUALITY MANUAL AND THE CITY OF MIDDLETOWN STANDARDS, TO THE EXTENT POSSIBLE AND PRACTICABLE FOR THIS PROJECT ON THIS SITE. EROSION AND SEDIMENTATION MEASURES ARE BASED UPON ENGINEERING PRACTICE, JUDGEMENT AND THE APPLICABLE SECTIONS OF THE CONNECTICUT EROSION AND SEDIMENT CONTROL GUIDELINES FOR URBAN AND SUBURBAN AREAS, LATEST EDITION.
- 4. CONSERVATION PRACTICES TO BE USED DURING CONSTRUCTION:
- A. STAGED CONSTRUCTION;
- B. MINIMIZE THE DISTURBED AREAS TO THE EXTENT PRACTICABLE DURING CONSTRUCTION;
- C. STABILIZE DISTURBED AREAS WITH TEMPORARY OR PERMANENT MEASURES AS SOON AS POSSIBLE, BUT NO LATER THAN 7-DAYS FOLLOWING DISTURBANCE;
- D. MINIMIZE IMPERVIOUS AREAS;
- E. UTILIZE APPROPRIATE CONSTRUCTION EROSION AND SEDIMENTATION MEASURES.

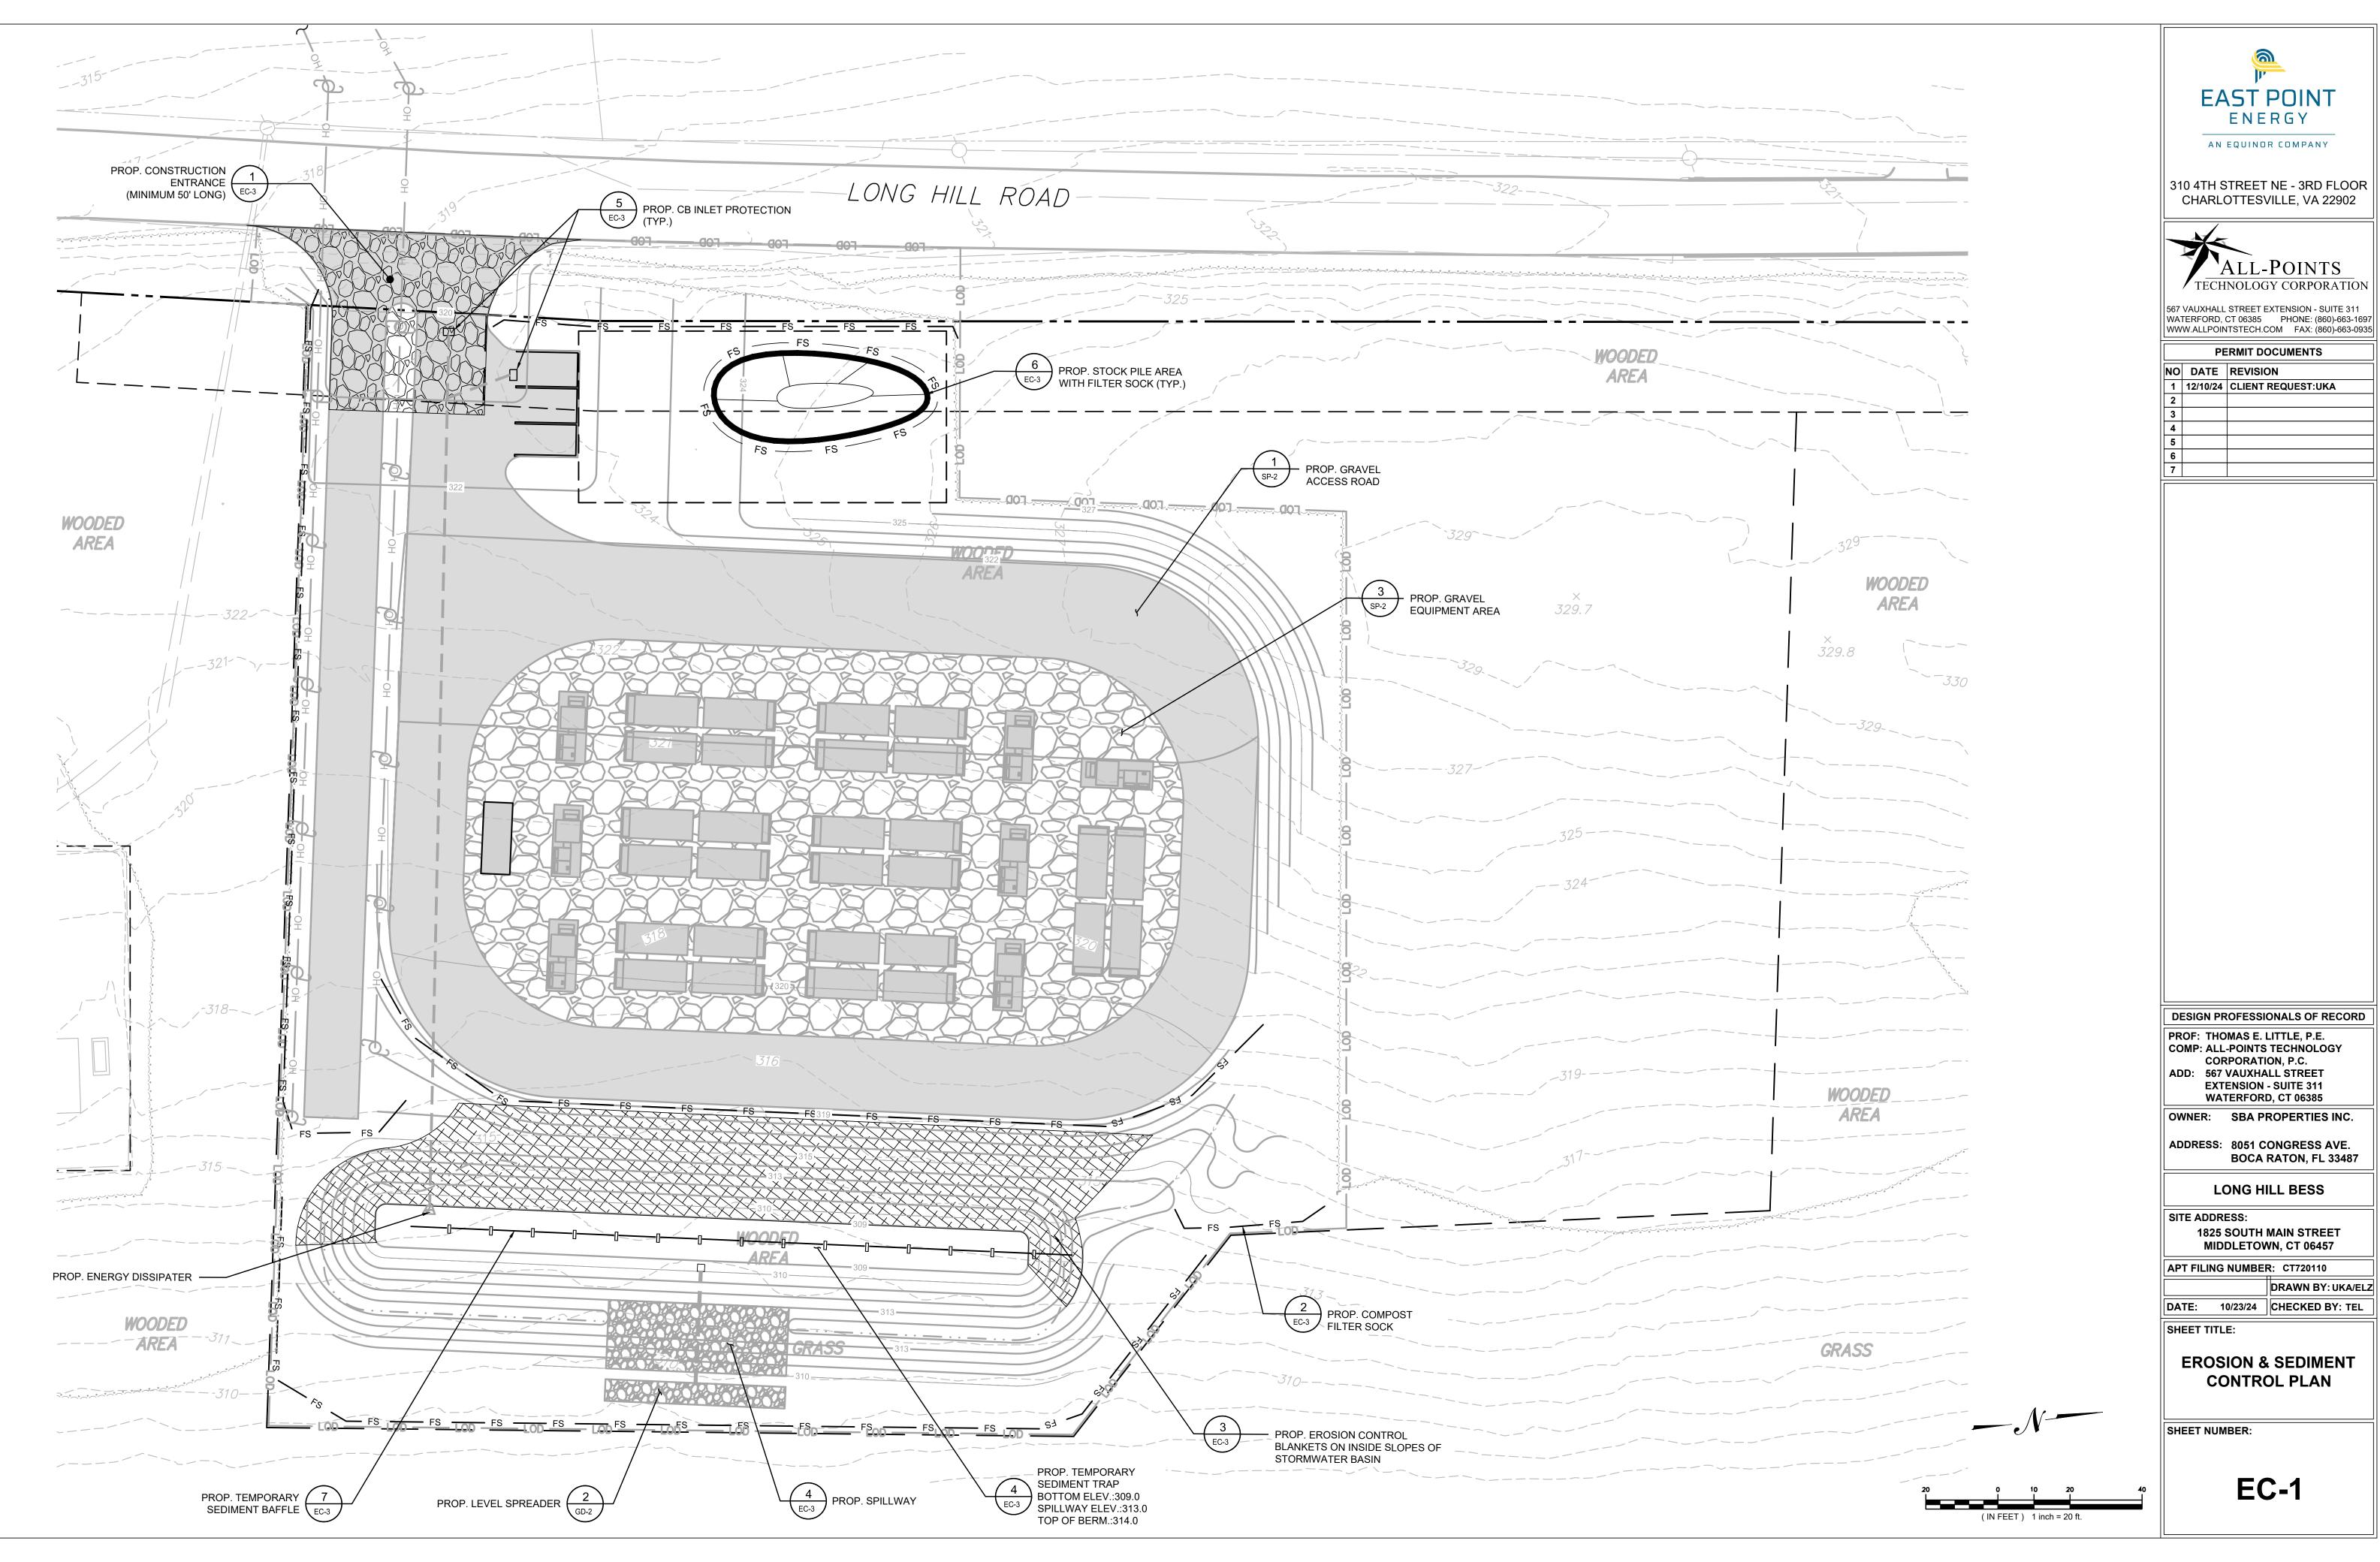	CONSTRUCTION OPERATION AND MAINTENANCE PLAN - BY CONTRACTOR			
E&S MEASURE	INSPECTION SCHEDULE	MAINTENANCE REQUIRED		
CONSTRUCTION ENTRANCE	DAILY	PLACE ADDITIONAL STONE, EXTEND THE LENGTH OR REMOVE AND REPLACE THE STONE. CLEAN PAVED SURFACES OF TRACKED SEDIMENT.		
COMPOST FILTER SOCK	WEEKLY & WITHIN 24 HOURS OF RAINFALL > 0.25"	REPAIR/REPLACE WHEN FAILURE OR DETERIORATION IS OBSERVED.		
SILT FENCE	WEEKLY & WITHIN 24 HOURS OF RAINFALL > 0.25"	REPAIR/REPLACE WHEN FAILURE OR DETERIORATION IS OBSERVED. REMOVE SILT WHEN IT REACHES 1/2 THE HEIGHT OF THE FENCE.		
TOPSOIL/BORROW STOCKPILES	DAILY	REPAIR/REPLACE SEDIMENT BARRIERS AS NECESSARY.		
TEMPORARY SOIL PROTECTION	WEEKLY & WITHIN 24 HOURS OF RAINFALL > 0.25"	REPAIR ERODED OR BARE AREAS IMMEDIATELY. RESEED AND MULCH.		
TEMPORARY SEDIMENT TRAP (W/ BAFFLES)	WEEKLY & WITHIN 24 HOURS OF RAINFALL > 0.5"	REMOVE SEDIMENT ONCE IT HAS ACCUMULATED TO ONE HALF OF MINIMUM REQUIRED VOLUME OF THE WET STORAGE, DEWATERING AS NEEDED. RESTORE TRAP TO ORIGINAL DIMENSIONS. REPAIR/REPLACE BAFFLES WHEN FAILURE OR DETERIORATION IS OBSERVED.		



310 4TH STREET NE - 3RD FLOOR CHARLOTTESVILLE, VA 22902



WATERFORD, CT 06385 PHONE: (860)-663-1697 WWW.ALLPOINTSTECH.COM FAX: (860)-663-0935

567 VAUXHALL STREET EXTENSION - SUITE 311

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NO	DATE	REVISION
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DESIGN PROFESSIONALS OF RECORD

PROF: THOMAS E. LITTLE, P.E.
COMP: ALL-POINTS TECHNOLOGY
CORPORATION, P.C.
ADD: 567 VAUXHALL STREET
EXTENSION - SUITE 311
WATERFORD, CT 06385

OWNER: SBA PROPERTIES INC.

ADDRESS: 8051 CONGRESS AVE. BOCA RATON, FL 33487

LONG HILL BESS

SITE ADDRESS:

1825 SOUTH MAIN STREET MIDDLETOWN, CT 06457

APT FILING NUMBER: CT720110

DRAWN BY: UKA/ELZ


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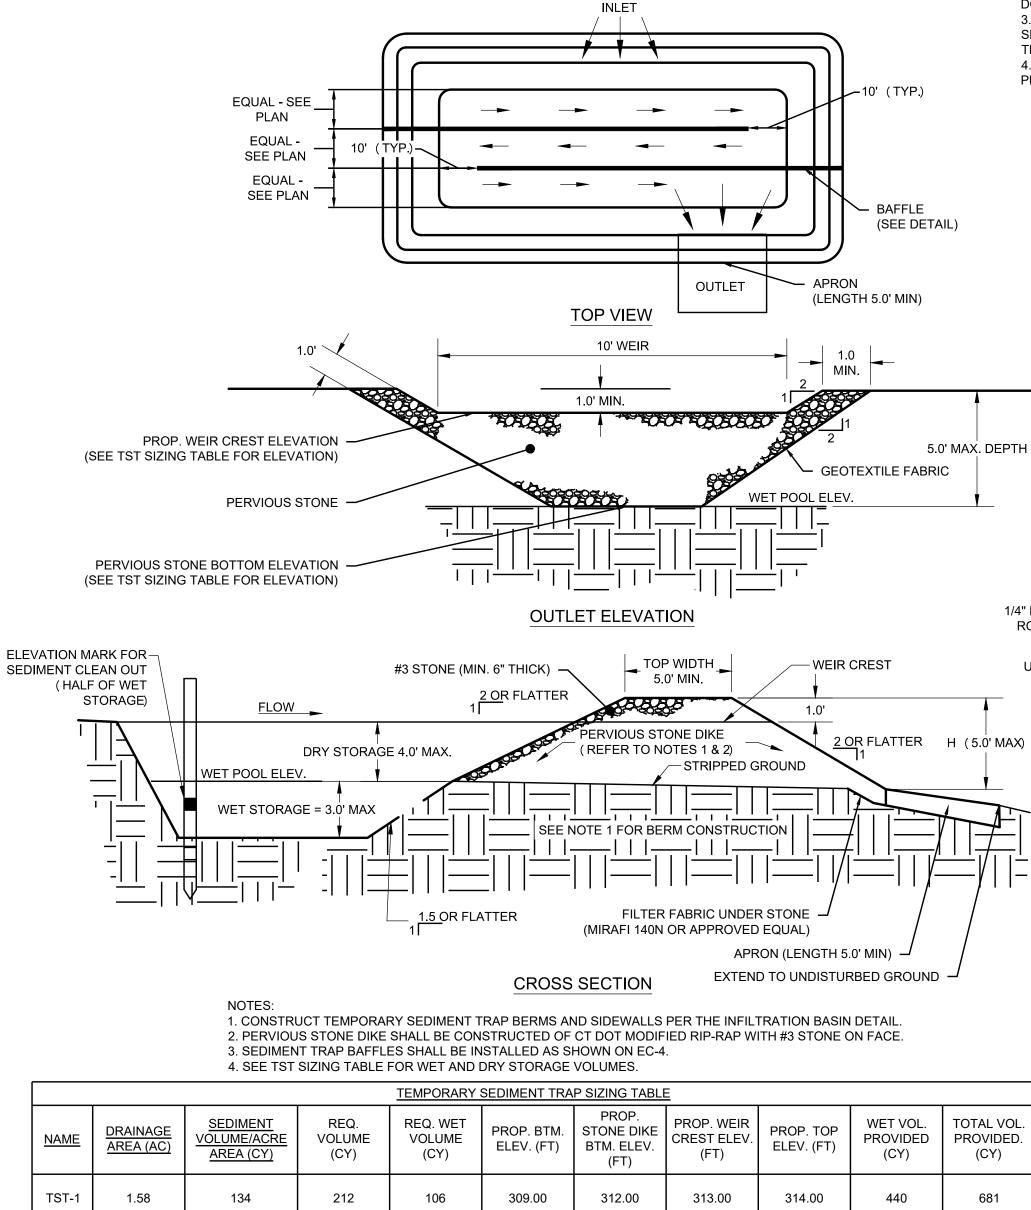
EROSION & SEDIMENT CONTROL NOTES


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EC-2




CONSTRUCTION 1 ENTRANCE DETAIL



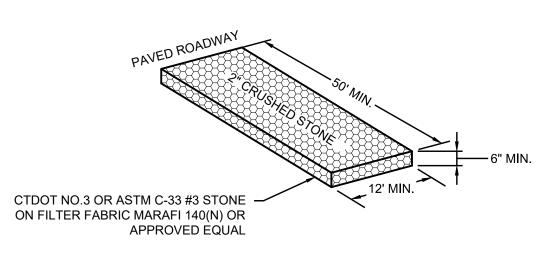

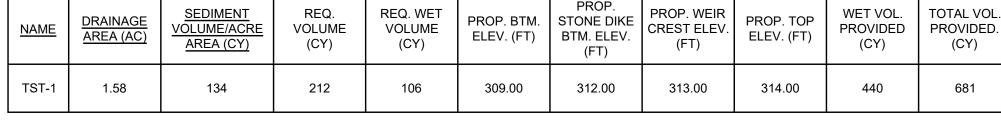TEMPORARY SEDIMENT TRAP EC-3 SCALE: N.T.S.

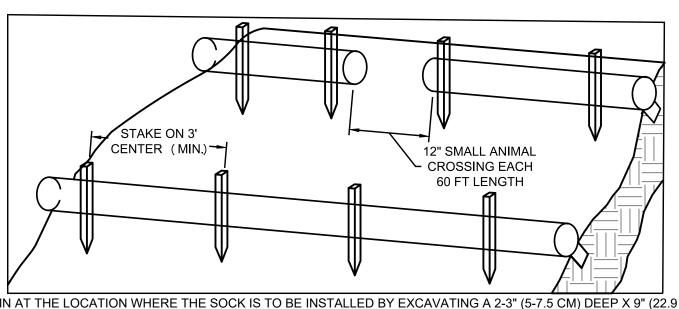

1. BEGIN AT THE LOCATION WHERE THE SOCK IS TO BE INSTALLED BY EXCAVATING A 2-3" (5-7.5 CM) DEEP X 9" (22.9 CM) WIDE TRENCH ALONG THE CONTOUR OF THE SLOPE. EXCAVATED SOIL SHOULD BE PLACED UP SLOPE FROM THE ANCHOR TRENCH.

2. PLACE THE SOCK IN THE TRENCH SO THAT IT CONTOURS TO THE SOIL SURFACE. COMPACT SOIL FROM THE EXCAVATED TRENCH AGAINST THE SOCK ON THE UPHILL SIDE. SOCKS SHALL BE INSTALLED IN 60 FT CONTINUOUS LENGTHS WITH ADJACENT SOCKS TIGHTLY ABUT. EVERY 60 FT THE SOCK ROW SHALL BE SPACED 12 INCHES CLEAR, END TO END, FOR AMPHIBIAN AND REPTILE TRAVEL. THE OPEN SPACES SHALL BE STAGGERED MID LENGTH OF THE NEXT DOWN GRADIENT SOCK.

3. SECURE THE SOCK WITH 18-24" (45.7-61 CM) STAKES EVERY 3' (0.9 -1.2 M) AND WITH A STAKE ON EACH END. STAKES SHOULD BE DRIVEN THROUGH THE MIDDLE OF THE SOCK LEAVING AT LEAST 2-3" (5-7.5 CM) OF STAKE EXTENDING ABOVE THE SOCK. STAKES SHOULD BE DRIVEN PERPENDICULAR TO THE SLOPE FACE.

4. CONTRACTOR TO FOLLOW MANUFACTURE'S SPECIFICATIONS AND INSTALL DIRECTIONS IF DIRECTED THAN WHAT IS PROVIDED ABOVE.

LOCATION.

COMPOST FILTER SOCK

SEDIMENTATION CONTROL BARRIER

INLET GRATE -**EROSION CONTROL BLANKET STEEP SLOPES** LOOPS SIZED FOR 1" REBAR. LIFT FILTER BAG FROM INLET USING REBAR FOR HANDLES. **FINISH** GRADE SECURE LIFTING LOOPS TO OR UNDER **OVERFLOW HOLES-**SURROUNDING SURFACE. GEOTEXTILE BAG-1/4" BRIGHTLY COLORED NYLON ROPE EXPANSION RESTRAINT LOOPS SIZED FOR 1" REBAR. USE REBAR FOR A HANDLE TO 2"X2"X3/4" EMPTY FILTER SACK AT A -SEDIMENT COLLECTION

RUBBER BLOCK 1/4" BRIGHTLY **COLORED NYLON** ROPE EXPANSION RESTRAINT

SECTION VIEW

SINGLE ROW OF COMPOST FILTER SOCK

SOIL/AGGREGATE STOCKPILE OF EXISTING SITE MATERIAL TO BE REUSED AND/OR NEW MATERIAL TO BE INSTALLED IN THE WORK DIRECTION OF RUN-OFF FLOW (TYP.)

1. ALL EXISTING EXCAVATED MATERIAL THAT IS NOT TO BE REUSED IN THE WORK IS TO BE IMMEDIATELY REMOVED FROM THE SITE AND PROPERLY DISPOSED OF.

2. SOIL/AGGREGATE STOCKPILE SITES TO BE WHERE SHOWN ON THE DRAWINGS.


3. RESTORE STOCKPILE SITES TO PRE-EXISTING PROJECT CONDITION AND RESEED AS REQUIRED.

4. STOCKPILE HEIGHTS MUST NOT EXCEED 35'. STOCKPILE SLOPES MUST BE 2:1 OR FLATTER.

5 INLET PROTECTION SCALE: N.T.S.

ISOMETRIC VIEW

ISOMETRIC VIEW

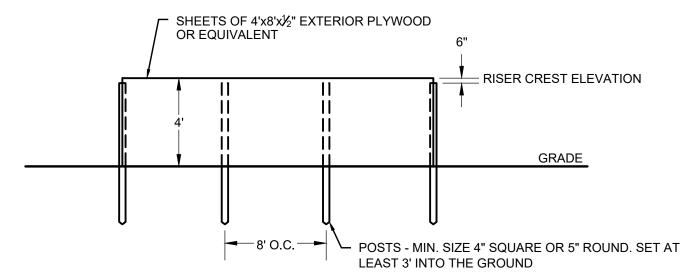

1. FILL ANY VOIDS BETWEEN THE BOTTOM OF THE BASIN AND BAFFLE.

SEDIMENT TRAP BAFFLE

EROSION CONTROL BLANKET INSTALLATION

. PREPARE SOIL BEFORE INSTALLING ROLLED EROSION CONTROL PRODUCTS (RECPS), INCLUDING ANY NECESSARY APPLICATION OF LIME, FERTILIZER, AND SEED.

2. BEGIN AT THE TOP OF THE SLOPE BY ANCHORING THE RECPS IN A 6" DEEP X 6" WIDE TRENCH WITH APPROXIMATELY 12" OF RECPS EXTENDED BEYOND THE UP-SLOPE PORTION OF THE TRENCH. ANCHOR THE RECPS WITH A ROW OF STAPLES/STAKES APPROXIMATELY 12" APART IN THE BOTTOM OF THE TRENCH. BACKFILL AND COMPACT THE TRENCH AFTER STAPLING. APPLY SEED TO THE COMPACTED SOIL AND FOLD THE REMAINING 12" PORTION OF RECPS BACK OVER THE SEED AND COMPACTED SOIL. SECURE RECPS OVER COMPACTED SOIL WITH A ROW OF STAPLES/STAKES SPACED APPROXIMATELY 12" APART ACROSS THE WIDTH OF THE RECPS.

ROLL THE RECPS DOWN HORIZONTALLY ACROSS THE SLOPE. RECPS WILL UNROLL WITH APPROPRIATE SIDE AGAINST THE SOIL SURFACE. ALL RECPS MUST BE SECURELY FASTENED TO SOIL SURFACE BY PLACING STAPLES/STAKES IN

APPROPRIATE LOCATIONS AS SHOWN IN THE STAPLE PATTERN GUIDE.

5. CONSECUTIVE RECPS SPLICED DOWN THE SLOPE MUST BE END OVER END (SHINGLE STYLE) WITH AN APPROXIMATE 3" OVERLAP. STAPLE THROUGH OVERLAPPED AREA, APPROXIMATELY 12" APART ACROSS ENTIRE RECPS WIDTH.

4. THE EDGES OF PARALLEL RECPS MUST BE STAPLED WITH APPROXIMATELY 2" - 5" OVERLAP DEPENDING ON THE RECPS


PROVIDE ANCHOR TRENCH AT TOE OF SLOPE IN SIMILAR FASHION AS AT TOP OF SLOPE.

2. SLOPE SURFACE SHALL BE FREE OF ROCKS, CLODS, STICKS, AND GRASS,


3. BLANKET SHALL HAVE GOOD CONTINUOUS CONTACT WITH UNDERLYING SOIL THROUGHOUT ENTIRE LENGTH. LAY BLANKET LOOSELY AND STAKE OR STAPLE TO MAINTAIN DIRECT CONTACT WITH SOIL. DO NOT STRETCH BLANKET.

4. THE BLANKET SHALL BE STAPLED IN ACCORDANCE WITH THE MANUFACTURER'S RECOMMENDATIONS.

5. BLANKETED AREAS SHALL BE INSPECTED WEEKLY AND AFTER EACH RUNOFF EVENT UNTIL PERENNIAL VEGETATION IS ESTABLISHED TO A MINIMUM UNIFORM 70% COVERAGE THROUGHOUT THE BLANKETED AREA. DAMAGED OR DISPLACED BLANKETS SHALL BE RESTORED OR REPLACED WITHIN 4 CALENDAR DAYS.

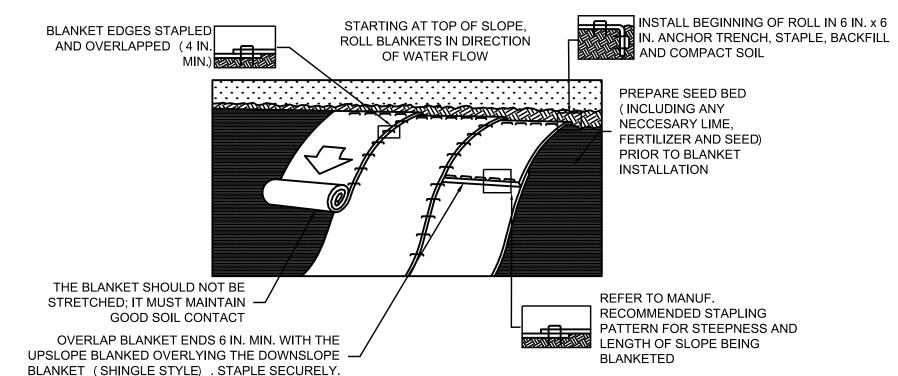

6 MATERIALS STOCKPILE DETAIL

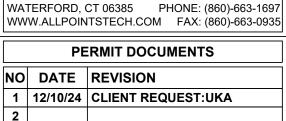

5

567 VAUXHALL STREET EXTENSION - SUITE 311

EAST POINT

ENERGY

AN EQUINOR COMPANY

310 4TH STREET NE - 3RD FLOOR

CHARLOTTESVILLE, VA 22902

'ALL-POINTS

TECHNOLOGY CORPORATION

DESIGN PROFESSIONALS OF RECORD

PROF: THOMAS E. LITTLE, P.E. COMP: ALL-POINTS TECHNOLOGY CORPORATION, P.C. ADD: 567 VAUXHALL STREET **EXTENSION - SUITE 311** WATERFORD, CT 06385

OWNER: SBA PROPERTIES INC.

ADDRESS: 8051 CONGRESS AVE. **BOCA RATON, FL 33487**

LONG HILL BESS

SITE ADDRESS:

SHEET TITLE:

1825 SOUTH MAIN STREET MIDDLETOWN, CT 06457

APT FILING NUMBER: CT720110


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DATE: 10/23/24 CHECKED BY: TEL

EROSION & SEDIMENT CONTROL DETAILS

SHEET NUMBER:

EC-3



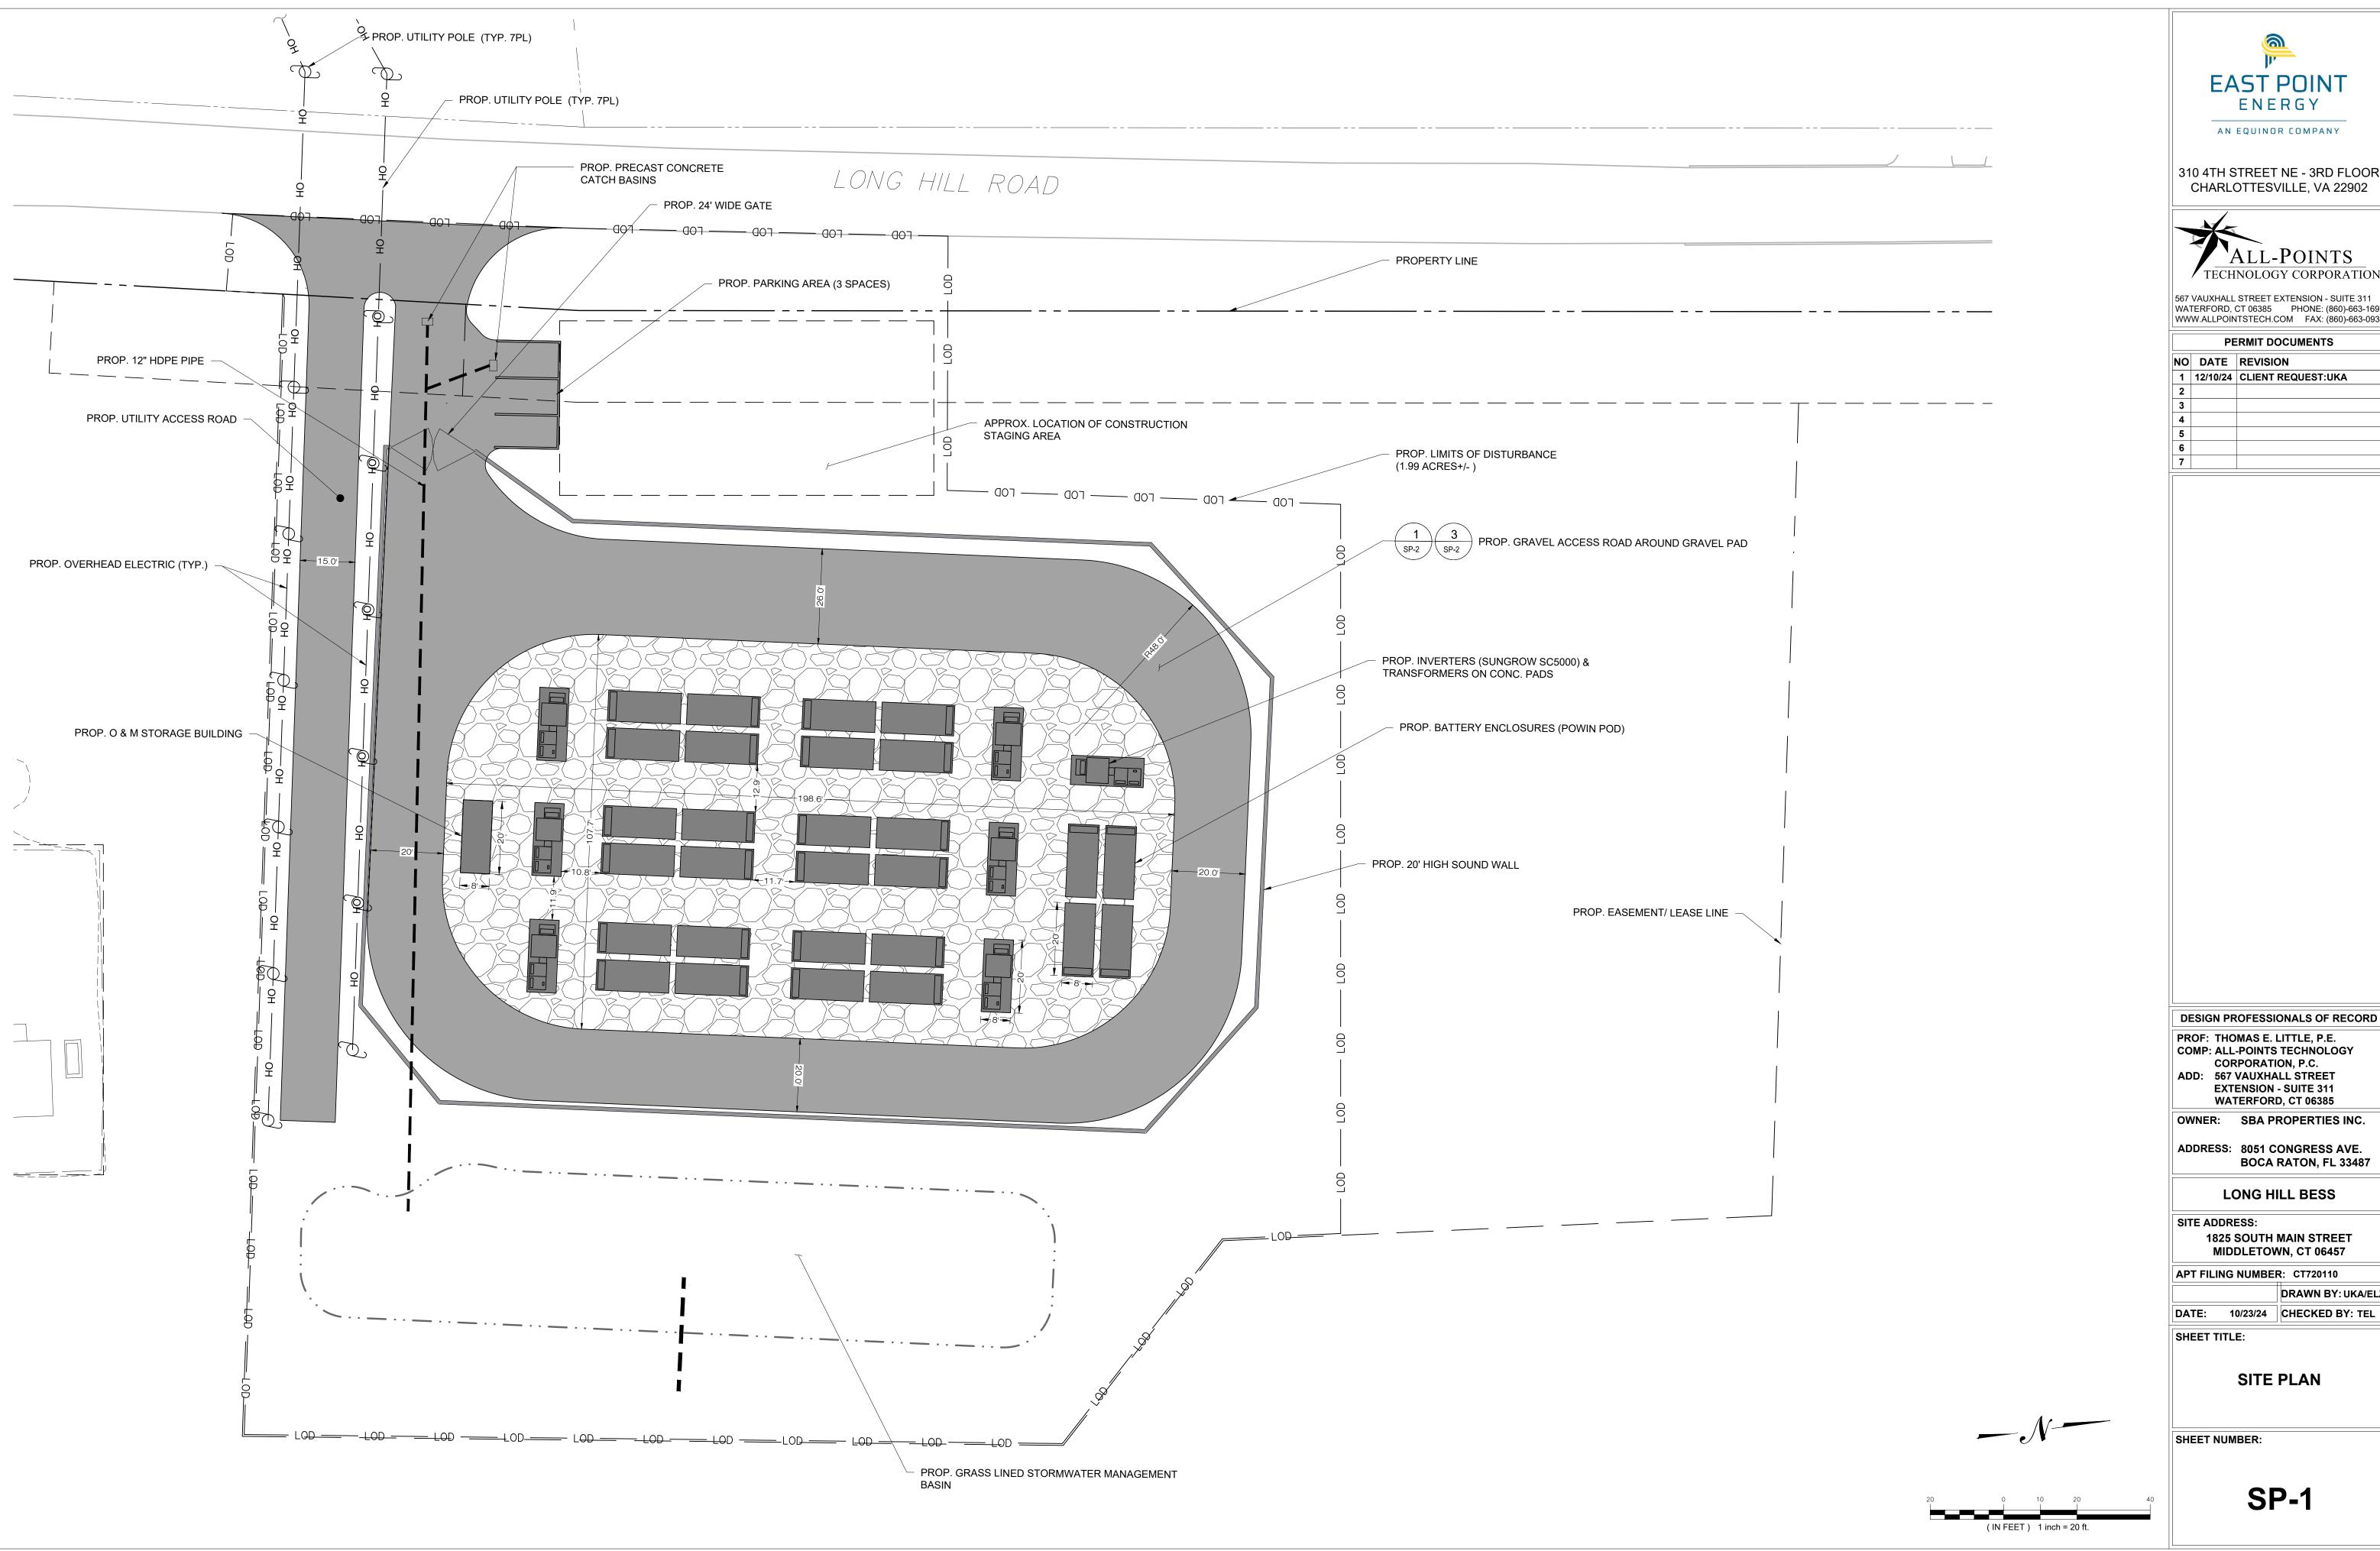

310 4TH STREET NE - 3RD FLOOR



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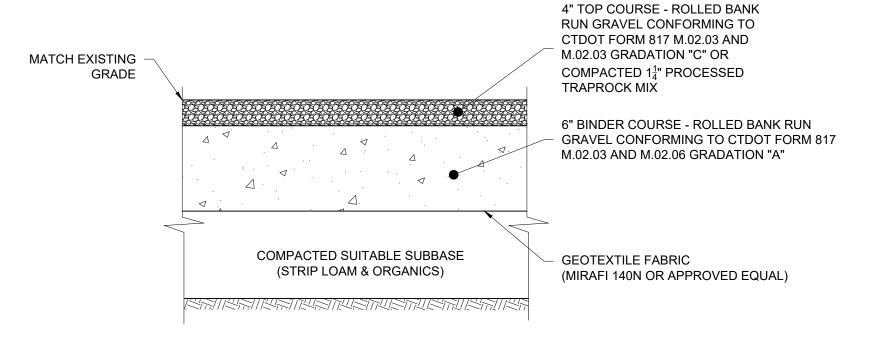
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SITE PLAN

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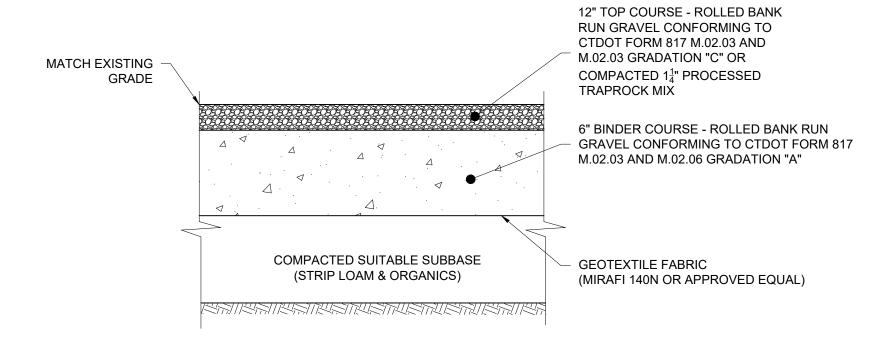
SP-1



NOTES:

 SUBBASE MAY CONSIST OF NATIVE MATERIALS IF FOUND ACCEPTABLE BY THE ENGINEER. SUBBASE TO BE COMPACTED TO 95% MAX DRY DENSITY.
 SUBBASE IS TO BE FREE FROM DEBRIS AND UNSUITABLE MATERIALS.

1 GRAVEL ACCESS DRIVE SECTION SCALE: N.T.S.



NOTES

- SUBBASE MAY CONSIST OF NATIVE MATERIALS IF FOUND ACCEPTABLE BY
 THE ENGINEER. SUBBASE TO BE COMPACTED TO 95% MAX DRY DENSITY.
- 2. SUBBASE IS TO BE FREE FROM DEBRIS AND UNSUITABLE MATERIALS.





Ernst Conservation Seeds

8884 Mercer Pike Meadville, PA 16335 (800) 873-3321 Fax (814) 336-5191 www.ernstseed.com

Date: October 23, 2024

Retention Basin Floor Mix - Low Maintenance - ERNMX-126

	Botanical Name	Common Name	Price/Lb
20.00 %	Panicum clandestinum, Tioga	Deertongue, Tioga	22.25
20.00 %	Puccinellia distans, Fults	Alkaligrass, Fults	4.56
18.00 %	Elymus virginicus, Madison-NY Ecotype	Virginia Wildrye, Madison-NY Ecotype	10.46
15.00 %	Agrostis stolonifera, 'Penncross'	Creeping Bentgrass, 'Penncross'	14.40
15.00 %	Poa palustris	Fowl Bluegrass	21.60
10.00 %	Carex vulpinoidea, PA Ecotype	Fox Sedge, PA Ecotype	28.80
1.00 %	Carex scoparia, PA Ecotype	Blunt Broom Sedge, PA Ecotype	81.60
1.00 %	Juncus effusus	Soft Rush	48.00
100.00 %		Mix Price/Lb Bulk:	\$16.82


Seeding Rate: 20-40 lbs per acre, or 0.5-1 lb/1,000 sq ft with a cover crop. For a cover crop use one of the

following: grain rye (1 Sep to 30 Apr; 30 lbs/acre), Japanese millet (1 May to 31 Aug; 10 lbs/acre), or barnyard grass (1 May to 31 Aug; 10 lbs/acre).

Grasses & Grass-like Species - Herbaceous Perennial; Stormwater Management


The hardy inexpensive grass and grass-like species are ideal for retention basins that may have high salt inflows and where mowing may be required. Mix formulations are subject to change without notice depending on the availability of existing and new products. While the formula may change, the guiding philosophy and function of the mix will not.



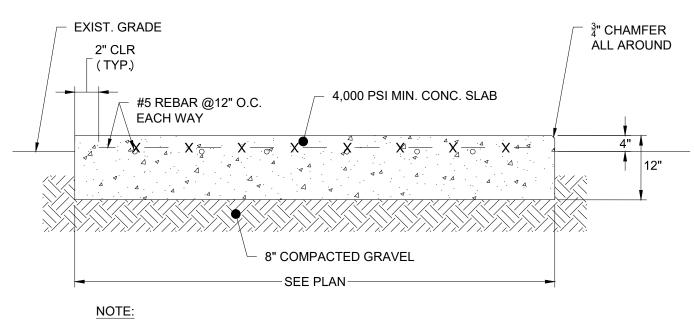

SEE ELECTRICAL DRAWINGS FOR ADDITIONAL CONCRETE PAD DESIGN DETAILS

2 CONCRETE EQUIPMENT PAD SCALE: N.T.S.

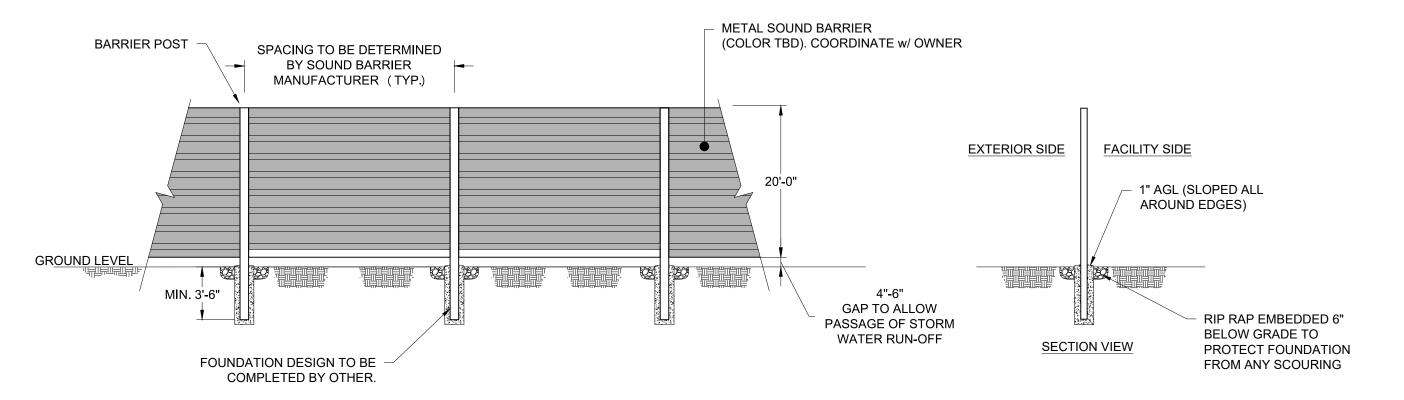

NOTES

- NOTES:

 1. SOUND BARRIER PRODUCT & SPECIFICATIONS TO BE DETERMINED BY
- OWNER.
 2. BARRIER POST FOUNDATION TO BE DESIGNED BY OTHERS.

4 GENERIC SOUND BARRIER DETAIL SCALE: N.T.S.



310 4TH STREET NE - 3RD FLOOR CHARLOTTESVILLE, VA 22902



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1825 SOUTH MAIN STREET MIDDLETOWN, CT 06457

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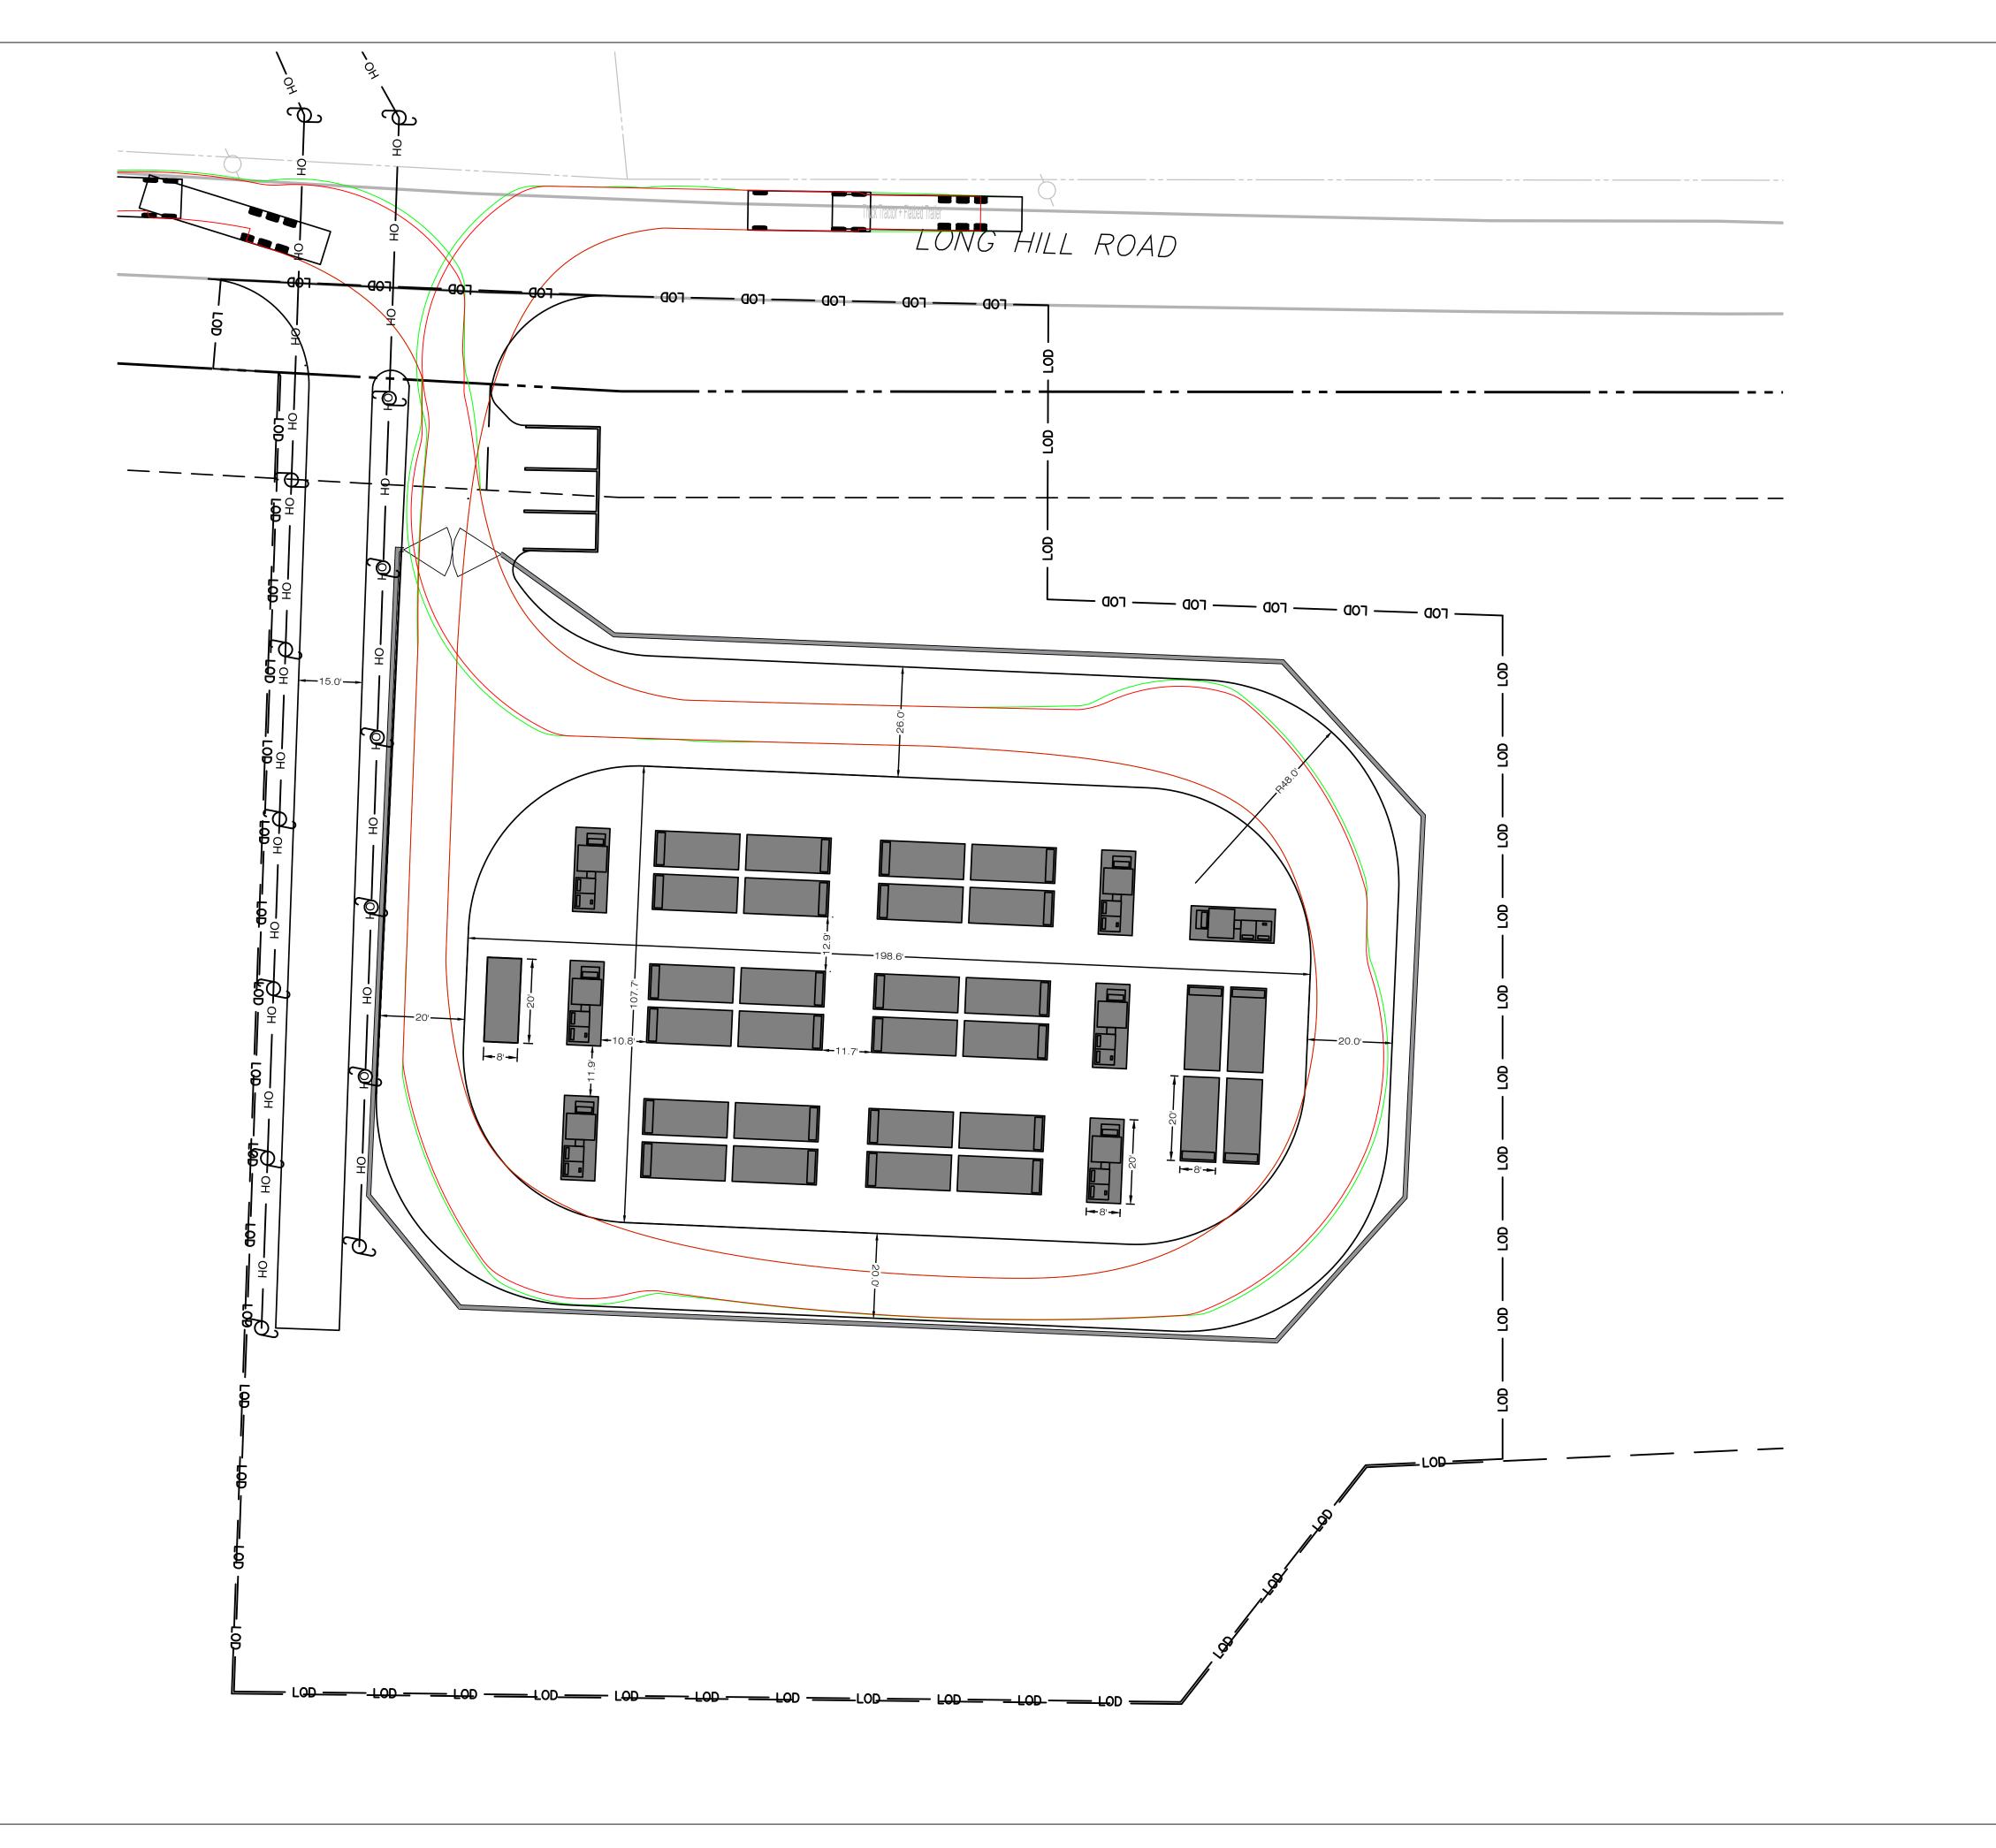
DATE: 10/23/24 CHECKED BY: TEL

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SITE DETAILS

SHEET NUMBER:

SP-2





310 4TH STREET NE - 3RD FLOOR CHARLOTTESVILLE, VA 22902



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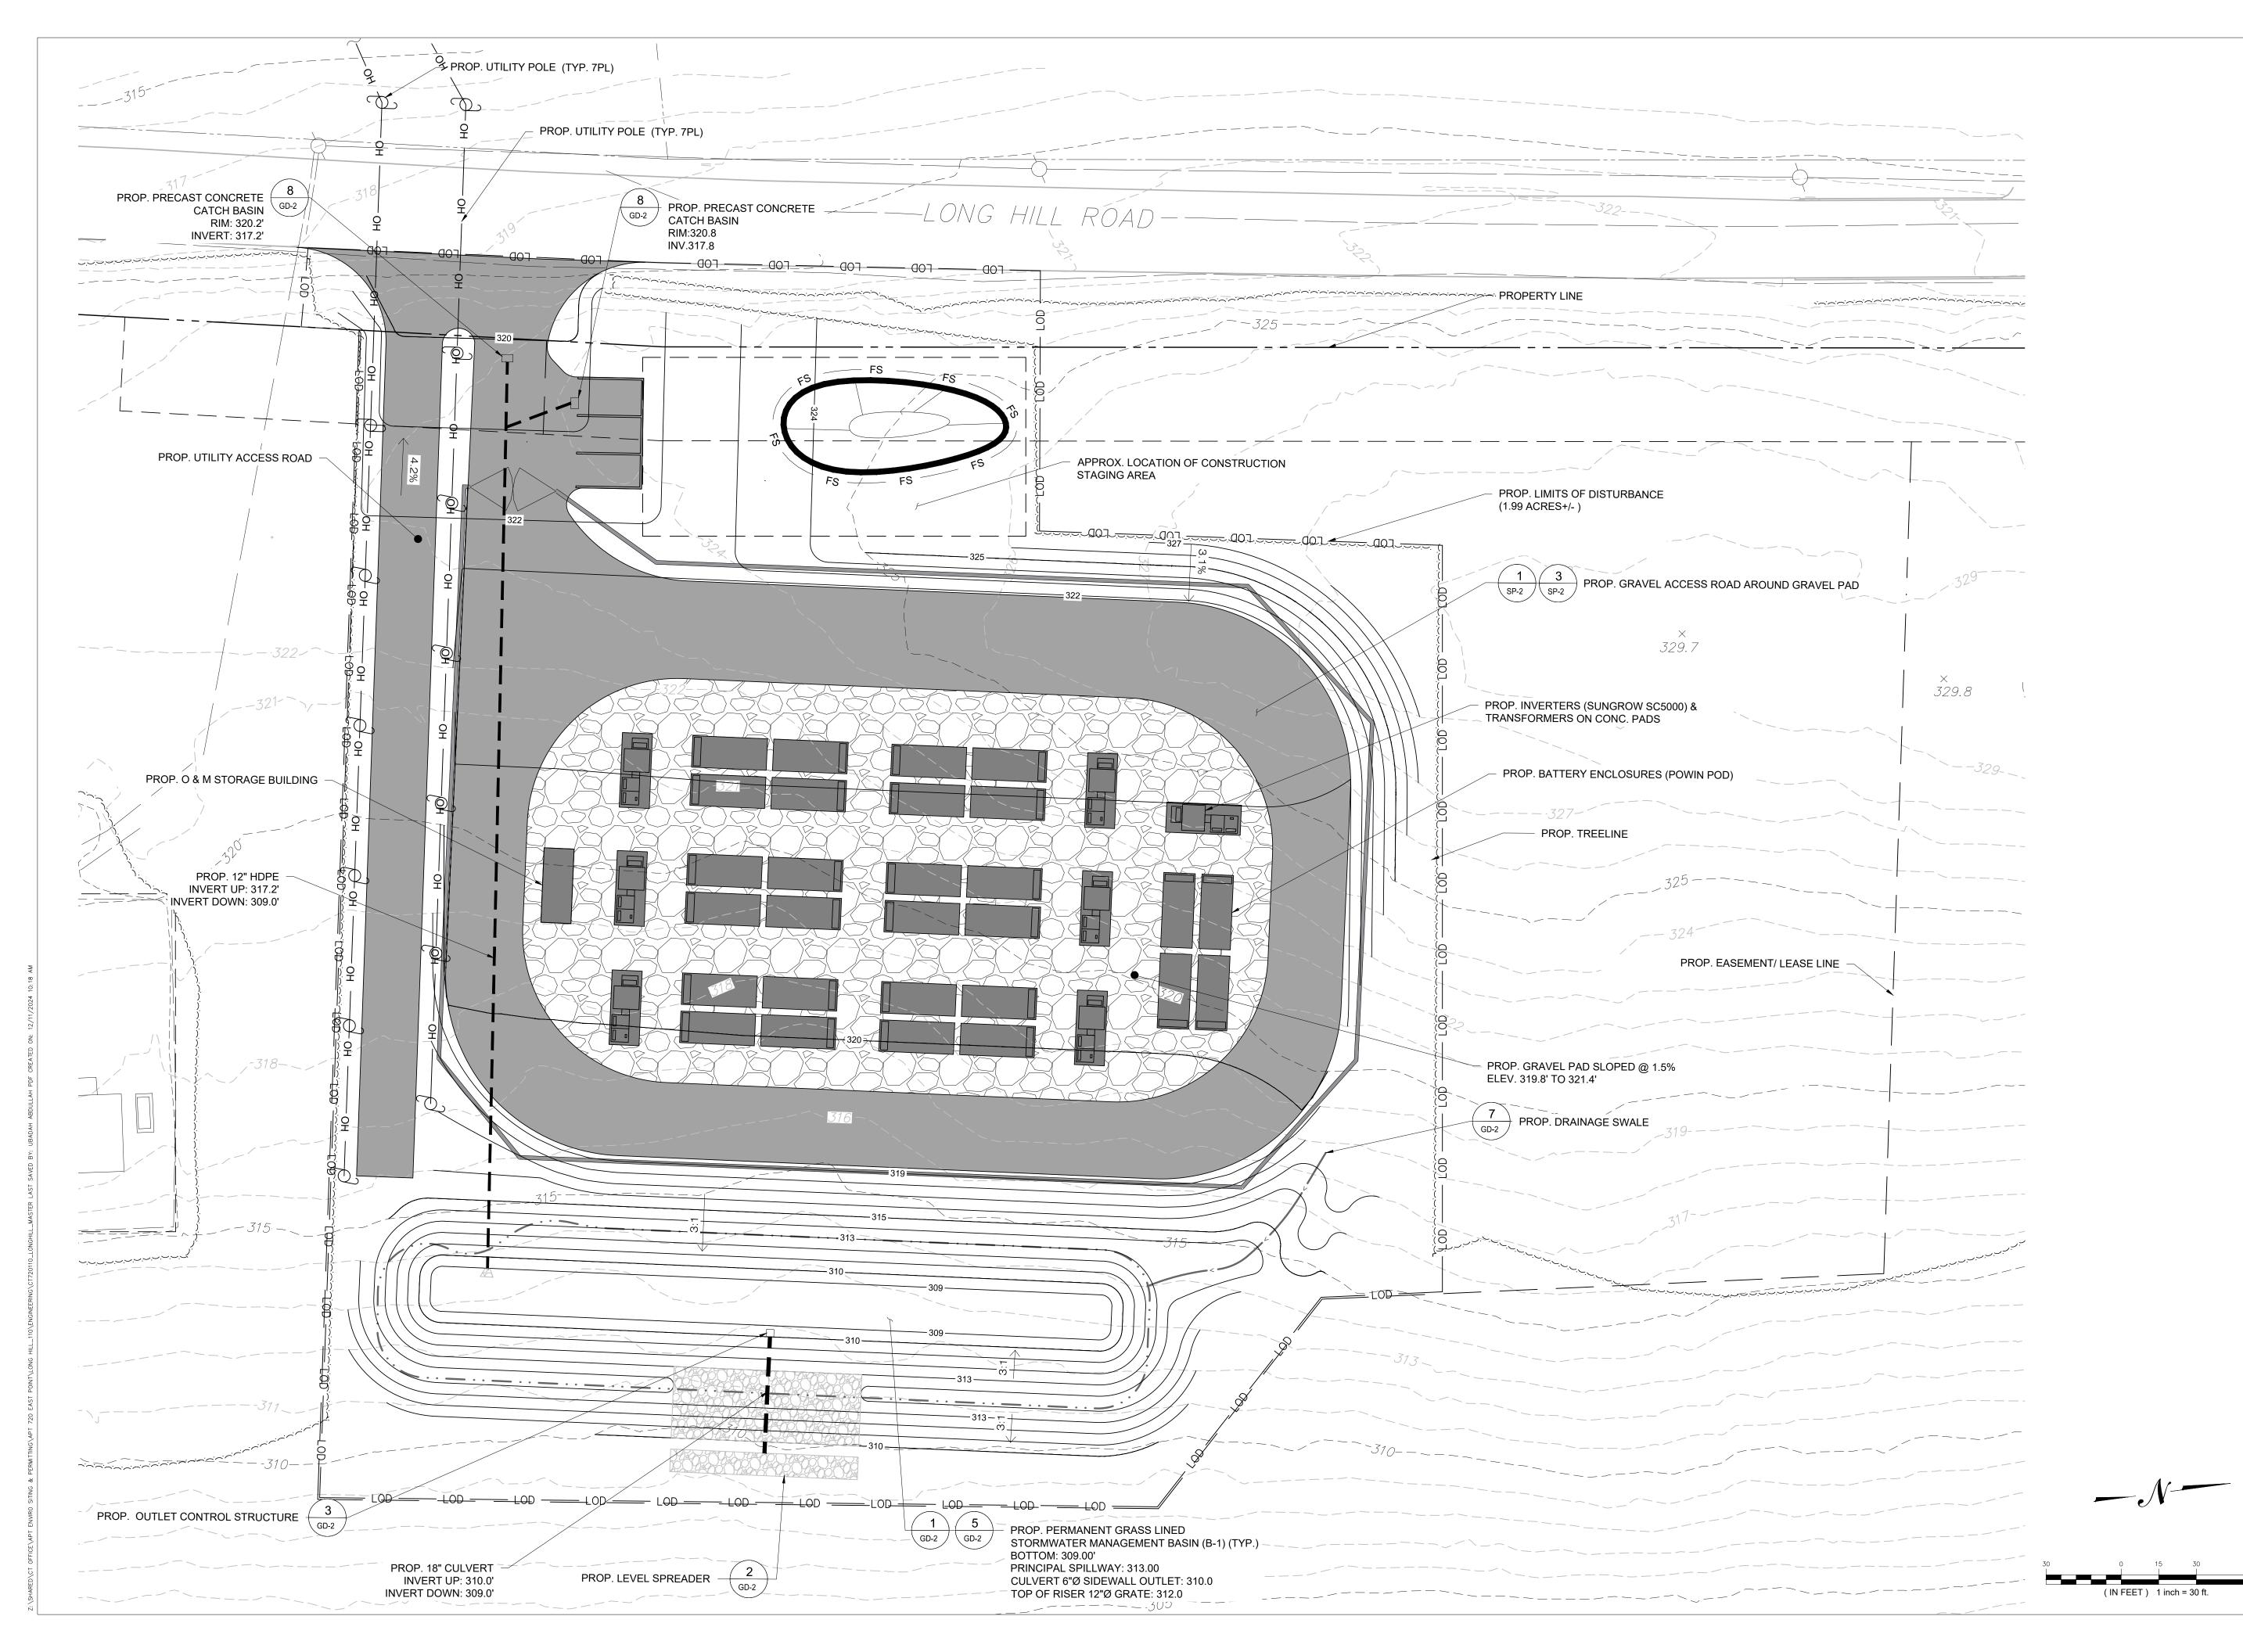
SHEET TITLE:

VEHICLE TURNING ANALYSIS

SHEET NUMBER:

(IN FEET) 1 inch = 20 ft.

TA-1





310 4TH STREET NE - 3RD FLOOR CHARLOTTESVILLE, VA 22902



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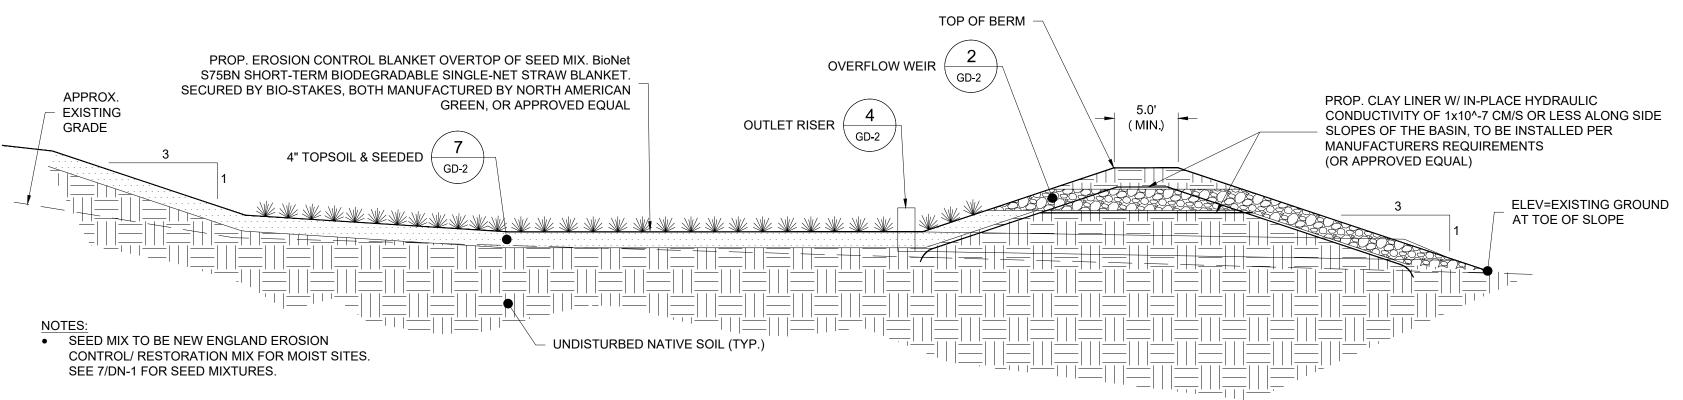
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SHEET TITLE:

GRADING & DRAINAGE PLAN


SHEET NUMBER:

GD-1




GRASS LINED STORMWATER BASIN


				HDP	E OUTLET PIPE SIZ	ZING TABLE				
BASIN	ORIFICE SIZE (IN)	ORIFICE ELEV. (FT.)	GRATE SIZE (IN)	GRATE ELEV. (FT)	GRATE	OUTLET PIPE SIZE (IN.)	OUTLET PIPE LENGTH (FT)	OUTLET PIPE SLOPE (%)	OUTLET PIPE INV. ELEV. AT STRUCTURE (FT)	OUTLET PIPE INV. AT OUTFALL (FT)
B-1	6	310.0	12	312.0	12	15	31.0	3.23%	310.0.0	309.00'

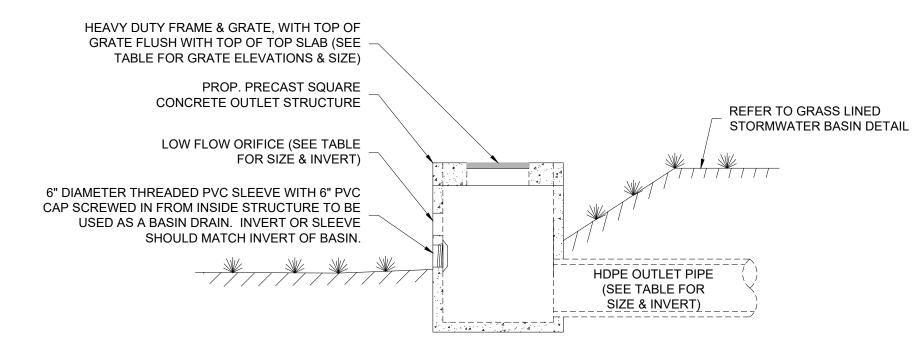


OUTLET CONTROL STRUCTURE GD-2 SCALE: N.T.S.

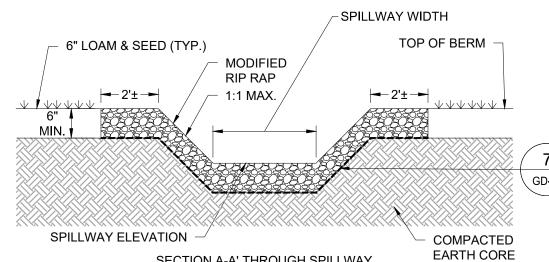

PROP. CLAY LINER W/ IN-PLACE HYDRAULIC CONDUCTIVITY OF 1x10^-7 CM/S OR LESS ALONG SIDE SLOPES OF THE BASIN, TO BE INSTALLED PER MANUFACTURERS REQUIREMENTS (OR APPROVED EQUAL)

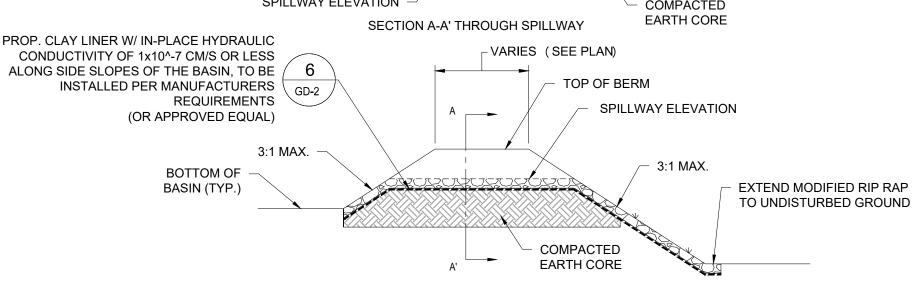

OVERFLOW WEIR DETAIL
SCALE: N.T.S.

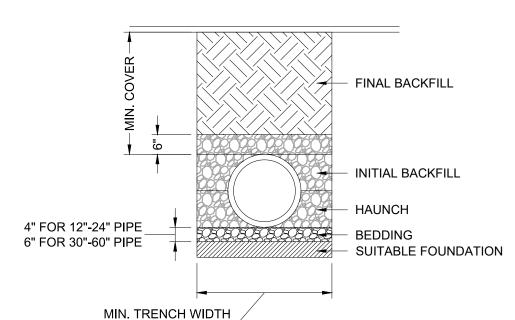


PIPE DIA. MIN. TRENCH WIDTH 23" 26" 10" 28" 12" 30" 15" 34" 18" 39" 24" 48" 30" 56" 36" 64" 48" 80" 60"

RECOMMENDED MIN. TRENCH WIDTH


(SEE TABLE)


- ALL PIPE SYSTEMS SHALL BE INSTALLED IN ACCORDANCE WITH ASTM D2321, "STANDARD PRACTICE FOR UNDERGROUND INSTALLATION OF THERMOPLASTIC PIPE FOR SEWERS AND OTHER GRAVITY FLOW APPLICATIONS", LATEST ADDITION.
- 2. MEASURES SHOULD BE TAKEN TO PREVENT MIGRATION OF NATIVE FINES INTO BACKFILL MATERIAL
- FOUNDATION: WHERE THE TRENCH BOTTOM IS UNSTABLE, THE CONTRACTOR SHALL EXCAVATE TO A DEPTH REQUIRED BY THE ENGINEER AND REPLACE WITH SUITABLE MATERIAL AS SPECIFIED BY THE ENGINEER. AS AN ALTERNATIVE AND AT THE DISCRETION OF THE DESIGN ENGINEER, THE TRENCH
- BOTTOM MAY BE STABILIZED USING A GEOTEXTILE MATERIAL. BEDDING: SUITABLE MATERIAL SHALL BE CLASS I, II OR III. THE CONTRACTOR SHALL PROVIDE DOCUMENTATION FOR MATERIAL SPECIFICATION TO ENGINEER. UNLESS OTHERWISE NOTED BY THE ENGINEER, MINIMUM BEDDING THICKNESS SHALL BE 4" (100mm) FOR 4"-24" (100mm-600mm); 6" (150mm) FOR 30"-60" (7S0mm-900mm).
- INITIAL BACKFILL: SUITABLÉ MATERIAL SHALL BE CLASS I, II OR III IN THE PIPE ZONE EXTENDING NOT LESS THAN 6" ABOVE CROWN OF PIPE. THE CONTRACTOR SHALL PROVIDE DOCUMENTATION FOR MATERIAL SPECIFICATION TO ENGINEER. MATERIAL SHALL BE INSTALLED AS REQUIRED IN ASTM D2321, LATEST EDITION.
- MINIMUM COVER: MINIMUM COVER, H, IN NON-TRAFFIC APPLICATIONS (GRASS OR LANDSCAPE AREAS) IS 12" FROM THE TOP OF PIPE TO GROUND SURFACE. ADDITIONAL COVER MAY BE REQUIRED TO PREVENT FLOTATION. FOR TRAFFIC APPLICATIONS, MINIMUM COVER, H, IS 12" UP TO 48" DIAMETER PIPE AND 24" OF COVER FOR 54"-60" DIAMETER PIPE, MEASURED FROM TOP OF PIPE TO BOTTOM OF FLEXIBLE PAVEMENT OR TO TOP OF RIGID PAVEMENT.

4 HDPE STORM DRAINAGE TRENCH DETAIL

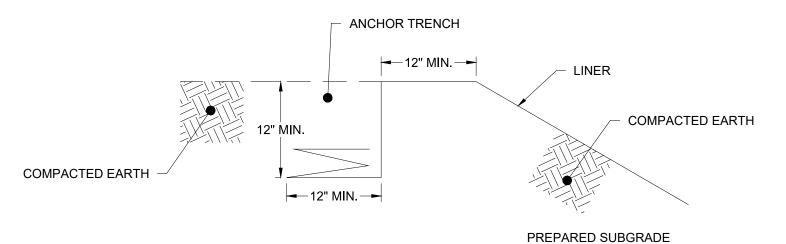

LINER ANCHOR DETAIL

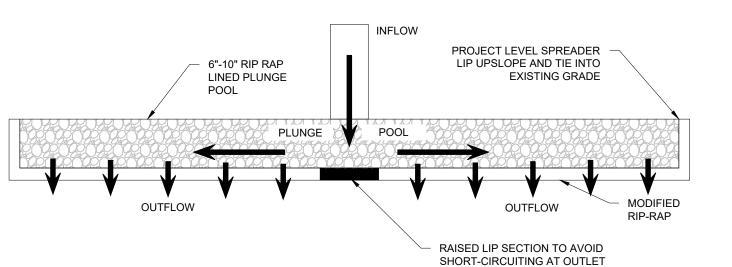

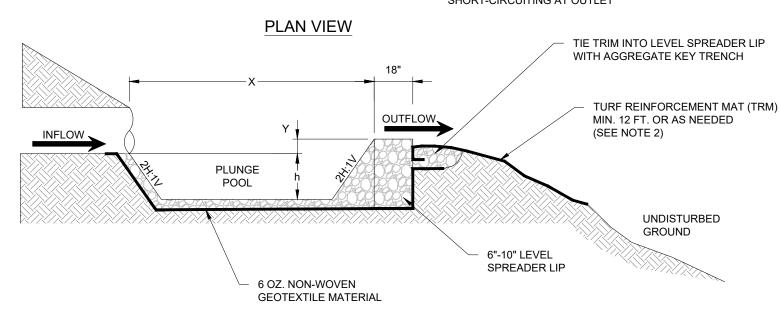


PROFILE VIEW

NOTES:


- UNDERLYING SOILS TO REMAIN UNDISTURBED, COMPACTED AND PROTECTED FROM HEAVY
- EQUIPMENT TO PRESERVE INFILTRATION CAPACITY. 2. LEVEL SPREADER TO BE INSTALLED COMPLETELY LEVEL ALONG THE EXISTING CONTOUR WITH
- A SMOOTH TRANSITION BETWEEN THE LEVEL SPREADER AND THE EXISTING GRADE. THE IDEAL ELEVATION OF THE LEVEL SPREADER LIP IS 3 INCHES ABOVE THE EXISTING GRADE. 3. THE MINIMUM WIDTH OF 12' OF TURF REINFORCEMENT MAT (TRM) IS TO BE INSTALLED
- IMMEDIATELY DOWNSLOPE OF THE LEVEL SPREADER LIP. CONTRACTOR TO INSTALL ADDITIONAL TRM AS NECESSARY BASED ON EXISTING SITE CONDITIONS TO ADEQUATELY STABILIZE THE DOWNSLOPE AREA.

PERMANENT LEVEL SPREADER SCALE: N.T.S.

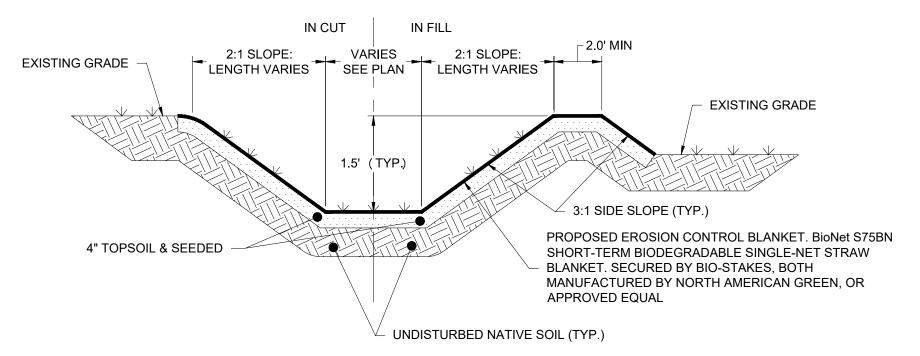

1. SEED MIX TO BE NEW ENGLAND EROSION CONTROL/ RESTORATION MIX FOR MOIST SITES ON THE BOTTOM OF THE BASIN AND NEW ENGLAND EROSION/RESTORATION MIX FOR DRY SITES ON THE SIDE SLOPES. 2. IF DEPTH VARIES FROM 2.0', SEE PLAN CALLOUTS.

GRASS LINED SWALE

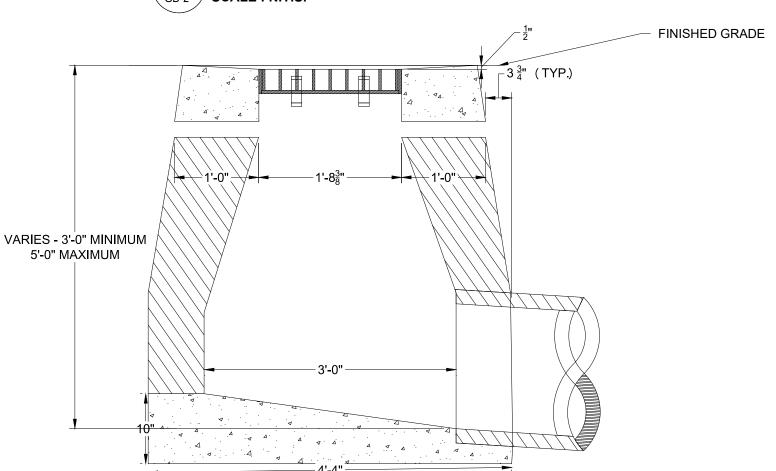

8 PRECAST CONCRETE CATCH BASIN GD-2 SCALE: N.T.S.



310 4TH STREET NE - 3RD FLOOR CHARLOTTESVILLE, VA 22902



567 VAUXHALL STREET EXTENSION - SUITE 311

WATERFORD, CT 06385 PHONE: (860)-663-1697 | | WWW.ALLPOINTSTECH.COM FAX: (860)-663-0935

	PE	RMIT DOCUMENTS		
NO	DATE	REVISION		
1	12/10/24	CLIENT REQUEST:UKA		
2				
3				
4				
5				
6				
7				

DESIGN PROFESSIONALS OF RECORD

PROF: THOMAS E. LITTLE, P.E. COMP: ALL-POINTS TECHNOLOGY CORPORATION, P.C. ADD: 567 VAUXHALL STREET **EXTENSION - SUITE 311** WATERFORD, CT 06385

OWNER: SBA PROPERTIES INC.

ADDRESS: 8051 CONGRESS AVE. **BOCA RATON, FL 33487**

LONG HILL BESS

SITE ADDRESS:

1825 SOUTH MAIN STREET MIDDLETOWN, CT 06457

APT FILING NUMBER: CT720110

DRAWN BY: UKA/ELZ

SHEET TITLE:

GRADING & DRAINAGE DETAILS

DATE: 10/23/24 CHECKED BY: TEL

SHEET NUMBER:

GD-2