
ATTACHMENT 1 (Civil Plan Set)

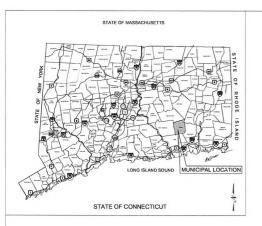

"SALEM BESS"

FAIRY LAKE, LLC

380 NEW LONDON ROAD **SALEM, CT 06420**

LIST OF DRAWINGS

T-1 TITLE SHEET

1 OF 1 TOPOGRAPHIC SURVEY

GN-1 GENERAL NOTES & LEGEND

OP-1 OVERALL LOCUS MAP

EC-1 EROSION & SEDIMENT CONTROL PLAN

EC-2 EROSION & SEDIMENT CONTROL NOTES

EC-3 EROSION & SEDIMENT CONTROL DETAILS

SP-1 SITE PLAN

SP-2 SITE PLAN DETAILS

TA-1 VEHICLE TURNING ANALYSIS

PR-1 ACCESS ROAD PLAN & PROFILE

GD-1 GRADING & DRAINAGE PLAN

GD-2 GRADING & DRAINAGE DETAILS

SITE INFORMATION

SITE NAME: "SALEM BESS"

LOCATION: 380 NEW LONDON ROAD SALEM, CT 06420

SITE TYPE/DESCRIPTION: ENERGY STORAGE SYSTEM 5 MW CONSISTING OF APPROX. 7 SOLBANK 3.0 BATTERIES, 5 EPC POWER CAB1000 INVERTERS, 2 TRANSFORMERS AND 2 DC

PROPERTY OWNER: 380 NEW LONDON ROAD HOLDINGS, LLC 380 NEW LONDON ROAD SALEM, CT 08420

PETITIONER: FAIRY LAKE, LLC 116 HUNTINGTON AVENUE - SUITE 601 BOSTON, MA 02116

ENGINEER CONTACT: THOMAS E. LITTLE, P.E. (860) 552-2046

LATITUDE: N 41° 27' 29.80° LONGITUDE: W 72° 14' 30.23'

MBLU: 06/002/B00 ZONE: SBA LAND USE: STORE/SHOP MDL-94 LAND CLASS CODE: 3220

TOTAL SITE ACREAGE: 14.48± AC. TOTAL DISTURBED AREA: 2.2± AC.

APPROX, VOLUME OF CUT: 1,486± CY APPROX, VOLUME OF FILL: 3,738± CY APPROX, NET VOLUME: 2,252± CY OF FILL

USGS TOPOGRAPHIC MAP



FAIRY LAKE, LLC

116 HUNTINGTON AVE SUITE 601 BOSTON , MA 02116

ALL-POINTS

DESIGN PROFESSIONALS OF RECORD PROF: THOMAS F. LITTLE, P.F.

OWNER: 380 NEW LONDON RD HOLDINGS LLC ADDRESS: 380 NEW LONDON ROAD SALEM, CT 06420


SALEM BESS

380 NEW LONDON ROAD SALEM, CT 06420

DATE: 11/06/24 CHECKED BY: TEL SHEET TITLE

TITLE SHEET

T-1

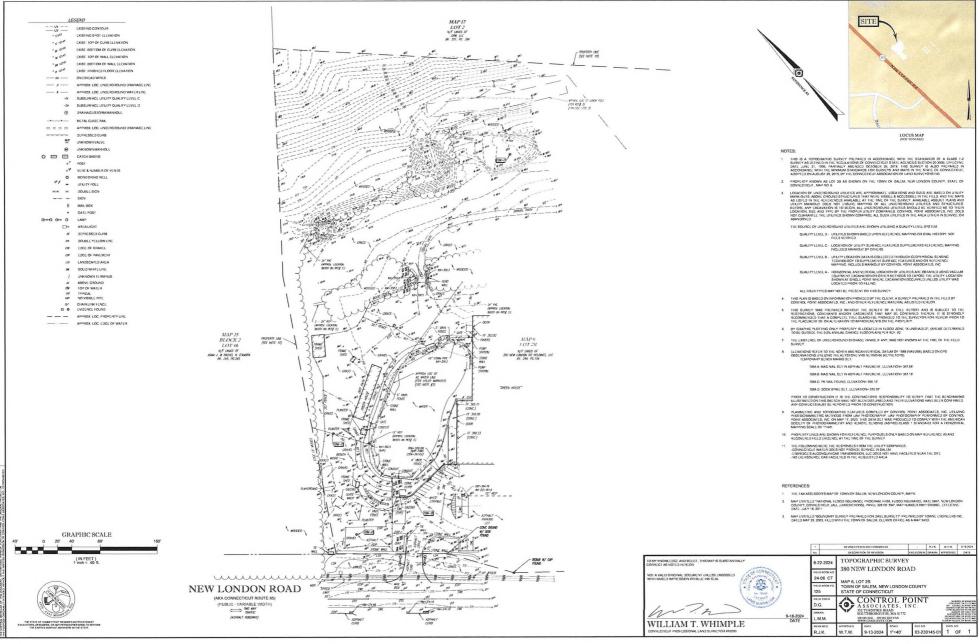

T ASSOCIATES, INC. - ALL RIGHTS RESERVED.

GENERAL NOTES

- ALL CONSTRUCTION SHALL COMPLY WITH PROJECT DEVELOPER STANDARDS, TOWN OF SALEM STANDARDS, CONNECTICAT DEPARTMENT OF TRANSPORTATION STANDARDS AND SPECIFICATIONS IN THE ABOVE REFERENCED INCREASING RIERARCHY. IF SPECIFICATIONS ARE IN CONFLICT, THE MORE STRINGENT SPECIFICATION SHALL APPLY
- 2 IF NO PROJECT CONSTRUCTION SPECIFICATION PACKAGE IS PROVIDED BY THE PROJECT DEVELOPER OR THEIR REPRESENTATIVE, THE CONTRACTOR SHALL COMPLY WITH THE MANUFACTURER, TOWN O SALEM, OR CONNECTION DEPARTMENT OF TRANSPORTATION STANDARD SPECIFICATIONS, AND BE IN ACCORDANCE WITH ALL APPLICABLE OSHA, FEDERAL, STATE AND LOCAL REGILLATIONS.
- 3 THE PROJECT DEVELOPER IS RESPONSIBLE FOR OBTAINING ALL NECESSARY ZONING AND STORMWATER PERMITS RECURRED BY GOVERNMENT AGENCIES PRIOR TO CONSTRUCTION. THE CONTRACTOR SHALL DRIVEN ALL TOWN OF SALEM CONSTRUCTION FEMELY THE CONTRACTOR SHALL BOXES, PAY ALL FEES, PROVIDE PROOF OF INSURANCE AND PROVIDE TRAFFIC CONTROL INCESSARY FOR THIS WORK.
- REFER TO FLANS, DE FALS AND REPORTS PREPARED BY ALL PRINTS FESTING, DOTY CORRESPA-SEN. FOR ADDITIONAL NORMANION THE CONTRACTOR SHALL DRIFTY ALL SITE CONDITIONS IN THE FIELD AND CONTACT THE PROJECT DEVELOPER IF THERE ARE ANY QUESTIONS OR CONVEIGTS REGARDING THE CONSTRUCTION DOCUMENTS AND/OFF PED CONTROLLORS OF THAT APPROPRIATE REVISIONS ON A SPECIFICATION SHALL BE CONFIRMED WITH THE PROJECT DEVELOPERS CONSTRUCTION ANAGER PRICE TO CONSTRUCTION.
- THE CONTRACTOR SHALL SUBMIT SHOP DRAWINGS OF ALL PRODUCTS, MATERIALS PER FLANS, AND SPECIFICATIONS TO THE PROJECT DEVELOPER FOR REVIEW AND APPROVAL PRIOR TO FABRICATION OF DELIVERY TO THE SITE. ALLOW A MINIMUM OF 14 WORKING DAYS FOR REVIEW.
- SHOULD ANY UNKNOWN OR INCORRECTLY LOCATED EXISTING PIPING OR OTHER UTILITY BE UNCOVERED DUBING EXCAVATION, CONSULT THE PROJECT DEVELOPER IMMEDIATELY FOR DIRECTIONS BEFORE PROJECTION OF UNITED WITH WORK IN THIS AREA.
- DO NOT INTERRUPT EXISTING UTILITIES SERVICING FACILITIES OCCUPIED AND USED BY THE PROJECT DEVELOPER OR OTHERS DURING OCCUPIED HOURS, EXCEPT WHEN SUCH INTERRUPTIONS HAVE BEEN AUTHORIZED IN WRITING BY THE PROJECT DEVELOPER AND THE LOCAL MUNICIPALITY. INTERRUPTIONS SHALL DILLY OCCUPI AFTER ACCEPTABLE TEMPORARY SERVICE HAS BEEN.
- 8 THE CONTRACT LIMIT IS THE PROPERTY LINE UNLESS OTHERWISE SPECIFIED OR SHOWN ON THE CONTRACT DRAWINGS
- 10 THE CONTRACTOR ISHALL COMPLY WITH GIR4 CFR 29 PART 1926 FOR EXCAVATION TRENCHING AND 1.0 CONSTRUCTION OF SITE IMPROVEMENTS MAY BEGIN UNTIL THE PROPER EROSION CONTROL MERCHANDED AND 1.0 CONSTRUCTION OF SITE IMPROVEMENTS MAY BEGIN UNTIL THE PROPER EROSION CONTROL MERCHANDED AND 1.0 CONSTRUCTION OF SITE IMPROVEMENTS MAY BEGIN UNTIL THE PROPER EROSION CONTROL MERCHANDED AND 1.0 CONSTRUCTION OF SITE IMPROVEMENTS MAY BEGIN UNTIL THE PROPER EROSION CONTROL MERCHANDED AND 1.0 CONSTRUCTION OF SITE IMPROVEMENTS MAY BEGIN UNTIL THE PROPER EROSION CONTROL MERCHANDED AND 1.0 CONSTRUCTION OF SITE IMPROVEMENTS MAY BEGIN UNTIL THE PROPER EROSION CONTROL MERCHANDED AND 1.0 CONSTRUCTION OF SITE IMPROVEMENTS MAY BEGIN UNTIL THE PROPER EROSION CONTROL MERCHANDED AND 1.0 CONSTRUCTION OF SITE IMPROVEMENTS MAY BEGIN UNTIL THE PROPER EROSION CONTROL MERCHANDED AND 1.0 CONSTRUCTION OF SITE IMPROVEMENTS MAY BEGIN UNTIL THE PROPER EROSION CONTROL MERCHANDED AND 1.0 CONSTRUCTION OF SITE IMPROVEMENTS MAY BEGIN UNTIL THE PROPER EROSION CONTROL MERCHANDED AND 1.0 CONSTRUCTION CONTROL MERCHANDED CO
- 11. THE ENGINEER IS NOT RESPONSIBLE FOR SITE SAFETY MEASURES TO BE EMPLOYED DURING THE ENGINEER IN OUR PROPUNDING FOR STIED RESIDENT MERCHANDER IN DE EMPLITED DUPING MORE THAN THE ENGINEER HAS NO CONTRACTUAL DUTY TO CONTROL HE SERVES METHODS OF MEANS OF THE WORK, JOB SIT RESPONSIBILITIES, SUPERVISION OF PERSONNEL OR TO SUPERVISE STAFF VAND ON NOT VOLUNITARILY ASSUME ANY SUCH DUTY OR RESPONSIBILITY.
- 12. THE CONTRACTOR SHALL RESTORE ANY DRAINAGE STRUCTURE, PIPE, CONDUIT, PAVEMENT, CURBING, SIDEWALKS, LANDSCAPED AREAS OR SIGNAGE DISTURBED DURING COMSTRUCTION TO THEIR ORBINAL CONDITION OR BETTER, AS APPROVED BY THE PROJECT DEVELOPER OR TOWN OF
- 13 THE CONTRACTOR SHALL PROVIDE AS-BUILT RECORDS OF ALL CONSTRUCTION (INCLUDING UNDERGROUND UTILITIES) TO THE PROJECT DEVELOPER AT THE END OF CONSTRUCTION.
- 14. ALTERNATIVE METHODS AND PRODUCTS, OTHER THAN THOSE SPECIFIED, MAY BE USED IF REVIEWED AND APPROVED BY THE PROJECT DEVELOPER, ENGINEER, AND APPROPRIATE REGULATORY AGENCY PRIOR TO INSTALLATION DURING THE BIDDING/CONSTRUCTION PROCESS.
- 18 INCOMPATION OF LESS TIRED UTILITIES AND STORM DRAINAGE SYSTEMS HAS BEEN COMPILED FROM WHAT AND ASSESSMENT OF THE PROPERTY O
- 16. NO CONSTRUCTION OR DEMOLITION SHALL BEGIN UNTIL APPROVAL OF THE FINAL PLANS AND PERMITS ARE GRANTED BY ALL GOVERNING AND REGULATORY AGENCIES.

SITE PLAN NOTES

- D BY CONTROL POINT ASSOCIATES, INC. DATED SEPTEMBER 18, 2024.
- THE CONTRACTOR SHALL FOLLOW THE RECOMMENDED SEQUENCE OF CONSTRUCTION NOTES PROVIDED ON THE EROSION CONTROL, PLAN OR SUBMIT AN ALTERNATE PLAN FOR APPROVAL BY THE ENDINEER ANDION PERMITTING AGENCIES PRIOR TO THE START CONSTRUCTION. ALLOW A MINIMUM OF 14 WORKING DAYS FOR REVIEW.
- PROPER CONSTRUCTION IN PROCEDURES SHALL BE FELLOWED ON ALL IMPROVEMENTS WITHIN PARCEL SO AS TO PREVENT THE SET IND OF ARY WATER-COURSE OF BYWER IN A ROCKPORNOSE. SEED AS TO PREVENT THE SET THE SET IN A CONTRIBUTE OF THE SET IN A CONTRIBU
- ALL SET WORK, MA ERNAL OF CONSTRUCTION, AND COUST RECTION METHODS FOR SATHWARD AND STORM DEMANDER WORK, SHALL, CONCEINS OF THE RESPECTATIONS AND SET RES. AND STORM DEPARTS AN SPECIFICATIONS, AND/OR PROJECT GEOTECHNICAL REPORT, AND SMALL BE FLANGUR WAS ACCORDANCE WITH THE APPLICABLE SPECIFICATIONS UNDER THE SUPERVISION OF A QUALIFIED PROFESSIONAL ENGINEER. MATERIAL SHALL BE COMPACTED IN 8° LIFTS TO 85% OF THE MAXIMUM DIVERSIONAL ENGINEER. MATERIAL SHALL BE COMPACTED IN 8° LIFTS TO 85% OF THE MAXIMUM DIVERSIONAL SECTION OF THE STATE OF THE
- ALL DISTURBANCE INCURRED TO PUBLIC, MUNICIPAL, COUNTY, STATE PROPERTY DUE TO
- IF IMPACTED OR CONTAMINATED SOIL IS ENCOUNTERED BY THE CONTRACTOR, THE CONTRACTOR SHALL SUSPEND EXCAVATION WORK OF IMPACTED SOIL AND NOTIFY THE PROJECT DEVELOPER ANDORIP PROJECT DEVELOPER ANDORIP MOVING TO EVELOPER ANDORIOAMENTAL CONSULTANT PRIOR TO PROCEEDING WITHFURTHER WORK IN THE IMPACTED SOIL LOCATION UNIT, FURTHER INSTRUCTED BY THE PROJECT DEVELOPERS ANDORIP PROJECT DEVELOPERS ANDORIMENTAL CONSULTANT

CONSTRUCTION SEQUENCE NOTES

- THE GENERAL CONSTRUCTION NOTES ARE AS FOLLOWS
- GENERAL CONSTRUCTION NOTES ARE AS FOLLOWS: THE SITE CONTRACTOR SHALL BE FULLY RESPONSIBLE TO CONTROL CONSTRUCTION SUCH THAT SEDIMENT ATON SHALL NOT AFFECT PROADSHIGHWAYS AND THEIR DRAINAGE SYSTEM. NEIGHBORING PROPERTIES, WETLANDS AND REGULATORY PROTECTED AREAS, WHETHER SUCH SEDIMENTATION IS CAUSED BY WATER, WIND, OH DIRECT DEPOSIT, DESIGNATED ACCESS DRIVES. MUST BE USED TO THE MAXIMUM EXTENTS POSSIBLE. IT IS REQUIRED THAT THE SITE CONTRACTOR PERFORM A DAILY INSPECTION OF ALL EROSION AND SEDIMENT CONTROL MEASURES EMPLOYED
- A CTUBE? APPROVED CHAIPED INSPECTOR SHALL BE ASSIGNED TO BE HESPONSBLE FOR PERFORMING INSPECTIONS AND PREPARENT REPORTS IN ACCORDANCE WITH SECTION 59(4)(8) MINEMAN, AND SHALL BE REQUIRED WITHIN SECTION OF A RAINMALL EVENT EXCEEDING O. IS NICHES. THE ENGINEER OF RECORD SHALL BE REQUIRED TO PEVEW AND COUNTER-SIGN THE PREPARED WEEKLY PEPORTS.
- ENGINEER OF RECORD WILL PERFORM MONTHLY PLAN IMPLEMENTATION INSPECTIONS UNTIL EROSION CONTROLS ARE IN PLACE, OR THE FIRST THREE MONTHS (WHICHEVER IS GREATER) AND WILL PREPARE REPORTS OF THE FINDINGS.
- THROUGHOUT THE COURSE OF THE CONSTRUCTION PROJECT, ADDITIONAL SEDMENT AND EROSION CONTROL MEASURES MAY BE WARRANTED AT THE DISCORTION OF THE CULALIFED INSPECTOR ANDIOR DESIGN EGINEET. THESE IMPROVEMENTS MUST BE IMPLEMENTED IN A TIMELY FASHION IN ACCORDANCE WITH THE REQUIREMENTS OF THE CONSTRUCTION GENERAL PERMIT.
- PRIOR TO CONSTRUCTION, THE APPLICANT SHALL PROVIDE THE TOWN OF GRANBY WITH THE NAME OF CONTACT AND 24-HOUR CONTACT INFORMATION.
- CONTRACTOR SHALL ADHERE TO 2024 CONNECTICUT GUIDELINES FOR EROSION AND SEDIMENT CONTROL, AS AMENDED
- THE CONTRACTOR SHALL HOLD PRE-CONSTRUCTION MEETING(S). ATTENDEES SHALL, IN, NOT BE LIMITED TO, REPRESENTATIVES OF THE GENERAL CONTRACTOR, SITE CONTRACT COTOEPS, TOWN OF GRANBY, ENGINEER OF PECODO, AND QUALIFIED SWPPP INSPECTOR.
- THE CONTRACTOR SHALL CONTACT CALL-BEFORE YOU DIG (1-809-922-4455) PRIOR TO ENGAGING IN 10. RECOGNITION OF UTILITY PROVIDER FACILITIES, SUCH AS POLES, SHALL BE DONE IN ACCORDANCE WITH THE RETURN ACTIVITIES AT THE SITE.

 WITH THE REQUIREMENTS OF THE UTILITY PROVIDER.

- ANTICIPATED WORK HOURS WILL BE BETWEEN 7:00 AM AND 5:00 PM MONDAY THROUGH FRIDAY. IF ANY VARIATION FROM THIS SCHEDULE IS TEMPORABILLY REQUIRED, THE PROJECT TEAM SHALL PROVIDE NOTICE TO CONNECTICUT STING COUNCIL.

- PRE-CONSTRUCTION SITE PROTECTION SEQUENCE
 1 SURVEY AND MARK ALL WOODLAND CLEARING LIMITS.
- EXISTING AND PROPOSED ACCESS ROADS SHALL BE DESIGNATED AS EARLY AS FEASIBLE AND USED PRIMARILY FOR CONSTRUCTION TRAFFIG.
- 3 FIELD SURVEY AND MARK BOUNDARY BETWEEN CLEARING LIMITS AND GRURRING LIMITS
- INSTALL EROSION AND SEDIMENT CONTROLS FOLLOWING THE CT GUIDELINES AND MANUFACTURERS DIRECTIONS. DURING CONSTRUCTION, THE CONTRACTOR SHALL INSTALL MEASURES AS REQUIRED BY THE ENGINEER OF RECORD OR QUALIFIED INSPECTOR, TO PREV SEDIMENT LADOS OF DISCHARGING OFFSTE.
- INSTALL TEMPORARY BRIDGE PER MANUFACTURER RECOMMENDATIONS
- INSTALL STORMATER BASIN AS EARLY AS FEASIBLE IN ACCORDANCE WITH THE APPROVED SITE SPECIFIC SWIFCP AND CT GUIDELINES DISCHARGE AREAS BELCOV QUIFALLS MUST BE INSPECTED TO CONFIRM FLOW WILL BE COVER THAT BE ORDING AND SEFF THOM SE REDCOURAGED IF DISTURBED SOLIS ARE PRESENT, THE ENGINEER OF RECORD TO PROVIDE CORRECT MEASURES TO ADDRESS CONDITION.
- SEED AND PROTECT DISTURBED SOILS AROUND SEDIMENT TRAPS AND BASINS WITHIN 72 HOURS OF
- 8. CLEAR AND GRUB VEGETATION PER SITE PLANS.
- THE USE OF A TUB GRINDER IS RECOMMENDED FOR THE MULCHING OF FELLED TREES IF CHIPPE ON SITE. MULCH SHALL NOT BE CAST WIDESPREAD ACROSS SITE AS IT WILL INHIBIT VEGETATIVE
- PERFORM EARTHWORK AND SHAPING ON THE SITE. TOPSOIL SHALL BE STRIPPED AND STOCKPILED FROM AREAS PROPOSED FOR REGRADING EXCESS SOIL WHICH IS NOT REUSED IN PROPOSED SITE GRADING AS DEPICTED ON PLANS CAN BE HAULED OFF-SITE.
- TOPSOIL SHALL BE REPLACED OVER REGRADED AREAS UPON COMPLETION OF MASS EARTHWORK ACTIVITIES AND AREAS WHICH WERE DISTURBED BY MASS EARTHWORK OPERATIONS SHALL BE RESECUED WITHIN 72 HOURS OF COMPLETION.
- ROUGHOUT CONSTRUCTION, THE CONTRACTOR SHALL ADDRESS ONGOING EROSION PROBLEMS ING TEMPORARY DIVERSIONS AND FILLING AND GRADING GUILLIES.

CONSTRUCTION SEQUENCE 1 INSTALL STABILIZED GRAVEL ROADS.

- 2 INSTALL ELECTRICAL COMPONENTS AND INTERCONNECTION.
- 3 INSTALL SITE FENCING AND/OR SOUND WALL
- 4 RESEED, REPAYE, AND/OR REPLANT ANY AREAS DISTURBED BY CONSTRUCTION
- 5 AFTER SITE IS STABILIZED, AND AFTER INSPECTION BY DESIGN ENGINEER, OR OTHER OWNERS REPRESENTATIVE, REMOVE TEMPORARY EROSION AND SEDIMENT CONTROLS. ENTIRE SITE SHALL BE CHECKED FOR AND CLEANED OF SEDIMENT AS NEEDED

UTILITY NOTES

- CONTRACTOR IS RESPONSIBLE FOR CONTACTING THE TOWN OF SALEM TO SECURE CONSTRUCTION PERMITS AND FOR PAYMENT OF FEES FOR STREET CUTS AND CONNECTIONS TO EXISTING UTILITIES.
- REPERT OF DAWNINGS BY PROJECT DEVELOPER FOR THE CASTS EXECUTION TO LEAVE HIS DAY INSTALL SHEET OF DAWNINGS AND INTERCONNECTION TO EXISTING ELECTRICAL GRID SHE CONTRACTOR SHALL SUPPLY AND INST PIPE ADAPTERS AS NECESSARY AT BUILDING CONNECTION POINT OR AT EXISTING UTILITY OR PIPE CONNECTION POINT. THESE DETAILS ARE NOT INCLUDED IN THESE PLANS.
- UTILITY LOCATIONS AND PENETRATIONS ARE SHOWN FOR THE CONTRACTORS INFORM SHALL BE VERRIED WITH THE ELECTRICAL ENGINEER AND THE PROJECT DEVELOPERS CONSTRUCTION MANAGER PRIOR TO THE START OF CONSTRUCTION.
- THE CONTRACTOR SHALL VISIT THE SITE AND VERIFY THE ELEVATION AND LOCATION OF ALL JTILITIES BY VARIOUS MEANS PRIOR TO BEGINNING ANY EXCAVATION. TEST PITS SHALL BE DUG AT ALL LOCATIONS WHERE PROP. SANITARY SEWERS AND WHERE PROP. STORM PIPING WILL CROSS EXISTING UTILITIES, AND THE HORIZONTAL AND VERTICAL LOCATIONS OF THE UTILITIES SHALL BI DETERMINED. THE CONTRACTOR SHALL CONTACT THE PROJECT DEVELOPER IN THE EVENT OF ANY DISCOVERED OR INFORESEEN CONFLICTS BETWEEN EXISTING AND PROPOSED SANITARY SEWERS STORM PIPING AND UTILITIES SO THAT AN APPROPRIATE MODIFICATION MAY BE MADE.
- UTILITY CONNECTION DESIGN AS REFLECTED ON THE PLAN MAY CHANGE SUBJECT TO UTILITY PROVIDER AND GOVERNING AUTHORITY STAFF REVIEW
- PROVIDER AND GROVENING AUTHORITS DIFFE HEVILLY.

 THE CONTRACTOR SHALL ENSURE THAT ALL UTILITY PROVIDERS AND GOVERNING AUTHORITY
 STANDARDS FOR MATERIALS AND CONSTRUCTION METHODS ARE MET. THE CONTRACTOR SHALL
 PERFORM PROPER COORDINATION WITH THE RESPECTIVE UTILITY PROVIDER.
- THE CONTRACTOR SHALL ARRANGE FOR AND COORDINATE WITH THE RESPECTIVE LITE ITY THE CONTRACTOR SHALL APPRAISE FOR AND COORDINATE WITH THE RESPECTIVE UTILITY PROVINCIES FOR SERVICE INSTALLATIONS AND COMMECTIONS. THE CONTRACTOR SHALL PLAY ALL COORDINATE WORK TO BE PERFORMED BY THE VARIOUS UTILITY PROVINCIES AND SHALL PLAY ALL FEES FOR CONNECTIONS, DISCONNECTIONS, ENCOLATIONS, INSPECTIONS, AND DEADULING NUMBERS OTHERWISE STATED IN THE PROJECT SPECIFICATIONS MANUAL AND/OR GENERAL CONDITIONS OF
- ALL EXISTING PAVEMENT WHERE LITH ITY PIPING IS TO BE INSTALLED SHALL BE SAW CHT. AFTER UTILITY INSTALLATION IS COMPLETED, THE CONTRACTOR SHALL INSTALL TEMPORARY AND/OR PERMANENT PAVEMENT REPAIR AS DETAILED ON THE DRAWINGS OR AS REQUIRED BY THE TOWN OF SALEM
- ALL PIPES SHALL BE LAID ON STRAIGHT ALIGNMENTS AND EVEN GRADES USING A PIPE LASER OR OTHER ACCUPATE METHOD.
- THE CONTRACTOR SHALL COMPACT PIPE BACKFILL IN 8" LIFTS ACCORDING TO THE PIPE BEDDING DETAILS. TRENCH BOTTOM SHALL BE STABLE IN MIGH GROUNDWATER AREAS A PIPE FOUNDATION SHALL BE USED PER THE TRENCH DETAILS AND IN AREAS OF PROCE EXCAVATION.
- 12. CONTRACTOR TO PROVIDE STEEL SLEEVES AND ANNULAR SPACE SAND FILL FOR UTILITY PIPE AND CONDUIT CONNECTIONS UNDER FOOTINGS.
- 13 ALL UTILITY CONSTRUCTION IS SUBJECT TO INSPECTION FOR APPROVAL PRIOR TO BACKFILLING, IN ACCORDANCE WITH THE APPROPRIATE UTILITY PROVIDER REQUIREMENTS.
- 14. A ONE-FOOT MIMIMUM VERTICAL CLEARANCE BETWEEN MATTER, GAS, ELECTRICAL, AND TELEPHONE LINES AND STORM PRIPAGS SHALL BE PROVIDED. A SIX-NOCH MIMMUM CLEARANCE SHALL BE LINES AND STORM PRIPAG SHALL BE PROVIDED. A SIX-NOCH MIMMUM CLEARANCE SHALL BE MARITAINED BETWEEN STORM PRIPAG AND SANITARY SEVER B. 69 ACT 10 TO BE NOCH VERTICAL. CLEARANCE BETWEEN SANITARY SEVER IPPING ON STORM PIPING SHALL REQUIRE CONCRETE ENCASEMENT OF THE SANITARY PRIPAG.
- THE CONTRACTOR SHALL RESTORE ANY UTILITY STRUCTURE, PIPE, CONDUIT, PAVEMENT, CURBING. SIDEWALKS, DRAINAGE STRUCTURE, SWALE OR LANDSCAPED AREAS DISTURBED DURING CONSTRUCTION, TO THEIR ORIGINAL CONDITION OR BETTER TO THE SATISFACTION OF THE PROJECT DEVELOPER AND TOWN OF SALEM.
- INCHMATION ON EXISTING UTLITES AND STORM DRAINING HAS BEEN COMPILED FROM AVAILABLE MINORMATION BULLOUNG UTLITED FOUNDER AND MINORMATION BANDOR RELED SURVEY. AND IS NOT GUARANTEED COPINED FOR COMPILED FROM STORM DRAINING ARE SHOWN AND IS NOT GUARANTEED COPINED FOR COMPILED FOR C INFORMATION ON EXISTING LITERIES AND STORM DRAINAGE HAS BEEN COMPILED FROM AVAILABLE
- THE CONTRACTOR SHALL ARRANGE AND COORDINATE WITH UTILITY PROVIDERS FOR WORK TO BE PERFORMED BY UTILITY PROVIDERS. THE CONTRACTOR SHALL PAY ALL UTILITY FEES UNLESS OTHERWISE STATED IN THE PROJECT SPECIFICATION MANUAL AND GENERAL CONDITIONS, AND REPAIR PAYEMENTS AS NECESSARY.
- 18. ELECTRIC DRAWINGS AND REQUIREMENTS ARE NOT INCLUDED AS PART OF THIS DRAWING SET AND SHOULD BE OBTAINED FROM THE PROJECT DEVELOPER
- ALTERNATIVE METHODS AND PRODUCTS OTHER THAN THOSE SPECIFIED MAY BE USED IF REVIEWED AND APPROVED BY THE PROJECT DEVELOPER, ENGINEER, AND APPROPRIATE REGULATORY AGENCIES PRODUCT OR INSTILLATION.
- THE CONTRACTOR SHALL MAINTAIN ALL FLOWS AND UTILITY CONNECTIONS TO EXISTING BUILDINGS WITHOUT INTERRUPTION UNLESS/UNTIL AUTHORIZED TO DISCONNECT BY THE PROJECT DEVELOPER TOWN OF SALEM, UTILITY PROVIDERS AND GOVERNING AUTHORITIES.

EXISTING PROPERTYLINE ____ ----EASEMENT ____ ------TREE LINE WETLAND _v__v__v WETLAND BUFFE VERNAL POOL VERNAL POOL BUFFER WATERCOURSE WATERCOURSE BUFFER _____ MAJOR CONTOUR MINOR CONTOUR

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- 100 -

- 100 -

GENERAL LEGEND

FAIRY LAKE, LLC

116 HUNTINGTON AVE SUITE 601 BOSTON MA 02116



CSC SUBMISSION NO DATE REVISION

ENVIRONMENTAL NOTES - RESOURCES PROTECTION MEASURES

BAT PROTECTION PROGRAM
THE PROTOSED FACILITY SI LOCATED WITHIN SENSITIVE HABITAT KNOWN TO BE USED BY
MORTHERIN LONG-SARED BAT CINLES", MYOTIS SEPTENTRIONALIS), A FEDERALLY. ANDASTATE LISTED ENDANGERED SPECIES, AND TRICOLORED BAT (TICE): PERMYOTIS SUBHAFEDERALLY PROTOSED ENDANGERED SAND STATE ENDANGERED SECIES, IN ORDER TO REPERMYOTIS THE ENDANGERED SECIES, IN ORDER TO REPERMY DISTRICT. NOT FERRI CINC. CARE DID AT YALLES, WHO IS SEPHICH FORMING, A FEDERALLY, AND ILLANDIS, A FEDERALLY AND ILLANDIS, A FEDERALLY AND ILLANDIS, A FEDERALLY REPORTED SENDING THE SERVICE OF THE

UNDERGROUND

VERHEAD ELECTR

BASIN SWALE

CENICE

DISTURBANCE FILTER SOCK

SILT FENCE

ELECTRIC

- BAT TREE CLEARING RESTRICTION
 2 a. A TIME OF YEAR RESTRICTION ("TOYP") FOR TREE CLEARING RESTRICTS TREE REMOVAL." A TIME OF YEAR HESTINGTION (TOTAT) FOR THEE CLEARING HESTINGTS THEE PRIMOVAL COCCUP ONLY BETWEEN NOVEMBER 1ST THROUGH APPILL 14TH, QUIRING THE BAT'S INACTIVE SEASON, WHEN NIEB AND TOB WOULD LIKELY BE IN HIBERNACULA AND NOT PRESENT IN FORESTED HABITATION THE SUBJICT PROPERTY. DO NOT PEMOVE TREES BETWEEN APPILL 15TH THROUGH OCTOBER 31ST/.
- BETWEEN APRIL 151H* FROUGH OCTOBER 31-ST/

 NEED AND TOS CONSERVATION

 READ AND TOS CONSERVATION

 FRONT THE SUBBECT PROPERTY LOCATED IN AN DESTING CLEARED AREA

 FRONT THE SUBBECT PROPERTY LOCATED IN AN DESTING CLEARED AREA

 PRODUMET TO A PROM AND VISING PROMISE POLICY BROCK BAT FOURSE BOSS VILL BE

 RISTALLED ON EITHER SIDE OF A SINGLE PRESSURE ITEM TO DE FOUT LOKE 4 SIGNLE FOR

 BETWEEN THE STATE OF THE SUBBECT THE STATE OF THE STATE OF THE STATE

 BEACK OFF A ARMS SANDE OF PARIN AND INSTALLED FORMS SOUTHERST TO CAPTURE DO

 MICHIGAN SAND THE STATE OF THE STATE
- JRTING A COMPLIANCE MONITORING REPORT (BRIEF NARRATIVE AND APPLICABLE PHOTOS DOCUMENTING APTINSPECTION VERIFYING TOYR FOR TREE REMOVAL WAS ADHER DOCUMENTING APTIMISPECTION VEHIFYING TOYN FOR THE HEMOVAL WAS ADHERED TO AND INSTALLATION OF THE BAT HOUSES WILL BE SUBMITTED BY APTIOT HE PERMITTEE FOR COMPLIANCE VERIFICATION, ANY OBSERVATIONS OF BATS WILL BE INCLUDED IN THE PORTS.
 DLLOWING COMPLETION OF THE CONSTRUCTION PROJECT, APT WILL PROVIDE A FINAL
- COMPLIANCE MONITORING REPORT TO THE PERMITTEE DOCUMENTING INDECEMBER A PINAL COMPLIANCE MONITORING REPORT TO THE PERMITTEE DOCUMENTING INDECEMBER AND TO PROGRAM AND ANY SPECIES OBSERVATIONS THE PERMITTEE SHALL PROVIDE A COPY OF THE FINAL COMPLIANCE MONITORING REPORT TO THE CONNECTIOUS STRING COUNCIL FOR COMPLIANCE
- MUNICIPANTS REPORT TO THE CONNECTICIT STING COUNCIL FOR COMPLANCE VERRICATION.

 ANY OBSERVATIONS OF PARE SPECIES WILL BE REPORTED TO DEEP BY APT ON THE APPROPRIATE SPECIAL ANIMAL REPORTING FORM, WITH PHOTO DOCUMENTATION OF POSSIBLE AND SPECIFIC INFORMATION ON THE LOCATION AND DISPOSITION OF THE ANIMAL.

DESIGN PROFESSIONALS OF RECORD PROF. THOMAS E LITTLE PE OMP: ALL-POINTS TECHNO CORPORATION, P.C. ADD: 567 VAUXHALL STREET EXTENSION - SUITE 311 WATERFORD, CT 06385

HOLDINGS LLC DDRESS: 380 NEW LONDON ROAD SALEM, CT 06420

SALEM BESS

SITE ADDRESS: 380 NEW LONDON ROAD SALEM, CT 06420

DRAWN BY:UKA/ELZ 11/06/24 CHECKED BY: TEL

GENERAL NOTES & I FGEND

CUEET NUMBER

SHEET TITLE

GN-1



FAIRY LAKE, LLC

116 HUNTINGTON AVE SUITE 601 BOSTON , MA 02116



CSC SUBMISSION				
NO	DATE	REVISION		
1				
2				
3				
4				
5				
8				
7				

DESIGN PROFESSIONALS OF RECORD

DESIGN PROFESSIONALS OF RECORD
PROF: THOMAS LITTLE, P.E.
COMP: ALL-POINTS TECHNOLOGY
CORPORATION, P.C.
ADD: S6T VAUNHALL STREET
EXTENSION: SUITE 311
WATER/CRD, CT 06385

OWNER: 380 NEW LONDON RO
HOLDINGS LLC
ADDRESS: 380 NEW LONDON ROAD
SALEM, CT 06420

SALEM BESS

SITE ADDRESS: 380 NEW LONDON ROAD SALEM, CT 06420


APT FILING NUMBER: C1760100

DRAWN BY:UKA DATE: 11/06/24 CHECKED BY: TEL

SHEET TITLE:

OVERALL LOCUS PLAN

OP-1

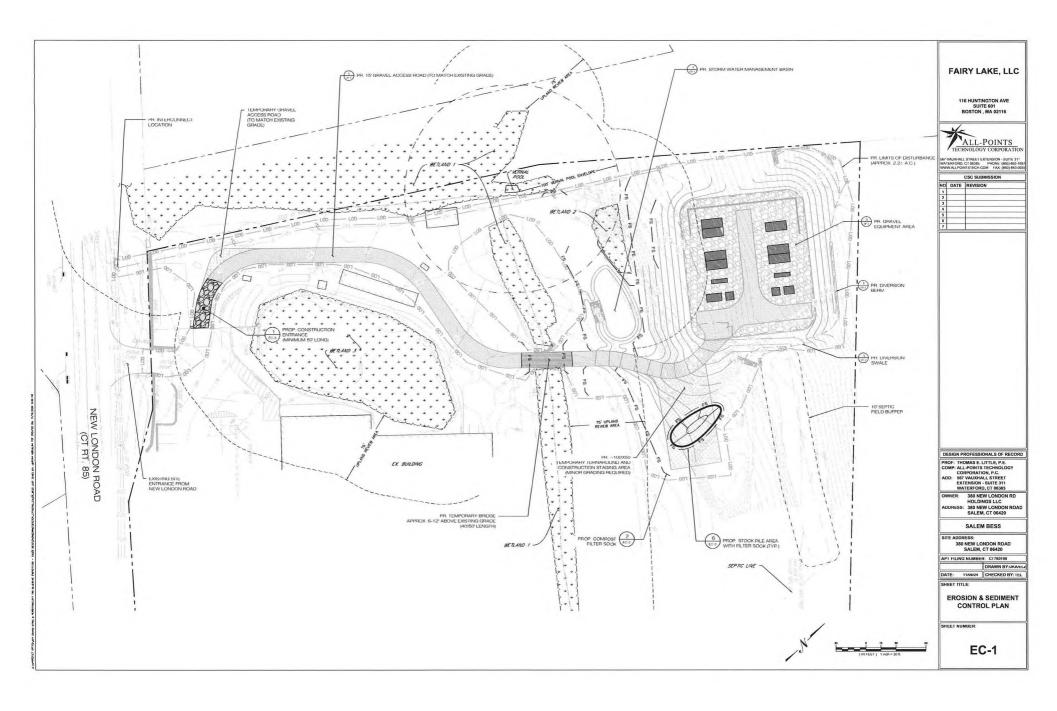

EROSION CONTROL NOTES

EROSION AND SEDIMENT CONTROL PLAN NOTES

- THE CONIFICATION SHALL CONSTRUCT ALL SEDIMENT AND EROSION CONTROLS IN ACCORDANCE WITH THE 2024 CONNECTICUT GUIDELINES FOR SOIL EROSION, AND SEDIMENT CONTROL, LATEST EDITION, IN ACCORDANCE WITH THE CONTROL DICOLMENTS, AND AS DIRECTED BY THE COVER OF SEALEM, PERMITTEE, ANDION SWEDS MONTH OF THE STATE OF ELEMENTS AND EROSION CONTROL MEASURES SHALL BE MISTALLED PROTO TO THE STATE OF CLEANING AND GRIBBORS AND COMMISSION CONTROL MEASURES SHALL BE MISTALLED PROTO TO THE STATE OF CLEANING AND GRIBBORS AND COMMISSION CONTROL MEASURES.
- 21 THESE DRAWNESS ARE ONLY INTENDED TO DESCRIBE THE SERVINGT AND BROGON CONTINUAL MEASURES FOR THIS BITS SEC CONSTRUCTION REGULARCY OF ADMINISTRATION ALL TEXTORIOR HER PROPERTY OF A SECONDARY OF THE PROPERTY OF THE PROPERTY OF THE PROPERTY OF THE OWNERS THE OWN AS REQUIRED BY THE EXPONENT FOR CONTRICTION BY MALL BE RESPONSEDE FOR ENSURING THAT ALL REPOSON SOLD AND PREVENT THE TRANSPORT OF SEDMENTS AND OTHER POLLUTIANTS TO SE OTHER DAMAGE SYSTEMS ANDORDOWN THE TRANSPORT OF SEDMENTS AND OTHER POLLUTIANTS TO SE OTHER DAMAGE SYSTEMS ANDORDOWN THE COURSES AND PREVENT THE TRANSPORT OF SEDMENTS AND OTHER POLLUTIANTS TO SE OTHER DAMAGE SYSTEMS AND OTHER POLLUTIANTS TO SET OWN DAMAGE SYSTEMS. ADDITIONAL CONTROLS OF CONFIGURATIONS OF SERSONNAL AND CLIMATIC CONTITIONS MAY WARRA ADDITIONAL CONTROLS OF CONFIGURATIONS, AS REQUIRED, AND AS DIRECTED BY THE PERMITTEE ANDRO SWPCP MONITOR. BEFER TO SITE PLAN FOR GENERAL INFORMATION AND OTHER CONTRACT PLANS FOR APPRICIPATE INFORMATION.
- A BOND OR LETTER OF CREDIT MAY BE REQUIRED TO BE POSTED WITH THE GOVERNING AUTHORITY FOR THE EROSION CONTROL INSTALLATION AND MAINTENANCE.
- IT THE CONTINUE OR SHALL AFTEV THE MEMBRAIN RECEIVE SECURISE CONTINUE MARGURES SHOWN ON THE PLAN IN COMMENTION WHITE CONSTRUCTIONS SECURISMOS SECRET HAVE ALL ACTIVE ARROWS CONES ARE PROTECTED. ADDITIONAL AND/OR ALT FINANTIVE SEDIMENT AND ERDSON CONTINUE. MEMBRISES MAY SEE HISTALLED DIVINING THE CONTINUE OF REPORT OF THOUGH NOCESSARY OF THE CONTINUE OFF, OWNERS, STEE CONNERS AND APPROPRIATE CONTINUES AGENCIES FOR APPROVAL IF ALTERNATIVE CONTROLS OTHER THAN THOSE SHOWN ON THE PLANS ARE PROPOSED OF THE CONTINUE OFF.
- 5 THE CONTRACTOR SHALL TAKE EXTREME CARE DURING CONSTRUCTION SO AS NOT TO DISTURB UNPROTECTED WETLAND AREAS OR INSTALLED SEDMENTATION AND EROSION CONTROL MEASURES. THE CONTRACTOR SHALL INSPECTAL SEDMENT AND EROSIONS CONTROLS WERELY AND WITHIN 24 HOURS OF A STORM WITH A RANALL ANDURY OF 0.25 INCHES OR DEATER TO VEREY THAT THE CONTROLS ARE OPERATING PROPERLY AND MAKE REPAIRS AS NECESCARY HA I TIME! WASHO!.
- THE CONTRACTOR SHALL KEEP A SUPPLY OF EROSION CONTROL MATERIAL (SILT FENCE, COMPOST FILTER SOCK, EROSION CONTROL BLANKET, ETC.) ON SITE FOR PERIODIC MAINTENANCE AND EMERGENCY REPAIRS.
- 7. AL FILLMISSIE, RACEDALAGEST O ANY WEITARD MER SMALL BE GODD GULLT WITHERS THAN 5% FIRST INSSIGNATION FROM THE ADDRESS DANK BANK HIS, JAMLA LER PLANDE MONOMAND FROM BOTTLES RANG SHALL BE COMMISCIED TO 85% MAX. DRY DENSITY MODIFIED PROGROTH OR AS SPECIFIED IN THE CONTRACT SPECIFICATIONS.
- PPOTICT ENSINET THESE THAT ARE TO BE SAVED BY FRICING, OTHANCE SAFETY FENCE, CONSTRUCTION TARE, OH EQUIVALNET FENCHAGY FOR ANY DUBS THANMAS SHOULD BE DONA FATER CONSULTATION WHITH AN ARBORIST AND BEFORE CONSTRUCTION BEGINS IN THAT AREA, FENCING SHALL BE MAINTAINED AND REPORTED DURING CONSTRUCTION.
- DOSISTRUCTION ENTRANCES (ANTI-TRACORIG PROS) SHALL BE INSTALLED PRIOR TO ANY SITE EXCIDANTION OF CONSTRUCTION ACTIVITY AND SHALL BE MANIFACED THROUGHOUT THE GUARATION PLAL CONSTRUCTION IN PROJUMED THE LOCATION OF THE TRACING PARE MAY CHANGE AS VARIOUS PRASES OF CONSTRUCTION ARE ANTI-TRACORD PAGE PRIOR TO ENTRING.
- 10. ALL CONSTRUCTION BHALL BE CONTAINED WITHEN THE BIRT OF DISTURBANCE, WHICH SHALL BE MARKED WITH BLI FENCE SAFETY FEROKL MY BALES, RIBBONS, OF OTHER BEAMS PRIGHT OF CLEARING CONSTRUCTION ACTIVITY SHALL REMAIN ON THE UPHILL SIDE OF THE SEDIMENT BARRIER UNLESS WORK IS SPECIFICALLY CALLED FOR ON THE DOWNHALL BIRD OF THE BARRIER.
- NO CUT OR FILL SLOPES SHALL EXCEED 2:1 EXCEPT WHERE STABILIZED BY POCK FACED EMBANKMENTS OR EROSION CONTROL BLANKETS, ALL SLOPES SHALL BE SEEDED AND BANKS WILL BE STABILIZED IMMEDIATELY UPON COMPLETION OF FINAL GRADING UNIT. TUPFI SE STABILISED.
- 12. DIRECT ALL DEWATERING PUMP DISCHARGE TO A SEDIMENT CONTROL DEVICE CONFORMING TO THE GUIDELINES WITHIN THE APPROVED LIMIT OF DISTURBANCE IF REQUIRED. DISCHARGE TO STORM DRAINS OR SURFACE WATERS FROM SEDIMENT CONTROLS SHALL BE CLEAR AND APPROVED BY THE PERMITTEE OR
- THE CONTRACTOR SHALL MAINTAIN A CLEAN CONSTRUCTION SITE AND SHALL NOT ALLOW THE ACCUMULATION OF RUBBISH OR CONSTRUCTION DEBRIS ON THE SITE. PROPER SANITARY DEVICES SHALL BE MAINTAINED UP HUMBBIN CHI CONSTRUCTION DEBRIS ON THE STIE. PROPER SANTARY DEVICES SHALL BE MAINTAINED ON STIE. AT LIMES AND SECURED APPROPRIATELY THE CONTINUOUS CONTINUOUS SHALL THE ALL IN CESSARIAN OF SHALL AND SHALL AND SHALL AND SHALL ADHERS TO ALL APPLICABLE POLICIES AND REQUESTIONS RELATED TO SPILL. PREVENTION AND RESPONDISCOOK TRANSMENT.
- MINIMAZE LAND DISTURBANCES. SEED AND MULCH DISTURBED AREAS WITH TEMPORARY MIX AS SOON AS PRACTICABLE (2' WEEK MAXIMUM INSTABLUZED FERDO) LISING FERENMAL, PREGNASA AT 40 LISE FER ACE NOT AND ADMINISTRATION OF A CONTROL OF A C
- 15. SWEEP AFFECTED PORTIONS OF OFF SITE ROADS ONE OR MORE TIMES A DAY (OR LESS FREQUENTLY IF TRACKING IS NOT A PROBLEM) DURING CONSTRUCTION FOR DUST CONTING, PERIODICALLY MOSTERY EXPOSED SOL SURPACES WITH WATER ON URPAYED TRACKINAN'S TO KEEP THE TRAVELWAYS DAMP CALCIUM CHI, ORDIO BY ALSO BE APPLIED TO ACCESS ROADS DUMP TRUCK LOADS EXTING "HE SITE SHALL BE COVERED."
- THE VICE LATURE ESTABLISHMENT SHALL COCULIF ON ALL DISTURBED DOL, LINELESS THE JERA IS MADER ACTIVE CONSTRUCTION. IT IS COVERED IN CITICAL OF THE CONSTRUCTION OF THE CONTROL OF THE CONTR
- 17. MANYAN AL, FERMANSHI AND TEMPORARY GEDMENT OCHTROL BEVOES IN EFFECTIVE CONDICION THROUGHOUT THE CONSTRUCTION PERIOD UNTO COMMETTING IN YOUNG SWEEP CONDRETE FAIRS, CLEAN THE STORMWATER MADERAL SYSTEMS AND FEMOUS ALL TEMPORARY SEDMENT CONTROLS ONCE THE STELLY STABLED AND APPROVAL HAS BEEN RECEIVED FHOM PERMITTE GOT THE M. INDIPIDALITY.
- THE STE VAND DESCRIED DE COMPS Y WITH FEDIDAN, SETALE, AND, IT APPLICABLE, LOCAL STANDARDS, PLUS CUMPRIST ACCEPTED PRANCINGS OF THE ROBUSTERY CONDITIONAL CONTINUES, AND ACTIVITIES AND AC

	CONSTRUCTION O	PERATION AND MAINTENANCE PLAN - BY CONTRACTOR
E&S MEASURE	INSPECTION SCHEDULE	MAINTENANCE REQUIRED
CONSTRUCTION ENTRANCE	DAILY	PLACE ADDITIONAL STONE, EXTEND THE LENGTH OR REMOVE AND REPLACE THE STONE. CLEAN PAVED SURFACES OF TRACKED SEDIMENT.
COMPOST FILTER SOCK	WEEKLY & WITHIN 24 HOURS OF RAINFALL > 0.25'	REPAIR/REPLACE WHEN FAILURE OR DETERIORATION IS OBSERVED.
SILT FENCE	WEEKLY & WITHIN 24 HOURS OF RAINFALL > 0.25'	REPAIR/REPLACE WHEN FAILURE OR DETERIORATION IS OBSERVED. REMOVE SILT WHEN IT REACHES 1/2. THE HEIGHT OF THE FENCE.
TOPSOIL/BORROW STOCKPILES	DAILY	REPAIR/REPLACE SEDIMENT BARRIERS AS NECESSARY.
TEMPORARY SOIL PROTECTION		

FAIRY LAKE, LLC

116 HUNTINGTON AVE



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7		

PROF: THOMAS E. LITTLE, P.E. COMP: ALL-POINTS TECHNOLOGY CORPORATION. P.C. ADD: 567 VAUXHALL STREET EXTENSION - SUITE 311 WATERFORD, CT 06385

OWNER: 380 NEW LONDON RD HOLDINGS LLC ADDRESS: 380 NEW LONDON ROAD SALEM, CT 06420

SALEM BESS

SITE ADDRESS 380 NEW LONDON ROAD SALEM, CT 06420

APT FILING NUMBER: CT760100

DRAWN BY:UKA/ELZ


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EROSION & SEDIMENT CONTROL

NOTES


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EC-2




WHAT IS PROVIDED ABOVE

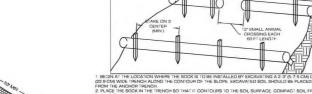SEDIMENTATION CONTROL BARRIER SCALE: N.T.S.

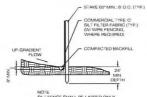

SILT FENCE SHALL BE LAPPED ONLY WHEN NECESSARY PER THE MANUFACTURER RECOMMENDATIONS



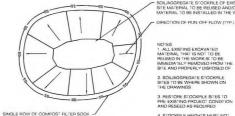

SOIL/AGGREGATE STOCKPILE OF EXISTING SITE MATERIAL TO BE REUSED AND/OR NEW MATERIAL TO BE INSTALLED IN THE WORK

NOTES

1. ALL EXISTING EXCAVATED
MATERIAL THAT IS NOT TO BE
REUSED IN THE WORK IS TO BE
IMMEDIATELY PREMOVED FROM THE
SITE AND PROPERLY DISPOSED OF

2. SOIL/AGGREGATE STOCKPILE SITES TO BE WHERE SHOWN ON THE DRAWINGS 3. RESTORE STOCKPILE SITES TO PRE-EXISTING PROJECT CONDITION AND RESEED AS REQUIRED

4, STOCKPILE HEIGHTS MUST NO EXCEED 35: STOCKPILE SLOPES MUST BE 2:1 OR FLATTER

MATERIALS STOCKPILE DETAIL

SCALE: N.T.S.



CONSTRUCTION

1 ENTRANCE DETAIL
EC-3 SCALE: N.T.S.

Ernst Conservation Seeds 8884 Mercer Pike Meadwille, PA 16335 (800) 873-3321 Fax (814) 336-5191 yymw.ernstseed.com

Date: July 12, 2022

Quick Erosion Control Cover Mix - ERNMX-104

100.00 %

Seeding Rate: 50 th per acre Frosion Control & Revegetation

Designed to achieve that quick, green color and fast erosion control with strong, fibrous mosts. Mix formulations are subject to change without notice depending on the availability of existing and new products. While the formula may change, the guiding philosophy and function of the mix will not.



Ernst Conservation Seeds 8884 Mercer Pike Meadville, PA 16335 (800) 873-3321 Fax (814) 336-5191 www.ernstseed.com

Date: July 17, 2022

Rain Garden Mix - ERNMX-180

Garden Fix - EKRINA - 1809

Common Ramo

Gardin Contyre

Life Blacken, For Debarterin Gap PA Extrage

Black Contyre

Lanced Contyre

Black Contyre

Lanced Contyre

Black C

Rain Garden

Balanical Home

34.50 % Shouthware supposes for disdenom Capital &

55.00 % Forms specially Administ Political

12.00 % College specials Administ Political

12.00 % College specials Administ Political

12.00 % College specials Administ Political

12.00 % College specials, Administ Political

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12.00 % College specials Administration

12.00 % Admin

100.00 %

Seeding Rate: 20 Its per acre with a cover crop. For sites that drain within 24 hours of a rain event use one of the following cover crups CNS (1 Jan to 31 July, 30 lith/acre), appanese Mildet (1 May to 31 Aug; 10 lith/acre), or grain rive (1 Aug to 31 Dec; 30 lith/acre).

Stormwater Management; Uplands & Meadows

The native perennial forbs and grasses previde food and cover for rain garden biodiversity. Mix formulations are subject to ch without notice depending on the availability of existing and new products. While the formula may change, the guiding philosocianal function of the mix will not.

sick mask snapy, South of the Codype foot plant. For Indiantown Catip PA Ecotype foot organization Asset, PA Ecotype Path Path, PA Ecotype Bloomet, PA Ecotype Bloomet, PA Ecotype South South PA Ecotype South South



Ernst Conservation Seeds 8884 Mercer Pike Meachville, PA 16335 (800) 873-3321 Fax (814) 336-5191 www.ernstseed.com

Native Steep Slope Mix w/Annual Ryegrass - ERNMX-181 Common Name 89, Bleasm, Their Verini Stotype 19, Stotyp

Botanical Name

Botanical Name

21-00 % Advisopors persist, Panker Verni Pil Europe

20-00 % Pilman Pilmanica, Rademark Pill Europe

10-00 % Pilman Pilmanica, Rademark Pill Europe

10-00 % Pilmanica Pilmanica, Rademark Pillado

3-00 % Pilmanica Pilmanica, Rademark Pillado

3-00 % Pilmanica Calendaria, Pillado

3-00 % Pilmanica, Pillado

3-00 % Pilmanica, Pilmanica, Pillado

3-00 % Pilmanica, Pillado


3-00

100.00 %

Seeding Rate: 60 lb per acre, or 1.5 lb per 1.000 sq ft

Erosion Control & Revegetation; Grasses & Grass-like Species - Herbaceous Perennial; Herbaceous Flowering Species - Herbaceous Perennial;

The native grass and forb species tolerate poor soils typically found on steep slopes in the eastern United States. Mix formulation are subject to change without notice depending on the availability of existing and new products. While the formula may change guiding philosophy and function of the mix will not.

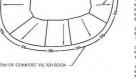

FAIRY LAKE, LLC

116 HUNTINGTON AVE SUITE 601 BOSTON , MA 02116



7 VAUXHALL STREET EXTENSION - SUITE 311 ATERFORD, CT 06385 PHONE: (860)-663-1

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SEED MIXES

SCALE : N.T.S.

DESIGN PROFESSIONALS OF RECORD

PROF: THOMAS E. LITTLE, P.E.
COMP: ALL-POINTS TECHNOLOGY
CORPORATION, P.C.
ADD: 557 VAUXHALL STREET
EXTENSION - SUITE 311 WATERFORD, CT 06385

OWNER: 380 NEW LONDON RE HOLDINGSLLC ADDRESS: 380 NEW LONDON ROAD SALEM, CT 06420

SALEM BESS

SITE ADDRESS: 380 NEW LONDON ROAD SALEM, CT 06420


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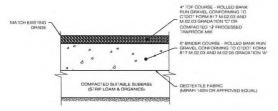
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EROSION & SEDIMENT CONTROL DETAILS

SHEET NUMBER

EC-3




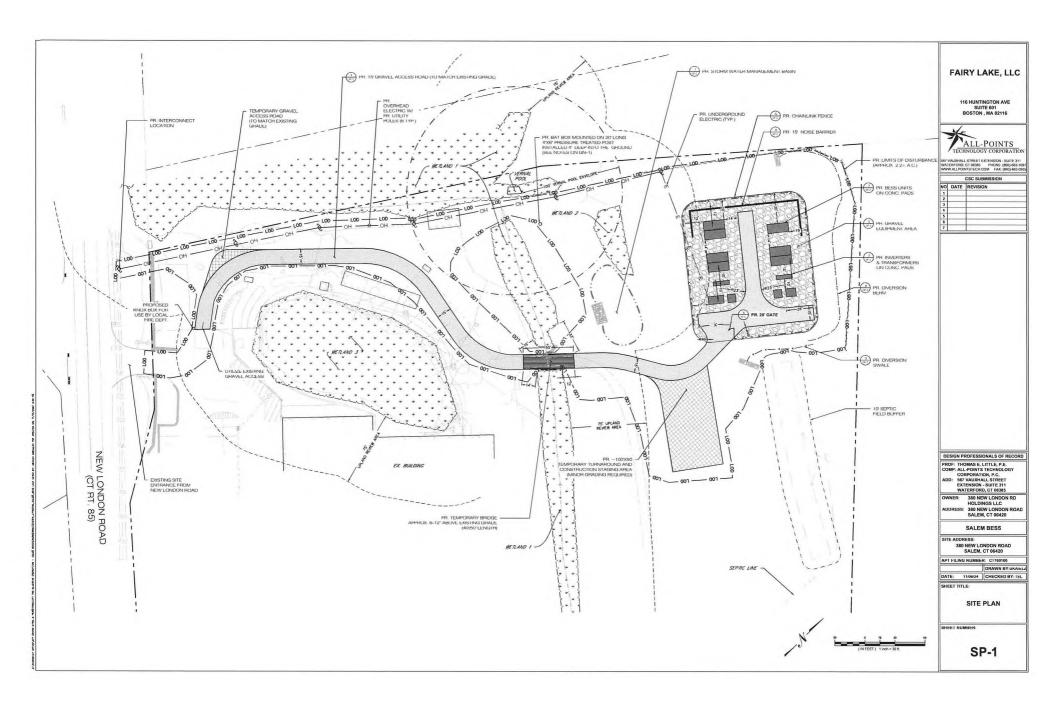

NOTES

1. SUBBASE MAY CONSIST OF NATIVE MATERIALS IF FOUND ACCEPTABLE
BY THE ENGINEER. SUBBASE TO BE COMPACTED TO 95% MAX DRY
DENSITY.
SUBBASE IS TO BE FREE FROM DEBRIS AND UNSUITABLE MATERIALS.


1 GRAVEL ACCESS DRIVE SECTION SP2 SCALE: N.T.S.

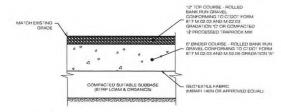

NOTES


1. SUBBASE MAY CONSIST OF NATIVE MATERIALS IF FOUND ACCEPTABLE
11. SUBBASE MAY CONSIST OF NATIVE MATERIALS IF FOUND ACCEPTABLE
12. SUBBASE MAY CONSIST OF NATIVE MATERIALS.
13. SUBBASE IS TO BE FREE FROM DEBRIS AND UNSUITABLE MATERIALS.



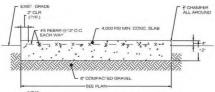

NOTE: SEE ELECTRICAL DRAWINGS FOR ADDITIONAL CONCRETE PAD DESIGN DETAILS

2 CONCRETE EQUIPMENT PAD 352 SCALE: N.T.S.

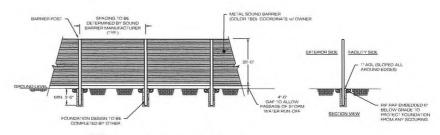


NOTES:
1. SOUND BARRIER PRODUCT & SPECIFICATIONS TO BE DETERMINED BY

OWNER

BARRIER POST FOUNDATION TO BE DESIGNED BY OTHERS.

4 GENERIC SOUND BARRIER DETAIL SY2 SCALE: N.T.S.

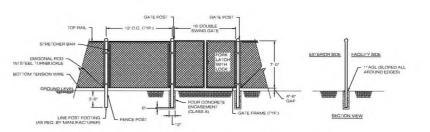

5 CHAIN-LINK FENCE & GATE DETAIL

SOLD SCALE: N.T.S.

FAIRY LAKE, LLC

116 HUNTINGTON AVE SUITE 601 BOSTON , MA 02116



567 VAUXHALL STREET EXTENSION - SUITE 311 WATERFORD, CT 06385 PHONE (860)-663-16

WWW.ALLPOINTSTECH.COM FAX: (860)-663-0935					
		CSC SUBMISSION			
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DESIGN PROFESSIONALS OF RECORD PROF: THOMAS E. LITTLE, P.E.
COMP: ALL-POINTS TECHNOLOGY
CORPORATION, P.C.
ADD: 567 VAUXHALL STREET
EXTENSION - SUITE 311
WATERFORD, CT 06385

380 NEW LONDON RD HOLDINGS LLC ADDRESS: 380 NEW LONDON ROAD SALEM, CT 06420

SALEM BESS

SITE ADDRESS:

380 NEW LONDON ROAD SALEM, CT 06420

APT FILING NUMBER: CT760100

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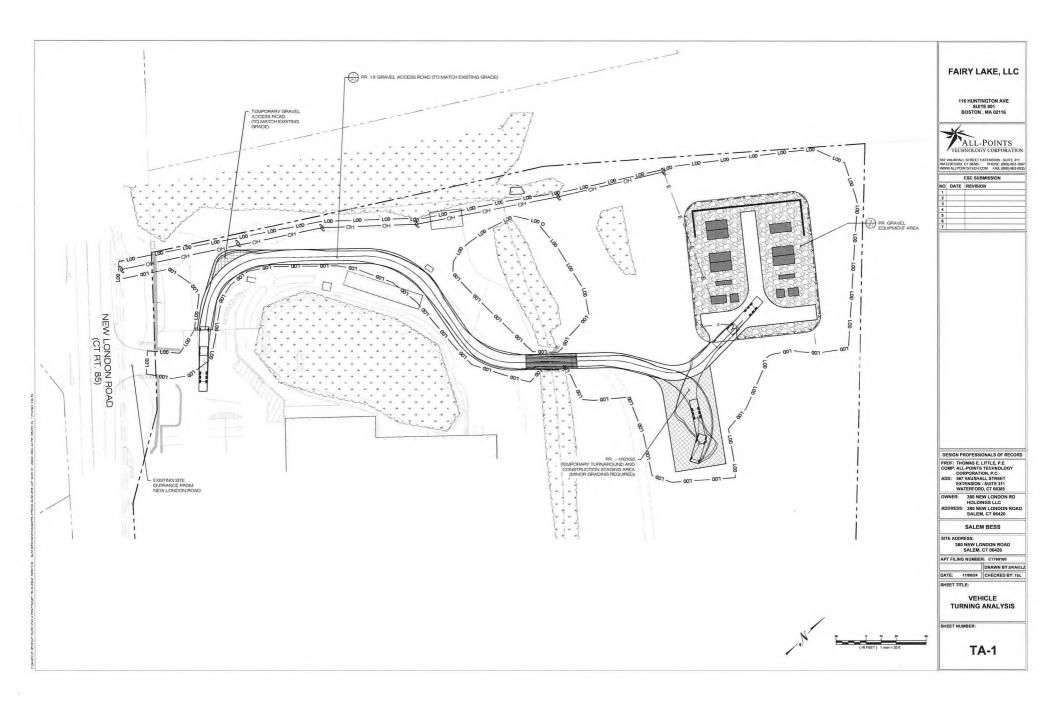
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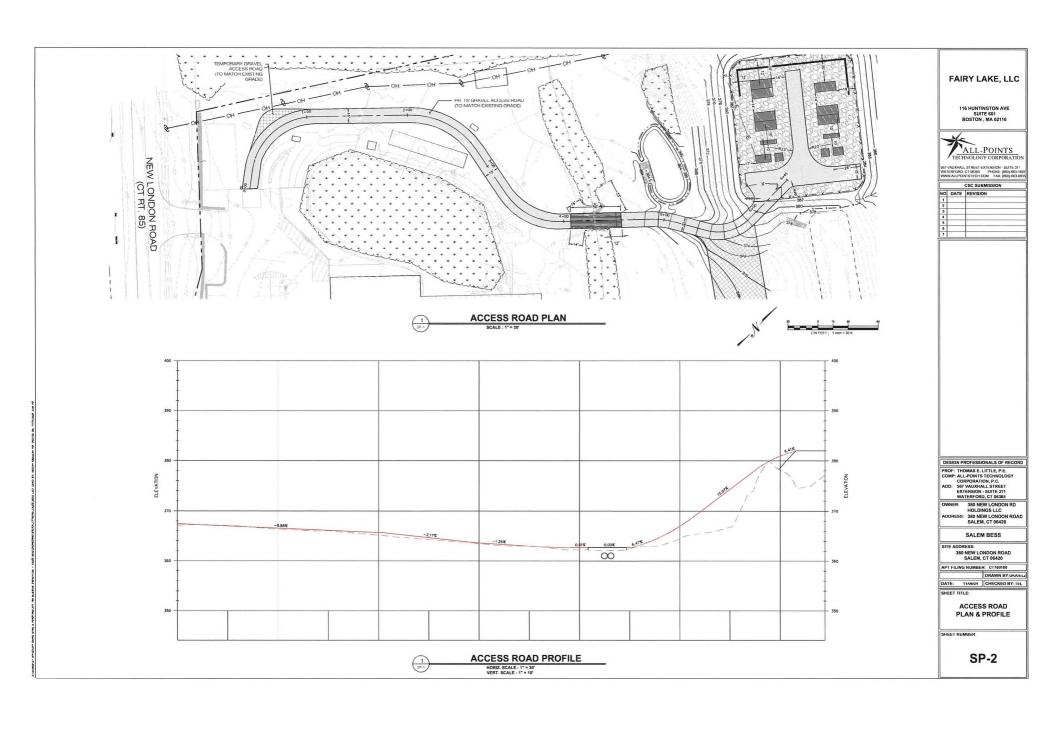
DETAILS


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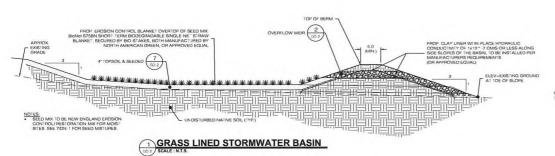
SP-2


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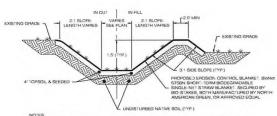






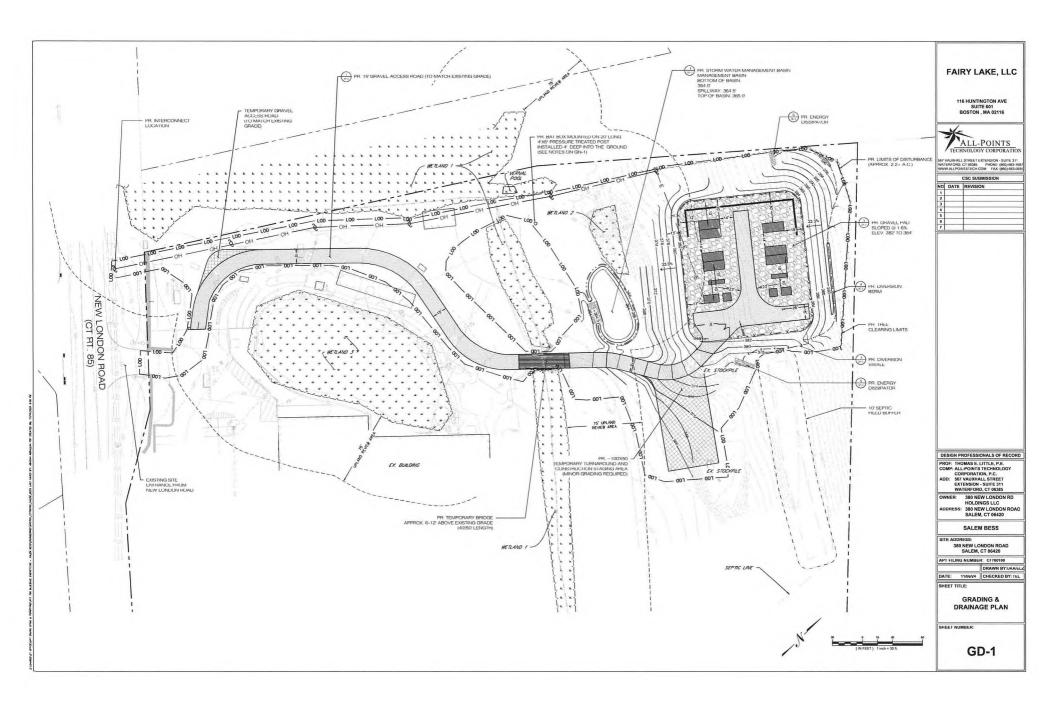


2 OVERFLOW WEIR DETAIL 2 SCALE: N.T.S.

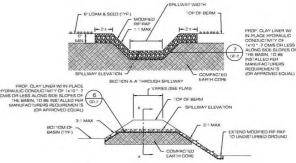

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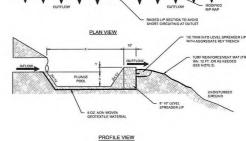
SED MM: TO BE NEW ENGLAND EROSION CONTROL/BESTORATION MIX FOR MOIST SITES ON THE
BOTTOM OF THE BASIN AND NEW ENGLAND EROSION/RESTORATION MIX FOR DRY SITES ON THE SIDE
SLOPES
BEFORE THOM 2.0, SEE PLAN CALLOUTS

3 GRASS LINED SWALE

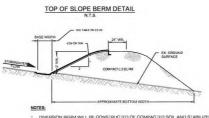

- 2. A MINIMUM OF 4° OF TOPSOIL SHALL BE PLACED ON TOP OF COMPACTED GROUND.

DIVERSION BERM DETAIL



- RVE INFILTRATION CAPACITY. BE INSTALLED COMPLETELY LEVEL ALONG THE EXISTING CONTOUR WITH N BETWEEN THE LEVEL SPREADER AND THE EXISTING GRADE THE IDEAL VEL SPREADER IN §1 IS INCHES ABOVE THE EXISTING GRADE 19 12 OF TURF REINFORCEMENT MIT (TRM) IS TO BE INSTALLED 100PE OF THE LEVEL SPREADER UP: CONTRACTOR TO INSTALL

ENERGY DISSIPATOR -PERMANENT LEVEL SPREADER

FAIRY LAKE, LLC

116 HUNTINGTON AVE SUITE 601 BOSTON , MA 02116



CSC SUBMISSION O DATE REVISION

PROF: THOMAS E. LITTLE, P.E.
COMP: ALL-POINTS TECHNOLOGY
CORPORATION, P.C.
ADD: 567 VAUXHALL STREET
EXTENSION - SUITE 311
WATERFORD, CT 06385

OWNER: 380 NEW LONDON RD HOLDINGS LLC ADDRESS: 380 NEW LONDON ROAD SALEM, CT 06420

SALEM BESS

380 NEW LONDON ROAD SALEM, CT 06420

APT FILING NUMBER: CT760100

DRAWN BY:UKA/EL DATE: 11/06/24 CHECKED BY: TEL

GRADING & DRAINAGE DETAILS

SHEET NUMBER

GD-2