

"SALEM BESS"

FAIRY LAKE, LLC

380 NEW LONDON ROAD SALEM, CT 06420

LIST OF DRAWINGS

T-1 TITLE SHEET

1 OF 1 TOPOGRAPHIC SURVEY

GN-1 GENERAL NOTES & LEGEND

OP-1 OVERALL LOCUS MAP

EC-1 EROSION & SEDIMENT CONTROL PLAN

EC-2 EROSION & SEDIMENT CONTROL NOTES

EC-3 EROSION & SEDIMENT CONTROL DETAILS

SP-1 SITE PLAN

SP-2 SITE PLAN DETAILS

TA-1 VEHICLE TURNING ANALYSIS

PR-1 ACCESS ROAD PLAN & PROFILE

GD-1 GRADING & DRAINAGE PLAN

GD-2 GRADING & DRAINAGE DETAILS

SITE INFORMATION

SITE NAME: "SALEM BESS"

LOCATION: 380 NEW LONDON ROAD

SALEM, CT 06420

SITE TYPE/DESCRIPTION: ENERGY STORAGE SYSTEM 5 MW

CONSISTING OF APPROX. 7 SOLBANK 3.0 BATTERIES, 5 EPC POWER CAB1000 INVERTERS, 2 TRANSFORMERS AND 2 DC

RECOMBINERS

PROPERTY OWNER: 380 NEW LONDON ROAD HOLDINGS, LLC

380 NEW LONDON ROAD SALEM, CT 06420

PETITIONER: FAIRY LAKE, LLC

116 HUNTINGTON AVENUE - SUITE 601

BOSTON, MA 02116

ENGINEER CONTACT: THOMAS E. LITTLE, P.E.

(860) 552-2046

LATITUDE: N 41° 27' 29.80" LONGITUDE: W 72° 14' 30.23"

MBLU: 06/002/B00

ZONE: SBA


LAND USE: STORE/SHOP MDL-94

LAND CLASS CODE: 3220

TOTAL SITE ACREAGE: 14.48± AC. TOTAL DISTURBED AREA: 2.2± AC.

APPROX. VOLUME OF CUT: 1,423± CY
APPROX. VOLUME OF FILL: 3,872± CY
APPROX. NET VOLUME: 2,449± CY OF FILL

USGS TOPOGRAPHIC MAP

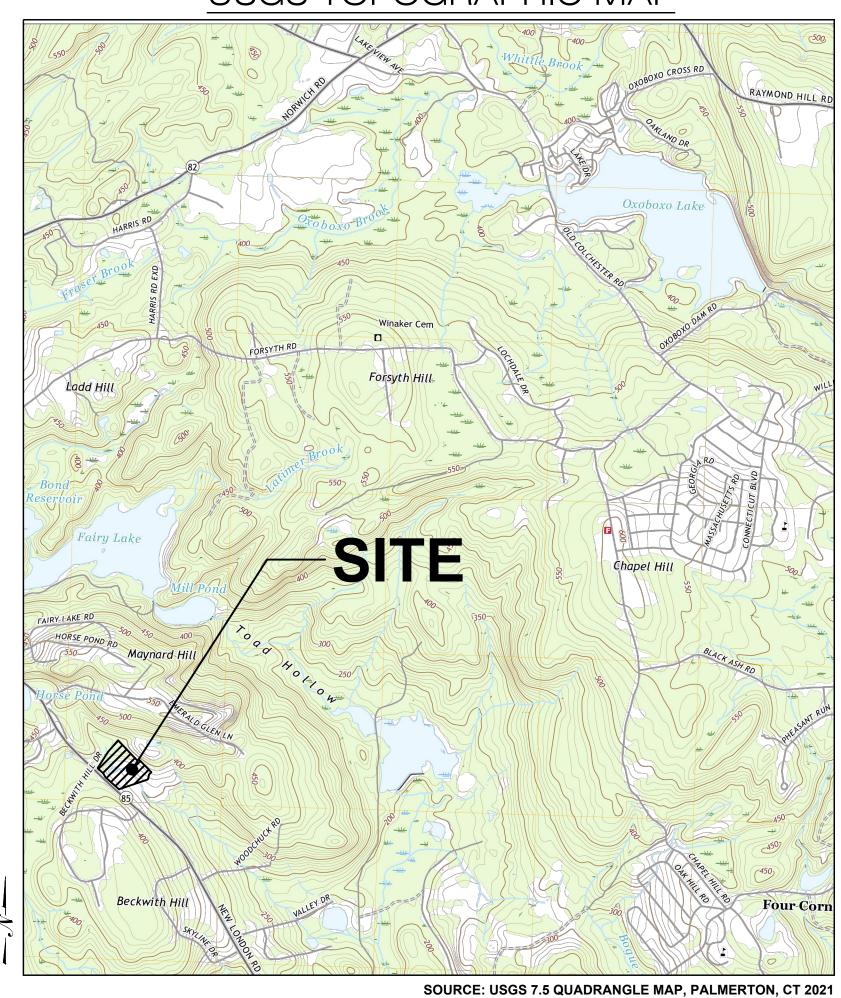

FAIRY LAKE, LLC

116 HUNTINGTON AVE SUITE 601 BOSTON , MA 02116



567 VAUXHALL STREET EXTENSION - SUITE 311 WATERFORD, CT 06385 PHONE: (860)-663-1697 WWW.ALLPOINTSTECH.COM FAX: (860)-663-0935

CSC SUBMISSION				
NO DATE REVISION				
1	02/20/25	INTERROGATORIES: UKA		
2				
3				
4				
5				



DESIGN PROFESSIONALS OF RECORD

PROF: THOMAS E. LITTLE, P.E.
COMP: ALL-POINTS TECHNOLOGY
CORPORATION, P.C.
ADD: 567 VAUXHALL STREET
EXTENSION - SUITE 311
WATERFORD, CT 06385

OWNER: 380 NEW LONDON RD
HOLDINGS LLC
ADDRESS: 380 NEW LONDON ROAD
SALEM, CT 06420

SALEM BESS

SITE ADDRESS:
380 NEW LONDON ROAD

SALEM, CT 06420

APT FILING NUMBER: CT760100

DRAWN BY:UKA/ELZ


DATE: 11/06/24 CHECKED BY:TEL

TITLE SHEET

SHEET TITLE:

SHEET NUMBER

T-1

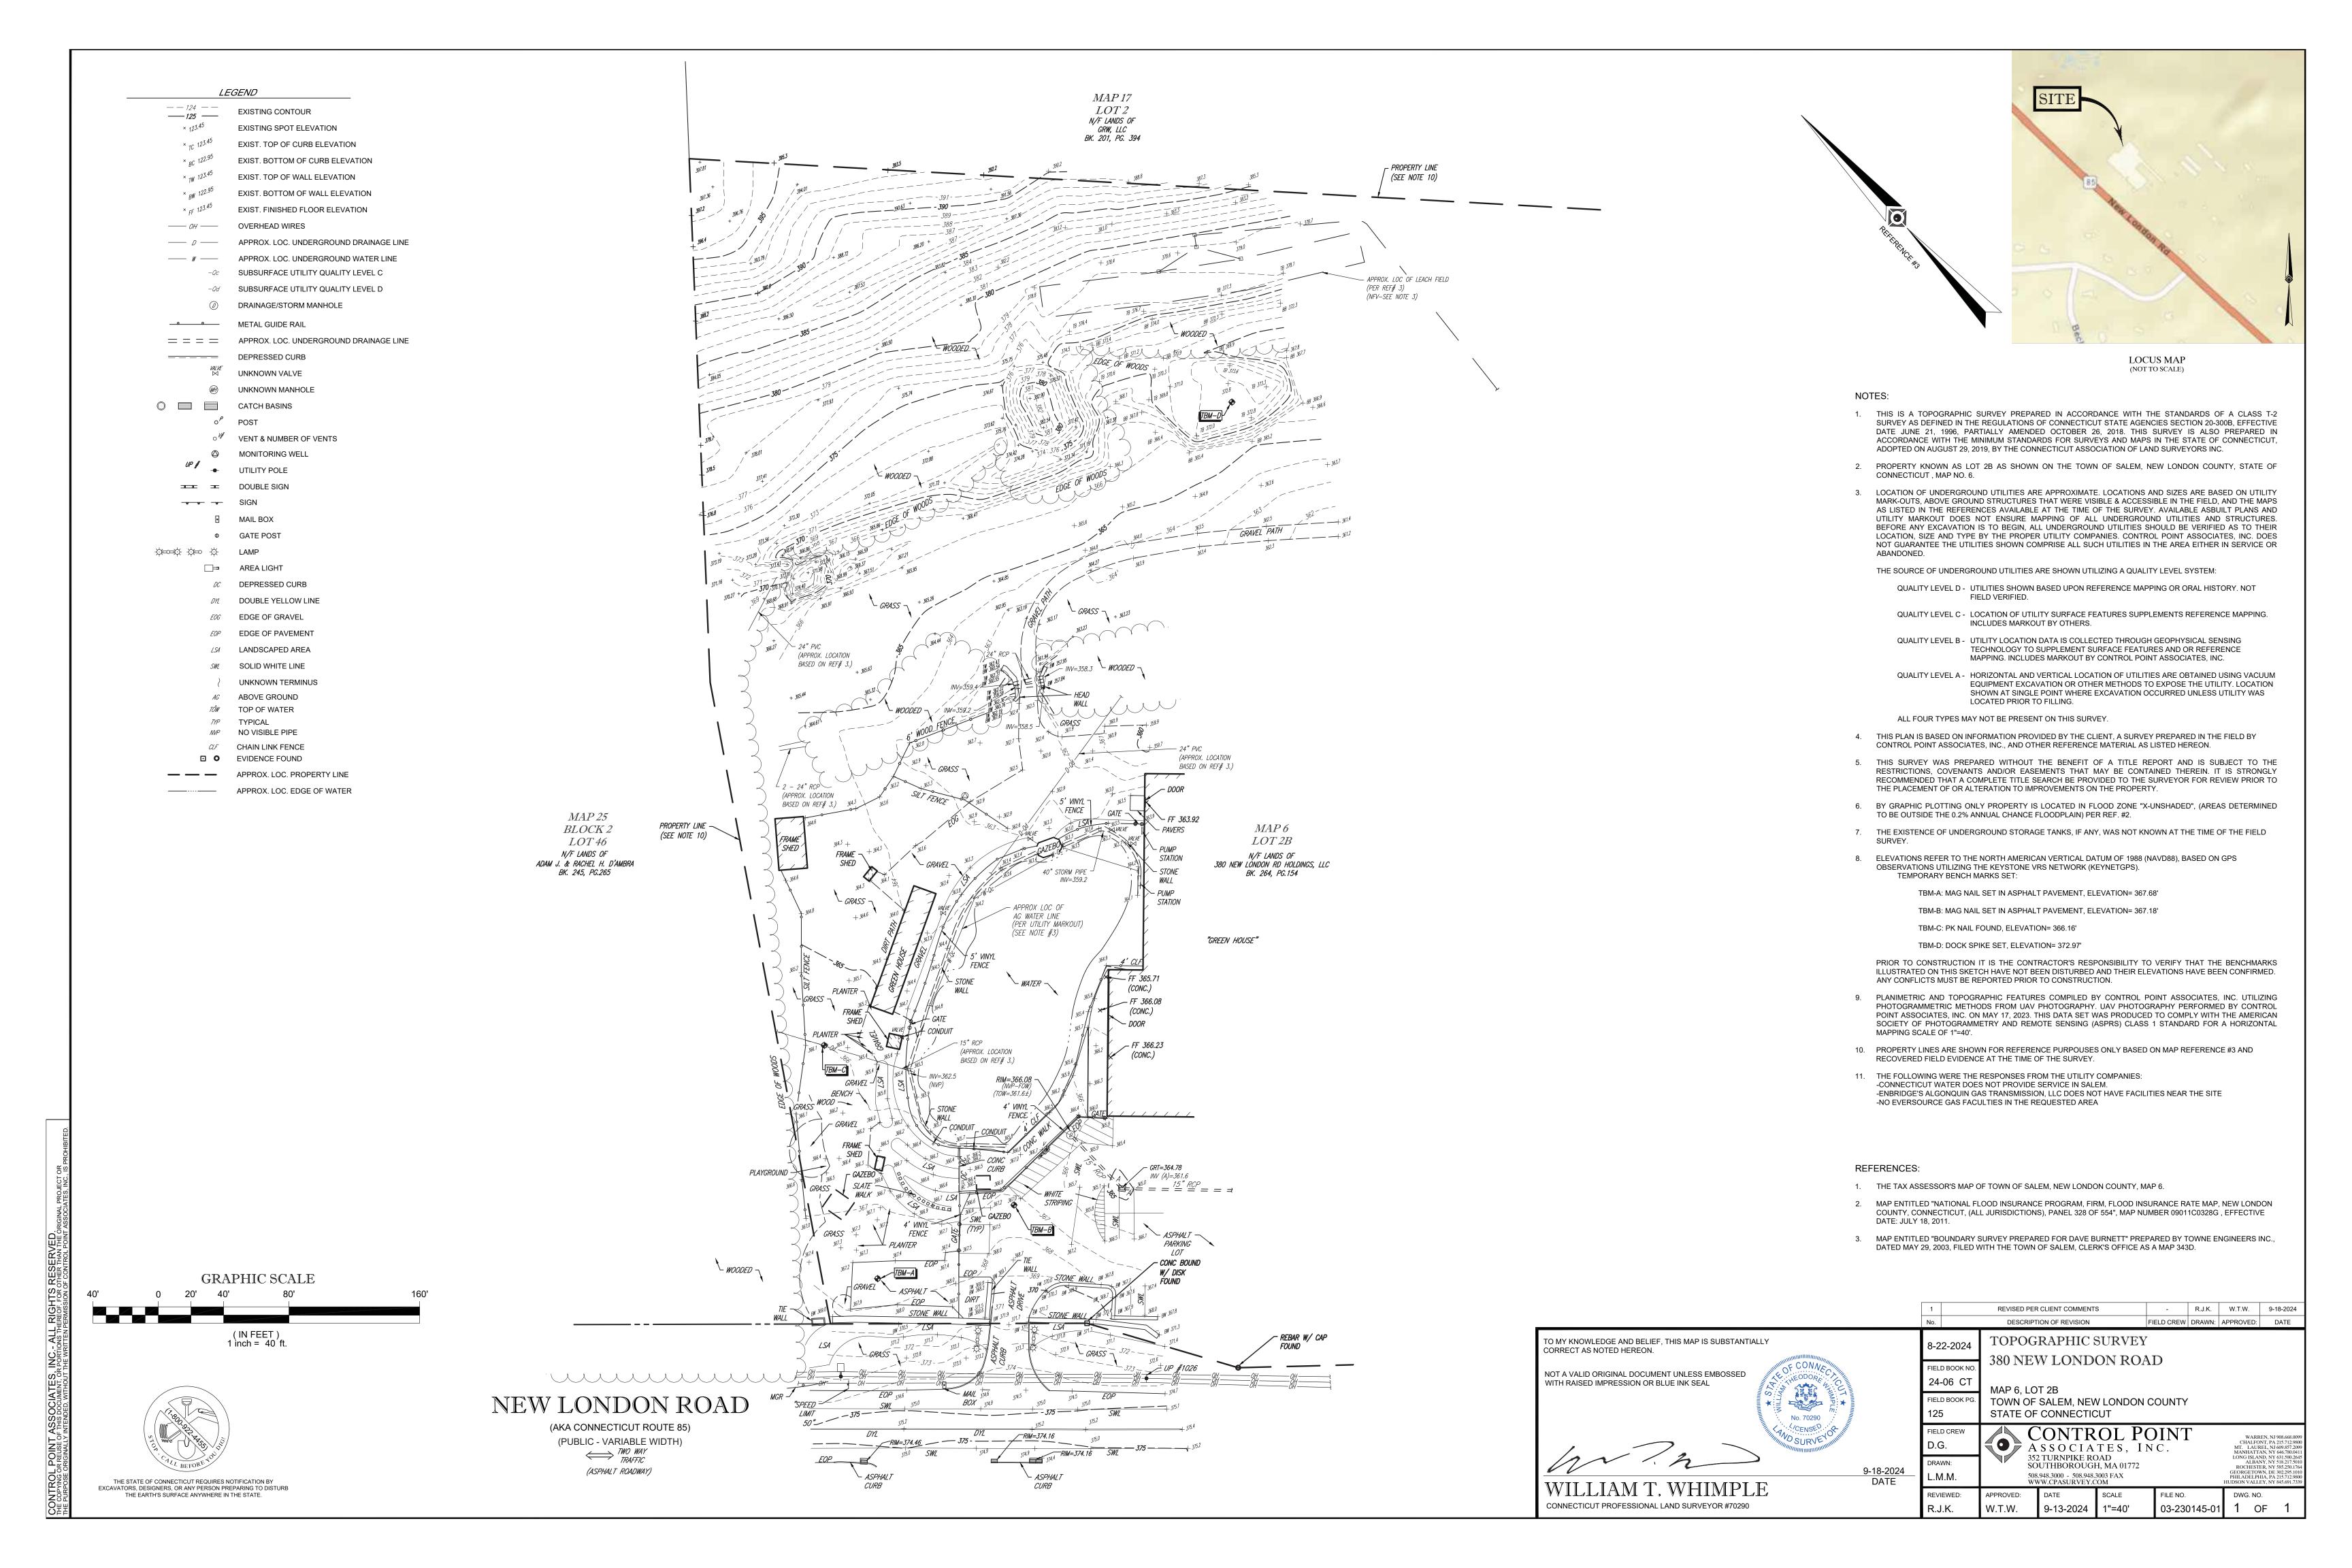

GENERAL NOTES

- ALL CONSTRUCTION SHALL COMPLY WITH PROJECT DEVELOPER STANDARDS, TOWN OF SALEM STANDARDS, CONNECTICUT DEPARTMENT OF TRANSPORTATION STANDARDS AND SPECIFICATIONS IN THE ABOVE REFERENCED INCREASING HIERARCHY. IF SPECIFICATIONS ARE IN CONFLICT, THE MORE STRINGENT SPECIFICATION SHALL APPLY.
- 2. IF NO PROJECT CONSTRUCTION SPECIFICATION PACKAGE IS PROVIDED BY THE PROJECT DEVELOPER OR THEIR REPRESENTATIVE, THE CONTRACTOR SHALL COMPLY WITH THE MANUFACTURER, TOWN OF SALEM, OR CONNECTICUT DEPARTMENT OF TRANSPORTATION STANDARD SPECIFICATIONS, AND BE IN ACCORDANCE WITH ALL APPLICABLE OSHA, FEDERAL, STATE AND LOCAL REGULATIONS.
- 3. THE PROJECT DEVELOPER IS RESPONSIBLE FOR OBTAINING ALL NECESSARY ZONING AND STORMWATER PERMITS REQUIRED BY GOVERNMENT AGENCIES PRIOR TO CONSTRUCTION. THE CONTRACTOR SHALL OBTAIN ALL TOWN OF SALEM CONSTRUCTION PERMITS. THE CONTRACTOR SHALL POST ALL BONDS, PAY ALL FEES, PROVIDE PROOF OF INSURANCE AND PROVIDE TRAFFIC CONTROL NECESSARY FOR THIS WORK.
- REFER TO PLANS, DETAILS AND REPORTS PREPARED BY ALL-POINTS TECHNOLOGY CORPORATION FOR ADDITIONAL INFORMATION. THE CONTRACTOR SHALL VERIFY ALL SITE CONDITIONS IN THE FIELD AND CONTACT THE PROJECT DEVELOPER IF THERE ARE ANY QUESTIONS OR CONFLICTS REGARDING THE CONSTRUCTION DOCUMENTS AND/OR FIELD CONDITIONS SO THAT APPROPRIATE REVISIONS CAN 3. BE MADE PRIOR TO BIDDING/CONSTRUCTION. ANY CONFLICT BETWEEN THE DRAWINGS AND SPECIFICATIONS SHALL BE CONFIRMED WITH THE PROJECT DEVELOPERS CONSTRUCTION MANAGER PRIOR TO CONSTRUCTION.
- 5. THE CONTRACTOR SHALL SUBMIT SHOP DRAWINGS OF ALL PRODUCTS, MATERIALS PER PLANS, AND SPECIFICATIONS TO THE PROJECT DEVELOPER FOR REVIEW AND APPROVAL PRIOR TO FABRICATION OR DELIVERY TO THE SITE. ALLOW A MINIMUM OF 14 WORKING DAYS FOR REVIEW.
- 6. SHOULD ANY UNKNOWN OR INCORRECTLY LOCATED EXISTING PIPING OR OTHER UTILITY BE UNCOVERED DURING EXCAVATION, CONSULT THE PROJECT DEVELOPER IMMEDIATELY FOR DIRECTIONS BEFORE PROCEEDING FURTHER WITH WORK IN THIS AREA.
- 7. DO NOT INTERRUPT EXISTING UTILITIES SERVICING FACILITIES OCCUPIED AND USED BY THE PROJECT 6. CONTRACTOR SHALL ADHERE TO 2024 CONNECTICUT GUIDELINES FOR EROSION AND SEDIMENT DEVELOPER OR OTHERS DURING OCCUPIED HOURS, EXCEPT WHEN SUCH INTERRUPTIONS HAVE BEEN AUTHORIZED IN WRITING BY THE PROJECT DEVELOPER AND THE LOCAL MUNICIPALITY. INTERRUPTIONS SHALL ONLY OCCUR AFTER ACCEPTABLE TEMPORARY SERVICE HAS BEEN PROVIDED.
- 8. THE CONTRACT LIMIT IS THE PROPERTY LINE UNLESS OTHERWISE SPECIFIED OR SHOWN ON THE CONTRACT DRAWINGS.
- 9. THE CONTRACTOR SHALL ABIDE BY ALL OSHA, FEDERAL, STATE AND LOCAL REGULATIONS WHEN OPERATING CRANES, BOOMS, HOISTS, ETC. IN CLOSE PROXIMITY TO OVERHEAD ELECTRIC LINES, IF CONTRACTOR MUST OPERATE EQUIPMENT CLOSE TO ELECTRIC LINES. CONTACT POWER COMPANY TO MAKE ARRANGEMENTS FOR PROPER SAFEGUARDS. ANY UTILITY COMPANY FEES SHALL BE PAID FOR BY THE CONTRACTOR.
- 10. THE CONTRACTOR SHALL COMPLY WITH OSHA CFR 29 PART 1926 FOR EXCAVATION TRENCHING AND 10. NO CONSTRUCTION OF SITE IMPROVEMENTS MAY BEGIN UNTIL THE PROPER EROSION CONTROL TRENCH PROTECTION REQUIREMENTS.
- 11. THE ENGINEER IS NOT RESPONSIBLE FOR SITE SAFETY MEASURES TO BE EMPLOYED DURING CONSTRUCTION. THE ENGINEER HAS NO CONTRACTUAL DUTY TO CONTROL THE SAFEST METHODS OR MEANS OF THE WORK, JOB SITE RESPONSIBILITIES, SUPERVISION OF PERSONNEL OR TO SUPERVISE SAFETY AND DO NOT VOLUNTARILY ASSUME ANY SUCH DUTY OR RESPONSIBILITY
- 12. THE CONTRACTOR SHALL RESTORE ANY DRAINAGE STRUCTURE, PIPE, CONDUIT, PAVEMENT, CURBING, SIDEWALKS, LANDSCAPED AREAS OR SIGNAGE DISTURBED DURING CONSTRUCTION TO THEIR ORIGINAL CONDITION OR BETTER, AS APPROVED BY THE PROJECT DEVELOPER OR TOWN OF SALEM.
- 13. THE CONTRACTOR SHALL PROVIDE AS-BUILT RECORDS OF ALL CONSTRUCTION (INCLUDING UNDERGROUND UTILITIES) TO THE PROJECT DEVELOPER AT THE END OF CONSTRUCTION.
- 14. ALTERNATIVE METHODS AND PRODUCTS, OTHER THAN THOSE SPECIFIED, MAY BE USED IF REVIEWED AND APPROVED BY THE PROJECT DEVELOPER. ENGINEER. AND APPROPRIATE REGULATORY AGENCY PRIOR TO INSTALLATION DURING THE BIDDING/CONSTRUCTION PROCESS.
- 15. INFORMATION ON EXISTING UTILITIES AND STORM DRAINAGE SYSTEMS HAS BEEN COMPILED FROM AVAILABLE INFORMATION INCLUDING UTILITY PROVIDER AND MUNICIPAL RECORD MAPS AND/OR FIELD SURVEY AND IS NOT GUARANTEED CORRECT OR COMPLETE. UTILITIES AND STORM DRAINAGE SYSTEMS ARE SHOWN TO ALERT THE CONTRACTOR TO THEIR PRESENCE AND THE CONTRACTOR IS SOLELY RESPONSIBLE FOR DETERMINING ACTUAL LOCATIONS AND ELEVATIONS OF ALL UTILITIES AND STORM DRAINAGE SYSTEMS INCLUDING SERVICES. PRIOR TO DEMOLITION OR CONSTRUCTION, THE CONTRACTOR SHALL CONTACT "CALL BEFORE YOU DIG" 72 HOURS BEFORE COMMENCEMENT OF WORK AT "811" AND VERIFY ALL UTILITY AND STORM DRAINAGE SYSTEM LOCATIONS.
- 16. NO CONSTRUCTION OR DEMOLITION SHALL BEGIN UNTIL APPROVAL OF THE FINAL PLANS AND PERMITS ARE GRANTED BY ALL GOVERNING AND REGULATORY AGENCIES.

SITE PLAN NOTES

- 1. THE SURVEY WAS PROVIDED BY CONTROL POINT ASSOCIATES, INC. DATED SEPTEMBER 18, 2024.
- 2. THE CONTRACTOR SHALL FOLLOW THE RECOMMENDED SEQUENCE OF CONSTRUCTION NOTES PROVIDED ON THE EROSION CONTROL PLAN OR SUBMIT AN ALTERNATE PLAN FOR APPROVAL BY THE ENGINEER AND/OR PERMITTING AGENCIES PRIOR TO THE START CONSTRUCTION. ALLOW A MINIMUM OF 14 WORKING DAYS FOR REVIEW.
- PROPER CONSTRUCTION PROCEDURES SHALL BE FOLLOWED ON ALL IMPROVEMENTS WITHIN THIS PARCEL SO AS TO PREVENT THE SILTING OF ANY WATERCOURSE OR BVWS IN ACCORDANCE WITH FEDERAL, STATE, AND LOCAL REGULATIONS. IN ADDITION, THE CONTRACTOR SHALL ADHERE TO THE 10. PERFORM EARTHWORK AND SHAPING ON THE SITE. TOPSOIL SHALL BE STRIPPED AND STOCKPILED "SEDIMENTATION EROSION CONTROL PLAN" CONTAINED HEREIN. THE CONTRACTOR SHALL BE RESPONSIBLE TO POST ALL BONDS AS REQUIRED BY GOVERNMENT AGENCIES WHICH WOULD GUARANTEE THE PROPER IMPLEMENTATION OF THE PLAN.
- 4. ALL SITE WORK, MATERIALS OF CONSTRUCTION, AND CONSTRUCTION METHODS FOR EARTHWORK AND STORM DRAINAGE WORK, SHALL CONFORM TO THE SPECIFICATIONS AND DETAILS AND APPLICABLE SECTIONS OF THE PROJECT SPECIFICATIONS MANUAL. OTHERWISE THIS WORK SHALL CONFORM TO THE STATE OF CONNECTICUT DEPARTMENT OF TRANSPORTATION AND PROJECT GEOTECHNICAL REPORT IF THERE IS NO PROJECT SPECIFICATIONS MANUAL. ALL FILL MATERIAL UNDER STRUCTURES AND PAVED AREAS SHALL BE PER THE ABOVE STATED APPLICABLE SPECIFICATIONS, AND/OR PROJECT GEOTECHNICAL REPORT, AND SHALL BE PLACED IN ACCORDANCE WITH THE APPLICABLE SPECIFICATIONS UNDER THE SUPERVISION OF A QUALIFIED PROFESSIONAL ENGINEER. MATERIAL SHALL BE COMPACTED IN 8" LIFTS TO 95% OF THE MAXIMUM DRY DENSITY AS DETERMINED BY ASTM D 1557 AT 95% PERCENT OF OPTIMUM MOISTURE CONTENT. 2. INSTALL ELECTRICAL COMPONENTS AND INTERCONNECTION
- 5. ALL DISTURBANCE INCURRED TO PUBLIC, MUNICIPAL, COUNTY, STATE PROPERTY DUE TO CONSTRUCTION SHALL BE RESTORED TO ITS PREVIOUS CONDITION OR BETTER, TO THE SATISFACTION OF THE TOWN OF SALEM AND STATE OF CONNECTICUT.
- 6. IF IMPACTED OR CONTAMINATED SOIL IS ENCOUNTERED BY THE CONTRACTOR, THE CONTRACTOR SHALL SUSPEND EXCAVATION WORK OF IMPACTED SOIL AND NOTIFY THE PROJECT DEVELOPER AND/OR PROJECT DEVELOPER'S ENVIRONMENTAL CONSULTANT PRIOR TO PROCEEDING WITH FURTHER WORK IN THE IMPACTED SOIL LOCATION UNTIL FURTHER INSTRUCTED BY THE PROJECT DEVELOPER AND/OR PROJECT DEVELOPER'S ENVIRONMENTAL CONSULTANT.

CONSTRUCTION SEQUENCE NOTES

- THE GENERAL CONSTRUCTION NOTES ARE AS FOLLOWS: THE SITE CONTRACTOR SHALL BE FULLY RESPONSIBLE TO CONTROL CONSTRUCTION SUCH THAT
- SEDIMENTATION SHALL NOT AFFECT ROADS/HIGHWAYS AND THEIR DRAINAGE SYSTEM, NEIGHBORING PROPERTIES. WETLANDS AND REGULATORY PROTECTED AREAS. WHETHER SUCH SEDIMENTATION IS CAUSED BY WATER, WIND, OR DIRECT DEPOSIT. DESIGNATED ACCESS DRIVES MUST BE USED TO THE MAXIMUM EXTENTS POSSIBLE. IT IS REQUIRED THAT THE SITE CONTRACTOR PERFORM A DAILY INSPECTION OF ALL EROSION AND SEDIMENT CONTROL MEASURES EMPLOYED AT THE SITE.
- A CTDEEP-APPROVED QUALIFIED INSPECTOR SHALL BE ASSIGNED TO BE RESPONSIBLE FOR PERFORMING INSPECTIONS AND PREPARING REPORTS IN ACCORDANCE WITH SECTION 5(B)(4)(B) OF THE CONSTRUCTION GENERAL PERMIT. THESE INSPECTIONS SHALL TAKE PLACE WEEKLY, AT A MINIMUM, AND SHALL BE REQUIRED WITHIN 24 HOURS OF A RAINFALL EVENT EXCEEDING 0.5 INCHES. THE ENGINEER OF RECORD SHALL BE REQUIRED TO REVIEW AND COUNTER-SIGN THE PREPARED WEEKLY REPORTS.
- ENGINEER OF RECORD WILL PERFORM MONTHLY PLAN IMPLEMENTATION INSPECTIONS UNTIL EROSION CONTROLS ARE IN PLACE, OR THE FIRST THREE MONTHS (WHICHEVER IS GREATER) AND WILL PREPARE REPORTS OF THE FINDINGS.
- THROUGHOUT THE COURSE OF THE CONSTRUCTION PROJECT, ADDITIONAL SEDIMENT AND EROSION CONTROL MEASURES MAY BE WARRANTED AT THE DISCRETION OF THE QUALIFIED INSPECTOR AND/OR DESIGN ENGINEER. THESE IMPROVEMENTS MUST BE IMPLEMENTED IN A TIMELY FASHION IN 7. ACCORDANCE WITH THE REQUIREMENTS OF THE CONSTRUCTION GENERAL PERMIT.
- PRIOR TO CONSTRUCTION, THE APPLICANT SHALL PROVIDE THE TOWN OF SALEM WITH THE NAME OF CONTACT AND 24-HOUR CONTACT INFORMATION.
- CONTROL, AS AMENDED.
- 7. THE CONTRACTOR SHALL HOLD PRE-CONSTRUCTION MEETING(S). ATTENDEES SHALL INCLUDE, BUT NOT BE LIMITED TO, REPRESENTATIVES OF THE GENERAL CONTRACTOR, SITE CONTRACTOR. CTDEEP, TOWN OF SALEM, ENGINEER OF RECORD, AND QUALIFIED SWPPP INSPECTOR.
- 8. THE CONTRACTOR SHALL CONTACT CALL-BEFORE-YOU-DIG (1-800-922-4455) PRIOR TO ENGAGING IN 10. RELOCATION OF UTILITY PROVIDER FACILITIES, SUCH AS POLES, SHALL BE DONE IN ACCORDANCE ANY EXCAVATION ACTIVITIES AT THE SITE.
- THE CONTRACTOR SHALL NOTIFY THE TOWN OF SALEM AGENT, ZONING ENFORCEMENT OFFICER, AND ENGINEERING DEPARTMENT, 48 HOURS PRIOR TO COMMENCEMENT OF ANY CONSTRUCTION ACTIVITY.
- MEASURES SERVING THE AREA TO BE DISTURBED ARE IN PLACE.
- 11. ANTICIPATED WORK HOURS WILL BE BETWEEN 7:00 AM AND 5:00 PM MONDAY THROUGH FRIDAY. IF ANY VARIATION FROM THIS SCHEDULE IS TEMPORARILY REQUIRED, THE PROJECT TEAM SHALL PROVIDE NOTICE TO CONNECTICUT SITING COUNCIL
- 12. HIGH FLOTATION TIRE EQUIPMENT SHALL BE USED TO THE MAXIMUM EXTENTS PRACTICABLE IN LIEU OF TRACK CONSTRUCTION EQUIPMENT IN AN EFFORT TO AVOID COMPACTION OF THE NATIVE SOILS.

PRE-CONSTRUCTION SITE PROTECTION SEQUENCE SURVEY AND MARK ALL WOODLAND CLEARING LIMITS

- 2. EXISTING AND PROPOSED ACCESS ROADS SHALL BE DESIGNATED AS EARLY AS FEASIBLE AND USED 16. INFORMATION ON EXISTING UTILITIES AND STORM DRAINAGE HAS BEEN COMPILED FROM AVAILABLE PRIMARILY FOR CONSTRUCTION TRAFFIC.
- FIELD SURVEY AND MARK BOUNDARY BETWEEN CLEARING LIMITS AND GRUBBING LIMITS.
- INSTALL EROSION AND SEDIMENT CONTROLS FOLLOWING THE CT GUIDELINES AND MANUFACTURER'S DIRECTIONS. DURING CONSTRUCTION, THE CONTRACTOR SHALL INSTALL MEASURES AS REQUIRED BY THE ENGINEER OF RECORD OR QUALIFIED INSPECTOR, TO PREVENT SEDIMENT-LADEN RUNOFF FROM REACHING WETLANDS OR DISCHARGING OFFSITE
- 5. INSTALL TEMPORARY BRIDGE PER MANUFACTURER RECOMMENDATIONS.
- 6. INSTALL STORMWATER BASIN AS EARLY AS FEASIBLE IN ACCORDANCE WITH THE APPROVED SITE-SPECIFIC SWPCP AND CT GUIDELINES. DISCHARGE AREAS BELOW OUTFALLS MUST BE INSPECTED TO CONFIRM FLOW WILL BE OVER STABLE GROUND AND SHEET FLOW IS ENCOURAGED. IF DISTURBED SOILS ARE PRESENT, THE ENGINEER OF RECORD TO PROVIDE CORRECT MEASURES TO ADDRESS CONDITION.
- SEED AND PROTECT DISTURBED SOILS AROUND SEDIMENT TRAPS AND BASINS WITHIN 72 HOURS OF COMPLETION.
- 8. CLEAR AND GRUB VEGETATION PER SITE PLANS.
- 9. THE USE OF A TUB GRINDER IS RECOMMENDED FOR THE MULCHING OF FELLED TREES IF CHIPPED ON SITE. MULCH SHALL NOT BE CAST WIDESPREAD ACROSS SITE AS IT WILL INHIBIT VEGETATIVE
- FROM AREAS PROPOSED FOR REGRADING. EXCESS SOIL WHICH IS NOT REUSED IN PROPOSED SITE GRADING AS DEPICTED ON PLANS CAN BE HAULED OFF-SITE.
- 11. TOPSOIL SHALL BE REPLACED OVER REGRADED AREAS UPON COMPLETION OF MASS EARTHWORK ACTIVITIES AND AREAS WHICH WERE DISTURBED BY MASS EARTHWORK OPERATIONS SHALL BE RESEEDED WITHIN 72 HOURS OF COMPLETION.
- 12. THROUGHOUT CONSTRUCTION, THE CONTRACTOR SHALL ADDRESS ONGOING EROSION PROBLEMS IT IS OF THE UTMOST IMPORTANCE THAT THE CONTRACTOR COMPLIES WITH THE REQUIREMENT USING TEMPORARY DIVERSIONS AND FILLING AND GRADING GULLIES.

CONSTRUCTION SEQUENCE

1. INSTALL STABILIZED GRAVEL ROADS.

- 3. INSTALL SITE FENCING AND/OR SOUND WALL.
- 4. RESEED, REPAVE, AND/OR REPLANT ANY AREAS DISTURBED BY CONSTRUCTION.
- 5. AFTER SITE IS STABILIZED, AND AFTER INSPECTION BY DESIGN ENGINEER, OR OTHER OWNER'S REPRESENTATIVE, REMOVE TEMPORARY EROSION AND SEDIMENT CONTROLS. ENTIRE SITE SHALL BE CHECKED FOR AND CLEANED OF SEDIMENT AS NEEDED

UTILITY NOTES

- CONTRACTOR IS RESPONSIBLE FOR CONTACTING THE TOWN OF SALEM TO SECURE CONSTRUCTION PERMITS AND FOR PAYMENT OF FEES FOR STREET CUTS AND CONNECTIONS TO EXISTING UTILITIES.
- 2. REFER TO DRAWINGS BY PROJECT DEVELOPER FOR THE ONSITE ELECTRICAL DRAWINGS AND INTERCONNECTION TO EXISTING ELECTRICAL GRID. SITE CONTRACTOR SHALL SUPPLY AND INSTALL PIPE ADAPTERS AS NECESSARY AT BUILDING CONNECTION POINT OR AT EXISTING UTILITY OR PIPE CONNECTION POINT. THESE DETAILS ARE NOT INCLUDED IN THESE PLANS.
- 3. UTILITY LOCATIONS AND PENETRATIONS ARE SHOWN FOR THE CONTRACTOR'S INFORMATION AND SHALL BE VERIFIED WITH THE ELECTRICAL ENGINEER AND THE PROJECT DEVELOPER'S CONSTRUCTION MANAGER PRIOR TO THE START OF CONSTRUCTION.
- 4. THE CONTRACTOR SHALL VISIT THE SITE AND VERIFY THE ELEVATION AND LOCATION OF ALL UTILITIES BY VARIOUS MEANS PRIOR TO BEGINNING ANY EXCAVATION. TEST PITS SHALL BE DUG AT ALL LOCATIONS WHERE PROP. SANITARY SEWERS AND WHERE PROP. STORM PIPING WILL CROSS EXISTING UTILITIES, AND THE HORIZONTAL AND VERTICAL LOCATIONS OF THE UTILITIES SHALL BE DETERMINED. THE CONTRACTOR SHALL CONTACT THE PROJECT DEVELOPER IN THE EVENT OF ANY DISCOVERED OR UNFORESEEN CONFLICTS BETWEEN EXISTING AND PROPOSED SANITARY SEWERS, STORM PIPING AND UTILITIES SO THAT AN APPROPRIATE MODIFICATION MAY BE MADE.
- 5. UTILITY CONNECTION DESIGN AS REFLECTED ON THE PLAN MAY CHANGE SUBJECT TO UTILITY PROVIDER AND GOVERNING AUTHORITY STAFF REVIEW.
- 6. THE CONTRACTOR SHALL ENSURE THAT ALL UTILITY PROVIDERS AND GOVERNING AUTHORITY STANDARDS FOR MATERIALS AND CONSTRUCTION METHODS ARE MET. THE CONTRACTOR SHALL PERFORM PROPER COORDINATION WITH THE RESPECTIVE UTILITY PROVIDER.
- THE CONTRACTOR SHALL ARRANGE FOR AND COORDINATE WITH THE RESPECTIVE UTILITY PROVIDERS FOR SERVICE INSTALLATIONS AND CONNECTIONS. THE CONTRACTOR SHALL COORDINATE WORK TO BE PERFORMED BY THE VARIOUS UTILITY PROVIDERS AND SHALL PAY ALL FEES FOR CONNECTIONS, DISCONNECTIONS, RELOCATIONS, INSPECTIONS, AND DEMOLITION UNLESS OTHERWISE STATED IN THE PROJECT SPECIFICATIONS MANUAL AND/OR GENERAL CONDITIONS OF THE CONTRACT.
- 8. ALL EXISTING PAVEMENT WHERE UTILITY PIPING IS TO BE INSTALLED SHALL BE SAW CUT. AFTER UTILITY INSTALLATION IS COMPLETED. THE CONTRACTOR SHALL INSTALL TEMPORARY AND/OR PERMANENT PAVEMENT REPAIR AS DETAILED ON THE DRAWINGS OR AS REQUIRED BY THE TOWN OF SALEM.
- 9. ALL PIPES SHALL BE LAID ON STRAIGHT ALIGNMENTS AND EVEN GRADES USING A PIPE LASER OR OTHER ACCURATE METHOD.
- WITH THE REQUIREMENTS OF THE UTILITY PROVIDER.
- 11. THE CONTRACTOR SHALL COMPACT PIPE BACKFILL IN 8" LIFTS ACCORDING TO THE PIPE BEDDING DETAILS. TRENCH BOTTOM SHALL BE STABLE IN HIGH GROUNDWATER AREAS. A PIPE FOUNDATION SHALL BE USED PER THE TRENCH DETAILS AND IN AREAS OF ROCK EXCAVATION.
- 12. CONTRACTOR TO PROVIDE STEEL SLEEVES AND ANNULAR SPACE SAND FILL FOR UTILITY PIPE AND CONDUIT CONNECTIONS UNDER FOOTINGS.
- 13. ALL UTILITY CONSTRUCTION IS SUBJECT TO INSPECTION FOR APPROVAL PRIOR TO BACKFILLING, IN ACCORDANCE WITH THE APPROPRIATE UTILITY PROVIDER REQUIREMENTS
- 14. A ONE-FOOT MINIMUM VERTICAL CLEARANCE BETWEEN WATER, GAS, ELECTRICAL, AND TELEPHONE LINES AND STORM PIPING SHALL BE PROVIDED. A SIX-INCH MINIMUM CLEARANCE SHALL BE MAINTAINED BETWEEN STORM PIPING AND SANITARY SEWER. A 6-INCH TO 18-INCH VERTICAL CLEARANCE BETWEEN SANITARY SEWER PIPING AND STORM PIPING SHALL REQUIRE CONCRETE ENCASEMENT OF THE SANITARY PIPING.
- 15. THE CONTRACTOR SHALL RESTORE ANY UTILITY STRUCTURE, PIPE, CONDUIT, PAVEMENT, CURBING, SIDEWALKS, DRAINAGE STRUCTURE, SWALE OR LANDSCAPED AREAS DISTURBED DURING CONSTRUCTION, TO THEIR ORIGINAL CONDITION OR BETTER TO THE SATISFACTION OF THE PROJECT DEVELOPER AND TOWN OF SALEM.
- INFORMATION INCLUDING UTILITY PROVIDER AND MUNICIPAL RECORD MAPS AND/OR FIELD SURVEY, AND IS NOT GUARANTEED CORRECT OR COMPLETE. UTILITIES AND STORM DRAINAGE ARE SHOWN TO ALERT THE CONTRACTOR TO THEIR PRESENCE. THE CONTRACTOR IS SOLELY RESPONSIBLE FOR DETERMINING ACTUAL LOCATIONS AND ELEVATIONS OF ALL UTILITIES AND STORM DRAINAGE INCLUDING SERVICES. CONTACT "CALL BEFORE YOU DIG" AT 811 72 HOURS PRIOR TO CONSTRUCTION AND VERIFY ALL UNDERGROUND AND OVERHEAD UTILITY AND STORM DRAINAGE LOCATIONS. THE CONTRACTOR SHALL EMPLOY THE USE OF A UTILITY LOCATING COMPANY TO PROVIDE SUBSURFACE UTILITY ENGINEERING CONSISTING OF DESIGNATING UTILITIES AND STORM PIPING ON PRIVATE PROPERTY WITHIN THE CONTRACT LIMIT AND CONSISTING OF DESIGNATING AND LOCATING WHERE PROP. UTILITIES AND STORM PIPING CROSS EXISTING UTILITIES AND STORM PIPING WITHIN THE CONTRACT LIMITS.
- 17. THE CONTRACTOR SHALL ARRANGE AND COORDINATE WITH UTILITY PROVIDERS FOR WORK TO BE PERFORMED BY UTILITY PROVIDERS. THE CONTRACTOR SHALL PAY ALL UTILITY FEES UNLESS OTHERWISE STATED IN THE PROJECT SPECIFICATION MANUAL AND GENERAL CONDITIONS, AND REPAIR PAVEMENTS AS NECESSARY.
- 18. ELECTRIC DRAWINGS AND REQUIREMENTS ARE NOT INCLUDED AS PART OF THIS DRAWING SET AND SHOULD BE OBTAINED FROM THE PROJECT DEVELOPER.
- 19. ALTERNATIVE METHODS AND PRODUCTS OTHER THAN THOSE SPECIFIED MAY BE USED IF REVIEWED AND APPROVED BY THE PROJECT DEVELOPER, ENGINEER, AND APPROPRIATE REGULATORY AGENCIES PRIOR TO INSTALLATION.
- 20. THE CONTRACTOR SHALL MAINTAIN ALL FLOWS AND UTILITY CONNECTIONS TO EXISTING BUILDINGS WITHOUT INTERRUPTION UNLESS/UNTIL AUTHORIZED TO DISCONNECT BY THE PROJECT DEVELOPER, TOWN OF SALEM, UTILITY PROVIDERS AND GOVERNING AUTHORITIES.

THE PROPOSED FACILITY IS LOCATED WITHIN SENSITIVE HABITAT KNOWN TO BE USED BY

THESE BAT SPECIES AND PREVENT INCIDENTAL TAKE, PROTECTION AND CONSERVATION

MEASURES ARE PROPOSED DURING CONSTRUCTION AND OPERATION OF THE FACILITY.

FOR IMPLEMENTATION OF THESE PROTECTIVE MEASURES AND THE EDUCATION OF ITS

ALL-POINTS TECHNOLOGY CORPORATION, P.C. ("APT") WILL SERVE AS THE ENVIRONMENTAL

MEASURES ARE IMPLEMENTED PROPERLY. APT WILL PROVIDE AN EDUCATION SESSION FOR THE

APT, AT LEAST 5 BUSINESS DAYS PRIOR TO THE START OF ANY CONSTRUCTION ACTIVITIES TO

SCHEDULE A PRE-CONSTRUCTION MEETING. MR. GUSTAFSON CAN BE REACHED BY PHONE AT

CONTRACTOR PRIOR TO THE START OF CONSTRUCTION ACTIVITIES ON THE POTENTIAL PRESENCE

OF NLEB AND TCB. THE CONTRACTOR SHALL CONTACT DEAN GUSTAFSON, SENIOR BIOLOGIST AT

CONTRACTORS AND SUB-CONTRACTORS PRIOR TO INITIATION OF WORK ON THE SITE; PROTECTIVE

1.a. PRIOR TO WORK ON SITE, THE CONTRACTOR SHALL ATTEND AN EDUCATIONAL SESSION

AT THE PRE-CONSTRUCTION MEETING WITH APT. THIS ORIENTATION AND EDUCATIONAL

SESSION WILL CONSIST OF AN INTRODUCTORY MEETING WITH APT TO EMPHASIZE THE

1.b. THE CONTRACTOR WILL BE PROVIDED WITH CELL PHONE AND EMAIL CONTACTS FOR APT PERSONNEL TO IMMEDIATELY REPORT ANY ENCOUNTERS WITH ANY RARE SPECIES. EDUCATIONAL POSTER MATERIALS WILL BE PROVIDED BY APT AND DISPLAYED ON THE

1.c. IF ANY RARE SPECIES ARE ENCOUNTERED, THE CONTRACTOR SHALL IMMEDIATELY CEASE

ENVIRONMENTALLY SENSITIVE NATURE OF THE PROJECT, THE RARE SPECIES RESOURCES, AND THE REQUIREMENT TO DILIGENTLY FOLLOW THE PROTECTIVE AND CONSERVATION

AND CONSERVATION MEASURES; PERIODIC INSPECTION OF THE CONSTRUCTION PROJECT; AND,

REPORTING. DETAILS OF THE NLEB AND TCB PROTECTION MEASURES TO BE IMPLEMENTED IN

ASSOCIATION WITH CONSTRUCTION AND OPERATION OF THE FACILITY ARE PROVIDED BELOW.

JOB SITE TO MAINTAIN WORKER AWARENESS AS THE PROJECT PROGRESSES.

ALL WORK, AVOID ANY DISTURBANCE TO THE SPECIES, AND CONTACT APT.

MONITOR FOR THIS PROJECT TO ENSURE THAT THESE PROTECTION AND CONSERVATION

THIS PROTECTION PROGRAM CONSISTS OF SEVERAL COMPONENTS: EDUCATION OF ALL

EMPLOYEES AND SUBCONTRACTORS PERFORMING WORK ON THE PROJECT SITE.

(860) 552-2033 OR VIA EMAIL AT DGUSTAFSON@ALLPOINTSTECH.COM.

MEASURES AS DESCRIBED IN SECTIONS BELOW.

1. CONTRACTOR EDUCATION

STATE-LISTED ENDANGERED SPECIES, AND TRICOLORED BAT ("TCB"; PERIMYOTIS SUBFLAVUS), A

FEDERALLY PROPOSED ENDANGERED AND STATE ENDANGERED SPECIES. IN ORDER TO PROTECT

NORTHERN LONG-EARED BAT ("NLEB"; MYOTIS SEPTENTRIONALIS), A FEDERALLY- AND

GENERAL LEGEND

•	SEITEITAL ELS	
	EXISTING	PROPOSED
PROPERTY LINE		
BUILDING SETBACK		
EASEMENT		
TREE LINE		
WETLAND		
WETLAND NOISE BARIER		
WETLAND BUFFER		
VERNAL POOL		
VERNAL POOL BUFFER		
WATERCOURSE		
WATERCOURSE BUFFER		
MAJOR CONTOUR		
MINOR CONTOUR		
UNDERGROUND ELECTRIC		—— Е —— Е ——
OVERHEAD ELECTRIC		—— он —— он ——
BASIN		
SWALE		
FENCE		x x x
LIMIT OF DISTURBANCE		— LOD —— LOD —
FILTER SOCK		— FS — FS —
SILT FENCE		
LEASE LINE		

FAIRY LAKE, LLC

116 HUNTINGTON AVE SUITE 601 BOSTON , **MA** 02116



567 VAUXHALL STREET EXTENSION - SUITE 311 WATERFORD, CT 06385 PHONE: (860)-663-1697 WWW.ALLPOINTSTECH.COM FAX: (860)-663-0935

		CSC SUBMISSION
NO	DATE	REVISION
1	02/20/25	INTERROGATORIES: UKA
2		
3		
4		
5		
6		

DESIGN PROFESSIONALS OF RECORD

PROF: THOMAS E. LITTLE, P.E. **COMP: ALL-POINTS TECHNOLOGY** CORPORATION, P.C. **ADD: 567 VAUXHALL STREET EXTENSION - SUITE 311** WATERFORD, CT 06385

OWNER: 380 NEW LONDON RD HOLDINGS LLC ADDRESS: 380 NEW LONDON ROAD **SALEM, CT 06420**

SALEM BESS

SITE ADDRESS: **380 NEW LONDON ROAD**

SALEM, CT 06420 APT FILING NUMBER: CT760100

DRAWN BY:UKA/ELZ


SHEET TITLE:

GENERAL NOTES & LEGEND

SHEET NUMBER:


ENVIRONMENTAL NOTES - RESOURCES PROTECTION MEASURES

- 2.a. A TIME OF YEAR RESTRICTION ("TOYR") FOR TREE CLEARING RESTRICTS TREE REMOVAL TO OCCUR ONLY BETWEEN NOVEMBER 1ST/THROUGH APRIL 14TH/, DURING THE BAT'S INACTIVE SEASON, WHEN NLEB AND TCB WOULD LIKELY BE IN HIBERNACULA AND NOT PRESENT IN FORESTED HABITAT ON THE SUBJECT PROPERTY. DO NOT REMOVE TREES BETWEEN APRIL 15TH/ THROUGH OCTOBER 31ST/. 3. NLEB AND TCB CONSERVATION
- 3.a. TWO (2) MULTI-CHAMBER NURSERY BAT HOUSES WILL BE INSTALLED IN THE NORTHERN PORTION OF THE SUBJECT PROPERTY LOCATED IN AN EXISTING CLEARED AREA
- PROXIMATE TO A POND AND HORSE POUND BROOK. BAT HOUSE BOXES WILL BE INSTALLED ON EITHER SIDE OF A SINGLE PRESSURE TREATED 20-FOOT LONG 4-INCH BY 6-INCH POST EMBEDDED 4-FEET INTO THE GROUND. BAT HOUSE BOXES WILL BE PAINTED BLACK OR A DARK SHADE OF PAINT AND INSTALLED FACING SOUTHEAST TO CAPTURE MORNING SUN AND ATTAIN SUN EXPOSURE FOR A MINIMUM OF 6-8 HOURS/DAY, IDEAL CONDITIONS FOR REARING YOUNG BAT PUPS. 4. REPORTING
- 4.a. A COMPLIANCE MONITORING REPORT (BRIEF NARRATIVE AND APPLICABLE PHOTOS) DATE: 11/06/24 | CHECKED BY: TEL DOCUMENTING APT INSPECTION VERIFYING TOYR FOR TREE REMOVAL WAS ADHERED TO AND INSTALLATION OF THE BAT HOUSES WILL BE SUBMITTED BY APT TO THE PERMITTEE FOR COMPLIANCE VERIFICATION. ANY OBSERVATIONS OF BATS WILL BE INCLUDED IN THE REPORTS.
- 4.b. FOLLOWING COMPLETION OF THE CONSTRUCTION PROJECT, APT WILL PROVIDE A FINAL COMPLIANCE MONITORING REPORT TO THE PERMITTEE DOCUMENTING IMPLEMENTATION OF THIS NLEB AND TCB PROTECTION AND CONSERVATION PROGRAM AND ANY SPECIES OBSERVATIONS. THE PERMITTEE SHALL PROVIDE A COPY OF THE FINAL COMPLIANCE MONITORING REPORT TO THE CONNECTICUT SITING COUNCIL FOR COMPLIANCE VERIFICATION. 4.c. ANY OBSERVATIONS OF RARE SPECIES WILL BE REPORTED TO DEEP BY APT ON THE
- APPROPRIATE SPECIAL ANIMAL REPORTING FORM, WITH PHOTO-DOCUMENTATION (IF POSSIBLE) AND SPECIFIC INFORMATION ON THE LOCATION AND DISPOSITION OF THE

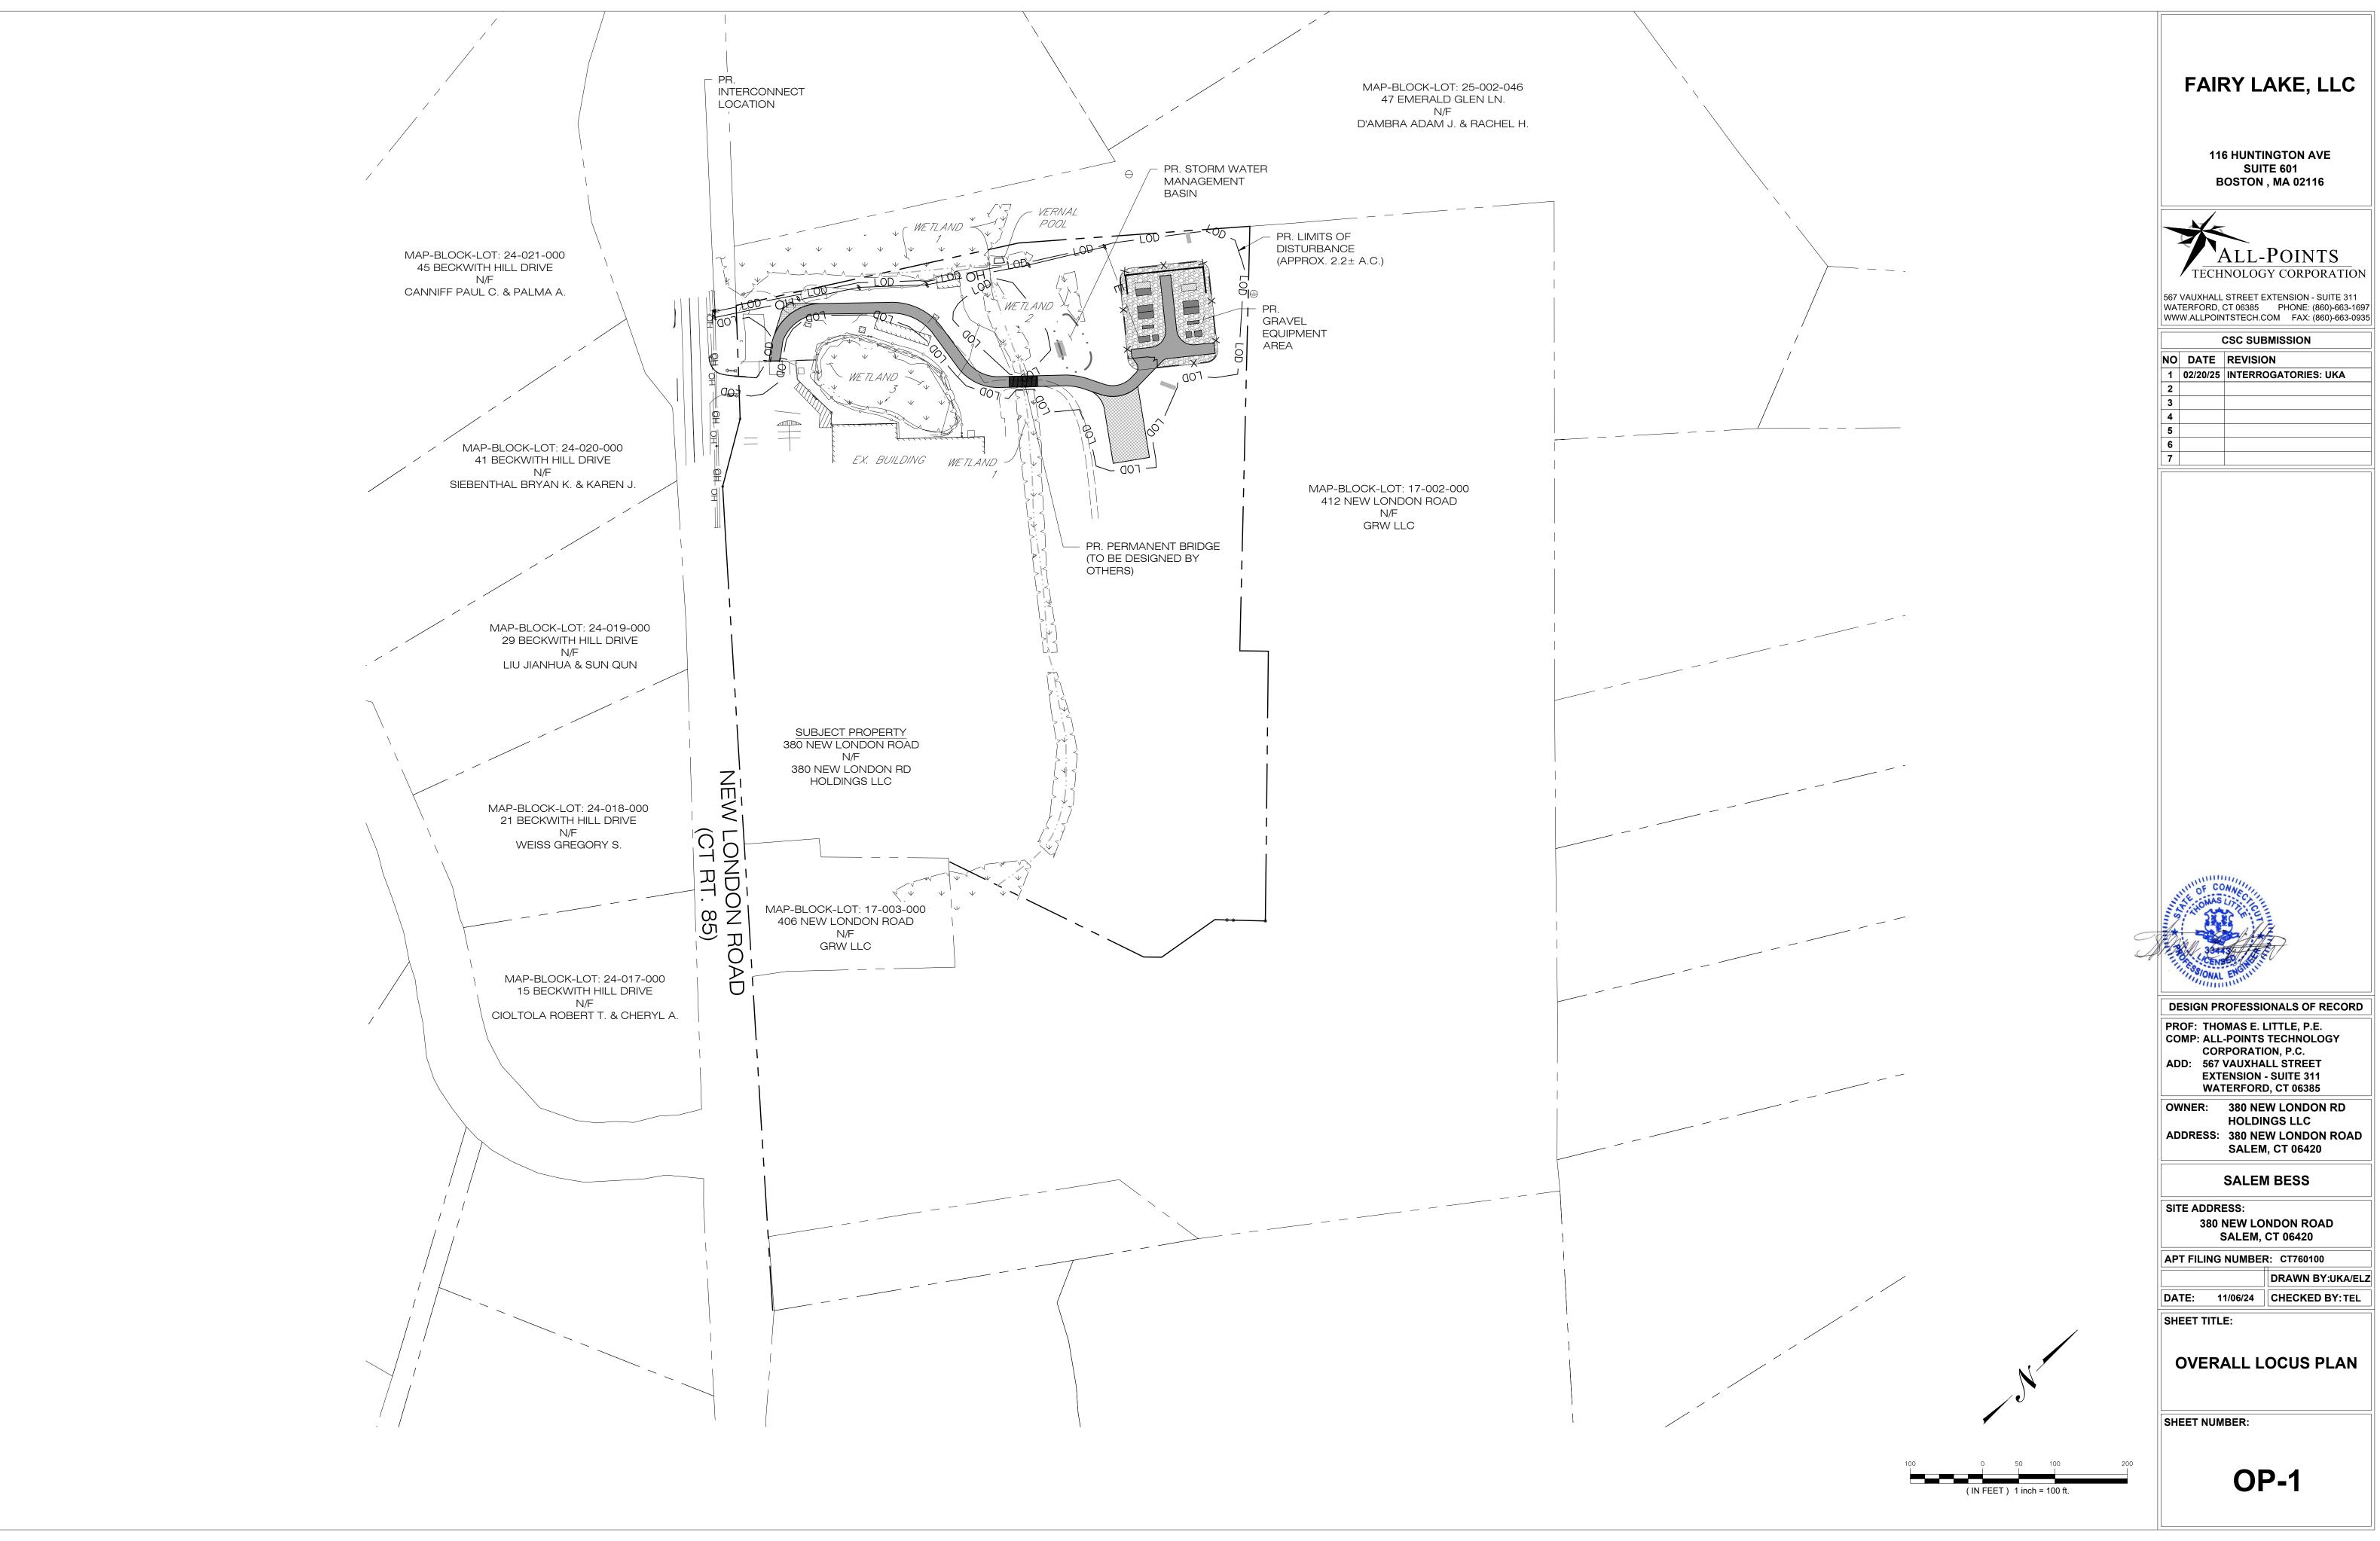



NO	DATE	REVISION
1	02/20/25	INTERROGATORIES: UKA
2		
3		
4		
5		
6		
7		

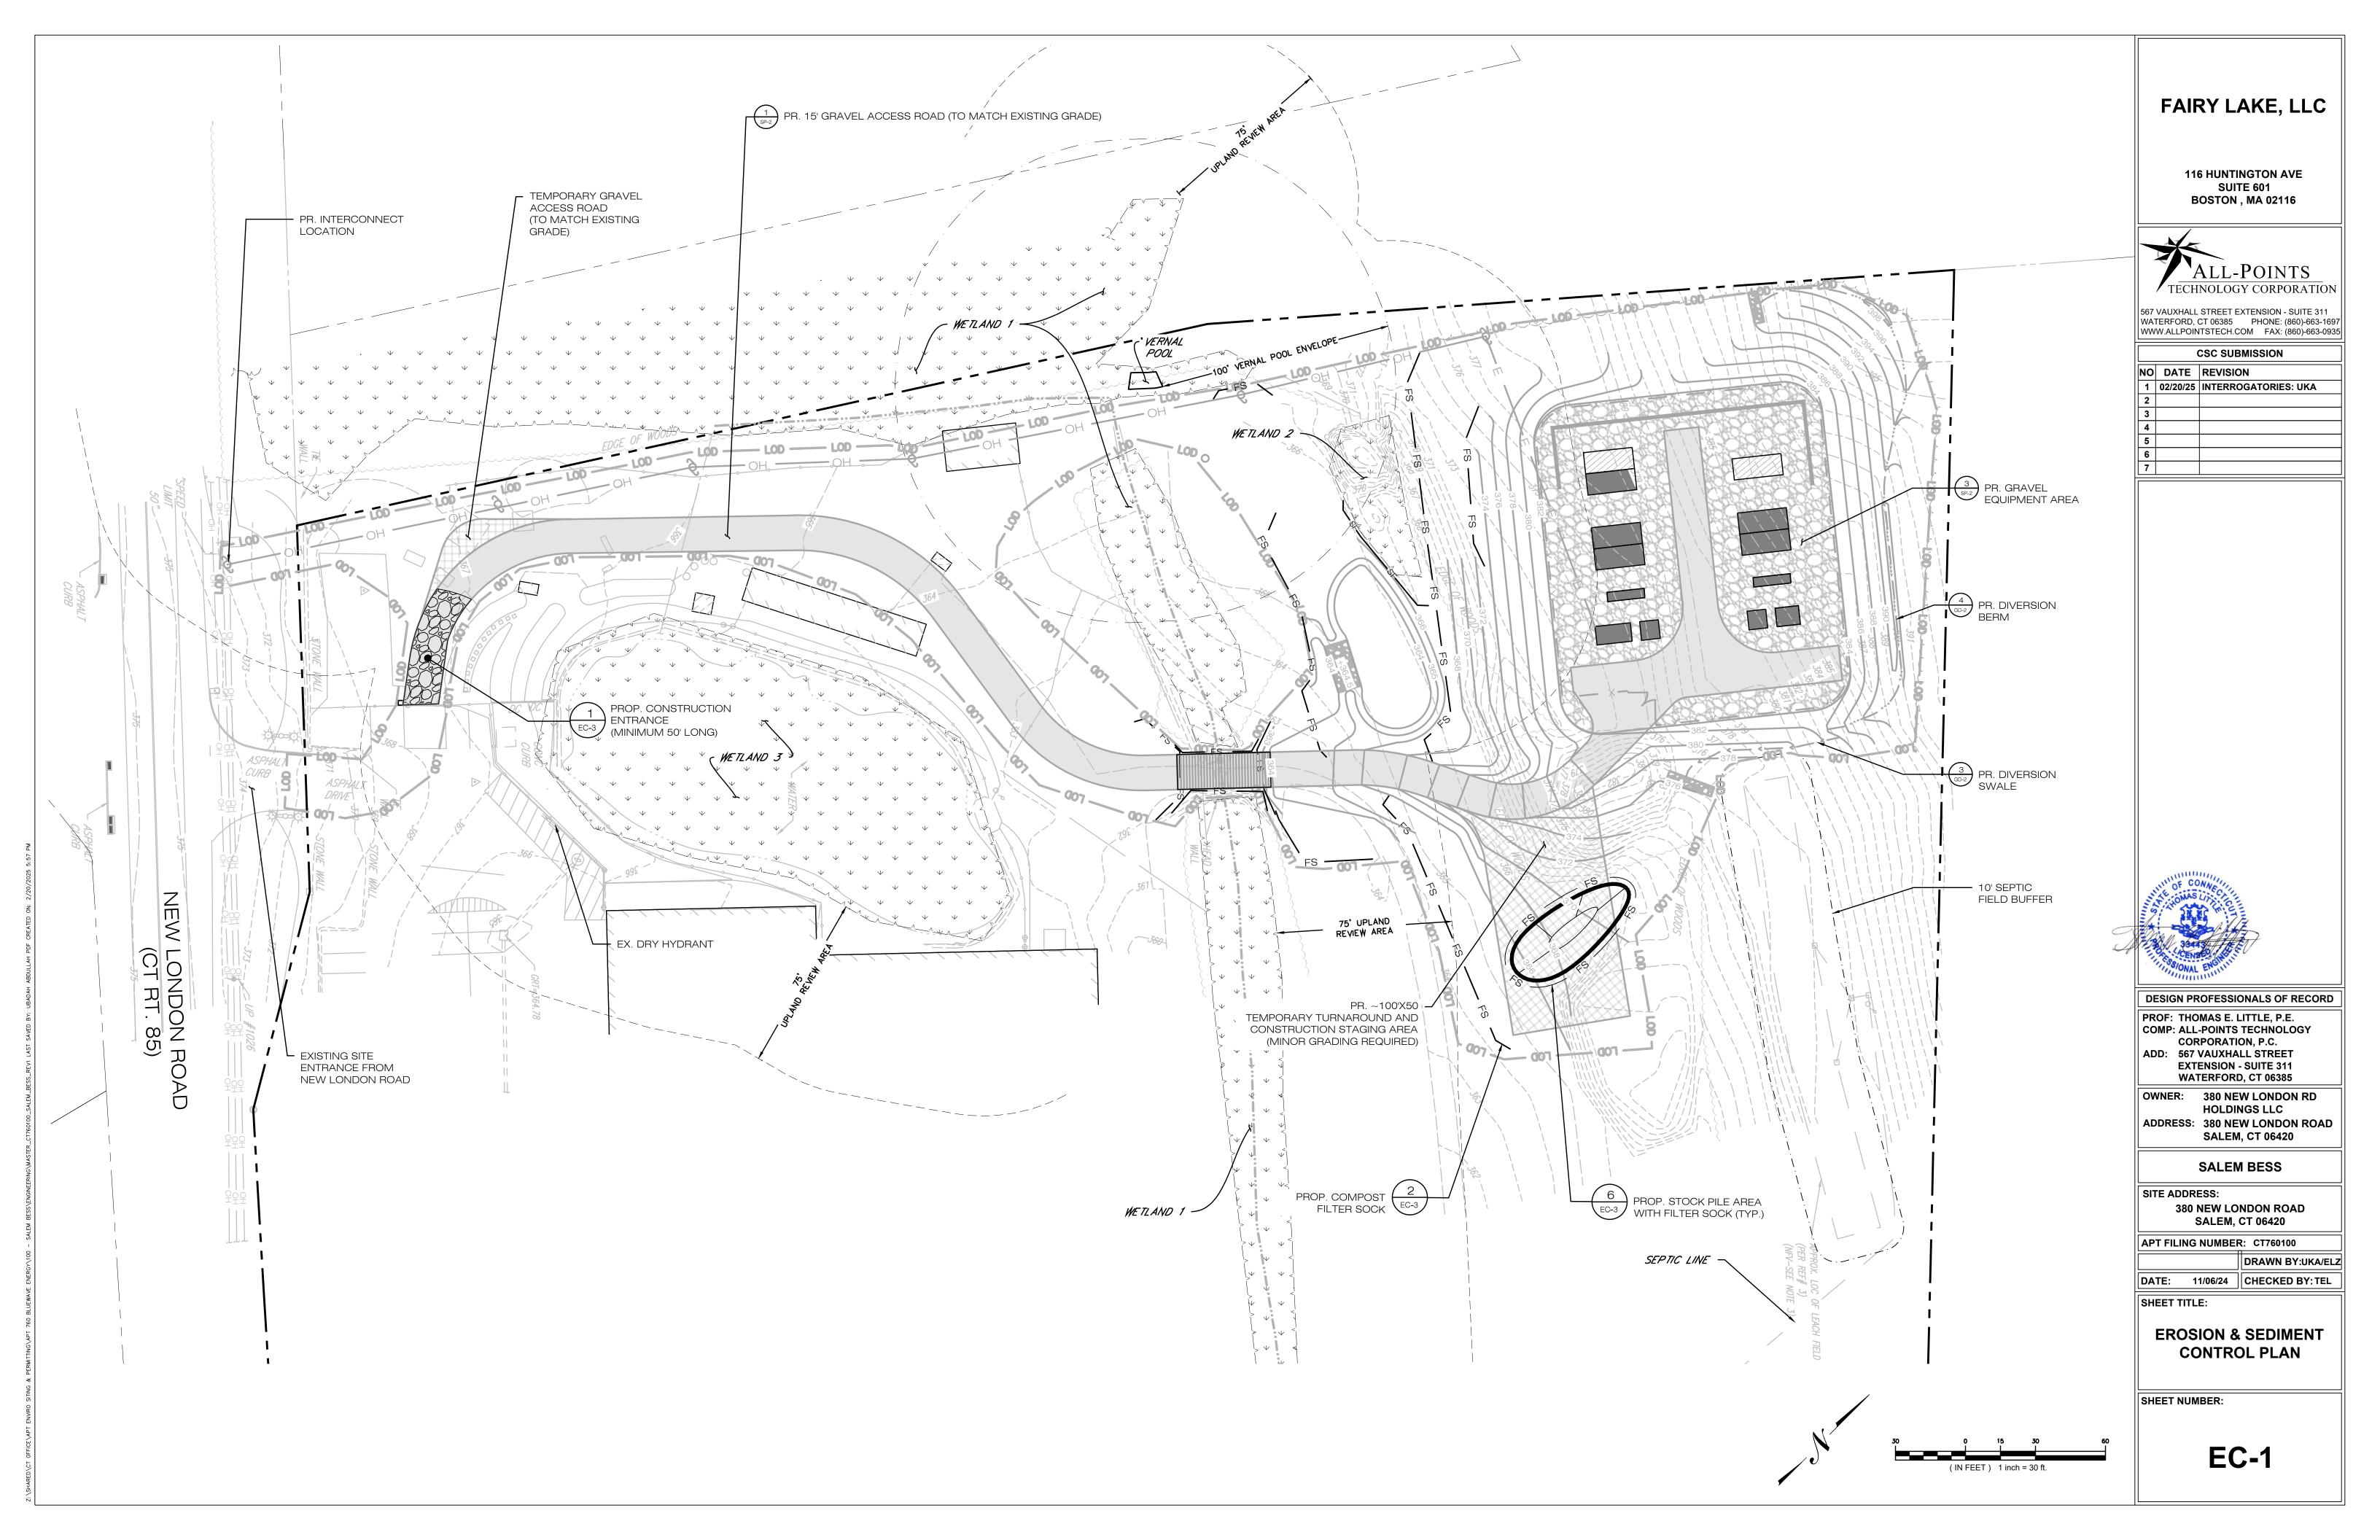

EROSION CONTROL NOTES

EROSION AND SEDIMENT CONTROL PLAN NOTES

- 1. THE CONTRACTOR SHALL CONSTRUCT ALL SEDIMENT AND EROSION CONTROLS IN ACCORDANCE WITH THE 2024 CONNECTICUT GUIDELINES FOR SOIL EROSION AND SEDIMENT CONTROL, LATEST EDITION, IN ACCORDANCE WITH THE CONTRACT DOCUMENTS, AND AS DIRECTED BY THE TOWN OF SALEM, PERMITTEE, AND/OR SWPCP MONITOR. ALL PERIMETER SEDIMENTATION AND EROSION CONTROL MEASURES SHALL BE INSTALLED PRIOR TO THE START OF CLEARING AND GRUBBING AND DEMOLITION OPERATIONS.
- 2. THESE DRAWINGS ARE ONLY INTENDED TO DESCRIBE THE SEDIMENT AND EROSION CONTROL MEASURES FOR THIS SITE. SEE CONSTRUCTION SEQUENCE FOR ADDITIONAL INFORMATION. ALL TEMPORARY EROSION AND SEDIMENT CONTROL MEASURES SHOWN ON THE EROSION & SEDIMENT CONTROL PLAN ARE SHOWN AS REQUIRED BY THE ENGINEER. THE CONTRACTOR SHALL BE RESPONSIBLE FOR ENSURING THAT ALL EROSION CONTROL MEASURES ARE CONFIGURED AND CONSTRUCTED IN A MANNER THAT WILL MINIMIZE EROSION OF SOILS AND PREVENT THE TRANSPORT OF SEDIMENTS AND OTHER POLLUTANTS TO STORM DRAINAGE SYSTEMS AND/OR WATERCOURSES. ACTUAL SITE CONDITIONS OR SEASONAL AND CLIMATIC CONDITIONS MAY WARRANT ADDITIONAL CONTROLS OR CONFIGURATIONS, AS REQUIRED, AND AS DIRECTED BY THE PERMITTEE AND/OR SWPCP MONITOR. REFER TO SITE PLAN FOR GENERAL INFORMATION AND OTHER CONTRACT PLANS FOR APPROPRIATE INFORMATION.
- 3. A BOND OR LETTER OF CREDIT MAY BE REQUIRED TO BE POSTED WITH THE GOVERNING AUTHORITY FOR THE EROSION CONTROL INSTALLATION AND MAINTENANCE.
- 4. THE CONTRACTOR SHALL APPLY THE MINIMUM EROSION & SEDIMENT CONTROL MEASURES SHOWN ON THE PLAN IN CONJUNCTION WITH CONSTRUCTION SEQUENCING, SUCH THAT ALL ACTIVE WORK ZONES ARE PROTECTED. ADDITIONAL AND/OR ALTERNATIVE SEDIMENT AND EROSION CONTROL MEASURES MAY BE INSTALLED DURING THE CONSTRUCTION PERIOD IF FOUND NECESSARY BY THE CONTRACTOR, OWNER, SITE ENGINEER, MUNICIPAL OFFICIALS, OR ANY GOVERNING AGENCY. THE CONTRACTOR SHALL CONTACT THE OWNER AND APPROPRIATE GOVERNING AGENCIES FOR APPROVAL IF ALTERNATIVE CONTROLS OTHER THAN THOSE SHOWN ON THE PLANS ARE PROPOSED BY THE CONTRACTOR.
- 5. THE CONTRACTOR SHALL TAKE EXTREME CARE DURING CONSTRUCTION SO AS NOT TO DISTURB UNPROTECTED WETLAND AREAS OR INSTALLED SEDIMENTATION AND EROSION CONTROL MEASURES. THE CONTRACTOR SHALL INSPECT ALL SEDIMENT AND EROSION CONTROLS WEEKLY AND WITHIN 24 HOURS OF A STORM WITH A RAINFALL AMOUNT OF 0.25 INCHES OR GREATER TO VERIFY THAT THE CONTROLS ARE OPERATING PROPERLY AND MAKE REPAIRS AS NECESSARY IN A TIMELY MANOR.
- 6. THE CONTRACTOR SHALL KEEP A SUPPLY OF EROSION CONTROL MATERIAL (SILT FENCE, COMPOST FILTER SOCK, EROSION CONTROL BLANKET, ETC.) ON-SITE FOR PERIODIC MAINTENANCE AND EMERGENCY REPAIRS.
- 7. ALL FILL MATERIAL PLACED ADJACENT TO ANY WETLAND AREA SHALL BE GOOD QUALITY, WITH LESS THAN 5% FINES PASSING THROUGH A #200 SIEVE (BANK RUN), SHALL BE PLACED IN MAXIMUM ONE FOOT LIFTS, AND SHALL BE COMPACTED TO 95% MAX. DRY DENSITY MODIFIED PROCTOR OR AS SPECIFIED IN THE CONTRACT SPECIFICATIONS.
- 8. PROTECT EXISTING TREES THAT ARE TO BE SAVED BY FENCING, ORANGE SAFETY FENCE, CONSTRUCTION TAPE, OR EQUIVALENT FENCING/TAPE. ANY LIMB TRIMMING SHOULD BE DONE AFTER CONSULTATION WITH AN ARBORIST AND BEFORE CONSTRUCTION BEGINS IN THAT AREA; FENCING SHALL BE MAINTAINED AND REPAIRED DURING CONSTRUCTION.
- 9. CONSTRUCTION ENTRANCES (ANTI-TRACKING PADS) SHALL BE INSTALLED PRIOR TO ANY SITE EXCAVATION OR CONSTRUCTION ACTIVITY AND SHALL BE MAINTAINED THROUGHOUT THE DURATION OF ALL CONSTRUCTION IF REQUIRED. THE LOCATION OF THE TRACKING PADS MAY CHANGE AS VARIOUS PHASES OF CONSTRUCTION ARE COMPLETED. CONTRACTOR SHALL ENSURE THAT ALL VEHICLES EXITING THE SITE ARE PASSING OVER THE ANTI-TRACKING PADS PRIOR TO EXITING.
- 10. ALL CONSTRUCTION SHALL BE CONTAINED WITHIN THE LIMIT OF DISTURBANCE, WHICH SHALL BE MARKED WITH SILT FENCE, SAFETY FENCE, HAY BALES, RIBBONS, OR OTHER MEANS PRIOR TO CLEARING. CONSTRUCTION ACTIVITY SHALL REMAIN ON THE UPHILL SIDE OF THE SEDIMENT BARRIER UNLESS WORK IS SPECIFICALLY CALLED FOR ON THE DOWNHILL SIDE OF THE BARRIER.
- 11. NO CUT OR FILL SLOPES SHALL EXCEED 2:1 EXCEPT WHERE STABILIZED BY ROCK FACED EMBANKMENTS OR EROSION CONTROL BLANKETS. ALL SLOPES SHALL BE SEEDED AND BANKS WILL BE STABILIZED IMMEDIATELY UPON COMPLETION OF FINAL GRADING UNTIL TURF IS ESTABLISHED.
- 12. DIRECT ALL DEWATERING PUMP DISCHARGE TO A SEDIMENT CONTROL DEVICE CONFORMING TO THE GUIDELINES WITHIN THE APPROVED LIMIT OF DISTURBANCE IF REQUIRED. DISCHARGE TO STORM DRAINS OR SURFACE WATERS FROM SEDIMENT CONTROLS SHALL BE CLEAR AND APPROVED BY THE PERMITTEE OR MUNICIPALITY.
- 13. THE CONTRACTOR SHALL MAINTAIN A CLEAN CONSTRUCTION SITE AND SHALL NOT ALLOW THE ACCUMULATION OF RUBBISH OR CONSTRUCTION DEBRIS ON THE SITE. PROPER SANITARY DEVICES SHALL BE MAINTAINED ON-SITE AT ALL TIMES AND SECURED APPROPRIATELY. THE CONTRACTOR SHALL TAKE ALL NECESSARY PRECAUTIONS TO AVOID THE SPILLAGE OF FUEL OR OTHER POLLUTANTS ON THE CONSTRUCTION SITE AND SHALL ADHERE TO ALL APPLICABLE POLICIES AND REGULATIONS RELATED TO SPILL PREVENTION AND RESPONSE/CONTAINMENT.
- 14. MINIMIZE LAND DISTURBANCES. SEED AND MULCH DISTURBED AREAS WITH TEMPORARY MIX AS SOON AS PRACTICABLE (2 WEEK MAXIMUM UNSTABILIZED PERIOD) USING PERENNIAL RYEGRASS AT 40 LBS PER ACRE. MULCH ALL CUT AND FILL SLOPES AND SWALES WITH LOOSE HAY AT A RATE OF 2 TONS PER ACRE. IF NECESSARY, REPLACE LOOSE HAY ON SLOPES WITH EROSION CONTROL BLANKETS OR JUTE CLOTH. MODERATELY GRADED AREAS, ISLANDS, AND TEMPORARY CONSTRUCTION STAGING AREAS MAY BE HYDROSEEDED WITH TACKIFIER.
- 15. SWEEP AFFECTED PORTIONS OF OFF SITE ROADS ONE OR MORE TIMES A DAY (OR LESS FREQUENTLY IF TRACKING IS NOT A PROBLEM) DURING CONSTRUCTION. FOR DUST CONTROL, PERIODICALLY MOISTEN EXPOSED SOIL SURFACES WITH WATER ON UNPAVED TRAVELWAYS TO KEEP THE TRAVELWAYS DAMP. CALCIUM CHLORIDE MAY ALSO BE APPLIED TO ACCESS ROADS. DUMP TRUCK LOADS EXITING THE SITE SHALL BE COVERED.
- 16. VEGETATIVE ESTABLISHMENT SHALL OCCUR ON ALL DISTURBED SOIL, UNLESS THE AREA IS UNDER ACTIVE CONSTRUCTION, IT IS COVERED IN STONE OR SCHEDULED FOR PAVING WITHIN 30 DAYS. TEMPORARY SEEDING OR NON-LIVING SOIL PROTECTION OF ALL EXPOSED SOILS AND SLOPES SHALL BE INITIATED WITHIN THE FIRST 7 DAYS OF SUSPENDING WORK IN AREAS TO BE LEFT LONGER THAN 30 DAYS.
- 17. MAINTAIN ALL PERMANENT AND TEMPORARY SEDIMENT CONTROL DEVICES IN EFFECTIVE CONDITION THROUGHOUT THE CONSTRUCTION PERIOD. UPON COMPLETION OF WORK SWEEP CONCRETE PADS, CLEAN THE STORMWATER MANAGEMENT SYSTEMS AND REMOVE ALL TEMPORARY SEDIMENT CONTROLS ONCE THE SITE IS FULLY STABILIZED AND APPROVAL HAS BEEN RECEIVED FROM PERMITTEE OR THE MUNICIPALITY.
- 18. THE SITE WAS DESIGNED TO COMPLY WITH FEDERAL, STATE, AND, IF APPLICABLE, LOCAL STANDARDS, PLUS CURRENT ACCEPTED PRACTICES FOR THE INDUSTRY. ADDITIONAL CONTROLS AND ACTIVITIES MAY BE DEEMED NECESSARY BY THE SWPCP MONITOR DURING CONSTRUCTION AS A RESULT OF UNFORESEEN CONDITIONS AND/OR MEANS AND METHODS. SUCH ITEMS MAY INCLUDE, BUT ARE NOT LIMITED TO: ADDITIONAL FOREBAYS, BASINS, OR UPSTREAM STRUCTURAL CONTROLS, THE USE OF FLOCCULANTS OF FLOCK LOGS TO DECREASE SEDIMENT, DISCHARGE MANAGEMENT SUCH AS ADDITIONAL ARMORING AND FILTERING MEASURES (I.E. STRAW BALES, WATTLES, ETC.), AND HYDROSEEDING WITH RAPIDLY GERMINATING SEED.

	CONSTRUCTION OPERATION AND MAINTENANCE PLAN - BY CONTRACTOR			
E&S MEASURE	INSPECTION SCHEDULE	MAINTENANCE REQUIRED		
CONSTRUCTION ENTRANCE	DAILY	PLACE ADDITIONAL STONE, EXTEND THE LENGTH OR REMOVE AND REPLACE THE STONE. CLEAN PAVED SURFACES OF TRACKED SEDIMENT.		
COMPOST FILTER SOCK	WEEKLY & WITHIN 24 HOURS OF RAINFALL > 0.25"	REPAIR/REPLACE WHEN FAILURE OR DETERIORATION IS OBSERVED.		
SILT FENCE	WEEKLY & WITHIN 24 HOURS OF RAINFALL > 0.25"	REPAIR/REPLACE WHEN FAILURE OR DETERIORATION IS OBSERVED. REMOVE SILT WHEN IT REACHES 1/2 THE HEIGHT OF THE FENCE.		
TOPSOIL/BORROW STOCKPILES	DAILY	REPAIR/REPLACE SEDIMENT BARRIERS AS NECESSARY.		
TEMPORARY SOIL PROTECTION	WEEKLY & WITHIN 24 HOURS OF RAINFALL > 0.25"	REPAIR ERODED OR BARE AREAS IMMEDIATELY. RESEED AND MULCH.		

FAIRY LAKE, LLC

116 HUNTINGTON AVE SUITE 601 BOSTON , MA 02116



567 VAUXHALL STREET EXTENSION - SUITE 311 WATERFORD, CT 06385 PHONE: (860)-663-1697 WWW.ALLPOINTSTECH.COM FAX: (860)-663-0935

	CSC SUBMISSION		
NO	DATE	REVISION	
1	02/20/25	INTERROGATORIES: UKA	
2			
3			
4			
5			
6			
7			



DESIGN PROFESSIONALS OF RECORD

PROF: THOMAS E. LITTLE, P.E.
COMP: ALL-POINTS TECHNOLOGY
CORPORATION, P.C.
ADD: 567 VAUXHALL STREET
EXTENSION - SUITE 311
WATERFORD, CT 06385

OWNER: 380 NEW LONDON RD
HOLDINGS LLC
ADDRESS: 380 NEW LONDON ROAD
SALEM, CT 06420

SALEM BESS

SITE ADDRESS:

380 NEW LONDON ROAD SALEM, CT 06420

APT FILING NUMBER: CT760100

DRAWN BY:UKA/ELZ

SHEET TITLE:


EROSION & SEDIMENT CONTROL

NOTES


DATE: 11/06/24 CHECKED BY: TEL

SHEET NUMBER:

EC-2

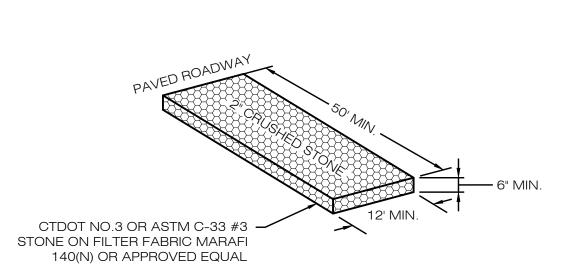

CONSTRUCTION **ENTRANCE DETAIL**

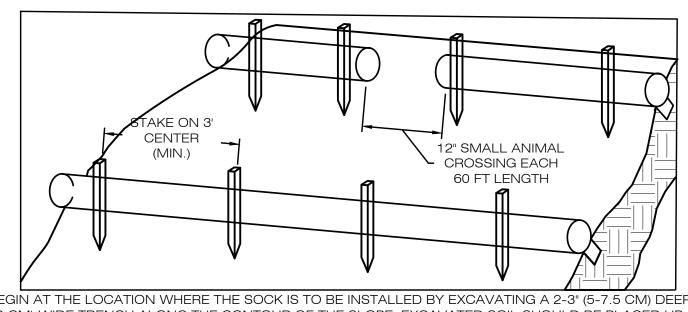


1. BEGIN AT THE LOCATION WHERE THE SOCK IS TO BE INSTALLED BY EXCAVATING A 2-3" (5-7.5 CM) DEEP X 9" (22.9 CM) WIDE TRENCH ALONG THE CONTOUR OF THE SLOPE. EXCAVATED SOIL SHOULD BE PLACED UP SLOPE

2. PLACE THE SOCK IN THE TRENCH SO THAT IT CONTOURS TO THE SOIL SURFACE. COMPACT SOIL FROM THE EXCAVATED TRENCH AGAINST THE SOCK ON THE UPHILL SIDE. SOCKS SHALL BE INSTALLED IN 60 FT CONTINUOUS LENGTHS WITH ADJACENT SOCKS TIGHTLY ABUT. EVERY 60 FT THE SOCK ROW SHALL BE

SPACED 12 INCHES CLEAR, END TO END, FOR AMPHIBIAN AND REPTILE TRAVEL. THE OPEN SPACES SHALL BE STAGGERED MID LENGTH OF THE NEXT DOWN GRADIENT SOCK. 3. SECURE THE SOCK WITH 18-24" (45.7-61 CM) STAKES EVERY 3' (0.9 -1.2 M) AND WITH A STAKE ON EACH END. STAKES SHOULD BE DRIVEN THROUGH THE MIDDLE OF THE SOCK LEAVING AT LEAST 2-3" (5-7.5 CM) OF STAKE EXTENDING ABOVE THE SOCK. STAKES SHOULD BE DRIVEN PERPENDICULAR TO THE SLOPE FACE.


4. CONTRACTOR TO FOLLOW MANUFACTURE'S SPECIFICATIONS AND INSTALL DIRECTIONS IF DIRECTED THAN

COMPOST FILTER SOCK SEDIMENTATION CONTROL BARRIER SCALE: N.T.S.

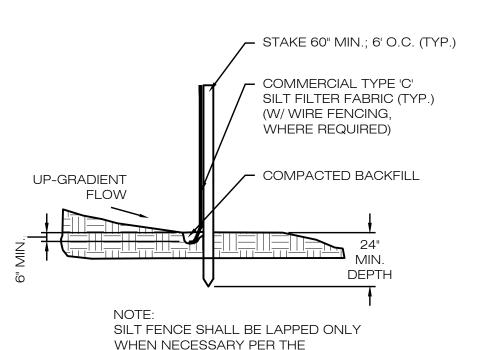

<u>\SILT FENCE DETAIL</u> SCALE : N.T.S.

MANUFACTURER RECOMMENDATIONS.

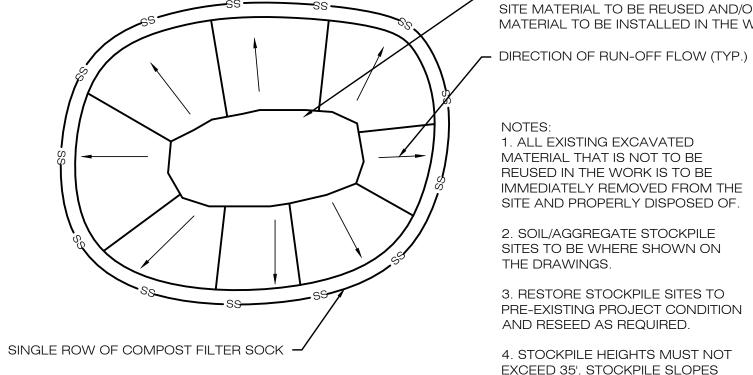

SOIL/AGGREGATE STOCKPILE OF EXISTING SITE MATERIAL TO BE REUSED AND/OR NEW MATERIAL TO BE INSTALLED IN THE WORK

1. ALL EXISTING EXCAVATED MATERIAL THAT IS NOT TO BE REUSED IN THE WORK IS TO BE IMMEDIATELY REMOVED FROM THE SITE AND PROPERLY DISPOSED OF.

2. SOIL/AGGREGATE STOCKPILE SITES TO BE WHERE SHOWN ON THE DRAWINGS.

3. RESTORE STOCKPILE SITES TO PRE-EXISTING PROJECT CONDITION AND RESEED AS REQUIRED.

4. STOCKPILE HEIGHTS MUST NOT EXCEED 35'. STOCKPILE SLOPES MUST BE 2:1 OR FLATTER.





Ernst Conservation Seeds 8884 Mercer Pike

Meadville, PA 16335 (800) 873-3321 Fax (814) 336-5191 www.ernstseed.com

Date: July 12, 2022

Quick Erosion Control Cover Mix - ERNMX-104

Botanical Name 50.00 % Lolium multiflorum

50.00 % Lolium perenne, 'Blackstone'

Common Name Annual Ryegrass Perennial Ryegrass, 'Blackstone'

100.00 %

Seeding Rate: 50 lb per acre

Erosion Control & Revegetation

Designed to achieve that quick, green color and fast erosion control with strong, fibrous roots. Mix formulations are subject to change without notice depending on the availability of existing and new products. While the formula may change, the guiding philosophy and function of the mix will not.



Ernst Conservation Seeds

8884 Mercer Pike Meadville, PA 16335 (800) 873-3321 Fax (814) 336-5191 www.ernstseed.com

Date: July 17, 2022

Rain Garden Mix - ERNMX-180

Botanical Name Common Name

34.50 % Schizachyrium scoparium, Fort Indiantown Gap-PA Ecotype Little Bluestem, Fort Indiantown Gap-PA Ecotype

Virginia Wildrye, Madison-NY Ecotype 20.00 % Elymus virginicus, Madison-NY Ecotype

7.50 % Echinacea purpurea Purple Coneflower River Oats, WV Ecotype 5.60 % Chasmanthium latifolium, WV Ecotype

5.00 % Carex vulpinoidea, PA Ecotype Fox Sedge, PA Ecotype 3.00 % Chamaecrista fasciculata, PA Ecotype Partridge Pea, PA Ecotype

3.00 % Coreopsis lanceolata Lanceleaf Coreopsis

3.00 % Panicum rigidulum, PA Ecotype Redtop Panicgrass, PA Ecotype 3.00 % Rudheckia hirta Blackeyed Susan

Oxeye Sunflower, PA Ecotype 2.00 % Heliopsis helianthoides, PA Ecotype

2.00 % Panicum clandestinum, Tioga 2.00 % Verbena hastata, PA Ecotype Blue Vervain, PA Ecotype

1.70 % Asclepias incarnata, PA Ecotype Swamp Milkweed, PA Ecotype

Blunt Broom Sedge, PA Ecotype 1.00 % Carex scoparia, PA Ecotype

1.00 % Senna hebecarpa, VA & WV Ecotype Wild Senna, VA & WV Ecotype 0.90 % Penstemon digitalis, PA Ecotype Tall White Beardtongue, PA Ecotype

0.80 % Zizia aurea, PA Ecotype Golden Alexanders, PA Ecotype Narrowleaf Mountainmint 0.70 % Pycnanthemum tenuifolium

0.50 % Baptisia australis, Southern WV Ecotype Blue False Indigo, Southern WV Ecotype 0.40 % Aster lateriflorus Calico Aster

0.40 % Monarda fistulosa, Fort Indiantown Gap-PA Ecotype 0.30 % Aster novae-angliae, PA Ecotype

0.30 % Aster prenanthoides, PA Ecotype Zigzag Aster, PA Ecotype 0.30 % Juncus tenuis, PA Ecotype Path Rush, PA Ecotype

0.20 % Eupatorium perfoliatum, PA Ecotype Boneset, PA Ecotype

0.20 % Helenium autumnale, Northern VA Ecotype 0.20 % Juncus effusus Soft Rush

0.20 % Oenothera fruticosa var. fruticosa 0.20 % Solidago nemoralis, PA Ecotype Gray Goldenrod, PA Ecotype 0.10 % Solidago rugosa, PA Ecotype

100.00 %

Seeding Rate: 20 lb per acre with a cover crop. For sites that drain within 24 hours of a rain event use one of

10 lbs/acre), or grain rye (1 Aug to 31 Dec; 30

Stormwater Management; Uplands & Meadows

without notice depending on the availability of existing and new products. While the formula may change, the guiding philosophy and function of the mix will not.



1.00 % Rudbeckia hirta

0.20 % Aster pilosus, PA Ecotype

Wild Bergamot, Fort Indiantown Gap-PA Ecotype

New England Aster, PA Ecotype

Common Sneezeweed, Northern VA Ecotype

Sundrops

Wrinkleleaf Goldenrod, PA Ecotype

the following cover crops:Oats (1 Jan to 31 Jul; 30 lbs/acre), Japanese Millet (1 May to 31 Aug;

The native perennial forbs and grasses provide food and cover for rain garden biodiversity. Mix formulations are subject to change



Seeding Rate: 60 lb per acre, or 1.5 lb per 1,000 sq ft

Erosion Control & Revegetation; Grasses & Grass-like Species - Herbaceous Perennial; Herbaceous Flowering Species - Herbaceous

The native grass and forb species tolerate poor soils typically found on steep slopes in the eastern United States. Mix formulations are subject to change without notice depending on the availability of existing and new products. While the formula may change, the guiding philosophy and function of the mix will not.



DESIGN PROFESSIONALS OF RECORD

FAIRY LAKE, LLC

116 HUNTINGTON AVE

SUITE 601

BOSTON , **MA** 02116

'ALL-POINTS

TECHNOLOGY CORPORATION

567 VAUXHALL STREET EXTENSION - SUITE 311

WATERFORD, CT 06385 PHONE: (860)-663-1697 WWW.ALLPOINTSTECH.COM FAX: (860)-663-0935

CSC SUBMISSION

1 02/20/25 INTERROGATORIES: UKA

NO DATE REVISION

PROF: THOMAS E. LITTLE, P.E. COMP: ALL-POINTS TECHNOLOGY CORPORATION, P.C. ADD: 567 VAUXHALL STREET **EXTENSION - SUITE 311**

OWNER: 380 NEW LONDON RD **HOLDINGS LLC** ADDRESS: 380 NEW LONDON ROAD **SALEM, CT 06420**

WATERFORD, CT 06385

SALEM BESS

380 NEW LONDON ROAD

SITE ADDRESS:

SALEM, CT 06420

APT FILING NUMBER: CT760100

DRAWN BY:UKA/ELZ


DATE: 11/06/24 | CHECKED BY: TEL


SHEET TITLE:

EROSION & SEDIMENT CONTROL **DETAILS**

SHEET NUMBER:

EC-3

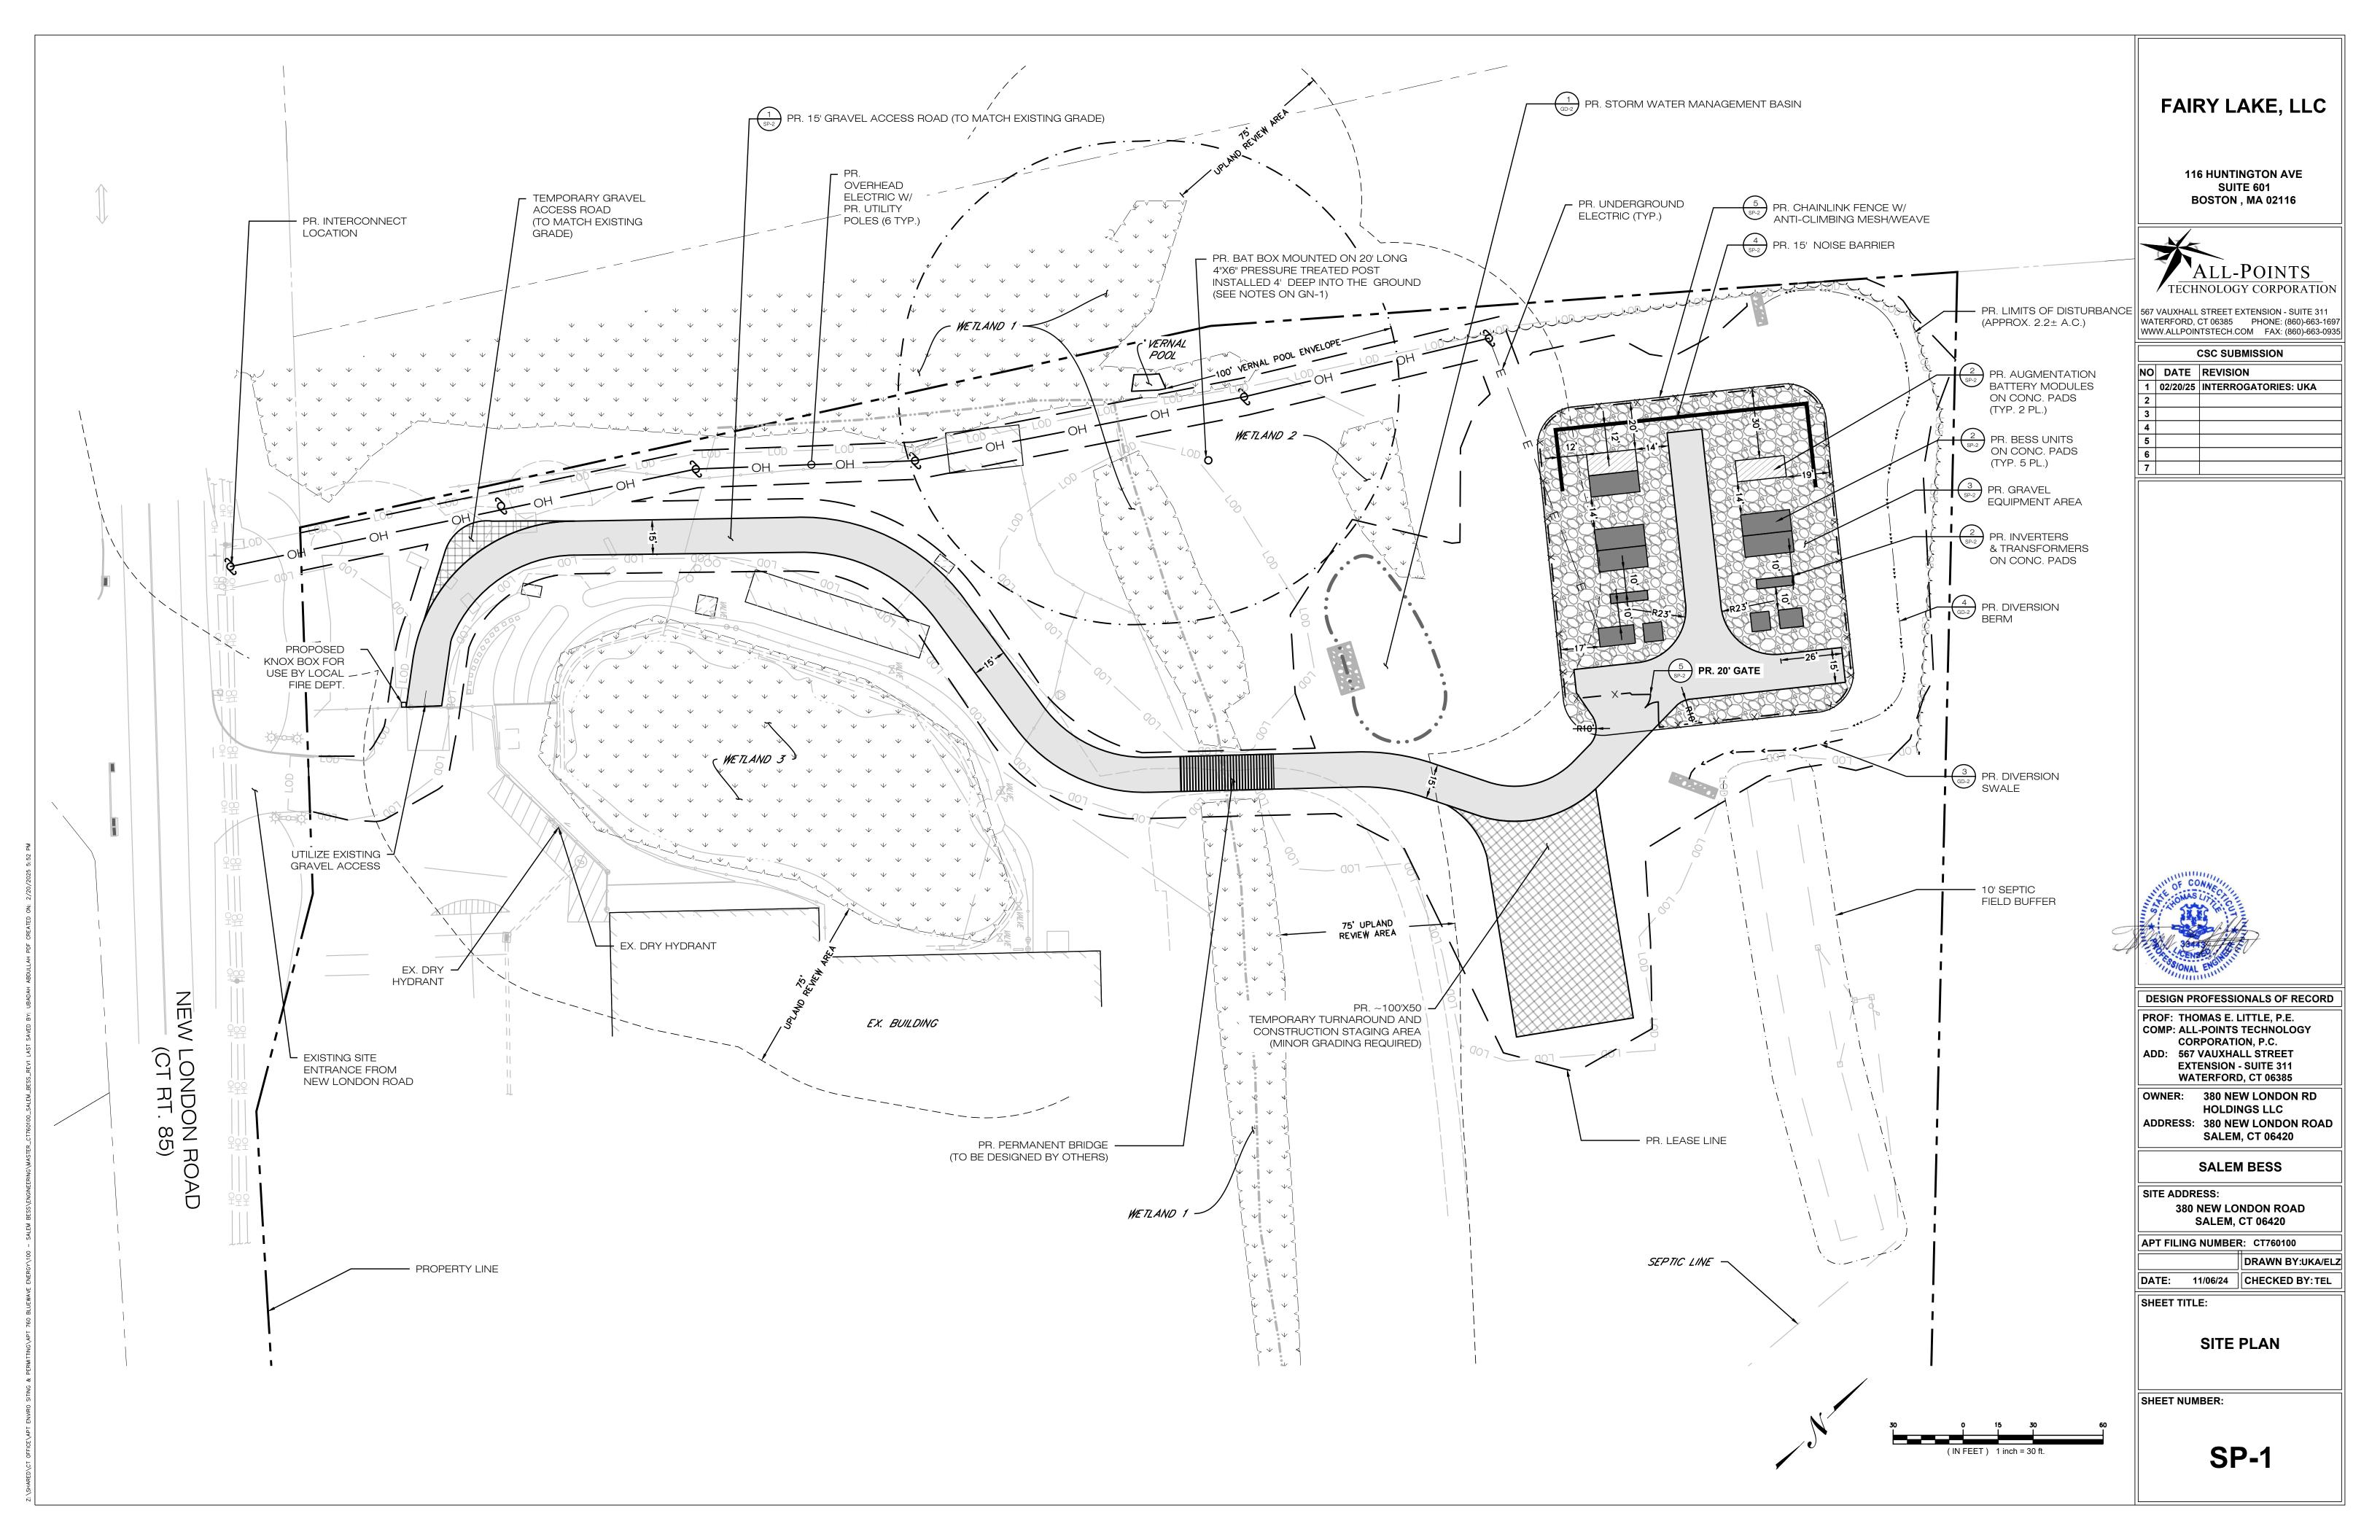

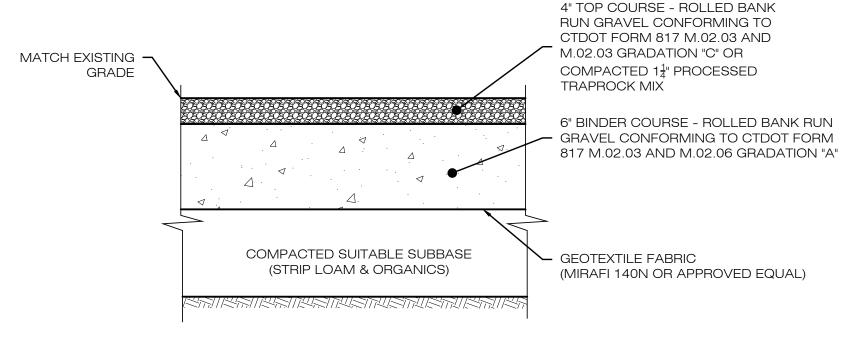


NOTES:

- SUBBASE MAY CONSIST OF NATIVE MATERIALS IF FOUND ACCEPTABLE
 BY THE ENGINEER. SUBBASE TO BE COMPACTED TO 95% MAX DRY

 PENDITY
- DENSITY.

 2. SUBBASE IS TO BE FREE FROM DEBRIS AND UNSUITABLE MATERIALS.

1 GRAVEL ACCESS DRIVE SECTION SCALE: N.T.S.

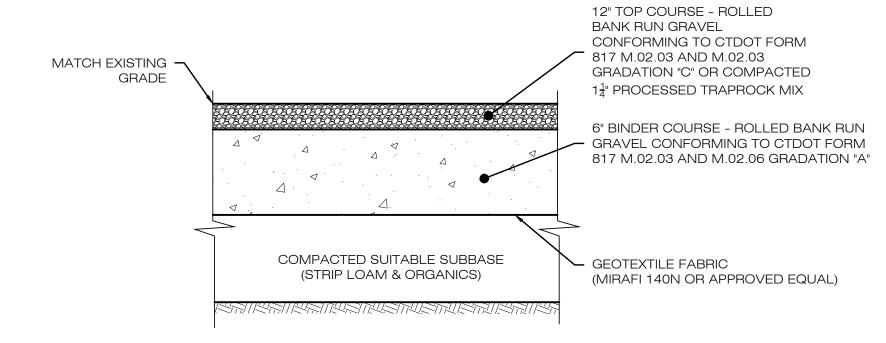


NOTES:

SUBBASE MAY CONSIST OF NATIVE MATERIALS IF FOUND ACCEPTABLE
BY THE ENGINEER. SUBBASE TO BE COMPACTED TO 95% MAX DRY
DENSITY


2. SUBBASE IS TO BE FREE FROM DEBRIS AND UNSUITABLE MATERIALS.



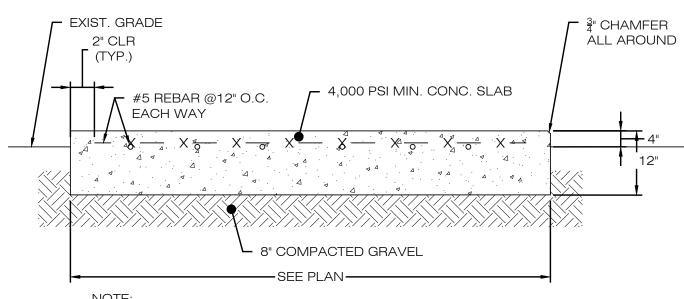

NOTE: SEE ELECTRICAL DRAWINGS FOR ADDITIONAL CONCRETE PAD DESIGN DETAILS

2 CONCRETE EQUIPMENT PAD SP-2 SCALE: N.T.S.

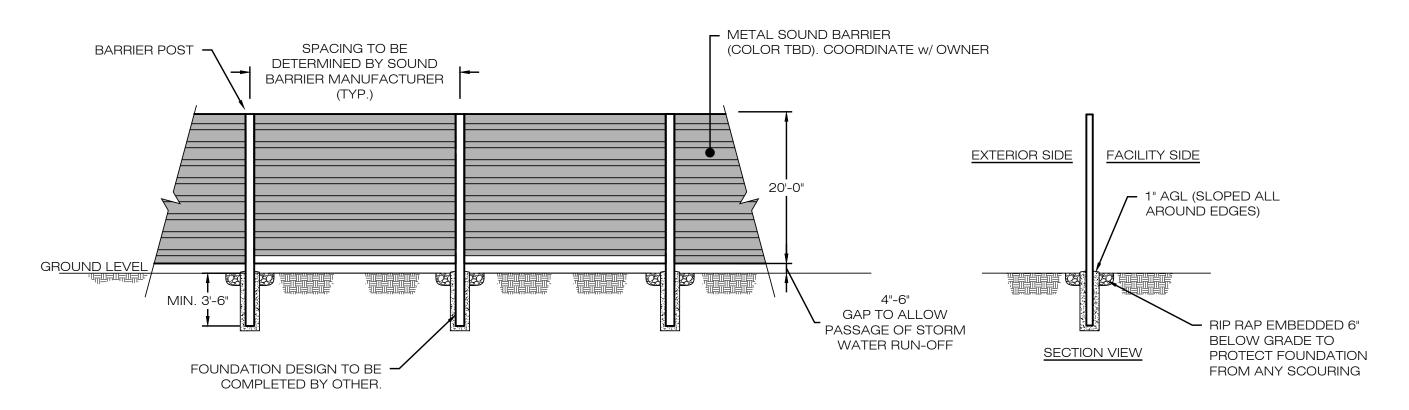


NOTES:

1. SOUND BARRIER PRODUCT & SPECIFICATIONS TO BE DETERMINED BY
OWNER

2. BARRIER POST FOUNDATION TO BE DESIGNED BY OTHERS.

4 GENERIC SOUND BARRIER DETAIL SP-2 SCALE: N.T.S.

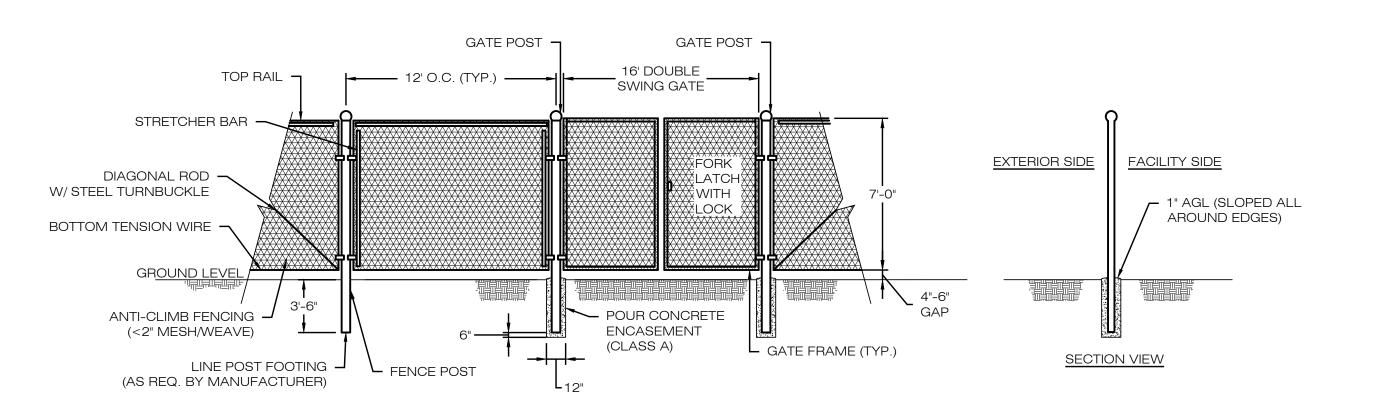

5 CHAIN-LINK FENCE & GATE DETAIL
SP-2 SCALE: N.T.S.


FAIRY LAKE, LLC

116 HUNTINGTON AVE SUITE 601 BOSTON , MA 02116



567 VAUXHALL STREET EXTENSION - SUITE 311 WATERFORD, CT 06385 PHONE: (860)-663-1697 WWW.ALLPOINTSTECH.COM FAX: (860)-663-0935

CSC SUBMISSION		
NO	DATE	REVISION
1	02/20/25	INTERROGATORIES: UKA
2		
3		
4		
5		
6		

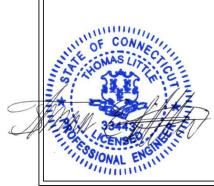

DESIGN PROFESSIONALS OF RECORD

PROF: THOMAS E. LITTLE, P.E.
COMP: ALL-POINTS TECHNOLOGY
CORPORATION, P.C.
ADD: 567 VAUXHALL STREET
EXTENSION - SUITE 311
WATERFORD, CT 06385

OWNER: 380 NEW LONDON RD
HOLDINGS LLC
ADDRESS: 380 NEW LONDON ROAD
SALEM, CT 06420

SALEM BESS

SITE ADDRESS:

380 NEW LONDON ROAD SALEM, CT 06420

APT FILING NUMBER: CT760100

TITLING NUMBER. C176010


DATE: 11/06/24 CHECKED BY: TEL


SHEET TITLE:


SITE PLAN DETAILS


SHEET NUMBER:


SP-2

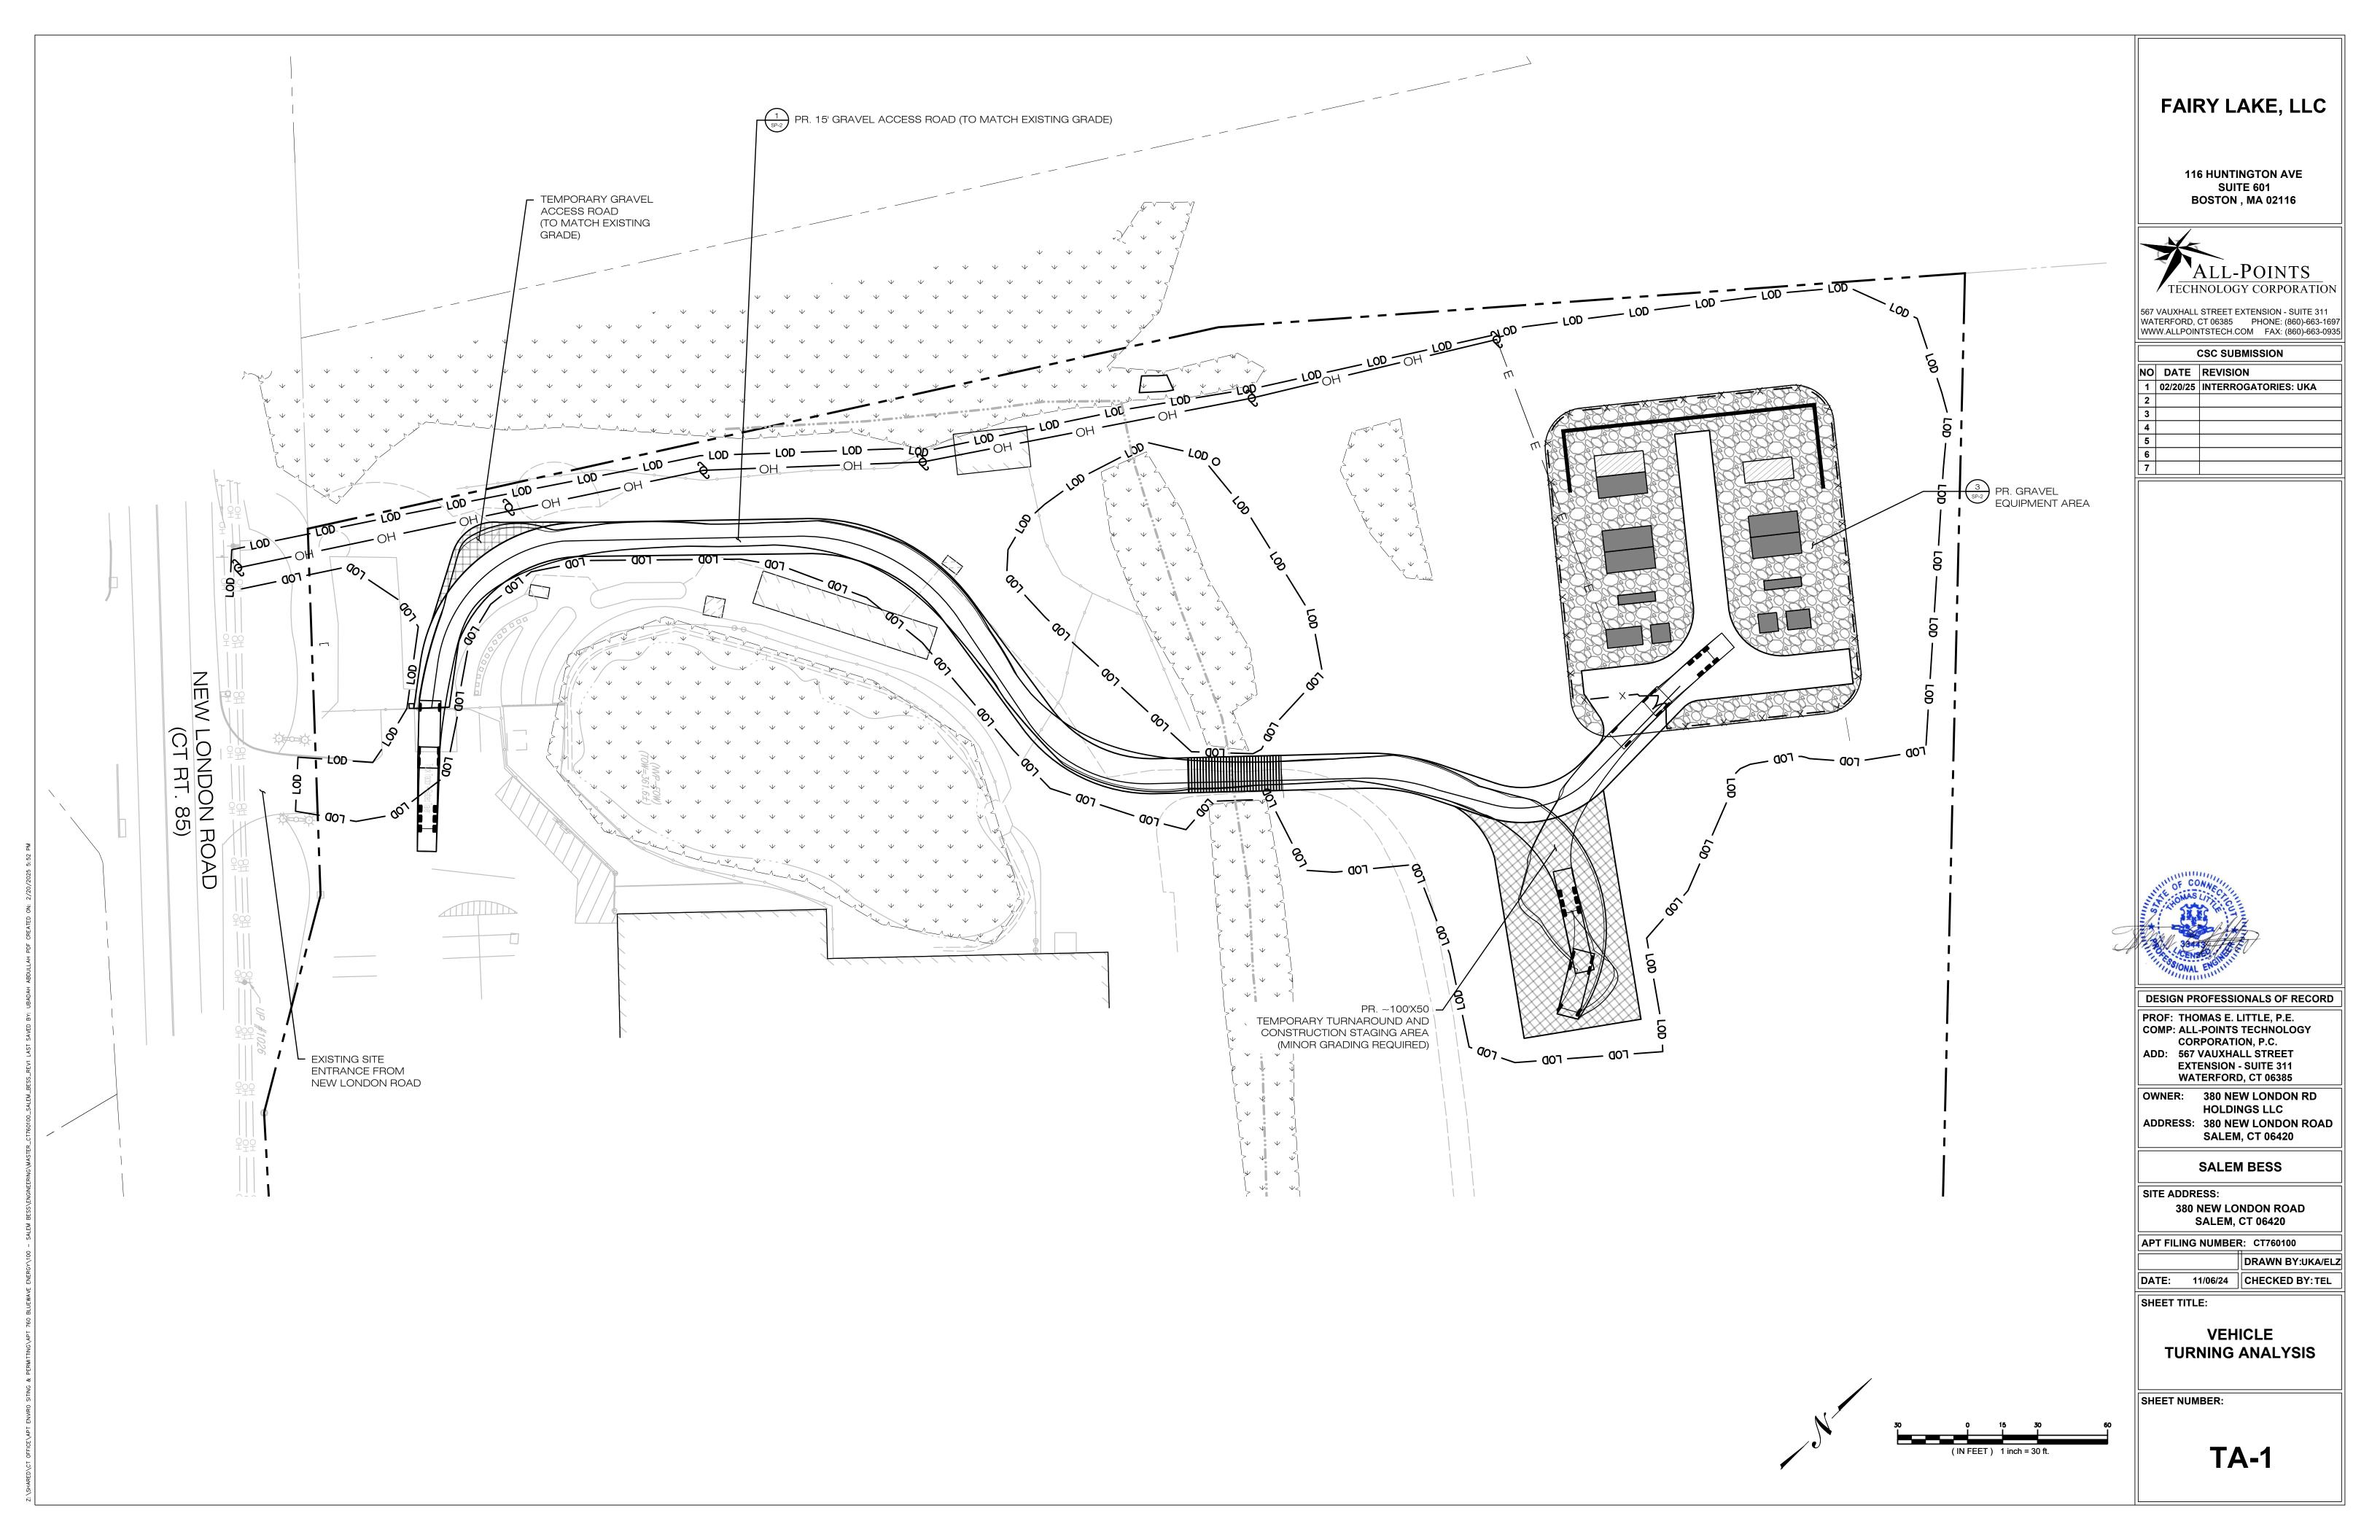

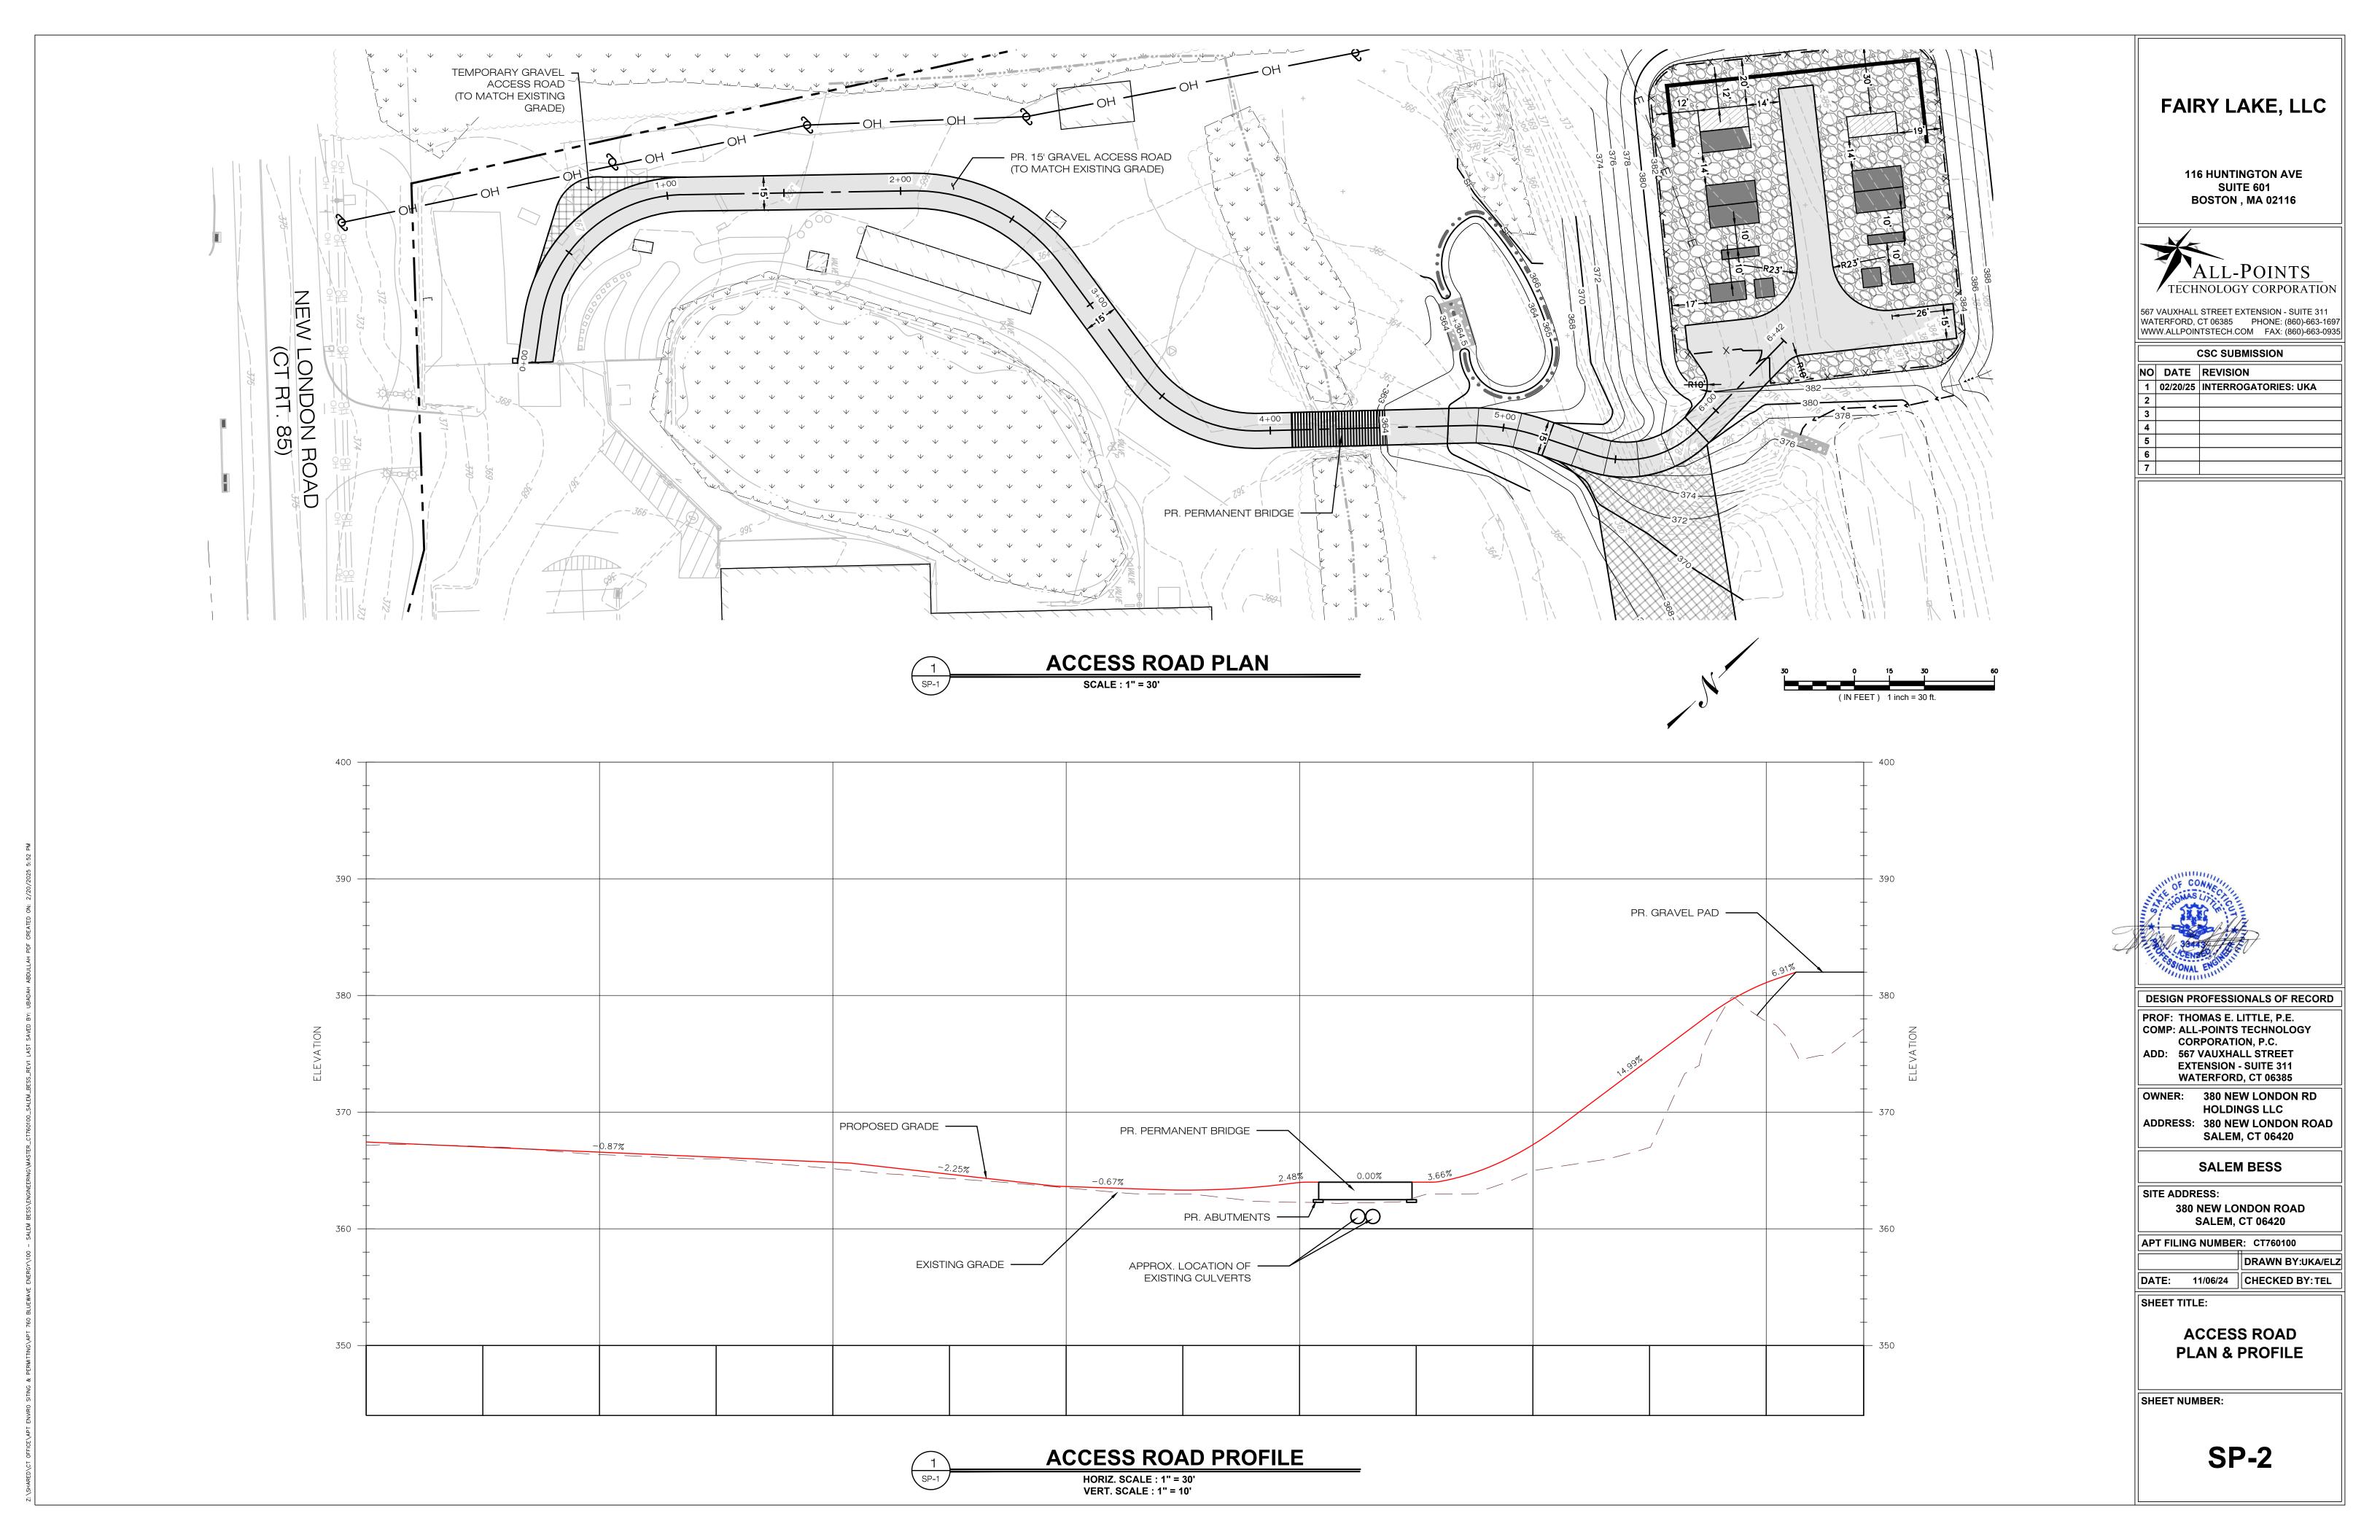

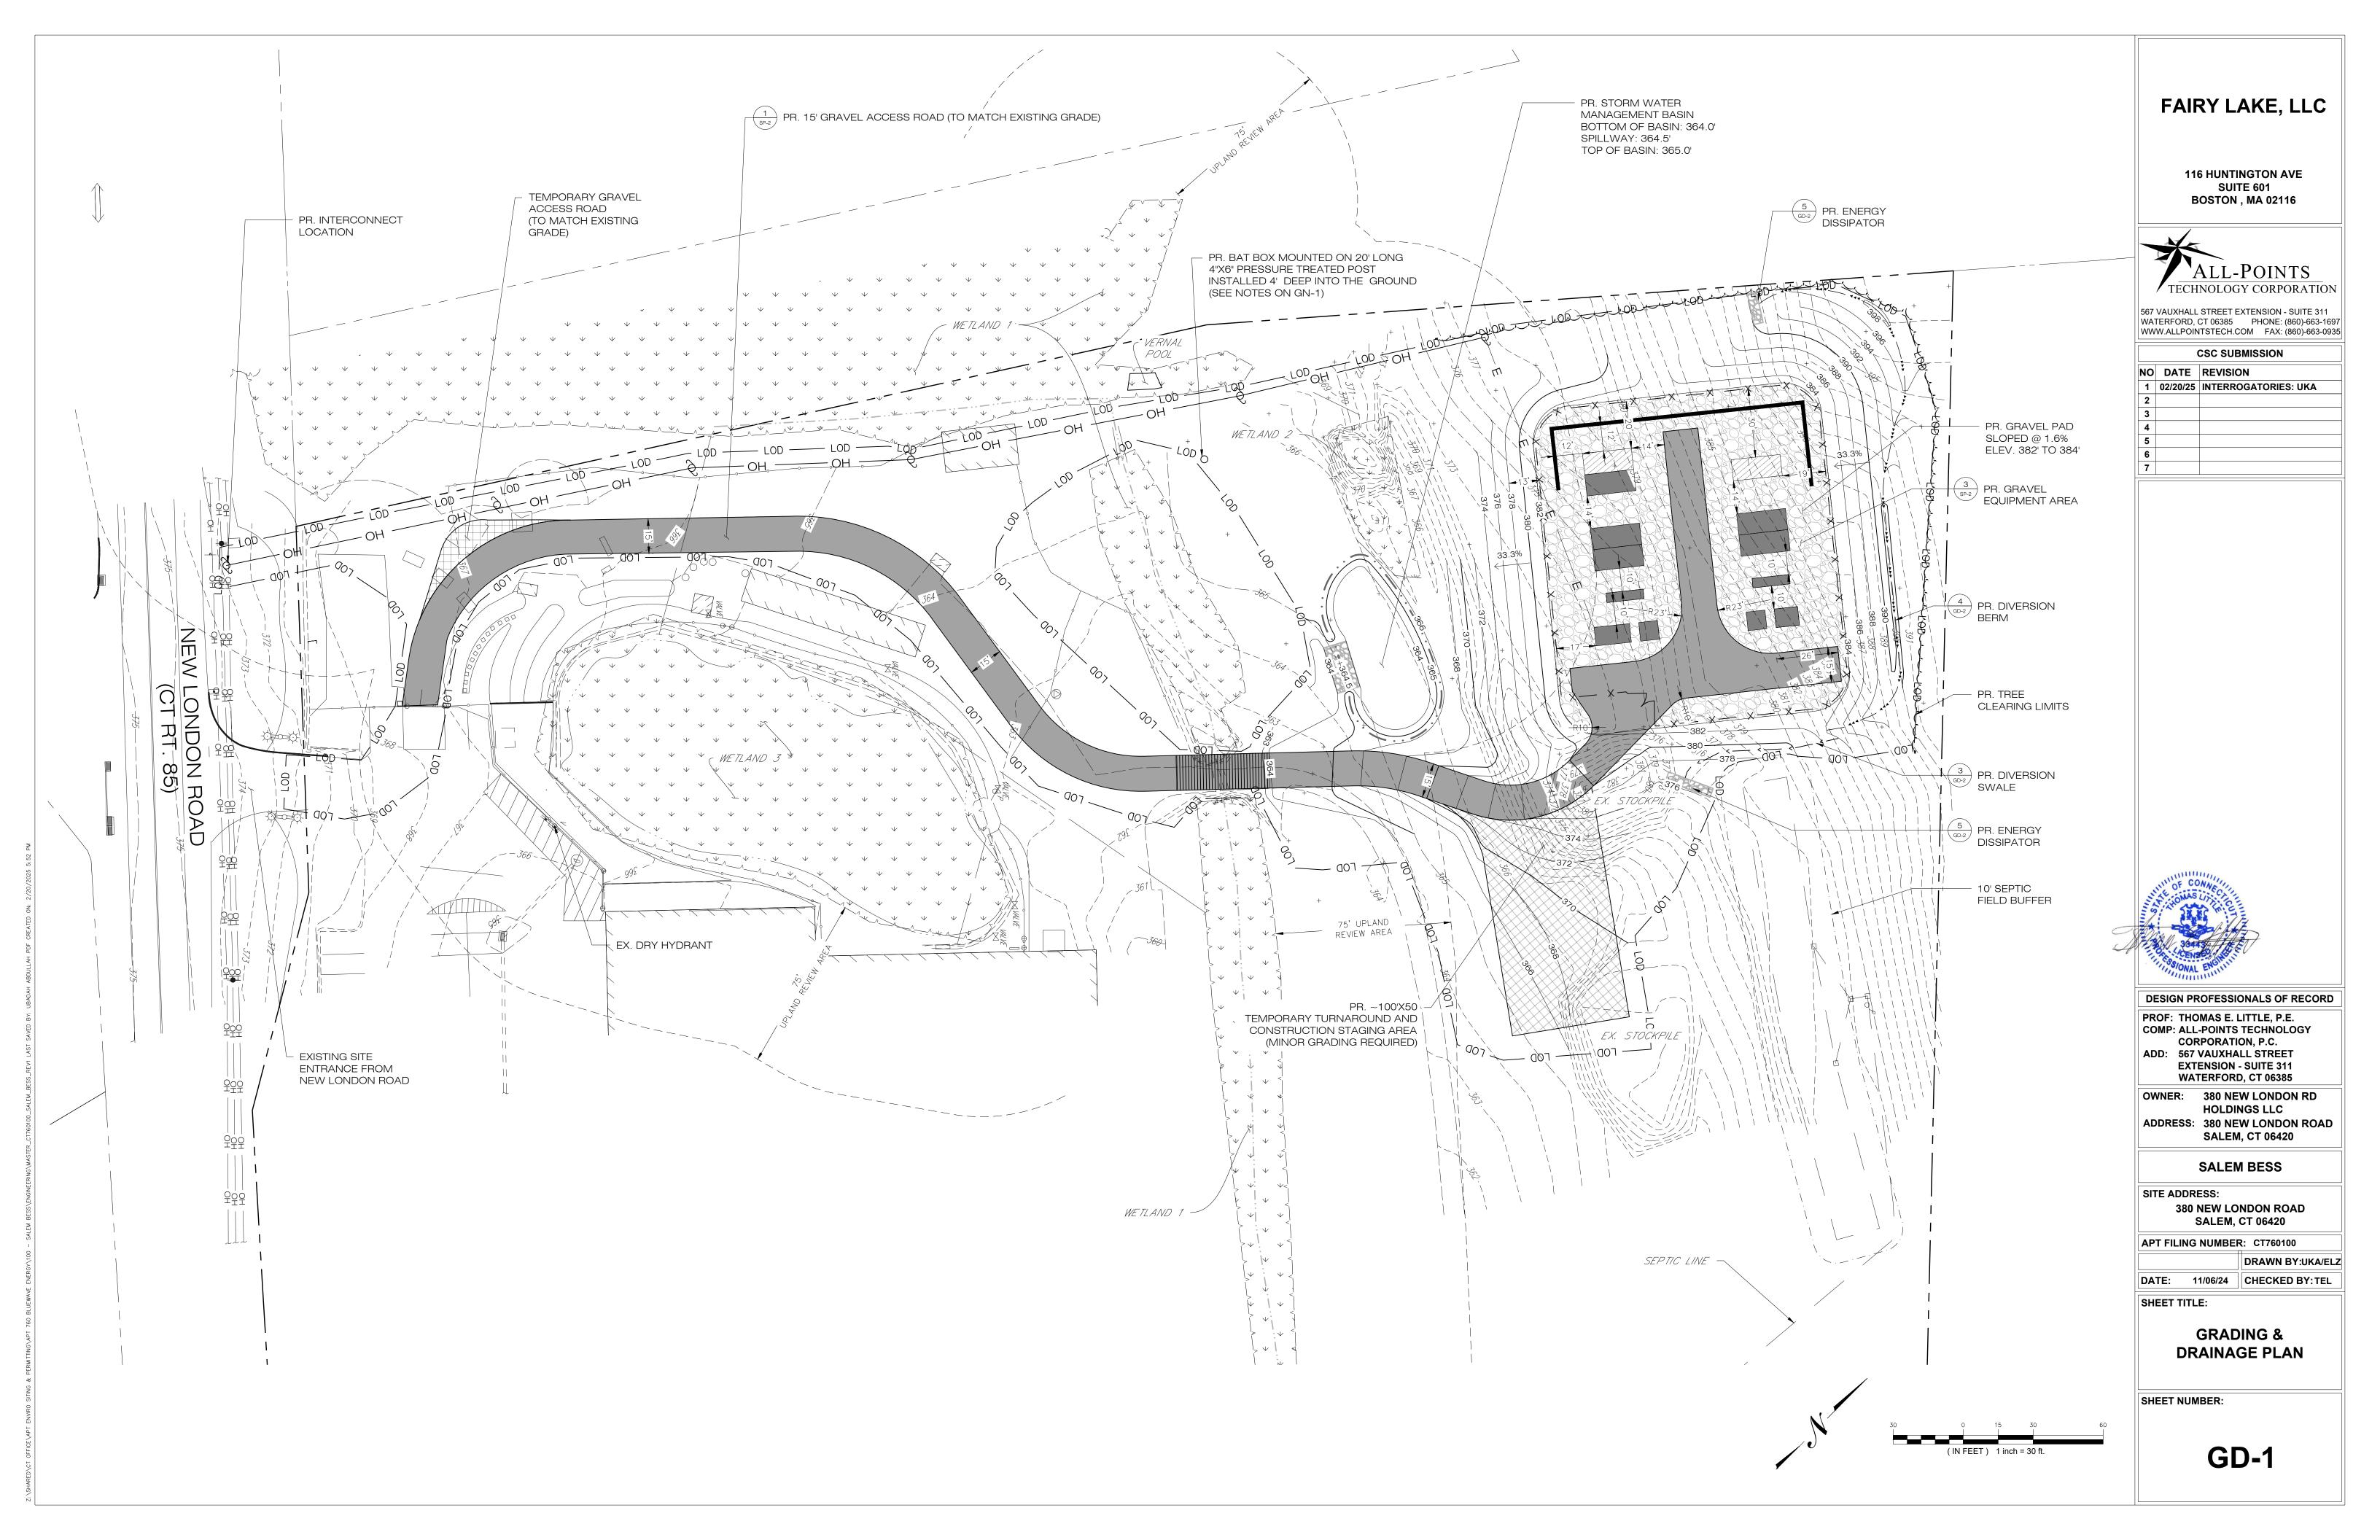

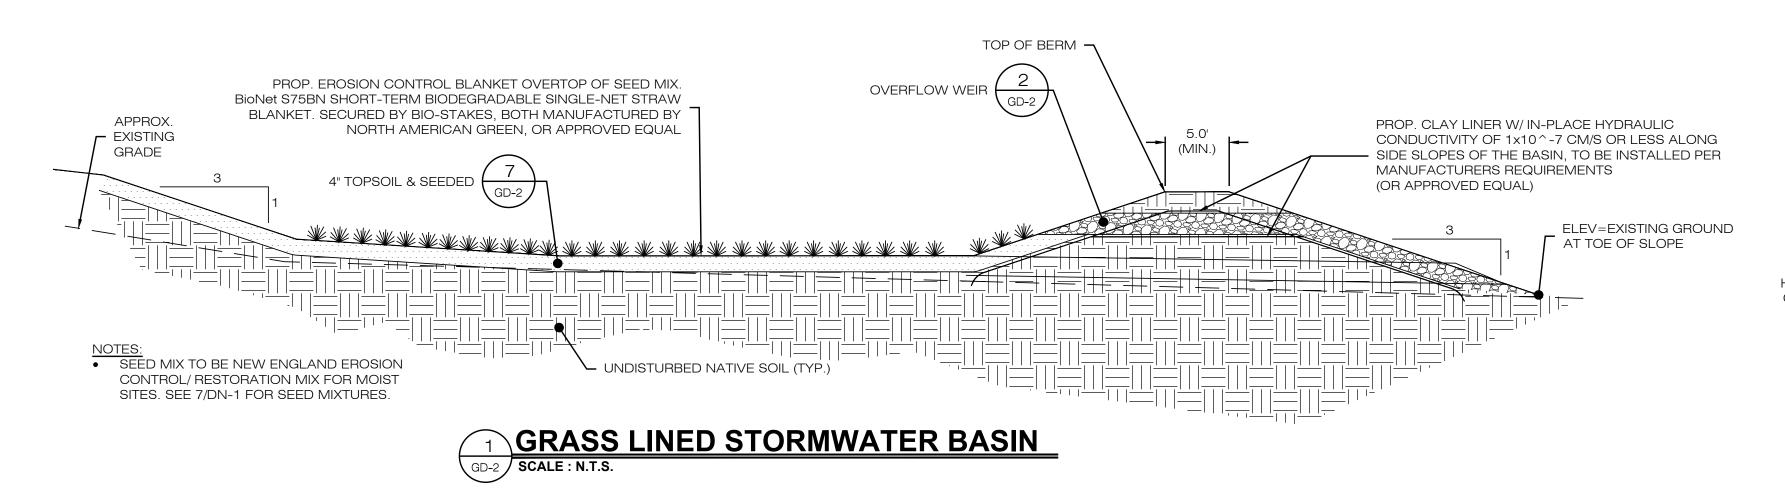


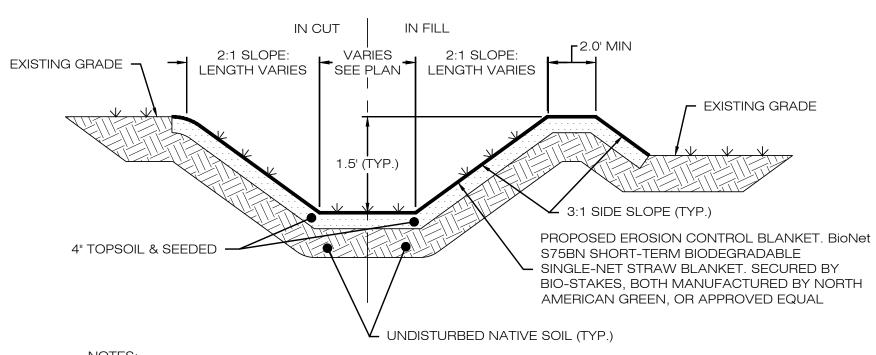

1. SEED MIX TO BE NEW ENGLAND EROSION CONTROL/ RESTORATION MIX FOR MOIST SITES ON THE BOTTOM OF THE BASIN AND NEW ENGLAND EROSION/RESTORATION MIX FOR DRY SITES ON THE SIDE

2. IF DEPTH VARIES FROM 2.0', SEE PLAN CALLOUTS.


GRASS LINED SWALE SCALE: N.T.S.

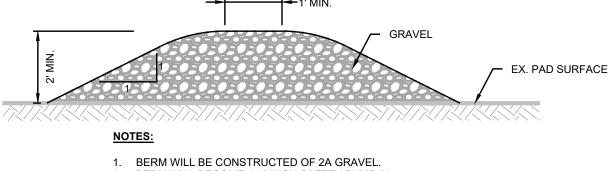

2. BERM WILL BECOME A 4" HIGH SAFTEY BUMP IN AREAS WHERE TRAFFIC MAY ENTER/EXIT.


TOP OF SLOPE BERM DETAIL

N.T.S.

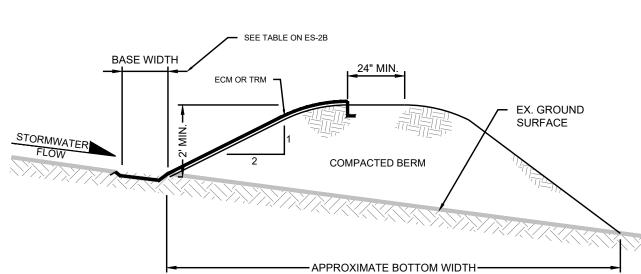

- 1. DIVERSION BERM WILL BE CONSTRUCTED OF COMPACTED SOIL AND STABILIZED WITH EROSION CONTROL MATTING OR TURF REINFORCEMENT MATTING.
- 2. A MINIMUM OF 4" OF TOPSOIL SHALL BE PLACED ON TOP OF COMPACTED


DIVERSION BERM DETAIL

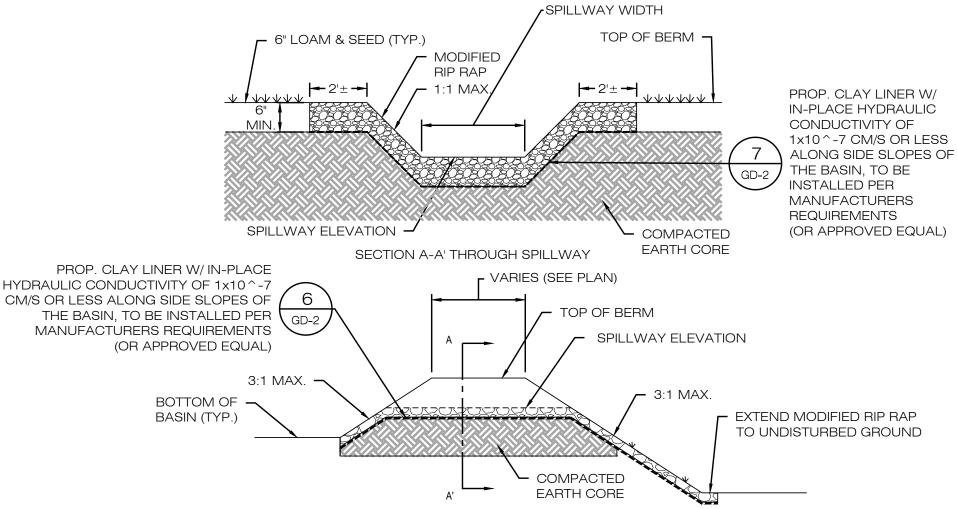

OVERFLOW WEIR DETAIL GD-2 SCALE: N.T.S.

6"-10" RIP RAP

LINED PLUNGE

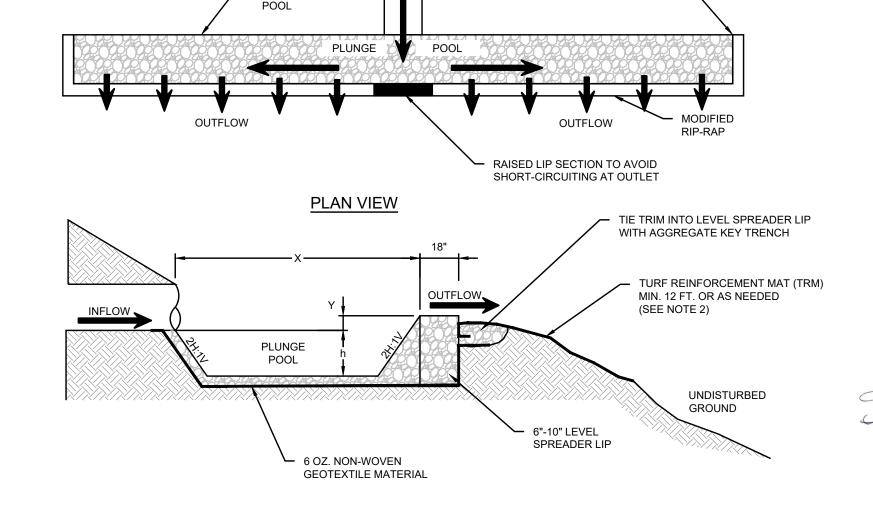

PROJECT LEVEL SPREADER -

EXISTING GRADE

LIP UPSLOPE AND TIE INTO

PROFILE VIEW

NOTES:

- 1. UNDERLYING SOILS TO REMAIN UNDISTURBED, COMPACTED AND PROTECTED FROM HEAVY EQUIPMENT TO PRESERVE INFILTRATION CAPACITY.
- 2. LEVEL SPREADER TO BE INSTALLED COMPLETELY LEVEL ALONG THE EXISTING CONTOUR WITH A SMOOTH TRANSITION BETWEEN THE LEVEL SPREADER AND THE EXISTING GRADE. THE IDEAL
- ELEVATION OF THE LEVEL SPREADER LIP IS 3 INCHES ABOVE THE EXISTING GRADE. 3. THE MINIMUM WIDTH OF 12' OF TURF REINFORCEMENT MAT (TRM) IS TO BE INSTALLED
- IMMEDIATELY DOWNSLOPE OF THE LEVEL SPREADER LIP. CONTRACTOR TO INSTALL ADDITIONAL TRM AS NECESSARY BASED ON EXISTING SITE CONDITIONS TO ADEQUATELY STABILIZE THE DOWNSLOPE AREA.

ENERGY DISSIPATOR -> PERMANENT LEVEL SPREADER GD-2 SCALE : N.T.S.

FAIRY LAKE, LLC

116 HUNTINGTON AVE SUITE 601 **BOSTON** , **MA** 02116



567 VAUXHALL STREET EXTENSION - SUITE 311 WATERFORD, CT 06385 PHONE: (860)-663-1697 WWW.ALLPOINTSTECH.COM FAX: (860)-663-0935

	CSC SUBMISSION		
NO	DATE	REVISION	
1	02/20/25	INTERROGATORIES: UKA	
2			
3			
4			
5			
6			
7			



DESIGN PROFESSIONALS OF RECORD

PROF: THOMAS E. LITTLE, P.E. COMP: ALL-POINTS TECHNOLOGY CORPORATION, P.C. ADD: 567 VAUXHALL STREET **EXTENSION - SUITE 311** WATERFORD, CT 06385

OWNER: 380 NEW LONDON RD HOLDINGS LLC ADDRESS: 380 NEW LONDON ROAD **SALEM, CT 06420**

SALEM BESS

SITE ADDRESS:

380 NEW LONDON ROAD **SALEM, CT 06420**

APT FILING NUMBER: CT760100

DRAWN BY:UKA/ELZ

DATE: 11/06/24 | CHECKED BY: TEL

SHEET TITLE:

GRADING & DRAINAGE DETAILS

SHEET NUMBER:

GD-2