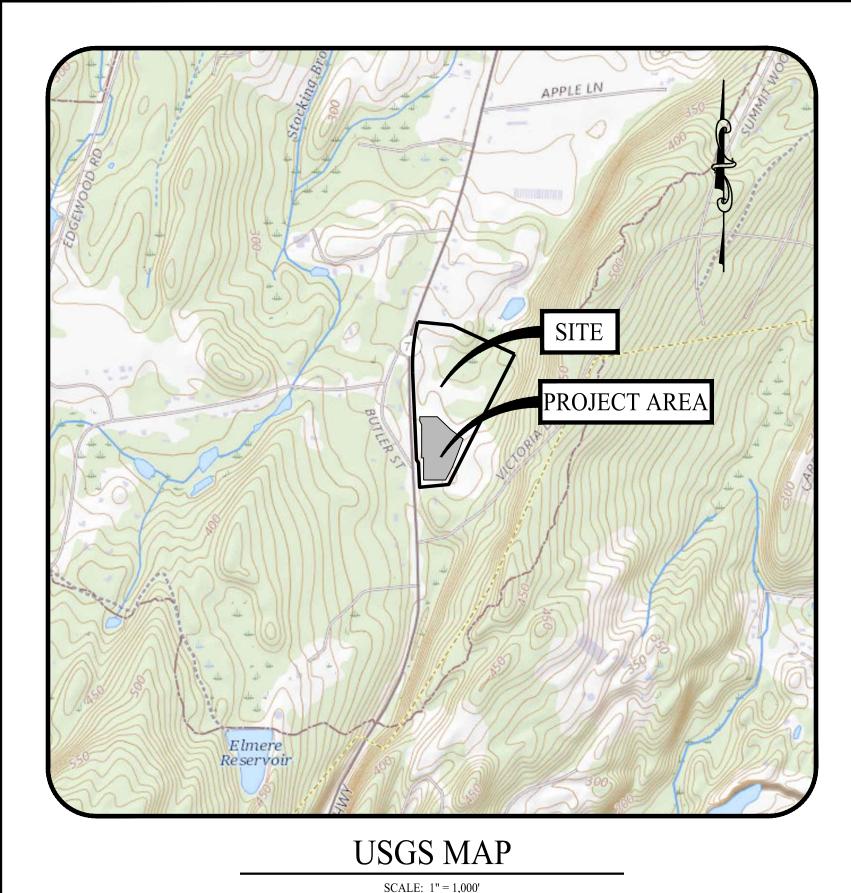
Appendix B: Site Plans





SHEET #	SHEET NAME	PLAN DATE	LATEST REVISION
0.00	COVER SHEET	09/30/23	N/A
EX-1	PROPERTY/TOPOGRAPHIC SURVEY	11/04/22	N/A
2.10	OVERALL SITE LAYOUT PLAN	09/30/23	N/A
2.11	SITE LAYOUT PLAN	09/30/23	N/A
2.21	GRADING & DRAINAGE PLAN	09/30/23	N/A
2.31	SOIL EROSION & SEDIMENT CONTROL PLAN - PHASE I	09/30/23	N/A
2.32	SOIL EROSION & SEDIMENT CONTROL PLAN - PHASE II	09/30/23	N/A
2.41	SOIL EROSION & SEDIMENT CONTROL NOTES & DETAILS	09/30/23	N/A
3.01	CONSTRUCTION DETAILS	09/30/23	N/A

PROPOSED SOLAR PHOTOVOLTAIC ARRAY

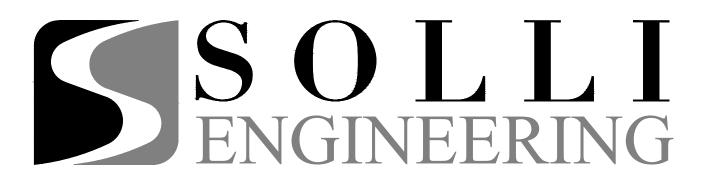
0 CHAMBERLAIN HIGHWAY BERLIN, CONNECTICUT

PREPARED FOR:

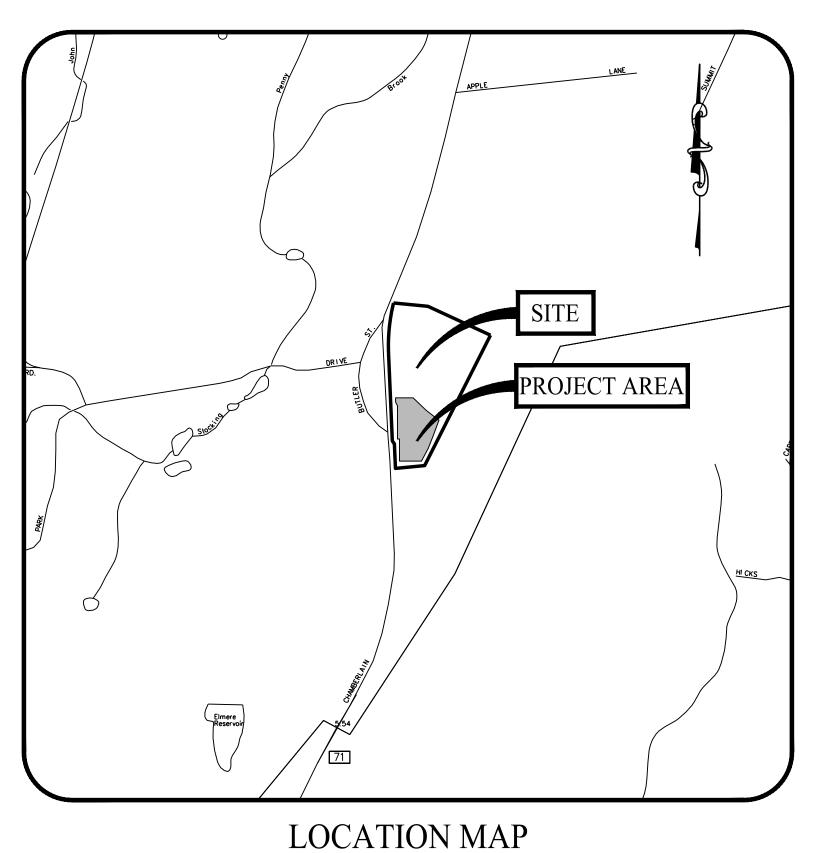


888 PROSPECT STREET, SUITE 200 LA JOLLA, CALIFORNIA

PREPARED BY:



501 MAIN STREET, MONROE, CONNECTICUT 06468 11 VANDERBILT AVENUE, NORWOOD, MASSACHUSETTS 02062



SCALE: 1" = 1,000'

OWNER

TRITEC AMERICAS, LLC 800 NORTH STATE STREET DOVER, DELAWARE 19901

APPLICANT

TRITEC AMERICAS, LLC 888 PROSPECT STREET, SUITE 200 LA JOLLA, CALIFORNIA 92307

PROPERTY INFORMATION

ADDRESS: 0 CHAMBERLAIN HIGHWAY, BERLIN, CONNECTICUT MAP-BLOCK-LOT: 30-2-74-40 AREA: ±26.82 AC BOOK/PAGE: 816/924

SOIL SCIENTIST

WILLIAM KENNY, CPWS, PLA, ASLA WILLIAM KENNY ASSOCIATES 195 TUNXIS HILL CUTOFF SOUTH FAIRFIELD, CT 06825 (203) 366-0588

ELECTRICAL ENGINEER

PURE POWER ENGINEERING, INC. 111 RIVER STREET, SUITE 1110 HOBOKEN, NJ 07030 (201) 687-9975

ENGINEER OF RECORD

KEVIN SOLLI, P.E., CPESC, LEED AP BD+C LICENSE NO. 25759 SOLLI ENGINEERING, LLC 501 MAIN STREET MONROE, CONNECTICUT 06468 (203) 880-5455

LANDSCAPE ARCHITECT

MARY BLACKBURN, P.L.A., LICENSE CT NO. 1499 SOLLI ENGINEERING, LLC 501 MAIN STREET MONROE, CONNECTICUT 06468 (203) 880-5455

SURVEYOR OF RECORD

PATRICK J CORLESS, JR., L.S. LICENSE NO. 70015 BL COMPANIES 355 RESEARCH PARKWAY MERIDEN, CONNECTICUT 06450 (203) 630-1406

Rev. #: Date

oject:

PROPOSED SOLAR PHOTOVOLTAIC ARRAY 0 CHAMBERLAIN HIGHWAY BERLIN, CONNECTICUT

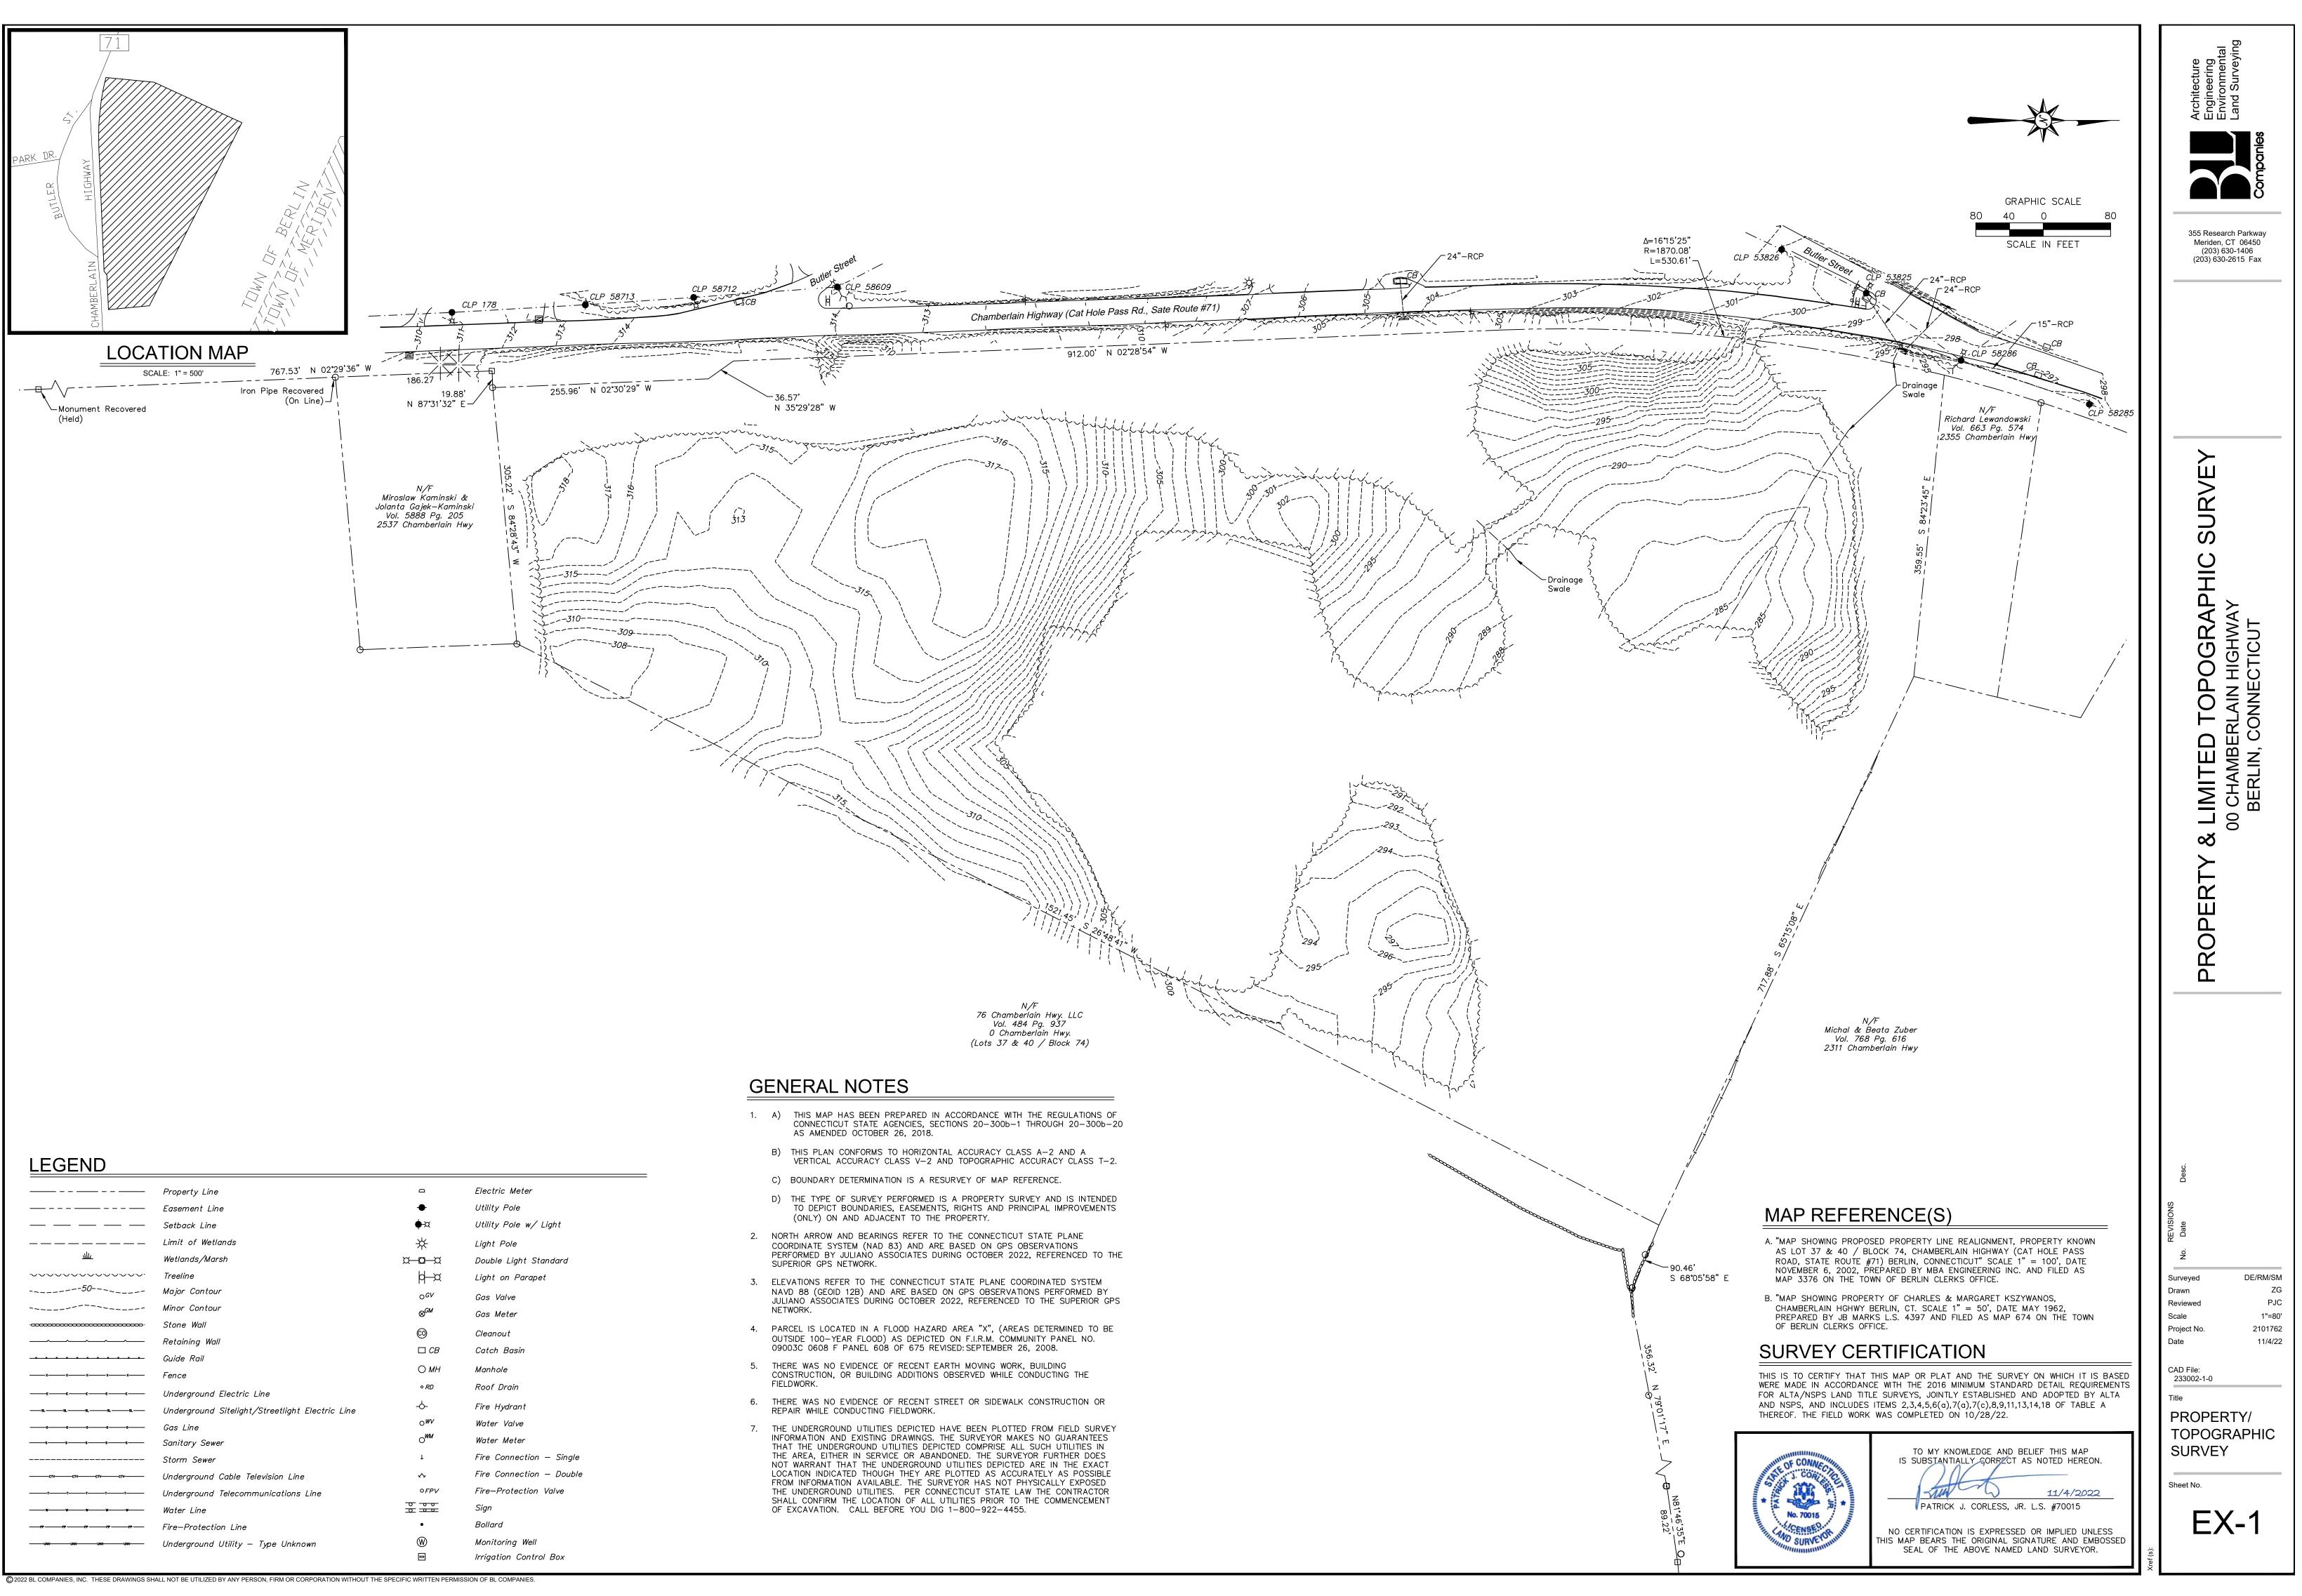
Description

Sheet Title:

Sheet #:

0.00

COVER SHEET



	Property Line	Ω	Electric Meter
·	Easement Line	•	Utility Pole
	Setback Line	∳-¤	Utility Pole w/ Light
	Limit of Wetlands	*	Light Pole
<u></u>	Wetlands/Marsh	x <u>a</u> x	Double Light Standard
	Treeline	d−פ	Light on Parapet
-50	Major Contour	0 GV	Gas Valve
	Minor Contour	⊖ ⊗ ^{GM}	Gas Meter
	Stone Wall	-	
	Retaining Wall	©	Cleanout
	Guide Rail		Catch Basin
xx	Fence	\bigcirc MH	Manhole
-EEE	Underground Electric Line	∘ RD	Roof Drain
SLSL	- Underground Sitelight/Streetlight Electric Line	-0-	Fire Hydrant
-ooo	Gas Line	OWV	Water Valve
-ss	Sanitary Sewer	OMM	Water Meter
	Storm Sewer	Ţ	Fire Connection — Single
стvстv	Underground Cable Television Line	~	Fire Connection — Double
ttt	Underground Telecommunications Line	0 <i>FPV</i>	Fire-Protection Valve
·₩₩₩	Water Line		Sign
ዋዋዋ	Fire-Protection Line	٠	Bollard
	Underground Utility — Type Unknown	\bigotimes	Monitoring Well
			Irrigation Control Box



Oct 09, 2023 — 12:14pm Anthony X:\SE Files\Project Data\2023\23100201 — 0 Chamberlain Highway — Berlin, CT\Cadd Data\23100201—2.10.dwg

LIMIT OF WETLANDS (TYP.) — 100' UPLAND WETLAND REVIEW AREA (TYP.) – LIMIT OF DISTURBANCE (TYP.) **—** . . **—** PROPOSED 7' HIGH CHAIN LINK FENCE (TYP.) — SOLAR SETBACK (TYP.) – EXISTING STORMWATER CATCHMENT AREA (SEE SHEET 2.21)



LEGEND

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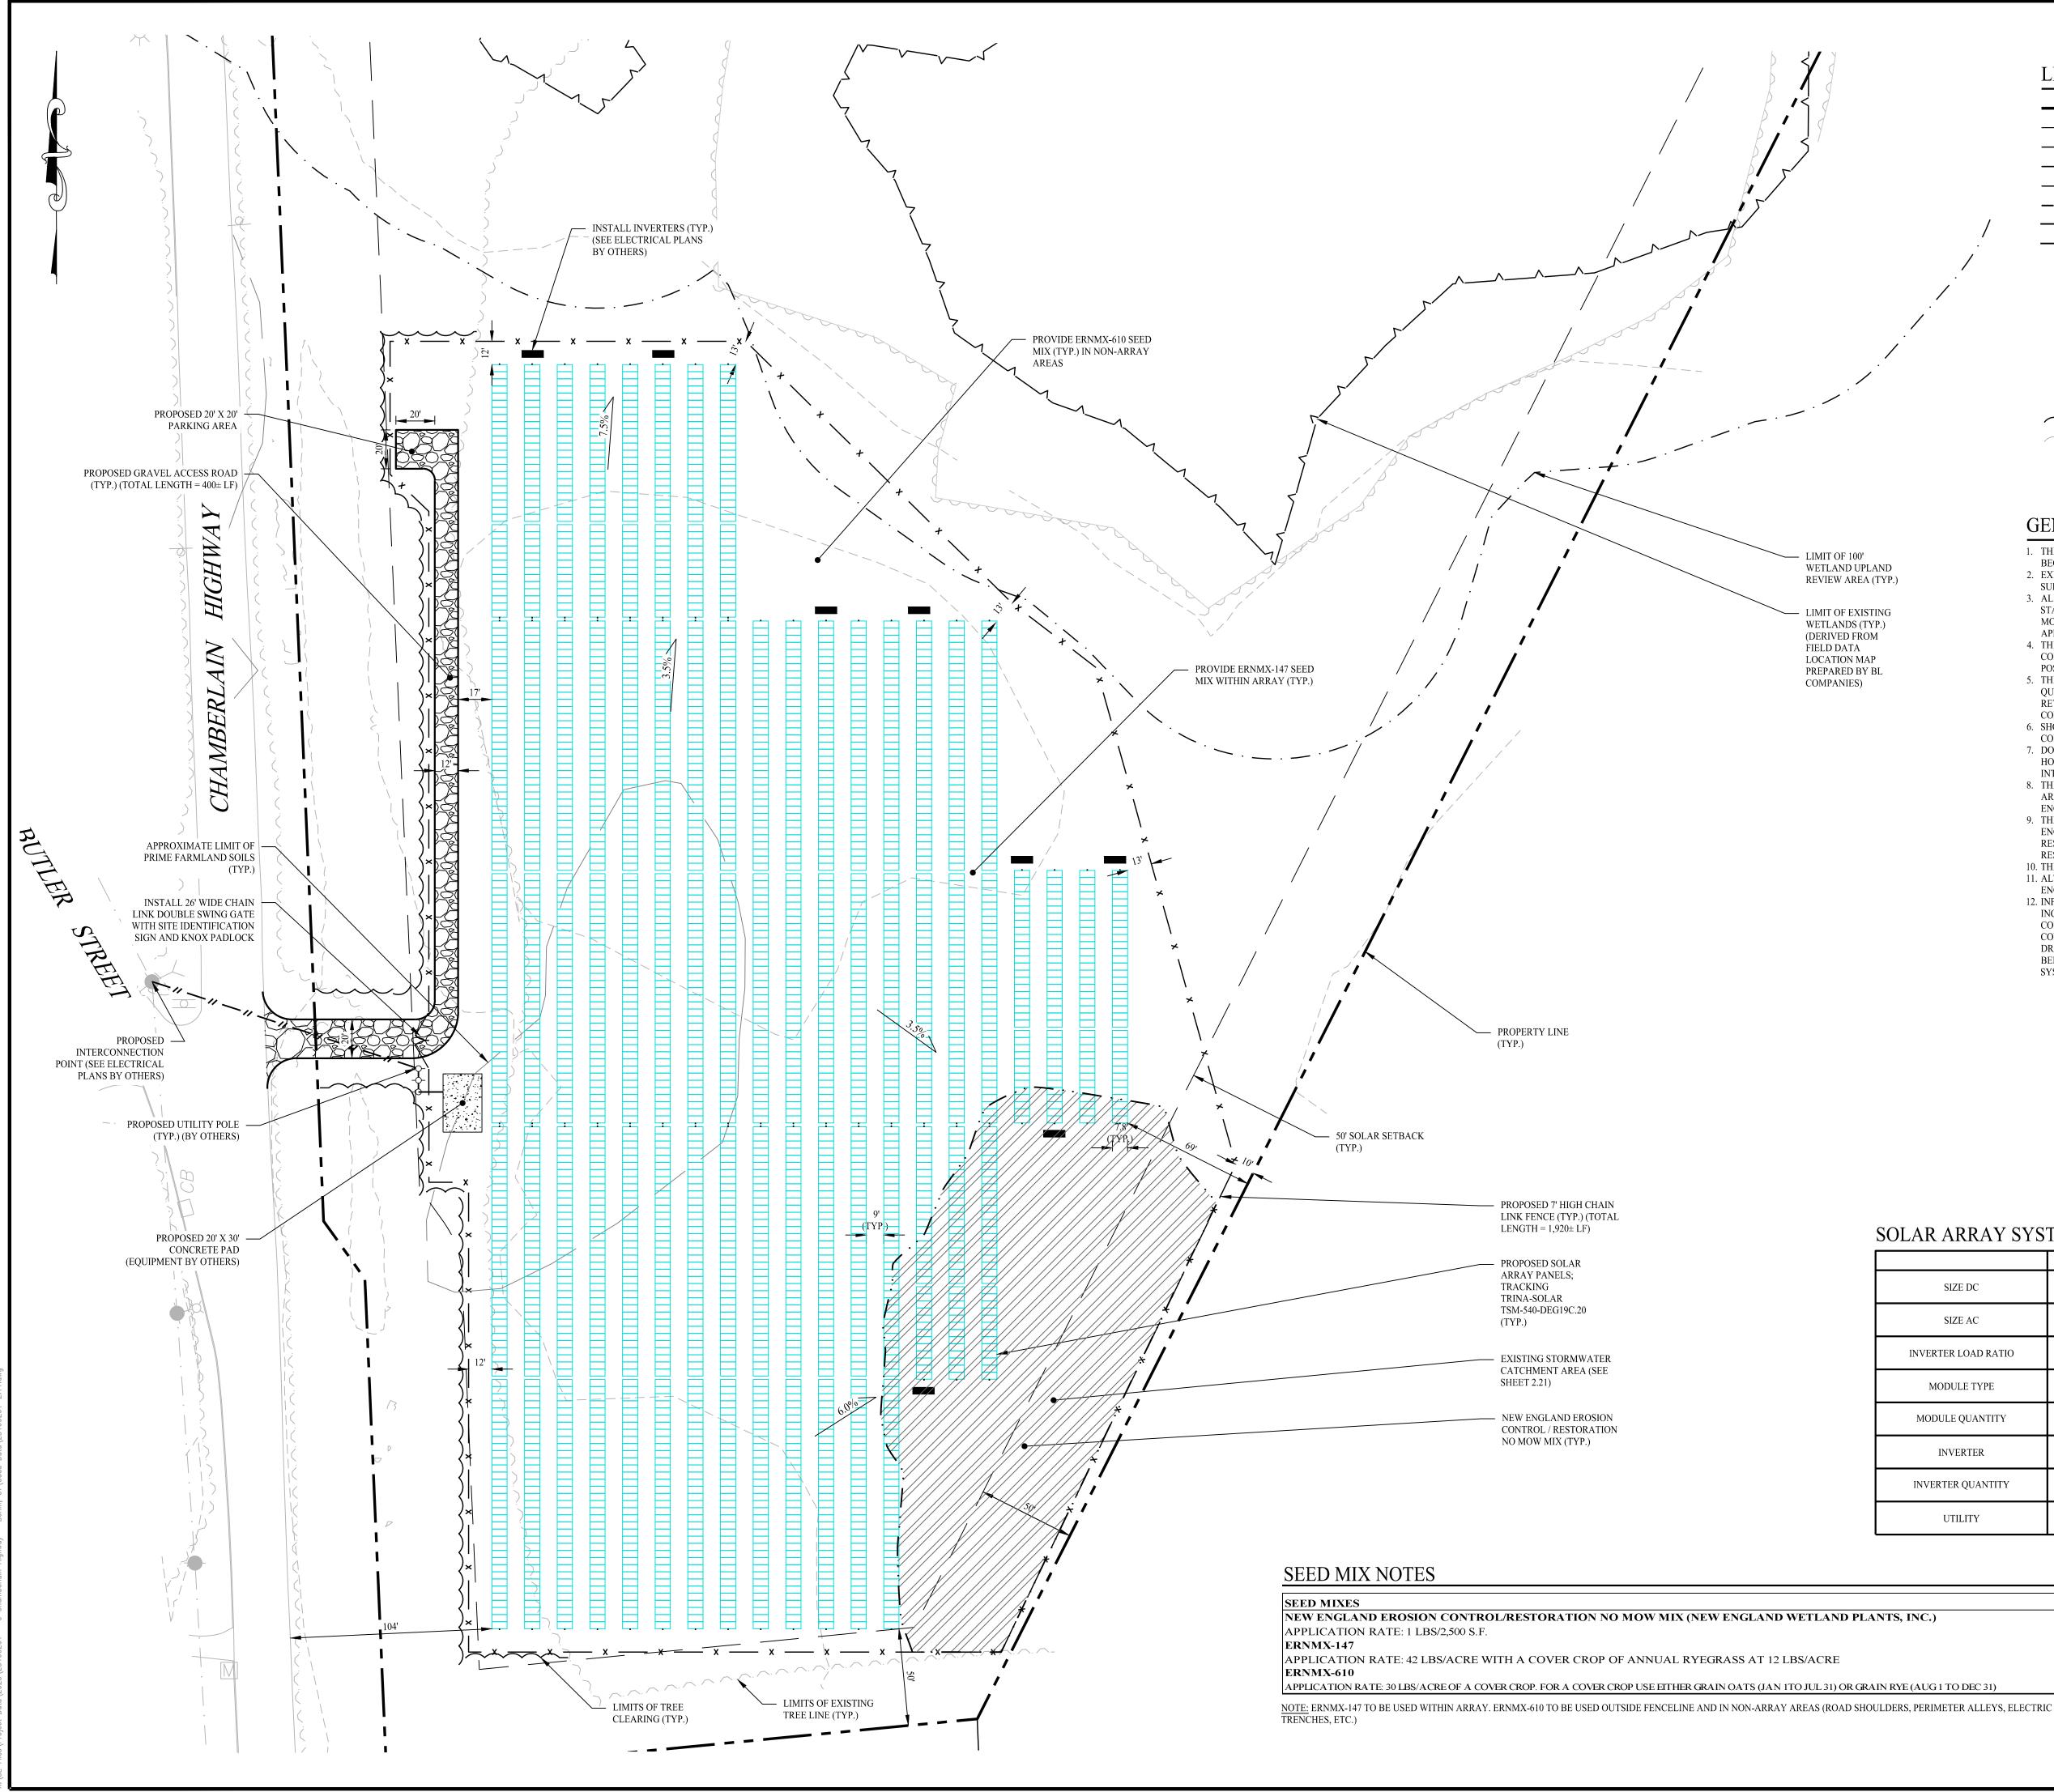
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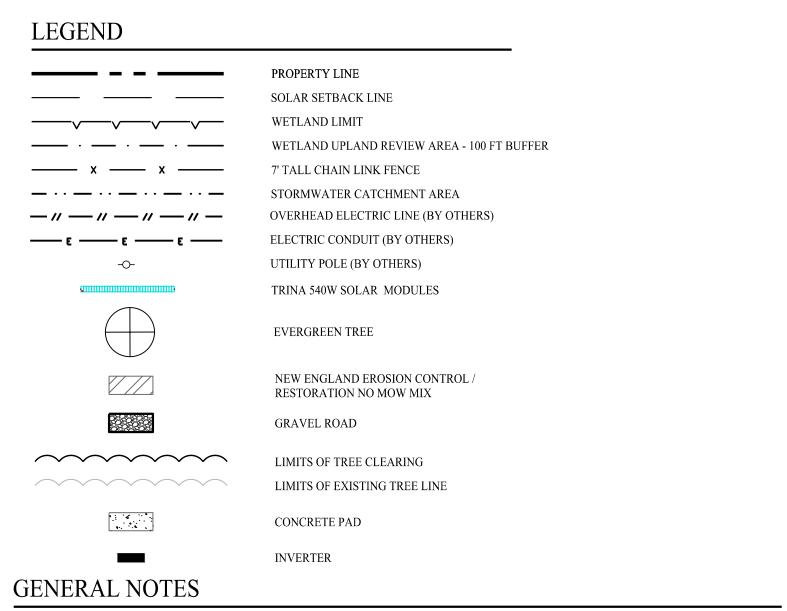
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PROPERTY LINE SOLAR SETBACK WETLAND LIMIT UPLAND REVIEW AREA - 100 FT BUFFER EDGE OF ACCESS DRIVE STORMWATER CATCHMENT AREA CHAIN LINK FENCE TRINA 540W SOLAR MODULES

LIMIT OF TREE CLEARING LIMIT OF DISTURBANCE OVERHEAD ELECTRIC LINE (BY OTHERS)

Rev. #: [	Date	Description
Graphic Scale:		
80	0	80 160
501 Main Street, N 11 Vanderbilt Ave	Aonroe, CT 06468 , Norwood, MA 0206	DILIF         F: (203) 880-5455           T: (203) 880-5455         F: (203) 880-9695           2         T: (781) 352-8491
Drawn By:	RHF	
Checked By:	CJB	MARKENN M. SOLO
Approved By:	KMS	
Project #:	23100201	25759 475 //CENST
Plan Date:	09/30/23	Mining OS/ONAL ENGINEER
Scale:	1" = 80'	Kevin Solli, P.E. CT 25759
Project:		-
PR	OPOSE	ED SOLAR
		TAIC ARRAY
		AIN HIGHWAY DNNECTICUT
Sheet Title:		Sheet #:
OVERA LAYOU		





- 1. THESE PLANS ARE FOR PERMITTING PURPOSES ONLY AND ARE NOT FOR CONSTRUCTION. NO CONSTRUCTION OR DEMOLITION SHALL BEGIN UNTIL FINAL APPROVAL OF THIS PLAN IS GRANTED.
- 2. EXISTING BOUNDARY, TOPOGRAPHY AND SITE CONDITIONS INFORMATION TAKEN FROM A PLAN ENTITLED "PROPERTY/TOPOGRAPHIC SURVEY" DATED 11/04/22, SCALE: 1"=80', BY BL COMPANIES. 3. ALL CONSTRUCTION SHALL COMPLY WITH TOWN OF MONTVILLE STANDARDS, CONNECTICUT DEPARTMENT OF TRANSPORTATION STANDARDS AND SPECIFICATIONS IN THE ABOVE REFERENCED INCREASING HIERARCHY. IF SPECIFICATIONS ARE IN CONFLICT, THE
- MORE STRINGENT SPECIFICATION SHALL APPLY. ALL CONSTRUCTION SHALL BE PERFORMED IN ACCORDANCE WITH ALL APPLICABLE OSHA, FEDERAL, STATE, AND LOCAL REGULATIONS. 4. THE OWNER IS RESPONSIBLE FOR OBTAINING ALL NECESSARY ZONING PERMITS REQUIRED BY GOVERNMENT AGENCIES PRIOR TO
- CONSTRUCTION. THE CONTRACTOR SHALL OBTAIN ALL COUNTY AND TOWN CONSTRUCTION PERMITS. THE CONTRACTOR SHALL POST ALL BONDS, PAY ALL FEES, PROVIDE PROOF OF INSURANCE, AND PROVIDE TRAFFIC CONTROL NECESSARY FOR THIS WORK. 5. THE CONTRACTOR SHALL VERIFY ALL SITE CONDITIONS IN THE FIELD AND CONTACT THE ENGINEER OF RECORD IF THERE ARE ANY QUESTIONS OR CONFLICTS REGARDING THE CONSTRUCTION DOCUMENTS AND/OR FIELD CONDITIONS SO THAT APPROPRIATE
- REVISIONS CAN BE MADE PRIOR TO BIDDING. ANY CONFLICT BETWEEN THE DRAWINGS SHALL BE CONFIRMED WITH THE OWNER'S CONSTRUCTION MANAGER PRIOR TO BIDDING. 6. SHOULD ANY UNCHARTED OR INCORRECTLY CHARTED, EXISTING PIPING, OR OTHER UTILITY BE UNCOVERED DURING EXCAVATION, CONSULT THE ENGINEER OF RECORD IMMEDIATELY FOR DIRECTIONS BEFORE PROCEEDING FURTHER WITH WORK IN THIS AREA.
- 7. DO NOT INTERRUPT EXISTING UTILITIES SERVICING FACILITIES OCCUPIED AND USED BY THE OWNER OR OTHERS DURING OCCUPIED HOURS EXCEPT WHEN SUCH INTERRUPTIONS HAVE BEEN AUTHORIZED IN WRITING BY THE OWNER AND THE LOCAL MUNICIPALITIES. INTERRUPTIONS SHALL ONLY OCCUR AFTER ACCEPTABLE TEMPORARY SERVICE HAS BEEN PROVIDED.
- 8. THE CONTRACTOR SHALL RESTORE ANY DRAINAGE STRUCTURE, PIPE, UTILITY, PAVEMENT, CURBS, SIDEWALKS, LANDSCAPED AREAS, OR SIGNAGE DISTURBED DURING CONSTRUCTION TO THEIR ORIGINAL CONDITION OR BETTER, AS APPROVED BY THE ENGINEER OF RECORD.
- 9. THE ENGINEER OF RECORD IS NOT RESPONSIBLE FOR SITE SAFETY MEASURES TO BE EMPLOYED DURING CONSTRUCTION. THE ENGINEER OF RECORD HAS NO CONTRACTUAL DUTY TO CONTROL THE SAFEST METHODS OR MEANS OF THE WORK, JOB SITE RESPONSIBILITIES. SUPERVISION OR TO SUPERVISE SAFETY AND DOES NOT VOLUNTARILY ASSUME ANY SUCH DUTY OR RESPONSIBILITY.
- 10. THE CONTRACTOR SHALL COMPLY WITH CFR 29 PART 1926 FOR EXCAVATION TRENCHING AND TRENCH PROTECTION REQUIREMENTS. 11. ALTERNATIVE METHODS AND PRODUCTS OTHER THAN THOSE SPECIFIED MAY BE USED IF REVIEWED AND APPROVED BY THE ENGINEER OF RECORD AND APPROPRIATE REGULATORY AGENCY PRIOR TO INSTALLATION DURING THE BIDDING PROCESS.
- 12. INFORMATION ON EXISTING UTILITIES AND STORM DRAINAGE SYSTEMS HAS BEEN COMPILED FROM AVAILABLE INFORMATION INCLUDING UTILITY PROVIDER, MUNICIPAL RECORD MAPS, AND/OR FIELD SURVEY AND IS NOT GUARANTEED CORRECT OR COMPLETE. UTILITIES AND STORM DRAINAGE SYSTEMS ARE SHOWN TO ALERT THE CONTRACTOR TO THEIR PRESENCE AND THE CONTRACTOR IS SOLELY RESPONSIBLE FOR DETERMINING ACTUAL LOCATIONS AND ELEVATIONS OF ALL UTILITIES AND STORM DRAINAGE SYSTEMS INCLUDING SERVICES. PRIOR TO DEMOLITION OR CONSTRUCTION, THE CONTRACTOR SHALL CONTACT "CALL BEFORE YOU DIG" 72 HOURS BEFORE COMMENCEMENT OF WORK AT "(800) 922-4455" AND VERIFY ALL UTILITY AND STORM DRAINAGE SYSTEM LOCATIONS.

Description Rev. #: Date

raphic Scale



Drawn By:	RHF
Checked By:	CJB
Approved By:	KMS
Project #:	23100201
Plan Date:	09/30/23
Scale:	1" = 40'
Destant	

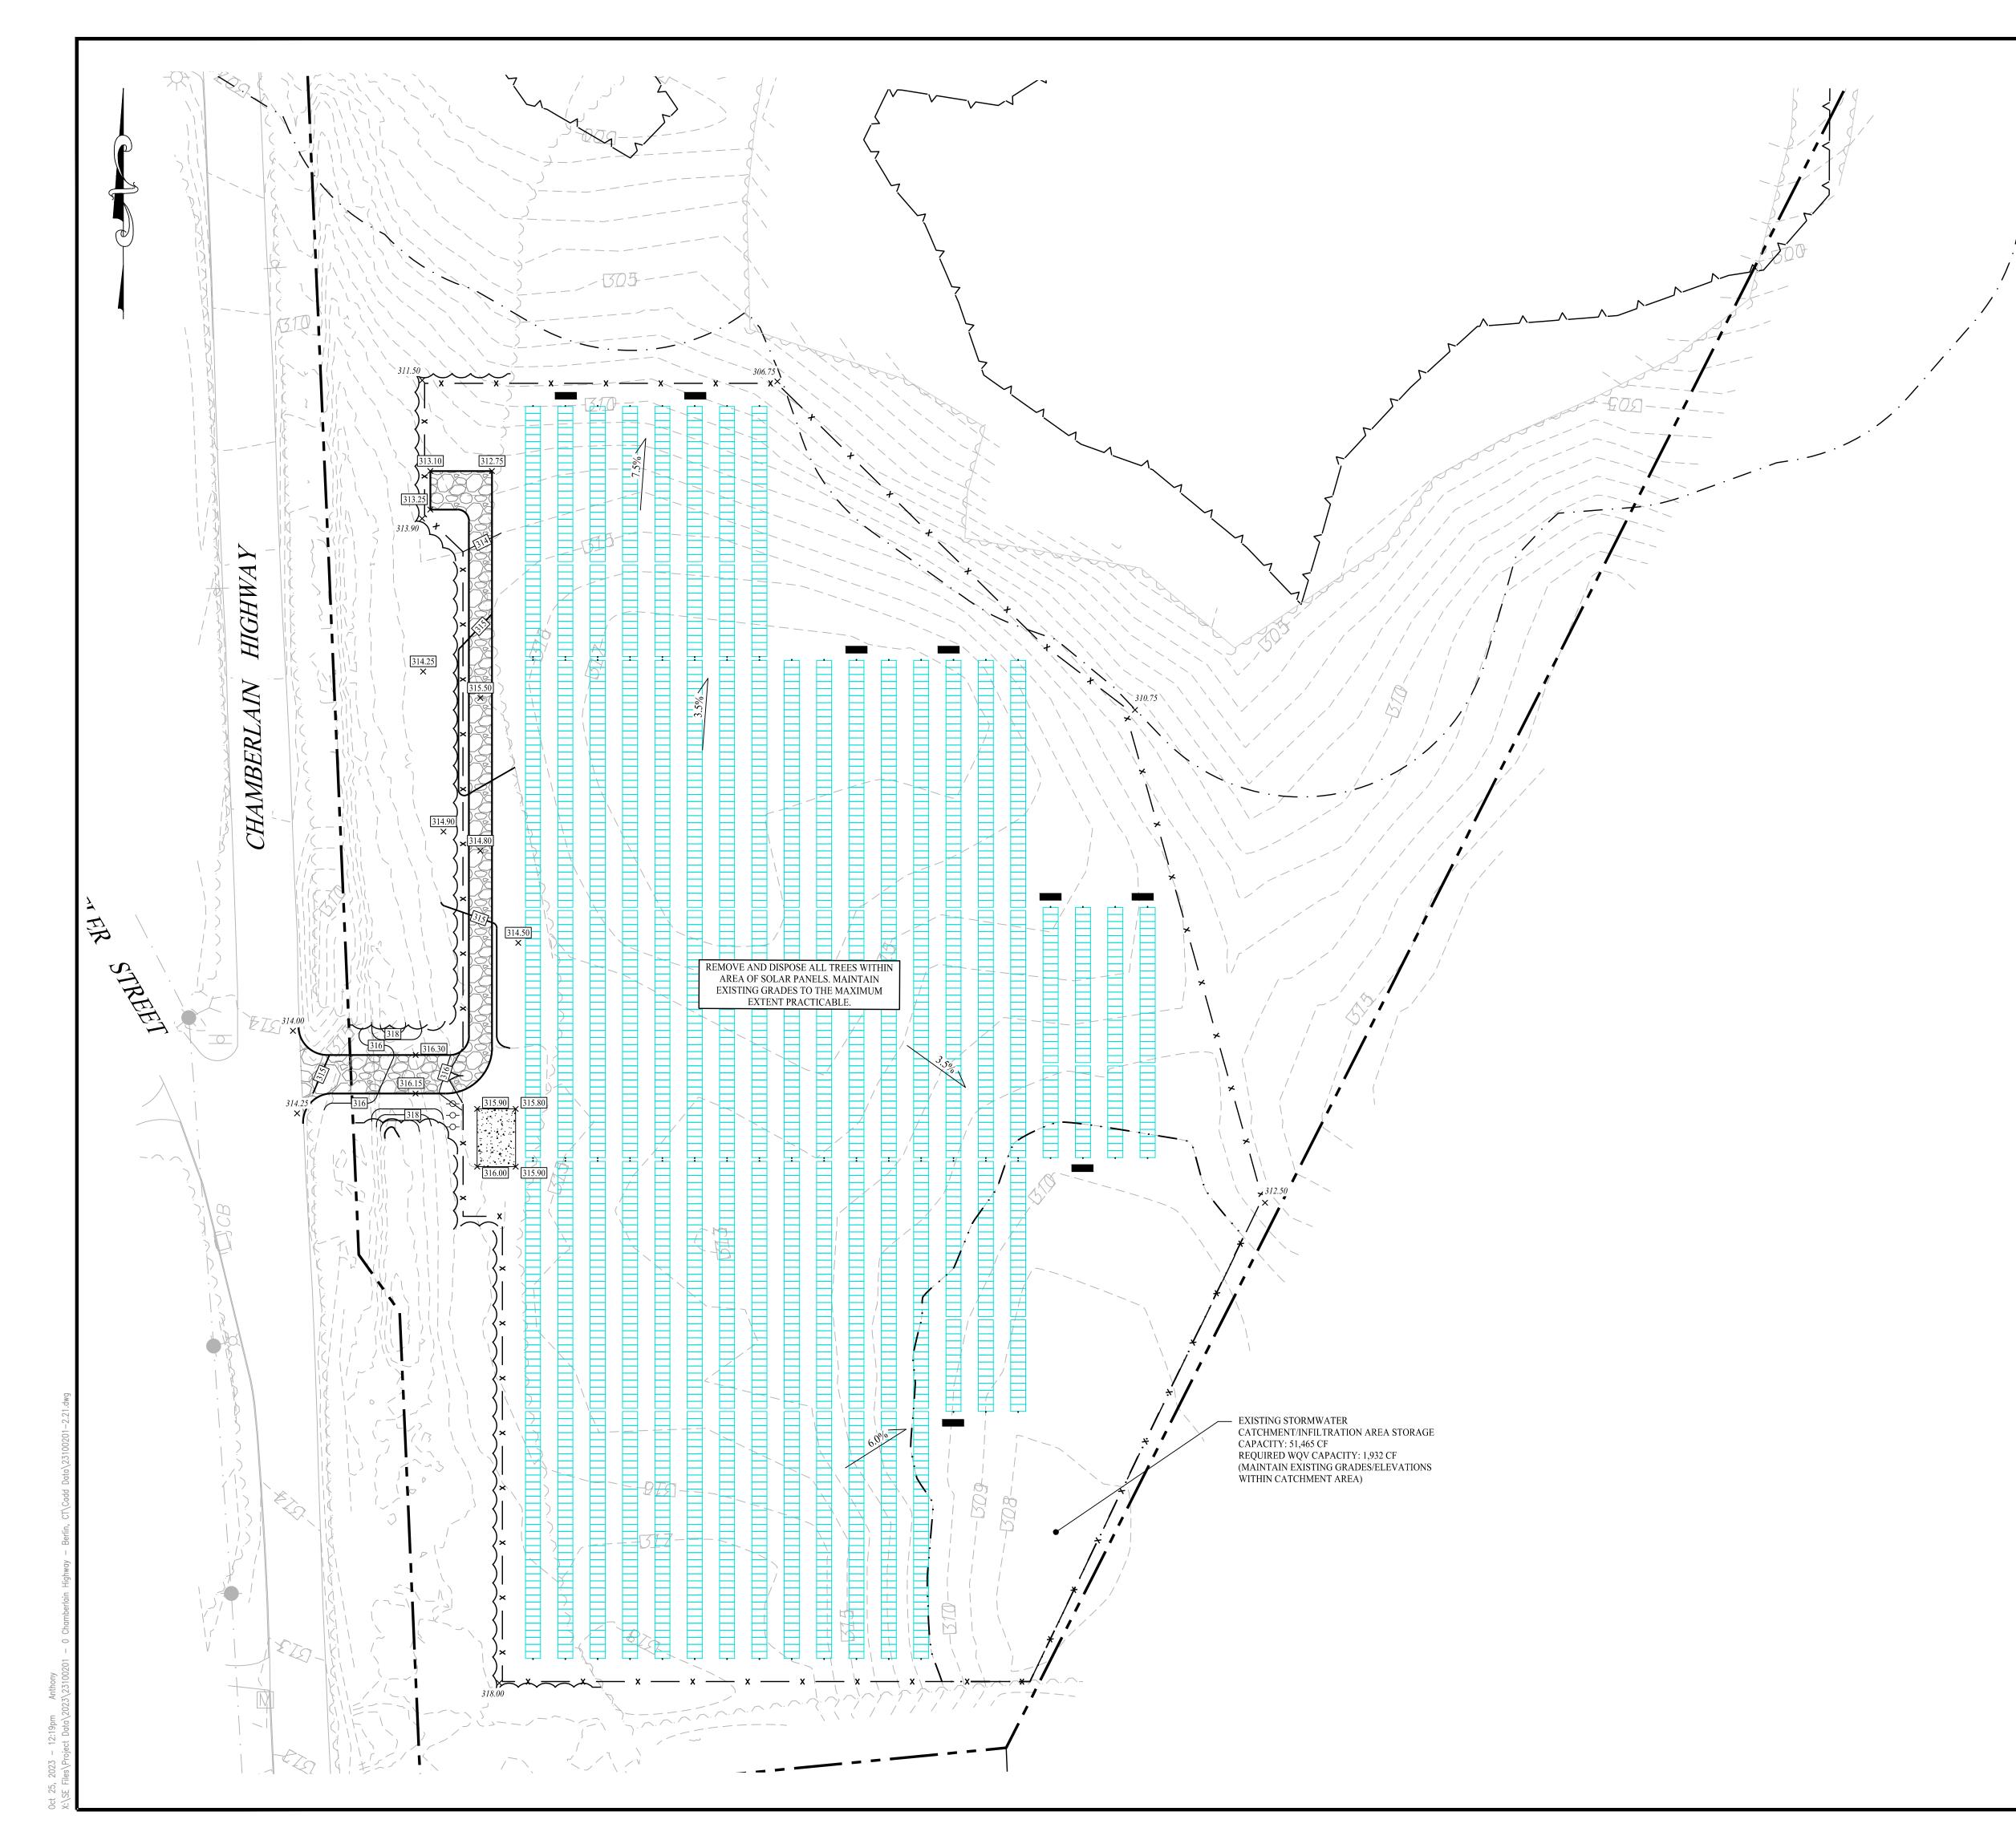


## PROPOSED SOLAR PHOTOVOLTAIC ARRAY 0 CHAMBERLAIN HIGHWAY BERLIN, CONNECTICUT heet Title: Sheet #: 2.11

#### SOLAR ARRAY SYSTEM INFORMATION

	TOTAL
SIZE DC	1.399 MW
SIZE AC	0.999 MW
INVERTER LOAD RATIO	1.40
MODULE TYPE	TRACKING TRINASOLAR TSM-540-DEG19C.20 (540W)
MODULE QUANTITY	2,590
INVERTER	SUNGROW SG125HV 125KW
INVERTER QUANTITY	8
UTILITY	EVERSOURCE

SITE LAYOUT PLAN



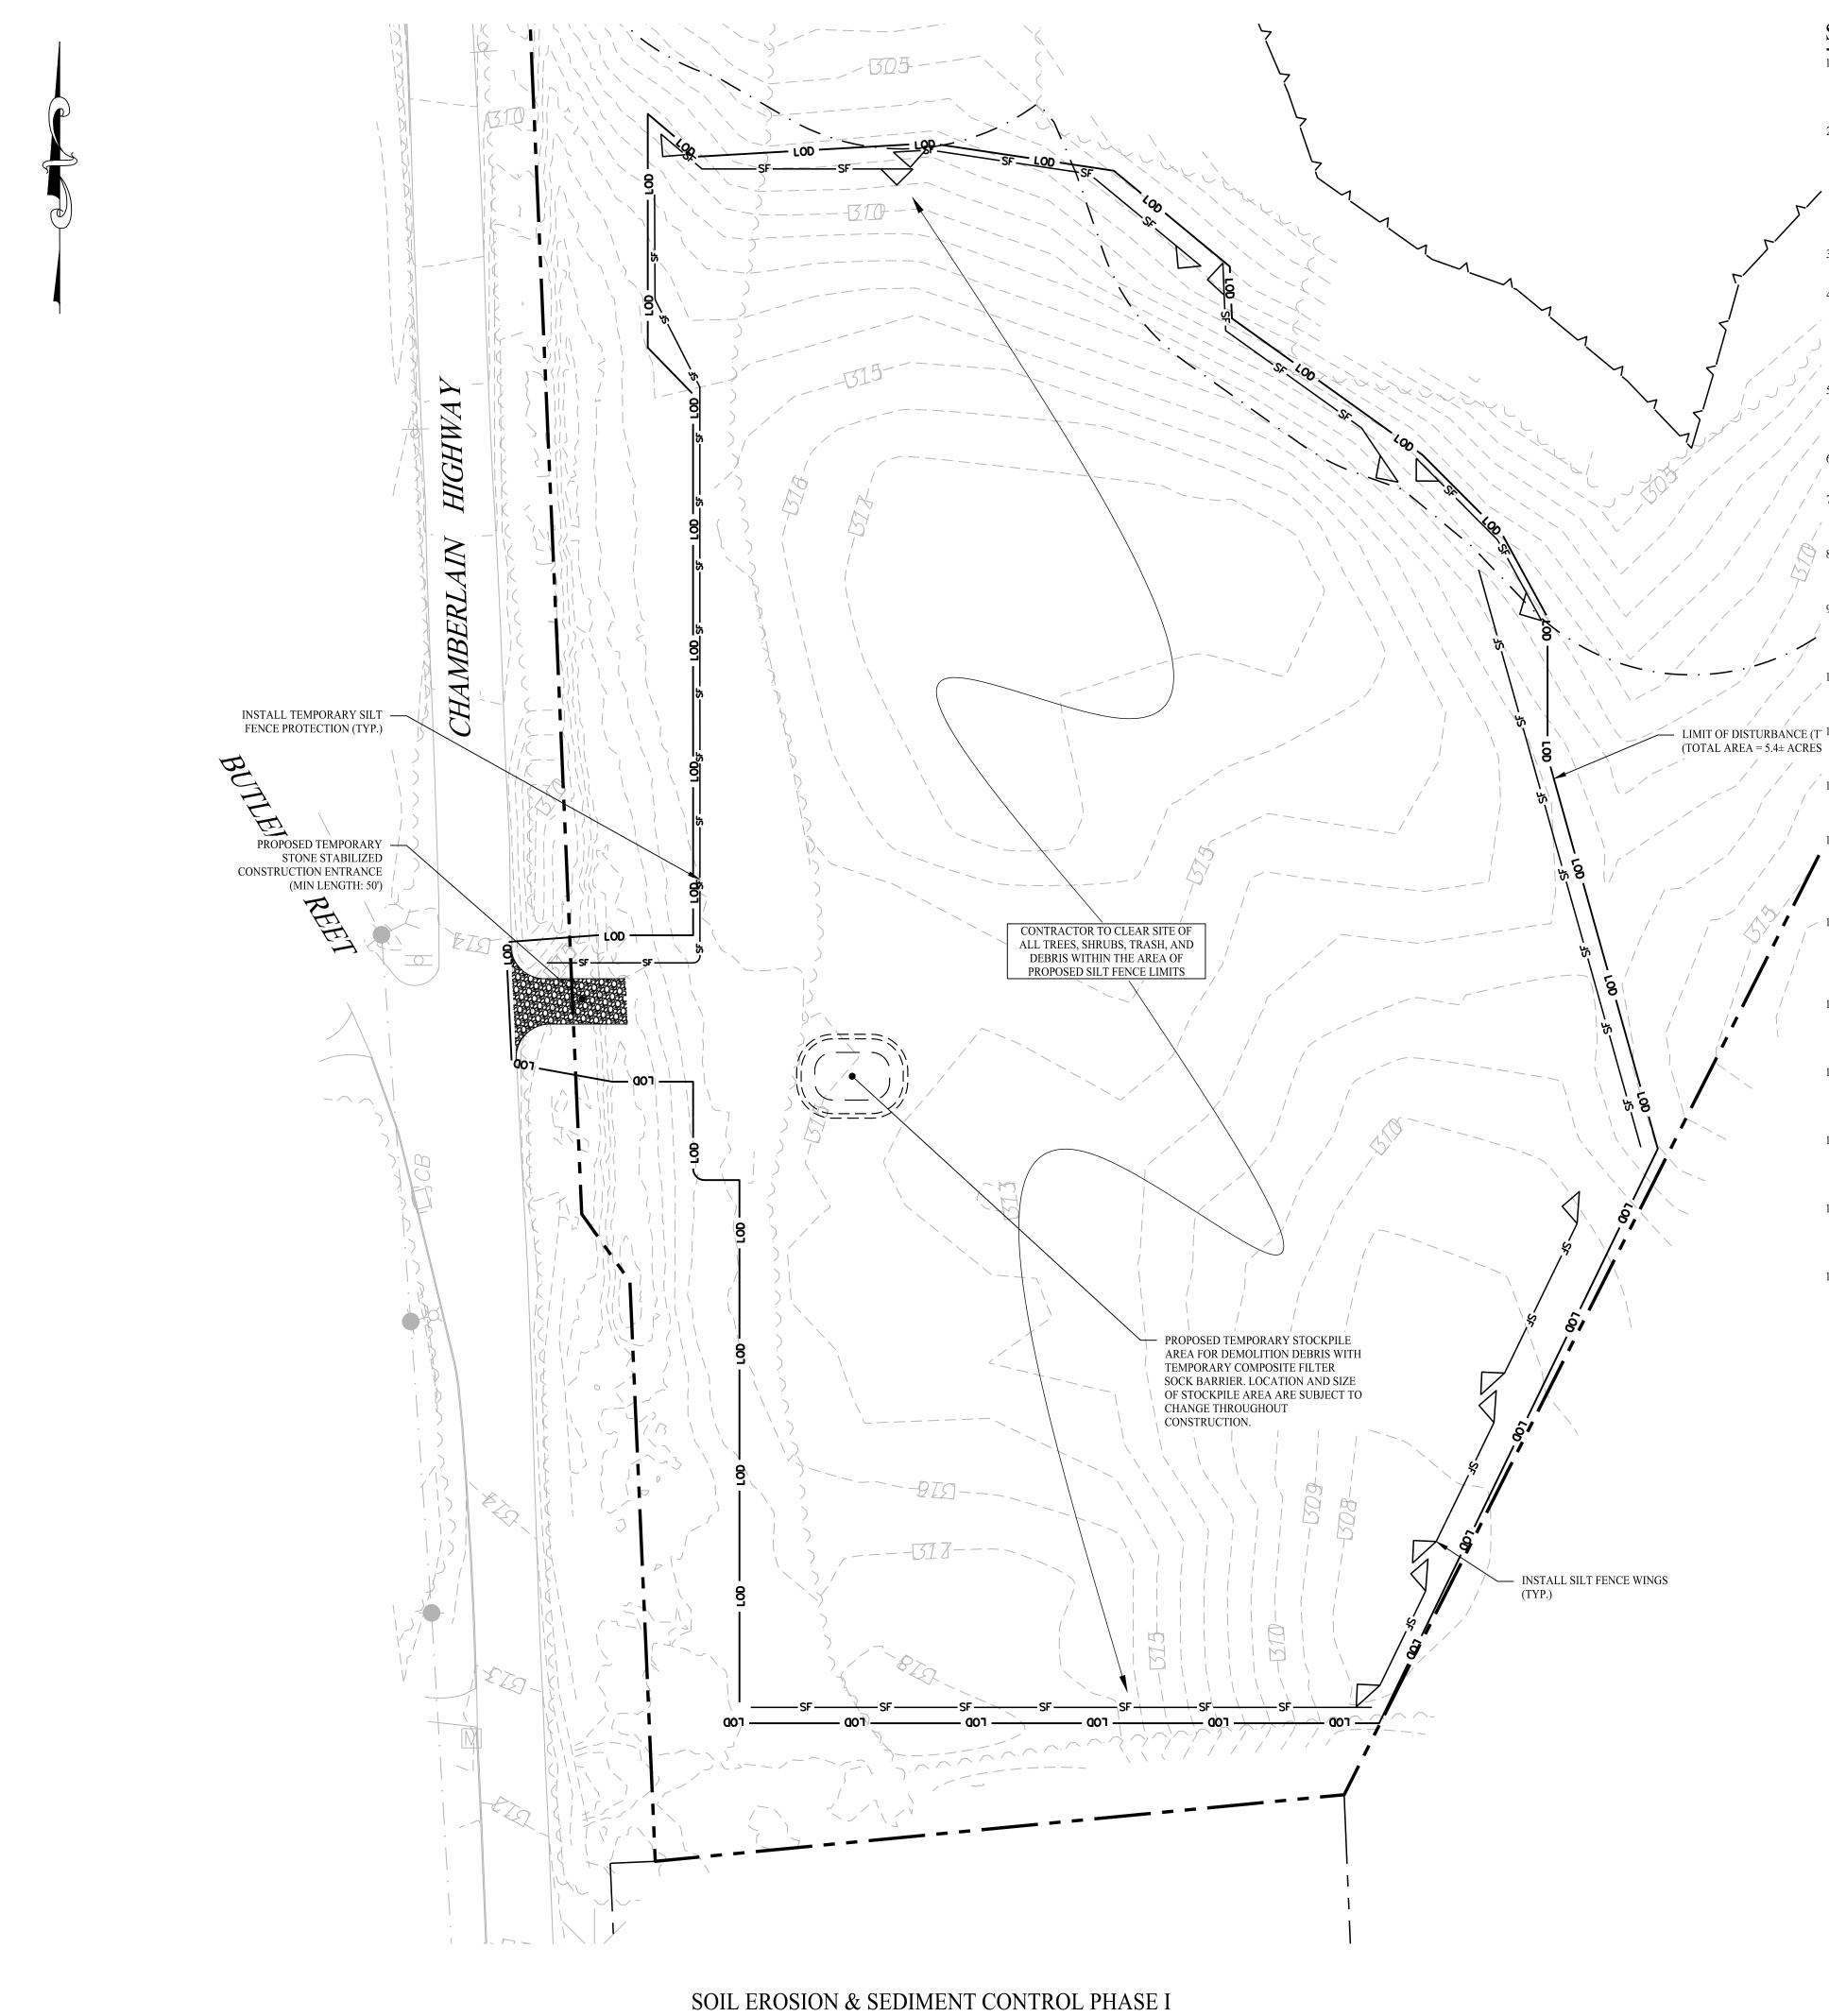
## GENERAL NOTES

- THIS DRAWING IS INTENDED TO DESCRIBE GRADING AND DRAINAGE ONLY. REFER TO SITE PLAN FOR GENERAL INFORMATION AND DETAIL SHEETS FOR CONSTRUCTION DETAILS.
   THE CONTRACTOR SHALL PRESERVE EXISTING VEGETATION WHERE POSSIBLE AND/OR AS NOTED ON DRAWINGS. REFER TO EROSION CONTROL PLAN FOR LIMIT OF DISTURBANCE AND EROSION
- CONTROL NOTES.3. TOPSOIL SHALL BE STRIPPED AND STOCKPILED ON SITE FOR USE IN FINAL LANDSCAPING.4. THE OWNER IS RESPONSIBLE FOR OBTAINING ALL NECESSARY CONSTRUCTION PERMITS REQUIRED
- BY GOVERNMENT AND LOCAL AGENCIES PRIOR TO CONSTRUCTION. THE CONTRACTOR SHALL OBTAIN ALL NECESSARY CONSTRUCTION PERMITS FROM THE TOWN OF BERLIN REQUIRED TO PERFORM ALL WORK. THE CONTRACTOR SHALL POST ALL BONDS, PAY ALL FEES, PROVIDE PROOF OF INSURANCE, AND PROVIDE TRAFFIC CONTROL NECESSARY FOR THIS WORK.
  5. THE CONTRACTOR SHALL COMPACT FILL IN 12" MAXIMUM LIFTS UNDER ALL PARKING, CONCRETE
- PADS, AND DRIVE AREAS TO 95% OF THE MAXIMUM DRY DENSITY AS DETERMINED BY ASTM D1557 (MODIFIED PROCTOR TEST)6. UNDERDRAINS SHALL BE ADDED, IF DETERMINED NECESSARY IN THE FIELD BY THE ENGINEER OF
- RECORD, AFTER SUBGRADE IS ROUGH GRADED.7. ALL DISTURBANCE INCURRED TO TOWN OR STATE PROPERTY DUE TO CONSTRUCTION SHALL BE RESTORED TO ITS PREVIOUS CONDITION OR BETTER, TO THE SATISFACTION OF THE TOWN OF
- BERLIN AUTHORITY.
  8. IF IMPACTED OR CONTAMINATED SOIL IS ENCOUNTERED BY THE CONTRACTOR, THE CONTRACTOR SHALL SUSPEND EXCAVATION WORK OF IMPACTED SOIL AND NOTIFY THE OWNER AND/OR OWNER'S ENVIRONMENTAL CONSULTANT PRIOR TO PROCEEDING WITH FURTHER WORK IN THE IMPACTED SOIL LOCATION UNTIL FURTHER INSTRUCTED BY THE OWNER AND/OR OWNER'S ENVIRONMENTAL CONSULTANT.
- 9. ALL DISTURBED AREAS TO BE RESEEDED WITH ERNMX-147 WITHIN THE ARRAY AREA. ERNMX-610 WILL BE USED OUTSIDE FENCELINE AND IN NON-ARRAY AREAS. CATCHMENT AREA TO BE SEEDED WITH NEW ENGLAND EROSION CONTROL/RESTORATION NO MOW MIX. REFER TO SHEET 2.11 FOR AREAS TO BE SEEDED.

#### LEGEND

	PROPERTY LINE
420	MAJOR CONTOURS
421	MINOR CONTOURS
	EXISTING MAJOR CONTOURS
	EXISTING MINOR CONTOURS
$\times^{[568.85]}$	PROPOSED SPOT ELEVATION
× ^{568.85}	EXISTING SPOT ELEVATION
· · ·	WETLAND UPLAND REVIEW AREA - 100 FT BUFFER
<b>_</b> · · <b>_</b> · · <b>_</b> · · <b>_</b> · · <b>_</b>	STORMWATER CATCHMENT AREA
	TRINA 540W SOLAR MODULES
	GRAVEL ROAD

Rev. #: D	late	Description
Graphic Scale:		
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501 Main Street, M 11 Vanderbilt Ave,	SC ENG Monroe, CT 06468 Norwood, MA 02062	DILII       F: (203) 880-5455         T: (203) 880-5455       F: (203) 880-9695         T: (781) 352-8491       F: (203) 880-9695
Drawn By:	RHF	
Checked By:	AWC	
Approved By:	KMS	
Project #:	23100201	
Plan Date:	09/30/23	Kevin Solli, P.E.
Scale:	1'' = 40'	CT 25759
Project:		
PRO	OPOSE	ED SOLAR
PHOT	OVOL	<b>FAIC ARRAY</b>
		AIN HIGHWAY
В	ERLIN, CO	NNECTICUT
Sheet Title:		Sheet #:
GRAD	ING &	
DRAI	NAGE	2.21
PLA	AN	



#### SEDIMENT & EROSION CONTROL NOTES

- TO SITE PLAN FOR GENERAL INFORMATION AND OTHER CONTRACT PLANS FOR APPROPRIATE INFORMATION.
- INSTALLATION AND MAINTENANCE.
- SHOWN ON THE PLANS ARE PROPOSED BY THE CONTRACTOR.
- CONTROLS ARE OPERATING PROPERLY AND MAKE REPAIRS AS NECESSARY IN A TIMELY MANNER.
- BLANKET, ETC.) ON-SITE FOR PERIODIC MAINTENANCE AND EMERGENCY REPAIRS.
- ALL FILL MATERIAL PLACED ADJACENT TO ANY WETLAND AREA SHALL BE GOOD QUALITY, WITH LESS THAN 5% FINES PASSING DENSITY MODIFIED PROCTOR OR AS SPECIFIED IN THE CONTRACT SPECIFICATIONS.
- PROTECT EXISTING TREES THAT ARE TO BE SAVED BY FENCING, ORANGE SAFETY FENCE, CONSTRUCTION TAPE, OR EQUIVALENT BEGINS IN THAT AREA. FENCING SHALL BE MAINTAINED AND REPAIRED DURING CONSTRUCTION.
- VEHICLES EXITING THE SITE ARE PASSING OVER THE ANTI-TRACKING PADS PRIOR TO EXITING.
- OF THE SEDIMENT BARRIER UNLESS WORK IS SPECIFICALLY CALLED FOR ON THE DOWNHILL SIDE OF THE BARRIER.
- UNTIL TURF IS ESTABLISHED.
- SHALL BE CLEAR AND APPROVED BY THE PERMITTEE OR MUNICIPALITY.
- PREVENTION AND RESPONSE/CONTAINMENT.
- HYDROSEEDED WITH TACKIFIER.
- EXITING THE SITE SHALL BE COVERED.
- THAN 30 DAYS.
- 17. MAINTAIN ALL PERMANENT AND TEMPORARY SEDIMENT CONTROL DEVICES IN EFFECTIVE CONDITION THROUGHOUT THE FROM PERMITTEE OR THE MUNICIPALITY.
- ALL SEED MIXTURES.
- 19. REFER TO SHEET 2.41 FOR SEDIMENT & EROSION CONTROL NARRATIVE & DETAILS.

1. THE CONTRACTOR SHALL CONSTRUCT ALL SEDIMENT AND EROSION CONTROLS IN ACCORDANCE WITH THE 2002 CONNECTICUT GUIDELINES FOR SOIL EROSION AND SEDIMENT CONTROL, LATEST EDITION, IN ACCORDANCE WITH THE CONTRACT DOCUMENTS, AND AS DIRECTED BY THE TOWN OF BERLIN, PERMITTEE, AND/OR SWPCP MONITOR. ALL PERIMETER SEDIMENTATION AND EROSION CONTROL MEASURES SHALL BE INSTALLED PRIOR TO THE START OF CLEARING AND GRUBBING AND DEMOLITION OPERATIONS.

THESE DRAWINGS ARE ONLY INTENDED TO DESCRIBE THE SEDIMENT AND EROSION CONTROL MEASURES FOR THIS SITE. SEE CONSTRUCTION SEQUENCE FOR ADDITIONAL INFORMATION. ALL TEMPORARY EROSION AND SEDIMENT CONTROL MEASURES SHOWN ON THE EROSION & SEDIMENT CONTROL PLAN ARE SHOWN AS REQUIRED BY THE ENGINEER OF RECORD. THE CONTRACTOR SHALL BE RESPONSIBLE FOR ENSURING THAT ALL EROSION CONTROL MEASURES ARE CONFIGURED AND CONSTRUCTED IN A MANNER THAT WILL MINIMIZE EROSION OF SOILS AND PREVENT THE TRANSPORT OF SEDIMENTS AND OTHER POLLUTANTS TO STORM DRAINAGE SYSTEMS AND/OR WATERCOURSES. ACTUAL SITE CONDITIONS OR SEASONAL AND CLIMATIC CONDITIONS MAY WARRANT ADDITIONAL CONTROLS OR CONFIGURATIONS, AS REQUIRED, AND AS DIRECTED BY THE PERMITTEE AND/OR SWPCP MONITOR. REFER

3. A BOND OR LETTER OF CREDIT MAY BE REQUIRED TO BE POSTED WITH THE GOVERNING AUTHORITY FOR THE EROSION CONTROL

4. THE CONTRACTOR SHALL APPLY THE MINIMUM EROSION & SEDIMENT CONTROL MEASURES SHOWN ON THE PLAN IN CONJUNCTION WITH CONSTRUCTION SEQUENCING, SUCH THAT ALL ACTIVE WORK ZONES ARE PROTECTED. ADDITIONAL AND/OR ALTERNATIVE SEDIMENT AND EROSION CONTROL MEASURES MAY BE INSTALLED DURING THE CONSTRUCTION PERIOD IF FOUND NECESSARY BY THE CONTRACTOR, OWNER, ENGINEER OF RECORD, MUNICIPAL OFFICIALS, OR ANY GOVERNING AGENCY. THE CONTRACTOR SHALL CONTACT THE OWNER AND APPROPRIATE GOVERNING AGENCIES FOR APPROVAL IF ALTERNATIVE CONTROLS OTHER THAN THOSE

THE CONTRACTOR SHALL TAKE EXTREME CARE DURING CONSTRUCTION SO AS NOT TO DISTURB UNPROTECTED WETLAND AREAS OR INSTALLED SEDIMENTATION AND EROSION CONTROL MEASURES. THE CONTRACTOR SHALL INSPECT ALL SEDIMENT AND EROSION CONTROLS WEEKLY AND WITHIN 24 HOURS OF A STORM WITH A RAINFALL AMOUNT OF 0.25 INCHES OR GREATER TO VERIFY THAT THE

THE CONTRACTOR SHALL KEEP A SUPPLY OF EROSION CONTROL MATERIAL (SILT FENCE, COMPOSITE FILTER SOCK, EROSION CONTROL

THROUGH A #200 SIEVE (BANK RUN), SHALL BE PLACED IN MAXIMUM ONE FOOT LIFTS, AND SHALL BE COMPACTED TO 95% MAX. DRY

FENCING/TAPE. ANY LIMB TRIMMING SHOULD BE DONE AFTER CONSULTATION WITH AN ARBORIST AND BEFORE CONSTRUCTION

CONSTRUCTION ENTRANCES (ANTI-TRACKING PADS) SHALL BE INSTALLED PRIOR TO ANY SITE EXCAVATION OR CONSTRUCTION ACTIVITY AND SHALL BE MAINTAINED THROUGHOUT THE DURATION OF ALL CONSTRUCTION IF REQUIRED. THE LOCATION OF THE TRACKING PADS MAY CHANGE AS VARIOUS PHASES OF CONSTRUCTION ARE COMPLETED. CONTRACTOR SHALL ENSURE THAT ALL

ALL CONSTRUCTION SHALL BE CONTAINED WITHIN THE LIMIT OF DISTURBANCE, WHICH SHALL BE MARKED WITH SILT FENCE, SAFETY FENCE, HAY BALES, RIBBONS, OR OTHER MEANS PRIOR TO CLEARING. CONSTRUCTION ACTIVITY SHALL REMAIN ON THE UPHILL SIDE

LIMIT OF DISTURBANCE (T 11. NO CUT OR FILL SLOPES SHALL EXCEED 2:1 EXCEPT WHERE STABILIZED BY ROCK FACED EMBANKMENTS OR EROSION CONTROL BLANKETS. ALL SLOPES SHALL BE SEEDED AND BANKS WILL BE STABILIZED IMMEDIATELY UPON COMPLETION OF FINAL GRADING

> 12. DIRECT ANY DEWATERING PUMP DISCHARGE TO A SEDIMENT CONTROL DEVICE CONFORMING TO THE GUIDELINES WITHIN THE APPROVED LIMIT OF DISTURBANCE IF REQUIRED. DISCHARGE TO STORM DRAINS OR SURFACE WATERS FROM SEDIMENT CONTROLS

THE CONTRACTOR SHALL MAINTAIN A CLEAN CONSTRUCTION SITE AND SHALL NOT ALLOW THE ACCUMULATION OF RUBBISH OR CONSTRUCTION DEBRIS ON THE SITE. PROPER SANITARY DEVICES SHALL BE MAINTAINED ON-SITE AT ALL TIMES AND SECURED APPROPRIATELY. THE CONTRACTOR SHALL TAKE ALL NECESSARY PRECAUTIONS TO AVOID THE SPILLAGE OF FUEL OR OTHER POLLUTANTS ON THE CONSTRUCTION SITE AND SHALL ADHERE TO ALL APPLICABLE POLICIES AND REGULATIONS RELATED TO SPILL

MINIMIZE LAND DISTURBANCES. SEED AND MULCH DISTURBED AREAS WITH TEMPORARY MIX AS SOON AS PRACTICABLE (2 WEEK MAXIMUM UNSTABILIZED PERIOD) USING PERENNIAL RYEGRASS AT 40 LBS PER ACRE. MULCH ALL CUT AND FILL SLOPES AND SWALES WITH LOOSE HAY AT A RATE OF 2 TONS PER ACRE. IF NECESSARY, REPLACE LOOSE HAY ON SLOPES WITH EROSION CONTROL BLANKETS OR JUTE CLOTH. MODERATELY GRADED AREAS, ISLANDS, AND TEMPORARY CONSTRUCTION STAGING AREAS MAY BE

SWEEP AFFECTED PORTIONS OF OFF SITE ROADS ONE OR MORE TIMES A DAY (OR LESS FREQUENTLY IF TRACKING IS NOT A PROBLEM) DURING CONSTRUCTION. FOR DUST CONTROL, PERIODICALLY MOISTEN EXPOSED SOIL SURFACES WITH WATER ON UNPAVED TRAVELWAYS TO KEEP THE TRAVELWAYS DAMP. CALCIUM CHLORIDE MAY ALSO BE APPLIED TO ACCESS ROADS. DUMP TRUCK LOADS

16. VEGETATIVE ESTABLISHMENT SHALL OCCUR ON ALL DISTURBED SOIL, UNLESS THE AREA IS UNDER ACTIVE CONSTRUCTION. IT IS COVERED IN STONE OR SCHEDULED FOR PAVING WITHIN 30 DAYS. TEMPORARY SEEDING OR NON-LIVING SOIL PROTECTION OF ALL EXPOSED SOILS AND SLOPES SHALL BE INITIATED WITHIN THE FIRST 7 DAYS OF SUSPENDING WORK IN AREAS TO BE LEFT LONGER

CONSTRUCTION PERIOD. UPON COMPLETION OF WORK SWEEP CONCRETE PADS, CLEAN THE STORMWATER MANAGEMENT SYSTEMS AND REMOVE ALL TEMPORARY SEDIMENT CONTROLS ONCE THE SITE IS FULLY STABILIZED AND APPROVAL HAS BEEN RECEIVED

18. SEEDING MIXTURES SHALL BE FUZZ & BUZZ MIX - PREMIUM - ERNMX-147, OR APPROVED EQUAL. NEW ENGLAND EROSION CONTROL/ RESTORATION MIX FOR STORMWATER BASINS & MOIST SITES, OR APPROVED EQUAL, SHALL BE UTILIZED ON THE BOTTOM OF THE BASIN & FUZZ & BUZZ MIX - PREMIUM - ERNMX-147, OR APPROVED EQUAL, ON THE SIDE SLOPES OF THE BASIN. SEE SHEET DN-2 FOR

#### CONSTRUCTION SEQUENCE (PHASE I)

SEOUENCE THE FOLLOWING SUGGESTED SEOUENCE OF CONSTRUCTION ACTIVITIES IS PROJECTED BASED UPON ENGINEERING JUDGEMENT AND BEST MANAGEMENT PRACTICES. THE CONTRACTOR MAY ELECT TO ALTER THE SEQUENCING TO BEST MEET THE CONSTRUCTION SCHEDULE. THE EXISTING SITE ACTIVITIES, AND WEATHER CONDITIONS. SHOULD THE CONTRACTOR ALTER THE CONSTRUCTION SEQUENCE OR ANY EROSION AND SEDIMENTATION CONTROL MEASURES THEY SHALL MODIFY THE STORMWATER POLLUTION CONTROL PLAN ("SWPCP") AS REQUIRED BY THE GENERAL PERMIT. MAJOR CHANGES IN SEQUENCING AND/OR METHODS MAY REQUIRE REGULATORY APPROVAL PRIOR TO IMPLEMENTATION.

PHASE I:

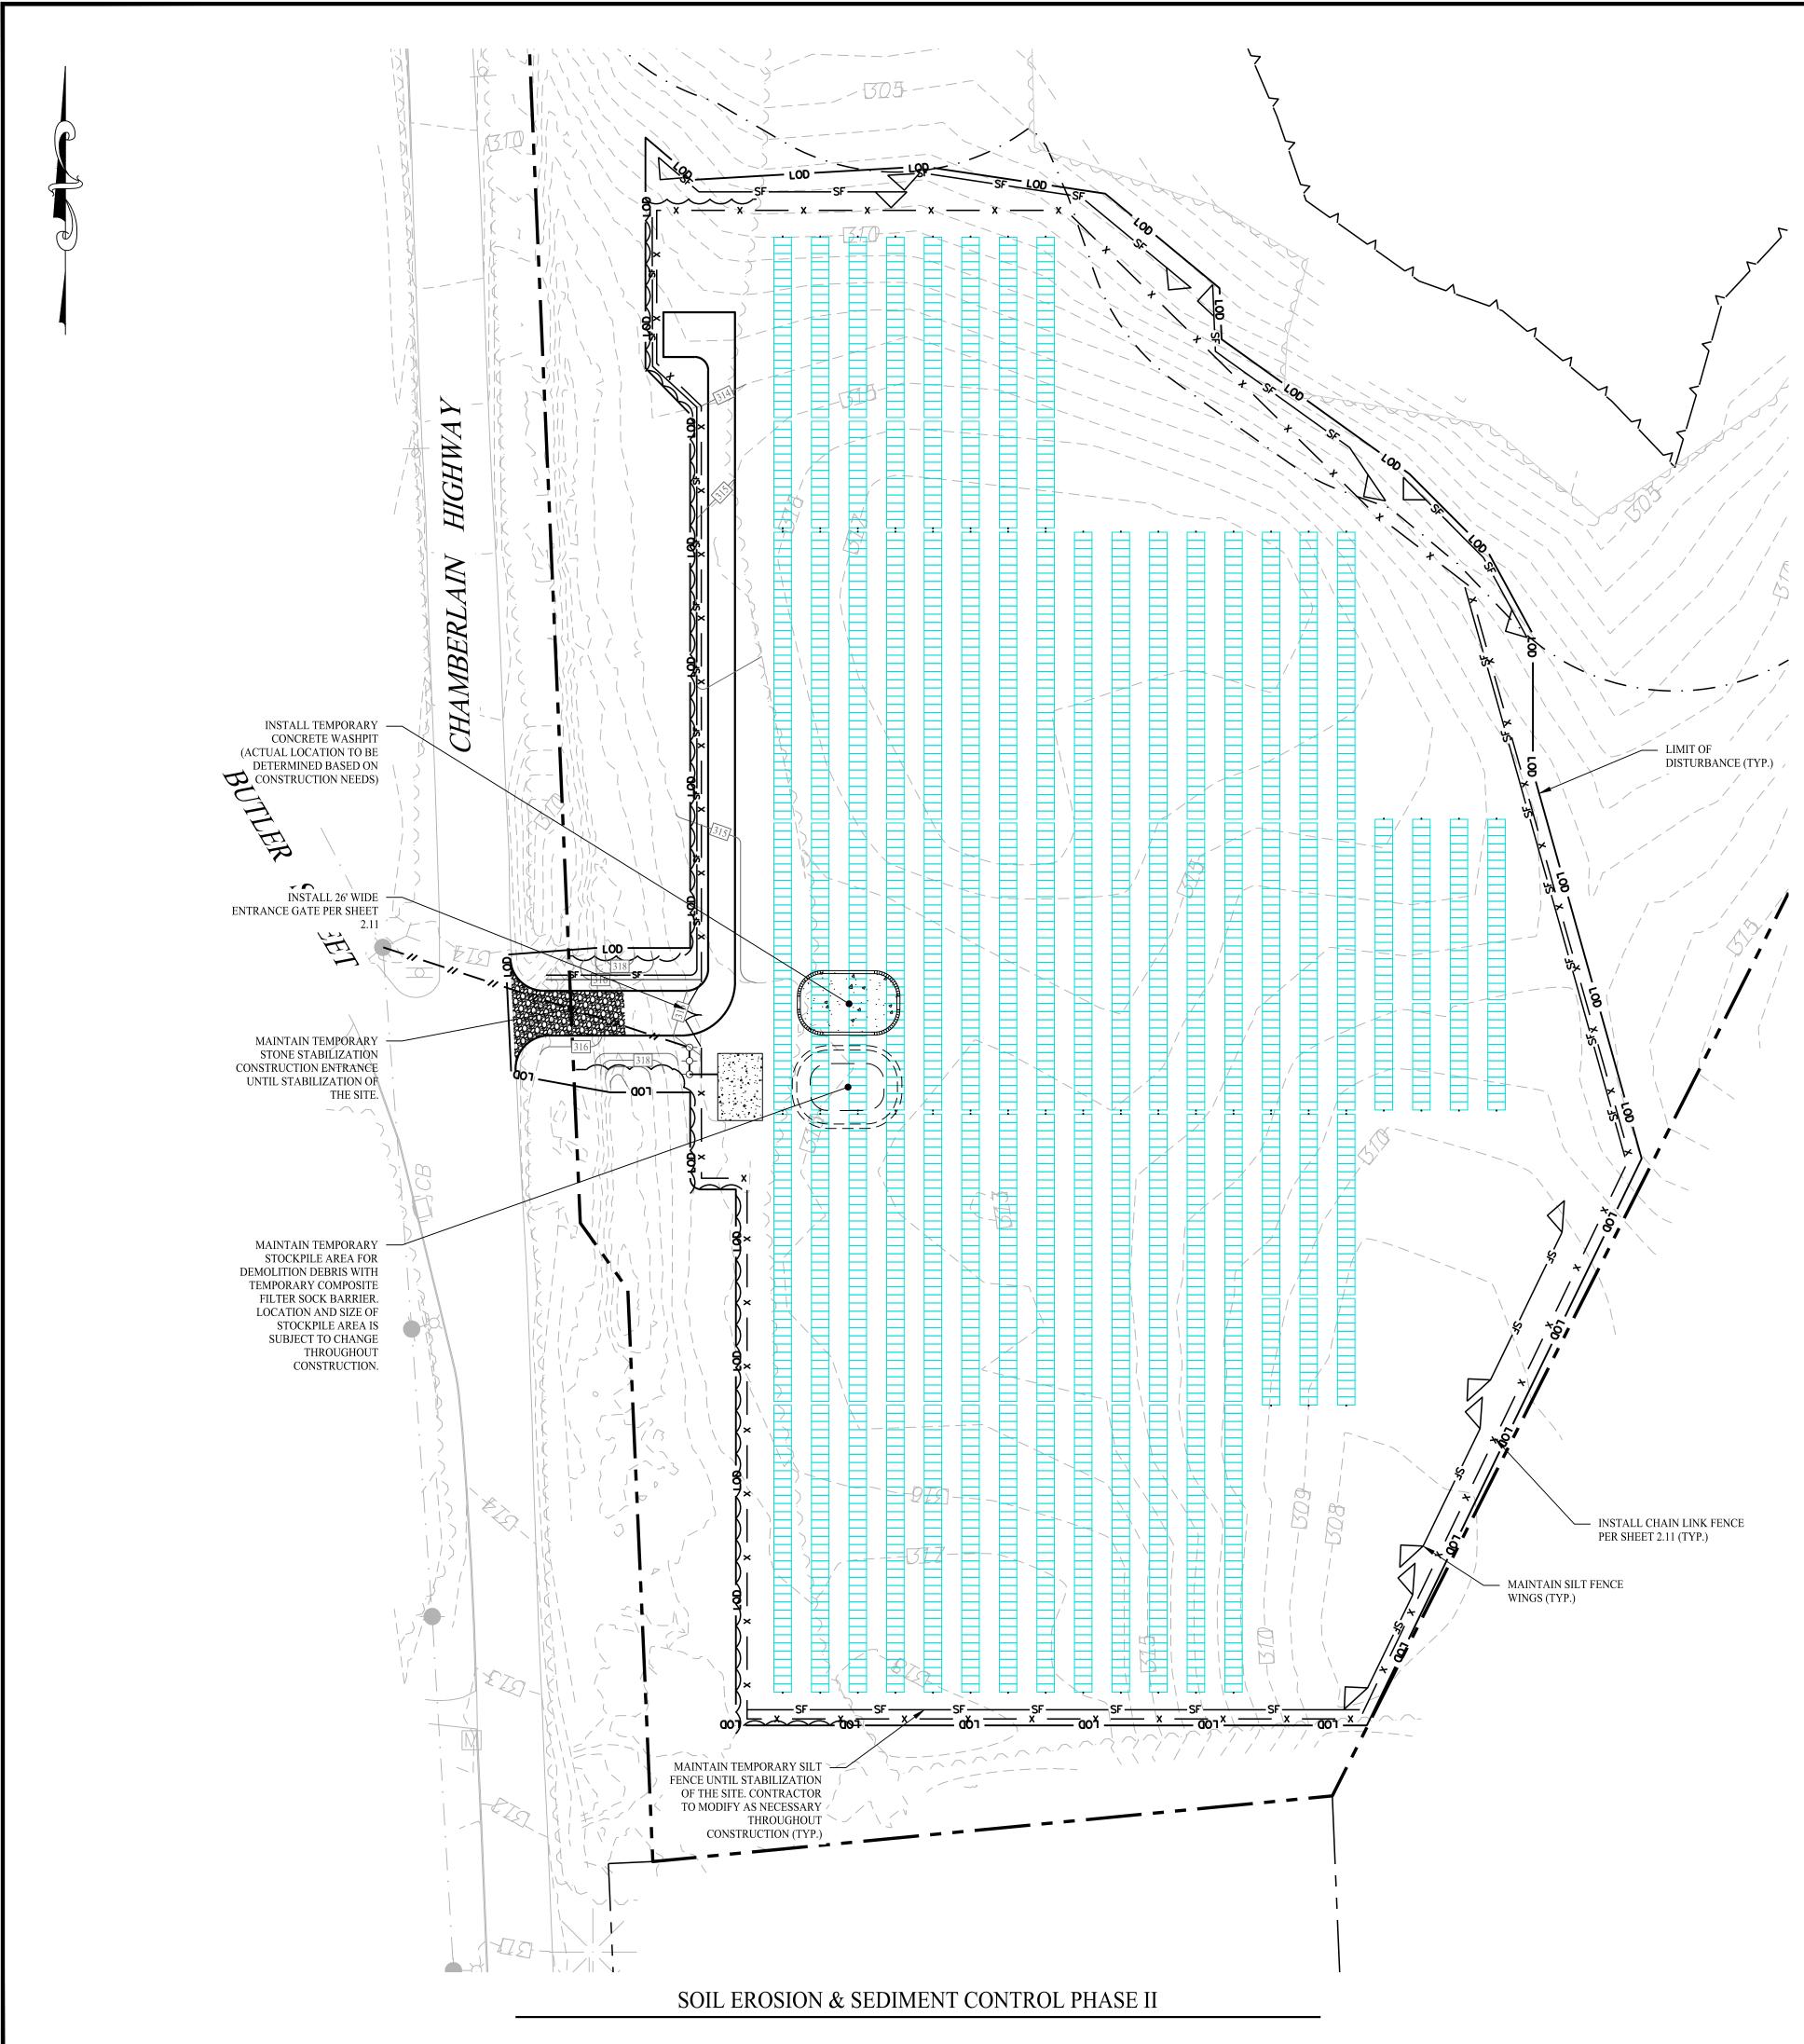
1. THE CONTRACTOR SHALL SCHEDULE A PRE-CONSTRUCTION MEETING. PHYSICALLY FLAG THE LIMITS OF DISTURBANCE IN THE FIELD AS NECESSARY TO FACILITATE THE PRE-CONSTRUCTION MEETING.

- 2. CONDUCT A PRE-CONSTRUCTION MEETING TO DISCUSS THE PROPOSED WORK AND EROSION AND SEDIMENTATION CONTROL MEASURES. THE MEETING SHOULD BE ATTENDED BY THE OWNER, THE OWNER'S REPRESENTATIVE(S), THE GENERAL CONTRACTOR, DESIGNATED SUB-CONTRACTORS AND THE PERSON, OR PERSONS, RESPONSIBLE FOR THE IMPLEMENTATION, OPERATION, MONITORING AND MAINTENANCE OF THE EROSION AND SEDIMENTATION MEASURES. THE CONSTRUCTION PROCEDURES FOR THE ENTIRE PROJECT SHALL BE REVIEWED AT THIS MEETING.
- 3. NOTIFY CALL BEFORE YOU DIG AT "(800) 922-4455", AS REQUIRED, PRIOR TO THE START OF CONSTRUCTION. PHASE 1 4. REMOVE EXISTING IMPEDIMENTS AS NECESSARY AND PROVIDE MINIMAL
- DISTURBANCE TO INSTALL THE REQUIRED CONSTRUCTION ENTRANCE. 5. INSTALL PERIMETER EROSION CONTROL.
- 6. INSTALL ACCESS DRIVE. 7. INSTALL ELECTRICAL CONDUIT, RACKING POSTS FOR GROUND MOUNTED SOLAR
- PANELS AND GROUND MOUNTED SOLAR PANELS AND COMPLETE ELECTRICAL INSTALLATION.
- 8. TEMPORARILY SEED DISTURBED AREAS NOT UNDER CONSTRUCTION FOR THIRTY (30) DAYS OR MORE.

## LEGEND

PROPERTY LINE WETLAND LIMIT WETLAND UPLAND REVIEW AREA - 100 FT BUF ------ · -------SILT FENCE PROTECTION LIMIT OF DISTURBANCE _____ MATERIAL STOCKPILE AREA CONSTRUCTION ENTRANCE

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501 Main Street, N		<b>DLLI</b> <b>INEERING</b> T: (203) 880-5455 F: (203) 880-9695
Drawn By:	e, Norwood, MA 0206 RHF	i2 T: (781) 352-8491 F: (203) 880-9695
Checked By:	CJB	
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Approved By:	KMS	
Approved By: Project #:	KMS 23100201	Kevin Solli, P.E. CT 25759
Approved By: Project #: Plan Date:	KMS 23100201 09/30/23	
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Approved By: Project #: Plan Date: Scale: Project: Project: PRO O CH B Sheet Title:	КМS 23100201 09/30/23 1" = 40' OPOSI OVOL HAMBERL BERLIN, CO OSION & MENT	ED SOLAR TAIC ARRAY AIN HIGHWAY DNNECTICUT



#### SEDIMENT & EROSION CONTROL NOTES

- 1. THE CONTRACTOR SHALL CONSTRUCT ALL SEDIMENT AND EROSION CONTROLS IN ACCORDANCE WITH THE 2002 CONNECTICUT
- THESE DRAWINGS ARE ONLY INTENDED TO DESCRIBE THE SEDIMENT AND EROSION CONTROL MEASURES FOR THIS SITE. SEE SYSTEMS AND/OR WATERCOURSES. ACTUAL SITE CONDITIONS OR SEASONAL AND CLIMATIC CONDITIONS MAY WARRANT TO SITE PLAN FOR GENERAL INFORMATION AND OTHER CONTRACT PLANS FOR APPROPRIATE INFORMATION.
- INSTALLATION AND MAINTENANCE.
- SHOWN ON THE PLANS ARE PROPOSED BY THE CONTRACTOR.
- CONTROLS ARE OPERATING PROPERLY AND MAKE REPAIRS AS NECESSARY IN A TIMELY MANNER.
- BLANKET, ETC.) ON-SITE FOR PERIODIC MAINTENANCE AND EMERGENCY REPAIRS.
- ALL FILL MATERIAL PLACED ADJACENT TO ANY WETLAND AREA SHALL BE GOOD QUALITY, WITH LESS THAN 5% FINES PASSING DENSITY MODIFIED PROCTOR OR AS SPECIFIED IN THE CONTRACT SPECIFICATIONS.
- PROTECT EXISTING TREES THAT ARE TO BE SAVED BY FENCING, ORANGE SAFETY FENCE, CONSTRUCTION TAPE, OR EQUIVALENT BEGINS IN THAT AREA. FENCING SHALL BE MAINTAINED AND REPAIRED DURING CONSTRUCTION.
- VEHICLES EXITING THE SITE ARE PASSING OVER THE ANTI-TRACKING PADS PRIOR TO EXITING
- OF THE SEDIMENT BARRIER UNLESS WORK IS SPECIFICALLY CALLED FOR ON THE DOWNHILL SIDE OF THE BARRIER.
- BLANKETS. ALL SLOPES SHALL BE SEEDED AND BANKS WILL BE STABILIZED IMMEDIATELY UPON COMPLETION OF FINAL GRADING UNTIL TURF IS ESTABLISHED.
- 12. DIRECT ANY DEWATERING PUMP DISCHARGE TO A SEDIMENT CONTROL DEVICE CONFORMING TO THE GUIDELINES WITHIN THE SHALL BE CLEAR AND APPROVED BY THE PERMITTEE OR MUNICIPALITY.
- PREVENTION AND RESPONSE/CONTAINMENT.
- MINIMIZE LAND DISTURBANCES. SEED AND MULCH DISTURBED AREAS WITH TEMPORARY MIX AS SOON AS PRACTICABLE (2 WEEK HYDROSEEDED WITH TACKIFIER.
- EXITING THE SITE SHALL BE COVERED.
- THAN 30 DAYS.
- 17. MAINTAIN ALL PERMANENT AND TEMPORARY SEDIMENT CONTROL DEVICES IN EFFECTIVE CONDITION THROUGHOUT THE FROM PERMITTEE OR THE MUNICIPALITY.
- ALL SEED MIXTURES.
- 19. REFER TO SHEET 2.41 FOR SEDIMENT & EROSION CONTROL NARRATIVE & DETAILS.

GUIDELINES FOR SOIL EROSION AND SEDIMENT CONTROL, LATEST EDITION, IN ACCORDANCE WITH THE CONTRACT DOCUMENTS, AND AS DIRECTED BY THE TOWN OF BERLIN, PERMITTEE, AND/OR SWPCP MONITOR, ALL PERIMETER SEDIMENTATION AND EROSION CONTROL MEASURES SHALL BE INSTALLED PRIOR TO THE START OF CLEARING AND GRUBBING AND DEMOLITION OPERATIONS.

CONSTRUCTION SEQUENCE FOR ADDITIONAL INFORMATION. ALL TEMPORARY EROSION AND SEDIMENT CONTROL MEASURES SHOWN ON THE EROSION & SEDIMENT CONTROL PLAN ARE SHOWN AS REQUIRED BY THE ENGINEER OF RECORD. THE CONTRACTOR SHALL BE RESPONSIBLE FOR ENSURING THAT ALL EROSION CONTROL MEASURES ARE CONFIGURED AND CONSTRUCTED IN A MANNER THAT WILL MINIMIZE EROSION OF SOILS AND PREVENT THE TRANSPORT OF SEDIMENTS AND OTHER POLLUTANTS TO STORM DRAINAGE ADDITIONAL CONTROLS OR CONFIGURATIONS, AS REOUIRED, AND AS DIRECTED BY THE PERMITTEE AND/OR SWPCP MONITOR. REFER

3. A BOND OR LETTER OF CREDIT MAY BE REQUIRED TO BE POSTED WITH THE GOVERNING AUTHORITY FOR THE EROSION CONTROL

4. THE CONTRACTOR SHALL APPLY THE MINIMUM EROSION & SEDIMENT CONTROL MEASURES SHOWN ON THE PLAN IN CONJUNCTION WITH CONSTRUCTION SEQUENCING, SUCH THAT ALL ACTIVE WORK ZONES ARE PROTECTED. ADDITIONAL AND/OR ALTERNATIVE SEDIMENT AND EROSION CONTROL MEASURES MAY BE INSTALLED DURING THE CONSTRUCTION PERIOD IF FOUND NECESSARY BY THE CONTRACTOR, OWNER, ENGINEER OF RECORD, MUNICIPAL OFFICIALS, OR ANY GOVERNING AGENCY. THE CONTRACTOR SHALL CONTACT THE OWNER AND APPROPRIATE GOVERNING AGENCIES FOR APPROVAL IF ALTERNATIVE CONTROLS OTHER THAN THOSE

THE CONTRACTOR SHALL TAKE EXTREME CARE DURING CONSTRUCTION SO AS NOT TO DISTURB UNPROTECTED WETLAND AREAS OR INSTALLED SEDIMENTATION AND EROSION CONTROL MEASURES. THE CONTRACTOR SHALL INSPECT ALL SEDIMENT AND EROSION CONTROLS WEEKLY AND WITHIN 24 HOURS OF A STORM WITH A RAINFALL AMOUNT OF 0.25 INCHES OR GREATER TO VERIFY THAT THE

THE CONTRACTOR SHALL KEEP A SUPPLY OF EROSION CONTROL MATERIAL (SILT FENCE, COMPOSITE FILTER SOCK, EROSION CONTROL

THROUGH A #200 SIEVE (BANK RUN), SHALL BE PLACED IN MAXIMUM ONE FOOT LIFTS, AND SHALL BE COMPACTED TO 95% MAX. DRY

FENCING/TAPE. ANY LIMB TRIMMING SHOULD BE DONE AFTER CONSULTATION WITH AN ARBORIST AND BEFORE CONSTRUCTION

CONSTRUCTION ENTRANCES (ANTI-TRACKING PADS) SHALL BE INSTALLED PRIOR TO ANY SITE EXCAVATION OR CONSTRUCTION ACTIVITY AND SHALL BE MAINTAINED THROUGHOUT THE DURATION OF ALL CONSTRUCTION IF REQUIRED. THE LOCATION OF THE TRACKING PADS MAY CHANGE AS VARIOUS PHASES OF CONSTRUCTION ARE COMPLETED. CONTRACTOR SHALL ENSURE THAT ALL

ALL CONSTRUCTION SHALL BE CONTAINED WITHIN THE LIMIT OF DISTURBANCE, WHICH SHALL BE MARKED WITH SILT FENCE, SAFETY FENCE, HAY BALES, RIBBONS, OR OTHER MEANS PRIOR TO CLEARING. CONSTRUCTION ACTIVITY SHALL REMAIN ON THE UPHILL SIDE

11. NO CUT OR FILL SLOPES SHALL EXCEED 2:1 EXCEPT WHERE STABILIZED BY ROCK FACED EMBANKMENTS OR EROSION CONTROL

APPROVED LIMIT OF DISTURBANCE IF REQUIRED. DISCHARGE TO STORM DRAINS OR SURFACE WATERS FROM SEDIMENT CONTROLS

13. THE CONTRACTOR SHALL MAINTAIN A CLEAN CONSTRUCTION SITE AND SHALL NOT ALLOW THE ACCUMULATION OF RUBBISH OR CONSTRUCTION DEBRIS ON THE SITE. PROPER SANITARY DEVICES SHALL BE MAINTAINED ON-SITE AT ALL TIMES AND SECURED APPROPRIATELY. THE CONTRACTOR SHALL TAKE ALL NECESSARY PRECAUTIONS TO AVOID THE SPILLAGE OF FUEL OR OTHER POLLUTANTS ON THE CONSTRUCTION SITE AND SHALL ADHERE TO ALL APPLICABLE POLICIES AND REGULATIONS RELATED TO SPILL

MAXIMUM UNSTABILIZED PERIOD) USING PERENNIAL RYEGRASS AT 40 LBS PER ACRE. MULCH ALL CUT AND FILL SLOPES AND SWALES WITH LOOSE HAY AT A RATE OF 2 TONS PER ACRE. IF NECESSARY, REPLACE LOOSE HAY ON SLOPES WITH EROSION CONTROL BLANKETS OR JUTE CLOTH. MODERATELY GRADED AREAS, ISLANDS, AND TEMPORARY CONSTRUCTION STAGING AREAS MAY BE

15. SWEEP AFFECTED PORTIONS OF OFF SITE ROADS ONE OR MORE TIMES A DAY (OR LESS FREQUENTLY IF TRACKING IS NOT A PROBLEM) DURING CONSTRUCTION. FOR DUST CONTROL, PERIODICALLY MOISTEN EXPOSED SOIL SURFACES WITH WATER ON UNPAVED TRAVELWAYS TO KEEP THE TRAVELWAYS DAMP. CALCIUM CHLORIDE MAY ALSO BE APPLIED TO ACCESS ROADS. DUMP TRUCK LOADS

16. VEGETATIVE ESTABLISHMENT SHALL OCCUR ON ALL DISTURBED SOIL, UNLESS THE AREA IS UNDER ACTIVE CONSTRUCTION, IT IS COVERED IN STONE OR SCHEDULED FOR PAVING WITHIN 30 DAYS. TEMPORARY SEEDING OR NON-LIVING SOIL PROTECTION OF ALL EXPOSED SOILS AND SLOPES SHALL BE INITIATED WITHIN THE FIRST 7 DAYS OF SUSPENDING WORK IN AREAS TO BE LEFT LONGER

CONSTRUCTION PERIOD. UPON COMPLETION OF WORK SWEEP CONCRETE PADS, CLEAN THE STORMWATER MANAGEMENT SYSTEMS AND REMOVE ALL TEMPORARY SEDIMENT CONTROLS ONCE THE SITE IS FULLY STABILIZED AND APPROVAL HAS BEEN RECEIVED

18. SEEDING MIXTURES SHALL BE FUZZ & BUZZ MIX - PREMIUM - ERNMX-147, OR APPROVED EQUAL. NEW ENGLAND EROSION CONTROL/ RESTORATION MIX FOR STORMWATER BASINS AND MOIST SITES, OR APPROVED EOUAL, SHALL BE UTILIZED ON THE BOTTOM OF THE BASIN & FUZZ & BUZZ MIX - PREMIUM - ERNMX-147, OR APPROVED EQUAL, ON THE SIDE SLOPES OF THE BASIN. SEE SHEET DN-2 FOR

## CONSTRUCTION SEQUENCE (PHASE II)

- PHASE II: 1. AFTER SUBSTANTIAL COMPLETION OF THE INSTALLATION OF THE SOLAR PANELS, COMPLETE REMAINING SITE WORK, INCLUDING ANY REQUIRED LANDSCAPE SCREENING, CHAIN LINK FENCE, AND STABILIZE ALL DISTURBED AREAS.
- 2. FOR SLOPES GREATER THAN OR EQUAL TO 8%, EROSION CONTROL BLANKETS OR STUMP GRINDINGS OR EROSION CONTROL MIX MULCH OR HYDROSEED WITH TACKIFIER SHALL BE APPLIED WITHIN 72 HOURS OF FINAL GRADING, OR WHEN A RAINFALL OF 0.5 INCHES OR GREATER IS PREDICTED WITHIN 24 HOURS OF FINAL GRADING, WHICHEVER TIME PERIOD IS LESS.
- FINE GRADE, RAKE, SEED, AND MULCH ALL REMAINING DISTURBED AREAS. AFTER THE SITE IS STABILIZED AND WITH THE APPROVAL OF THE PERMITTEE AND IF NECESSARY THE CONSERVATION AGENT, REMOVE PERIMETER EROSION

PROPERTY LINE

WETLAND LIMIT

SILT FENCE PROTECTION

LIMIT OF DISTURBANCE

MATERIAL STOCKPILE AREA

CONSTRUCTION ENTRANCE

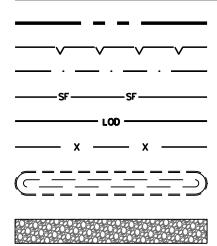
CONCRETE WASHPIT

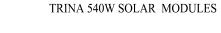
CHAIN LINK FENCE

WETLAND UPLAND REVIEW AREA - 100 FT BUFFER

AND SEDIMENTATION CONTROLS.

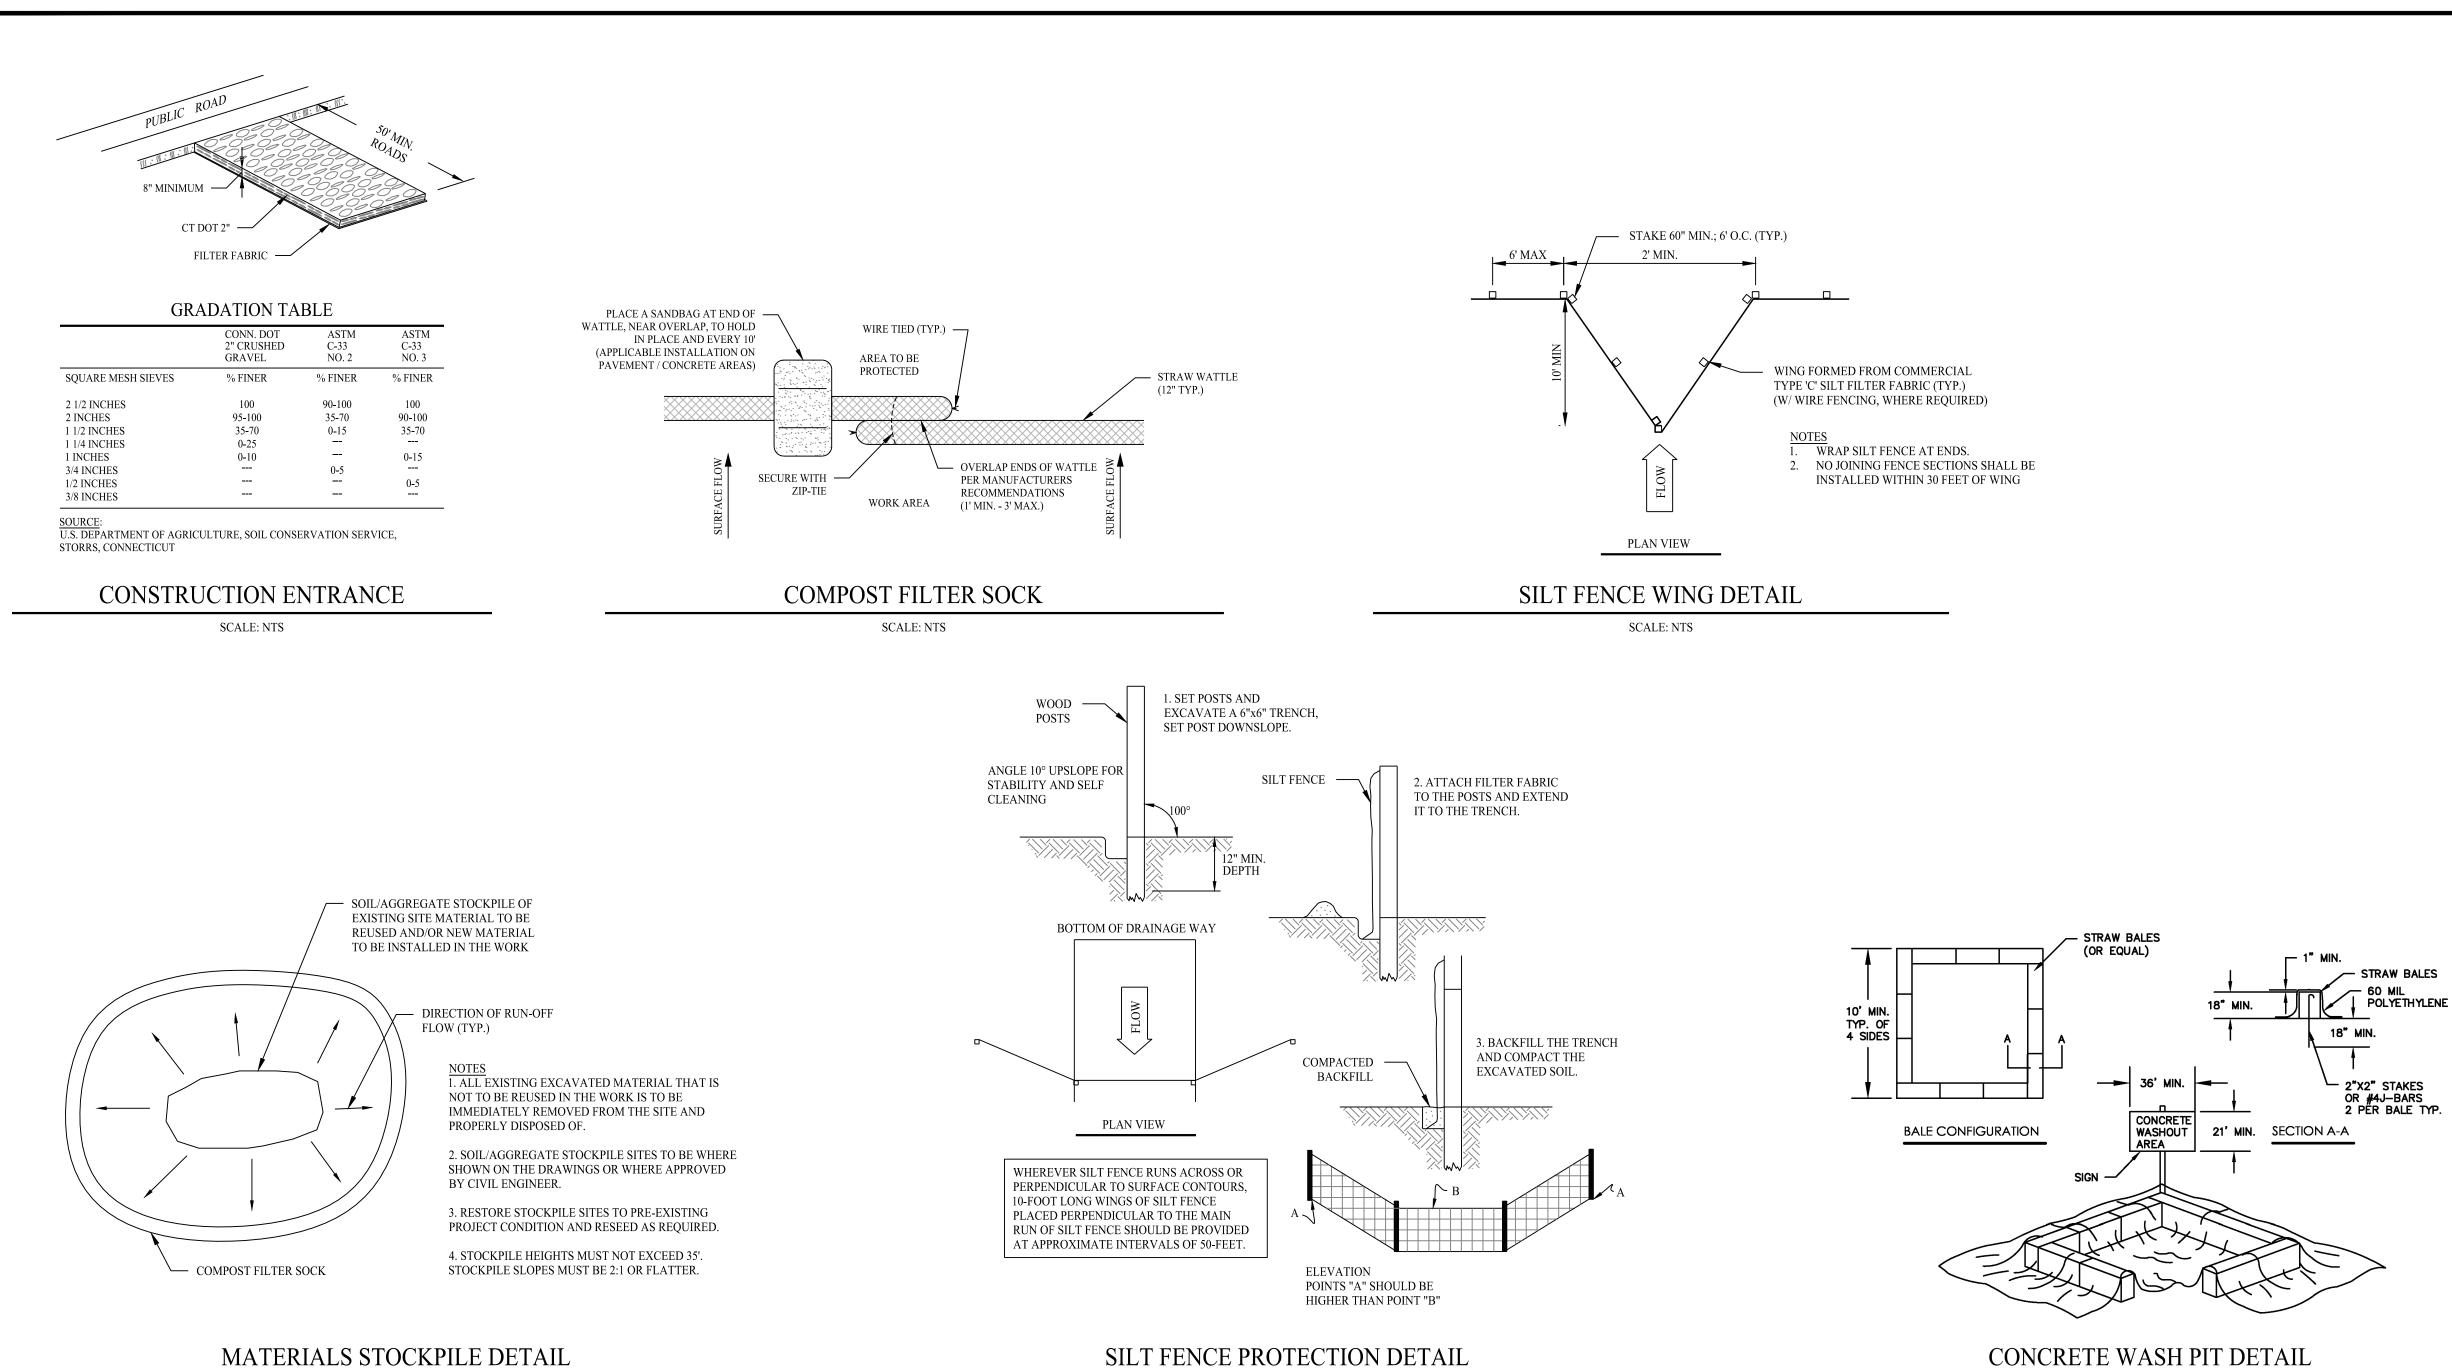
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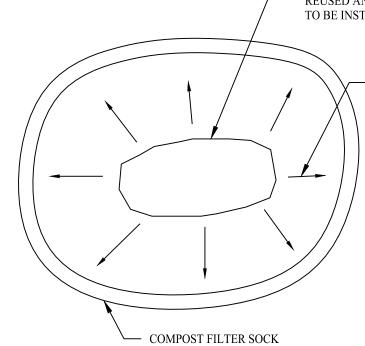




GRAVEL ROAD

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Drawn By:	RHF	
Checked By:	СЈВ	
Approved By:	KMS	
Project #:	23100201	
Plan Date:	09/30/23	Kevin Solli, P.E.
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## SEDIMENT & EROSION CONTROL NARRATIVE

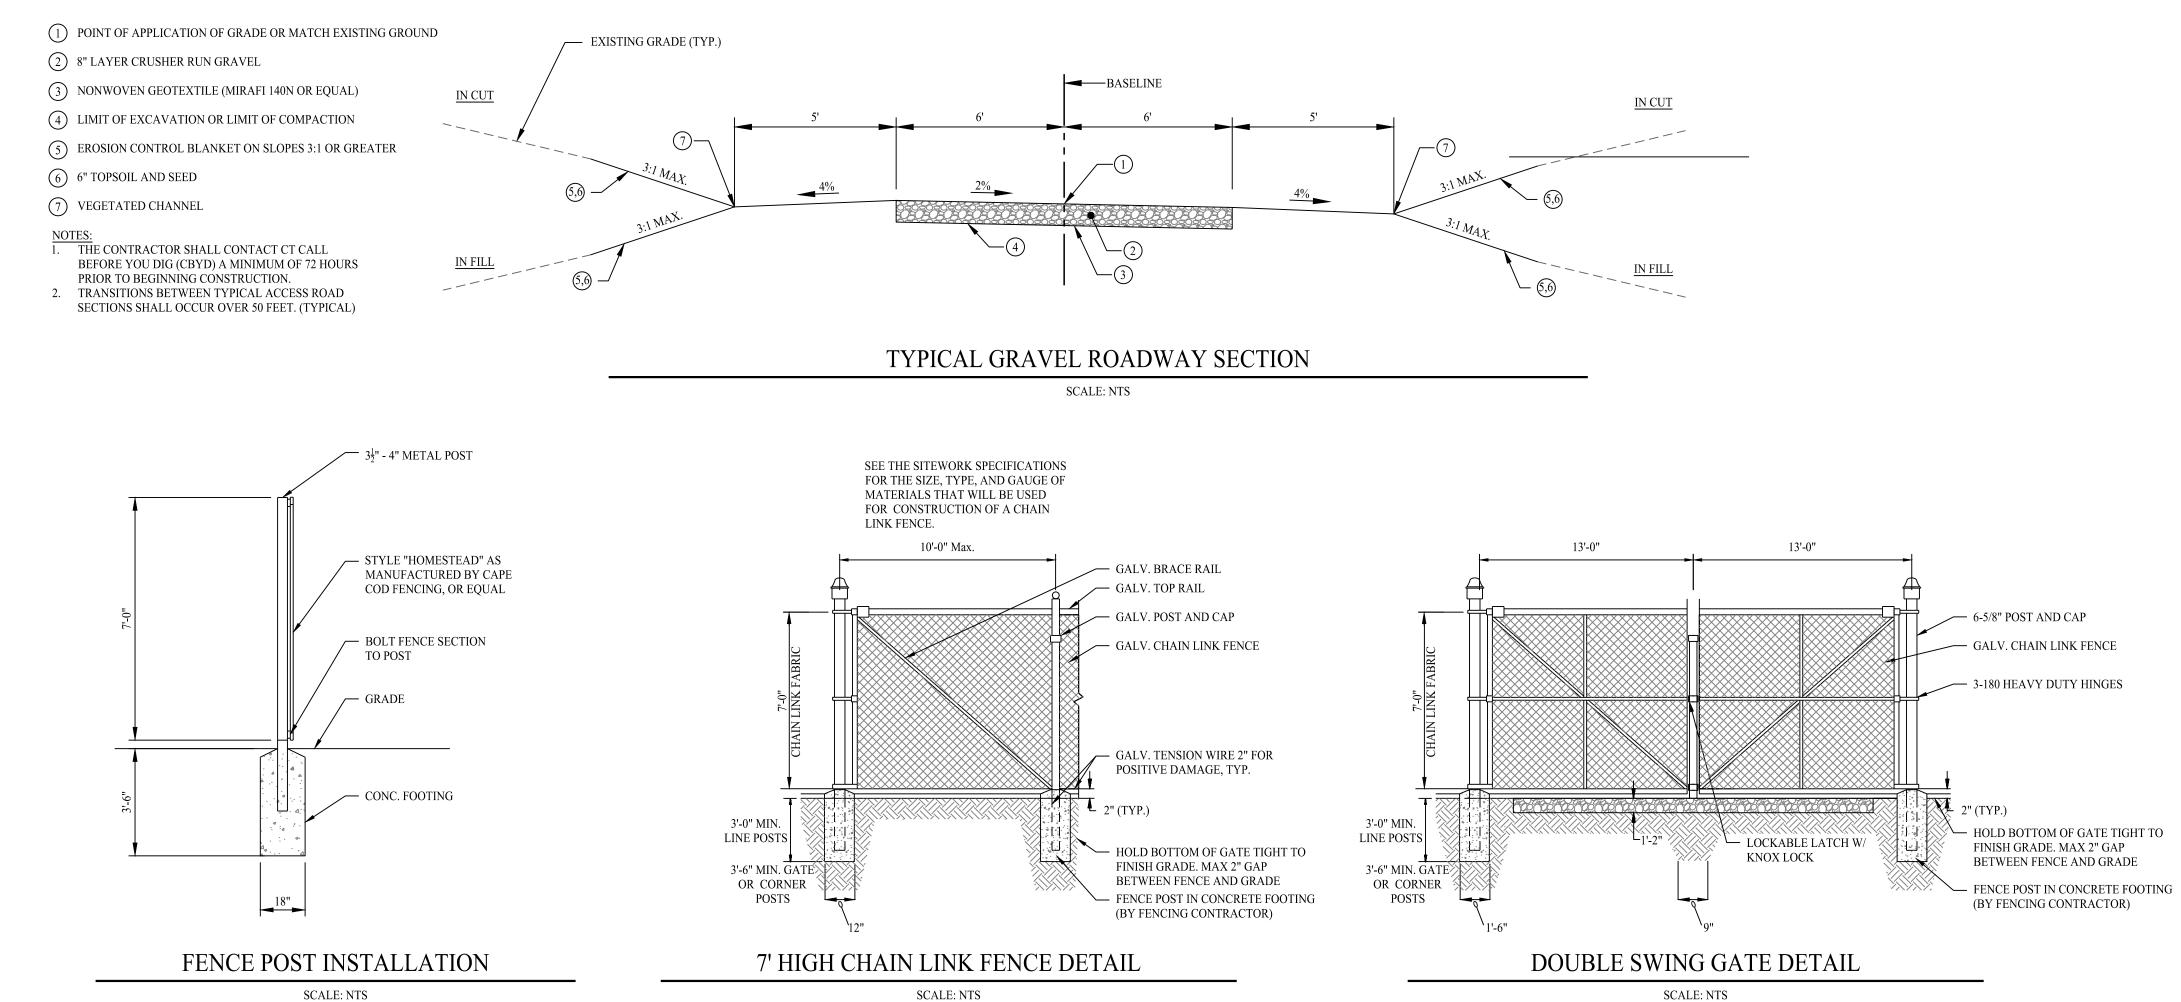
1. THE PROJECT INVOLVES THE CONSTRUCTION OF A GROUND MOUNTED SOLAR PANEL FACILITY WITH ASSOCIATED EQUIPMENT, INCLUDING GRADING OF APPROXIMATELY 5.5± ACRES OF EXISTING LOT.

THE PROPOSED PROJECT INVOLVES THE FOLLOWING CONSTRUCTION:

- A. CLEARING, GRUBBING, AND GRADING OF EXISTING LOT. B. CONSTRUCTION OF 2,590 GROUND MOUNTED SOLAR PANELS AND ASSOCIATED EQUIPMENT, EQUIPMENT PADS, CONDUIT AND POLES. C. THE STABILIZATION OF DISTURBED AREAS WITH PERMANENT VEGETATIVE TREATMENTS.
- 2. FOR THIS PROJECT, THERE ARE APPROXIMATELY 5.6± ACRES OF THE SITE BEING DISTURBED WITH NEGLIGIBLE INCREASE IN THE IMPERVIOUS AREA OF THE SITE. IMPERVIOUS AREAS ARE LIMITED TO THE CONCRETE PADS FOR ELECTRICAL EQUIPMENT AND GRAVEL ACCESS DRIVE.
- 3. THE PROJECT AREA, AS MAPPED IN THE SOIL SURVEY OF STATE OF CONNECTICUT (NRCS, VERSION 18, DEC 6, 2018), CONTAINS TYPE 37C (HYDROLOGIC SOIL GROUP A) AND 20A & 30B (HYDROLOGIC SOIL GROUP B). A GEOTECHNICAL ENGINEERING REPORT IS SCHEDULED AND WILL BE PROVIDED UNDER SÉPARATE COVER.
- 4. IT IS ANTICIPATED THAT CONSTRUCTION WILL BE COMPLETED IN APPROXIMATELY 4-6 MONTHS.
- 5. REFER TO THE CONSTRUCTION SEQUENCING AND EROSION AND SEDIMENTATION NOTES FOR INFORMATION REGARDING SEQUENCING OF MAJOR OPERATIONS IN THE ON-SITE CONSTRUCTION PHASES.
- 6. STORMWATER MANAGEMENT DESIGN CRITERIA UTILIZES THE APPLICABLE SECTIONS OF THE 2004 CONNECTICUT STORMWATER QUALITY MANUAL AND THE TOWN OF BERLIN STANDARDS, TO THE EXTENT POSSIBLE AND PRACTICABLE FOR THIS PROJECT ON THIS SITE. EROSION AND SEDIMENTATION MEASURES ARE BASED UPON ENGINEERING PRACTICE. JUDGEMENT AND THE APPLICABLE SECTIONS OF THE CONNECTICUT EROSION AND SEDIMENT CONTROL GUIDELINES FOR URBAN AND SUBURBAN AREAS, LATEST EDITION.
- 7. DETAILS FOR THE TYPICAL STORMWATER MANAGEMENT AND EROSION AND SEDIMENTATION MEASURES ARE SHOWN ON THE PLAN SHEETS OR PROVIDED AS SEPARATE SUPPORT DOCUMENTATION FOR REVIEW IN THIS PLAN.
- 8. CONSERVATION PRACTICES TO BE USED DURING CONSTRUCTION:
  - A. STAGED CONSTRUCTION; B. MINIMIZE THE DISTURBED AREAS TO THE EXTENT PRACTICABLE DURING
  - CONSTRUCTION; C. STABILIZE DISTURBED AREAS WITH TEMPORARY OR PERMANENT MEASURES AS SOON AS POSSIBLE, BUT NO LATER THAN 7-DAYS FOLLOWING DISTURBANCE;
  - D. MINIMIZE IMPERVIOUS AREAS; E. UTILIZE APPROPRIATE CONSTRUCTION EROSION AND SEDIMENTATION MEASURES.
- 9. THE FOLLOWING SEPARATE DOCUMENTS ARE TO BE CONSIDERED A PART OF THE EROSION AND SEDIMENTATION PLAN:
- A. STORMWATER MANAGEMENT REPORT, TO BE ISSUED AT A LATER DATE. B. SWPCP, TO BE ISSUED AT A LATER DATE.

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