


EXHIBIT C

Alternative Project Site Plan

ALTERNATIVE PROJECT SITE PLAN

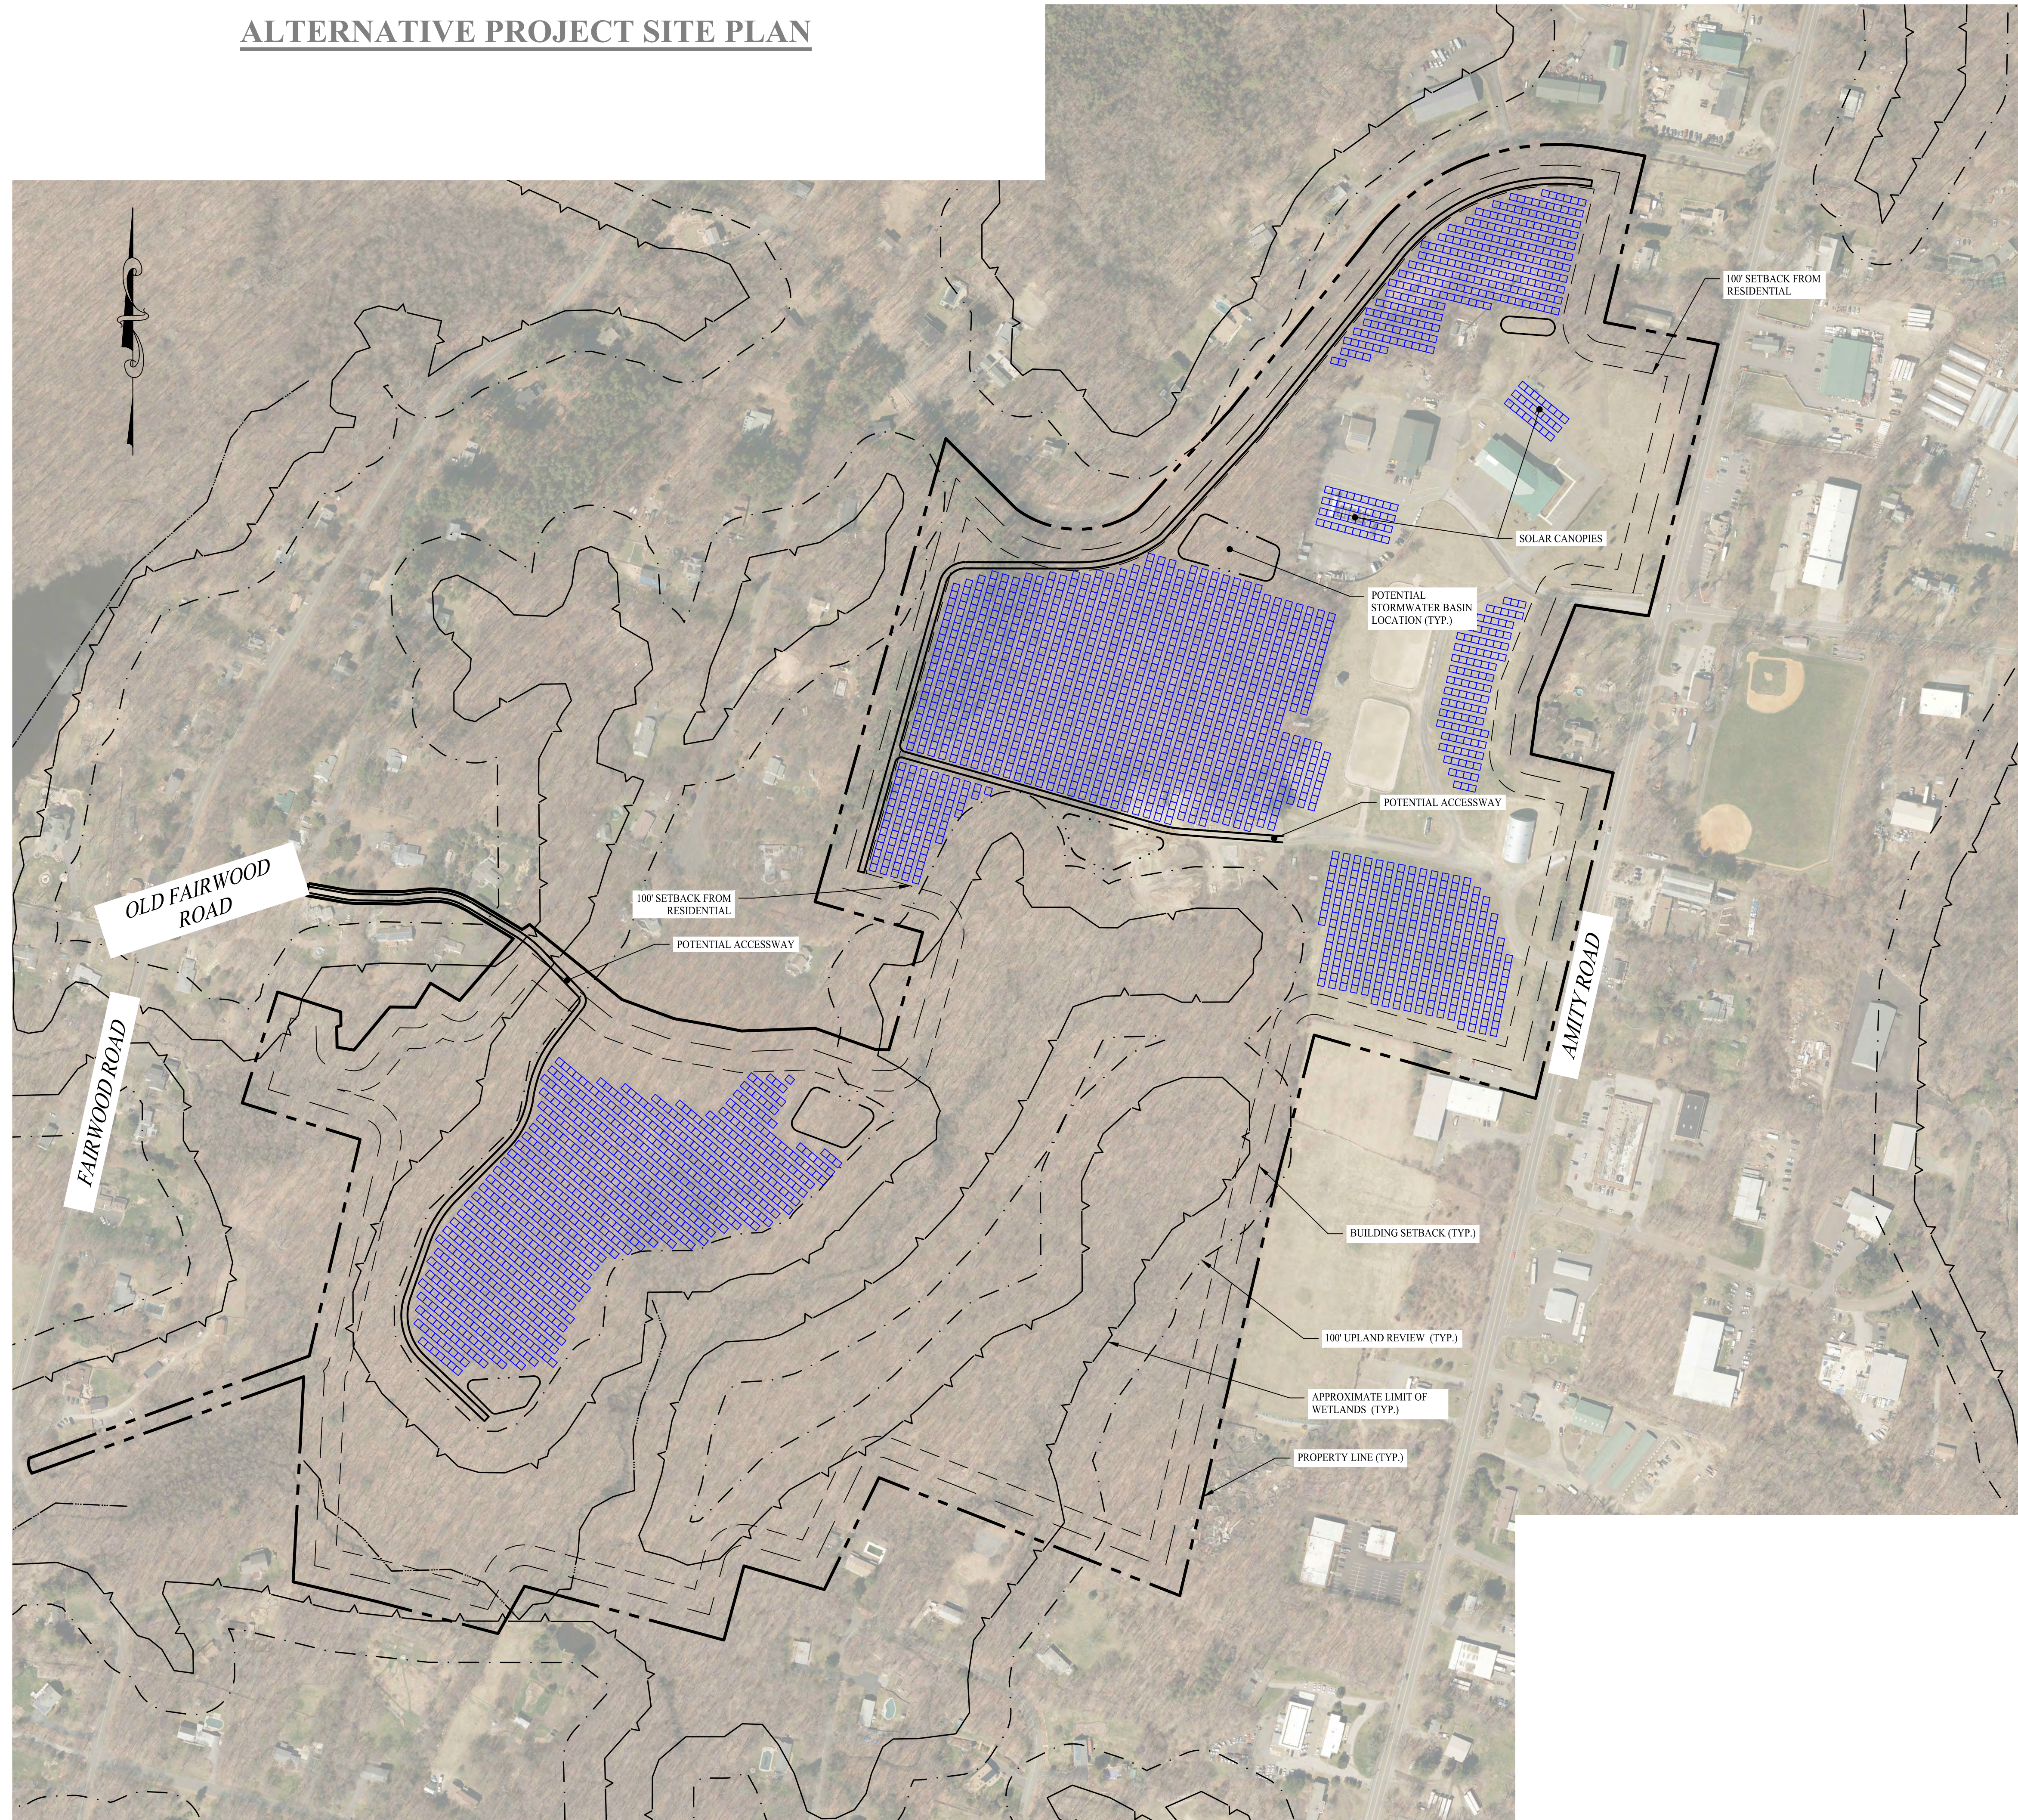

GENERAL NOTES

- EXISTING BOUNDARY INFORMATION TAKEN FROM TOWN OF BETHANY GEOGRAPHICAL INFORMATION SYSTEMS (GIS), AND BASEMAP IMAGERY TAKEN FROM AERIAL MAPPING PRODUCED BY CT ECO.
- THE SUBJECT PARCEL CONSISTS OF A TOTAL AREA OF APPROXIMATELY 138.5+ ACRES, LOCATED IN THE B&I DISTRICT IN THE TOWN OF BETHANY, CONNECTICUT.
- TOPOGRAPHICAL DATA WAS TAKEN FROM CT ECO. EARTHWORK MAY BE REQUIRED PENDING A DETAILED ANALYSIS.
- LOCATIONS OF WETLANDS, WATERCOURSES, AND COLD WATER STREAMS WERE TAKEN FROM CT ECO DATA. ALL DELINEATIONS ARE CONSIDERED APPROXIMATE AND SHOULD BE DELINEATED AND FLAGGED BY A CERTIFIED SOIL SCIENTIST REGISTERED WITHIN THE STATE OF CONNECTICUT.


LEGEND

	PROPERTY LINE
	BUILDING SETBACK
	LIMIT OF WETLANDS
	UPLAND REVIEW AREA - 100 FT BUFFER
	EDGE OF FARM ROAD/ACCESS DRIVE
	STORMWATER BASIN AREA
	100' RESIDENTIAL SETBACK
	TRINA 540W MODULES

SOLAR ARRAY SYSTEM INFORMATION

	TOTAL OUTPUT
SIZE DC	14.31 MW
SIZE AC	11.45 MW
INVERTER LOAD RATIO	1.25
MODULE TYPE	FIXED TILT TRINASOLAR TSM-540-DEG19C.20 (540W)
MODULE QUANTITY	26,500

Rev. #:	Date	Description

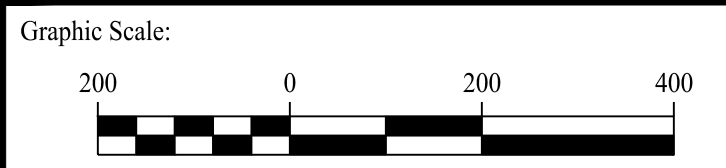

501 Main Street, Monroeville, CT 06468 T: (203) 880-5455 F: (203) 880-9695
 11 Vanderbilt Ave, Norwood, MA 02062 T: (781) 352-8491 F: (203) 880-9695

Drawn By:	MDM	Kevin Solli, P.E. CT 25759
Checked By:	RPP	
Approved By:	KMS	
Project #:	22109701	
Plan Date:	10/10/22	
Scale:	1" = 200'	

PROPOSED SOLAR PHOTOVOLTAIC ARRAY
 755 AMITY ROAD
 BETHANY, CONNECTICUT

Sheet Title:	Sheet #:
CONCEPTUAL LAYOUT PLAN	CP-1