



LIST OF DRAWINGS

- T-1 TITLE SHEET
- **1 OF 1 BOUNDARY SURVEY & LIDAR CONTOURS**
- **GN-1 GENERAL NOTES**
- **GN-2 ENVIRONMENTAL NOTES RESOURCE PROTECTION MEASURES**
- **OP-1 OVERALL LOCUS MAP**
- **OP-2 PARTIAL SITE PLAN**
- **EC-1 SEDIMENTATION & EROSION CONTROL NOTES**
- **EC-2 SEDIMENTATION & EROSION CONTROL DETAILS**
- EC-3 & EC-4 PHASE 1 SEDIMENTATION & EROSION CONTROL PLANS
- EC-5 & EC-6 PHASE 2 SEDIMENTATION & EROSION CONTROL PLANS
- SP-1 & SP-2 SITE & UTILITY PLANS
 - DN-1 SITE DETAILS
 - **DN-2 LANDSCAPING DETAILS**

EAST WINDSOR SOLAR TWO, LLC


"EAST WINDSOR SOLAR TWO" 31 THRALL ROAD BROAD BROOK, CT 06016

CSC PETITION PLAN SET APRIL 3, 2023


SITE INFORMATION

SITE NAME:	"EAST WINDSOR SOLAR TWO"
LOCATION:	31 THRALL ROAD BROAD BROOK, CT 06016
SITE TYPE/DESCRIPTION:	ADD GROUND MOUNTED SOLAR PANEL ARRA' W/ ASSOCIATED EQUIPMENT, GRAVEL ACCESS ROAD, AND STORMWATER MANAGEMENT.
PROPERTY OWNER:	CATHOLIC CEMETERIES ASSOCIATION OF THE ARCHDIOCESE OF HARTFORD, INC. 700 MIDDLETOWN AVE. NORTH HAVEN, CT 06473
APPLICANT:	EAST WINDSOR SOLAR TWO, LLC 124 LASALLE ROAD, 2ND FLOOR WEST HARTFORD, CT 06107
ENGINEER CONTACT:	ROBERT C. BURNS, P.E. (860) 552-2036
LONGITUDE:	41°53'39.37" N 72°31'51.58" W 220'± AMSL
ZONE: EXISTING LAND USE:	49-60-15 R-3 RESIDENTIAL - FARMING COMMUNICATIONS, TRANSPORTATION AND PUBLIC UTILITY USES - LARGE SCALE GROUND MOUNTED SOLAR PHOTOVOLTAIC INSTALLATIONS
TOTAL SITE: TOTAL DISTURBED AREA:	
PROP. SITE GRADING APPROX. VOLUME OF CUT : APPROX. VOLUME OF FILL:	
APPROX. OVERALL NET VOLUME:	0± CY OF CUT
TREE CLEARING AREA:	2,650± LINEAR FEET


IMPERVIOUS AREA: 17,500± SQUARE FEET

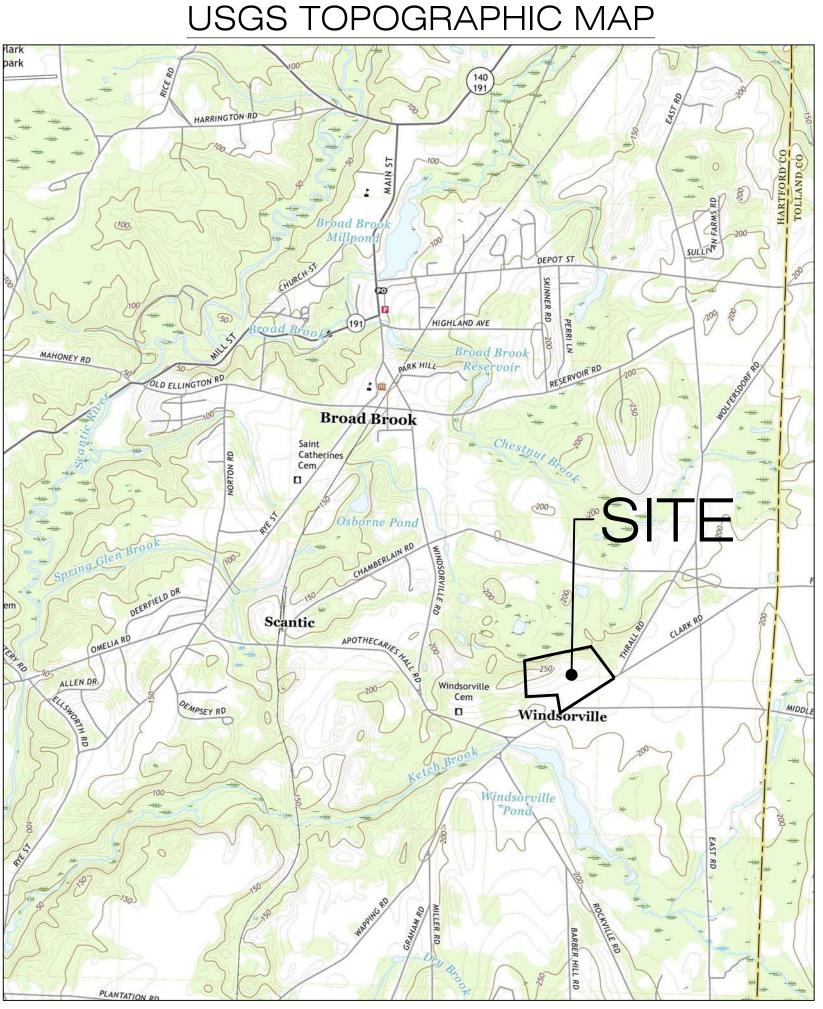

SCALE : 1" = 2000'±

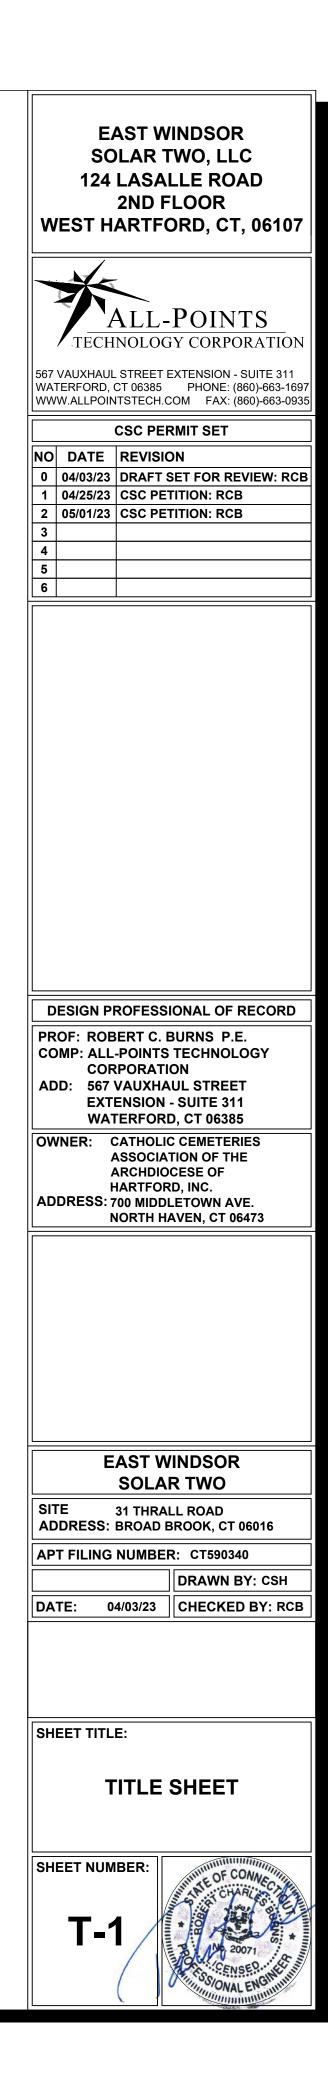

SOURCE: USGS 7.5 BROAD BROOK QUADRANGLE, CT 2021

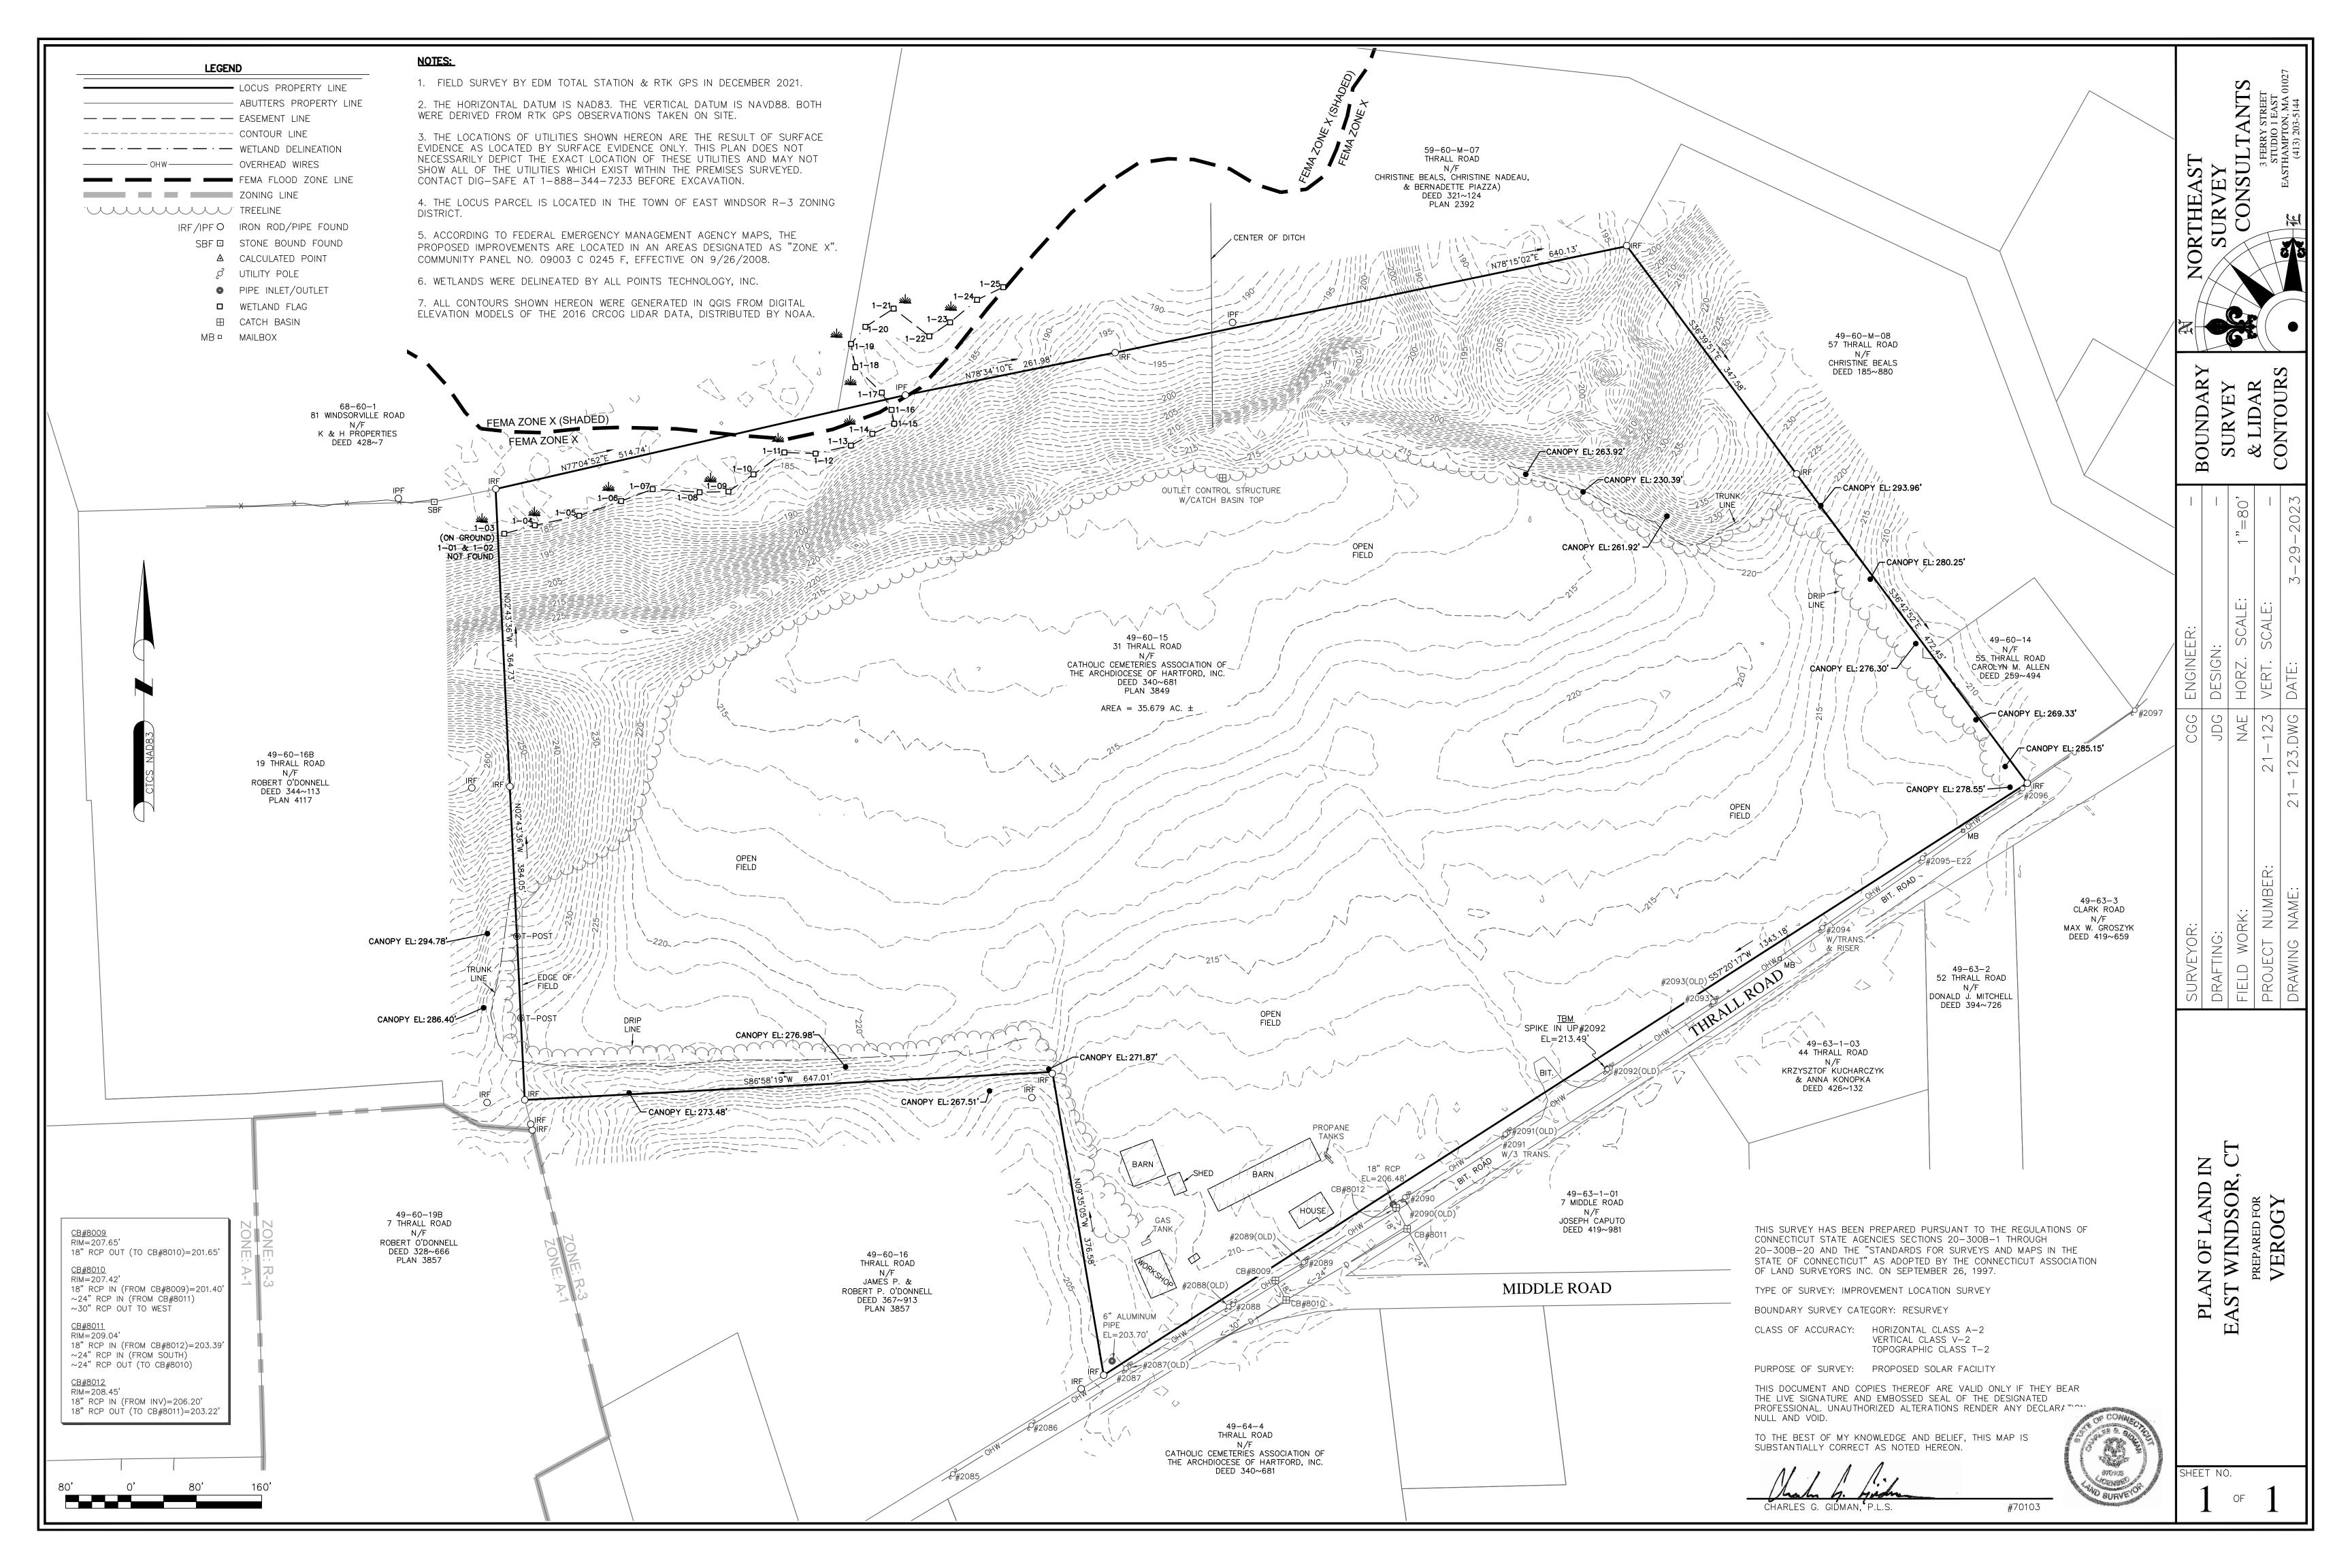

GENERAL NOTES

- ALL CONSTRUCTION SHALL COMPLY WITH PROJECT DEVELOPER STANDARDS, TOWN OF EAST WINDSOR STANDARDS. CONNECTICUT DEPARTMENT OF ENERGY & ENVIRONMENTAL PROTECTION. CONNECTICUT DEPARTMENT OF TRANSPORTATION STANDARDS AND SPECIFICATIONS IN THE ABOVE 2. THERE ARE WETLANDS LOCATED ON THE SITE AS INDICATED ON THE PLANS. WETLAND BOUNDARIES REFERENCED INCREASING HIERARCHY. IF SPECIFICATIONS ARE IN CONFLICT, THE MORE STRINGENT SPECIFICATION SHALL APPLY.
- IF NO PROJECT CONSTRUCTION SPECIFICATION PACKAGE IS PROVIDED BY THE PROJECT DEVELOPER 3. THE CONTRACTOR SHALL FOLLOW THE RECOMMENDED SEQUENCE OF CONSTRUCTION NOTES OR THEIR REPRESENTATIVE, THE CONTRACTOR SHALL COMPLY WITH THE MANUFACTURER, TOWN OF EAST WINDSOR, CONNECTICUT DEPARTMENT OF ENERGY & ENVIRONMENTAL PROTECTION, OR CONNECTICUT DEPARTMENT OF TRANSPORTATION STANDARD SPECIFICATIONS, AND BE IN ACCORDANCE WITH ALL APPLICABLE OSHA, FEDERAL, STATE AND LOCAL REGULATIONS.
- THE PROJECT DEVELOPER IS RESPONSIBLE FOR OBTAINING ALL NECESSARY ZONING AND STORMWATER PERMITS REQUIRED BY GOVERNMENT AGENCIES PRIOR TO CONSTRUCTION. THE CONTRACTOR SHALL OBTAIN ALL EAST WINDSOR CONSTRUCTION PERMITS. THE CONTRACTOR SHALL POST ALL BONDS, PAY ALL FEES, PROVIDE PROOF OF INSURANCE AND PROVIDE TRAFFIC CONTROL NECESSARY FOR THIS WORK.
- REFER TO PLANS, DETAILS AND REPORTS PREPARED BY ALL-POINTS TECHNOLOGY CORPORATION FOR ADDITIONAL INFORMATION. THE CONTRACTOR SHALL VERIFY ALL SITE CONDITIONS IN THE FIELD 5 AND CONTACT THE PROJECT DEVELOPER IF THERE ARE ANY QUESTIONS OR CONFLICTS REGARDING THE CONSTRUCTION DOCUMENTS AND/OR FIELD CONDITIONS SO THAT APPROPRIATE REVISIONS CAN BE MADE PRIOR TO BIDDING/CONSTRUCTION. ANY CONFLICT BETWEEN THE DRAWINGS AND SPECIFICATIONS SHALL BE CONFIRMED WITH THE PROJECT DEVELOPER'S CONSTRUCTION MANAGER PRIOR TO CONSTRUCTION.
- THE CONTRACTOR SHALL SUBMIT SHOP DRAWINGS OF ALL PRODUCTS, MATERIALS PER PLANS AND SPECIFICATIONS TO THE PROJECT DEVELOPER FOR REVIEW AND APPROVAL PRIOR TO FABRICATION OR DELIVERY TO THE SITE. ALLOW A MINIMUM OF 14 WORKING DAYS FOR REVIEW.
- SHOULD ANY UNKNOWN OR INCORRECTLY LOCATED EXISTING PIPING OR OTHER UTILITY BE UNCOVERED DURING EXCAVATION, CONSULT THE PROJECT DEVELOPER IMMEDIATELY FOR DIRECTIONS BEFORE PROCEEDING FURTHER WITH WORK IN THIS AREA.
- DO NOT INTERRUPT EXISTING UTILITIES SERVICING FACILITIES OCCUPIED AND USED BY THE PROJECT DEVELOPER OR OTHERS DURING OCCUPIED HOURS, EXCEPT WHEN SUCH INTERRUPTIONS HAVE BEEN AUTHORIZED IN WRITING BY THE PROJECT DEVELOPER AND THE LOCAL MUNICIPALITY. INTERRUPTIONS SHALL ONLY OCCUR AFTER ACCEPTABLE TEMPORARY SERVICE HAS BEEN PROVIDED.
- THE CONTRACT LIMIT IS THE PROPERTY LINE UNLESS OTHERWISE SPECIFIED OR SHOWN ON THE CONTRACT DRAWINGS.
- THE CONTRACTOR SHALL ABIDE BY ALL OSHA, FEDERAL, STATE AND LOCAL REGULATIONS WHEN OPERATING CRANES, BOOMS, HOISTS, ETC. IN CLOSE PROXIMITY TO OVERHEAD ELECTRIC LINES. IF CONTRACTOR MUST OPERATE EQUIPMENT CLOSE TO ELECTRIC LINES, CONTACT POWER COMPANY TO MAKE ARRANGEMENTS FOR PROPER SAFEGUARDS. ANY UTILITY COMPANY FEES SHALL BE PAID FOR BY THE CONTRACTOR.
- 0. THE CONTRACTOR SHALL COMPLY WITH OSHA CFR 29 PART 1926 FOR EXCAVATION TRENCHING AND TRENCH PROTECTION REQUIREMENTS.
- . THE ENGINEER IS NOT RESPONSIBLE FOR SITE SAFETY MEASURES TO BE EMPLOYED DURING CONSTRUCTION. THE ENGINEER HAS NO CONTRACTUAL DUTY TO CONTROL THE SAFEST METHODS OR MEANS OF THE WORK, JOB SITE RESPONSIBILITIES, SUPERVISION OF PERSONNEL OR TO SUPERVISE SAFETY AND DOES NOT VOLUNTARILY ASSUME ANY SUCH DUTY OR RESPONSIBILITY
- . THE CONTRACTOR SHALL RESTORE ANY DRAINAGE STRUCTURE, PIPE, CONDUIT, PAVEMENT CURBING, SIDEWALKS, LANDSCAPED AREAS OR SIGNAGE DISTURBED DURING CONSTRUCTION TO THEIR ORIGINAL CONDITION OR BETTER, AS APPROVED BY THE PROJECT DEVELOPER OR THE TOWN OF EAST WINDSOR.
- 13. THE CONTRACTOR SHALL PROVIDE AS-BUILT RECORDS OF ALL CONSTRUCTION (INCLUDING UNDERGROUND UTILITIES) TO THE PROJECT DEVELOPER AT THE END OF CONSTRUCTION.
- ALTERNATIVE METHODS AND PRODUCTS, OTHER THAN THOSE SPECIFIED, MAY BE USED IF REVIEWED AND APPROVED BY THE PROJECT DEVELOPER, ENGINEER, AND APPROPRIATE REGULATORY AGENCY PRIOR TO INSTALLATION DURING THE BIDDING/CONSTRUCTION PROCESS.
- 15. INFORMATION ON EXISTING UTILITIES AND STORM DRAINAGE SYSTEMS HAS BEEN COMPILED FROM AVAILABLE INFORMATION INCLUDING UTILITY PROVIDER AND MUNICIPAL RECORD MAPS AND/OR FIELD SURVEY AND IS NOT GUARANTEED CORRECT OR COMPLETE. UTILITIES AND STORM DRAINAGE SYSTEMS ARE SHOWN TO ALERT THE CONTRACTOR TO THEIR PRESENCE AND THE CONTRACTOR IS SOLELY RESPONSIBLE FOR DETERMINING ACTUAL LOCATIONS AND ELEVATIONS OF ALL UTILITIES AND STORM DRAINAGE SYSTEMS INCLUDING SERVICES. PRIOR TO DEMOLITION OR CONSTRUCTION. THE CONTRACTOR SHALL CONTACT "CALL BEFORE YOU DIG" 72 HOURS BEFORE COMMENCEMENT OF WORK AT "811" AND VERIFY ALL UTILITY AND STORM DRAINAGE SYSTEM LOCATIONS.
- 6. NO CONSTRUCTION OR DEMOLITION SHALL BEGIN UNTIL APPROVAL OF THE FINAL PLANS IS GRANTED BY ALL GOVERNING AND REGULATORY AGENCIES.

SITE PLAN NOTES

- THE SURVEY WAS PROVIDED BY NORTHEAST SURVEY CONSULTANTS, DATED MARCH 29, 2023.
- WERE FLAGGED AND LOCATED BY ALL-POINTS TECHNOLOGY CORPORATION, IN MAY 2021.
- PROVIDED ON THE EROSION CONTROL PLAN OR SUBMIT AN ALTERNATE PLAN FOR APPROVAL BY THE ENGINEER AND/OR PERMITTING AGENCIES PRIOR TO THE START OF CONSTRUCTION. ALLOW A MINIMUM OF 14 WORKING DAYS FOR REVIEW.
- 4. PROPER CONSTRUCTION PROCEDURES SHALL BE FOLLOWED ON ALL IMPROVEMENTS WITHIN THIS PARCEL SO AS TO PREVENT THE SILTING OF ANY WATERCOURSE OR WETLANDS IN ACCORDANCE WITH FEDERAL, STATE, AND LOCAL REGULATIONS, IN ADDITION, THE CONTRACTOR SHALL ADHERE TO "EROSION CONTROL PLAN" CONTAINED HEREIN. THE CONTRACTOR SHALL BE RESPONSIBLE TO POST ALL BONDS AS REQUIRED BY GOVERNMENT AGENCIES WHICH WOULD GUARANTEE THE PROPER IMPLEMENTATION OF THE PLAN.
- ALL SITE WORK, MATERIALS OF CONSTRUCTION, AND CONSTRUCTION METHODS FOR EARTHWORK AND STORM DRAINAGE WORK, SHALL CONFORM TO THE SPECIFICATIONS AND DETAILS AND APPLICABLE SECTIONS OF THE PROJECT SPECIFICATIONS MANUAL. OTHERWISE THIS WORK SHALL CONFORM TO THE STATE OF CONNECTICUT DEPARTMENT OF TRANSPORTATION AND PROJECT GEOTECHNICAL REPORT IF THERE IS NO PROJECT SPECIFICATIONS MANUAL. ALL FILL MATERIAL UNDER STRUCTURES AND PAVED AREAS SHALL BE PER THE ABOVE STATED APPLICABLE SPECIFICATIONS, AND/OR PROJECT GEOTECHNICAL REPORT, AND SHALL BE PLACED IN ACCORDANCE WITH THE APPLICABLE SPECIFICATIONS UNDER THE SUPERVISION OF A QUALIFIED PROFESSIONAL ENGINEER. MATERIAL SHALL BE COMPACTED IN 8" LIFTS TO 95% OF THE MAXIMUM DRY DENSITY AS DETERMINED BY ASTM D 1557 AT 95% PERCENT OF OPTIMUM MOISTURE CONTENT.
- 6. ALL DISTURBANCE INCURRED TO PUBLIC, MUNICIPAL, COUNTY, STATE PROPERTY DUE TO CONSTRUCTION SHALL BE RESTORED TO ITS PREVIOUS CONDITION OR BETTER, TO THE SATISFACTION OF THE TOWN OF EAST WINDSOR AND STATE OF CONNECTICUT.
- 7. IF IMPACTED OR CONTAMINATED SOIL IS ENCOUNTERED BY THE CONTRACTOR. THE CONTRACTOR SHALL SUSPEND EXCAVATION WORK OF IMPACTED SOIL AND NOTIFY THE PROJECT DEVELOPER AND/OR PROJECT DEVELOPER'S ENVIRONMENTAL CONSULTANT PRIOR TO PROCEEDING WITH FURTHER WORK IN THE IMPACTED SOIL LOCATION UNTIL FURTHER INSTRUCTED BY THE PROJECT DEVELOPER AND/OR PROJECT DEVELOPER'S ENVIRONMENTAL CONSULTANT.


UTILITY NOTES

- CONTRACTOR IS RESPONSIBLE FOR CONTACTING THE TOWN OF EAST WINDSOR TO SECURE CONSTRUCTION PERMITS AND FOR PAYMENT OF FEES FOR STREET CUTS AND CONNECTIONS TO EXISTING UTILITIES.
- 2. REFER TO DRAWINGS BY PROJECT DEVELOPER FOR THE ONSITE ELECTRICAL DRAWINGS AND INTERCONNECTION TO EXISTING ELECTRICAL GRID. SITE CONTRACTOR SHALL SUPPLY AND INSTALL PIPE ADAPTERS AS NECESSARY AT BUILDING CONNECTION POINT OR AT EXISTING UTILITY OR PIPE CONNECTION POINT. THESE DETAILS ARE NOT INCLUDED IN THESE PLANS.
- 3. UTILITY LOCATIONS AND PENETRATIONS ARE SHOWN FOR THE CONTRACTOR'S INFORMATION AND SHALL BE VERIFIED WITH THE ELECTRICAL ENGINEER AND THE PROJECT DEVELOPER'S CONSTRUCTION MANAGER PRIOR TO THE START OF CONSTRUCTION
- THE CONTRACTOR SHALL VISIT THE SITE AND VERIFY THE ELEVATION AND LOCATION OF ALL UTILITIES BY VARIOUS MEANS PRIOR TO BEGINNING ANY EXCAVATION. TEST PITS SHALL BE DUG AT ALL LOCATIONS WHERE PROP. SANITARY SEWERS AND WHERE PROP. STORM PIPING WILL CROSS EXISTING UTILITIES, AND THE HORIZONTAL AND VERTICAL LOCATIONS OF THE UTILITIES SHALL BE DETERMINED. THE CONTRACTOR SHALL CONTACT THE PROJECT DEVELOPER IN THE EVENT OF ANY DISCOVERED OR UNFORESEEN CONFLICTS BETWEEN EXISTING AND PROPOSED SANITARY SEWERS, STORM PIPING AND UTILITIES SO THAT AN APPROPRIATE MODIFICATION MAY BE MADE.
- 5. UTILITY CONNECTION DESIGN AS REFLECTED ON THE PLAN MAY CHANGE SUBJECT TO UTILITY PROVIDER AND GOVERNING AUTHORITY STAFF REVIEW.
- 6. THE CONTRACTOR SHALL ENSURE THAT ALL UTILITY PROVIDERS AND GOVERNING AUTHORITY STANDARDS FOR MATERIALS AND CONSTRUCTION METHODS ARE MET. THE CONTRACTOR SHALL PERFORM PROPER COORDINATION WITH THE RESPECTIVE UTILITY PROVIDER
- 7. THE CONTRACTOR SHALL ARRANGE FOR AND COORDINATE WITH THE RESPECTIVE UTILITY PROVIDERS FOR SERVICE INSTALLATIONS AND CONNECTIONS. THE CONTRACTOR SHALL COORDINATE WORK TO BE PERFORMED BY THE VARIOUS UTILITY PROVIDERS AND SHALL PAY ALL FEES FOR CONNECTIONS, DISCONNECTIONS, RELOCATIONS, INSPECTIONS, AND DEMOLITION UNLESS OTHERWISE STATED IN THE PROJECT SPECIFICATIONS MANUAL AND/OR GENERAL CONDITIONS OF THE CONTRACT.
- 8. ALL EXISTING PAVEMENT WHERE UTILITY PIPING IS TO BE INSTALLED SHALL BE SAW CUT. AFTER UTILITY INSTALLATION IS COMPLETED, THE CONTRACTOR SHALL INSTALL TEMPORARY AND/OR PERMANENT PAVEMENT REPAIR AS DETAILED ON THE DRAWINGS OR AS REQUIRED BY THE TOWN OF EAST WINDSOR.
- 9. ALL PIPES SHALL BE LAID ON STRAIGHT ALIGNMENTS AND EVEN GRADES USING A PIPE LASER OR OTHER ACCURATE METHOD.
- 10. RELOCATION OF UTILITY PROVIDER FACILITIES, SUCH AS POLES, SHALL BE DONE IN ACCORDANCE WITH THE REQUIREMENTS OF THE UTILITY PROVIDER.
- 11. THE CONTRACTOR SHALL COMPACT PIPE BACKFILL IN 8" LIFTS ACCORDING TO THE PIPE BEDDING DETAILS. TRENCH BOTTOM SHALL BE STABLE IN HIGH GROUNDWATER AREAS. A PIPE FOUNDATION SHALL BE USED PER THE TRENCH DETAILS AND IN AREAS OF ROCK EXCAVATION.
- 12. CONTRACTOR TO PROVIDE STEEL SLEEVES AND ANNULAR SPACE SAND FILL FOR UTILITY PIPE AND CONDUIT CONNECTIONS UNDER FOOTINGS.
- 13. ALL UTILITY CONSTRUCTION IS SUBJECT TO INSPECTION FOR APPROVAL PRIOR TO BACKFILLING, IN ACCORDANCE WITH THE APPROPRIATE UTILITY PROVIDER REQUIREMENTS.
- 14. A ONE-FOOT MINIMUM VERTICAL CLEARANCE BETWEEN WATER, GAS, ELECTRICAL, AND TELEPHONE LINES AND STORM PIPING SHALL BE PROVIDED. A SIX-INCH MINIMUM CLEARANCE SHALL BE MAINTAINED BETWEEN STORM PIPING AND SANITARY SEWER. A 6-INCH TO 18-INCH VERTICAL CLEARANCE BETWEEN SANITARY SEWER PIPING AND STORM PIPING SHALL REQUIRE CONCRETE ENCASEMENT OF THE PROP. SANITARY PIPING.
- 15. THE CONTRACTOR SHALL RESTORE ANY UTILITY STRUCTURE, PIPE, CONDUIT, PAVEMENT, CURBING, SIDEWALKS, DRAINAGE STRUCTURE, SWALE OR LANDSCAPED AREAS DISTURBED DURING CONSTRUCTION, TO THEIR ORIGINAL CONDITION OR BETTER TO THE SATISFACTION OF THE PROJECT DEVELOPER AND THE TOWN OF EAST WINDSOR.
- 16. INFORMATION ON EXISTING UTILITIES AND STORM DRAINAGE HAS BEEN COMPILED FROM AVAILABLE INFORMATION INCLUDING UTILITY PROVIDER AND MUNICIPAL RECORD MAPS AND/OR FIELD SURVEY AND IS NOT GUARANTEED CORRECT OR COMPLETE. UTILITIES AND STORM DRAINAGE ARE SHOWN TO ALERT THE CONTRACTOR TO THEIR PRESENCE. THE CONTRACTOR IS SOLELY RESPONSIBLE FOR DETERMINING ACTUAL LOCATIONS AND ELEVATIONS OF ALL UTILITIES AND STORM DRAINAGE INCLUDING SERVICES. CONTACT "CALL BEFORE YOU DIG" AT 811 72 HOURS PRIOR TO CONSTRUCTION AND VERIFY ALL UNDERGROUND AND OVERHEAD UTILITY AND STORM DRAINAGE LOCATIONS. THE CONTRACTOR SHALL EMPLOY THE USE OF A UTILITY LOCATING COMPANY TO PROVIDE SUBSURFACE UTILITY ENGINEERING CONSISTING OF DESIGNATING UTILITIES AND STORM PIPING ON PRIVATE PROPERTY WITHIN THE CONTRACT LIMIT AND CONSISTING OF DESIGNATING AND LOCATING WHERE PROP. UTILITIES AND STORM PIPING CROSS EXISTING UTILITIES AND STORM PIPING WITHIN THE CONTRACT LIMITS.
- 17. THE CONTRACTOR SHALL ARRANGE AND COORDINATE WITH UTILITY PROVIDERS FOR WORK TO BE PERFORMED BY UTILITY PROVIDERS. THE CONTRACTOR SHALL PAY ALL UTILITY FEES UNLESS OTHERWISE STATED IN THE PROJECT SPECIFICATION MANUAL AND GENERAL CONDITIONS, AND REPAIR PAVEMENTS AS NECESSARY.
- 18. ELECTRIC DRAWINGS AND REQUIREMENTS ARE NOT INCLUDED AS PART OF THIS DRAWING SET AND SHOULD BE OBTAINED FROM THE PROJECT DEVELOPER.
- 19. ALTERNATIVE METHODS AND PRODUCTS OTHER THAN THOSE SPECIFIED MAY BE USED IF REVIEWED AND APPROVED BY THE PROJECT DEVELOPER, ENGINEER, AND APPROPRIATE REGULATORY AGENCIES PRIOR TO INSTALLATION.
- 20. THE CONTRACTOR SHALL MAINTAIN ALL FLOWS AND UTILITY CONNECTIONS TO EXISTING BUILDINGS WITHOUT INTERRUPTION UNLESS/UNTIL AUTHORIZED TO DISCONNECT BY THE PROJECT DEVELOPER. TOWN OF EAST WINDSOR, UTILITY PROVIDERS AND GOVERNING AUTHORITIES.

PROPERTY LINE
BUILDING SETBACK
EASEMENT
TREE LINE
WETLAND
WETLAND BUFFER
VERNAL POOL
VERNAL POOL BUFFER
WATERCOURSE
WATERCOURSE BUFFER
LIMIT OF PLOWED AREA
MAJOR CONTOUR
MINOR CONTOUR
UNDERGROUND ELECTRIC
OVERHEAD ELECTRI
BASIN
FENCE
LIMIT OF DISTURBANCE

SILT FENCE

(GENERAL LEG	END	EAST WINDSOR SOLAR TWO, LLC 124 LASALLE ROAD
	EXISTING	PROPOSED	2ND FLOOR WEST HARTFORD, CT, 06107
<			ALL-POINTS
			TECHNOLOGY CORPORATION
			WATERFORD, CT 06385 PHONE: (860)-663-16 WWW.ALLPOINTSTECH.COM FAX: (860)-663-09
3			CSC PERMIT SET
			0 04/03/23 DRAFT SET FOR REVIEW: RC 1 04/25/23 CSC PETITION: RCB 2 05/01/23 CSC PETITION: RCB
			3 4
			5 6
	· · ·		
ł			
		EE	
IC	OHW	—— он —— он ——	
		X X	
		SFSF	
			DESIGN PROFESSIONAL OF RECORD
			PROF: ROBERT C. BURNS P.E. COMP: ALL-POINTS TECHNOLOGY CORPORATION ADD: 567 VAUXHAUL STREET EXTENSION - SUITE 311
			WATERFORD, CT 06385 OWNER: CATHOLIC CEMETERIES
			ASSOCIATION OF THE ARCHDIOCESE OF HARTFORD, INC. ADDRESS: 700 MIDDLETOWN AVE. NORTH HAVEN, CT 06473
			EAST WINDSOR
			SOLAR TWO SITE 31 THRALL ROAD ADDRESS: BROAD BROOK, CT 06016
			APT FILING NUMBER: CT590340
			DRAWN BY: CSH
			GENERAL NOTES

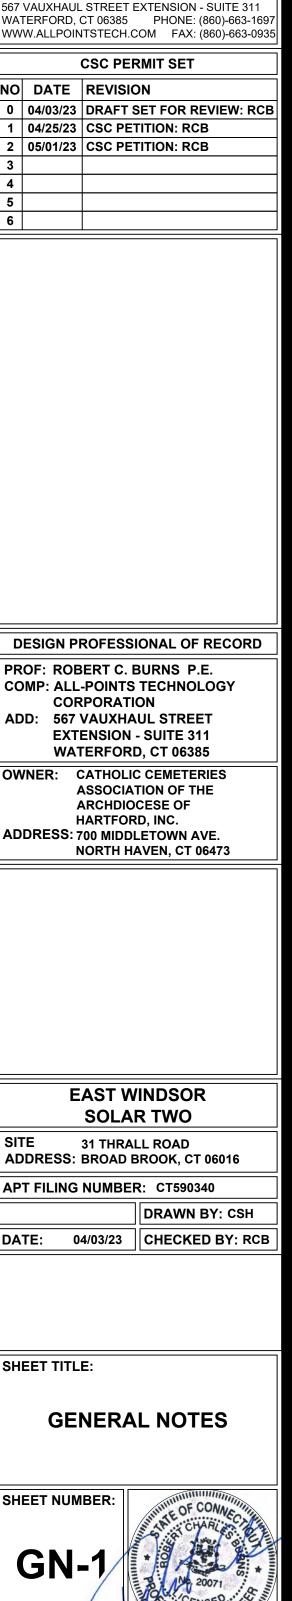

ENVIRONMENTAL NOTES RESOURCE PROTECTION MEASURES

RESOURCE PROTECTION PROGRAM

AS A RESULT OF THE FACILITY'S LOCATION IN THE VICINITY OF SENSITIVE WETLAND AND VERNAL POOL HABITAT THE FOLLOWING PROXIMATE WETLAND RESOURCES OR MORTALITY TO VERNAL POOL HERPETOFAUNA (I.E., WOOD FROG, SALAMANDERS, TURTLES, ETC.) DURING CONSTRUCTION ACTIVITIES. THE VERNAL POOL SPECIFIC PROTECTION MEASURES SHALL BE IMPLEMENTED SHOULD CONSTRUCTION ACTIVITIES OCCUR DURING PEAK AMPHIBIAN MOVEMENT PERIODS (EARLY SPRING BREEDING [MARCH 1ST TO MAY 15TH] AND LATE SUMMER DISPERSAL [JULY 15TH TO SEPTEMBER 15TH]). PROTECTION MEASURES ASSOCIATED WITH WETLANDS SHALL BE IMPLEMENTED SHOULD CONSTRUCTION ACTIVITIES. THE VERNAL POOL SPECIFIC PROTECTION MEASURES SHALL BE IMPLEMENTED SHOULD CONSTRUCTION MEASURES ASSOCIATED WITH WETLANDS SHALL BE IMPLEMENTED REGARDLESS OF THE TIME OF YEAR.

IT IS OF THE UTMOST IMPORTANCE THAT THE CONTRACTORS PERFORMING WORK ON THE PROJECT SITE. THE WETLAND AND VERNAL POOL PROTECTION MEASURES AND THE PROJECT SITE. THE WETLAND AND VERNAL POOL PROTECTION MEASURES AND THE PROJECT SITE. THE WETLAND AND VERNAL POOL PROTECTION MEASURES AND THE PROJECT SITE. THE WETLAND AND VERNAL POOL PROTECTION OF ITS EMPLOYEES AND THE INSTALLATION OF ITS EMPLOYEES AND THE INSTALLATION OF ITS EMPLOYEES AND THE PROJECT SITE. THE WETLAND AND VERNAL POOL PROTECTION MEASURES SHALL BE IMPLEMENTED AND MAINTAINED THROUGHOUT THE DURATION OF CONSTRUCTION ACTIVITIES UNTIL PERMANENT STABILIZATION OF SITE SOILS HAS OCCURRED.

ALL. POINTS TECHNOLOGY CORPORATION, P.C. ("APT") WILL SERVE AS THE ENVIRONMENTAL MONITOR FOR THIS PROJECT'S PROXIMITY TO SENSITIVE WETLANDS AND ASSOCIATED VERNAL POOL HERPETOFAUNA PRIOR TO THE START OF CONSTRUCTION ACTIVITIES THE CONTRACTOR SHALL CONTACT DEAN GUSTAFSON, SENIOR WETLAND SCIENTIST AT APT, AT LEAST 5 BUSINESS DAYS PRIOR TO THE PRE CONSTRUCTION MEETING, MR. GUSTAFSON CAN BE REACHED BY PHONE AT (860) 552-2033 OR VIA EMAIL AT DGUSTAFSON@ALLPOINTSTECH.COM.

THIS RESOURCE PROTECTION PROGRAM CONSISTS OF SEVERAL COMPONENTS INCLUDING: EDUCATION OF ALL CONTRACTORS AND SUB **RESTRICTIONS: AND REPORTING.**

1. CONTRACTOR EDUCATION:

- REPRESENTATIVE PHOTOGRAPHS OF TYPICAL HERPETOFAUNA THAT MAY BE ENCOUNTERED, TYPICAL SPECIES BEHAVIOR, AND PROPER PROCEDURES IF SPECIES ARE ENCOUNTERED, AND THE ENVIRONMENTALLY SENSITIVE NATURE OF THE DEVELOPMENT SITE.
- B. THE CONTRACTOR'S PROJECT MONITOR WILL BE PROVIDED WITH CELL PHONE AND EMAIL CONTACTS FOR APT PERSONNEL. EDUCATIONAL POSTER MATERIALS WILL BE PROVIDED BY APT AND DISPLAYED ON THE JOB SITE TO MAINTAIN WORKER AWARENESS AS THE PROJECT PROGRESSES
- C. APT WILL ALSO POST CAUTION SIGNS THROUGHOUT THE PROJECT SITE FOR THE DURATION OF THE CONSTRUCTION PROJECT PROVIDING NOTICE OF THE ENVIRONMENTALLY SENSITIVE NATURE OF THE WORK AREA.

2. EROSION AND SEDIMENTATION CONTROLS/ISOLATION BARRIERS

- BIODEGRADABLE FIBER TO AVOID/MINIMIZE WILDLIFE ENTANGLEMENT.
- AT THE DISCRETION OF THE ENVIRONMENTAL MONITOR.
- BARRIERS WILL BE POSITIONED TO DEFLECT MIGRATING/DISPERSAL ROUTES AWAY FROM THE WORK ZONE TO MINIMIZE POTENTIAL ENCOUNTERS WITH HERPETOFAUNA AT THE DISCRETION OF THE ENVIRONMENTAL MONITOR.
- THE REQUEST OF REGULATORY AGENCIES. IF THE ENVIRONMENTAL MONITOR IS NOTIFIED BY THE CONTRACTOR OF A SEDIMENT RELEASE, AN INSPECTION WILL BE SCHEDULED SPECIFICALLY TO INVESTIGATE AND EVALUATE POSSIBLE IMPACTS TO WETLAND RESOURCES.
- E. THIRD PARTY MONITORING OF SEDIMENTATION AND EROSION CONTROLS WILL BE PERFORMED BY OTHER PARTIES, AS NECESSARY, UNDER APPLICABLE LOCAL, STATE AND/OR FEDERAL REGULATIONS AND PERMIT CONDITIONS.
- F. NO EQUIPMENT, VEHICLES OR CONSTRUCTION MATERIALS SHALL BE STORED WITHIN 100 FEET OF WETLAND RESOURCES.
- SOILS ARE STABLE SO AS NOT TO CREATE A BARRIER TO WILDLIFE MOVEMENT. SEED FROM SEEDING OF SOILS SHOULD NOT SPREAD OVER FIBER ROLLS/WATTLES AS IT MAKES THEM HARDER TO REMOVE ONCE SOILS ARE STABILIZED BY VEGETATION.

3. PETROLEUM MATERIALS STORAGE AND SPILL PREVENTION

- A. CERTAIN PRECAUTIONS ARE NECESSARY TO STORE PETROLEUM MATERIALS, REFUEL AND CONTAIN AND PROPERLY CLEAN UP ANY INADVERTENT FUEL OR PETROLEUM (I.E., OIL, HYDRAULIC FLUID, ETC.) SPILL DUE TO THE PROJECT'S LOCATION IN PROXIMITY TO WETLAND RESOURCES.
- ACCORDANCE WITH APPLICABLE LOCAL, STATE AND FEDERAL LAWS.
- C. SERVICING OF MACHINERY SHALL NOT OCCUR WITHIN 100 FEET OF WETLANDS.
- D. AT A MINIMUM, THE FOLLOWING PETROLEUM AND HAZARDOUS MATERIALS STORAGE AND REFUELING RESTRICTIONS AND SPILL RESPONSE PROCEDURES WILL BE ADHERED TO BY THE CONTRACTOR. I. PETROLEUM AND HAZARDOUS MATERIALS STORAGE AND REFUELING
- 1. REFUELING OF VEHICLES OR MACHINERY SHALL OCCUR A MINIMUM OF 100 FEET FROM WETLANDS AND SHALL TAKE PLACE ON AN IMPERVIOUS PAD WITH SECONDARY CONTAINMENT DESIGNED TO CONTAIN FUELS. 2. ANY FUEL OR HAZARDOUS MATERIALS THAT MUST BE KEPT ON SITE SHALL BE STORED ON AN IMPERVIOUS SURFACE UTILIZING SECONDARY CONTAINMENT A MINIMUM OF 100 FEET FROM WETLANDS.
- II. INITIAL SPILL RESPONSE PROCEDURES
- 1. STOP OPERATIONS AND SHUT OFF EQUIPMENT.
- 2. REMOVE ANY SOURCES OF SPARK OR FLAME. 3. CONTAIN THE SOURCE OF THE SPILL.
- 4. DETERMINE THE APPROXIMATE VOLUME OF THE SPILL
- 5. IDENTIFY THE LOCATION OF NATURAL FLOW PATHS TO PREVENT THE RELEASE OF THE SPILL TO SENSITIVE NEARBY WETLANDS AND VERNAL POOL 6. ENSURE THAT FELLOW WORKERS ARE NOTIFIED OF THE SPILL.
- III. SPILL CLEAN UP & CONTAINMENT
- 1. OBTAIN SPILL RESPONSE MATERIALS FROM THE ON SITE SPILL RESPONSE KIT. PLACE ABSORBENT MATERIALS DIRECTLY ON THE RELEASE AREA.
- 2. LIMIT THE SPREAD OF THE SPILL BY PLACING ABSORBENT MATERIALS AROUND THE PERIMETER OF THE SPILL. 3. ISOLATE AND ELIMINATE THE SPILL SOURCE.
- 4. CONTACT APPROPRIATE LOCAL, STATE AND/OR FEDERAL AGENCIES, AS NECESSARY.
- 5. CONTACT A DISPOSAL COMPANY TO PROPERLY DISPOSE OF CONTAMINATED MATERIALS.

IV. REPORTING

- 1. COMPLETE AN INCIDENT REPORT.
- 2. SUBMIT A COMPLETED INCIDENT REPORT TO LOCAL, STATE AND FEDERAL AGENCIES, AS NECESSARY, INCLUDING THE CONNECTICUT SITING COUNCIL

4. WETLAND AND VERNAL POOL PROTECTIVE MEASURES

- WORK ZONE IN THE GENERAL DIRECTION THE ANIMAL WAS ORIENTED. PERIODIC INSPECTIONS WILL BE PERFORMED BY APT'S ENVIRONMENTAL MONITOR THROUGHOUT THE DURATION OF THE CONSTRUCTION.
- CHANGES WILL BE REVIEWED BY THE DESIGN ENGINEER TO ENSURE STORMWATER MANAGEMENT FUNCTIONS ARE MAINTAINED.
- C. EROSION CONTROL MEASURES WILL BE REMOVED NO LATER THAN 30 DAYS FOLLOWING FINAL SITE STABILIZATION SO AS NOT TO IMPEDE MIGRATION OF HERPETOFAUNA OR OTHER WILDLIFE.

5. HERBICIDE, PESTICIDE, AND SALT RESTRICTIONS

- B. MAINTENANCE OF THE FACILITY DURING THE WINTER MONTHS SHALL NOT INCLUDE THE APPLICATION OF SALT OR SIMILAR PRODUCTS FOR MELTING SNOW OR ICE.
- 6. REPORTING

 - COUNCIL FOR COMPLIANCE VERIFICATION.

A. PRIOR TO WORK ON SITE AND INITIAL DEPLOYMENT/MOBILIZATION OF EQUIPMENT AND MATERIALS, THE CONSTRUCTION AND EDUCATIONAL SESSION WILL CONSIST OF INFORMATION SUCH AS, BUT NOT LIMITED TO: IDENTIFICATION OF WETLAND RESOURCES PROXIMATE TO WORK AREAS,

A. PLASTIC NETTING USED IN A VARIETY OF EROSION CONTROL PRODUCTS (I.E., EROSION CONTROL BLANKETS, FIBER ROLLS [WATTLES], REINFORCED SILT FENCE) HAS BEEN FOUND TO ENTANGLE WILDLIFE, INCLUDING REPTILES, AMPHIBIANS, BIRDS AND SMALL MAMMALS. NO PERMANENT EROSION CONTROL PRODUCTS (I.E., EROSION CONTROL BLANKETS, FIBER ROLLS [WATTLES], REINFORCED SILT FENCE) HAS BEEN FOUND TO ENTANGLE WILDLIFE, INCLUDING REPTILES, AMPHIBIANS, BIRDS AND SMALL MAMMALS. NO PERMANENT EROSION CONTROL PRODUCTS (I.E., EROSION CONTROL PRODUCTS (I.E., EROSION CONTROL BLANKETS, FIBER ROLLS [WATTLES], REINFORCED SILT FENCE) HAS BEEN FOUND TO ENTANGLE WILDLIFE, INCLUDING REPTILES, AMPHIBIANS, BIRDS AND SMALL MAMMALS. NO PERMANENT EROSION CONTROL PRODUCTS (I.E., EROSION CONTROL PRODUCTS (I.E EROSION CONTROL PRODUCTS THAT WILL BE EXPOSED AT THE GROUND SURFACE AND REPRESENT A POTENTIAL FOR WILDLIFE ENTANGLEMENT WILL BE EXPOSED OF PROCESSED FIBERS MECHANICALLY BOUND TOGETHER TO FORM A CONTINUOUS MATRIX (NETLESS) OR NETTING COMPOSED OF PLANAR WOVEN NATURAL

B. THE EXTENT OF THE EROSION CONTROLS WILL BE AS SHOWN ON THE SITE PLANS. THE CONTRACTOR SHALL HAVE ADDITIONAL SEDIMENTATION AND EROSION CONTROLS WILL BE AS SHOWN ON THE SITE PLANS. THE CONTRACTOR SHALL HAVE ADDITIONAL SEDIMENTATION AND EROSION CONTROLS WILL BE AS SHOWN ON THE SITE PLANS. THE CONTRACTOR SHALL HAVE ADDITIONAL SEDIMENTATION AND EROSION CONTROLS WILL BE AS SHOWN ON THE SITE PLANS. THE CONTRACTOR SHALL HAVE ADDITIONAL SEDIMENTATION AND EROSION CONTROLS WILL ALSO BE

C. INSTALLATION OF EROSION AND SEDIMENTATION CONTROLS, REQUIRED FOR EROSION CONTROL COMPLIANCE AND CREATION OF A BARRIER TO POSSIBLE MIGRATING/DISPERSING HERPETOFAUNA (ONLY APPLICABLE DURING THE SEASONAL RESTRICTION OF A BARRIER TO POSSIBLE MIGRATING/DISPERSING HERPETOFAUNA (ONLY APPLICABLE DURING THE SEASONAL RESTRICTION OF A BARRIER TO POSSIBLE MIGRATING/DISPERSING HERPETOFAUNA (ONLY APPLICABLE DURING THE SEASONAL RESTRICTION OF A BARRIER TO POSSIBLE MIGRATING/DISPERSING HERPETOFAUNA (ONLY APPLICABLE DURING THE SEASONAL RESTRICTION OF A BARRIER TO POSSIBLE MIGRATING/DISPERSING HERPETOFAUNA (ONLY APPLICABLE DURING THE SEASONAL RESTRICTION OF A BARRIER TO POSSIBLE MIGRATING/DISPERSING HERPETOFAUNA (ONLY APPLICABLE DURING THE SEASONAL RESTRICTION OF A BARRIER TO POSSIBLE MIGRATING/DISPERSING HERPETOFAUNA (ONLY APPLICABLE DURING THE SEASONAL RESTRICTION OF A BARRIER TO POSSIBLE MIGRATING/DISPERSING HERPETOFAUNA (ONLY APPLICABLE DURING THE SEASONAL RESTRICTION OF A BARRIER TO POSSIBLE MIGRATING/DISPERSING HERPETOFAUNA (ONLY APPLICABLE DURING THE SEASONAL RESTRICTION OF A BARRIER TO POSSIBLE MIGRATING/DISPERSING HERPETOFAUNA (ONLY APPLICABLE DURING THE SEASONAL RESTRICTION OF A BARRIER TO POSSIBLE MIGRATING/DISPERSING HERPETOFAUNA (ONLY APPLICABLE DURING THE SEASONAL RESTRICTION OF A BARRIER TO POSSIBLE MIGRATING/DISPERSING HERPETOFAUNA (ONLY APPLICABLE DURING THE SEASONAL RESTRICTION OF A BARRIER TO POSSIBLE MIGRATING/DISPERSING HERPETOFAUNA (ONLY APPLICABLE DURING THE SEASONAL RESTRICTION OF A BARRIER TO POSSIBLE MIGRATING/DISPERSING HERPETOFAUNA (ONLY APPLICABLE DURING THE SEASONAL RESTRICTION OF A BARRIER TO POSSIBLE MIGRATING/DISPERSING HERPETOFAUNA (ONLY APPLICABLE DURING THE SEASONAL RESTRICTION OF A BARRIER TO POSSIBLE MIGRATING/DISPERSING HERPETOFAUNA (ONLY APPLICABLE DURING SOIL DISTURBANCE OCCURS OR HEAVY MACHINERY IS ANTICIPATED. THE ENVIRONMENTAL MONITOR WILL INSPECT THE WORK ZONES IN PROXIMITY TO VERNAL POOL RESOURCES WILL BE INSPECTED PRIOR TO AND FOLLOWING EROSION CONTROL BARRIER INSTALLATION. IN ADDITION, WORK ZONES IN PROXIMITY TO VERNAL POOL RESOURCES WILL BE INSPECTED PRIOR TO AND FOLLOWING EROSION CONTROL BARRIER INSTALLATION. IN ADDITION, WORK ZONES IN PROXIMITY TO VERNAL POOL RESOURCES WILL BE INSPECTED PRIOR TO AND FOLLOWING EROSION CONTROL BARRIER INSTALLATION. IN ADDITION, WORK ZONES IN PROXIMITY TO VERNAL POOL RESOURCES WILL BE INSPECTED PRIOR TO AND FOLLOWING EROSION CONTROL BARRIER INSTALLATION. IN ADDITION, WORK ZONES IN PROXIMITY TO VERNAL POOL RESOURCES WILL BE INSPECTED PRIOR TO AND FOLLOWING EROSION CONTROL BARRIER INSTALLATION. IS FREE OF HERPETOFAUNA AND SATISFACTORILY INSTALLED. THE INTENT OF THE BARRIER IS TO SEGREGATE THE MAJORITY OF THE BARRIER IS TO SEGREGATE THE MAJORITY OF THE WORK ZONE FROM MIGRATING/DISPERSING HERPETOFAUNA. OFTENTIMES COMPLETE ISOLATION OF A WORK ZONE IS NOT FEASIBLE DUE TO ACCESSIBILITY NEEDS AND LOCATIONS OF STAGING/MATERIAL STORAGE AREAS, ETC. IN THOSE CIRCUMSTANCES, THE

D. THE CONTRACTOR SHALL BE RESPONSIBLE FOR DAILY INSPECTIONS OF THE SEDIMENTATION AND EROSION CONTROLS FOR TEARS OR BREACHES AND ACCUMULATION LEVELS OF SEDIMENT, PARTICULARLY FOLLOWING STORM EVENTS THAT GENERATE A DISCHARGE, AS DEFINED BY AND IN ACCORDANCE WITH APPLICABLE LOCAL, STATE AND FEDERAL REGULATIONS. THE CONTRACTOR SHALL NOTIFY THE APT ENVIRONMENTAL MONITOR WITHIN 24 HOURS OF ANY BREACHES OF THE SEDIMENTATION AND EROSION CONTROLS AND ANY SEDIMENTATION AND ANY SEDIMENTATION AND ANY SEDIMENTATION EROSION CONTROLS THROUGHOUT THE DURATION OF CONSTRUCTION ACTIVITIES ONLY AS IT PERTAINS TO THEIR FUNCTION TO PROTECT NEARBY WETLANDS. SUCH INSPECTIONS WILL GENERALLY OCCUR ONCE PER MONTH. THE FREQUENCY OF MONITORING MAY INCREASE DEPENDING UPON SITE CONDITIONS, LEVEL OF CONSTRUCTION ACTIVITIES IN PROXIMITY TO SENSITIVE RECEPTORS, OR AT

G. ALL SILT FENCING AND OTHER EROSION CONTROL DEVICES SHALL BE REMOVED WITHIN 30 DAYS OF COMPLETION OF SITE SOILS. IF FIBER ROLLS/WATTLES, STRAW BALES, OR OTHER NATURAL MATERIAL EROSION CONTROL PRODUCTS ARE USED, SUCH DEVICES WILL NOT BE LEFT IN PLACE TO BIODEGRADE AND SHALL BE PROMPTLY REMOVED AFTER

B. A SPILL CONTAINMENT KIT CONSISTING OF A SUFFICIENT SUPPLY OF ABSORBENT PADS AND TIMELY DISPOSAL OFF SITE IN


A. A THOROUGH COVER SEARCH OF THE CONSTRUCTION AREA WILL BE PERFORMED BY APT'S ENVIRONMENTAL MONITOR FOR HERPETOFAUNA PRIOR TO AND FOLLOWING INSTALLATION OF THE SILT FENCING BARRIER TO REMOVE ANY SPECIES FROM THE WORK ZONE PRIOR TO THE INITIATION OF CONSTRUCTION ACTIVITIES. ANY HERPETOFAUNA PRIOR TO AND FOLLOWING INSTALLATION OF THE SILT FENCING BARRIER TO REMOVE ANY SPECIES FROM THE WORK ZONE PRIOR TO THE INITIATION OF CONSTRUCTION AREA WILL BE PERFORMED BY APT'S ENVIRONMENTAL MONITOR FOR HERPETOFAUNA PRIOR TO THE INITIATION OF CONSTRUCTION ACTIVITIES. ANY HERPETOFAUNA PRIOR TO THE INITIATION OF CONSTRUCTION ACTIVITIES.

B. ANY RUTS OR ARTIFICIAL DEPRESSIONS THAT COULD HOLD WATER CREATED INTENTIONALLY OR UNINTENTIONALLY BY SITE CLEARING/CONSTRUCTION ACTIVITIES WILL BE PROPERLY FILLED IN AND PERMANENTLY STABILIZED WITH VEGETATION OF VERNAL POOLS. STORMWATER MANAGEMENT FEATURES SUCH AS LEVEL SPREADERS WILL BE CAREFULLY REVIEWED IN THE FIELD TO ENSURE THAT STANDING WATER DOES NOT ENDURE FOR MORE THAN A 24 HOUR PERIOD, WHERE FEASIBLE AT THE DISCRETION OF THE ENVIRONMENTAL MONITOR, TO AVOID CREATION OF DECOY POOLS AND MAY BE SUBJECT TO FIELD DESIGN CHANGES. ANY SUCH PROPOSED DESIGN

A. THE USE OF HERBICIDES AND PESTICIDES AT THE FACILITY SHALL BE MINIMIZED. IF HERBICIDES AND/OR PESTICIDES ARE REQUIRED AT THE FACILITY, THEIR USE WITH PARTICULAR ATTENTION TO AVOID/MINIMIZE APPLICATIONS WITHIN 100 FEET OF WETLAND AND VERNAL POOL RESOURCES.


A. COMPLIANCE MONITORING REPORTS (BRIEF NARRATIVE AND APPLICABLE PHOTOS) DOCUMENTING EACH APT INSPECTION WILL BE SUBMITTED BY APT TO THE PERMIT AGENCY APPROVAL CONDITIONS (I.E., DEEP STORMWATER PERMIT MONITORING, ETC.). ANY NON-COMPLIANCE OBSERVATIONS OF EROSION CONTROL MEASURES OR EVIDENCE OF EROSION OR SEDIMENT RELEASE WILL BE IMMEDIATELY REPORTED TO THE PERMITTEE AND ITS CONTRACTOR AND INCLUDED IN THE REPORTED TO THE PERMITTEE AND ITS CONTRACTOR AND INCLUDED IN THE REPORTED TO THE PERMITTEE AND ITS CONTRACTOR AND INCLUDED IN THE REPORTED TO THE PERMITTEE AND ITS CONTRACTOR AND INCLUDED IN THE REPORTED TO THE PERMITTEE AND ITS CONTRACTOR AND INCLUDED IN THE REPORTED TO THE PERMITTEE AND ITS CONTRACTOR AND INCLUDED IN THE REPORTED TO THE PERMITTEE AND ITS CONTRACTOR AND INCLUDED IN THE REPORTED TO THE PERMITTEE AND ITS CONTRACTOR AND INCLUDED IN THE REPORTED TO THE PERMITTEE AND ITS CONTRACTOR AND INCLUDED IN THE REPORTED TO THE PERMITTEE AND ITS CONTRACTOR AND INCLUDED IN THE REPORTED TO THE PERMITTEE AND ITS CONTRACTOR AND INCLUDED IN THE REPORTED TO THE PERMITTEE AND ITS CONTRACTOR AND INCLUDED IN THE REPORTED TO THE PERMITTEE AND ITS CONTRACTOR AND INCLUDED IN THE REPORTED TO THE PERMITTEE AND ITS CONTRACTOR AND INCLUDED IN THE REPORTED TO THE PERMITTEE AND ITS CONTRACTOR AND INCLUDED IN THE REPORTED TO THE PERMITTEE AND ITS CONTRACTOR AND INCLUDED IN THE REPORTED TO THE PERMITTEE AND ITS CONTRACTOR AND INCLUDED IN THE REPORTED TO THE PERMITTEE AND INCLUDED IN THE REPORTED TO THE PERMITTEE AND INCLUDED IN THE REPORTED TO THE PERMITTEE AND INCLUDED IN THE PERMIT B. FOLLOWING COMPLETION OF THE CONSTRUCTION PROJECT, APT WILL PROVIDE A FINAL COMPLIANCE MONITORING REPORT TO THE RESOURCE PROTECTION OF THE RESOURCE PROTECTION OF

EAST WINDSOR SOLAR TWO, LLC 124 LASALLE ROAD 2ND FLOOR WEST HARTFORD, CT, 06107
ALL-POINTS TECHNOLOGY CORPORATION 567 VAUXHAUL STREET EXTENSION - SUITE 311 WATERFORD, CT 06385 PHONE: (860)-663-1697 WWW.ALLPOINTSTECH.COM FAX: (860)-663-0935
CSC PERMIT SET NO DATE REVISION 0 04/03/23 DRAFT SET FOR REVIEW: RCB 1 04/25/23 CSC PETITION: RCB 2 05/01/23 CSC PETITION: RCB 3
DESIGN PROFESSIONAL OF RECORD PROF: ROBERT C. BURNS P.E. COMP: ALL-POINTS TECHNOLOGY CORPORATION
ADD: 567 VAUXHAUL STREET EXTENSION - SUITE 311 WATERFORD, CT 06385 OWNER: CATHOLIC CEMETERIES ASSOCIATION OF THE ARCHDIOCESE OF HARTFORD, INC. ADDRESS: 700 MIDDLETOWN AVE. NORTH HAVEN, CT 06473
EAST WINDSOR SOLAR TWO SITE 31 THRALL ROAD ADDRESS: BROAD BROOK, CT 06016 APT FILING NUMBER: CT590340 DRAWN BY: CSH DATE: 04/03/23 CHECKED BY: RCB
SHEET TITLE: ENVIRONMENTAL NOTES RESOURCE PROTECTION MEASURES
SHEET NUMBER: OF CONNECTION OF CONNECTION

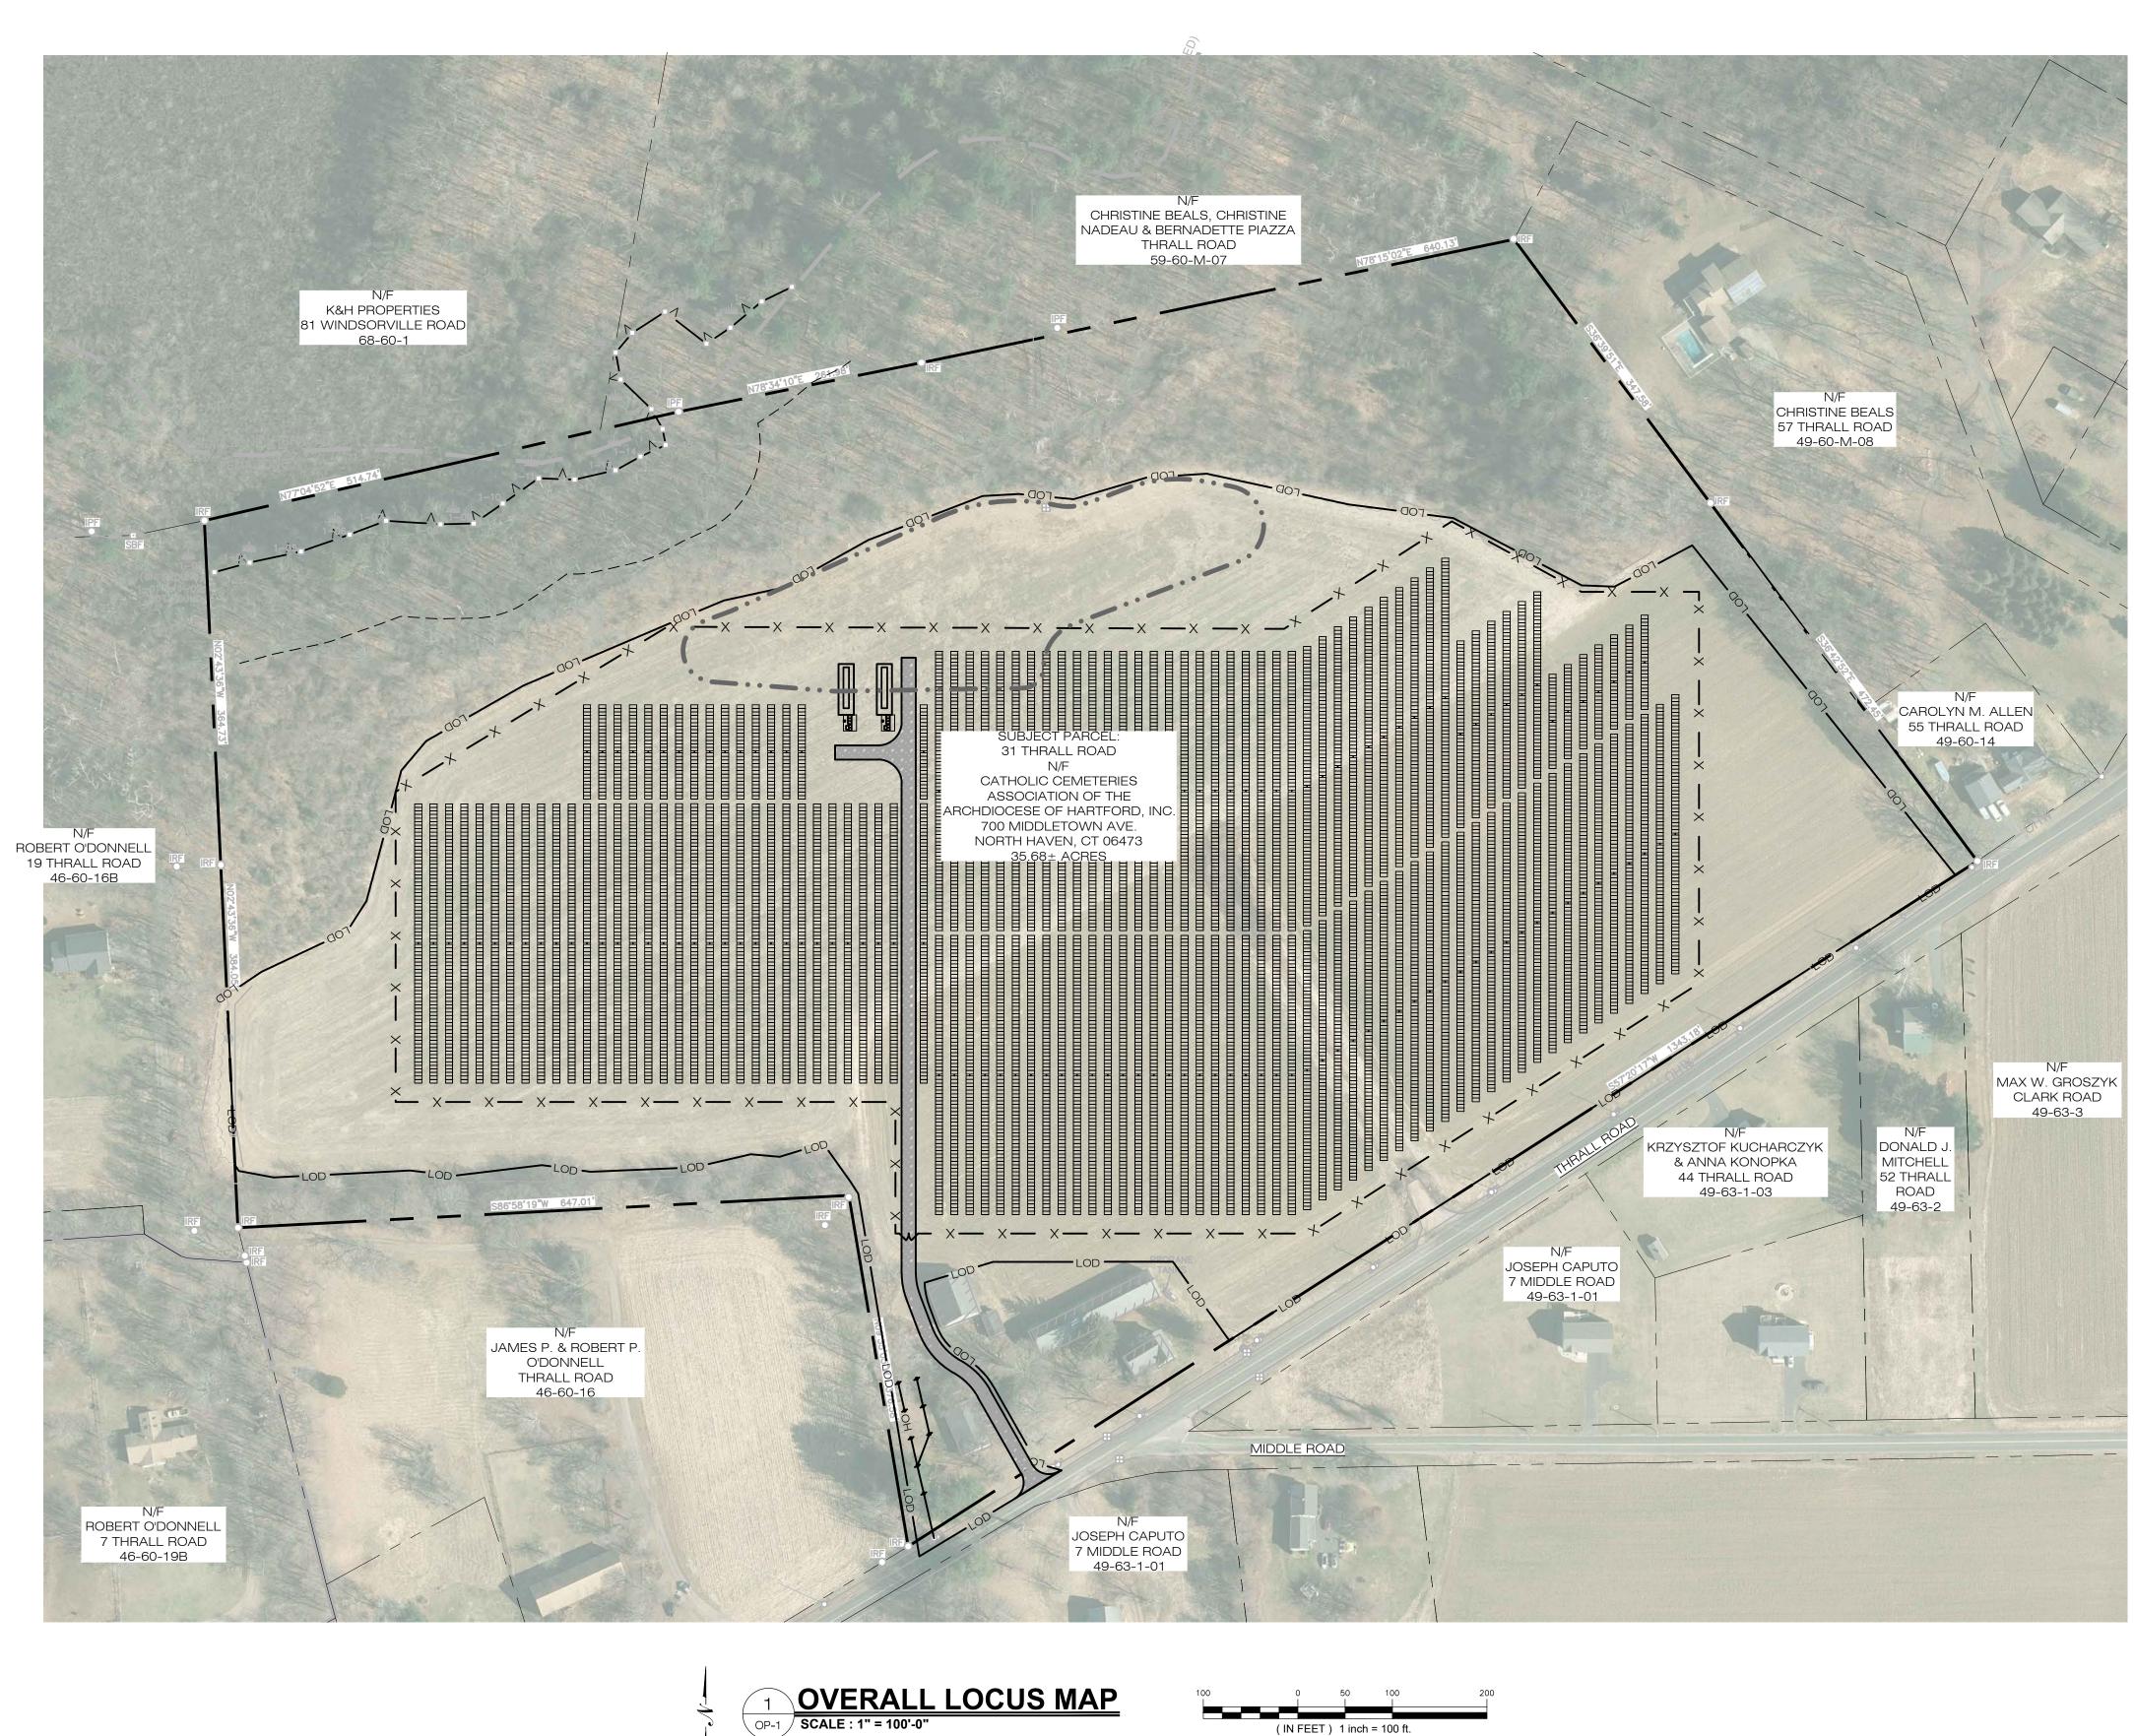

(IN FEET) 1 inch = 100 ft.

EAST WINDSOR SOLAR TWO, LLC 124 LASALLE ROAD 2ND FLOOR WEST HARTFORD, CT, 06107
ALL-POINTS TECHNOLOGY CORPORATION
WATERFORD, CT 06385 PHONE: (860)-663-1697 WWW.ALLPOINTSTECH.COM FAX: (860)-663-0935
NO DATE REVISION 0 04/03/23 DRAFT SET FOR REVIEW: RCB 1 04/25/23 CSC PETITION: RCB 2 05/01/23 CSC PETITION: RCB 3
4 5 6
DESIGN PROFESSIONAL OF RECORD PROF: ROBERT C. BURNS P.E. COMP: ALL-POINTS TECHNOLOGY CORPORATION ADD: 567 VAUXHAUL STREET EXTENSION - SUITE 311 WATERFORD, CT 06385 OWNER: CATHOLIC CEMETERIES ASSOCIATION OF THE ARCHDIOCESE OF HARTFORD, INC. ADDRESS: 700 MIDDLETOWN AVE. NORTH HAVEN, CT 06473
EAST WINDSOR SOLAR TWO
SITE 31 THRALL ROAD ADDRESS: BROAD BROOK, CT 06016
APT FILING NUMBER: CT590340 DRAWN BY: CSH
DATE: 04/03/23 CHECKED BY: RCB
SHEET TITLE:
SHEET NUMBER:
OP-1 Solori SSIONAL ENGINEER

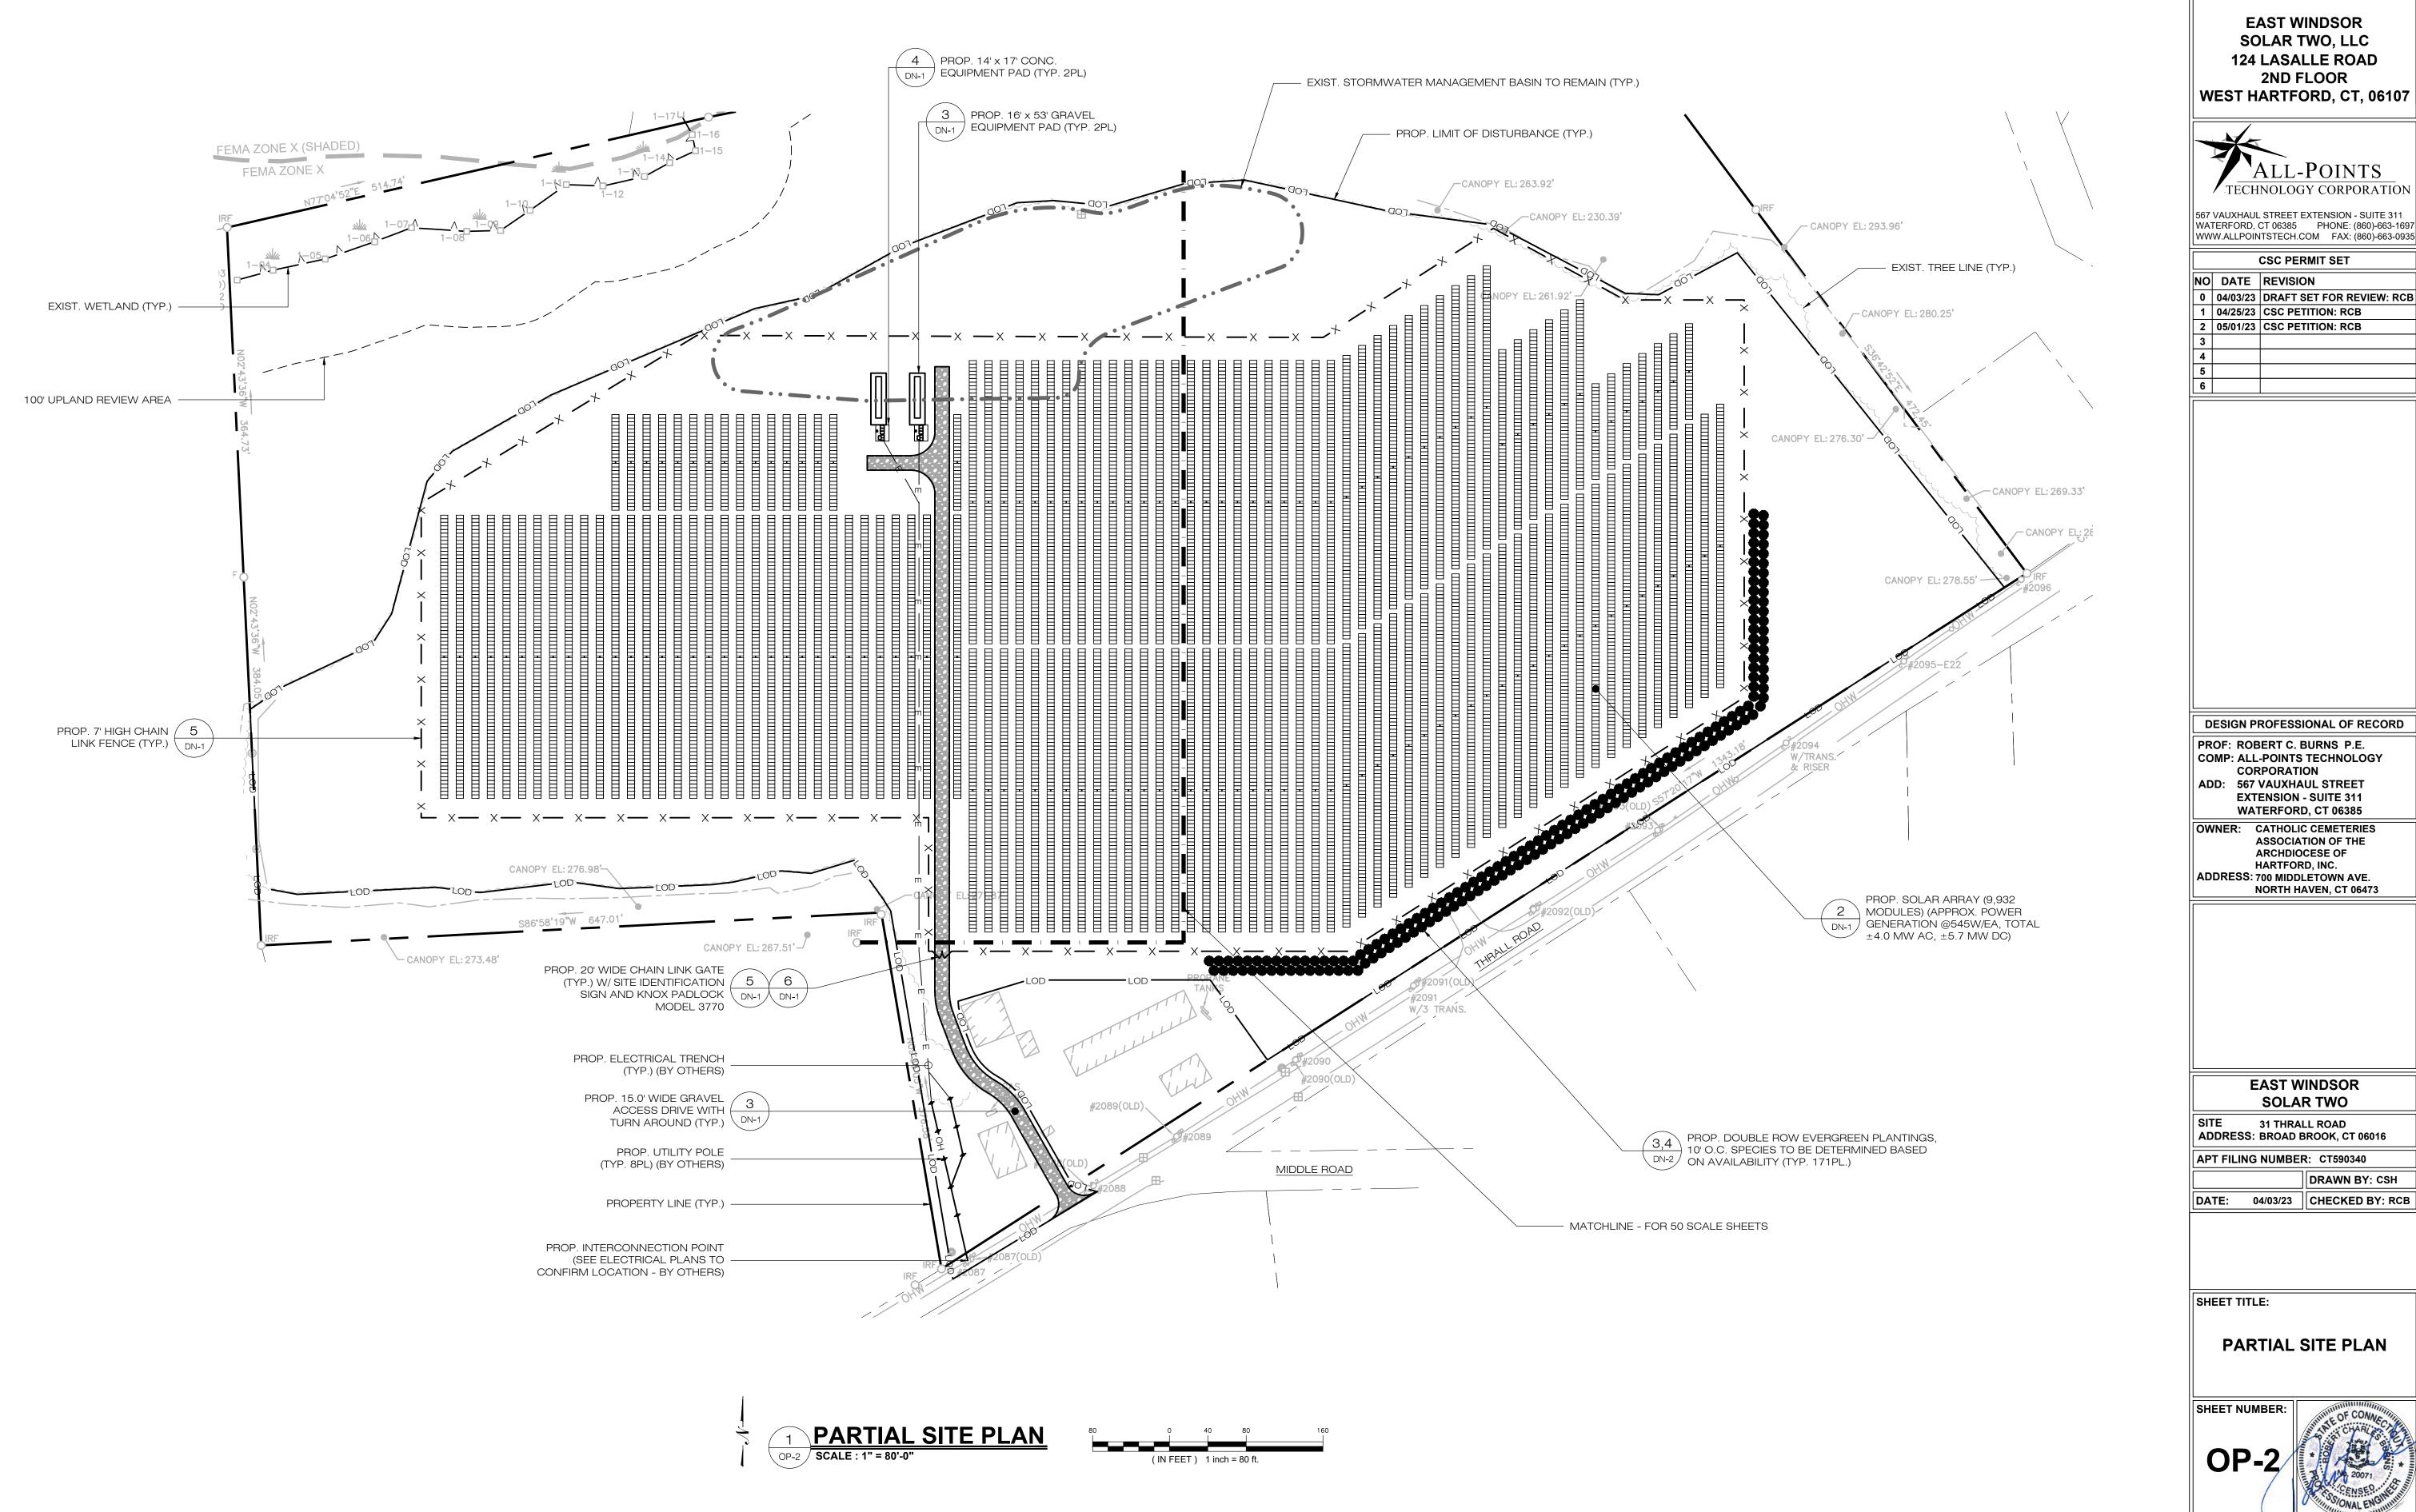

EROSION CONTROL NOTES


EROSION AND SEDIMENT CONTROL PLAN NOTES


- 1. THE CONTRACTOR SHALL CONSTRUCT ALL SEDIMENT AND EROSION CONTROLS IN ACCORDANCE WITH THE 2002 CONNECTICUT GUIDELINES FOR SOIL EROSION AND SEDIMENT CONTROL, LATEST EDITION, IN ACCORDANCE WITH THE CONTRACT DOCUMENTS, AND AS DIRECTED BY THE TOWN OF EAST WINDSOR, PERMITTE AND/OR SWPCP MONITOR. ALL PERIMETER SEDIMENTATION AND EROSION CONTROL MEASURES SHALL BE INSTALLED PRIOR TO THE START OF CLEARING AND GRUBBING AND DEMOLITION OPERATIONS.
- 2. THESE DRAWINGS ARE ONLY INTENDED TO DESCRIBE THE SEDIMENT AND EROSION CONTROL MEASURES FOR THIS SITE. SEE CONSTRUCTION SEQUENCE FOR ADDITIONAL INFORMATION. ALL TEMPORARY EROSION AND SEDIMENT CONTROL MEASURES SHOWN ON THE EROSION & SEDIMENT CONTROL PLAN ARE SHOW AS REQUIRED BY THE ENGINEER. THE CONTRACTOR SHALL BE RESPONSIBLE FOR ENSURING THAT ALL EROSION CONTROL MEASURES ARE CONFIGURED AND CONSTRUCTED IN A MANNER THAT WILL MINIMIZE EROSION OF SOILS AND PREVENT THE TRANSPORT OF SEDIMENTS AND OTHER POLLUTANTS TO STORM DRAINAGE SYSTEMS AND/OR WATERCOURSES. ACTUAL SITE CONDITIONS OR SEASONAL AND CLIMATIC CONDITIONS MAY WARRANT ADDITIONAL CONTROLS OF CONFIGURATIONS, AS REQUIRED, AND AS DIRECTED BY THE PERMITTEE AND/OR SWPCP MONITOR. REFER TO SITE PLAN FOR GENERAL INFORMATION AND OTHE CONTRACT PLANS FOR APPROPRIATE INFORMATION.
- 3. A BOND OR LETTER OF CREDIT MAY BE REQUIRED TO BE POSTED WITH THE GOVERNING AUTHORITY FOR THE EROSION CONTROL INSTALLATION AND MAINTENANCE.
- 4. THE CONTRACTOR SHALL APPLY THE MINIMUM EROSION & SEDIMENT CONTROL MEASURES SHOWN ON THE PLAN IN CONJUNCTION WITH CONSTRUCTION SEQUENCING, SUCH THAT ALL ACTIVE WORK ZONES ARE PROTECTED. ADDITIONAL AND/OR ALTERNATIVE SEDIMENT AND EROSION CONTROL MEASURES MAY B INSTALLED DURING THE CONSTRUCTION PERIOD IF FOUND NECESSARY BY THE CONTRACTOR, OWNER, SITE ENGINEER, MUNICIPAL OFFICIALS, OR ANY GOVERNI AGENCY. THE CONTRACTOR SHALL CONTACT THE OWNER AND APPROPRIATE GOVERNING AGENCIES FOR APPROVAL IF ALTERNATIVE CONTROLS OTHER THAN THOSE SHOWN ON THE PLANS ARE PROPOSED BY THE CONTRACTOR.
- 5. THE CONTRACTOR SHALL TAKE EXTREME CARE DURING CONSTRUCTION SO AS NOT TO DISTURB UNPROTECTED WETLAND AREAS OR INSTALLED SEDIMENTATIC AND EROSION CONTROL MEASURES. THE CONTRACTOR SHALL INSPECT ALL SEDIMENT AND EROSION CONTROLS WEEKLY AND WITHIN 24 HOURS OF A STORM WITH A RAINFALL AMOUNT OF 0.25 INCHES OR GREATER TO VERIFY THAT THE CONTROLS ARE OPERATING PROPERLY AND MAKE REPAIRS AS NECESSARY IN A TIMELY MANNER.
- 6. THE CONTRACTOR SHALL KEEP A SUPPLY OF EROSION CONTROL MATERIAL (SILT FENCE, COMPOST FILTER SOCK, EROSION CONTROL BLANKET, ETC.) ON-SITE PERIODIC MAINTENANCE AND EMERGENCY REPAIRS.
- ALL FILL MATERIAL PLACED ADJACENT TO ANY WETLAND AREA SHALL BE GOOD QUALITY, WITH LESS THAN 5% FINES PASSING THROUGH A #200 SIEVE (BANK RUN), SHALL BE PLACED IN MAXIMUM ONE FOOT LIFTS, AND SHALL BE COMPACTED TO 95% MAX. DRY DENSITY MODIFIED PROCTOR OR AS SPECIFIED IN THE CONTRACT SPECIFICATIONS.
- 8. PROTECT EXISTING TREES THAT ARE TO BE SAVED BY FENCING, ORANGE SAFETY FENCE, CONSTRUCTION TAPE, OR EQUIVALENT FENCING/TAPE. ANY LIMB TRIMMING SHOULD BE DONE AFTER CONSULTATION WITH AN ARBORIST AND BEFORE CONSTRUCTION BEGINS IN THAT AREA; FENCING SHALL BE MAINTAINED, REPAIRED DURING CONSTRUCTION.
- 9. CONSTRUCTION ENTRANCES (ANTI-TRACKING PADS) SHALL BE INSTALLED PRIOR TO ANY SITE EXCAVATION OR CONSTRUCTION ACTIVITY AND SHALL BE MAINTAINED THROUGHOUT THE DURATION OF ALL CONSTRUCTION IF REQUIRED. THE LOCATION OF THE TRACKING PADS MAY CHANGE AS VARIOUS PHASES OF CONSTRUCTION ARE COMPLETED. CONTRACTOR SHALL ENSURE THAT ALL VEHICLES EXITING THE SITE ARE PASSING OVER THE ANTI-TRACKING PADS PRIOR TO EXISTING.
- 10. ALL CONSTRUCTION SHALL BE CONTAINED WITHIN THE LIMIT OF DISTURBANCE, WHICH SHALL BE MARKED WITH SILT FENCE, SAFETY FENCE, HAY BALES, RIBBO OR OTHER MEANS PRIOR TO CLEARING. CONSTRUCTION ACTIVITY SHALL REMAIN ON THE UPHILL SIDE OF THE SEDIMENT BARRIER UNLESS WORK IS SPECIFICALL CALLED FOR ON THE DOWNHILL SIDE OF THE BARRIER.
- 11. NO CUT OR FILL SLOPES SHALL EXCEED 2:1 EXCEPT WHERE STABILIZED BY ROCK FACED EMBANKMENTS OR EROSION CONTROL BLANKETS. ALL SLOPES SHALI SEEDED AND BANKS WILL BE STABILIZED IMMEDIATELY UPON COMPLETION OF FINAL GRADING UNTIL TURF IS ESTABLISHED.
- 12. DIRECT ALL DEWATERING PUMP DISCHARGE TO A SEDIMENT CONTROL DEVICE CONFORMING TO THE GUIDELINES WITHIN THE APPROVED LIMIT OF DISTURBANCE REQUIRED. DISCHARGE TO STORM DRAINS OR SURFACE WATERS FROM SEDIMENT CONTROLS SHALL BE CLEAR AND APPROVED BY THE PERMITTEE OR MUNICIPALITY.
- 13. THE CONTRACTOR SHALL MAINTAIN A CLEAN CONSTRUCTION SITE AND SHALL NOT ALLOW THE ACCUMULATION OF RUBBISH OR CONSTRUCTION DEBRIS ON THE SITE. PROPER SANITARY DEVICES SHALL BE MAINTAINED ON-SITE AT ALL TIMES AND SECURED APPROPRIATELY. THE CONTRACTOR SHALL TAKE ALL NECESSAR PRECAUTIONS TO AVOID THE SPILLAGE OF FUEL OR OTHER POLLUTANTS ON THE CONSTRUCTION SITE AND SHALL ADHERE TO ALL APPLICABLE POLICIES AND REGULATIONS RELATED TO SPILL PREVENTION AND RESPONSE/CONTAINMENT.
- 14. MINIMIZE LAND DISTURBANCES. SEED AND MULCH DISTURBED AREAS WITH TEMPORARY MIX AS SOON AS PRACTICABLE (2 WEEK MAXIMUM UNSTABILIZED PERI USING PERENNIAL RYEGRASS AT 40 LBS PER ACRE. MULCH ALL CUT AND FILL SLOPES AND SWALES WITH LOOSE HAY AT A RATE OF 2 TONS PER ACRE. IF NECESSARY, REPLACE LOOSE HAY ON SLOPES WITH EROSION CONTROL BLANKETS OR JUTE CLOTH. MODERATELY GRADED AREAS, ISLANDS, AND TEMPORARY CONSTRUCTION STAGING AREAS MAY BE HYDROSEEDED WITH TACKIFIER.
- 15. SWEEP AFFECTED PORTIONS OF OFF SITE ROADS ONE OR MORE TIMES A DAY (OR LESS FREQUENTLY IF TRACKING IS NOT A PROBLEM) DURING CONSTRUCTION. FOR DUST CONTROL, PERIODICALLY MOISTEN EXPOSED SOIL SURFACES WITH WATER ON UNPAVED TRAVELWAYS TO KEEP THE TRAVELWAYS DAMP. CALCIUM CHLORIDE MAY ALSO BE APPLIED TO ACCESS ROADS. DUMP TRUCK LOADS EXITING THE SITE SHALL BE COVERED.
- 16. VEGETATIVE ESTABLISHMENT SHALL OCCUR ON ALL DISTURBED SOIL, UNLESS THE AREA IS UNDER ACTIVE CONSTRUCTION, IT IS COVERED IN STONE OR SCHEDULED FOR PAVING WITHIN 30 DAYS. TEMPORARY SEEDING OR NON-LIVING SOIL PROTECTION OF ALL EXPOSED SOILS AND SLOPES SHALL BE INITIATED WITHIN THE FIRST 7 DAYS OF SUSPENDING WORK IN AREAS TO BE LEFT LONGER THAN 30 DAYS.
- 17. MAINTAIN ALL PERMANENT AND TEMPORARY SEDIMENT CONTROL DEVICES IN EFFECTIVE CONDITION THROUGHOUT THE CONSTRUCTION PERIOD. UPON COMPLETION OF WORK SWEEP CONCRETE PADS, CLEAN THE STORMWATER MANAGEMENT SYSTEMS AND REMOVE ALL TEMPORARY SEDIMENT CONTROLS ON THE SITE IS FULLY STABILIZED AND APPROVAL HAS BEEN RECEIVED FROM PERMITTEE OR THE MUNICIPALITY.
- 18. SEEDING MIXTURES SHALL BE <u>FUZZ & BUZZ MIX PREMIUM ERNMX-147</u>, OR APPROVED EQUAL. <u>NEW ENGLAND EROSION CONTROL/ RESTORATION MIX FOR</u> <u>DETENTION BASINS & MOIST SITES</u>, OR APPROVED EQUAL, SHALL BE UTILIZED ON THE BOTTOM OF THE BASIN & <u>FUZZ & BUZZ MIX - PREMIUM - ERNMX-147</u>, OR APPROVED EQUAL, ON THE SIDE SLOPES OF THE BASIN. SEE SHEET DN-2 FOR ALL SEED MIXTURES.


	CONSTRUCTION OPERATION AND N	MAINTENANCE PLAN - BY CONTRACTOR
E&S MEASURE	INSPECTION SCHEDULE	MAINTENANCE REQUIRED
CONSTRUCTION ENTRANCE	DAILY	PLACE ADDITIONAL STONE, EXTEND THE LENGTH OR REMOVE AND REPLACE THE STONE. CLEAN PAVED SURFACES OF TRACKED SEDIMENT.
SILT FENCE	WEEKLY & WITHIN 24 HOURS OF RAINFALL > 0.25"	REPAIR/REPLACE WHEN FAILURE OR DETERIORATION IS OBSERVED. REMOVE SILT WHEN IT REACHES 1/2 THE HEIGHT OF THE FENCE.
TOPSOIL/BORROW STOCKPILES	DAILY	REPAIR/REPLACE SEDIMENT BARRIERS AS NECESSARY.
TEMPORARY SEDIMENT BASIN	WEEKLY & WITHIN 24 HOURS OF RAINFALL > 0.5"	REMOVE SEDIMENT ONCE IT HAS ACCUMULATED TO ONE HALF OF MINIMUM REQUIRED VOLUME OF THE WET STORAGE, DEWATERING AS NEEDED. RESTORE TRAP TO ORIGINAL DIMENSIONS. REPAIR/REPLACE BAFFLES WHEN FAILURE OR DETERIORATION IS OBSERVED.
TEMPORARY SEDIMENT TRAP	WEEKLY & WITHIN 24 HOURS OF RAINFALL > 0.5"	REMOVE SEDIMENT ONCE IT HAS ACCUMULATED TO ONE HALF OF MINIMUM REQUIRED VOLUME OF THE WET STORAGE, DEWATERING AS NEEDED. RESTORE TRAP TO ORIGINAL DIMENSIONS. REPAIR/REPLACE BAFFLES WHEN FAILURE OR DETERIORATION IS OBSERVED.
TEMPORARY SOIL PROTECTION	WEEKLY & WITHIN 24 HOURS OF RAINFALL > 0.25"	REPAIR ERODED OR BARE AREAS IMMEDIATELY. RESEED AND MULCH.


	SEDIMENT & EROSION CONTROL NARRATIVE
N TEE,	1. THE PROJECT INVOLVES THE CONSTRUCTION OF A GROUND MOUNTED SOLAR PANEL FACILITY WITH ASSOCIATED EQUIPMENT, INCLUDING GRADING OF APPROXIMATELY 24.70± ACRES OF EXISTING LOT.
	THE PROPOSED PROJECT INVOLVES THE FOLLOWING CONSTRUCTION:
	A. CLEARING, GRUBBING, AND GRADING OF EXISTING LOT.
VN	B. CONSTRUCTION OF 9,932 GROUND MOUNTED SOLAR PANELS AND ASSOCIATED EQUIPMENT. B. THE STABILIZATION OF DISTURBED AREAS WITH PERMANENT VEGETATIVE TREATMENTS.
)R ER	2. FOR THIS PROJECT, THERE ARE APPROXIMATELY 24.70± ACRES OF THE SITE BEING DISTURBED WITH NEGLIGIBLE INCREASE IN THE IMPERVIOUS AREA OF THE SITE. IMPERVIOUS AREAS ARE LIMITED TO THE CONCRETE PADS FOR ELECTRICAL EQUIPMENT & GRAVEL ACCESS DRIVE.
	3. THE PROJECT SITE, AS MAPPED IN THE SOIL SURVEY OF STATE OF CONNECTICUT (NRCS, VERSION 18, DEC 6, 2018), CONTAINS TYPE 37C & 38E (HYDROLOGIC SOIL GROUP A) AND 704A & 704B (HYDROLOGIC SOIL GROUP B). A GEOTECHNICAL ENGINEERING REPORT IS AVAILABLE UNDER SEPARATE COVER.
BE	4. IT IS ANTICIPATED THAT CONSTRUCTION WILL BE COMPLETED IN APPROXIMATELY 4-6 MONTHS.
NING J	 REFER TO THE CONSTRUCTION SEQUENCING AND EROSION AND SEDIMENTATION NOTES FOR INFORMATION REGARDING SEQUENCING OF MAJOR OPERATIONS IN THE ON-SITE CONSTRUCTION PHASES.
ON	6. STORMWATER MANAGEMENT DESIGN CRITERIA UTILIZES THE APPLICABLE SECTIONS OF THE 2004 CONNECTICUT STORMWATER QUALITY MANUAL AND THE TOWN OF EAST WINDSOR STANDARDS, TO THE EXTENT POSSIBLE AND PRACTICABLE FOR THIS PROJECT ON THIS SITE. EROSION AND SEDIMENTATION MEASURES ARE BASED UPON ENGINEERING PRACTICE, JUDGEMENT AND THE APPLICABLE SECTIONS OF THE CONNECTICUT EROSION AND SEDIMENT CONTROL GUIDELINES FOR URBAN AND SUBURBAN AREAS, LATEST EDITION.
FOR	7. DETAILS FOR THE TYPICAL STORMWATER MANAGEMENT AND EROSION AND SEDIMENTATION MEASURES ARE SHOWN ON THE PLAN SHEETS OR PROVIDED AS SEPARATE SUPPORT DOCUMENTATION FOR REVIEW IN THIS PLAN.
	8. CONSERVATION PRACTICES TO BE USED DURING CONSTRUCTION:
	A. STAGED CONSTRUCTION; B. MINIMIZE THE DISTURDED ADEAS TO THE EXTENT REACTICARLE DURING CONSTRUCTION:
	 B. MINIMIZE THE DISTURBED AREAS TO THE EXTENT PRACTICABLE DURING CONSTRUCTION; C. STABILIZE DISTURBED AREAS WITH TEMPORARY OR PERMANENT MEASURES AS SOON AS POSSIBLE, BUT NO LATER THAN 7-DAYS FOLLOWING DISTURBANCE;
AND	D. MINIMIZE IMPERVIOUS AREAS; E. UTILIZE APPROPRIATE CONSTRUCTION EROSION AND SEDIMENTATION MEASURES.
	9. THE FOLLOWING SEPARATE DOCUMENTS ARE TO BE CONSIDERED A PART OF THE EROSION AND SEDIMENTATION PLAN:
= D	A. STORMWATER MANAGEMENT REPORT DATED APRIL 2023. B. SWPCP, TO BE ISSUED AT A LATER DATE.
	SUGGESTED CONSTRUCTION SEQUENCE
DNS, _LY	THE FOLLOWING SUGGESTED SEQUENCE OF CONSTRUCTION ACTIVITIES IS PROJECTED BASED UPON ENGINEERING JUDGEMENT AND BEST MANAGEMENT
LBE	PRACTICES. THE CONTRACTOR MAY ELECT TO ALTER THE SEQUENCING TO BEST MEET THE CONSTRUCTION SCHEDULE, THE EXISTING SITE ACTIVITIES AND WEATHER CONDITIONS. SHOULD THE CONTRACTOR ALTER THE CONSTRUCTION SEQUENCE OR ANY EROSION AND SEDIMENTATION CONTROL MEASURES THEY SHALL MODIFY THE STORMWATER POLLUTION CONTROL PLAN ("SWPCP") AS REQUIRED BY THE GENERAL PERMIT. MAJOR CHANGES IN SEQUENCING AND/OR METHODS MAY REQUIRE REGULATORY APPROVAL PRIOR TO IMPLEMENTATION.
DE IF	1. THE CONTRACTOR SHALL SCHEDULE A PRE-CONSTRUCTION MEETING. PHYSICALLY FLAG THE LIMITS OF DISTURBANCE IN THE FIELD AS NECESSARY TO FACILITATE THE PRE-CONSTRUCTION MEETING.
THE }Y	2. CONDUCT A PRE-CONSTRUCTION MEETING TO DISCUSS THE PROPOSED WORK AND EROSION AND SEDIMENTATION CONTROL MEASURES. THE MEETING SHOULD BE ATTENDED BY THE OWNER, THE OWNER'S REPRESENTATIVE(S), THE GENERAL CONTRACTOR, DESIGNATED SUB-CONTRACTORS AND THE PERSON, OR PERSONS, RESPONSIBLE FOR THE IMPLEMENTATION, OPERATION, MONITORING AND MAINTENANCE OF THE EROSION AND SEDIMENTATION MEASURES. THE CONSTRUCTION PROCEDURES FOR THE ENTIRE PROJECT SHALL BE REVIEWED AT THIS MEETING.
RIOD)	3. NOTIFY CALL BEFORE YOU DIG AT 811, AS REQUIRED, PRIOR TO THE START OF CONSTRUCTION.
Y	PHASE 1
	4. REMOVE EXISTING IMPEDIMENTS AS NECESSARY AND PROVIDE MINIMAL DISTURBANCE TO INSTALL THE REQUIRED CONSTRUCTION ENTRANCE.
۱.	5. INSTALL PERIMETER EROSION CONTROL.
	6. CLEAN OUT EXISTING DRYWELL IN EXISTING STORMWATER MANAGEMENT BASIN AND INSTALL SILT SACK & HAYBALES.
	7. INSTALL ACCESS DRIVE.
	8. INSTALL ELECTRICAL CONDUIT, RACKING POSTS FOR GROUND MOUNTED SOLAR PANELS & GROUND MOUNTED SOLAR PANELS AND COMPLETE ELECTRICAL INSTALLATION.
NCE	9. TEMPORARILY SEED DISTURBED AREAS NOT UNDER CONSTRUCTION FOR THIRTY (30) DAYS OR MORE.
	PHASE 2
	10. AFTER SUBSTANTIAL COMPLETION OF THE INSTALLATION OF THE SOLAR PANELS, COMPLETE REMAINING SITE WORK, INCLUDING ANY REQUIRED LANDSCAPE SCREENING, CHAIN LINK FENCE, AND STABILIZE ALL DISTURBED AREAS.
	11. FINE GRADE, RAKE, SEED AND MULCH ALL REMAINING DISTURBED AREAS.


12. AFTER THE SITE IS STABILIZED AND WITH THE APPROVAL OF THE PERMITTEE AND IF NECESSARY THE CONSERVATION AGENT, REMOVE PERIMETER EROSION AND SEDIMENTATION CONTROLS.

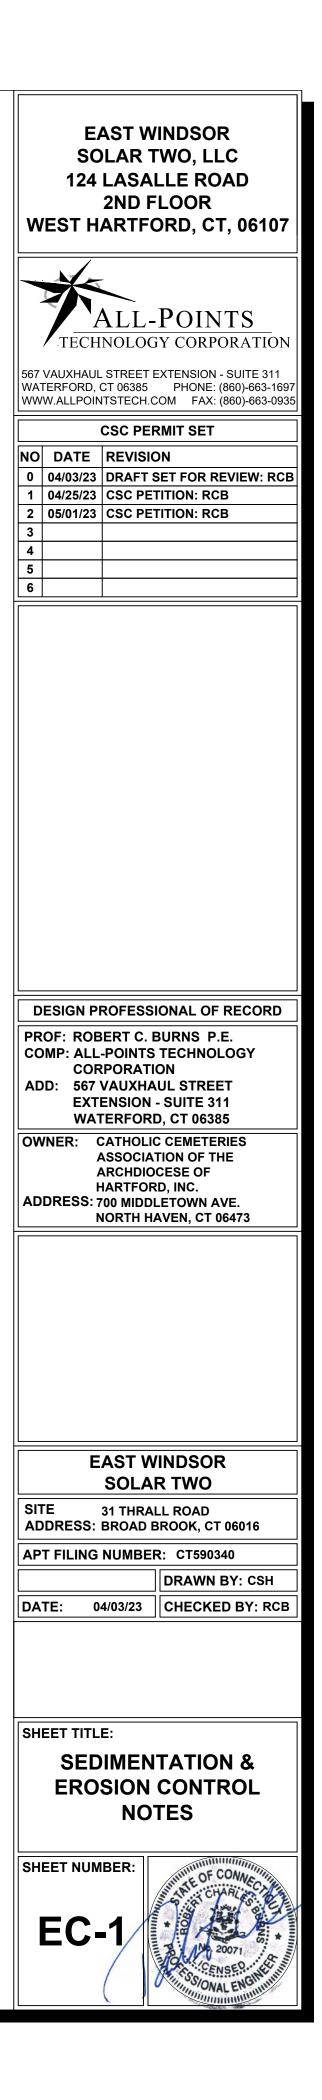

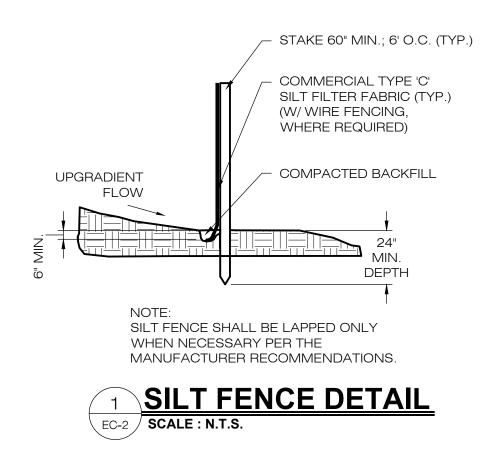


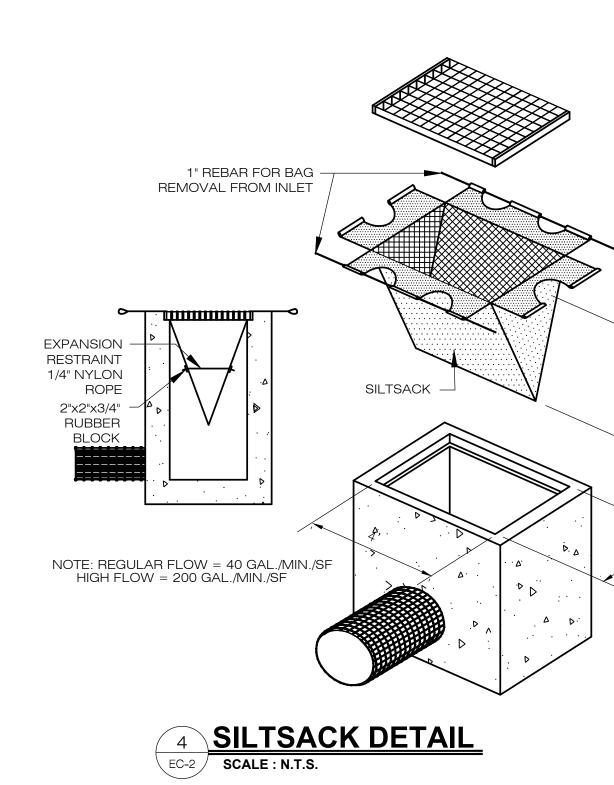

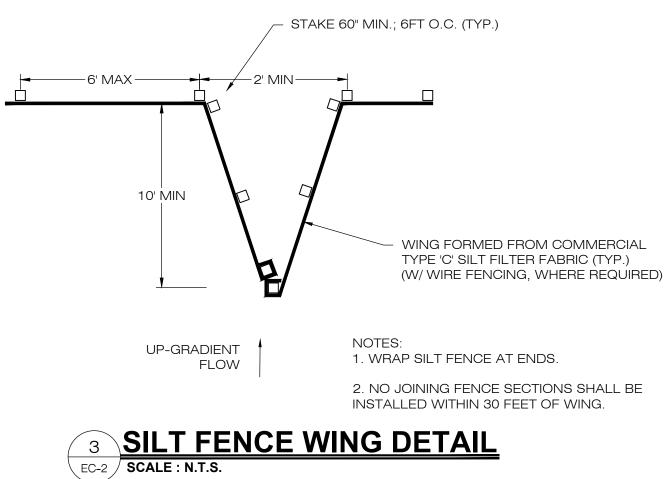


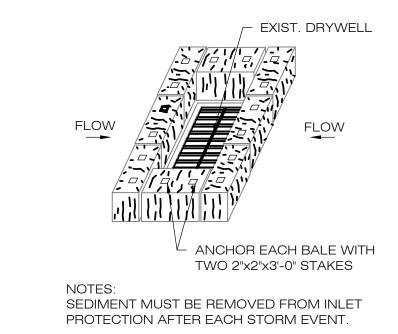



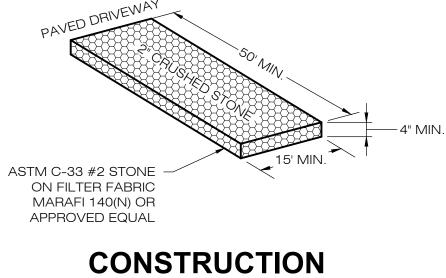





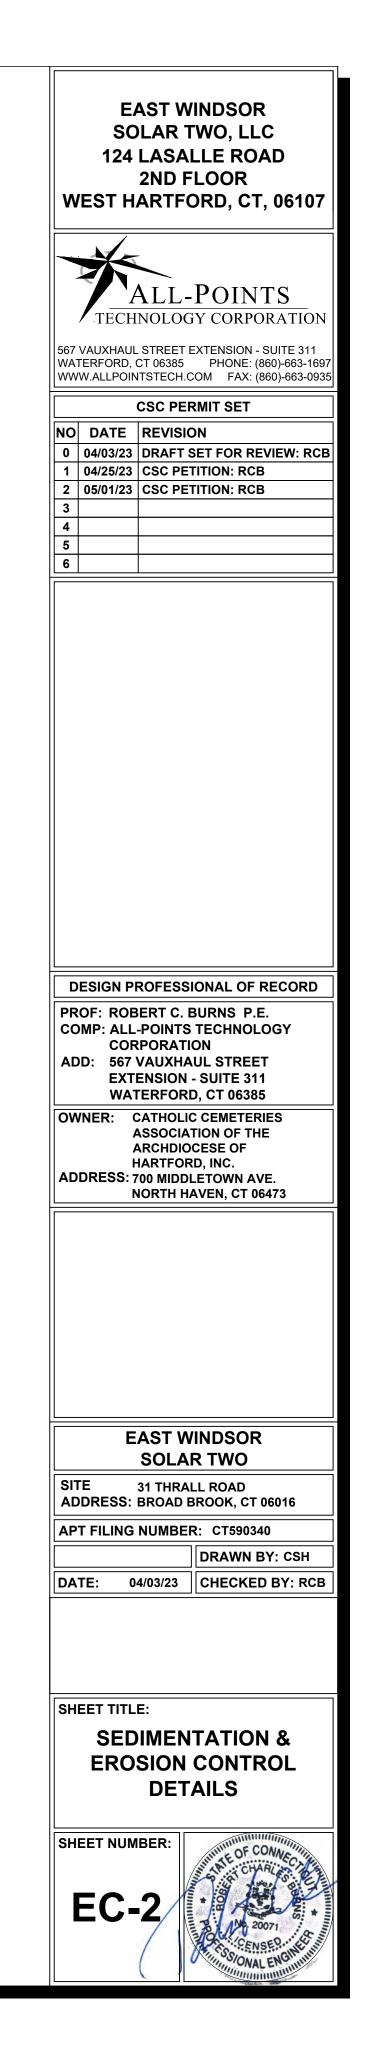


INSTALLED WITHIN 30 FEET OF WING.


2. NO JOINING FENCE SECTIONS SHALL BE

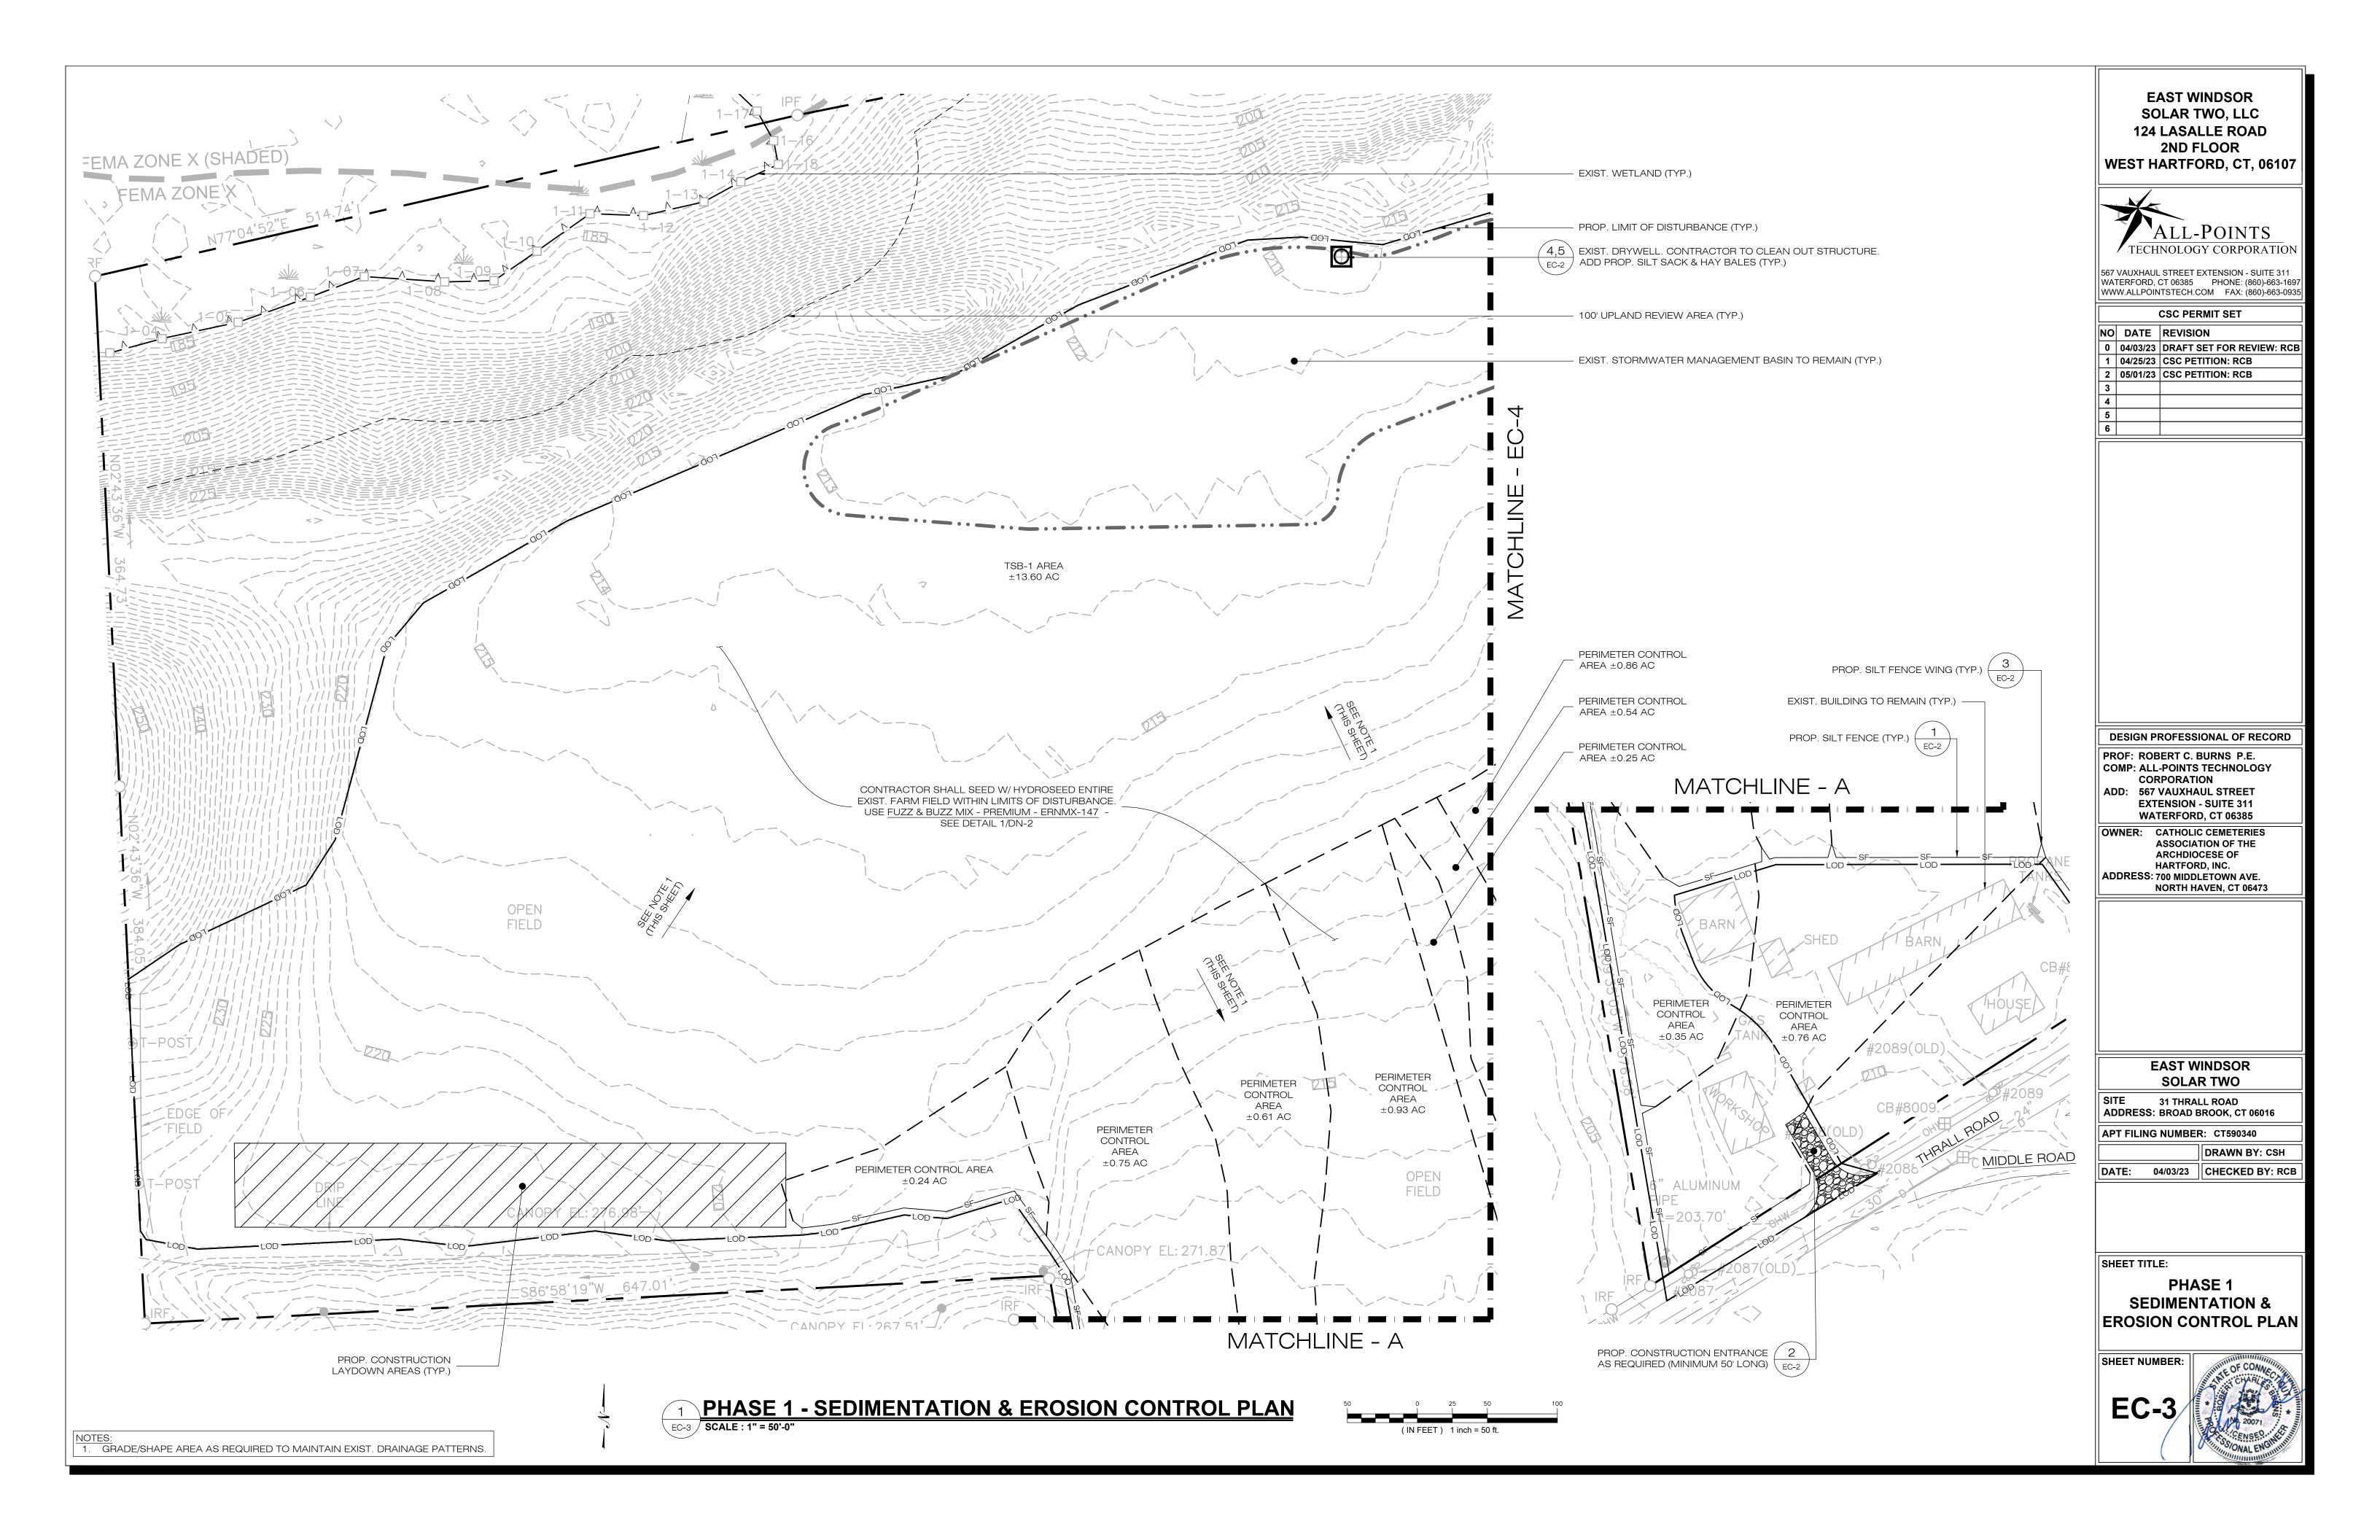

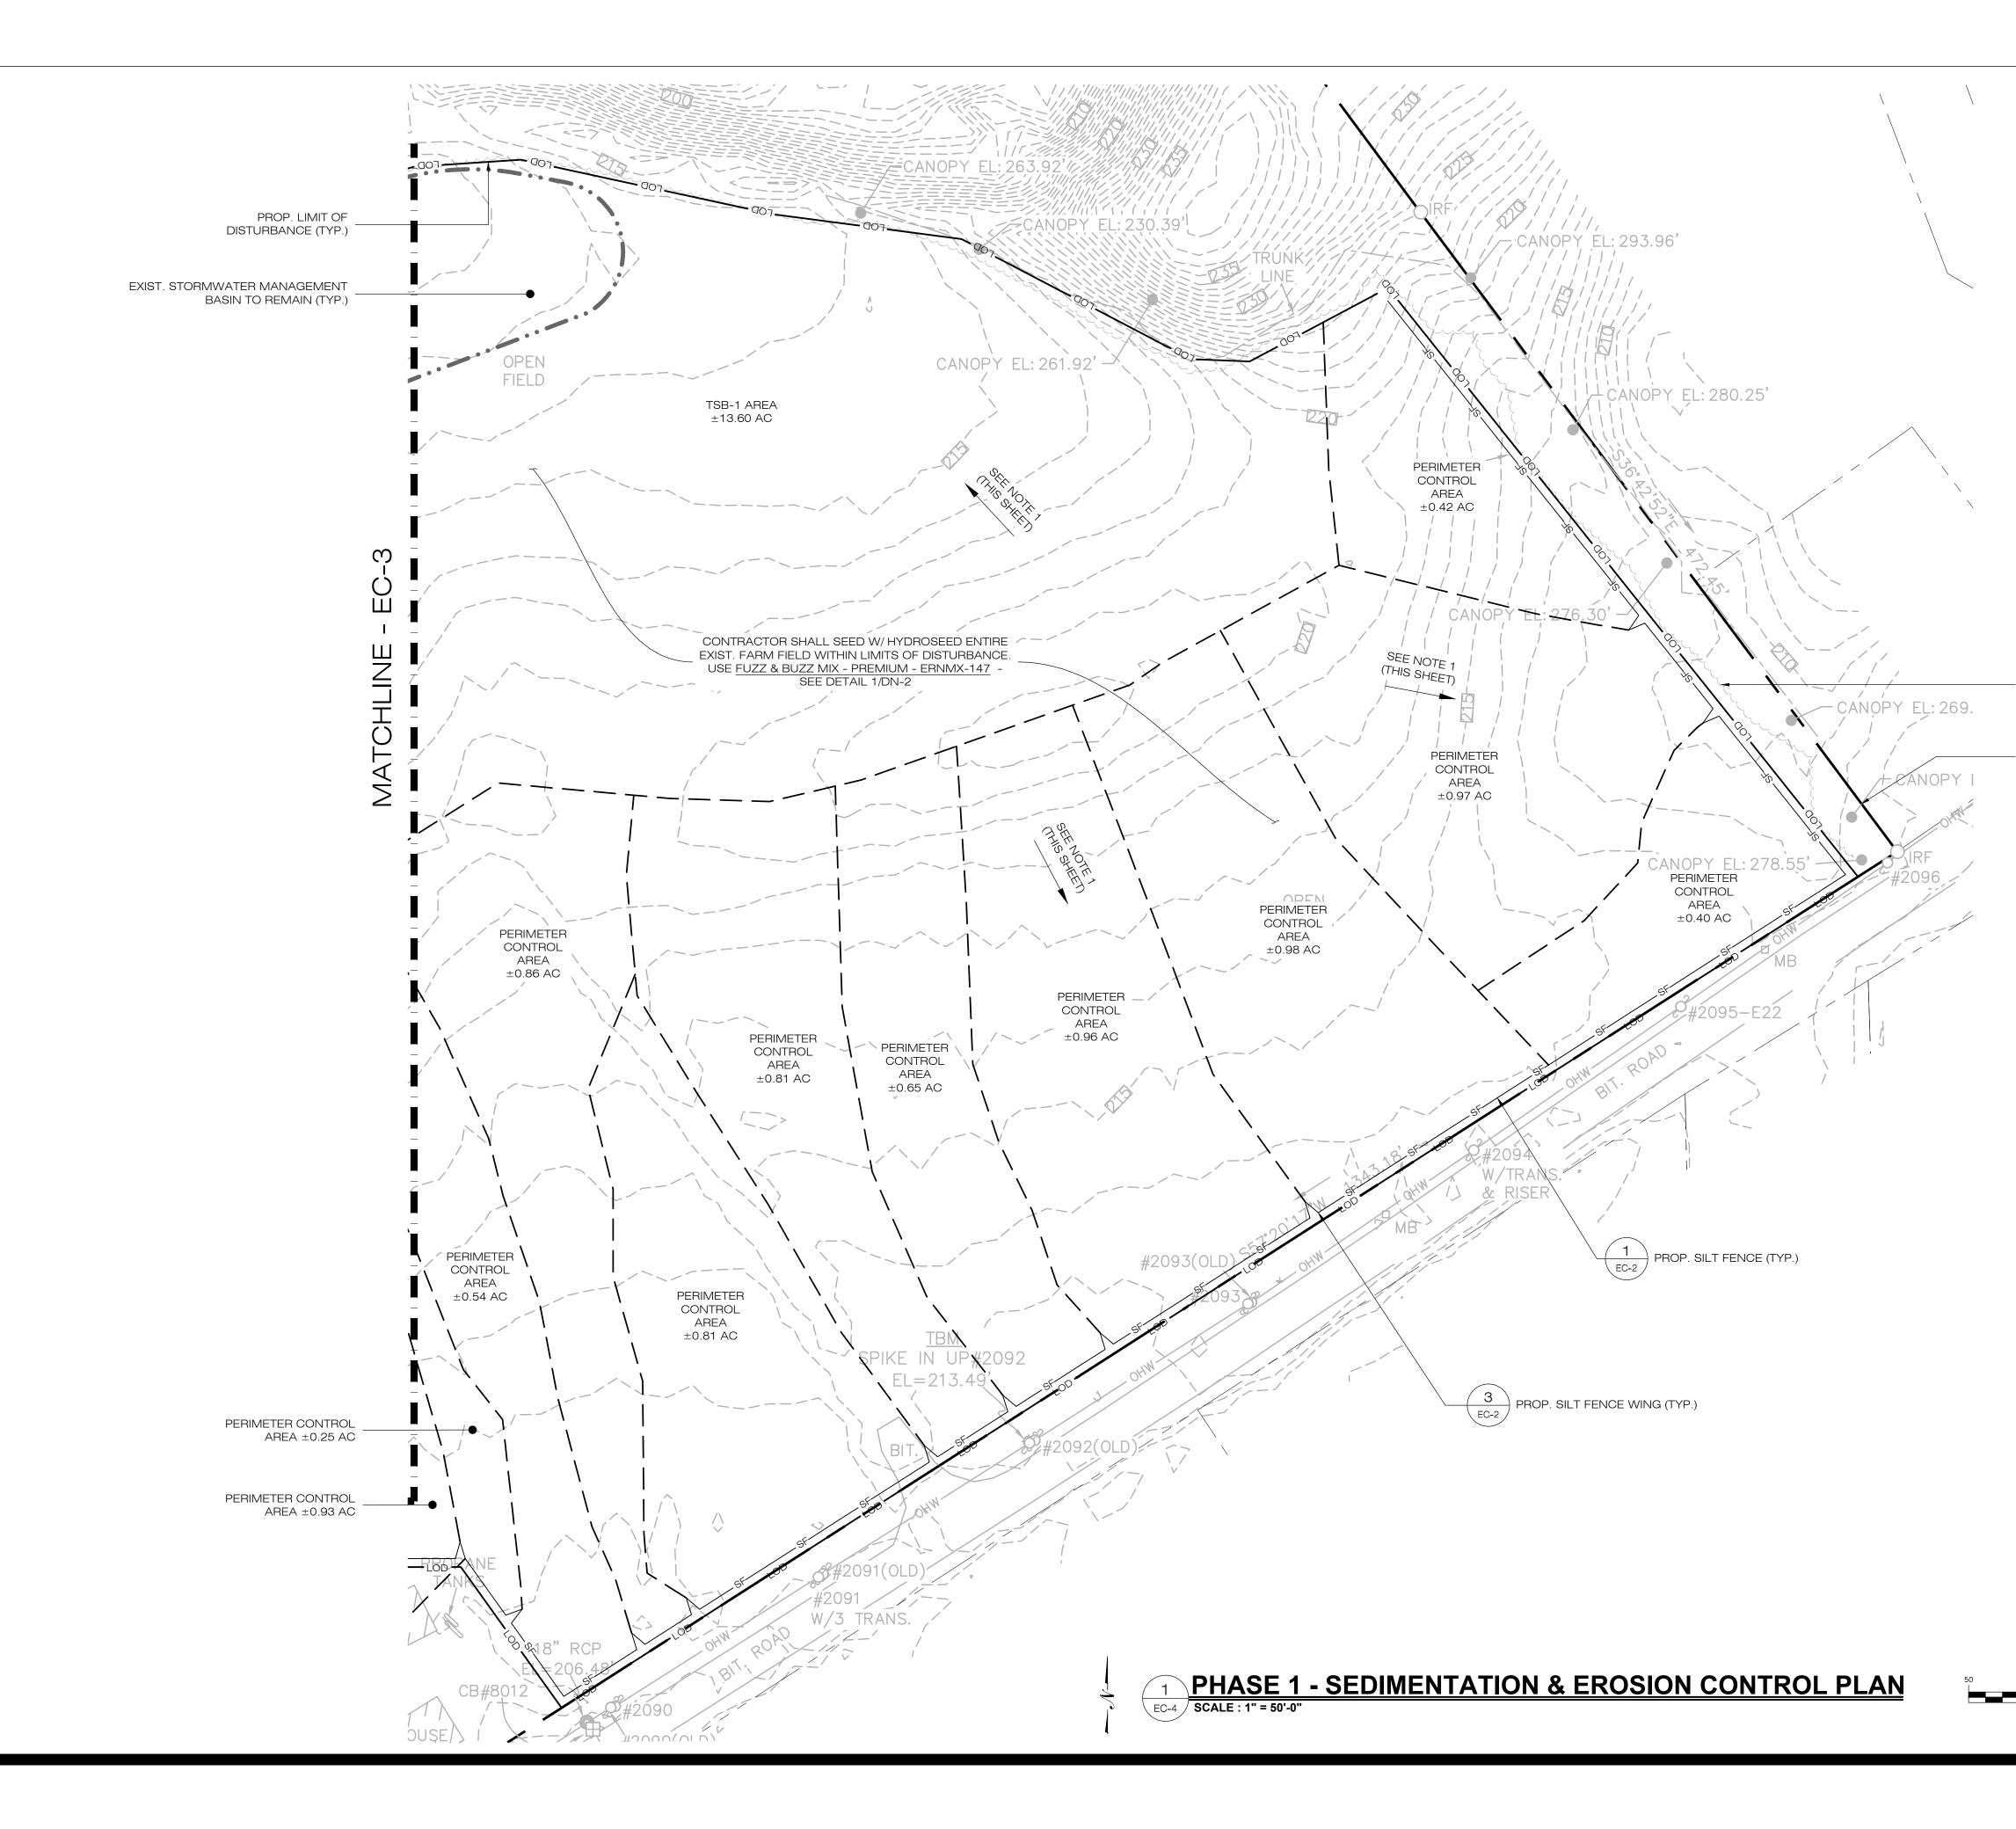

	·
	EAST WINDSOR SOLAR TWO, LLC 124 LASALLE ROAD 2ND FLOOR WEST HARTFORD, CT, 06107
	ALL-POINTS TECHNOLOGY CORPORATION 567 VAUXHAUL STREET EXTENSION - SUITE 311 WATERFORD, CT 06385 PHONE: (860)-663-1697 WWW.ALLPOINTSTECH.COM FAX: (860)-663-0935
	CSC PERMIT SETNODATEREVISION004/03/23DRAFT SET FOR REVIEW: RCB104/25/23CSC PETITION: RCB205/01/23CSC PETITION: RCB3
	6
- EXIST. TREE LINE (TYP.) - PROPERTY LINE (TYP.)	
- FROFENTT LINE (TTF.)	
	DESIGN PROFESSIONAL OF RECORD PROF: ROBERT C. BURNS P.E. COMP: ALL-POINTS TECHNOLOGY CORPORATION ADD: 567 VAUXHAUL STREET EXTENSION - SUITE 311 WATERFORD, CT 06385 OWNER: CATHOLIC CEMETERIES ASSOCIATION OF THE
	ARCHDIOCESE OF HARTFORD, INC. ADDRESS: 700 MIDDLETOWN AVE. NORTH HAVEN, CT 06473
	EAST WINDSOR SOLAR TWO
	SITE 31 THRALL ROAD ADDRESS: BROAD BROOK, CT 06016
	APT FILING NUMBER: CT590340
	DATE: 04/03/23 CHECKED BY: RCB
	SHEET TITLE: PHASE 1 SEDIMENTATION & EROSION CONTROL PLAN
	SHEET NUMBER:
	EC-4
(IN FEET) 1 inch = 50 ft.	SSIONAL ENGINE

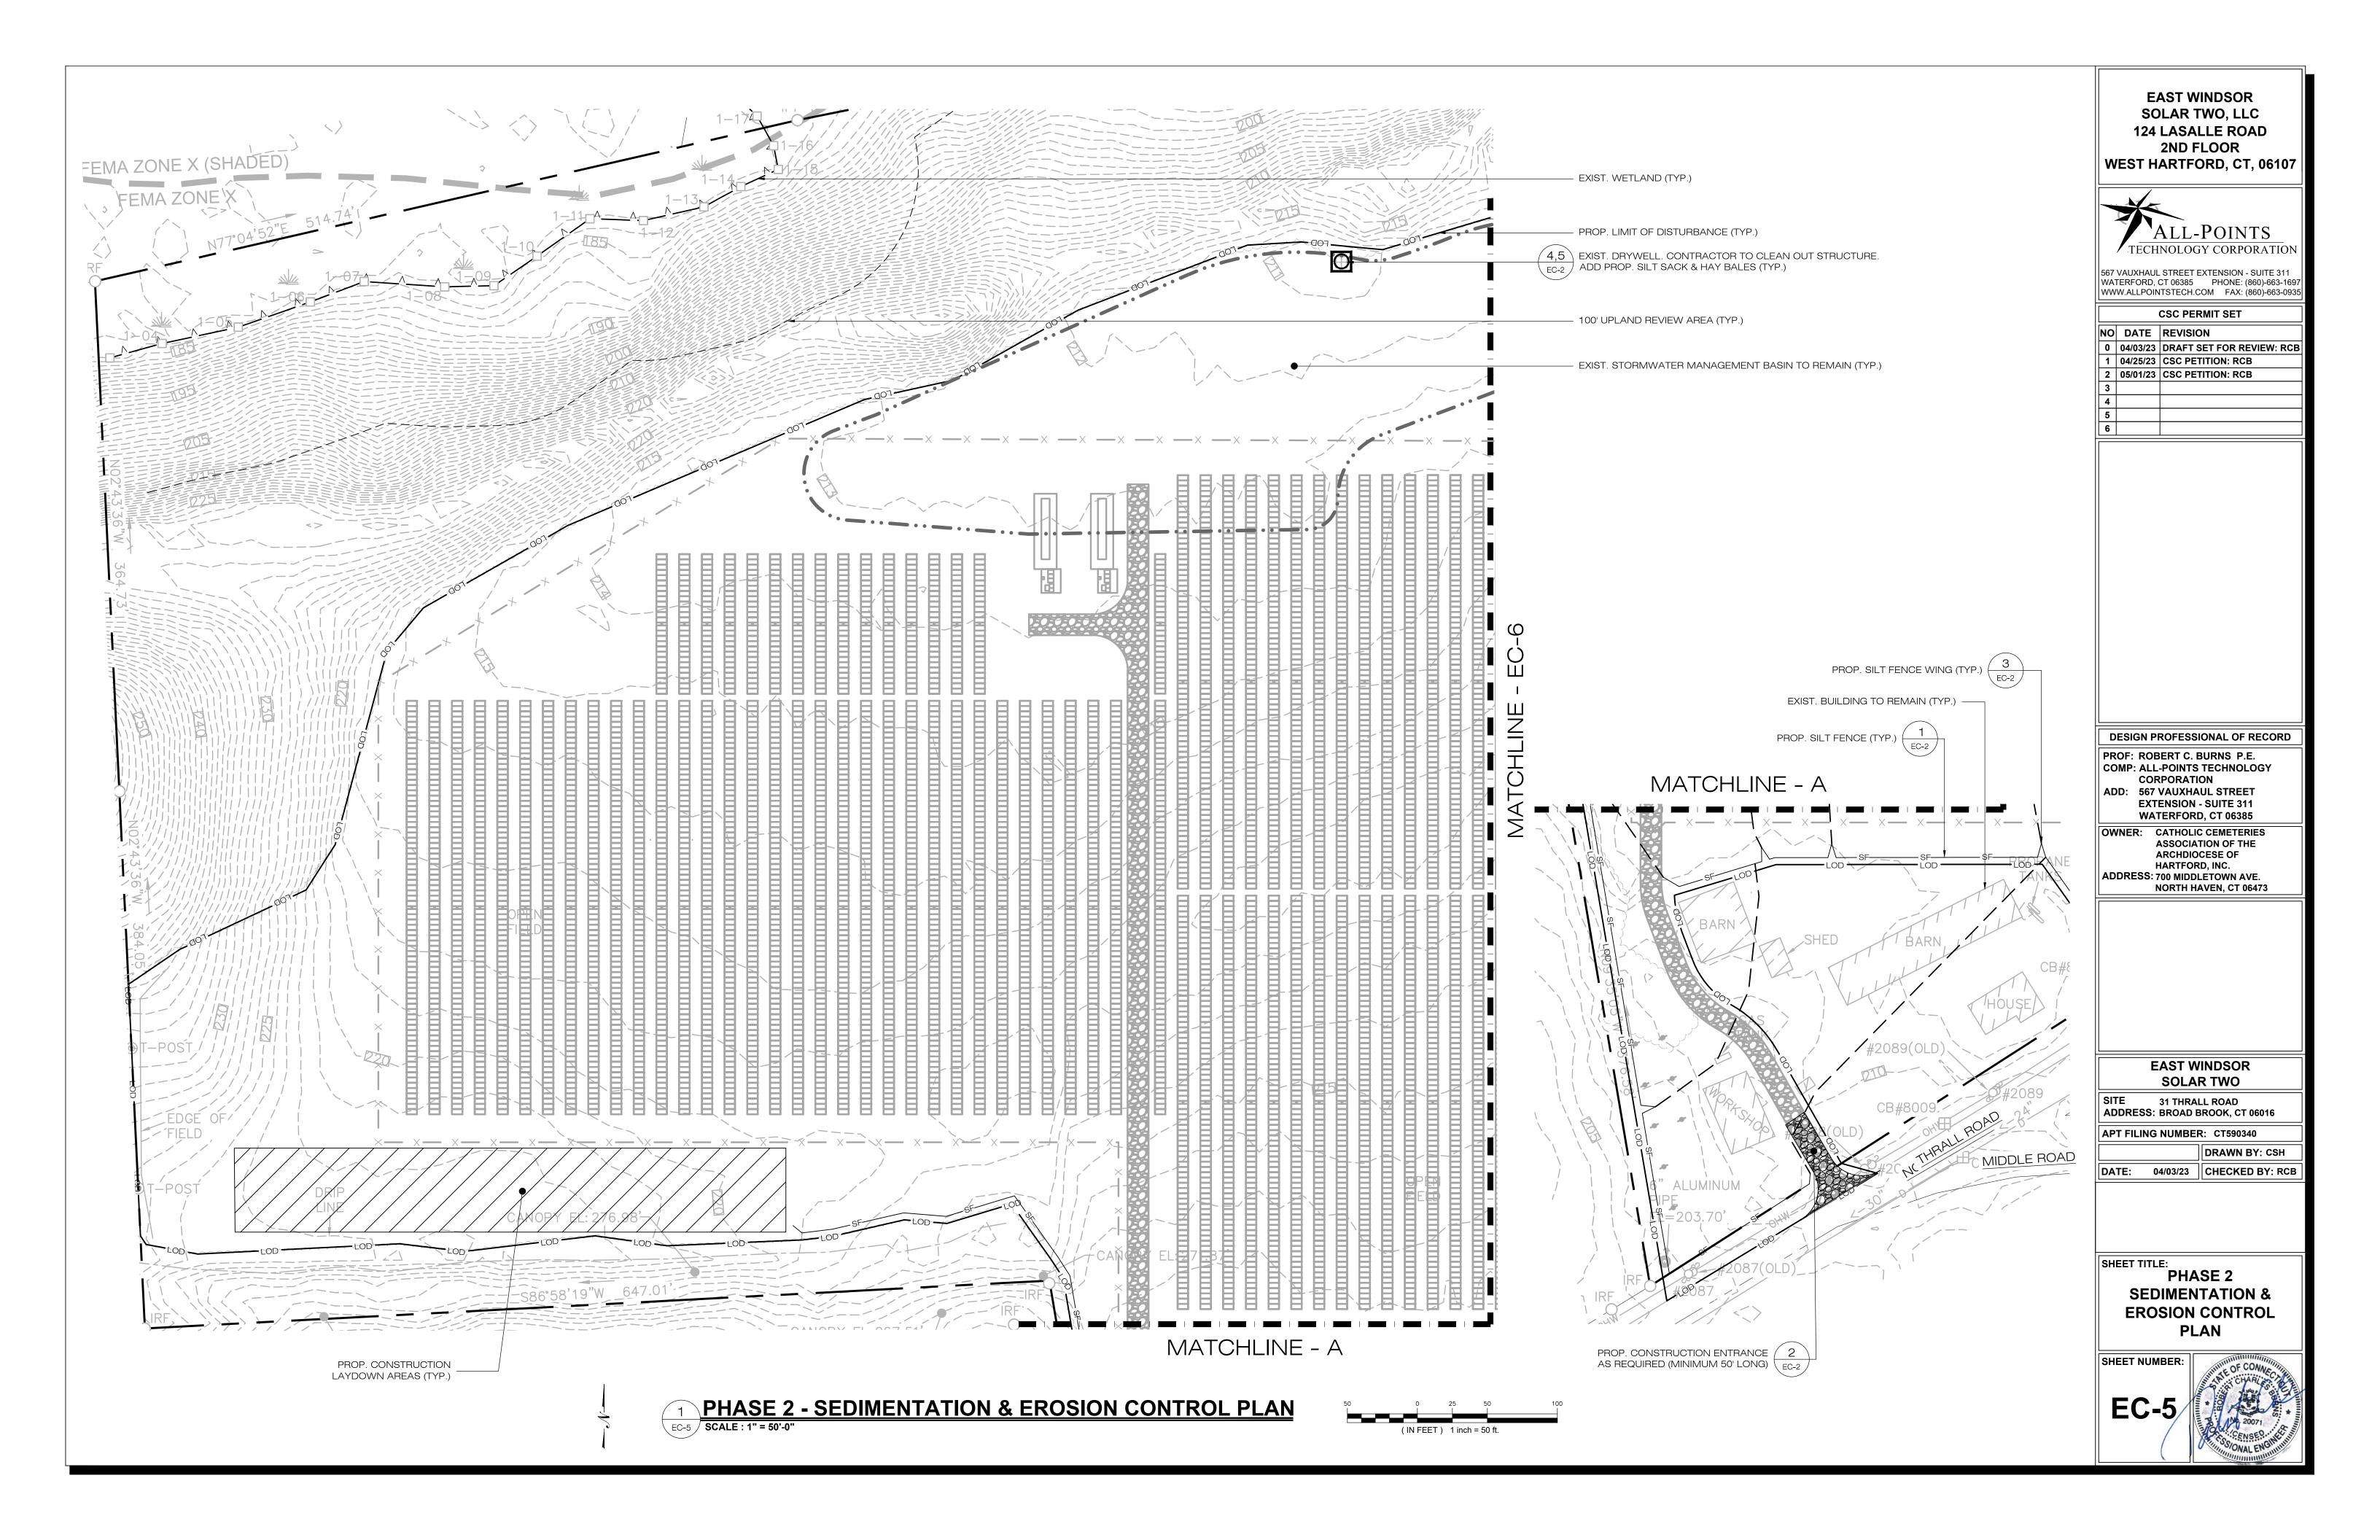


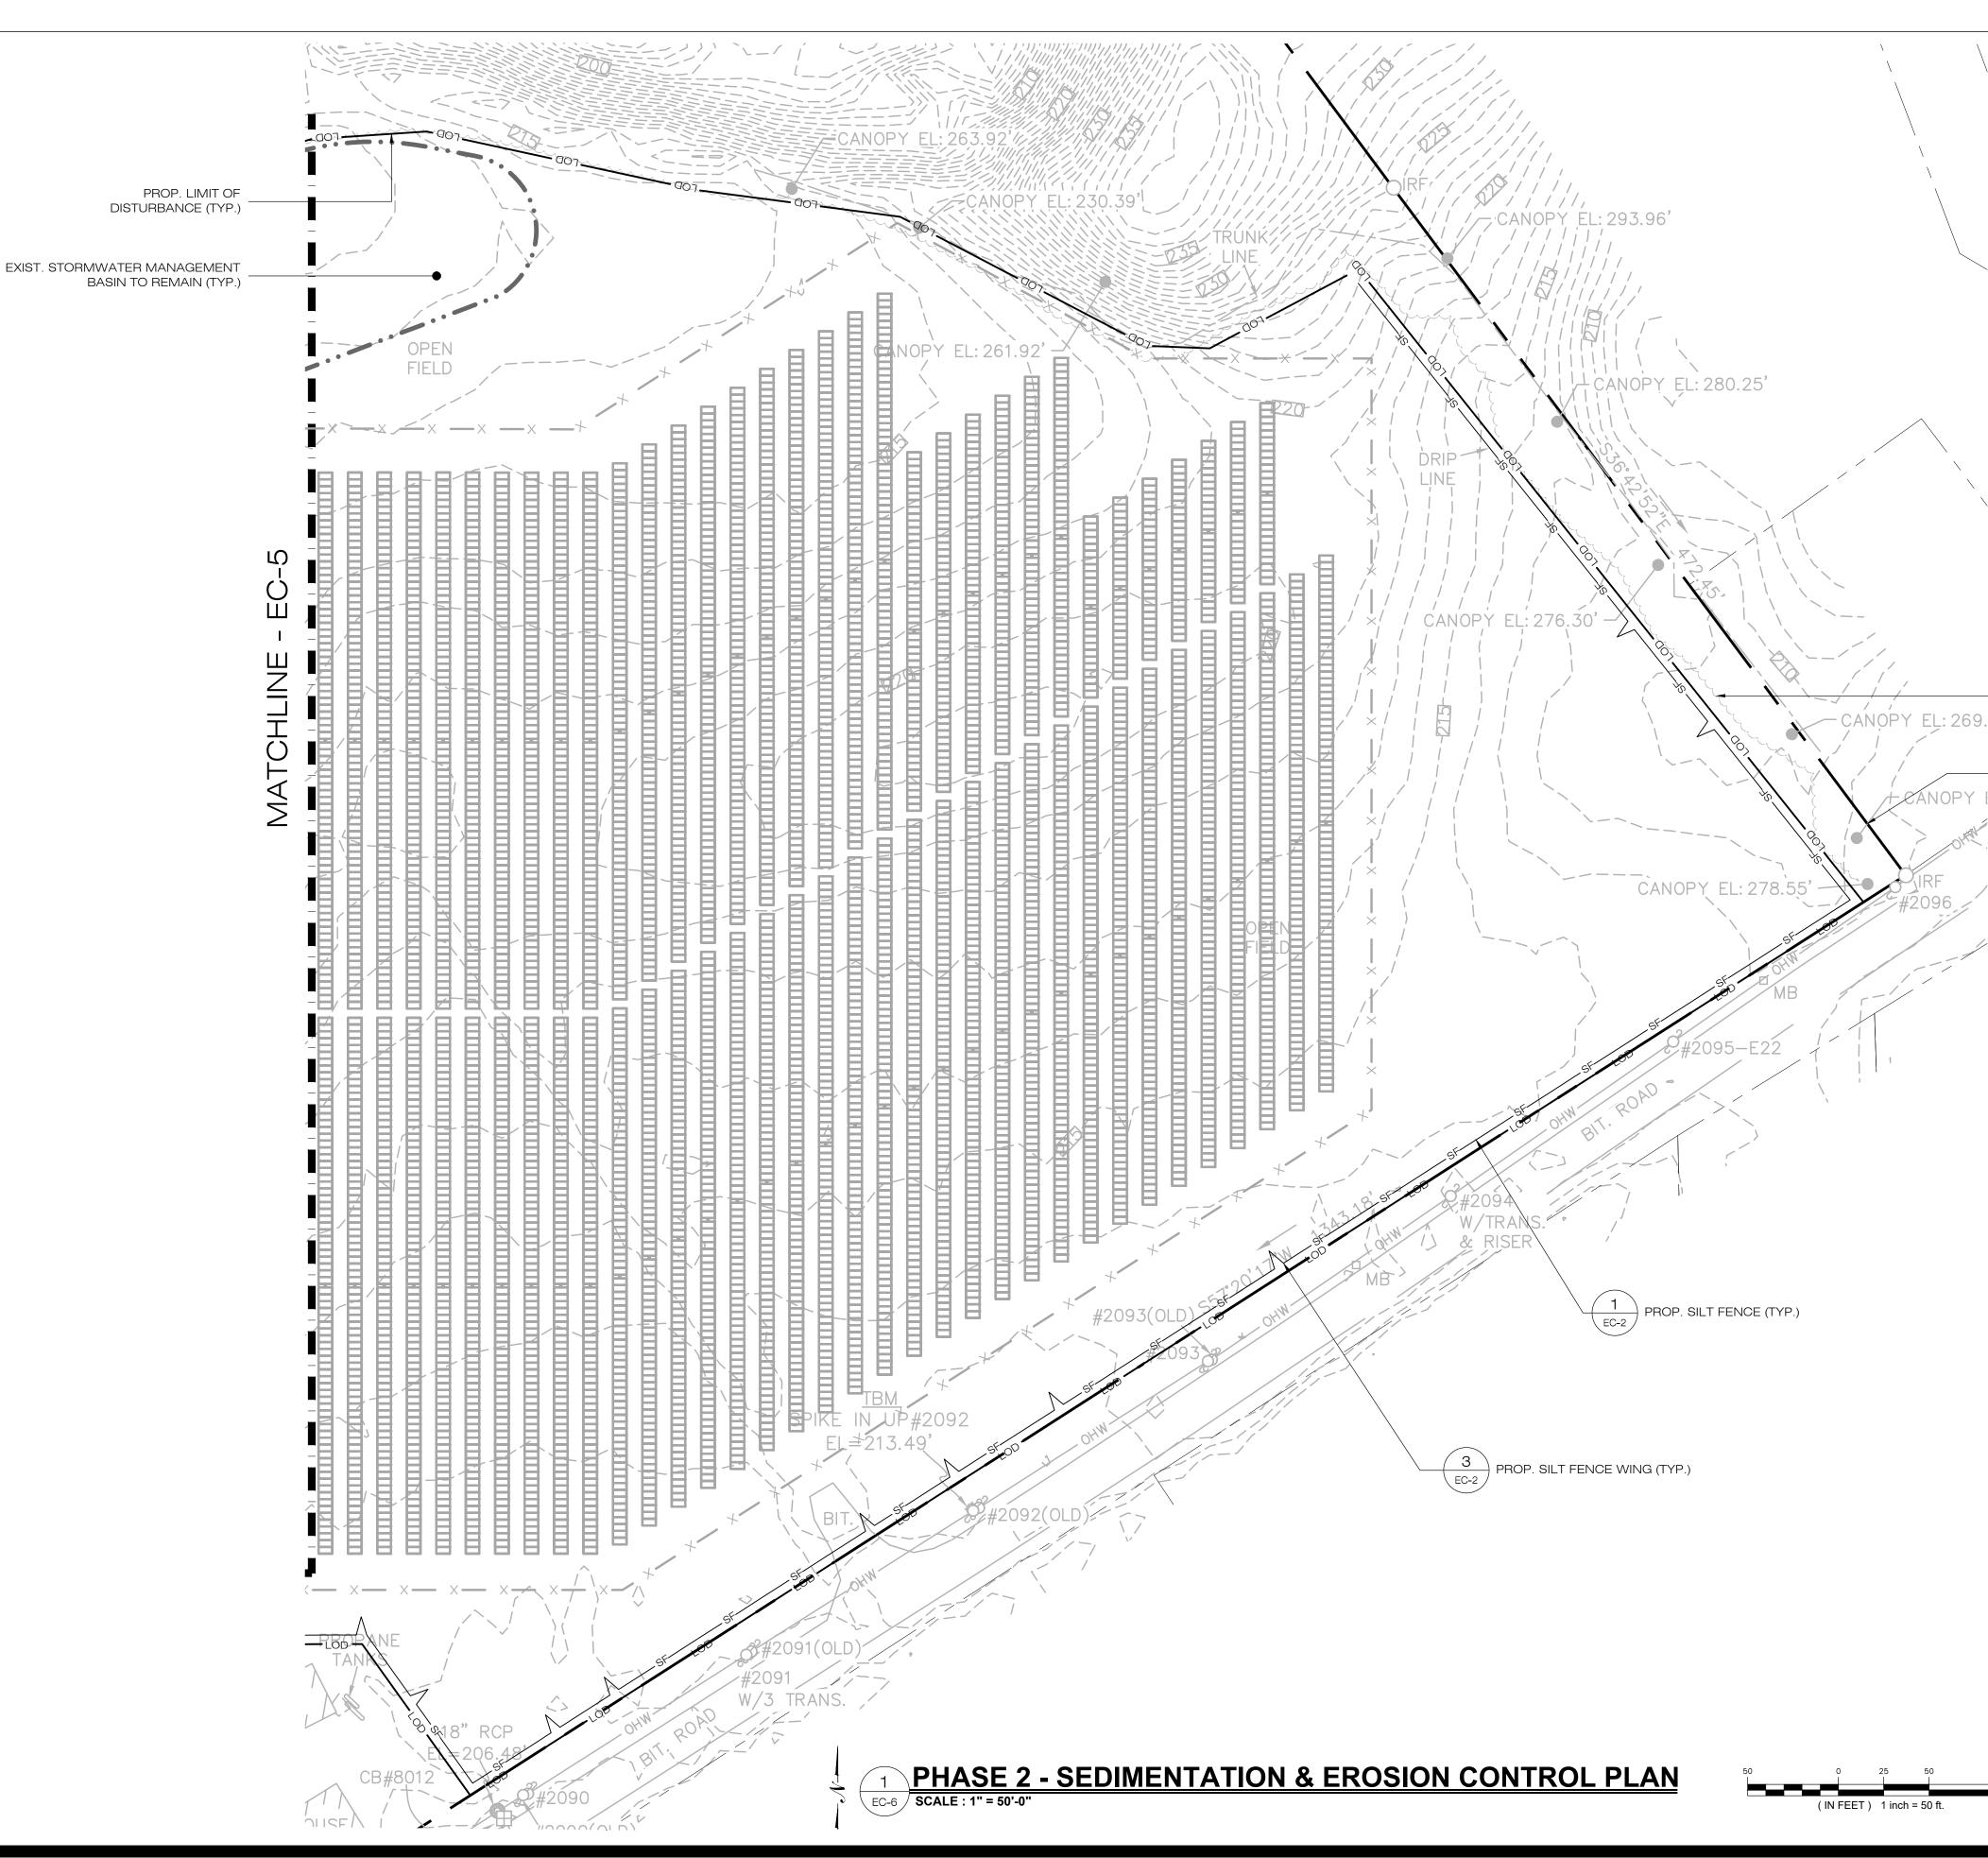


w	SO 124	LAR T LASA 2ND F	VINDSOR WO, LLC LLE ROAD LOOR DRD, CT, 06107
567	TECH	NOLOG	POINTS BY CORPORATION
WA1	Terford, (W.Allpoin	CT 06385 TSTECH.C	PHONE: (860)-663-169
NO 0 1 2	DATE 04/03/23 04/25/23	REVISIO DRAFT S CSC PE	
3 4 5 6			
	OF: ROB OMP: ALL COR DD: 567 V EXTI WAT VNER: C / / DRESS: 7	ERT C. E POINTS PORATI /AUXHA ENSION ERFORI CATHOLIC ASSOCIA ARCHDIO IARTFOR 00 MIDDI	UL STREET - SUITE 311 D, CT 06385 C CEMETERIES TION OF THE CESE OF
	E		/INDSOR R TWO
	DRESS:	BROAD E	LL ROAD BROOK, CT 06016 R: CT590340
	TE: 0 [,]	4/03/23	DRAWN BY: CSH CHECKED BY: RCB
		PHA IMEN	SE 2 TATION & NTROL PLAN
	EET NUM		CHARLOS CONNECTION OF CONNECTI

PROPERTY LINE (TYP.)

EXIST. TREE LINE (TYP.)

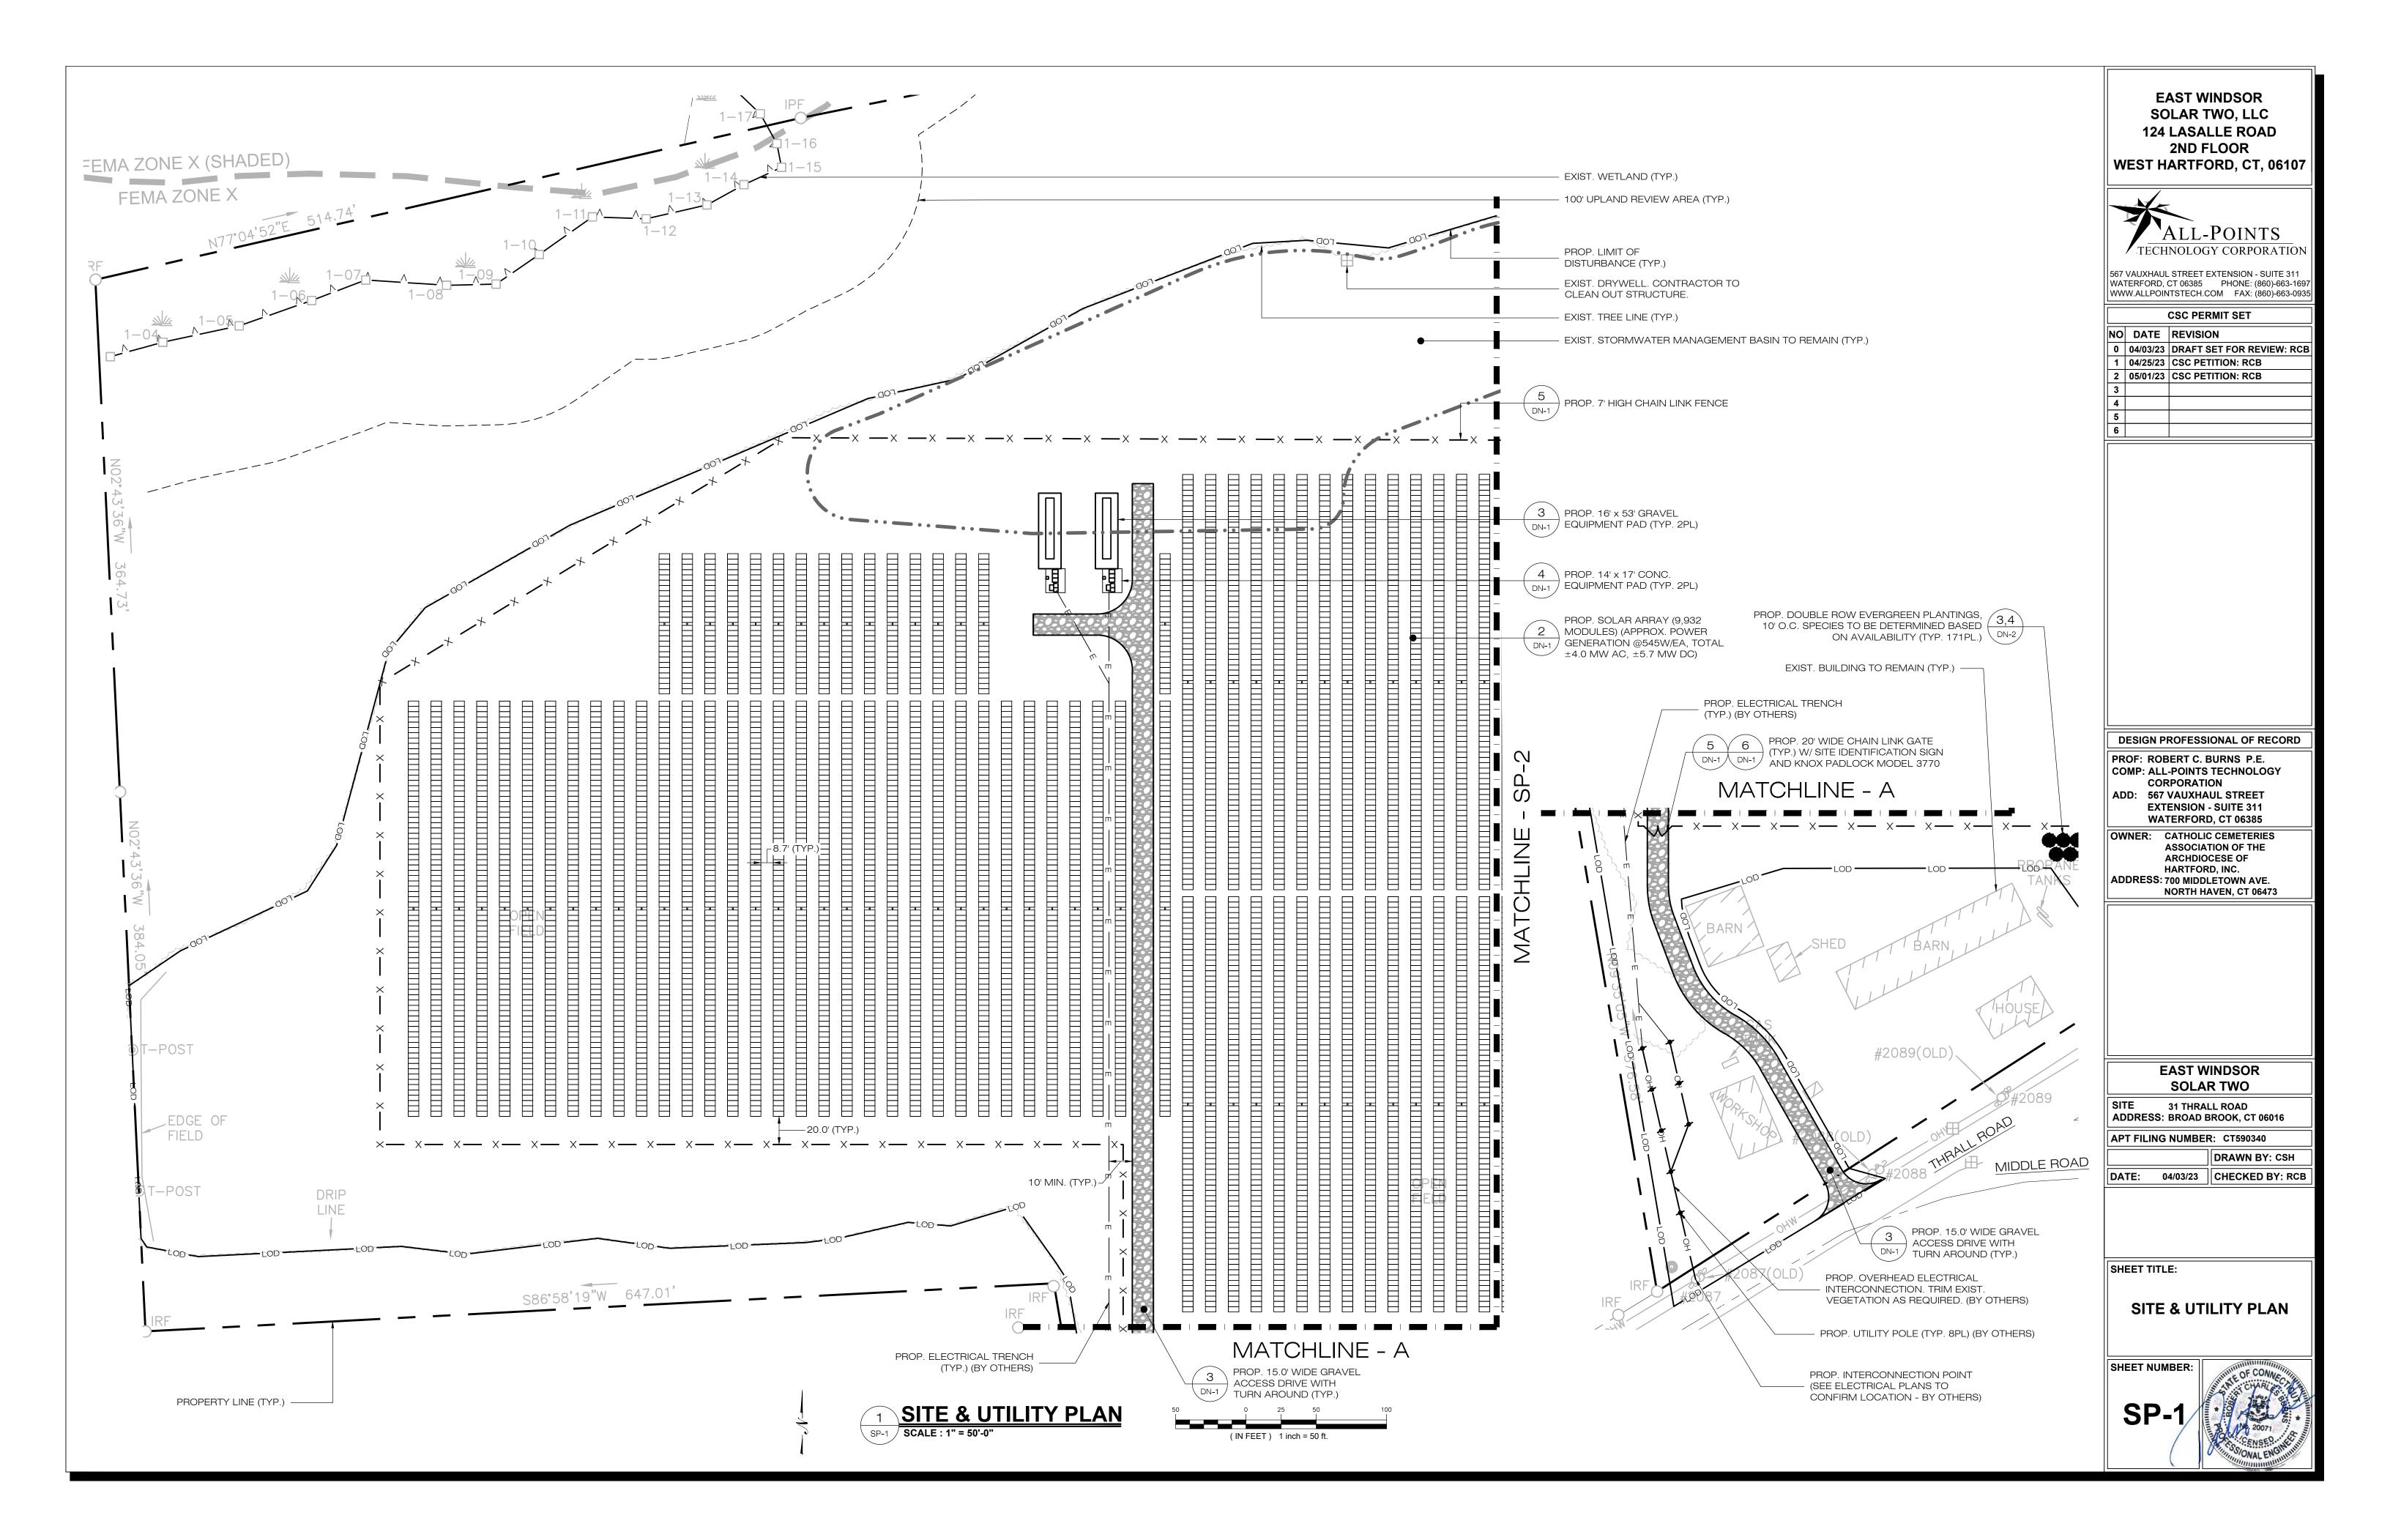

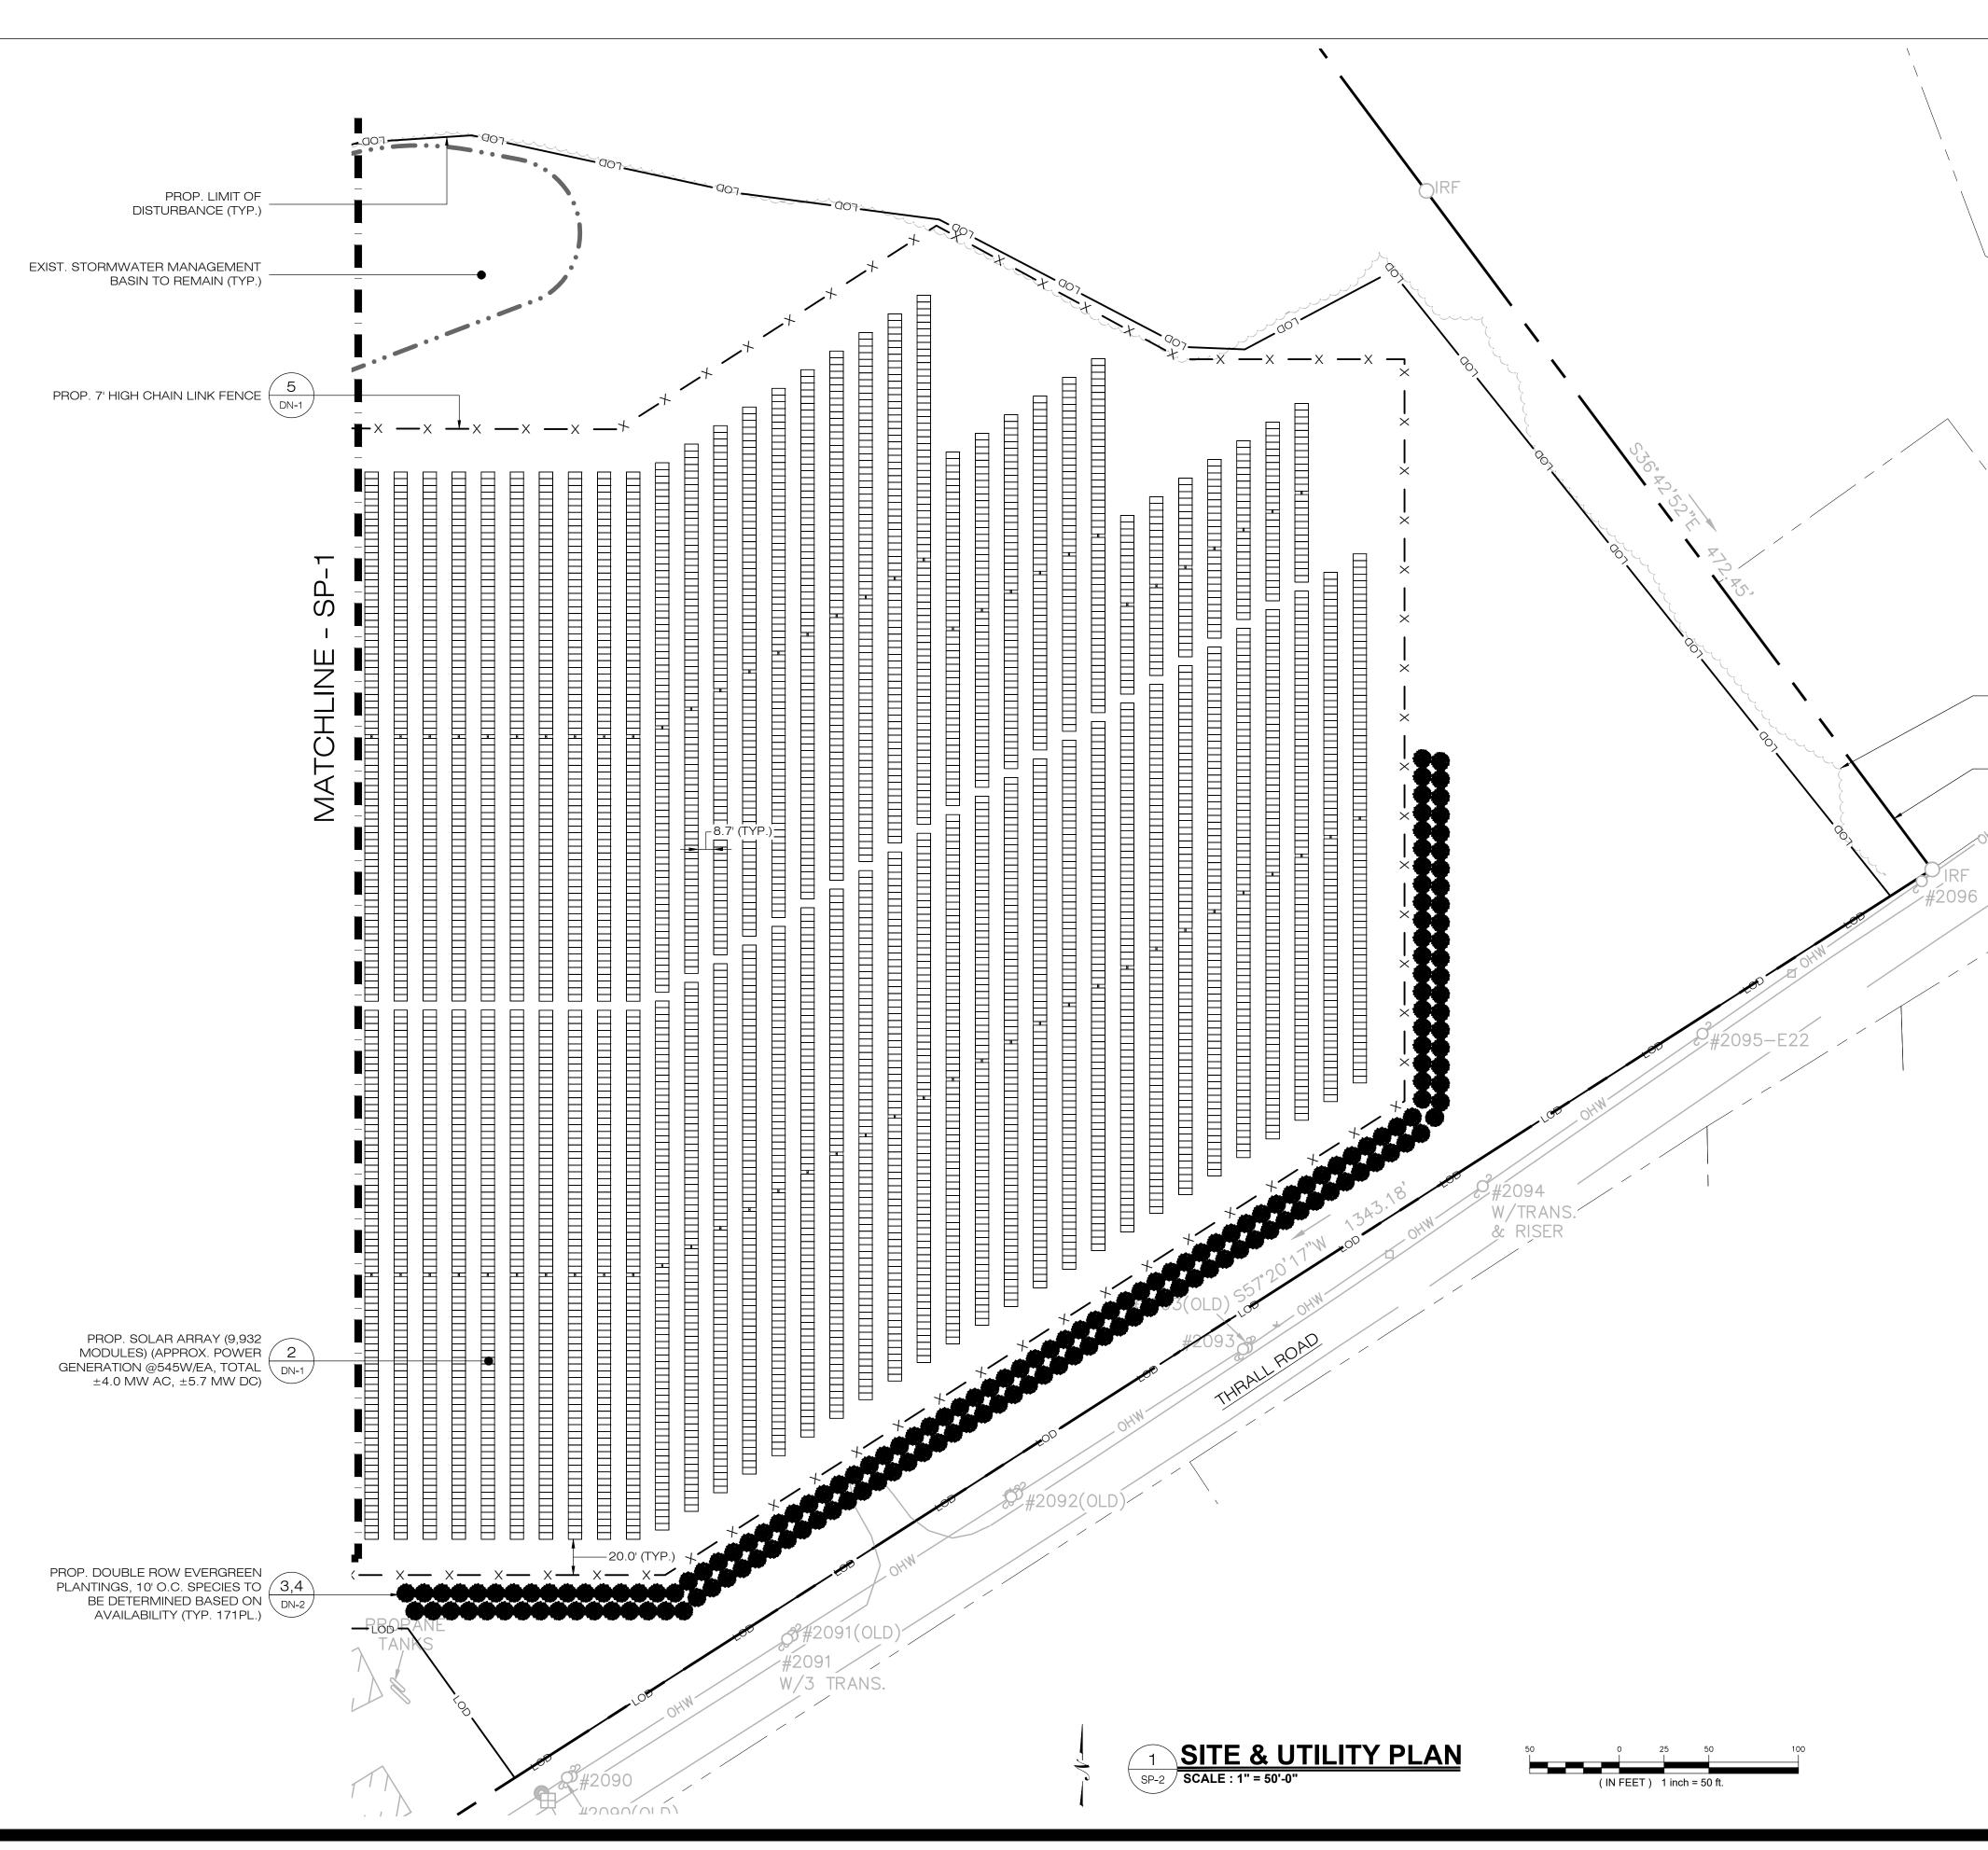

	E A OT	
	EAST	WINDSOR
		R TWO, LLC
	124 LAS	ALLE ROAD
	21/1	FLOOR
	WEST HART	FORD, CT, 06107
	ALI	L-POINTS
	TECHNOL	OGY CORPORATION
	567 VAUXHAUL STRE	ET EXTENSION - SUITE 311
	WATERFORD, CT 063	B5 PHONE: (860)-663-1697
	WWW.ALLPOINTSTEC	H.COM FAX: (860)-663-0935
		PERMIT SET
	C3C1	
	NO DATE REVI	SION
	0 04/03/23 DRAF	T SET FOR REVIEW: RCB
	1 04/25/23 CSC	
		PETITION: RCB
	3	
	4	
	5	
	6	
		SSIONAL OF RECORD
	PROF: ROBERT	C. BURNS PF
		TS TECHNOLOGY
	COMP: ALL-POIN CORPOR	
	ADD: 567 VAUX	
	THE JUI VAUA	
I	EVTENO	
		ON - SUITE 311
	WATERFO	DRD, CT 06385
	WATERFO	DRD, CT 06385
	WATERFO	DRD, CT 06385 DLIC CEMETERIES CIATION OF THE
	WATERFO OWNER: CATHO ASSOC ARCHI	ORD, CT 06385 DLIC CEMETERIES CIATION OF THE DIOCESE OF
	WATERFO OWNER: CATHO ASSOC ARCHI HARTF	DRD, CT 06385 DLIC CEMETERIES CIATION OF THE DIOCESE OF ORD, INC.
	WATERFO OWNER: CATHO ASSOC ARCHI HARTF ADDRESS: 700 MI	DRD, CT 06385 DLIC CEMETERIES CIATION OF THE DIOCESE OF ORD, INC. DDLETOWN AVE.
	WATERFO OWNER: CATHO ASSOC ARCHI HARTF ADDRESS: 700 MI	DRD, CT 06385 DLIC CEMETERIES CIATION OF THE DIOCESE OF ORD, INC.
	WATERFO OWNER: CATHO ASSOC ARCHI HARTF ADDRESS: 700 MI	DRD, CT 06385 DLIC CEMETERIES CIATION OF THE DIOCESE OF ORD, INC. DDLETOWN AVE.
	WATERFO OWNER: CATHO ASSOC ARCHI HARTF ADDRESS: 700 MI	DRD, CT 06385 DLIC CEMETERIES CIATION OF THE DIOCESE OF ORD, INC. DDLETOWN AVE.
	WATERFO	ORD, CT 06385 DLIC CEMETERIES CIATION OF THE DIOCESE OF ORD, INC. DDLETOWN AVE. I HAVEN, CT 06473
	WATERFO	ORD, CT 06385 DLIC CEMETERIES DIATION OF THE DIOCESE OF ORD, INC. DDLETOWN AVE. I HAVEN, CT 06473
	WATERFO	ORD, CT 06385 DLIC CEMETERIES CIATION OF THE DIOCESE OF ORD, INC. DDLETOWN AVE. I HAVEN, CT 06473
	WATERFO	DRD, CT 06385 DLIC CEMETERIES DIATION OF THE DIOCESE OF ORD, INC. DDLETOWN AVE. I HAVEN, CT 06473
	WATERFO	DRD, CT 06385 DLIC CEMETERIES DIATION OF THE DIOCESE OF ORD, INC. DDLETOWN AVE. I HAVEN, CT 06473 WINDSOR AR TWO RALL ROAD
	WATERFO	DRD, CT 06385 DLIC CEMETERIES DIATION OF THE DIOCESE OF ORD, INC. DDLETOWN AVE. I HAVEN, CT 06473
	WATERFO	DRD, CT 06385 DLIC CEMETERIES DIATION OF THE DIOCESE OF ORD, INC. DDLETOWN AVE. I HAVEN, CT 06473 WINDSOR AR TWO RALL ROAD D BROOK, CT 06016
	WATERFO	DRD, CT 06385 DLIC CEMETERIES DIATION OF THE DIOCESE OF ORD, INC. DDLETOWN AVE. I HAVEN, CT 06473 WINDSOR AR TWO RALL ROAD D BROOK, CT 06016 BER: CT590340
	WATERFO	DRD, CT 06385 DLIC CEMETERIES DIATION OF THE DIOCESE OF ORD, INC. DDLETOWN AVE. I HAVEN, CT 06473 WINDSOR AR TWO RALL ROAD D BROOK, CT 06016
	WATERFO	DRD, CT 06385 DLIC CEMETERIES DIATION OF THE DIOCESE OF ORD, INC. DDLETOWN AVE. HAVEN, CT 06473 WINDSOR AR TWO RALL ROAD D BROOK, CT 06016 BER: CT590340 DRAWN BY: CSH
	WATERFO	DRD, CT 06385 DLIC CEMETERIES DIATION OF THE DIOCESE OF ORD, INC. DDLETOWN AVE. HAVEN, CT 06473 WINDSOR AR TWO RALL ROAD D BROOK, CT 06016 BER: CT590340 DRAWN BY: CSH
	WATERFO	DRD, CT 06385 DLIC CEMETERIES CIATION OF THE DIOCESE OF ORD, INC. DDLETOWN AVE. I HAVEN, CT 06473 WINDSOR AR TWO RALL ROAD D BROOK, CT 06016 BER: CT590340 DRAWN BY: CSH 3 CHECKED BY: RCB
	WATERFO	DRD, CT 06385 DLIC CEMETERIES DIATION OF THE DIOCESE OF ORD, INC. DDLETOWN AVE. HAVEN, CT 06473 WINDSOR AR TWO RALL ROAD D BROOK, CT 06016 BER: CT590340 DRAWN BY: CSH
	WATERFO	DRD, CT 06385 DLIC CEMETERIES CIATION OF THE DIOCESE OF ORD, INC. DDLETOWN AVE. I HAVEN, CT 06473 WINDSOR AR TWO RALL ROAD D BROOK, CT 06016 BER: CT590340 DRAWN BY: CSH 3 CHECKED BY: RCB
	WATERFO	DRD, CT 06385 DLIC CEMETERIES CIATION OF THE DIOCESE OF ORD, INC. DDLETOWN AVE. I HAVEN, CT 06473 WINDSOR AR TWO RALL ROAD D BROOK, CT 06016 BER: CT590340 DRAWN BY: CSH 3 CHECKED BY: RCB
	WATERFO	DRD, CT 06385 DLIC CEMETERIES CIATION OF THE DIOCESE OF ORD, INC. DDLETOWN AVE. I HAVEN, CT 06473 WINDSOR AR TWO RALL ROAD D BROOK, CT 06016 BER: CT590340 DRAWN BY: CSH 3 CHECKED BY: RCB
	WATERFO	DRD, CT 06385 DLIC CEMETERIES CIATION OF THE DIOCESE OF ORD, INC. DDLETOWN AVE. I HAVEN, CT 06473 WINDSOR AR TWO RALL ROAD D BROOK, CT 06016 BER: CT590340 DRAWN BY: CSH 3 CHECKED BY: RCB
	WATERFO	DRD, CT 06385 DLIC CEMETERIES CIATION OF THE DIOCESE OF ORD, INC. DDLETOWN AVE. I HAVEN, CT 06473 WINDSOR AR TWO RALL ROAD D BROOK, CT 06016 BER: CT590340 DRAWN BY: CSH 3 CHECKED BY: RCB
	WATERFO	DRD, CT 06385 DLIC CEMETERIES CIATION OF THE DIOCESE OF ORD, INC. DDLETOWN AVE. I HAVEN, CT 06473 WINDSOR AR TWO RALL ROAD D BROOK, CT 06016 BER: CT590340 DRAWN BY: CSH 3 CHECKED BY: RCB
	WATERFO	DRD, CT 06385 DLIC CEMETERIES CIATION OF THE DIOCESE OF ORD, INC. DDLETOWN AVE. HAVEN, CT 06473 WINDSOR AR TWO RALL ROAD D BROOK, CT 06016 BRCOK, CT 06016 BRCOK, CT 06016 BRCOK, CT 06016 BRCOK, CT 06016 CHECKED BY: RCB
	WATERFO OWNER: CATHO ASSOC ARCHI HARTF ADDRESS: 700 MII NORTH NORTH EAST SOL SITE 31 TH ADDRESS: BROA APT FILING NUME DATE: 04/03/23 SHEET TITLE: SITE & U SHEET NUMBER:	DRD, CT 06385 DLIC CEMETERIES CIATION OF THE DIOCESE OF ORD, INC. DDLETOWN AVE. I HAVEN, CT 06473 WINDSOR AR TWO RALL ROAD D BROOK, CT 06016 BER: CT590340 DRAWN BY: CSH 3 CHECKED BY: RCB
	WATERFO OWNER: CATHO ASSOC ARCHI HARTF ADDRESS: 700 MII NORTH NORTH EAST SOL SITE 31 TH ADDRESS: BROA APT FILING NUME DATE: 04/03/23 SHEET TITLE: SITE & U SHEET NUMBER:	DRD, CT 06385 DLIC CEMETERIES CIATION OF THE DIOCESE OF ORD, INC. DDLETOWN AVE. I HAVEN, CT 06473 WINDSOR AR TWO RALL ROAD D BROOK, CT 06016 BER: CT590340 DRAWN BY: CSH 3 CHECKED BY: RCB
	WATERFO	DRD, CT 06385 DLIC CEMETERIES CIATION OF THE DIOCESE OF ORD, INC. DDLETOWN AVE. I HAVEN, CT 06473 WINDSOR AR TWO RALL ROAD D BROOK, CT 06016 BER: CT590340 DRAWN BY: CSH 3 CHECKED BY: RCB
	WATERFO OWNER: CATHO ASSOC ARCHI HARTF ADDRESS: 700 MII NORTH NORTH EAST SOL SITE 31 TH ADDRESS: BROA APT FILING NUME DATE: 04/03/23 SHEET TITLE: SITE & U SHEET NUMBER:	DRD, CT 06385 DLIC CEMETERIES CIATION OF THE DIOCESE OF ORD, INC. DDLETOWN AVE. I HAVEN, CT 06473 WINDSOR AR TWO RALL ROAD D BROOK, CT 06016 BER: CT590340 DRAWN BY: CSH 3 CHECKED BY: RCB
	WATERFO OWNER: CATHO ASSOC ARCHI HARTF ADDRESS: 700 MII NORTH NORTH EAST SOL SITE 31 TH ADDRESS: BROA APT FILING NUME DATE: 04/03/23 SHEET TITLE: SITE & U SHEET NUMBER:	DRD, CT 06385 DLIC CEMETERIES CIATION OF THE DIOCESE OF ORD, INC. DDLETOWN AVE. I HAVEN, CT 06473 WINDSOR AR TWO RALL ROAD D BROOK, CT 06016 BER: CT590340 DRAWN BY: CSH 3 CHECKED BY: RCB


------ EXIST. TREE LINE (TYP.)

------ PROPERTY LINE (TYP.)

X

/

/

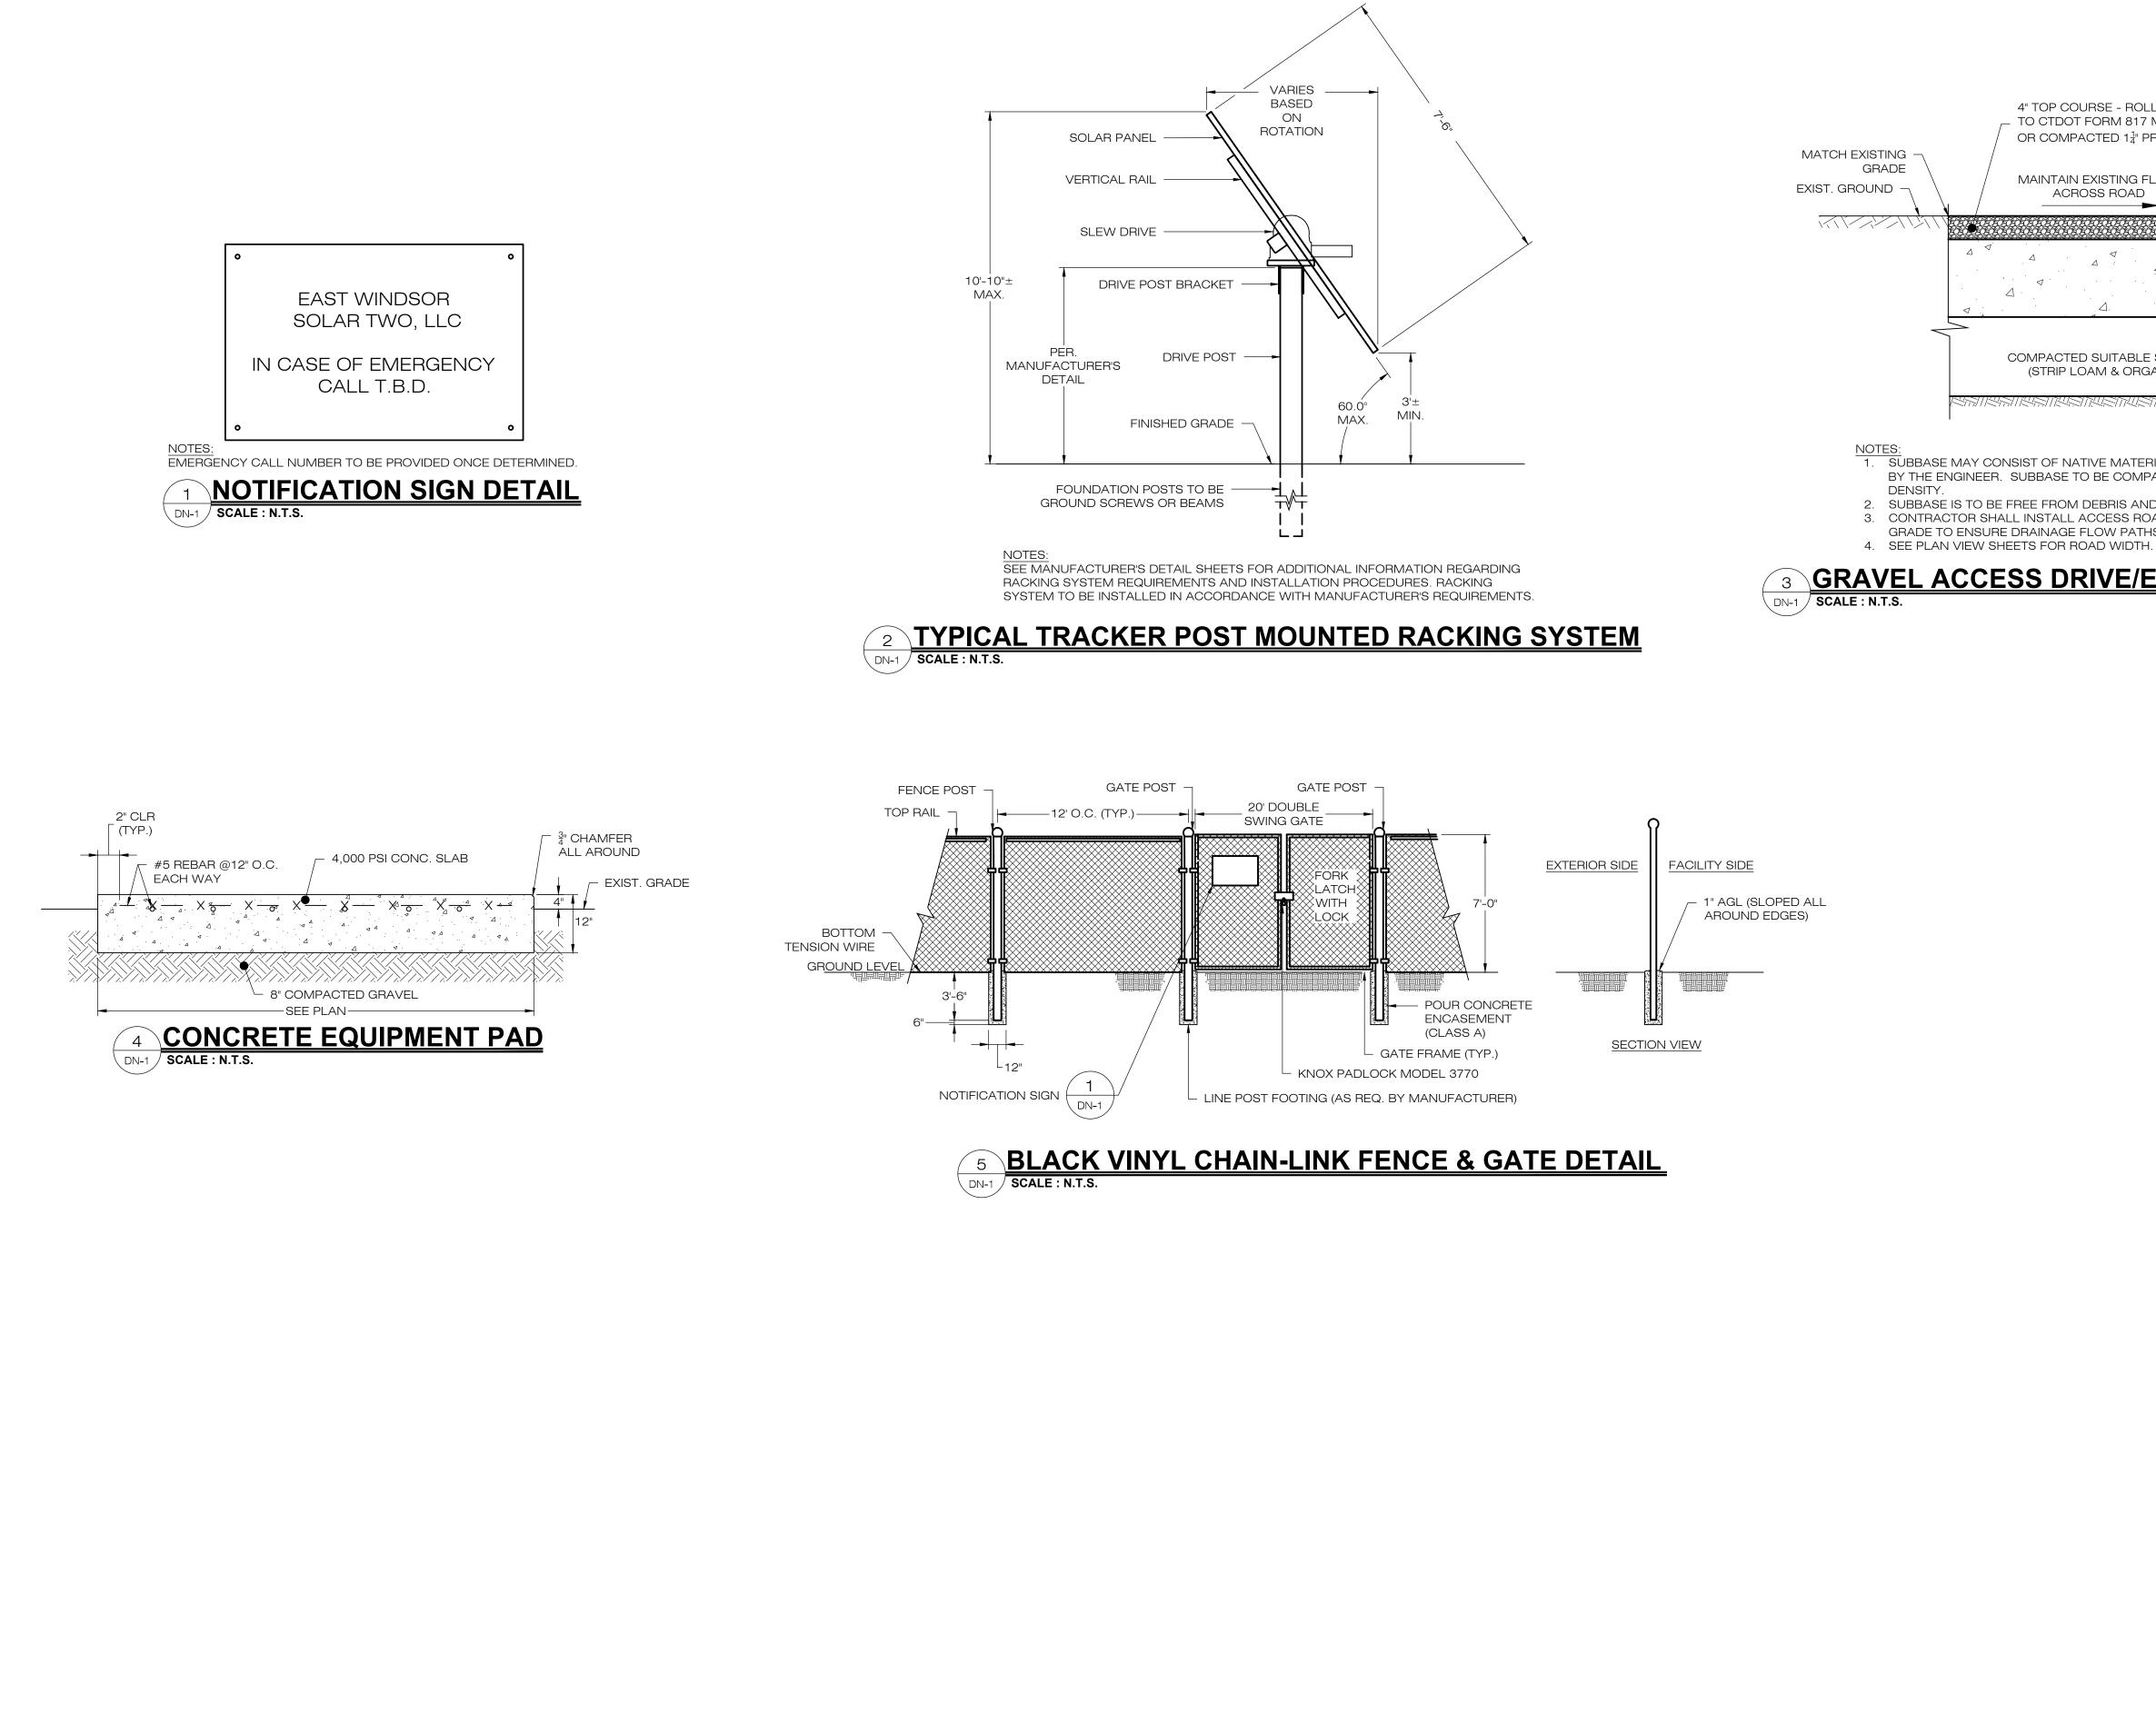

4" TOP COURSE - ROLLED BANK RUN GRAVEL CONFORMING TO CTDOT FORM 817 M.02.03 AND M.02.03 GRADATION "C" OR COMPACTED 1¹/₄" PROCESSED TRAPROCK MIX - MATCH EXISTING GRADE MAINTAIN EXISTING FLOW ACROSS ROAD - EXIST. GROUND 8" BINDER COURSE -ROLLED BANK RUN GRAVEL CONFORMING TO CTDOT FORM 817 M.02.03 AND M.02.06 GRADATION "A" COMPACTED SUITABLE SUBBASE GEOTEXTILE FABRIC (STRIP LOAM & ORGANICS) (MIRAFI 140N OR APPROVED EQUAL)

1. SUBBASE MAY CONSIST OF NATIVE MATERIALS IF FOUND ACCEPTABLE BY THE ENGINEER. SUBBASE TO BE COMPACTED TO 95% MAX DRY

2. SUBBASE IS TO BE FREE FROM DEBRIS AND UNSUITABLE MATERIALS. 3. CONTRACTOR SHALL INSTALL ACCESS ROAD FLUSH WITH EXISTING GRADE TO ENSURE DRAINAGE FLOW PATHS ARE MAINTAINED.

GRAVEL ACCESS DRIVE/EQUIPMENT PAD SECTION

EAST WINDSOR SOLAR TWO, LLC 124 LASALLE ROAD 2ND FLOOR WEST HARTFORD, CT, 06107 **'**ALL-POINTS TECHNOLOGY CORPORATIO 567 VAUXHAUL STREET EXTENSION - SUITE 311 WATERFORD, CT 06385 PHONE: (860)-663-1697 WWW.ALLPOINTSTECH.COM FAX: (860)-663-0935 CSC PERMIT SET NO DATE REVISION 04/03/23 DRAFT SET FOR REVIEW: RCB 0 04/25/23 CSC PETITION: RCB 2 05/01/23 CSC PETITION: RCB ||3| 4 5 6 DESIGN PROFESSIONAL OF RECORD PROF: ROBERT C. BURNS P.E. COMP: ALL-POINTS TECHNOLOGY CORPORATION ADD: 567 VAUXHAUL STREET **EXTENSION - SUITE 311** WATERFORD, CT 06385 OWNER: CATHOLIC CEMETERIES ASSOCIATION OF THE ARCHDIOCESE OF HARTFORD, INC. ADDRESS: 700 MIDDLETOWN AVE. NORTH HAVEN, CT 06473 EAST WINDSOR SOLAR TWO SITE 31 THRALL ROAD ADDRESS: BROAD BROOK, CT 06016 APT FILING NUMBER: CT590340 DRAWN BY: CSH DATE: 04/03/23 CHECKED BY: RCB SHEET TITLE: SITE DETAILS SHEET NUMBER: DN-1



Ernst Conservation Seeds 8884 Mercer Pike Meadville, PA 16335 (800) 873-3321 Fax (814) 336-5191 www.ernstseed.com

Date: April 14, 2021

Fuzz & Buzz Mix - Premium - ERNMX-147

	Botanical Name	Common Name	Price/lb
24.20 %	Lolium perenne, 'Crave', Tetraploid	Perennial Ryegrass, 'Crave', Tetraploid	3.48
17.70 %	Dactylis glomerata, 'Pennlate'	Orchardgrass, 'Pennlate'	3.00
17.70 %	Festuca elatior	Meadow Fescue	4.80
17.70 %	Poa pratensis, 'Ginger'	Kentucky Bluegrass, 'Ginger' (pasture type)	3.36
5.40 %	Trifolium hybridum	Alsike Clover	3.90
4.90 %	Trifolium incarnatum, Variety Not Stated	Crimson Clover, Variety Not Stated	1.92
4.50 %	Trifolium pratense, Medium, Variety Not Stated	Red Clover, Medium, Variety Not Stated	3.00
2.00 %	Lotus corniculatus, 'Leo'	Bird's Foot Trefoil, 'Leo'	7.50
1.30 %	Chrysanthemum leucanthemum	Oxeye Daisy	33.60
1.30 %	Cichorium intybus	Blue Chicory	19.20
0.80 %	Chamaecrista fasciculata, PA Ecotype	Partridge Pea, PA Ecotype	7.20
0.40 %	Aster oblongifolius, PA Ecotype	Aromatic Aster, PA Ecotype	336.00
0.40 %	Aster prenanthoides, PA Ecotype	Zigzag Aster, PA Ecotype	432.00
0.40 %	Coreopsis lanceolata	Lanceleaf Coreopsis	28.80
0.40 %	Tradescantia ohiensis, PA Ecotype	Ohio Spiderwort, PA Ecotype	192.00
0.40 %	Zizia aurea	Golden Alexanders	288.00
0.30 %	Solidago nemoralis, PA Ecotype	Gray Goldenrod, PA Ecotype	336.00
0.10 %	Asclepias syriaca	Common Milkweed	163.20
0.10 %	Penstemon hirsutus	Hairy Beardtongue	480.00
00.00 %		Mix Price/Ib Bulk:	\$10.91

100.00 %

Seeding Rate: Expect to apply about 42 lbs per acre with a cover crop of annual ryegrass at 12 lbs/acre.

Forage & Pasture Sites; Solar Sites



_____ Elymus I Schizach Festuca Andropo Panicun Vernoni Agrostis Bidens Eupator Eupator Aster no Scirpus Juncus

NEW ENGLAND WETLAND PLANTS, INC

820 WEST STREET, AMHERST, MA 01002 PHONE: 413-548-8000 FAX 413-549-4000


EMAIL: INFO@NEWP.COM WEB ADDRESS: WWW.NEWP.COM New England Erosion Control/Restoration Mix For Detention Basins and Moist Sites

Botanical Name	Common Name	Indicator	
Elymus riparius	Riverbank Wild Rye	FACW	
Schizachyrium scoparium	Little Bluestem	FACU	
Festuca rubra	Red Fescue	FACU	
Andropogon gerardii	Big Bluestem	FAC	
Panicum virgatum	Switch Grass	FAC	
Vernonia noveboracensis	New York Ironweed	FACW+	
Agrostis perennans	Upland Bentgrass	FACU	
Bidens frondosa	Beggar Ticks	FACW	
Eupatorium maculatum (Eutrochium maculatum)	Spotted Joe Pye Weed	OBL	
Eupatorium perfoliatum	Boneset	FACW	
Aster novae-angliae (Symphyotrichum novae-anglia	New England Aster	FACW-	
Scirpus cyperinus	Wool Grass	FACW	
Juncus effusus	Soft Rush	FACW+	
PRICE PER LB. \$37.00 MIN. QUANITY 3 LBS.	TOTAL: \$111.00	APPLY: 35 LBS/ACRE :1	

The New England Erosion Control/Restoration Mix for Detention Basins and Moist Sites contains a selection of native grasses and wildflowers designed to colonize generally moist, recently disturbed sites where quick growth of vegetation is desired to stabilize the soil surface. It is an appropriate seed mix for ecologically sensitive restorations that require stabilization as well as long-term establishment of native vegetation. This mix is particularly appropriate for detention basins that do not hold standing water. Many of the plants in this mix can tolerate infrequent inundation, but not constant flooding. The mix may be applied by hand, by mechanical spreader, or by hydroseeder. After sowing, lightly rake, roll or cultipack to insure good seed-to-soil contact. Best results are obtained with a Spring or late Summer seeding. Late Fall and Winter dormant seeding requires an increase in the application rate. A light mulching of clean, weed-free straw is recommended

New England Wetland Plants, Inc. may modify seed mixes at any time depending upon seed availability. The design criteria and ecological function of the mix will remain unchanged. Price is \$/bulk pound, FOB warehouse, Plus SH and applicable taxes.

STORMWATER MANAGEMENT BASIN MIX 2 DN-2 SCALE : N.T.S.

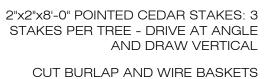

FROM TOP $rac{1}{3}$ OF ROOT BALL

4" MULCH - FINELY SHREDDED BARK MULCH (SAMPLE TO BE APPROVED)

3" SOIL SAUCER (TYP.) —

FINISHED GRADE -

PLANTING MIX -

SUBSOIL

SCARIFY GLAZED SIDES OR HARDENED SURFACES IF PITS ARE DUG WITH AUGERING DEVICE


COMPACT PLANTING MIX BELOW BALL. PITCH TO PERIMETER OF PIT



NOTE

IOWA JUNIPER



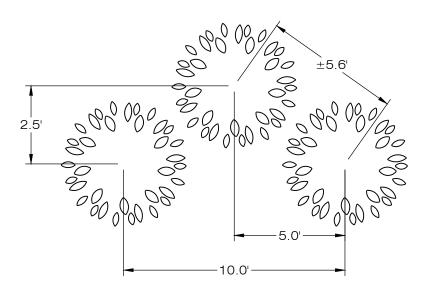

4 DN-2 SCALE : N.T.S.

