

THOMAS J. REGAN

March 19, 2021

VIA E-MAIL (<u>SITING.COUNCIL@CT.GOV</u>) & (<u>MELANIE.BACHMAN@CT.GOV</u>) & OVERNIGHT MAIL

Connecticut Siting Council Attn: Melanie A. Bachman, Esq., Executive Director Ten Franklin Square New Britain, CT 06051

RE: Petition for Declaratory Ruling - Windsor Locks, CT

Dear Executive Director Bachman:


Please find enclosed for filing one copy of New Cingular Wireless PCS LLC d/b/a AT&T's ("AT&T") Petition for Declaratory Ruling that no certificate of environmental compatibility and public need is required for AT&T to locate its antennas on the proposed pole located at 53 Ella T. Grasso Turnpike in Windsor Locks, Connecticut. Also enclosed is a check in the amount of \$625.00 representing the required filing fee.

A complete copy of the filing will be provided in PDF format electronically via One Drive.

Sincerely,

BROWN RUDNICK LLP

Thomas Regan

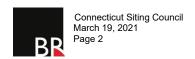

Cc: J. Christopher Kervick, First Selectman
Windsor Locks Town Hall
50 Church Street
Windsor Locks, CT 06096
ckervick@wlocks.com

Jennifer V. Rodriguez, AICP, CZEO, Town Planner Windsor Locks Town Hall Building and Land 50 Church Street Windsor Locks, CT 06096

Scott A. Nolan, Town Clerk Windsor Locks Town Hall 50 Church Street Windsor Locks, CT 06096

AT&T

Centerline Communications

Edward D. Pare, Jr., Esq.

63984928

STATE OF CONNECTICUT

CONNECTICUT SITING COUNCIL

IN RE:		
NEW CINGULAR WIRELESS PCS, LLC (AT&T)	PETITION NO	
PETITION FOR A DECLARATORY RULING,		
PURSUANT TO CONNECTICUT GENERAL		
STATUTES SECTION 4-176 AND SECTION 16-50K,	March 19, 2021	
FOR THE TELECOMMUNICATIONS FACILITY ON		
PROPERTY LOCATED AT		
53 ELLA GRASSO TURNPIKE, WINDSOR LOCKS,		
CONNECTICUT.		

PETITION FOR A DECLARATORY RULING: INSTALLATION HAVING NO SUBSTANTIAL ADVERSE ENVIRONMENTAL EFFECT

I. INTRODUCTION

Pursuant to Sections 16-50j-38 and 39 of the Regulations of Connecticut State Agencies (hereafter "R.C.S.A."), New Cingular Wireless PCS LLC d/b/a AT&T ("AT&T") respectfully submits this petition (the "Petition") to the Connecticut Siting Council (the "Council") for a declaratory ruling that no Certificate of Environmental Compatibility and Public Need ("Certificate") is required pursuant to Connecticut General Statutes, Section 16-50k(a) to install a new small cell wireless telecommunications facility on a proposed 34' above ground level ("AGL) wood pole (the "Pole"), extending to 39' 3" AGL to the top of a proposed cylindrical antenna, on property located at 53 Ella T. Grasso Turnpike, Windsor Locks, CT (41.918781° N, 72.672035° W, Property ID 039-125-048) (the "Site"). The Site is owned by LPRI Ella Grasso LLC. **Attachment 1** contains the owner's authorization permitting AT&T to file this Petition.

II. BACKGROUND

A. Need for the Facility

AT&T's Radio Frequency Engineers have identified a need for additional wireless telecommunications coverage and/or capacity in AT&T's network in this area of Windsor Locks. AT&T's existing macro telecommunication cell sites are not providing adequate data capacity in this area due to population, vehicular and foot traffic, multiple wireless devices used by customers and other contributing factors. This small cell wireless telecommunications facility will work to offload the demand on AT&T's macro cell sites and allow for increased data capacity and speed within the immediate vicinity of the proposed facility. By addressing network capacity, the small cell wireless telecommunications facility will aid in reaching AT&T's goal of providing reliable wireless telecommunications services in and around the Town of Windsor Locks and to all of Connecticut.

B. Design and Equipment Details

AT&T proposes to install a new small cell wireless telecommunications facility on a proposed 34'AGL Pole, extending to 39' 3" AGL to the top of a proposed cylindrical antenna. The Site is located within the BUS1 zoning district. The surrounding area is a mix of commercial and residential uses. The nearest residence is approximately 1,000' to the northeast and the nearest wetlands are about 600' away from the Site. The nearest existing utility distribution lines will be about 55' from the proposed Pole. The existing wooden utility poles along Ella Grasso Turnpike were considered as a location for the proposed antenna, but it was determined that they were not feasible due to existing equipment loading, transformers or top crossmembers which the utility company will not approve for use as a small cell facility. The Site is not within a quarter mile of a Department of Energy and Environmental Protection Natural Diversity Database buffered area. Please refer to the DEEP Map submitted herewith at **Attachment 2**.

AT&T's proposed facility is illustrated on the site plans submitted herewith at **Attachment 3**. Please also refer to the Structural Analysis at **Attachment 4** verifying the proposed Pole's structural capability to support AT&T's small cell wireless telecommunications facility. AT&T's proposed antenna will measure 24.7" long with a 10" diameter and will be mounted on top of the Pole. Additional antenna equipment will be concealed within a shroud located at a 35' 2" AGL centerline height on the Pole. AT&T's small cell wireless telecommunications facility will not have emergency backup power. The electrical and telecommunications interconnection route will be determined by the utility company upon the completion of a field visit. The Pole will be located on the portion of the Site fronting on Ella Grasso Turnpike, approximately 30' from the street. Once approvals have been received, it is anticipated that the installation of the small cell facility will take approximately a week and will be constructed during normal business hours.

C. Jurisdiction

The Council is authorized to hear this Petition pursuant to Connecticut General Statutes Section 16-50i(a)(6), as a communication tower. R.C.S.A Section 16-50j-2a(30(A))defines a "tower" as "a structure, whether free standing or attached to a building or another structure…used principally to support one or more antennas for receiving or sending radio frequency signals…" We note that the Public Utilities Regulatory Authority has jurisdiction over small cell attachments to utility poles within the public Right of Way. This proposed facility is not within the public Right of Way, and therefore the Council has jurisdiction in this particular matter.

III. NO SUBSTANTIAL ENVIRONMENTAL IMPACT

AT&T respectfully asserts that the proposed small cell wireless telecommunications facility will not adversely impact the environment and that a Certificate pursuant to Connecticut General Statutes, Section 16-50k(a) is not required.

a. Physical Effects

The proposed unmanned facility will not produce any excessive noise, smoke, odors, waste, glare or significant amounts of traffic. The proposed facility will not require the removal

of trees on the Site. The small cell wireless telecommunications facility will be concealed within a shroud on top of a wooden utility Pole and will have minimal impact on the surrounding area based on the small footprint of the Pole. See **Attachment 3**.

b. Visual Effects

As evidenced by the photo simulations submitted herewith as **Attachment 5**, the proposed facility will not adversely impact the area. AT&T's equipment will be contained and concealed in shrouds.

c. Compliance with FCC

Please refer to the Radio Frequency Emissions Analysis Report submitted as **Attachment** 6. The total radio frequency power density will comply with the standards adopted by the Connecticut Department of Environmental Protection and the Maximum Permissible Exposure limits of the Federal Communications Commission.

IV. NOTICE TO MUNICIPAL OFFICIALS AND ADJOINING PROPERTY OWNERS

AT&T sent notice of its intent to file this Petition pursuant to R.C.S.A, Section 16-50j-40(a), to all municipal officials and government agencies entitled to such notice pursuant to Connecticut General Statutes, Section 16-50l (Attachment 7), as well as to each person identified as an owner of record of the parcels adjoining the Site, as listed in the Town of Windsor Locks Assessor records (Attachment 8).

V. CONCLUSION

AT&T respectfully asserts that its proposed small cell wireless telecommunications facility will not result in any adverse environmental impacts. For the foregoing reasons, AT&T requests that the Council render a determination that no Certificate is required and that the Council issue an order approving AT&T's proposed small cell wireless telecommunications facility.

Respectfully submitted,

/s/ Thomas J. Regan
Thomas J. Regan

63966958

ATTACHMENT 1



LETTER OF AUTHORIZATION

RE: AT&T Small Cell Facility // cRAN_RCTB_BDLY_001

ADDRESS: 53 Ella Grasso Turnpike, Windsor Locks, CT

LPRI ELLA GRASSO LLC, owners of the above described property, authorize New Cingular Wireless PCS, LLC ("AT&T") and/or their agent, to act as our nonexclusive agent for the sole purpose of filing and consummating any land use or building permit application(s) necessary to obtain approval of the applicable jurisdiction for AT&T's proposed small cell facility at the above described property.

We understand that this application may be denied, modified or approved with conditions, and that any such conditions of approval or modifications will be the sole responsibility of the carrier and will be complied with prior to issuance of a building permit.

LPRI ELLA GRASSO LLC

By: Brian Grill

Its: GM

Date: 1/27/21

ATTACHMENT 2

Natural Diversity Data Base Areas

WINDSOR LOCKS, CT

December 2020

State and Federal Listed Species

Critical Habitat

Town Boundary

NOTE: This map shows general locations of State and Federal Listed Species and Critical Habitats. Information on listed species is collected and compiled by the Natural Diversity Data Base (NDDB) from a variety of data sources. Exact locations of species have been buffered to produce the generalized locations.


This map is intended for use as a preliminary screening tool for conducting a Natural Diversity Data Base Review Request. To use the map, locate the project boundaries and any additional affected areas If the project is within a hatched area there may be a potential conflict with a listed species. For more information, complete a Request for Natural Diversity Data Base State Listed Species Review form (DEP-APP-007), and submit it to the NDDB along with the required maps and information. More detailed instructions are provided with the request form on our website.

www.ct.gov/deep/nddbrequest

Use the CTECO Interactive Map Viewers at http://cteco.uconn.edu to more precisely search for and locate a site and to view aerial imagery with NDDB Areas.

QUESTIONS: Department of Energy and Environmental Protection (DEEP) 79 Elm St, Hartford, CT 06106 email: deep.nddbrequest@ct.gov Phone: (860) 424-3011



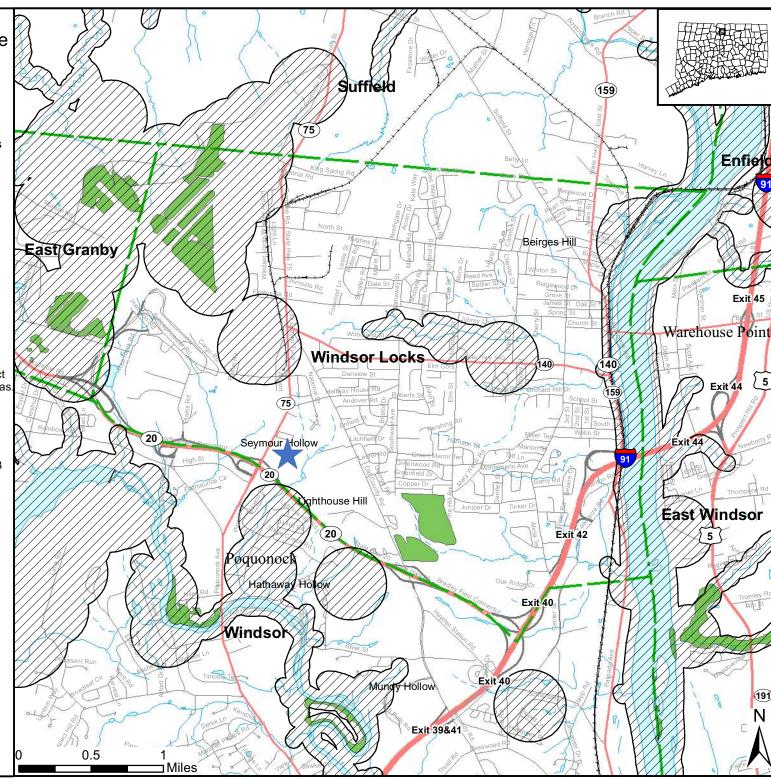


ATTACHMENT 3



AT&T SITE ID: CRAN_RCTB_BDLY_001 **53 ELLA GRASSO TURNPIKE WINDSOR LOCKS, CT 06096**

TAKE EXIT 38 FOR CT075 TOWARD POQUONOCK. TURN RIGHT ONTO CT-75 N/POQUONOCK AVE.

GENERAL NOTES

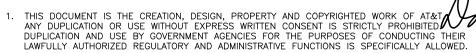

THE FACILITY IS AN UNMANNED PRIVATE AND SECURED EQUIPMENT INSTALLATION. IT IS ONLY ACCESSED BY TRAINED TECHNICIANS FOR PERIODIC ROUTINE MAINTENANCE AND THEREFORE DOES NOT REQUIRE ANY WATER OR SANITARY SEWER SERVICE. THE FACILITY IS NOT GOVERNED BY REGULATIONS REQUIRING PUBLIC ACCESS PER ADA REQUIREMENTS.

CONTRACTOR SHALL VERIFY ALL PLANS AND EXISTING DIMENSIONS AND CONDITIONS ON THE JOB SITE AND SHALL IMMEDIATELY NOTIFY THE AT&T MOBILITY REPRESENTATIVE IN WRITING OF DISCREPANCIES BEFORE PROCEEDING WITH THE WORK OR BE RESPONSIBLE FOR SAME.

at&t 500 ENTERPRISE DRIVE, SUITE 3A ROCKY HILL, CT 06067



750 WEST CENTER STREET, SUITE# 301
WEST BRIDGEWATER, MA 02379

<u></u>

<u>0</u>





CHECKED BY:

APPROVED BY: DPH

SUBMITTALS

REV.	DATE	DESCRIPTION	BY
2		ISSUED FOR REVIEW	MR
1		ISSUED FOR REVIEW	MR
Α	11/20/20	ISSUED FOR REVIEW	MR

CLUSTER AND NODE NUMBER: CRAN_RCTB_BDLY_001


CRAN_RCTB_BDLY_001

SITE ADDRESS: 53 ELLA GRASSO TURNPIKE WINDSOR LOCKS, CT 06096 HARTFORD COUNTY

TITLE SHEET

SHEET NUMBER

T-1

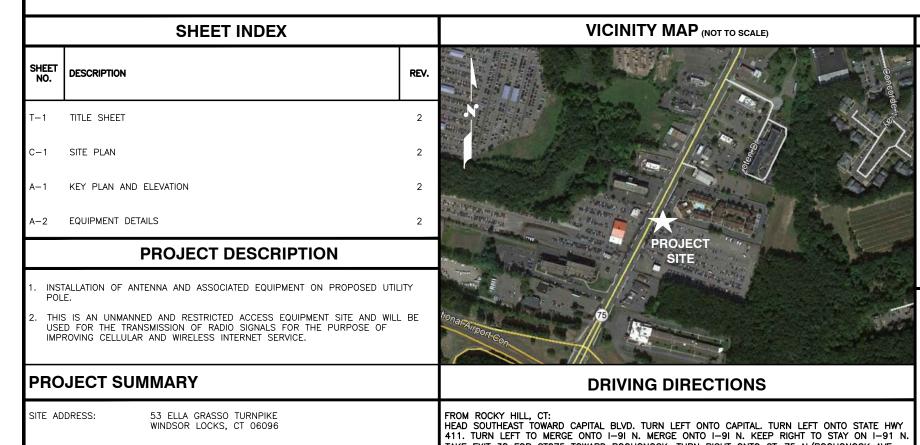

COUNTY:

LATITUDE:

LONGITUDE:

STRUCTURE TYPE:

ARCHITECT/ENGINEER:

HARTFORD


41.918784° N

72.672035° W

UTILITY POLE

HUDSON DESIGN GROUP LLC 45 BEECHWOOD DRIVE

NORTH ANDOVER, MA 01845

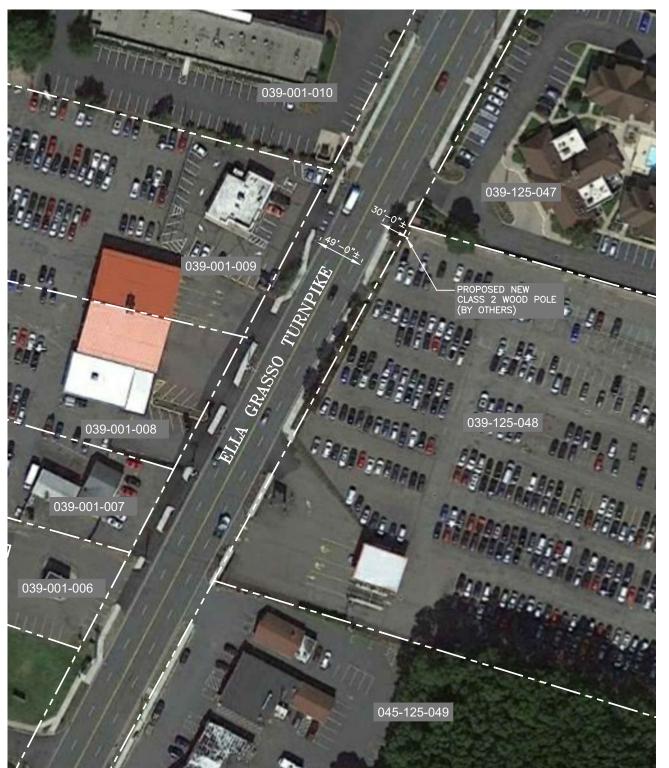

IMMEDIATE ADJOINING PROPERTY OWNER INFORMATION						
PARCEL	OWNER	PHYSICAL ADDRESS	MAILING ADDRESS			
039-125-048	LPRI ELLA GRASSO LLC	53 ELLA T GRASSO TURNPIKE WINDSOR, CT 06096	FOUR COPLEY PLACES STE 4105 BOSTON, MA 2116			
039-125-047	ARC HOSPITALITY PORTFOLIO/OWNER LLC	65 ELLA T GRASSO TURNPIKE WINDSOR, CT 06096	3950 UNIVERSITY DR. STE 301 FAIRFAX, VA 22030			
039-001-006	LPRI ELLA GRASSO LLC	18 ELLA T GRASSO TURNPIKE WINDSOR, CT 06096	FOUR COPLEY PLACES STE 4105 BOSTON, MA 2116			
039-001-007	TWENTY-TWENTY-ONE ELLA GRASSO TNPK ASSOC	20 ELLA T GRASSO TURNPIKE WINDSOR, CT 06096	860 RUSSELL AVE. SUFFIELD, CT 06078			
039-001-008	LPRI ELLA GRASSO LLC	22 ELLA T GRASSO TURNPIKE WINDSOR, CT 06096	FOUR COPLEY PLACES STE 4105 BOSTON, MA 2116			
039-001-009	ALAMPI GRAZIA	50 ELLA T GRASSO TURNPIKE WINDSOR, CT 06096	560 OAKWOOD AVE. STE 100 LAKE FOREST, IL 60045			
039-001-010	BRE/LQ PROPERTIES LLC	64 ELLA T GRASSO TURNPIKE WINDSOR, CT 06096	909 HIDDEN RIDGE STE 600 IRVING, TX 75038			
045-125-049	FLEET NATL BANK TR ANTHONY GANNAUSCIO TR	15 ELLA T GRASSO TURNPIKE WINDSOR, CT 06096	185 ASYLUM ST. HARTFORD, CT 06103			

APPROXIMATE 41.918784° N 72.672035° W LONG: COORDINATES:





Design Group LLC

45 BEECHWOOD DRIVE N. ANDOVER, MA 01845

at&t

CENTERLINE

APPROVED BY: DPH

	SUBMITTALS					
REV.	DATE	DESCRIPTION	BY			
2		ISSUED FOR REVIEW	MR			
1		ISSUED FOR REVIEW	MR			
Α	11/20/20	ISSUED FOR REVIEW	MR			


CLUSTER AND NODE NUMBER: CRAN_RCTB_BDLY_001

CRAN_RCTB_BDLY_001

SITE ADDRESS: 53 ELLA GRASSO TURNPIKE WINDSOR LOCKS, CT 06096 HARTFORD COUNTY

SHEET TITLE

SITE PLAN

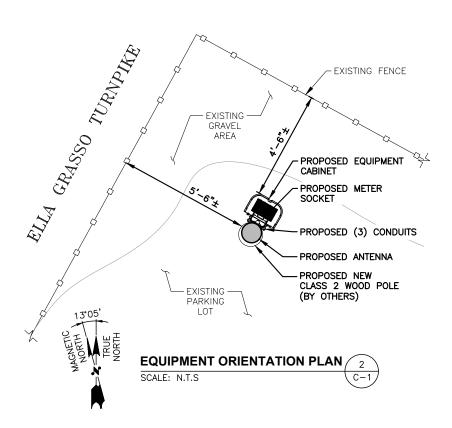


INFORMATION SHOWN HEREON IS BASED ON EXISTING INFORMATION OBTAINED FROM TAX MAPS, MUNICIPAL GIS WEBSITE, & AERIAL IMAGERY. THE INFORMATION SHOWN IS NOT A RIGHT OF WAY OR BOUNDARY SURVEY AND DOES NOT SATISFY THE REQUIREMENTS FOR A BOUNDARY SURVEY. A SITE SURVEY WAS NOT PERFORMED BY HUDSON DESIGN GROUP, LLC

SITE PLAN

22x34 SCALE: 1"=50' 11x17 SCALE: 1"=100'



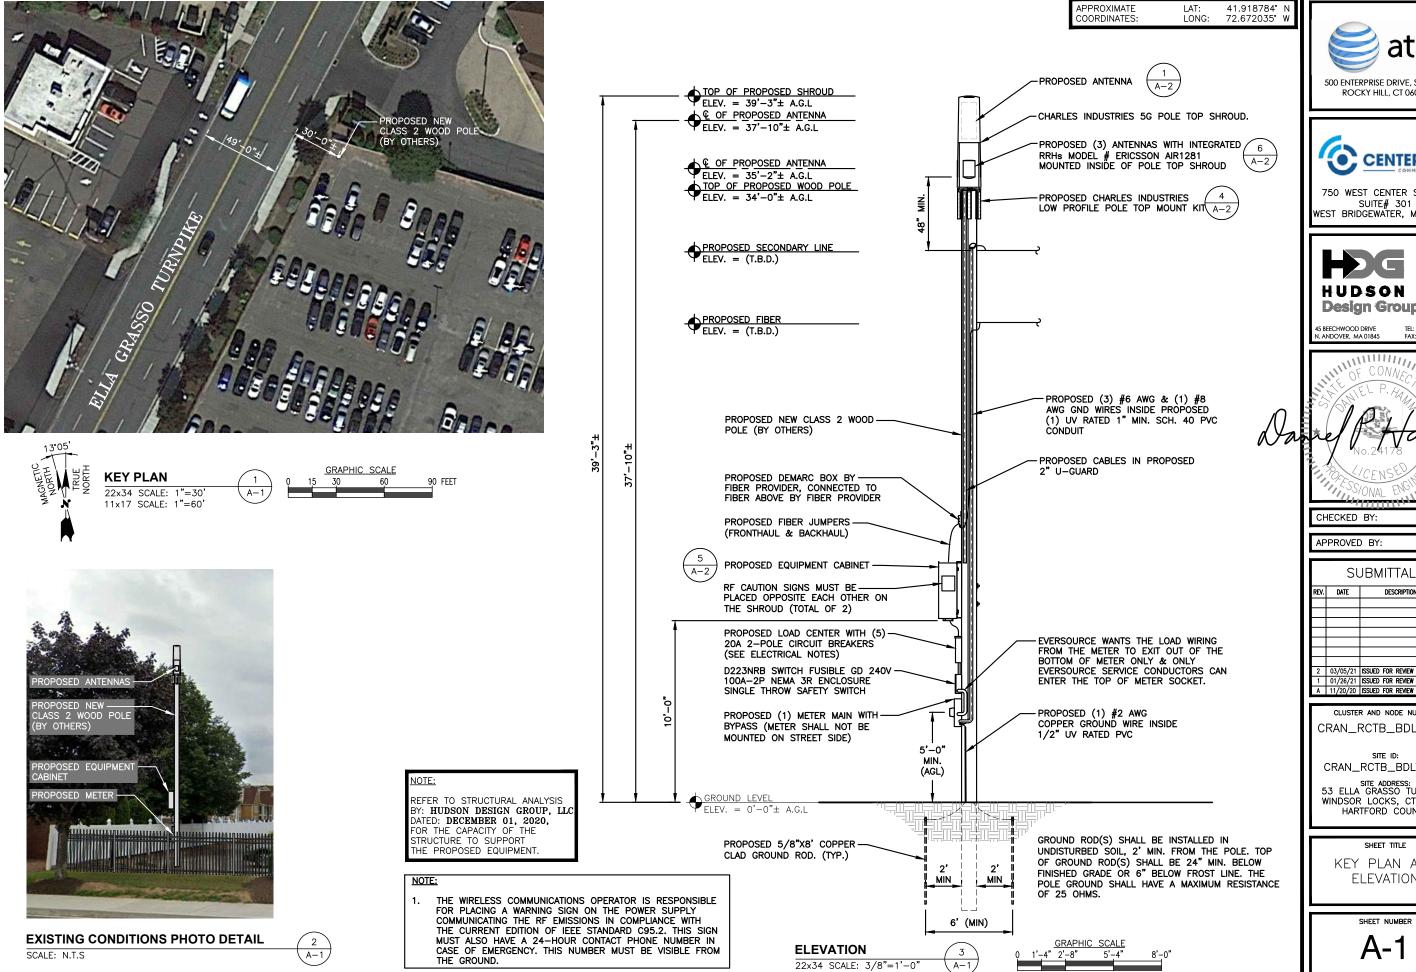

(A-1,

11x17 SCALE: 3/16"=1'-0"

at&t 500 ENTERPRISE DRIVE, SUITE 3A ROCKY HILL, CT 06067



750 WEST CENTER STREET, SUITE# 301 WEST BRIDGEWATER, MA 02379



45 BEECHWOOD DRIVE N. ANDOVER, MA 01845 TEL: (978) 557-5553 FAX: (978) 336-5586

CHECKED BY:

APPROVED BY:

SUBMITTALS DATE DESCRIPTION 2 03/05/21 ISSUED FOR REVIEW 01/26/21 ISSUED FOR REVIEW

DPH

CLUSTER AND NODE NUMBER: CRAN_RCTB_BDLY_001


CRAN_RCTB_BDLY_001

SITE ADDRESS: 53 ELLA GRASSO TURNPIKE WINDSOR LOCKS, CT 06096 HARTFORD COUNTY

SHEET TITLE


KEY PLAN AND **ELEVATION**

SHEET NUMBER

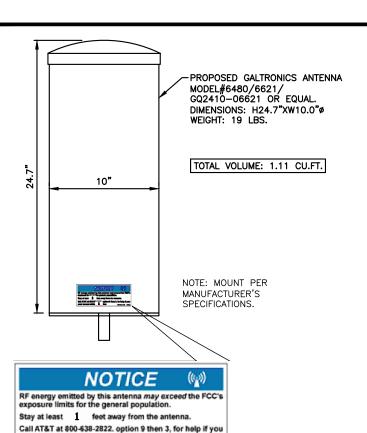


STONEHOUSE SIGNS INC. P/N RD899
SIGN DIMENSIONS 2.5"x6.5"
TWO NOTICE STICKERS MUST BE PLACED OPPOSITE EACH OTHER ON THE ANTENNA

need access within feet.

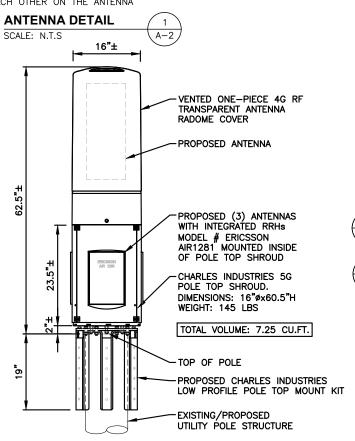

MOUNT PER MANUFACTURER'S SPECIFICATIONS.




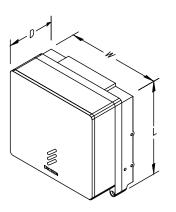

MODEL	QTY.	L	W	D	WGT.
4415	1	16.5"	13.5"	6.3"	47.4 LBS
4402	1	15.0"	13.5"	5.8"	48.5 LBS
2205	1	8.0"	8.0"	4.0"	11 LBS

NOTE: MOUNT PER MANUFACTURER'S SPECIFICATIONS.

RRH DETAIL	2
SCALE: N.T.S	A-2

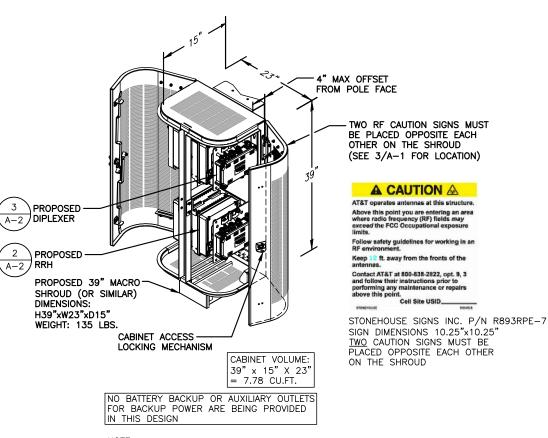


A-2

MOUNT PER MANUFACTURER'S SPECIFICATIONS.

EQUIPMENT CABINET DETAIL

SCALE: N.T.S

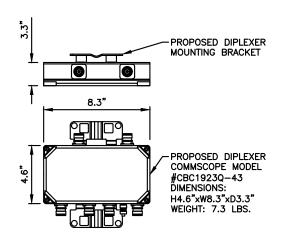

NOTE:
MOUNT PER MANUFACTURER'S SPECIFICATIONS.

DIPLEXER DETAIL (AS REQUIRED)

SCALE: N.T.S

need access within 1 feet.

SIGN DIMENSIONS 2.5"x6.5"

EACH OTHER ON THE ANTENNA


ANTENNA DETAIL

SCALE: N.T.S

STONEHOUSE SIGNS INC. P/N RD899

TWO NOTICE STICKERS MUST BE PLACED OPPOSITE

3 A-2

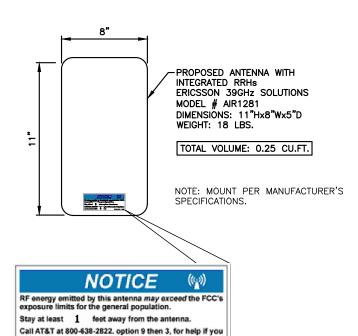






750 WEST CENTER STREET, SUITE# 301 WEST BRIDGEWATER, MA 02379



45 BEECHWOOD DRIVE N. ANDOVER, MA 01845

DD DRIVE TEL: (978) 557-5 MA 01845 FAX: (978) 336-5

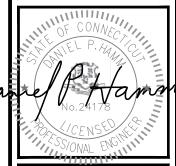

CHECKED BY: AT

APPROVED BY: DPH

	SUBMITTALS				
REV.	DATE	DESCRIPTION	BY		
2		ISSUED FOR REVIEW	MR		
1	01/26/21	ISSUED FOR REVIEW	MR		
Α	11/20/20	ISSUED FOR REVIEW	MR		

CLUSTER AND NODE NUMBER:

CRAN_RCTB_BDLY_001

SITE ID:
CRAN_RCTB_BDLY_001

SITE ADDRESS: 53 ELLA GRASSO TURNPIKE WINDSOR LOCKS, CT 06096 HARTFORD COUNTY

SHEET TITLE

EQUIPMENT DETAILS

SHEET NUMBER

A-2

ATTACHMENT 4

STRUCTURAL ANALYSIS REPORT

For

CRAN_RCTB_BDLY_001

53 Ella Grasso Turnpike Windsor, CT 06096

Equipment Mounted on Proposed Utility Pole



Prepared for:





Dated: December 1, 2020

Prepared by:



HUDSONDesign Group LLC

45 Beechwood Drive North Andover, MA 01845 Phone: (978) 557-5553

www.hudsondesigngroupllc.com



SCOPE OF WORK:

Hudson Design Group LLC (HDG) has been authorized by AT&T to conduct a structural evaluation of the proposed wood pole supporting the proposed AT&T equipment.

This report represents this office's findings, conclusions and recommendations pertaining to the support of the proposed AT&T equipment listed below.

This office conducted an on-site visual survey of the above areas on October 27, 2020. Attendees included Patrick Barrett (HDG – Field Technician).

CONCLUSION SUMMARY:

Based on our evaluation, we have determined that the proposed pole <u>is in conformance</u> with the National Electric Safety Code 2017 (NESC). <u>The wood pole structure is rated at 47.0%.</u>

APPURTENANCES CONFIGURATION:

Appurtenances	Elev.	Mount
(1) GQ2410-06621 Antenna	37'-10"	Top of Pole Top Shroud
(3) AIR1281 Antennas	35'-2"	Pole Top Shroud
(1) Demarc Box	14'-6"	Side of Wood Pole
(1) RRH Shroud	11'-6"	Side of Wood Pole
(1) Load Center	8'-9"	Side of Wood Pole
(1) Safety Switch	7'-3"	Side of Wood Pole
(1) Electric Meter	5'-9"	Side of Wood Pole

ANALYSIS RESULTS SUMMARY:

Component	Max. Stress Ratio	Elev. of Component (ft.)	Pass/Fail
SYP 2 (Proposed)	47.0%	0 – 34.0	PASS



DESIGN CRITERIA:

National Electric Safety Code 2017 (NESC) and the 2018 Connecticut State Building Code Amendments					
Wind					
City/Town:	Windsor				
County:	Hartford				
NESC Rule	Rule 250B	NESC Section 25			
Construction Grade	С	NESC Section 25			
Wind Load:	39.53 mph	NESC Table 230-2			
Ice					
Loading District	Heavy	NESC Figure 250-1			
Radial Ice Thickness:	0.50 in	NESC Table 230-1			

- 1. Approximate height above grade to center of the proposed Galtronics antenna: 37'-10" +/-
- 2. Approximate height above grade to center of the proposed Ericsson antennas: 35'-2" +/-

^{*}Calculations and referenced documents are attached.



PROPOSED STRUCTURE:

The proposed 34'-0" +/- wood pole is assumed to be Southern Yellow Pine Class 2 (fb=8000psi) with a 12.25" diameter base. If field conditions differ from what is assumed in this report, then the engineer of record is to be notified as soon as possible.

ANTENNA SUPPORT RECOMMENDATIONS:

- The new Galtronics antenna is proposed to be installed on the proposed pole top shroud using thru bolts.
- The new Ericsson antennas are proposed to be installed within the proposed pole top shroud secured to the wood pole using a low profile pole top kit.

EQUIPMENT SUPPORT RECOMMENDATIONS:

The new equipment is proposed to be installed on the wood pole using the approved manufacturer's mounts.

Limitations and assumptions:

- Reference the latest HDG construction drawings for all the equipment locations details.
- 2. Mount all equipment per manufacturer's specifications.
- 3. All structural members and their connections are assumed to be in good condition and are free from defects with no deterioration to its member capacities. Contractor to perform pre-inspection prior to construction.
- 4. All antennas and waveguide cables are assumed to be properly installed and supported as per the manufacturer requirements.
- 5. HDG is not responsible for any modifications completed prior to and hereafter which HDG was not directly involved.
- 6. If field conditions differ from what is assumed in this report, then the engineer of record is to be notified as soon as possible.
- 7. HDG did not perform any geotechnical analysis / or / investigation. Soil Information is unknown.



FIELD PHOTOS:



Photo 1: Sample photo illustrating the location of the new utility pole.



PoleForeman - Pole Loading Analysis Report

License: Hudson Design Group Version 7.4.14



POLE LOADING DATA

Pole: 40/2 (Wood-Cylindrical)

NESC Edition: 2017 Pole Loading Horizontal:

47% (250B) Loading District: Heavy


Vertical: 11% (k=1.20) Construction: Grade C (Crossing) Soil: None

Rule 250B: Temp=0F, Wind=4 psf, Ice=0.5 in

POLES

Pole #	Length (ft)	Depth (ft)	Elevation (ft)
0	40	6	0
1	40	6	0



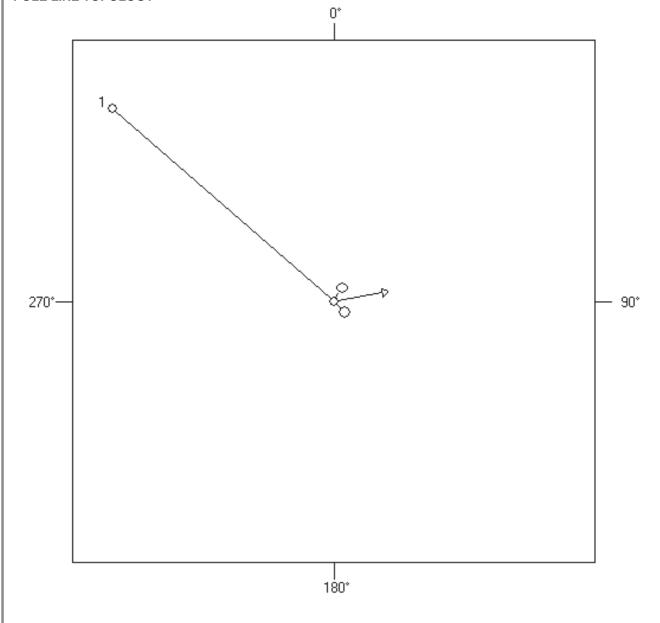

File: CRAN_RCTB_BDLY_001.pff

PoleForeman - Pole Loading Analysis Report

License: Hudson Design Group Version 7.4.14

INSULATORS

 $\begin{array}{cccc} \mbox{Insulator} & \mbox{Attach} & \mbox{Loading} & \mbox{Angle} \\ \mbox{Spool Tangent} & 72" & 23\% & 0^{\circ} \\ \end{array}$

SPANS

Span: 1 Span Length (ft): 90 Direction: 311°

Secondary 4 ACSR (7/1) 100 0 72 0 250

Joint Use

Joint Use Cable Ruling Span (ft) Diameter (in) Weight (lbs/ft) Attach A (in) Offset (in) Attach B (in) Tension (lbs) Description 144CT Fiber ADSS DNA-31074 100 0.80 0.23 108 0 108 902

EQUIPMENT


Equipment Weight (lbs) Attach (in) Direction 4U4MT360X06F60SO Top Mount 135° User Defined Equipment 135.0 270 30° User Defined Equipment 234 30° 3.0 User Defined Equipment 17.0 321 30° User Defined Equipment 15.0 339 30° User Defined Equipment 30° 9.7 303

RISERS


Riser Length (ft) Direction 2" Riser - Primary 34 80°

File: CRAN_RCTB_BDLY_001.pff

12/1/20 3:03 PM

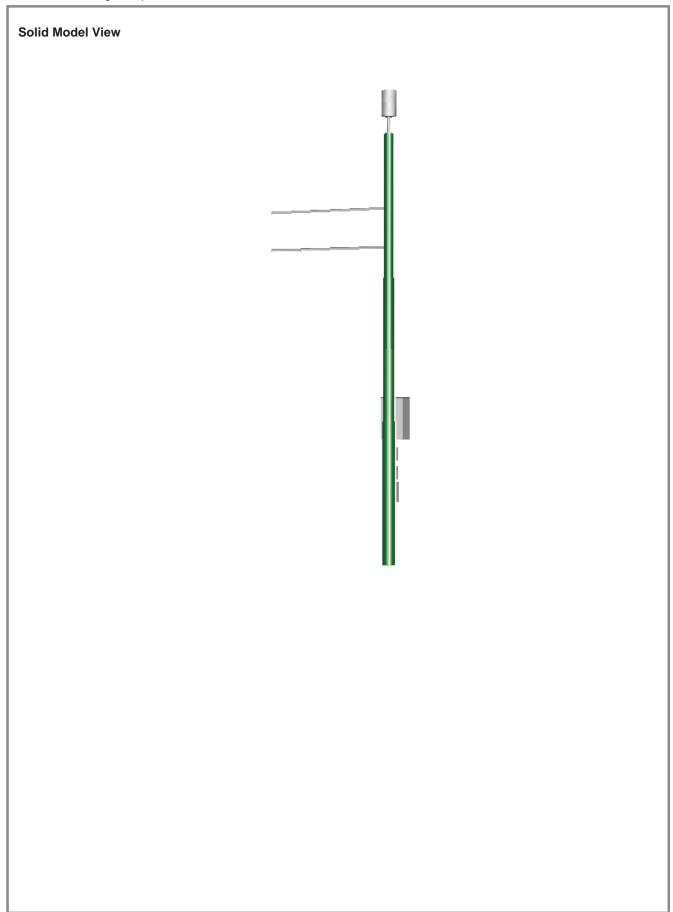

ATTACHMENT 5

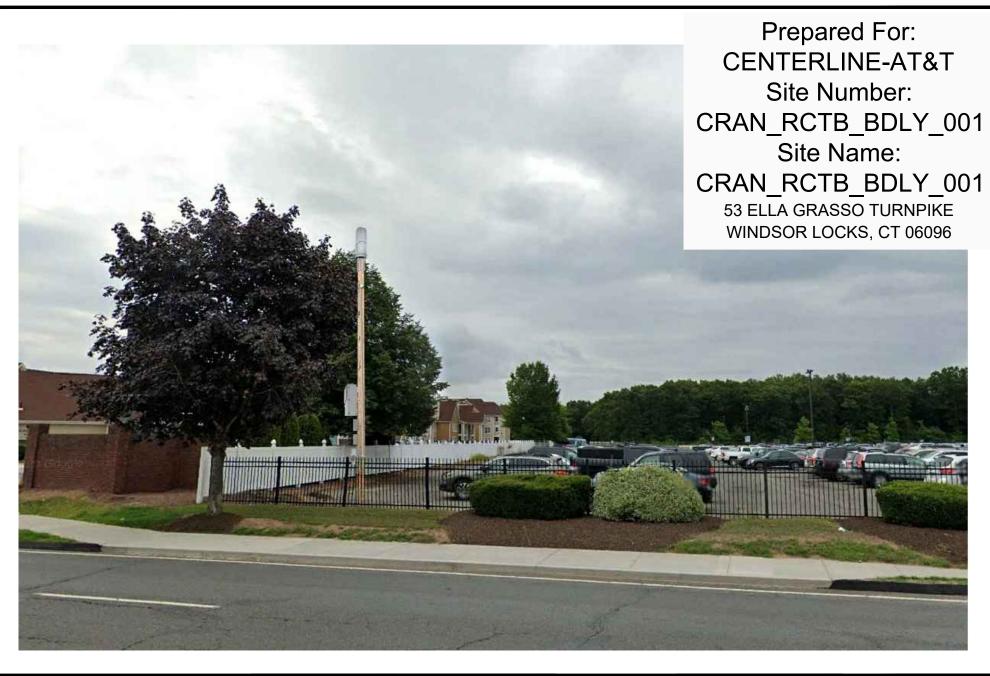

SITE NO: CRAN_RCTB_BDLY_001 SITE NAME: CRAN_RCTB_BDLY_001

ADDRESS: 53 ELLA GRASSO TURNPIKE WINDSOR LOCKS, CT 06096



550 COCHITUATE ROAD FRAMINGHAM, MA 01701



750 WEST CENTER STREET SUITE #301 WEST BRIDGEWATER, MA 02379



SITE TYPE: UTILITY POLE DATE: 02/25/2021

REV: 0


DRAWN BY: VP

SCALE: N.T.S.

TO SHOW THE ONLY AREAS OF VISIBILIT REPRESENTATION OF AREAS WHERE THE PROPOSED INSTALLATION MAY BE VISIBLE BASED UPON THE BEST INFORMATION FOR TOPOGRAPHY AND VEGETATION LOCATIONS AVAILABLE TO DATE.

LOCUS MAP

TAKEN FROM GOOGLE.COM ON 02-25-21

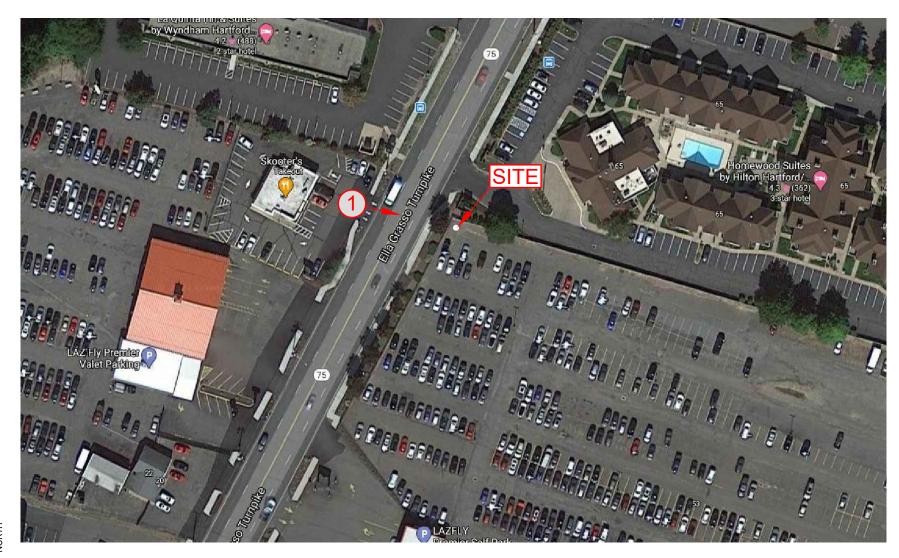





SITE NO: CRAN_RCTB_BDLY_001 SITE NAME: CRAN_RCTB_BDLY_001

ADDRESS: 53 ELLA GRASSO TURNPIKE WINDSOR LOCKS, CT 06096



550 COCHITUATE ROAD FRAMINGHAM, MA 01701





SITE TYPE: UTILITY POLE

DATE: 02/25/2021 REV: 0

DRAWN BY: VP

SCALE: N.T.S.

TO SHOW THE ONLY AREAS OF VISIBILITY IT IS MEANT TO SHOW A BROAD REPRESENTATION OF AREAS WHERE THE PROPOSED INSTALLATION MAY BE VISIBLE BASED UPON THE BEST INFORMATION FOR TOPOGRAPHY AND VEGETATION LOCATIONS AVAILABLE TO DATE.

PAGE 2 OF 4



VIEW EAST FROM ELLA GRASSO TURNPIKE

SITE NO: CRAN_RCTB_BDLY_001

SITE NAME: CRAN_RCTB_BDLY_001

ADDRESS: 53 ELLA GRASSO TURNPIKE WINDSOR LOCKS, CT 06096



FRAMINGHAM, MA 01701



750 WEST CENTER STREET SUITE #301 WEST BRIDGEWATER, MA 02379



SITE TYPE: UTILITY POLE


DATE: 02/25/2021 REV: 0

DRAWN BY: VP

SCALE: N.T.S.

TO SHOW THE ONLY AREAS OF VISIBILITY IT IS MEANT TO SHOW A BROAD REPRESENTATION OF AREAS WHERE THE PROPOSED INSTALLATION MAY BE VISIBLE BASED UPON THE BEST INFORMATION FOR TOPOGRAPHY AND VEGETATION LOCATIONS AVAILABLE TO DATE.

PAGE 3 OF 4

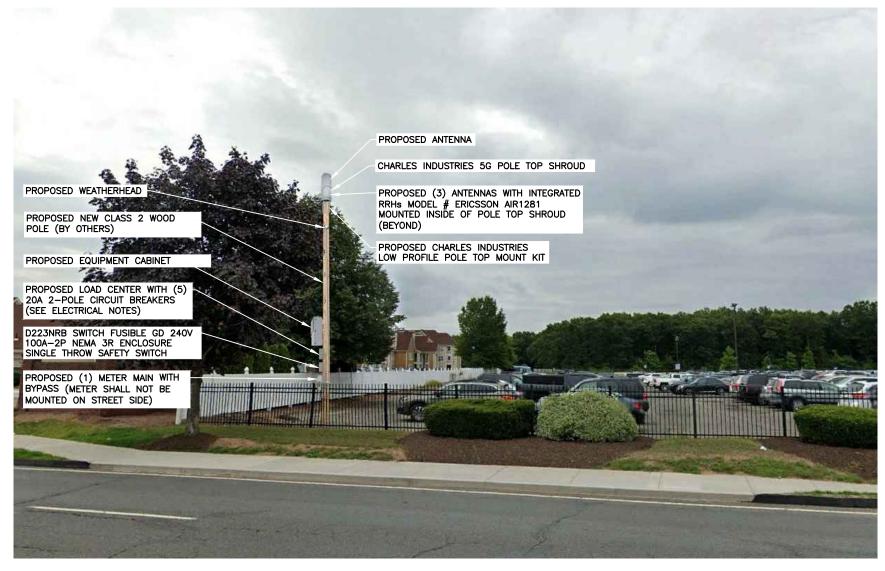

VIEW EAST FROM ELLA GRASSO TURNPIKE

SITE NO: CRAN_RCTB_BDLY_001

SITE NAME: CRAN_RCTB_BDLY_001

ADDRESS: 53 ELLA GRASSO TURNPIKE

WINDSOR LOCKS, CT 06096



550 COCHITUATE ROAD

FRAMINGHAM, MA 01701

CENTERLINE 750 WEST CENTER STREET

WEST BRIDGEWATER, MA 02379

HUDSON **Design Group LLC**

SITE TYPE: UTILITY POLE

DATE: 02/25/2021 REV: 0

DRAWN BY: VP

SCALE: N.T.S.

THIS STUDY DOES NOT CLAIM IN ANY WAY TO SHOW THE ONLY AREAS OF VISIBILITY IT IS MEANT TO SHOW A BROAD REPRESENTATION OF AREAS WHERE THE PROPOSED INSTALLATION MAY BE VISIBLE BASED UPON THE BEST INFORMATION FOR TOPOGRAPHY AND VEGETATION LOCATIONS AVAILABLE TO DATE.

PAGE 4 OF 4

ATTACHMENT 6



Radio Frequency Emissions Analysis Report

January 28, 2021

Centerline Communications on behalf of AT&T

Site Name: CRAN_RCTB_BDLY_001

Site Address: 53 Ella Grasso Turnpike, Windsor, CT 06096

FA#: 14941741

Site Compliance Summary

Compliance Status:

Compliant

Carrier MPE%

0.16387900%

of FCC General Population Allowable Limit:

Composite MPE% | 0.16387900%

of FCC General Population Allowable Limit:



January 28, 2021

AT&T New England Attn: John Benedetto, RF Manager 5050 Cochituate Road Suite 550 - 13&14 Framingham, MA 01701

Emissions Analysis for Site: CRAN_RCTB_BDLY_001

Centerline Communications, LLC ("Centerline") was directed to analyze the proposed AT&T facility to be located on a small cell facility near **53 Ella Grasso Turnpike**, **Windsor CT 06096** for the purpose of determining whether the emissions from the proposed facility are within specified federal limits.

All information used in this report was analyzed as a percentage of current Maximum Permissible Exposure (% MPE) as listed in the FCC OET Bulletin 65 Edition 97-01 and ANSI/IEEE Std C95.1. The FCC regulates Maximum Permissible Exposure in units of microwatts per square centimeter (μ W/cm2). The number of μ W/cm² calculated at each sample point is called the power density. The exposure limit for power density varies depending upon the frequencies being utilized. Wireless Carriers and Paging Services use different frequency bands each with different exposure limits, therefore it is necessary to report results and limits in terms of percent MPE rather than power density.

All results were compared to the FCC (Federal Communications Commission) radio frequency exposure rules, 47 CFR 1.1307(b)(1) - (b)(3), to determine compliance with the Maximum Permissible Exposure (MPE) limits for General Population/Uncontrolled environments as defined below.

<u>General population/uncontrolled exposure</u> limits apply to situations in which the general population may be exposed or in which persons who are exposed as a consequence of their employment may not be made fully aware of the potential for exposure or cannot exercise control over their exposure. Therefore, members of the general population would always be considered under this category when exposure is not employment related, for example, in the case of a telecommunications tower that exposes persons in a nearby residential area.

Population exposure to radio frequencies is regulated and enforced in units of microwatts per square centimeter (μ W/cm²). The general population exposure limits for the 1900 MHz (PCS), 2100 MHz (AWS), 5 GHz (LAA) and 39GHz bands is 1000 μ W/cm².

Occupational/controlled exposure limits apply to situations in which persons are exposed as a consequence of their employment and in which those persons who are exposed have been made fully aware of the potential for exposure and can exercise control over their exposure. Occupational/controlled exposure limits also apply where exposure is of a transient nature as a result of incidental passage through a location where exposure levels may be above general population/uncontrolled limits, as long as the exposed person has been made fully aware of the potential for exposure and can exercise control over his or her exposure by leaving the area or by some other appropriate means. Additional details can be found in FCC OET 65.



Calculations

Calculations were performed for the proposed facility using the equipment information listed below. All calculations were performed per the specifications under FCC OET 65. Since AT&T is proposing focused omnidirectional antennas, which project most of the emitted energy out toward the horizon, all calculations were performed assuming a lobe representing the maximum gain of the antenna per the antenna manufactures supplied specifications, minus 10 dB, was focused at the base of the tower. This is a very conservative estimate since the gain reduction in actual applications is typically greater than 10 dB in the direction of ground immediately surrounding the facility. Real world emissions values from this facility are expected to be lower than values listed in this report at ground level. For this report the sample point is the top of a 6-foot person standing at the base of the tower.

Per FCC OET Bulletin No. 65 - Edition 97-01 recommendations to achieve the maximum anticipated value at each sample point, all power levels emitting from the proposed antenna installation are increased by a factor of 2.56 to account for possible in-phase reflections from the surrounding environment. All power values expressed and analyzed are maximum power levels expected to be used on all radios.

For each sector the following channel counts, frequency bands and power levels were utilized as shown in *Table 1*:

RRH#	Frequency Band	Technology	Channel Count	Transmit Power per Channel (W)
1	1900	PCS	4	5
1	2100	AWS	4	5
1	5150	LAA	2	0.316
2	39000	5G	2	2.8

Table 1: Channel Data Table



The following antennas listed in Table 2 were used in the modeling for transmission in the 1900 MHz (PCS), 2100 MHz (AWS), 5 GHz (LAA) and 39GHz bands. This is based on information from the carrier with regard to anticipated antenna selection.

Sector	Antenna Number	Make / Model	Centerline (ft)		
A	1	GALTRONICS GQ2410-06621	37.83		
A	1	GALTRONICS GQ2418-06941	37.83		
A	1	GALTRONICS GQ2418-06941	37.83		
A	2	NOKIA SON AEWD-E 39GHz	35.17		

Table 2: Antenna Data

All calculations were done with respect to uncontrolled / general population threshold limits.



Results

Per the calculations completed for the proposed AT&T configurations *Table 3* shows resulting emissions power levels and percentages of the FCC's allowable general population limit.

ID	Make / Model	Frequency Band	Gain (dBd)	Centerline (ft)	Channel Count	TX Power (W)	ERP (W)	MPE %
AT&T	GALTRONICS 1 GQ2410-06621	1900	6.11	37.8	4	5	81.6639	0.000035000
АТ&Т	GALTRONICS 1 GQ2418-06941	2100	6.04	37.8	4	5	80.3582	0.000042000
АТ&Т	GALTRONICS 1 GQ2418-06941	5150	2	37.8	2	0.316	1.0017	0.000000000
АТ&Т	NOKIA 2 SON AEWD-E	39000	20.9	35.2	2	2.8	688.9505	0.163802000
						AT8	&T MPE%	0.16387900 %

Table 3: AT&T Antenna Inventory & Power Level



FCC OET 65 specifies that for carriers utilizing directional antennas that the highest recorded sector value be used for composite site MPE values due to their greatly reduced emissions contributions in the directions of the adjacent sectors. *Table 4* below details a breakdown by frequency band and technology for the MPE power values for the maximum calculated AT&T sector(s). Since this proposed facility is utilizing an omnidirectional antenna there is only one sector for this site (Sector A).

Frequen Band	cy Technology	Centerline (ft.)	# of Channels	ERP W (Per Channel)	Total Power Density (μW/cm²)	Allowable MPE (μW/cm²)	MPE %
1900	PCS	37.8	4	20.41596932	0.0003490	1000	0.00003500
2100	AWS	37.8	4	20.08954054	0.0004160	1000	0.00004200
5150	LAA	37.8	2	0.500826249	0.0000050	1000	0.00000000
39000	5G	35.2	2	344.4752558	1.6380220	1000	0.16380200
1900	PCS	37.8	4	20.41596932	0.0003490	1000	0.00003500
AT&T MPE% 0.1638790							0.16387900 %

Table 4: AT&T Maximum Sector MPE Power Values



Summary

All calculations performed for this analysis yielded results that were **within** the allowable limits for general population exposure to RF Emissions.

The anticipated maximum composite contributions from the AT&T facility as well as the site composite emissions value with regards to compliance with FCC's allowable limits for general population exposure to RF Emissions are shown here:

Carrier	Predicted MPE %
AT&T	0.16387900%
Composite	0.16387900%

Table 5: Total Predicted MPE(%) by Carrier

Compliance Status:

The anticipated composite MPE value for this site assuming all carriers present is **0.16387900%** of the allowable FCC established general population limit sampled at the ground level.

FCC guidelines state that if a site is found to be out of compliance (over allowable thresholds), that carriers over a 5% contribution to the composite value will require measures to bring the site into compliance. For this facility, the composite values calculated were well within the allowable 100% threshold standard per the federal government.

Dane Folie
RF Compliance Consultant
Centerline Communications, LLC

750 West Center St. Suite 301 West Bridgewater, MA 02379

ATTACHMENT 7

CERTIFICATE OF SERVICE

I hereby certify that on the 18th day of March 2021, a copy of the following notice of intended filing of a Petition with the Connecticut Siting Council for a declaratory ruling was sent by first class certified mail to the list below.

Dated: March 18, 2021

Brown Rudnick LLP Joseph A. Giammarco

State

State	
THE HONORABLE WILLIAM TONG	DEPARTMENT OF ECONOMIC AND
ATTORNEY GENERAL	COMMUNITY DEVELOPMENT,
OFFICE OF THE ATTORNEY GENERAL	CULTURE AND TOURISM
165 CAPITOL AVENUE	DAVID LEHMAN, COMMISSIONER
HARTFORD, CT 06106	450 COLUMBUS BLVD, HARTFORD
	HARTFORD, CT 06103
DEPARTMENT OF PUBLIC HEALTH	DEPARTMENT OF ENERGY AND
DEIDRE S. GIFFORD, MD, MPH,	ENVIRONMENTAL PROTECTION
ACTING COMMISSIONER	PUBLIC UTILITIES REGULATORY
410 CAPITOL AVENUE	AUTHORITY
HARTFORD, CT 06134	MARISSA P. GILLETT, CHAIRMAN
	TEN FRANKLIN SQUARE
	NEW BRITAIN, CT 06051
COUNCIL ON ENVIRONMENTAL	DEPARTMENT OF TRANSPORTATION
QUALITY	JOSEPH GIULIETTI, COMMISSIONER
PETER B. HEARN, EXECUTIVE	2800 BERLIN TURNPIKE
DIRECTOR	P.O. BOX 317546
79 ELM STREET, 6 TH FLOOR	NEWINGTON, CT 06131
HARTFORD, CT 06106	
DEPARTMENT OF ENERGY &	DEPARTMENT OF AGRICULTURE
ENVIRONMENTAL PROTECTION	BRYAN P. HURLBURT, COMMISSIONER
KATIE DYKES, COMMISSIONER	450 COLUMBUS BOULEVARD
79 ELM STREET	SUITE 701
HARTFORD, CT 06106	HARTFORD, CT 06103
OFFICE OF POLICY AND	DEPARTMENT OF EMERGENCY
MANAGEMENT	SERVICES & PUBLIC PROTECTION
MELISSA MCCAW, SECRETARY	DIVISION OF EMERGENCY
450 CAPITOL AVENUE	MANAGEMENT AND HOMELAND
HARTFORD, CT 06106	SECURITY
	JAMES C. ROVELLA, COMMISSIONER
	1111 COUNTRY CLUB ROAD
	MIDDLETOWN, CT 06457

The state of the s
SECRETARY OF STATE
DENISE MERRILL
165 CAPITOL AVENUE
HARTFORD, CT 06106
STATE SENATOR-DISTRICT 7
JOHN KISSEL
LEGISLATIVE OFFICE BUILDING,
300 CAPITOL AVENUE, ROOM 3400
HARTFORD, CT 06106
9

Federal

FEDERAL COMMUNICATIONS	FEDERAL AVIATION ADMINISTRATION
COMMISSION	800 INDEPENDENCE AVENUE, SW
445 12 TH STREET SW	WASHINGTON, DC 20591
WASHINGTON, DC 20554	
U.S. SENATOR CHRISTOPHER MURPHY	U.S. SENATOR RICHARD BLUMENTHAL
COLT GATEWAY	90 STATE HOUSE SQUARE, 10 TH FLOOR
120 HUYSHOPE AVENUE	HARTFORD, CT 06103
SUITE 401	
HARTFORD, CT 06106	
U.S. CONGRESSMAN – ^{1ST} DISTRICT	
JOHN B. LARSON	
221 MAIN STREET, 2 ND FLOOR	
HARTFORD, CT 06106	

Town of Windsor Locks

J. CHRISTOPHER KERVICK	JENNIFER V. RODRIGUEZ, AICP, CZEO
TOWN OF WINDSOR LOCKS	TOWN PLANNER AND WETLANDS
50 CHURCH STREET	AGENT
WINDSOR LOCKS, CT 06096	TOWN OF WINDSOR LOCKS
	50 CHURCH STREET
	WINDSOR LOCKS, CT 06096

CONSERVATION COMMISSION RICHARD FRAWLEY, CHAIRMAN TOWN OF WINDSOR LOCKS 50 CHURCH STREET WINDSOR LOCKS, CT 06096	SCOTT A. NOLAN, TOWN CLERK TOWN OF WINDSOR LOCKS 50 CHURCH STREET WINDSOR LOCKS, CT 06096
TOWN OF WINDSOR HISTORICAL COMMISSION MICKEY DANYLUK TOWN OF WINDSOR LOCKS 50 CHURCH STREET WINDSOR LOCKS, CT 06096	

March 18, 2021 VIA CERTIFIED MAIL/ RETURN RECEIPT REQUESTED

[Insert Abutter/official Name and Address]

Re: New Cingular Wireless PCS, LLC ("AT&T") Installation of A Small Cell

Wireless Telecommunication Facility 53 Ella Grasso Turnpike, Windsor

Locks, Connecticut

To Whom it May Concern:

On behalf of our client New Cingular Wireless PCS, LLC ("AT&T"), we are notifying you with respect to the above referenced matter and our client's intent to file a petition for a declaratory ruling with the State of Connecticut Siting Council (the "Siting Council") for approval of installation of a small cell wireless telecommunication facility on a new wood pole (the "Facility") to be installed at above-referenced property owned by LPRI Ella Grasso, LLC. Connecticut law requires that record property owners of property abutting a parcel on which a facility is proposed be notified of an applicant's intent to file a petition with the Siting Council. A notice of this application and details of the proposal are included with this letter. The location, height and other details of the proposed Facility are subject to the review and potential alteration by the Siting Council under the provisions of Connecticut General Statutes §16-50g et seq. If you have any questions concerning this petition, please feel free to contact the Connecticut Siting Council or this office after March 22, 2021, at which time we anticipate that the petition will be on file.

Sincerely,

/s/ Thomas J. Regan
Thomas J. Regan

Enclosure

NOTICE

Notice is hereby given, pursuant to Section 16-50j-40(a) of the Regulations of Connecticut State Agencies of a Petition being filed with the Connecticut Siting Council ("Siting Council") on or after March 19, 2021 by New Cingular Wireless PCS, LLC ("AT&T"). AT&T seeks a declaratory ruling that no Certificate of Environmental Compatibility and Public Need ("Certificate") is required under Section 16-50k(a) of the Connecticut General Statutes ("C.G.S.") to install a new "small cell" wireless telecommunications facility on a new light pole.

The proposed telecommunications facility will be located on property owned by LPRI Ella Grasso, LLC, at 53 Ella Grasso Turnpike, in the Town of Windsor Locks and identified on the Town of Windsor Locks' GIS as Parcel ID 039-125-048 (the "Site"). AT&T proposes to install a new "small cell" wireless telecommunications facility on a proposed 34' wood pole, extending to 39' 3" to the top of a proposed cylindrical antenna. The pole will be located on the portion of the Site fronting on Ella Grasso Turnpike, approximately 30' from the street adjacent to the Site's parking area. This small cell wireless telecommunications facility will work to offload the demand on AT&T's macro cell sites and allow for increased data capacity and speed within the immediate vicinity of the proposed facility. By addressing network capacity, the small cell wireless telecommunications facility will aid in reaching AT&T's goal of providing reliable wireless telecommunications services in and around the Town of Windsor Locks and to all of Connecticut.

The Petition will provide additional details of the proposal and discuss AT&T's assertion that this proposed small cell telecommunications facility presents no significant adverse environmental effects. The location, height and other features of the proposal are subject to review and potential change under the provisions of Connecticut General Statutes Sections 16-50g et. seq.

Copies of the Petition will be available for review during normal business hours on or after March 22, 2021 at the following:

Connecticut Siting Council 10 Franklin Square New Britain, Connecticut 06051 Town Clerk of Windsor Locks Scott A. Nolan 50 Church Street Windsor Locks, CT 06096

or this office. A copy of the Petition will also be available on the Connecticut Siting Council website: https://www.ct.gov/cSc/site/default.asp under Pending Matters. All inquiries should be addressed to the Connecticut Siting Council or to the undersigned.

Thomas J. Regan, Esq. Brown Rudnick LLP 185 Asylum Street Hartford, CT 06103

ATTACHMENT 8


CERTIFICATE OF SERVICE

I hereby certify that on the 18th day of March, 2021, a copy of the following letter and notice of the intended filing of a Petition with the Connecticut Siting Council for a declaratory ruling was sent by certified mail, return receipt requested, to the attached list of abutting property owners:

Dated: March 18, 2021

Brown Rudnick LLP Joseph A. Giammarco

LPRI ELLA GRASSO LLC	ARC HOSPITALITY PORTFOLIO/OWNER LLC
FOUR COPLEY PLACE, STE 4105	3950 UNIVERSITY DR., STE 301
BOSTON, MA 2116	FAIRFAX, VA 22030
039-125-048	039-125-047
Subject Property: 53 Ella T. Grasso Tpke	Property Address: 65 Ella T. Grasso Tpke
Identified as parcel A on Abutters Map	Identified as parcel B on Abutters Map
038-001-006	
Abutting Property: 18 Ella T. Grasso Tpke	
Identified as parcel G on Abutters Map	
038-001-008	
Abutting Property: 22 Ella T. Grasso Tpke	
Identified as parcel I on Abutters Map	
Twentytes as pareer I on Header's Hup	
MURKOWICZ, JOSEPH	F & L CONSTRUCTION LIMITED
72 GREENFIELD DRIVE	38 RUSSELL ROAD, UNIT A
WINDSOR LOCKS, CT 06026	EAST GRANBY, CT 06026
039-125-021	045-125-019
Property Address: 159 Old County Road	Property Address: 177 Old County Road
Identified as property G on Abutters Map	Identified as property D on Abutters Map
incluyion as property of our flounders friap	The mylea as property 2 on House is Hap
BARRETT, DEBORAH G.	FLEET NATIONAL BANK TR
9950 62 ND TERRACE NORTH #411	ANTHONY GANNAUSCIO, TR
ST. PETERSBURG, FL 33708	185 ASYLUM STREET
045-125-018	HARTFORD, CT 06103
Property Address: 1 Fox Hollow Drive	045-125-049
Identified as property E on Abutters Map	Property Address: 15 Ella T. Grasso Tpke
	Identified as property F on Abutters Map
	The state of the s
TWENTY-TWENTY-ONE ELLA GRASSO TNPK	ALAMPI GRAZIA
ASSOC	560 OAKWOOD AVE, STE 100
880 RUSSELL AVE	LAKE FOREST, IL 60045
SUFFIELD, CT 06078	039-001-009
039-001-007	Property Address: 50 Ella T. Grasso Tpke
Property Address: 20 Ella T. Grasso Tpke	Identified as property J on Abutters Map
Identified as property H on Abutters Map	T I I
BRE/LQ PROPERTIES LLC	
909 HIDDEN RIDGE, STE 600	
IRVING, TX 75038	
039-001-010	
Property Address: 64 Ella T. Grasso Tpke	
Identified as property K on Abutters Map	

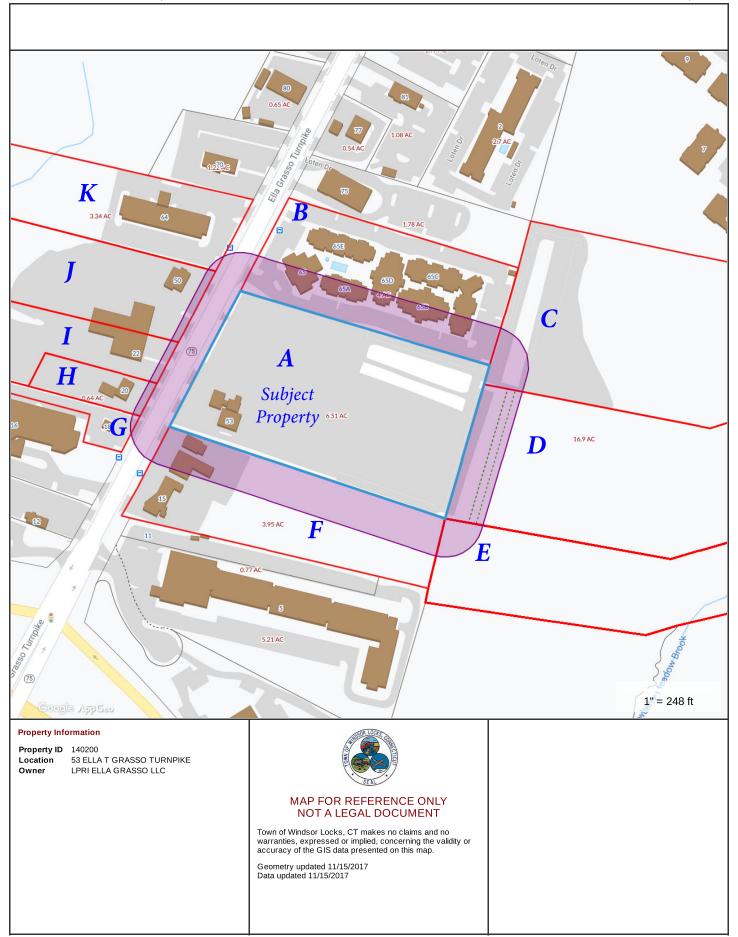

March 18, 2021 VIA CERTIFIED MAIL/ RETURN RECEIPT REQUESTED

[Insert Abutter/official Name and Address]

Re: New Cingular Wireless PCS, LLC ("AT&T") Installation of A Small Cell

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Thomas J. Regan, Esq. Brown Rudnick LLP 185 Asylum Street Hartford, CT 06103