



Northeast Site Solutions
Victoria Masse
420 Main Street #2, Sturbridge, MA 01566
860-306-2326
victoria@northeastsitesolutions.com

August 9, 2021

Members of the Siting Council
Connecticut Siting Council
Ten Franklin Square
New Britain, CT 06051

RE: Notice of Exempt Modification
347 East Street, Wolcott CT 06716
Latitude: 41.55950000
Longitude: -72.94690000
T-Mobile Site#: CT11494B _NHP

Dear Ms. Bachman:

T-Mobile currently has nine (9) antennas at the 186-foot mount on the existing 180-foot monopole located at 347 East Street, Wolcott CT 06716. The property is owned by Agostinho V & Joanne Rodrigues. The monopole is owned by Crown Castle. T-Mobile now intends to add a 25Kw generator to an existing concrete pad within a fenced compound.

Planned Modifications:

Ground work only-Install New:

(1) GENERAC RD 25 KW AC DIESEL GENERATOR – 240-gallon double walled self-contained tank with fuel sensor. Requires two (2) 12-minute run cycles by-weekly.



This facility was approved by the by the Connecticut Siting Council in Docket No. 56 on April 14, 1986. Please see attached.

Please accept this letter as notification pursuant to Regulations of Connecticut State Agencies § 16-50j-73, for construction that constitutes an exempt modification pursuant to R.C.S.A. § 16-50j-72(b)(2). In accordance with R.S.C.A. § 16-50j-73, a copy of this letter is being sent to Thomas G. Dunn, Mayor for the Town of Wolcott, David Kalinowski, Zoning Inspector, and Mr. and Mrs. Rodrigues, the property owners.

The planned modifications to the facility fall squarely within those activities explicitly provided for in R.C.S.A. § 16-50j-72(b)(2).

1. The proposed modifications will not result in an increase in the height of the existing structure.
2. The proposed modifications will not require the extension of the site boundary.
3. The proposed modifications will not increase noise levels at the facility by six decibels or more, or to levels that exceed state and local criteria.
4. The operation of the replacement antennas will not increase radio frequency emissions at the facility to a level at or above the Federal Communications Commission safety standard.
5. The proposed modifications will not cause a change or alteration in the physical or environmental characteristics of the site.
6. The existing structure and its foundation can support the proposed loading.

For the foregoing reasons, T-Mobile respectfully submits that the proposed modifications to the above referenced telecommunications facility constitute an exempt modification under R.C.S.A. § 16-50j-72(b)(2).

Sincerely,

Victoria Masse
Mobile: 860-306-2326
Fax: 413-521-0558
Office: 420 Main Street, Unit 2, Sturbridge MA 01566
Email: victoria@northeastsitesolutions.com



NSS **NORTHEAST**
SITE SOLUTIONS
Turnkey Wireless Development

Attachments

cc: The Honorable Thomas G. Dunn, Mayor (via email only to tdunn@wolcottct.org)
Town Hall
10 Kenea Avenue
Wolcott, CT 06716

David Kalinowski, Zoning Inspector (via email only to dkalinowski@wolcottct.org)
Town Hall
10 Kenea Avenue
Wolcott, CT 06716

Augustinho & Joanne Rodrigues
347 East Street
Wolcott, CT 06716

Crown Castle - as tower owner
3 Corporate Park Drive, Suite 101,
Clifton Park, NY 12065

Exhibit A

AN APPLICATION OF METRO MOBILE CTS OF : CONNECTICUT SITING
NEW HAVEN, INC., FOR A CERTIFICATE OF :
ENVIRONMENTAL COMPATIBILITY AND PUBLIC : COUNCIL
NEED FOR THE CONSTRUCTION, MAINTENANCE, :
AND OPERATION OF FACILITIES TO PROVIDE : April 14, 1986
CELLULAR SERVICE IN NEW HAVEN COUNTY. :

D E C I S I O N A N D O R D E R

Pursuant to the foregoing opinion, the Council hereby directs that a certificate of environmental compatibility and public need as required by section 16-50k of the General Statutes of Connecticut (CGS) be issued to Metro Mobile CTS of New Haven, Inc., for the construction, maintenance, and operation of cellular mobile phone telecommunication towers and associated equipment in the towns of Wolcott, Naugatuck, West Haven (existing tower), Milford, Hamden (existing tower), Guilford, and North Branford subject to the conditions below.

1. The proposed and alternate Beacon Falls sites are rejected without prejudice.
2. The Wolcott tower shall be constructed to meet Zone C wind loading with 1" of radial ice and shall not exceed 180' in height excluding antennas.
3. The Naugatuck tower shall not exceed 160' in height, excluding antennas. The certificate holder shall offer to remove the existing privately owned, unused tower now on the site.
4. Any future actions requiring the removal of the existing West Haven or Hamden towers to be shared by the certificate holder shall also apply to the equipment mounted on those towers by the certificate holder, regardless of that equipment's status under Chapter 277a of the CGS.

5. The Milford tower shall be a monopole structure not to exceed 100' in height, excluding antennas.
6. The Guilford tower shall be a monopole structure not to exceed 150' in height, excluding antennas.
7. The North Branford Route 17 site is rejected. The North Branford East Reeds Gap Road tower shall not exceed 160' in height, excluding antennas.
8. The certificate holder shall submit a development and management plan for the Wolcott, Naugatuck, Milford, Hamden, Guilford, and North Branford sites pursuant to sections 16-50j-75 through 16-50j-77 of the RSA, except that irrelevant items in section 16-50j-76 need only be identified as such. In addition to the requirements of section 16-50j-76, the D&M plan shall provide plans for evergreen screening around the fenced perimeter at the Wolcott, Milford, Hamden, Guilford, and North Branford sites. The D&M plan shall include a proposal for painting the approved monopole structures to blend with the sky. Any changes to specifications in the D&M plan must be approved by the Council prior to facility operation.
9. All certified facilities shall be constructed, operated, and maintained as specified in the Council's record and in the site development and management plan required by order 8.
10. The certificate holder shall permit public or private entities to share space on the towers approved herein, for due consideration received, or shall provide any requesting entity with specific legal, technical, environmental, or economic reasons precluding such tower sharing. In addition to complying with 16-50j-73, the

certificate holder shall notify the Council of the addition of any equipment to any approved tower.

11. A fence not lower than 8' shall surround each tower and associated equipment.
12. Unless necessary to comply with order 13, below, no lights shall be installed on any of these towers.
13. The facilities' construction and any future tower sharing shall be in accordance with all applicable federal, state, and municipal laws and regulations. Shared uses by entities not subject to jurisdiction pursuant to sections 16-50i and 16-50k of the CGS shall be subject to all applicable federal, state, and municipal laws and regulations.
14. Construction activities shall take place during daylight working hours.
15. This decision and order shall be void and the towers and associated equipment shall be dismantled and removed, or reapplication for any new use shall be made to the CSC before any such new use is made, if the towers do not provide or permanently cease to provide cellular service following completion of construction.
16. This decision and order shall be void if all construction authorized herein is not completed within three years of the issuance of this decision, or within three years of the completion of any appeal if appeal of this decision is taken, unless otherwise approved by the Council.

Pursuant to CGS section 16-50p, we hereby direct that a copy of the decision and order shall be served on each person listed below. A notice

of the issuance shall be published in The Record-Journal, The New Haven Register, The Branford Review, The Evening Sentinel, The Waterbury American, and The Waterbury Republican.

The parties to this proceeding are:

Metro Mobile CTS of New Haven, Inc. (Applicant)
5 Eversley Avenue
Norwalk, Connecticut 06855

ATTN: Armand Mascioli
General Manager

Mr. Kevin B. Sullivan, Esq. (its attorneys)
Byrne, Slater, Sandler, Shulman & Rouse, P.C.
111 Pearl Street
P.O. Box 3216
Hartford, Connecticut 06103

Mr. Richard Rubin, Esq.
Fleischman and Walsh, P.C.
1725 N Street, N.W.
Washington, D.C. 20036

Guilford Conservation Commission

represented by:

Mr. David B. Damer
Chairman
Guilford Conservation Commission
440 Great Hill Road
Guilford, Connecticut 06437

Mr. Robert W. Griswold, Jr.
100 Rimmon Hill Road
Beacon Falls, Connecticut 06403

Town of Hamden
Memorial Town Hall
2372 Whitney Avenue
Hamden, Connecticut 06518

ATTN: Shirley Gonzales
Town Planner

Guilford Planning and Zoning Commission

represented by:

Mr. David W. Fisher
Chairman
Town Hall
31 Park Street
Guilford, Connecticut 06437

Town of Hamden

represented by:

John DeNicola, Jr.
Mayor
Town of Hamden
Memorial Town Hall
2372 Whitney Avenue
New Haven, Connecticut 06518

Citizens Park Council of New Haven

represented by:

Mr. John J. Ciarleglio
President
Citizens Park Council
of New Haven
36 Elmwood Road
New Haven, Connecticut 06515

Mr. Thomas V. Keating
343 Rimmon Hill Road
Beacon Falls, Connecticut 06403

Ms. Evelyn M. Sirowich
245 Rimmon Hill Road
Beacon Falls, Connecticut 06403

Mr. Jack B. Levine
11 White Birch Lane
Beacon Falls, Connecticut 06403

Southern New England Telephone Company

represented by:

Mr. Peter J. Tyrrell, Esq.
227 Church Street
New Haven, Connecticut 06506

Mr. Dennis Bialecki
96 West Road
Beacon Falls, Connecticut 06403

Brittany Woods Homeowner's Association

represented by:

Mr. Stephen P. DeI Sole, Esq.
DeI Sole & DeI Sole
152 Temple Street
P.O. Box 405
New Haven, Connecticut 06502-0405

Ms. Barbara G. Schlein
Box 2993 Westville Station
New Haven, Connecticut 06515

Mr. & Mrs. Joseph T. Farrell, Jr.
334 Rimmon Hill Road
Beacon Falls, Connecticut 06403

Town of Beacon Falls

represented by:

The Honorable Leonard F. D'Amico
First Selectman
10 Maple Avenue
Beacon Falls, Connecticut 06403

West Rock Ridge Park Association

represented by:

Mr. William L. Doheny Jr., D.D.S.
President
220 Mountain Road
Hamden, Connecticut 06514

Department of Parks,
Recreation & Trees

represented by:

Mr. Robert G. Sheeley
Director
Parks, Recreation & Trees
P.O. Box 1416
New Haven, Connecticut 06506

Town of Wallingford

represented by:

William W. Dickinson, Jr.
Mayor
Municipal Building
350 Center Street
P.O. Box 427
Wallingford, Connecticut 06492

New Haven Sierra Club

represented by:

Ms. Laurie Klein
270 Edgewood Avenue
New Haven, Connecticut 06511

Peter M. Lerner
State Representative
8 Merritt Avenue
Woodbridge, Connecticut 06525

Carleton J. Benson
State Representative
161 Scott Road
Prospect, Connecticut 06712

Dr. Stephen Collins (service waived)
Vice Chairman
West Rock State Park
Advisory Council
Bethany, Connecticut

Mr. Louis Melillo (service waived)
985 Wintergreen Avenue
Hamden, Connecticut

Mr. John McGeever (service waived)
339 Rimmon Hill
Beacon Falls, Connecticut 06403

Senator John Consoli (service waived)
51 Luke Hill Road
Bethany, Connecticut 06525

Representative George P. Bassing (service waived)
14 Oakwood Drive
Seymour, Connecticut 06483

Dr. George D. Whitney (service waived)
858 Oakwood Road
Orange, Connecticut

Mr. Steve Molnar (service waived)
205 West Road
Beacon Falls, Connecticut

Mr. James W. Grandy (service waived)
President
Hamden Land Conservation Trust
Hamden, Connecticut

Senator Richard S. Eaton (service waived)
269 Mulberry Point Road
Guilford, Connecticut 06437

Representative Robert M. Ward
719 Totoket Road
Northford, Connecticut 06472

Town of North Branford

represented by:

John Gesmonde, Esquire
3127 Whitney Avenue
Hamden, Connecticut 06518

Regina Smith
1887 Middletown Avenue
Northford, Connecticut 06472

(service waived)

Richard A. Nizolek
The Restland Farm Corporation
Route 17
Northford, Connecticut 06472

Mary Liska
83 Reeds Gap Road
Northford, Connecticut 06472

Ben Bullard
50 Christmas Hill Road
Guilford, Connecticut 06437

(service waived)

Roland Robichaud
31 Berncliff Drive
North Branford, Connecticut 06471

(service waived)

Irene Flynn
1926 Middletown Avenue
Northford, Connecticut 06472

(service waived)

Charles Pope
199 Donalds Road
Guilford, Connecticut 06437

Richard Abate
131 Manor Road
Guilford, Connecticut 06437

(service waived)

City of Milford

represented by:

Mayor Alberta Jagoe
Alderman Maurice Condon
Alderman Frederick Lisman
City Hall
River Street
Milford, Connecticut 06460

Thomas Scelfo
81 Berncliff Drive
North Branford, Connecticut 06471

(service waived)

Senator Thomas Scott
22 Meyers Court
Milford, Connecticut 06460

(service waived)

Helen Moore
385 Oronoque Road
Milford, Connecticut 06460

(service waived)









William Barberi
298 Oronoque Road
Milford, Connecticut 06460

(service waived)

C E R T I F I C A T I O N

The undersigned members of the Connecticut Siting Council hereby certify that they have heard this case or read the record thereof, and that we voted as follows:

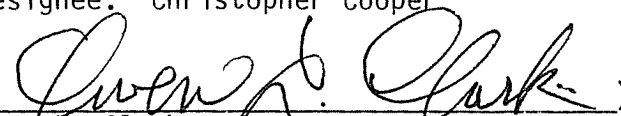
Dated at New Britain, Connecticut, this 14th day of April, 1986.
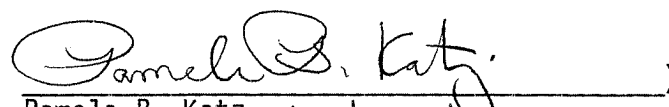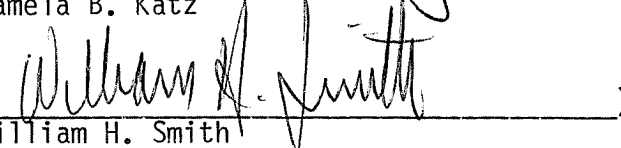
<u>Council Members</u>	<u>Vote Cast</u>
 Gloria Dibble Pond Chairperson	Yes
_____) Commissioner John Downey Designee: Commissioner Peter G. Boucher	Absent
 Commissioner Stanley Pad Designee: Christopher Cooper	No
 Owen L. Clark	Yes
 Mortimer A. Gelston	Yes
 James G. Horsfall	Yes
 Pamela B. Katz	Yes
 William H. Smith	No
 Colin C. Tait	No

STATE OF CONNECTICUT)
 :
COUNTY OF HARTFORD) ss. New Britain, April 14, 1986

I hereby certify that the foregoing is a true and correct copy of the decision and order issued by the Connecticut Siting Council, State of Connecticut.

ATTEST:

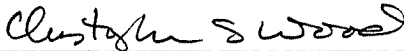

Christopher S. Wood, Executive Director
Connecticut Siting Council

Petition No. 673
Omnipoint Communications, Inc. (T-Mobile)
347 East Street
Wolcott, CT
Staff Report
June 9, 2004

On May 28, 2004, Connecticut Siting Council (Council) member Edward S. Wilensky and Christina Lepage of the Council staff met with Omnipoint Communications, Inc., a subsidiary of T-Mobile USA, Inc. (T-Mobile) representative Stephen Humes at 347 East Street, Wolcott, Connecticut for the inspection of an existing lattice tower. The structure is owned by Crown Castle. T-Mobile proposes to modify the existing tower by installing antennas and associated equipment for telecommunications use and is petitioning the Council for a declaratory ruling that no Certificate of Environmental Compatibility and Public Need (Certificate) is required for the modification.

T-Mobile proposes to install six flush mounted antennas, which would be mounted to pipe supports attached to the existing 180-foot tower. The pipe mast would extend approximately ten feet above the top of the existing tower. The antennas would be mounted with a centerline at 188 feet above ground level (AGL) bringing the top of the tower to 190 feet three inches AGL. T-Mobile would install GPS and GSM antennas on the ice bridge at 30 feet AGL.

The proposed equipment would be installed on a 17-foot by five-foot concrete slab to be located within the existing fenced area at the base of the tower. Access to the tower is via an existing access drive extending from East Street. Utilities would originate from existing sources.

The tower is located in an industrial zone on property owned by Agostino Rodrigues. The proposed antennas are intended to provide coverage to a portion of Interstate 84, Route 322 and the surrounding area.

The calculated cumulative worst-case radio frequency power density would not exceed the applicable standard.

T-Mobile contends that the proposed project would reduce the need for another telecommunications tower to provide coverage to the area, and that the proposed project would not have a substantial environmental effect.

Exhibit B

347 EAST ST

Location 347 EAST ST

Mblu 131/ 1/ 19/ /

Acct# R0478100

Owner RODRIGUES AGOSTINHO V &

Assessment \$453,670

Appraisal \$648,090

PID 5352

Building Count 3

Current Value

Appraisal			
Valuation Year	Improvements	Land	Total
2016	\$401,720	\$246,370	\$648,090

Assessment			
Valuation Year	Improvements	Land	Total
2016	\$281,210	\$172,460	\$453,670

Owner of Record

Owner RODRIGUES AGOSTINHO V &
Co-Owner JOANNE
Address 347 EAST ST
WOLCOTT, CT 06716

Sale Price \$0
Certificate
Book & Page 0131/0023
Sale Date 06/27/1980
Instrument 25

Ownership History

Ownership History					
Owner	Sale Price	Certificate	Book & Page	Instrument	Sale Date
RODRIGUES AGOSTINHO V &	\$0		0131/0023	25	06/27/1980

Building Information

Building 1 : Section 1

Year Built: 1930
Living Area: 3,139
Replacement Cost: \$339,418
Building Percent Good: 62
Replacement Cost
Less Depreciation: \$210,440

Building Attributes


Field	Description
Style	Colonial
Model	Residential
Grade:	B
Stories	1.9
Occupancy	1
Exterior Wall 1	Vinyl Siding
Exterior Wall 2	
Roof Structure	Gambrel
Roof Cover	Arch Shingles
Interior Wall 1	Drywall
Interior Wall 2	
Interior Flr 1	Carpet
Interior Flr 2	
Heat Fuel	Oil
Heat Type:	Hot Water
AC Percent	35% CAC
Total Bedrooms:	5 Bedrooms
Full Bthrms:	3
Half Baths:	0
Extra Fixtures	0
Total Rooms:	9
Bath Style:	Average
Kitchen Style:	Average
Num Kitchens	1
Fireplace(s)	0
% Attic Fin	0
LF Dormer	12
Foundation	Poured Conc
Bsmt Gar(s)	0
Bsmt %	100
SF FBM	0.00
SF Rec Rm	182
Fin Bsmt Qual	LQ
Bsmt Access	Int & Ext
Fndtn Cndtn	
Basement	

Building Photo



(<http://images.vgsi.com/photos/WolcottCTPhotos/A00\01\17\56.jpg>)

Building Layout

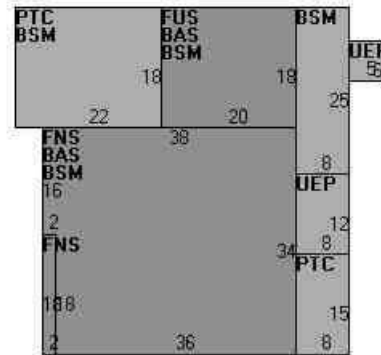

(http://images.vgsi.com/photos/WolcottCTPhotos/Sketches/5352_5352.jpg)

Building Sub-Areas (sq ft)			Legend
Code	Description	Gross Area	Living Area
BAS	First Floor	1,616	1,616
FNS	Finished 90% Story	1,292	1,163
FUS	Finished Upper Story	360	360
BSM	Basement	2,212	0
PTC	Concrete Patio	516	0
UEP	Unfin. Enclosed Porch	126	0
		6,122	3,139

Building 2 : Section 1

Year Built: 1910
Living Area: 1,308

Replacement Cost: \$134,245

Building Percent Good: 60

Replacement Cost

Less Depreciation: \$80,550

Building Attributes : Bldg 2 of 3


Field	Description
Style	Conventional
Model	Residential
Grade:	D
Stories	1
Occupancy	1
Exterior Wall 1	Vinyl Siding
Exterior Wall 2	
Roof Structure	Gable
Roof Cover	Arch Shingles
Interior Wall 1	Plaster
Interior Wall 2	
Interior Flr 1	Carpet
Interior Flr 2	
Heat Fuel	Oil
Heat Type:	Hot Water
AC Percent	None
Total Bedrooms:	2 Bedrooms
Full Bthrms:	1
Half Baths:	0
Extra Fixtures	0
Total Rooms:	5
Bath Style:	Average
Kitchen Style:	Average
Num Kitchens	1
Fireplace(s)	0
% Attic Fin	0
LF Dormer	0
Foundation	Poured Conc
Bsmt Gar(s)	0
Bsmt %	0
SF FBM	0.00
SF Rec Rm	0
Fin Bsmt Qual	
Bsmt Access	None
Fndtn Cndtn	
Basement	

Building Photo



(<http://images.vgsi.com/photos/WolcottCTPhotos/A00\01\17\57.jpg>)

Building Layout

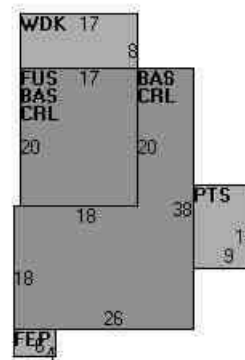

(http://images.vgsi.com/photos/WolcottCTPhotos/Sketches/5352_20142.jp)

Building Sub-Areas (sq ft)			Legend
Code	Description	Gross Area	Living Area
BAS	First Floor	968	968
FUS	Finished Upper Story	340	340
CRL	Crawl Space	968	0
FEP	Finished Enclosed Porch	24	0
PTS	Stone Patio	108	0
WDK	Deck	136	0
		2,544	1,308

Building 3 : Section 1

Year Built: 1912
Living Area: 1,481
Replacement Cost: \$160,287
Building Percent Good: 60
Replacement Cost Less Depreciation: \$96,170

Building Attributes : Bldg 3 of 3


Field	Description
Style	Conventional
Model	Residential
Grade:	D
Stories	1.65
Occupancy	2
Exterior Wall 1	Vinyl Siding
Exterior Wall 2	
Roof Structure	Gable
Roof Cover	Arch Shingles
Interior Wall 1	Plaster
Interior Wall 2	
Interior Flr 1	Hardwood
Interior Flr 2	Carpet
Heat Fuel	Oil
Heat Type:	Hot Water
AC Percent	None
Total Bedrooms:	3 Bedrooms
Full Bthrms:	2
Half Baths:	0
Extra Fixtures	0
Total Rooms:	7
Bath Style:	Average
Kitchen Style:	Average
Num Kitchens	2
Fireplace(s)	0
% Attic Fin	0
LF Dormer	0
Foundation	Poured Conc
Bsmt Gar(s)	0
Bsmt %	100
SF FBM	0.00
SF Rec Rm	0
Fin Bsmt Qual	

Building Photo



(<http://images.vgsi.com/photos/WolcottCTPhotos/A00\01\17\58.jpg>)

Building Layout

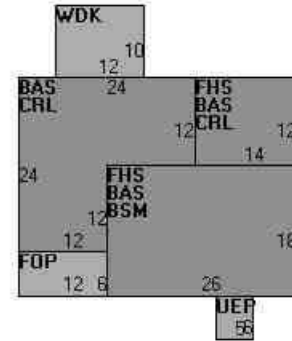

(http://images.vgsi.com/photos/WolcottCTPhotos/Sketches/5352_20143.jp)

Building Sub-Areas (sq ft)			Legend
Code	Description	Gross Area	Living Area
BAS	First Floor	1,068	1,068
FHS	Finished Half Story	636	413
BSM	Basement	468	0
CRL	Crawl Space	600	0
FOP	Open Porch	72	0
UEP	Unfin. Enclosed Porch	30	0
WDK	Deck	120	0
		2,994	1,481

Bsmt Access	Int & Ext
Fndtn Cndtn	
Basement	

Extra Features

Extra Features				Legend
Code	Description	Size	Value	Bldg #
SOL	Solar Array	39.00 UNITS	\$0	1

Land

Land Use

Use Code 112
Description Multiple Houses
Zone R-30
Neighborhood 6C
Alt Land Appr Category No

Land Line Valuation

Size (Acres) 2.20
Frontage
Depth
Assessed Value \$172,460
Appraised Value \$246,370


Outbuildings

Outbuildings						Legend
Code	Description	Sub Code	Sub Description	Size	Value	Bldg #
FGR1	Garage	FR	Frame	672.00 S.F.	\$5,880	1
FGR1	Garage	FR	Frame	560.00 S.F.	\$4,900	1
FOP	Porch			480.00 S.F.	\$2,760	1
PTO	Patio	CN	Concrete	408.00 S.F.	\$1,020	1

Valuation History

Appraisal			
Valuation Year	Improvements	Land	Total
2019	\$401,720	\$246,370	\$648,090
2018	\$401,720	\$246,370	\$648,090
2017	\$401,720	\$246,370	\$648,090

Assessment			
Valuation Year	Improvements	Land	Total
2019	\$281,210	\$172,460	\$453,670
2018	\$281,210	\$172,460	\$453,670
2017	\$281,210	\$172,460	\$453,670

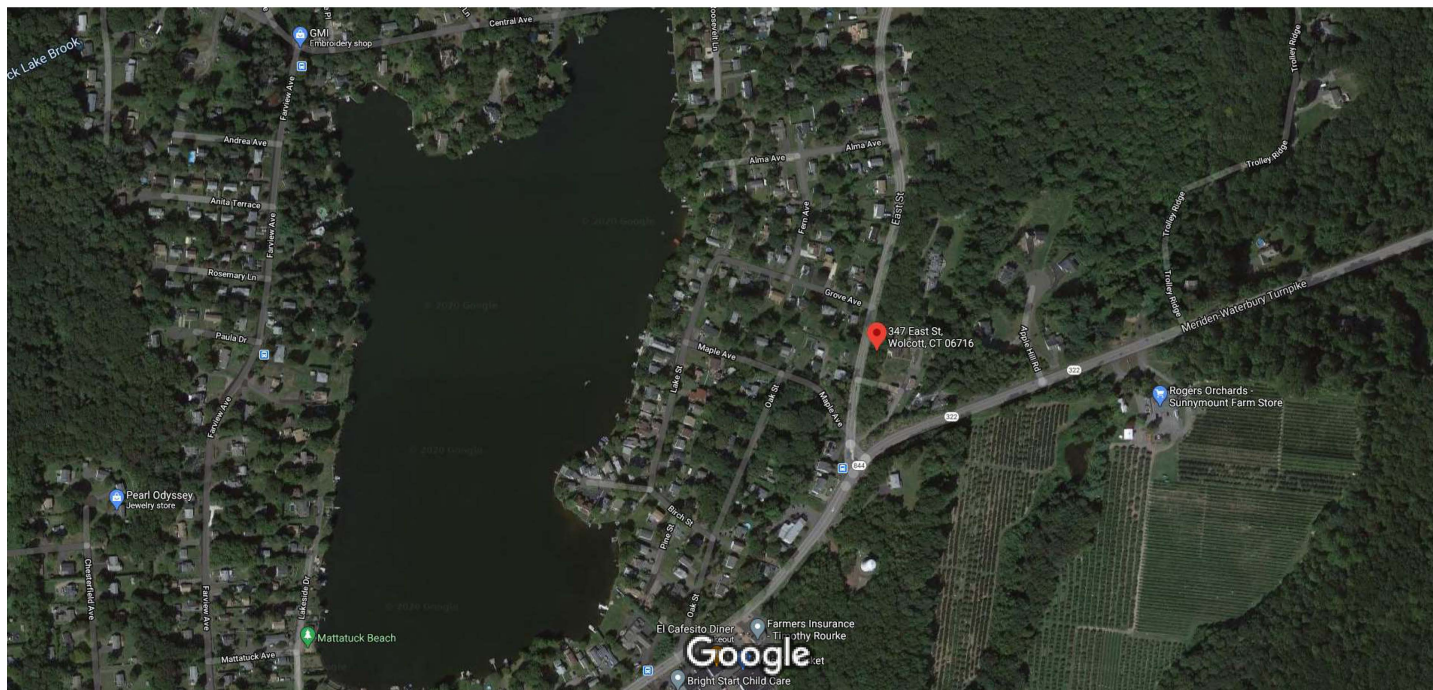

200 ft



Exhibit C

MODIFICATION TO EXISTING WIRELESS FACILITY BY



**T-MOBILE NORTHEAST LLC
NATIONAL HARDENING PROJECT**


**CROWN CASTLE BUSINESS UNIT #: 806362
SITE NUMBER: CT11494B
SITE NAME: CT494 / CCASTLE-WOLCOTT-SST
SITE ADDRESS: 347 EAST STREET
WOLCOTT, CT 06716**

APPLICANT:
T-Mobile
T-MOBILE NORTHEAST LLC
35 GRIFFIN ROAD SOUTH
BLOOMFIELD, CT 06002
860-692-7100

PROJECT MANAGER

420 MAIN STREET, BLDG 4
STURBRIDGE, MA 01566
203-275-6669

CONSULTANT:
FORESITE LLC
Architects . Engineers . Surveyors
462 WALNUT STREET
NEWTON, MA 02460
617-212-3123

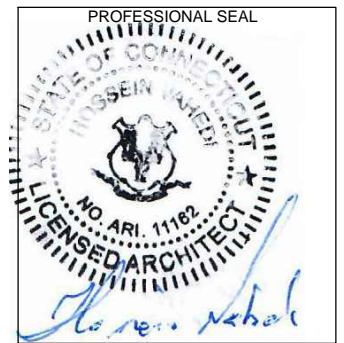

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REV	DESCRIPTION	DATE
A	PRELIMINARY	04/15/21

CROWN CASTLE BUSINESS UNIT #: 806362
SITE NUMBER: CT11494B
SITE NAME: CT494 / CCASTLE-WOLCOTT-SST
SITE ADDRESS:
347 EAST STREET
WOLCOTT, CT 06716

SHEET TITLE:
T-1: TITLE SHEET

PROJECT NOTES:

- THIS IS AN UNMANNED TELECOMMUNICATION FACILITY AND NOT FOR HUMAN HABITATION. HANDICAPPED ACCESS IS NOT REQUIRED. POTABLE WATER OR SANITARY SERVICE IS NOT REQUIRED. NO OUTDOOR STORAGE OR ANY SOLID WASTE RECEPTACLES REQUIRED.
- CONTRACTOR SHALL VERIFY ALL PLANS, EXISTING DIMENSIONS, AND CONDITIONS ON THE JOB SITE. CONTRACTOR SHALL IMMEDIATELY NOTIFY THE ARCHITECT/ENGINEER IN WRITING OF ANY DISCREPANCIES BEFORE PROCEEDING WITH THE WORK. FAILURE TO NOTIFY THE ARCHITECT/ENGINEER PLACES THE RESPONSIBILITY ON THE CONTRACTOR TO CORRECT THE DISCREPANCIES AT THE CONTRACTOR'S EXPENSE.
- DEVELOPMENT AND USE OF THE SITE WILL CONFORM TO ALL APPLICABLE CODES, ORDINANCES AND SPECIFICATIONS.



PROJECT SCOPE:
THE PROPOSED PROJECT SCOPE WILL CONSIST OF INSTALLING A NEW GENERAC RD 25 KW AC DIESEL GENERATOR AND TANK FOR AN EXISTING TELECOM BASE STATION. NO SIGNIFICANT GRADING IS REQUIRED. ALL PROPOSED CONSTRUCTION WILL BE CONTAINED WITHIN TOWER SITE LEASE AREA.

PROJECT INFORMATION:

SITE NUMBER: CT11494B
SITE NAME: CT494 / CCASTLE-WOLCOTT-SST
SITE ADDRESS: 347 EAST STREET WOLCOTT, CT 06716

MBLU: 131-1-19
ZONING DISTRICT: R-30
STRUCTURE TYPE: SELF SUPPORT TOWER
COORDINATES: 41° 33' 34.21" N, 72° 56' 49.26" W
GROUND ELEV: 744± (AMSL)

PROJECT TEAM:

APPLICANT: T-MOBILE NORTHEAST, LLC.
35 GRIFFIN ROAD SOUTH
BLOOMFIELD, CT 06002
860-692-7100

PROPERTY OWNER: RODRIGUES AGOSTINHO V & JOANNE
347 EAST STREET
WOLCOTT, CT 06716


PROJECT MANAGER: NORTHEAST SITE SOLUTIONS
420 MAIN STREET, BLDG 4
STURBRIDGE, MA 01566
SHELDON FREINCLE
SHELDON@NORTHEASTSITESOLUTIONS.COM
TEL: 201-776-8521

ENGINEERING CONSULTANTS: FORESITE LLC
462 WALNUT ST, SUITE 1
NEWTON, MA 02460
SAEED MOSSAVAT
SMOSSAVAT@FORESITELLC.COM
TEL: 617-212-3123

CODE COMPLIANCE:

ALL WORK SHALL COMPLY WITH THE CURRENT NATIONAL AND CONNECTICUT STATE BUILDING AND LIFE SAFETY CODES, SUPPLEMENTS AND AMENDMENTS INCLUDING BUT NOT LIMITED TO THE LATEST EDITION OF:

CONNECTICUT STATE BUILDING CODE (CSBC).
ANSI/TIA-222-G STRUCTURAL STANDARD FOR ANTENNA SUPPORTING STRUCTURES AND ANTENNAS.
NATIONAL ELECTRICAL CODE (NEC) FOR POWER AND GROUNDING REQUIREMENTS.
OCCUPATIONAL SAFETY AND HEALTH ACT (OSHA).
NFPA - NATIONAL FIRE PROTECTION ASSOCIATION.

 **Connecticut - Call Before You Dig**
811 or 1-800-922-4455
Advance Notice: Minimum of 2 working days in advance, no more than 30 days in advance



APPROVALS:

FSA CM	DATE
RF ENGINEER	DATE
FOPS	DATE
T-MOBILE ENGINEERING AND DEVELOPMENT	DATE
	DATE
	DATE

SHEET INDEX:

T-1: TITLE SHEET
N-1: GENERAL NOTES
A-1: SITE SCAN
A-2: SITE PLAN
A-3: GENERATOR SPECIFICATIONS AND DETAILS
A-4: GENERATOR SPECIFICATIONS AND DETAILS
A-5: AUTOMATIC TRANSFER SWITCH SPECIFICATIONS
A-6: UNDERGROUND CONDUIT DETAILS
E-1: ELECTRICAL DETAILS
G-1: GROUNDING DETAILS

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1. THE CONTRACTOR SHALL GIVE ALL NOTICES AND COMPLY WITH ALL LAWS, ORDINANCES, RULES, REGULATIONS AND LAWFUL ORDERS OF ANY PUBLIC AUTHORITY, MUNICIPAL AND UTILITY COMPANY SPECIFICATIONS, AND LOCAL AND STATE JURISDICTIONAL CODES BEARING ON THE PERFORMANCE OF THE WORK. THE WORK PERFORMED ON THE PROJECT AND THE MATERIALS INSTALLED SHALL BE IN STRICT ACCORDANCE WITH ALL APPLICABLE CODES, REGULATIONS, AND ORDINANCES.
2. THE ARCHITECT/ENGINEER HAS MADE EVERY EFFORT TO SET FORTH IN THE CONSTRUCTION AND CONTRACT DOCUMENTS THE COMPLETE SCOPE OF WORK. THE CONTRACTOR BIDDING THE JOB IS NEVERTHELESS CAUTIONED THAT MINOR OMISSIONS OR ERRORS IN THE DRAWINGS AND OR SPECIFICATIONS SHALL NOT EXCUSE SAID CONTRACTOR FROM COMPLETING THE PROJECT AND IMPROVEMENTS IN ACCORDANCE WITH THE INTENT OF THESE DOCUMENTS.
3. THE CONTRACTOR OR BIDDER SHALL BEAR THE RESPONSIBILITY OF NOTIFYING (IN WRITING) THE CLIENT'S REPRESENTATIVE OF ANY CONFLICTS, ERRORS, OR OMISSIONS PRIOR TO THE SUBMISSION OF CONTRACTOR'S PROPOSAL OR PERFORMANCE OF WORK.
5. THE CONTRACTOR SHALL VISIT THE JOB SITE PRIOR TO THE SUBMISSION OF BIDS OR PERFORMING WORK TO FAMILIARIZE HIMSELF WITH THE FIELD CONDITIONS AND TO VERIFY THAT THE PROJECT CAN BE CONSTRUCTED IN ACCORDANCE WITH THE CONSTRUCTION DOCUMENTS.
6. THE CONTRACTOR SHALL INSTALL ALL EQUIPMENT AND MATERIALS ACCORDING TO THE MANUFACTURER'S / VENDOR'S SPECIFICATIONS UNLESS NOTED OTHERWISE OR WHERE LOCAL CODES OR ORDINANCES TAKE PRECEDENCE.
7. THE CONTRACTOR SHALL MAKE NECESSARY PROVISIONS TO PROTECT EXISTING IMPROVEMENTS DURING CONSTRUCTION.
8. THE CONTRACTOR SHALL COMPLY WITH ALL PERTINENT SECTIONS OF THE BASIC STATE BUILDING CODE, LATEST EDITION, AND ALL OSHA REQUIREMENTS AS THEY APPLY TO THIS PROJEC
9. THE CONTRACTOR SHALL NOTIFY THE CLIENT'S REPRESENTATIVE IN WRITING WHERE A CONFLICT OCCURS ON ANY OF THE CONTRACT DOCUMENTS. THE CONTRACTOR IS NOT TO ORDER MATERIAL OR CONSTRUCT ANY PORTION OF THE WORK THAT IS IN CONFLICT UNTIL CONFLICT IS RESOLVED BY THE CLIENT'S REPRESENTATIVE.
10. THE WORK SHALL CONFORM TO THE CODES AND STANDARDS OF THE FOLLOWING AGENCIES AS FURTHER CITED HEREIN:
 - A. ASTM: AMERICAN SOCIETY FOR TESTING AND MATERIALS, AS PUBLISHED IN "COMPILATION OF ASTM STANDARDS BUILDING CODES" OR LATEST EDITION.
 - B. AWS: AMERICAN WELDING SOCIETY INC. AS PUBLISHED IN "STANDARD D1.1-08, STRUCTURAL WELDING CODE" OR LATEST EDITION.
 - C. AISC: AMERICAN INSTITUTE FOR STEEL CONSTRUCTION AS PUBLISHED IN "CODE FOR STANDARD PRACTICE FOR STEEL BUILDINGS AND BRIDGES"; "SPECIFICATIONS FOR THE DESIGN, FABRICATION AND ERECTION OF STRUCTURAL STEEL FOR BUILDINGS" (LATEST EDITION).
11. BOLTING:
 - A. BOLTS SHALL BE CONFORMING TO ASTM A325 HIGH STRENGTH, HOT DIP GALVANIZED WITH ASTM A153 HEAVY HEX TYPE NUTS.
 - B. BOLTS SHALL BE 3/4"Ø MINIMUM (UNLESS OTHERWISE NOTED)
 - C. ALL CONNECTIONS SHALL BE 2 BOLTS MINIMUM.
12. FABRICATION:
 - A. FABRICATION OF STEEL SHALL CONFORM TO THE AISC AND AWS STANDARDS AND CODES (LATEST EDITION).
 - B. ALL STRUCTURAL STEEL SHALL BE HOT-DIP GALVANIZED AFTER FABRICATION IN ACCORDANCE WITH ASTM A123 (LATEST EDITION), UNLESS OTHERWISE NOTED.
13. ERECTION OF STEEL:
 - A. PROVIDE ALL ERECTION EQUIPMENT, BRACING, PLANKING, FIELD BOLTS, NUTS, WASHERS, DRIFT PINS, AND SIMILAR MATERIALS WHICH DO NOT FORM A PART OF THE COMPLETED CONSTRUCTION BUT ARE NECESSARY FOR ITS PROPER ERECTION.
 - B. ERECT AND ANCHOR ALL STRUCTURAL STEEL IN ACCORDANCE WITH AISC REFERENCE STANDARDS. ALL WORK SHALL BE ACCURATELY SET TO ESTABLISHED LINES AND ELEVATIONS AND RIGIDLY FASTENED IN PLACE WITH SUITABLE ATTACHMENTS TO THE CONSTRUCTION OF THE BUILDING.
 - C. TEMPORARY BRACING, GUYING AND SUPPORT SHALL BE PROVIDED TO KEEP THE STRUCTURE SAFE AND ALIGNED AT ALL TIMES DURING CONSTRUCTION, AND TO PREVENT DANGER TO PERSONS AND PROPERTY. CHECK ALL TEMPORARY LOADS AND STAY WITHIN SAFE CAPACITY OF ALL BUILDING COMPONENTS.
14. ANTENNA INSTALLATION:
 - A. INSTALL ANTENNAS AS INDICATED ON DRAWINGS AND CLIENT'S REPRESENTATIVE SPECIFICATIONS.


- B. INSTALL GALVANIZED STEEL ANTENNA MOUNTS AS INDICATED ON DRAWINGS.
- C. INSTALL COAXIAL / FIBER CABLES AND TERMINATIONS BETWEEN ANTENNAS AND EQUIPMENT PER MANUFACTURER'S RECOMMENDATIONS. WEATHERPROOF ALL CONNECTORS BETWEEN THE ANTENNA AND EQUIPMENT PER MANUFACTURER'S REQUIREMENTS.
15. ANTENNA AND COAXIAL / FIBER CABLE GROUNDING:
 - A. ALL EXTERIOR #6 GREEN GROUND WIRE "DAISY CHAIN" CONNECTIONS ARE TO BE WEATHER SEALED WITH ANDREWS CONNECTOR/SPLICE WEATHERPROOFING KIT TYPE #221213 OR EQUAL.
 - B. ALL COAXIAL / FIBER CABLE GROUNDING KITS ARE TO BE INSTALLED ON STRAIGHT RUNS OF COAXIAL / FIBER CABLE (NOT WITHIN BENDS).
16. RELATED WORK, FURNISH THE FOLLOWING WORK AS SPECIFIED UNDER CONSTRUCTION DOCUMENTS, BUT COORDINATE WITH OTHER TRADES PRIOR TO BID:
 - A. FLASHING OF OPENING INTO OUTSIDE WALLS
 - B. SEALING AND CAULKING ALL OPENINGS
 - C. PAINTING
 - D. CUTTING AND PATCHING
17. REQUIREMENTS OF REGULATORY AGENCIES:
 - A. FURNISH U.L. LISTED EQUIPMENT WHERE SUCH LABEL IS AVAILABLE. INSTALL IN CONFORMANCE WITH U.L. STANDARDS WHERE APPLICABLE.
 - B. INSTALL ANTENNA, ANTENNA CABLES, GROUNDING SYSTEM IN ACCORDANCE WITH DRAWINGS AND SPECIFICATION IN EFFECT AT PROJECT LOCATION AND RECOMMENDATIONS OF STATE AND LOCAL BUILDING CODES, AND SPECIAL CODES HAVING JURISDICTION OVER SPECIFIC PORTIONS OF WORK. THIS WORK INCLUDES BUT IS NOT LIMITED TO THE FOLLOWING:
 - C. TIA-EIA - 222 (LATEST EDITION). STRUCTURAL STANDARDS FOR STEEL ANTENNA TOWERS AND ANTENNA SUPPORTING STRUCTURES.
 - D. FAA - FEDERAL AVIATION ADMINISTRATION ADVISORY CIRCULAR AC 70/7460-IH. OBSTRUCTION MARKING AND LIGHTING.
 - E. FCC - FEDERAL COMMUNICATIONS COMMISSION RULES AND REGULATIONS FORM 715, OBSTRUCTION MARKING AND LIGHTING SPECIFICATION FOR ANTENNA STRUCTURES AND FORM 715A, HIGH INTENSITY OBSTRUCTION LIGHTING SPECIFICATIONS FOR ANTENNA STRUCTURES.
 - F. AISC - AMERICAN INSTITUTE OF STEEL CONSTRUCTION SPECIFICATION FOR STRUCTURAL JOINTS USING ASTM A325 BOLTS (LATEST EDITION).
 - G. NEC - NATIONAL ELECTRICAL CODE - ON TOWER LIGHTING KITS.
 - H. UL - UNDERWRITER'S LABORATORIES APPROVED ELECTRICAL PRODUCTS.
 - I. IN ALL CASES, PART 77 OF THE FAA RULES AND PARTS 17 AND 22 OF THE FCC RULES ARE APPLICABLE AND IN THE EVENT OF CONFLICT, SUPERSEDE ANY OTHER STANDARDS OR SPECIFICATIONS.
 - J. 2018 LIFE SAFETY CODE NFPA - 101.


APPLICANT:

T-MOBILE NORTHEAST LLC
 35 GRIFFIN ROAD SOUTH
 BLOOMFIELD, CT 06002
 860-692-7100

PROJECT MANAGER

 420 MAIN STREET, BLDG 4
 STURBRIDGE, MA 01566
 203-275-6669

CONSULTANT:

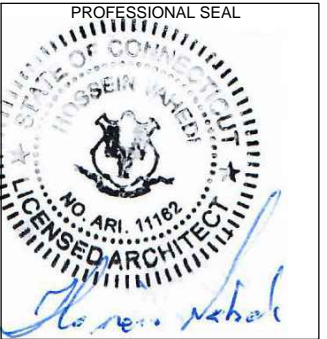 Architects . Engineers . Surveyors
 462 WALNUT STREET
 NEWTON, MA 02460
 617-212-3123



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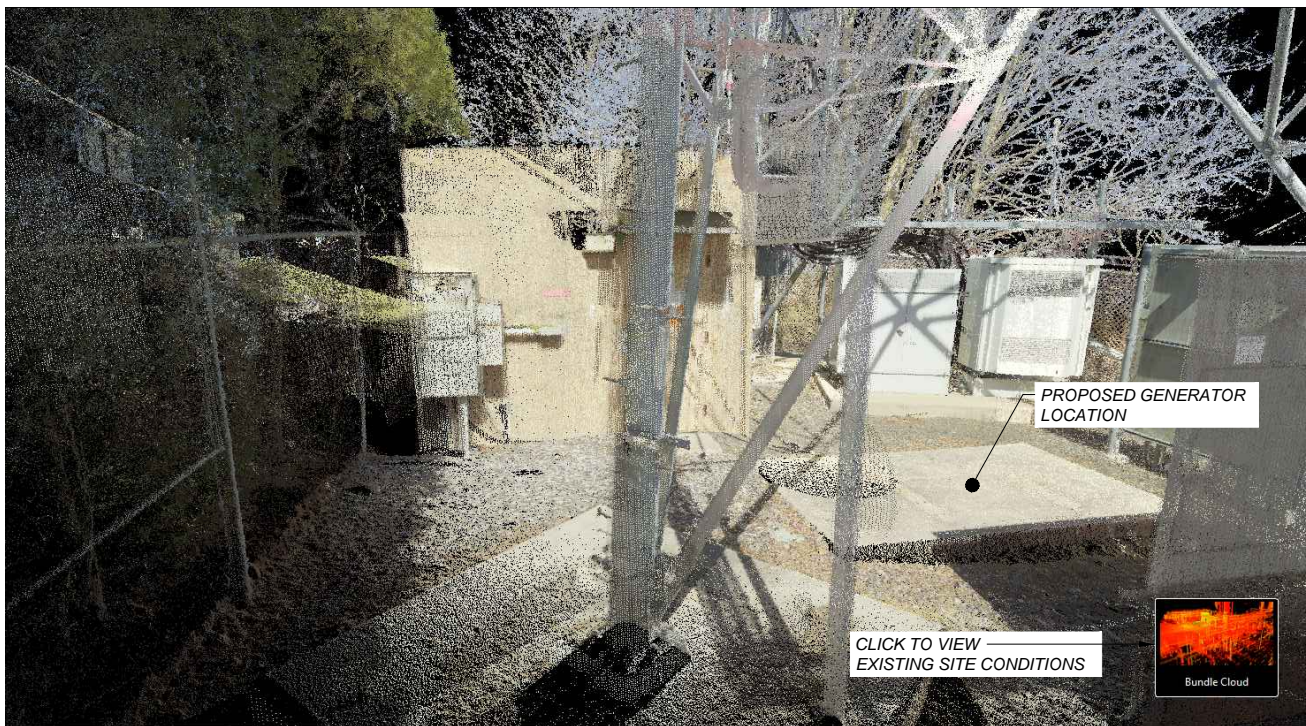
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SHEET TITLE:
N-1: GENERAL NOTES

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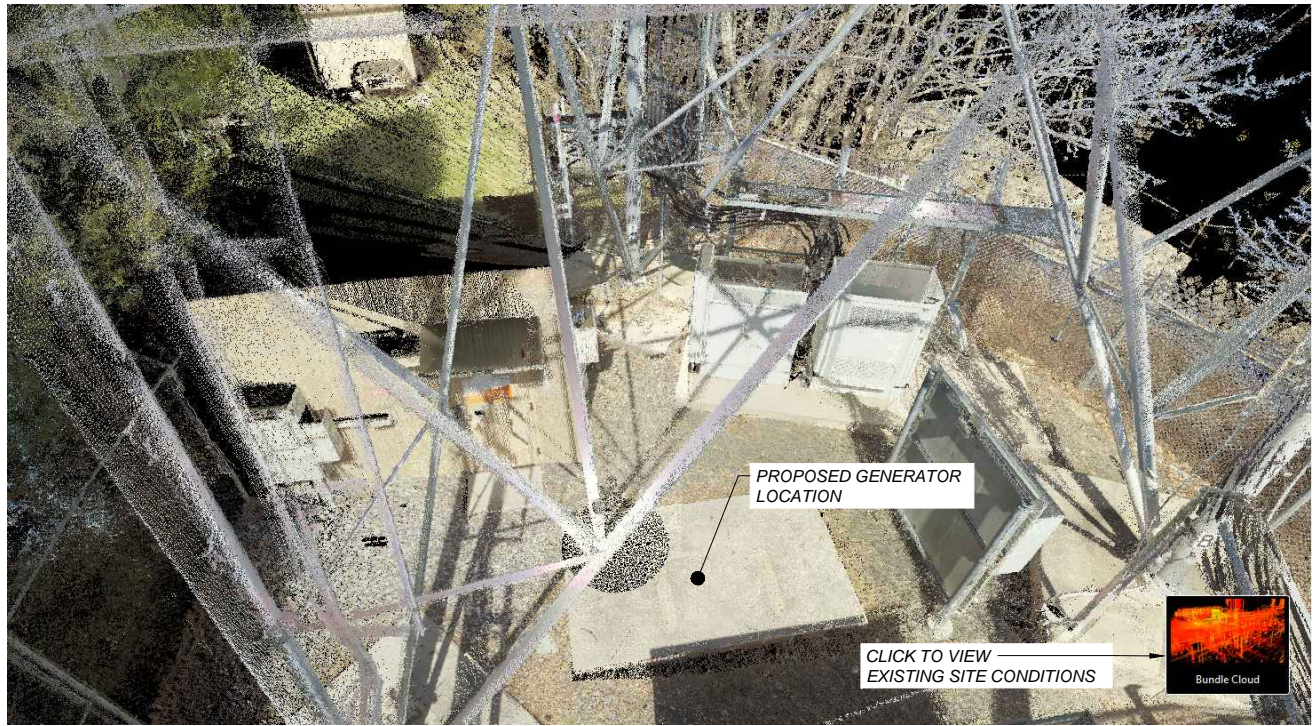


CLICK TO VIEW
EXISTING SITE CONDITIONS




PROPOSED GENERATOR
LOCATION

CLICK TO VIEW
EXISTING SITE CONDITIONS



PROPOSED GENERATOR
LOCATION

CLICK TO VIEW
EXISTING SITE CONDITIONS

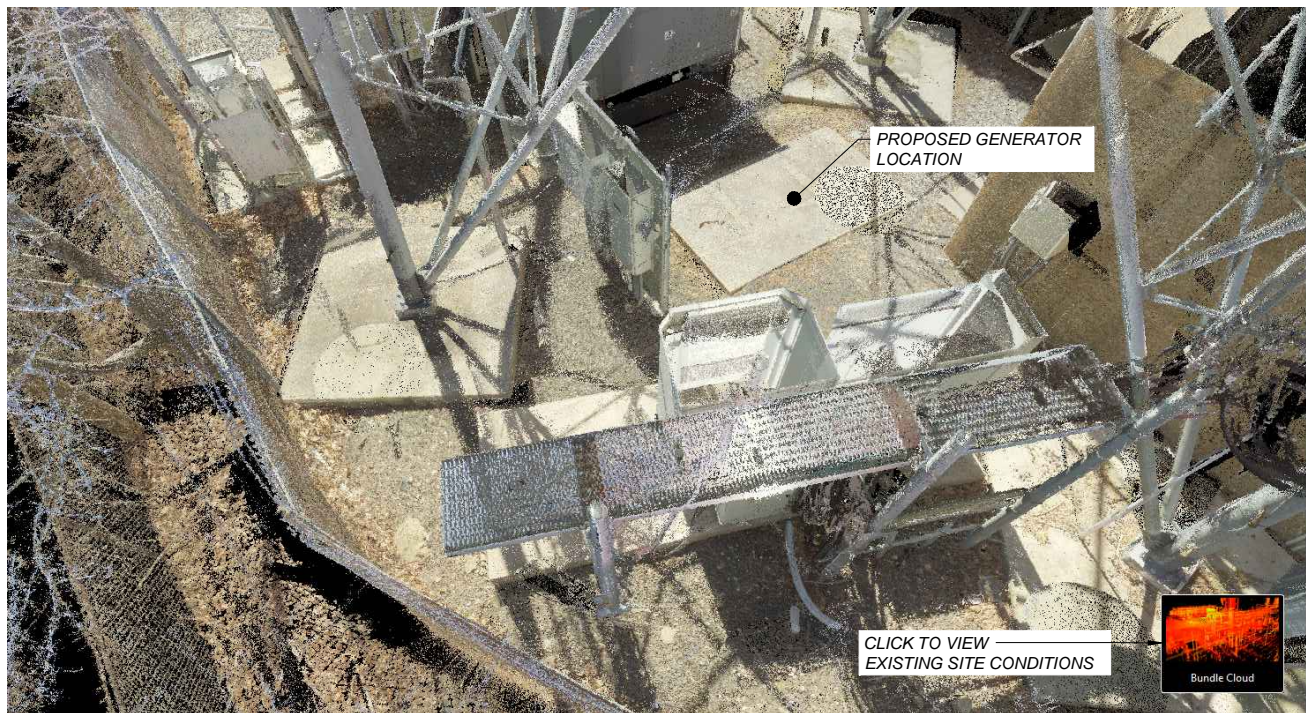

PROPOSED GENERATOR
LOCATION

CLICK TO VIEW
EXISTING SITE CONDITIONS



APPLICANT:
T-Mobile
T-MOBILE NORTHEAST LLC

35 GRIFFIN ROAD SOUTH
BLOOMFIELD, CT 06002
860-692-7100

PROJECT MANAGER




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203-275-6669

CONSULTANT:

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Architects . Engineers . Surveyors

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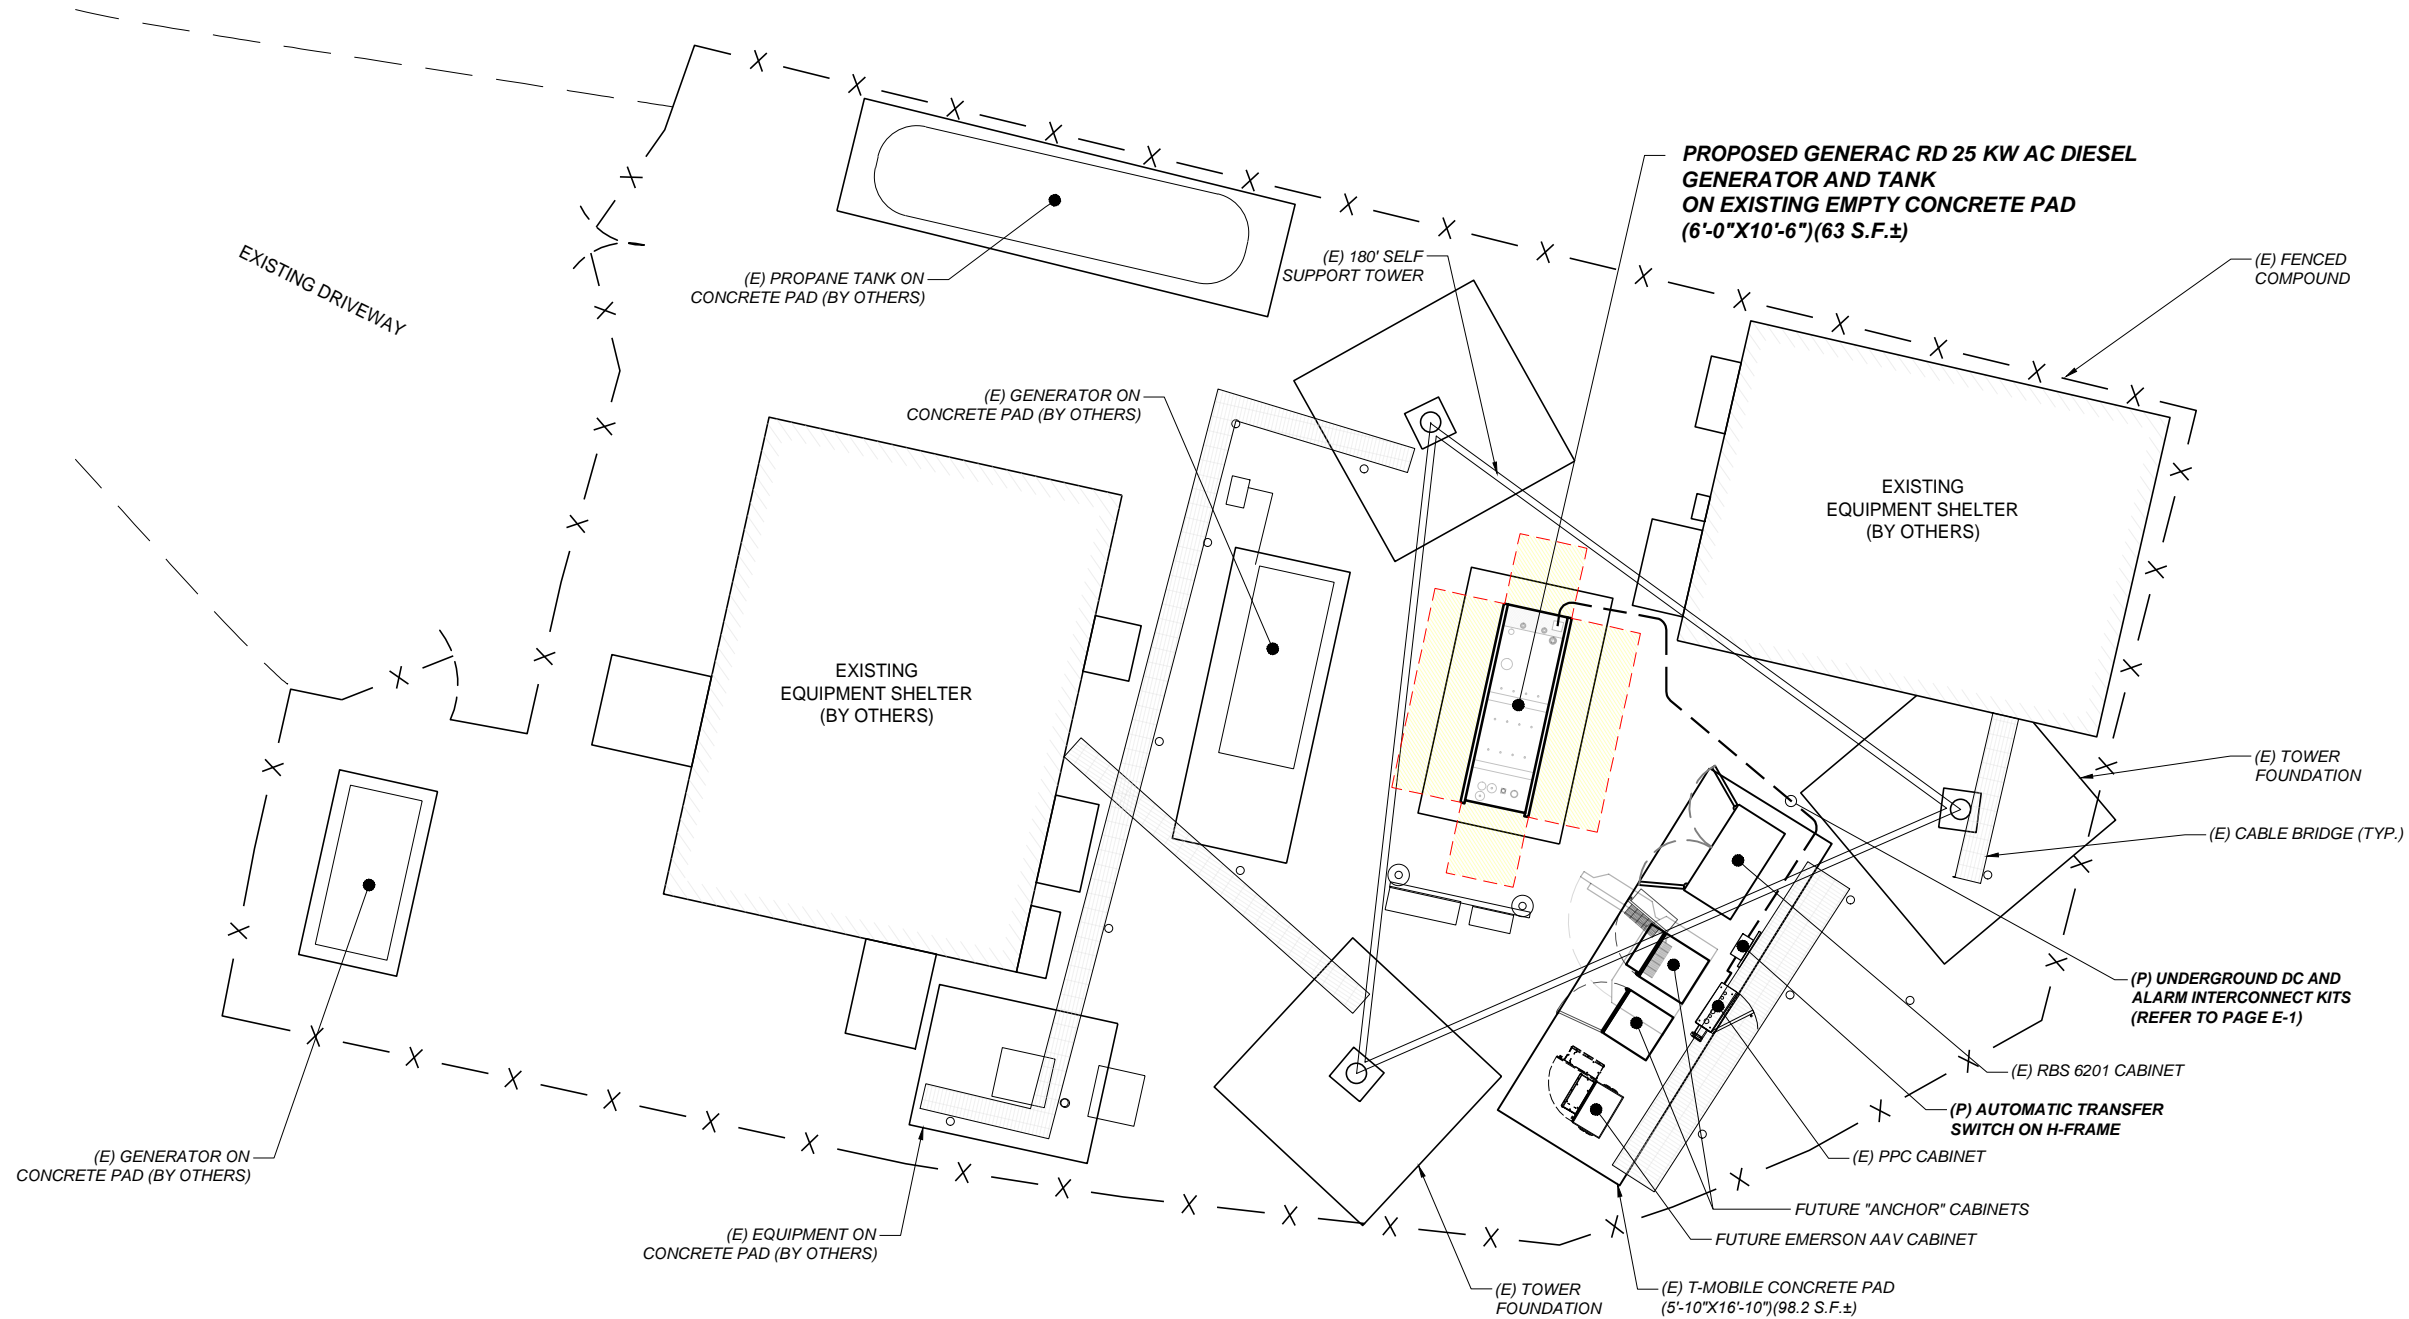
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WOLCOTT, CT 06716

SHEET TITLE:
A-1: SITE SCAN

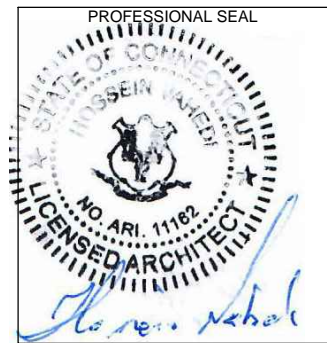SITE POINT CLOUD
SCALE: 1"=150'±



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SITE PLAN
SCALE: 1"=150'±

1
A-2

APPLICANT:
T-Mobile
T-MOBILE NORTHEAST LLC

35 GRIFFIN ROAD SOUTH
BLOOMFIELD, CT 06002
860-692-7100

PROJECT MANAGER




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STURBRIDGE, MA 01566
203-275-6669

CONSULTANT:

FORESITE LLC

Architects . Engineers . Surveyors

462 WALNUT STREET
NEWTON, MA 02460
617-212-3123

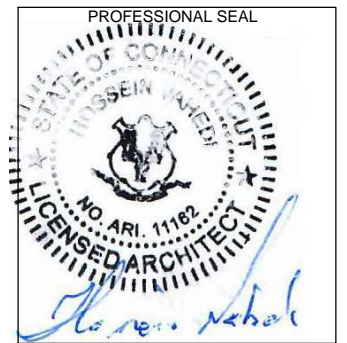

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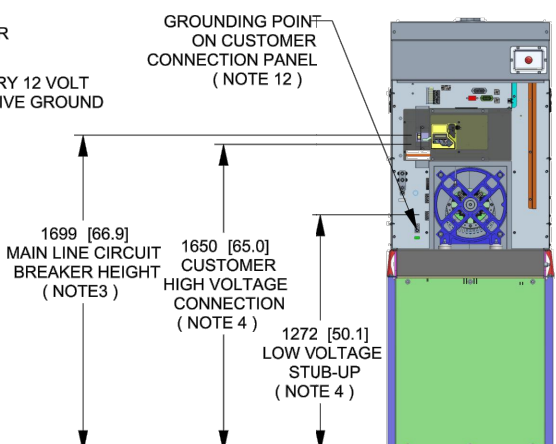
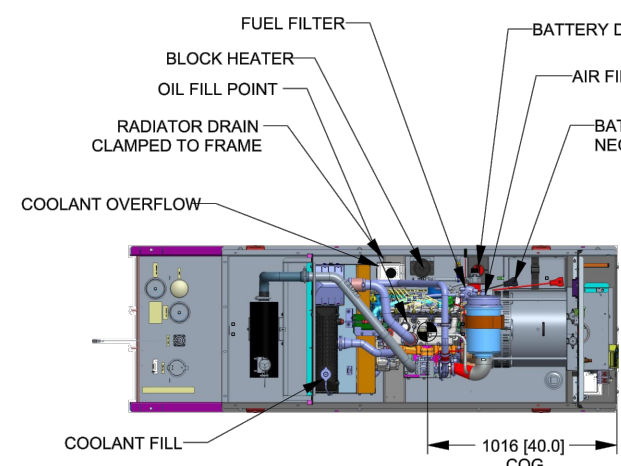
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SHEET TITLE:
A-2: SITE PLAN

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GENERAC RD 25 KW AC DIESEL GENERATOR AND TANK

SH	1/2	REV	2	WINDCHILL VERSION	2.12
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WEIGHT DATA WITH EMPTY BASE TANK (SEE NOTE 6)	
GENERATOR AS SHOWN	1336 [2946]
WITH WOODEN SHIPPING SKID	1354 [2984]


WEIGHT: KG [LBS]
DIMENSIONS: MM [INCHES]

- NOTES:**
- THIS UNIT MUST BE INSTALLED IN ACCORDANCE WITH CURRENT APPLICABLE NFPA 37 AND NFPA 70 STANDARDS AS WELL AS ANY OTHER FEDERAL, STATE, AND LOCAL CODES.
 - BATTERY (12 VOLT NEGATIVE GROUND SYSTEM).
 - CONTROL PANEL / CIRCUIT BREAKER INFORMATION:
 - MAIN LINE CIRCUIT BREAKER 125 AMPS
 - SEE SPECIFICATION SHEET OR OWNERS MANUAL
 - ACCESSIBLE THROUGH CUSTOMER ACCESS ASSEMBLY DOOR ON REAR OF GENERATOR.
 - CONTROL PANEL INCLUDES INTEGRATED BATTERY CHARGER
 - REMOVE THE REAR STUB-UP AND REAR ENCLOSURE COVER PANEL TO ACCESS THE STUB-UP AREAS AS FOLLOWS:
 - HIGH VOLTAGE CONNECTION INCLUDING AC LOAD LEAD CONDUIT CONNECTION, NEUTRAL CONNECTION, AND BATTERY CHARGER 120 VOLT AC (0.5 AMP MAX) CONNECTION.
 - LOW VOLTAGE CONNECTION INCLUDING TRANSFER SWITCH CONTROL WIRES
 - ENGINE SERVICE CONNECTIONS
OIL DRAIN: 1/2" NPT
RADIATOR DRAIN : HOSE CLAMPED TO FRAME
 - CENTER OF GRAVITY AND WEIGHT MAY CHANGE DUE TO UNIT OPTIONS.
 - BOTTOM OF GENERATOR SET MUST BE ENCLOSED TO PREVENT PEST INTRUSION AND RECIRCULATION OF DISCHARGE AIR AND/OR IMPROPER COOLING AIR FLOW.
 - REFERENCE OWNERS MANUAL FOR LIFTING WARNINGS.
 - MOUNTING BOLTS OR STUDS TO MOUNTING SURFACE SHALL BE 5/8-11 GRADE 5 (USE STANDARD SAE TORQUE SPECS)
 - MUST ALLOW FREE FLOW OF INTAKE AIR, DISCHARGE AIR AND EXHAUST. SEE SPEC SHEET FOR MINIMUM AIR FLOW AND MAXIMUM RESTRICTION REQUIREMENTS.
 - GENERATOR MUST BE INSTALLED SUCH THAT FRESH COOLING AIR IS AVAILABLE AND THAT DISCHARGE AIR FROM RADIATOR IS NOT RECIRCULATED. RECOMMENDED MINIMUM PERIMETER(3FT) AND VERTICAL OVER EXHAUST (5FT) CLEARANCE FOR SITE LOCATION.
 - GENERATOR MUST BE GROUNDED.



B

B

TOP VIEW (SHOWN WITH ENCLOSURE REMOVED)

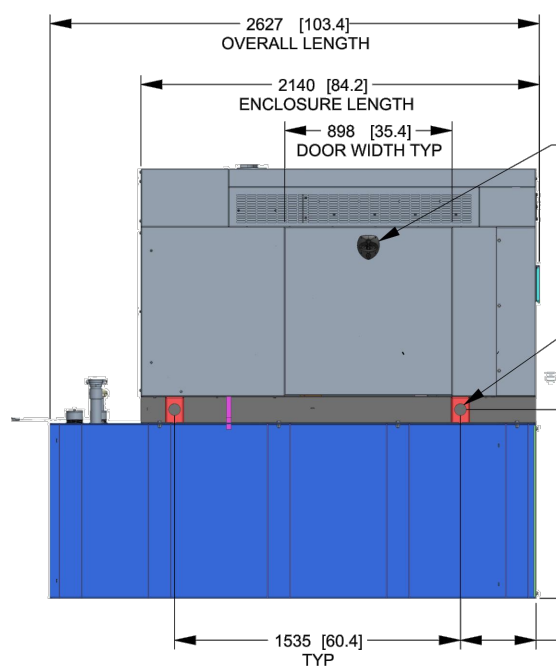

REAR VIEW (SHOWN WITH REAR COVER PANEL REMOVED)

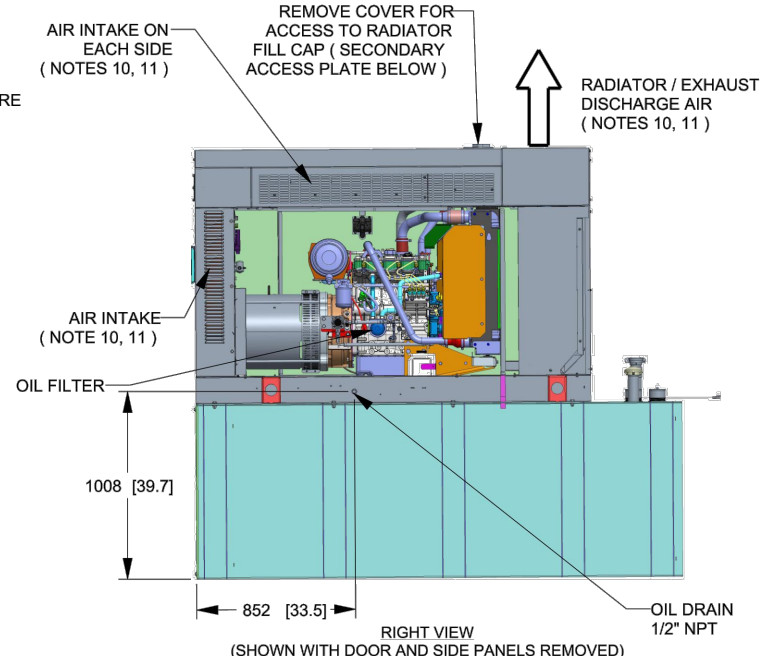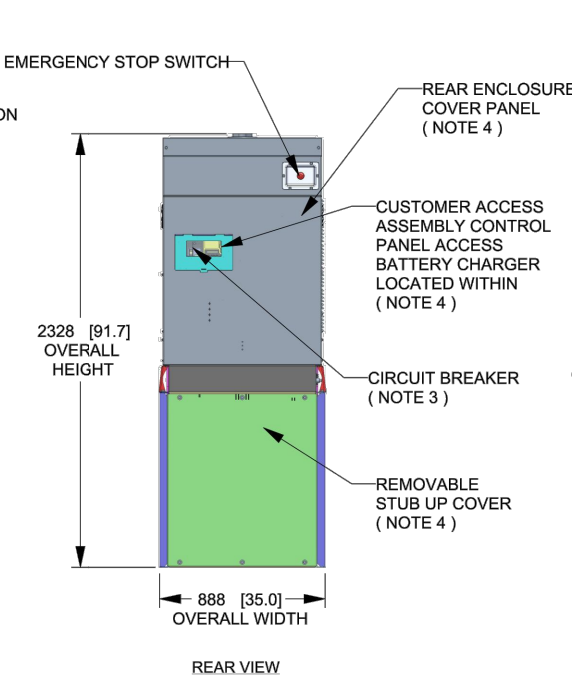

A

A

DRAWING CREATED FROM PRO/ENGINEER 3D FILE. ECO MODIFICATION TO BE APPLIED TO SOLID MODEL ONLY.

INSTALLATION DRAWING

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ELECTRONICALLY APPROVED INSIDE WINDCHILL



TITLE			
INSTALLATION D2.2L 25KW Y06 PD			
ISSUE DATE: 5/10/18			
SIZE	CAGE NO	DWG NO	REV
B	N/A	10000036728	2
SCALE	WT-KG	SEE ABOVE	SHEET
0.031			1 of 2

4

3

2

1

GENERATOR SPECIFICATIONS
N.T.S.

1
A-3

APPLICANT:
T-Mobile
T-MOBILE NORTHEAST LLC
35 GRIFFIN ROAD SOUTH
BLOOMFIELD, CT 06002
860-692-7100

PROJECT MANAGER
NORTHEAST SITE SOLUTIONS
420 MAIN STREET, BLDG 4
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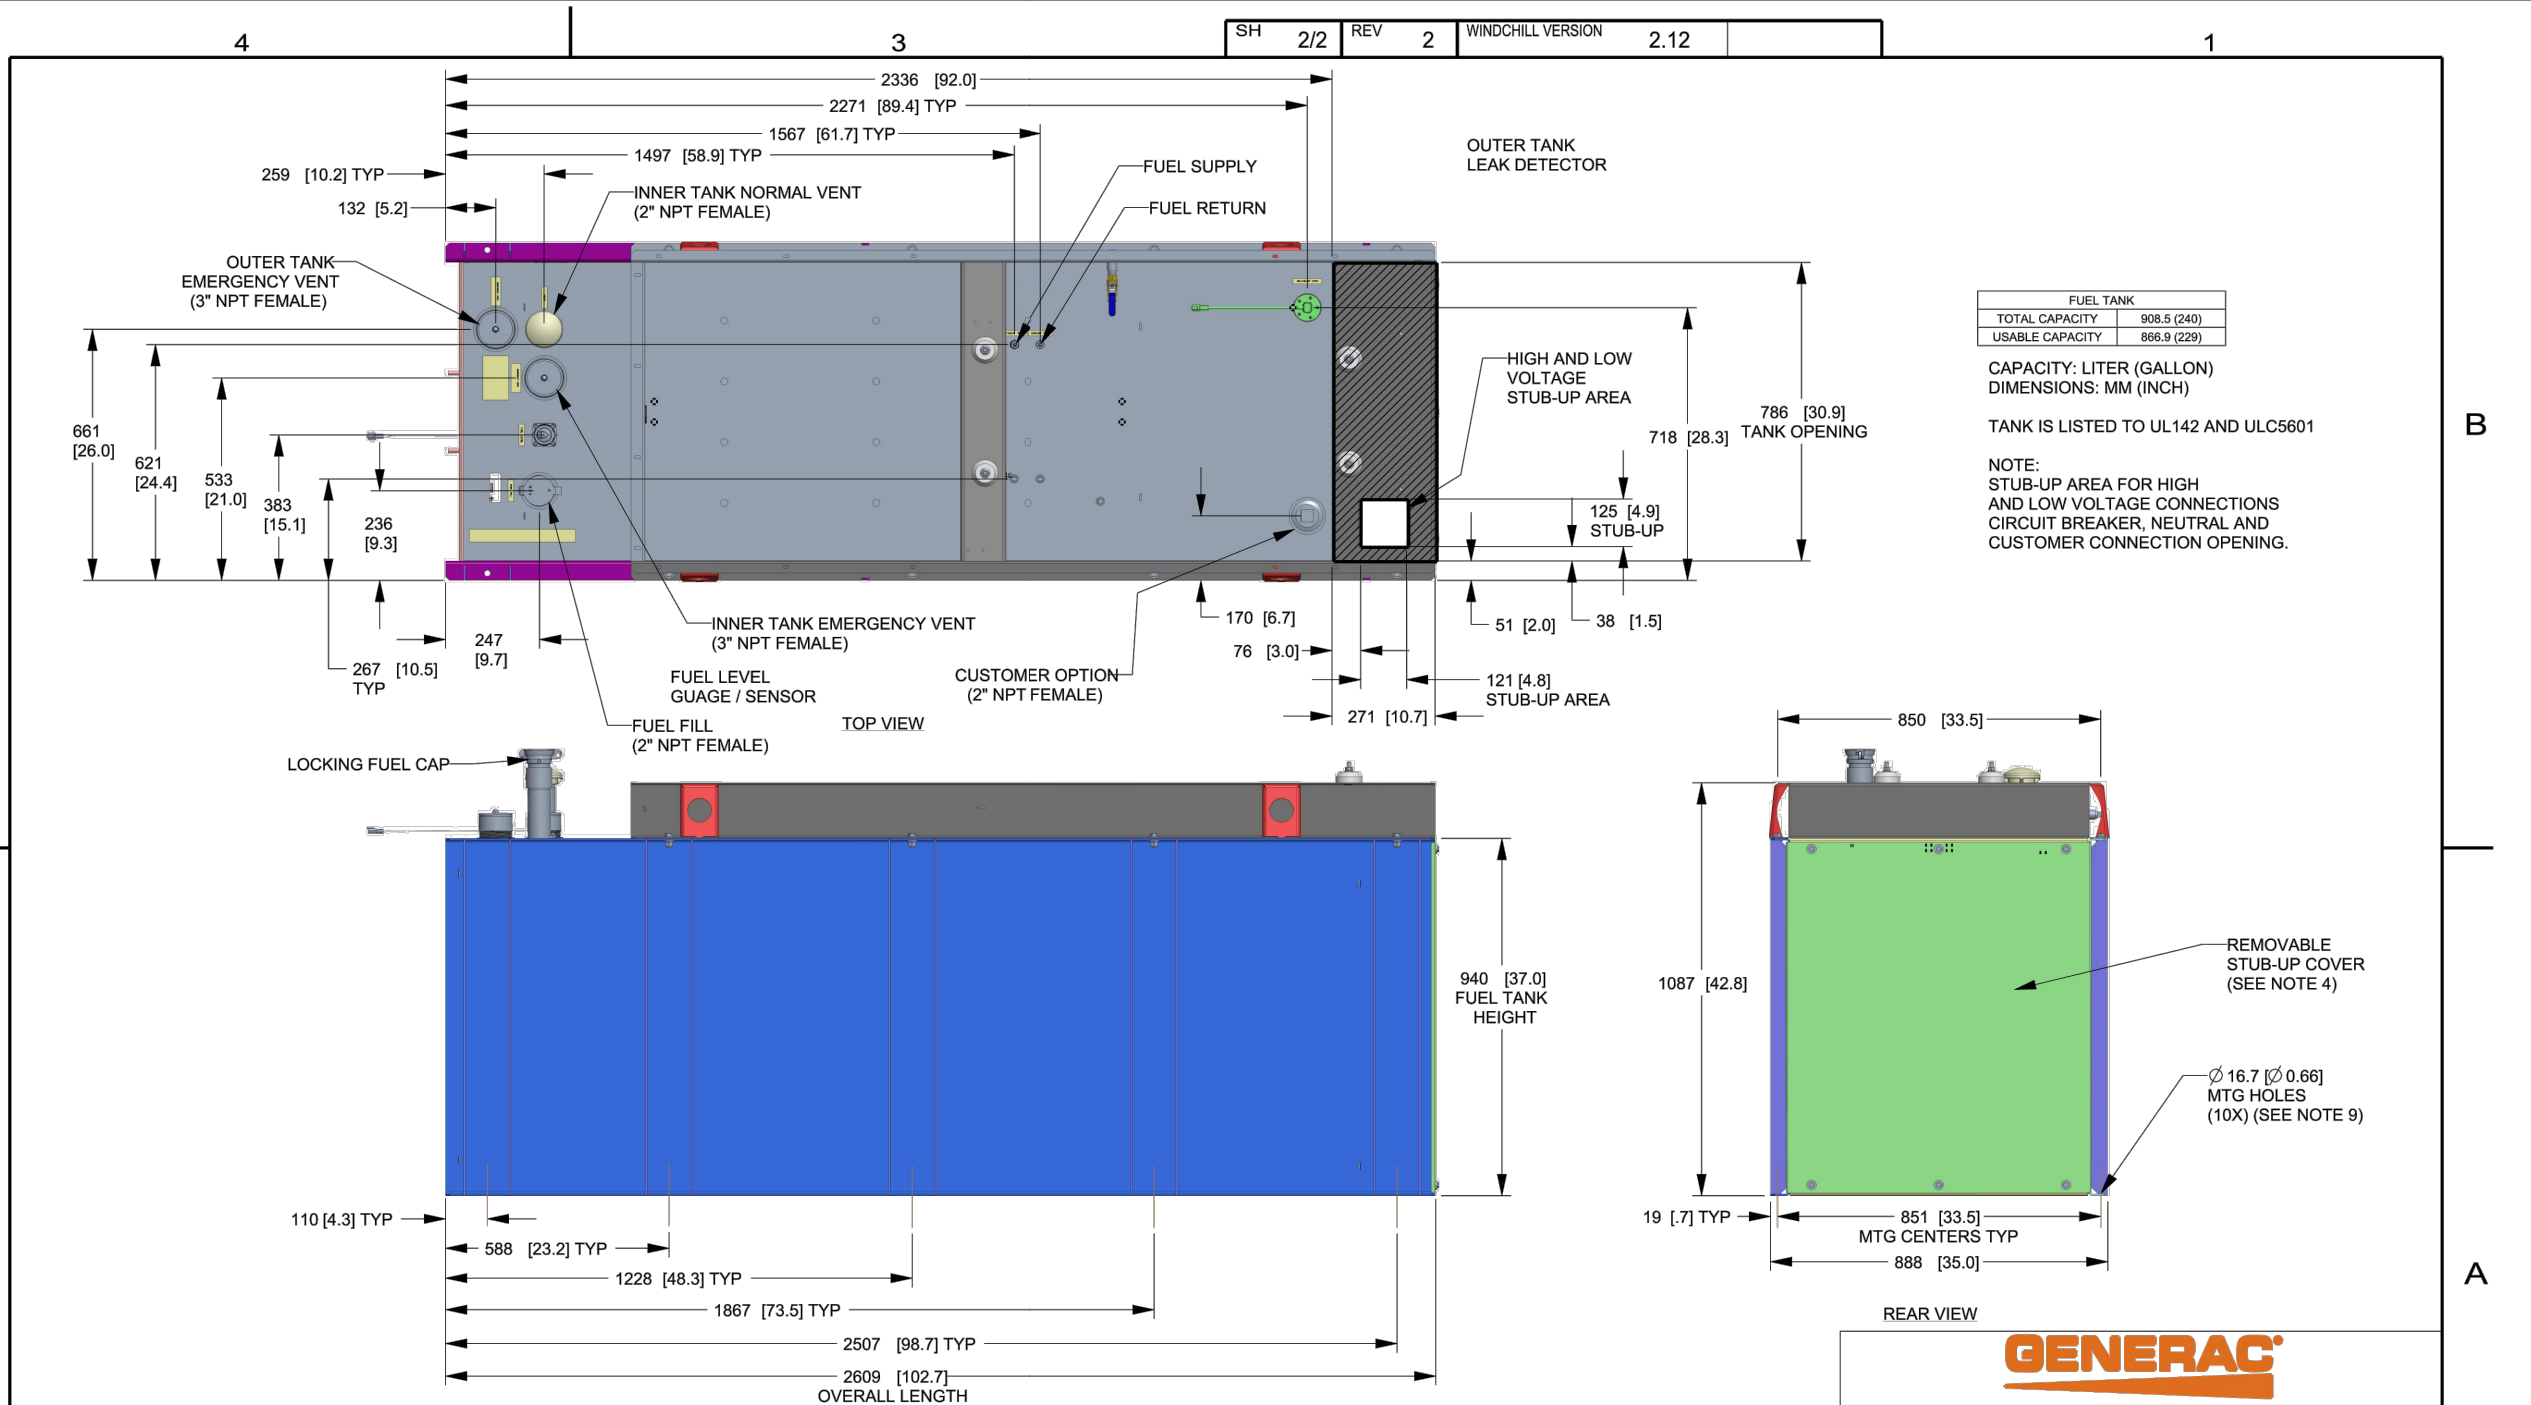
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SHEET TITLE:
A-3: GENERATOR SPECIFICATIONS

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SH	2/2	REV	2	WINDCHILL VERSION	2.12
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FUEL TANK	
TOTAL CAPACITY	908.5 (240)
USABLE CAPACITY	866.9 (229)

CAPACITY: LITER (GALLON)
DIMENSIONS: MM (INCH)

TANK IS LISTED TO UL142 AND ULC5601

NOTE:
STUB-UP AREA FOR HIGH AND LOW VOLTAGE CONNECTIONS CIRCUIT BREAKER, NEUTRAL AND CUSTOMER CONNECTION OPENING.

DRAWING CREATED FROM PRO/ENGINEER 3D FILE. ECO MODIFICATION TO BE APPLIED TO SOLID MODEL ONLY.

INSTALLATION DRAWING

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ELECTRONICALLY APPROVED INSIDE WINDCHILL

GENERAC

TITLE
INSTALLATION D2.2L
25KW Y06 PD


ISSUE DATE: 5/10/18

SIZE	CAGE NO	DWG NO	REV
B	N/A	10000036728	2
SCALE	0.063	WT-KG	SEE ABOVE
		SHEET	2 of 2

APPLICANT:
T-Mobile
T-MOBILE NORTHEAST LLC
35 GRIFFIN ROAD SOUTH
BLOOMFIELD, CT 06002
860-692-7100

PROJECT MANAGER
NORTHEAST SITE SOLUTIONS
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203-275-6669

CONSULTANT:
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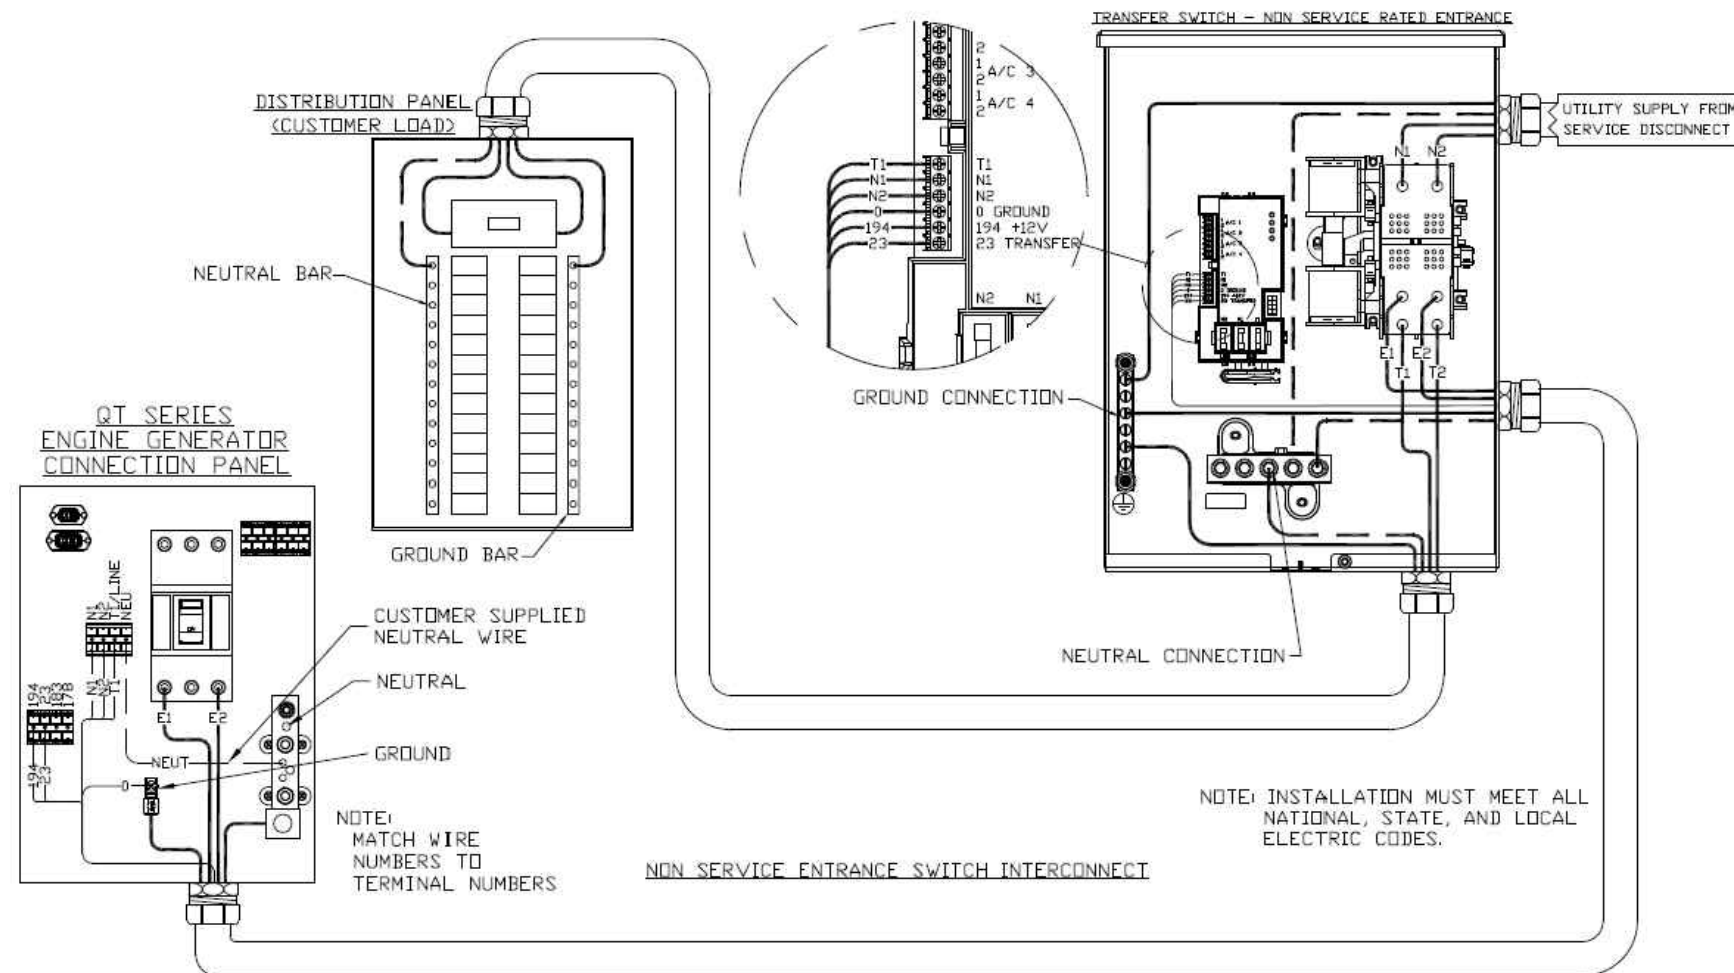
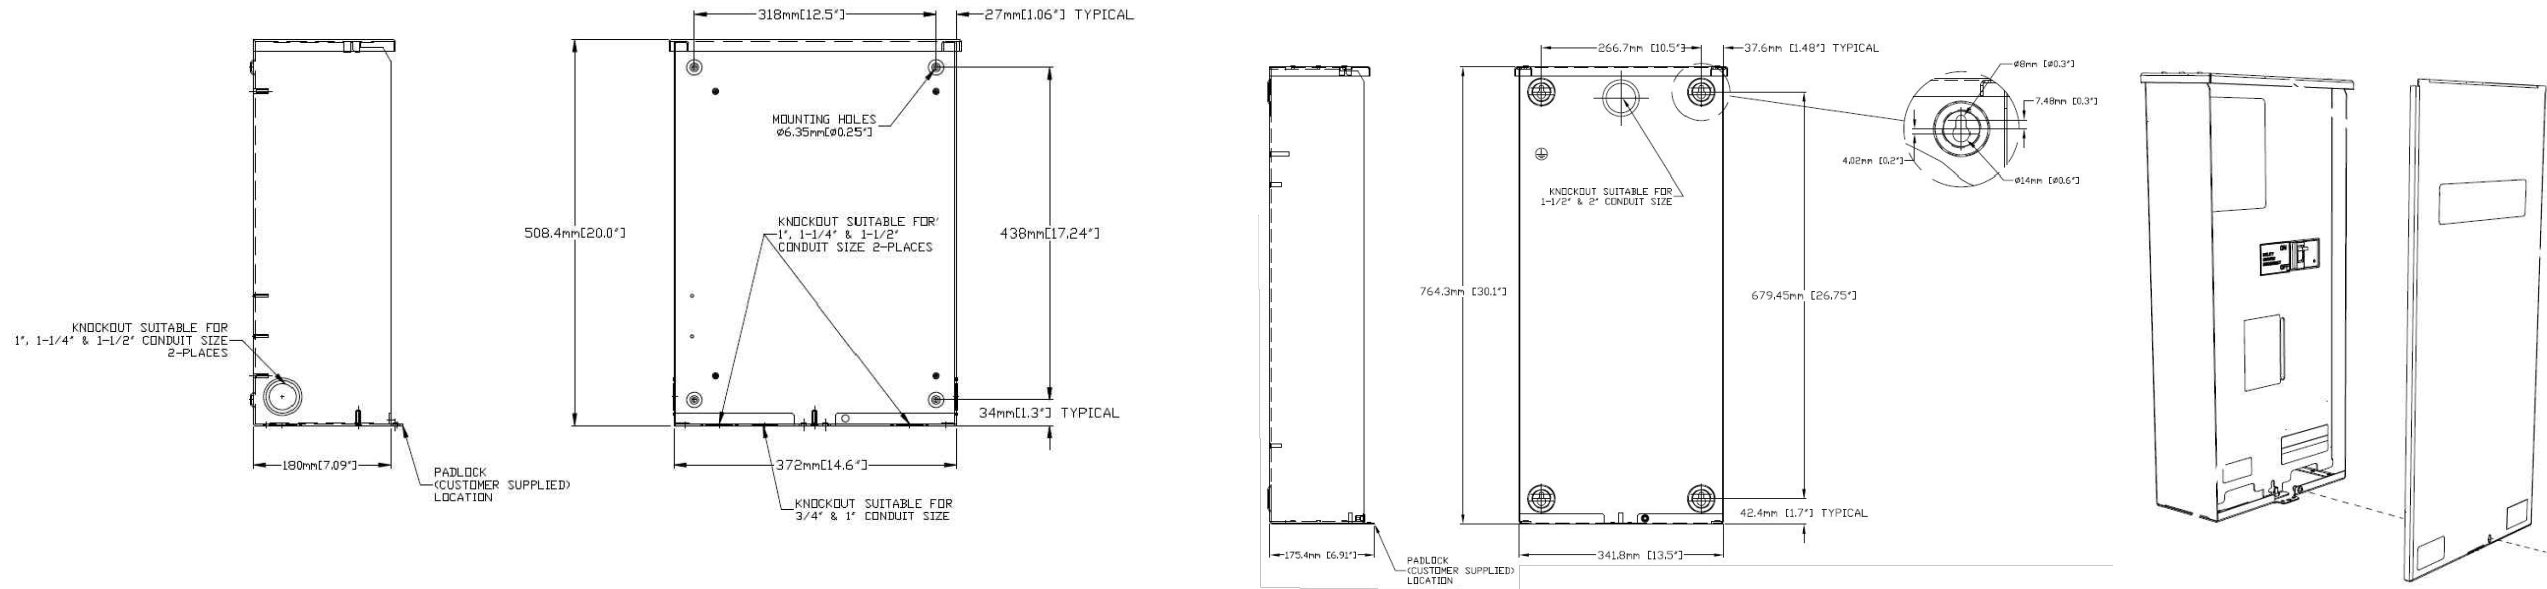
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SITE NAME: CT494 / CCASTLE-WOLCOTT-SST
SITE ADDRESS:
347 EAST STREET
WOLCOTT, CT 06716

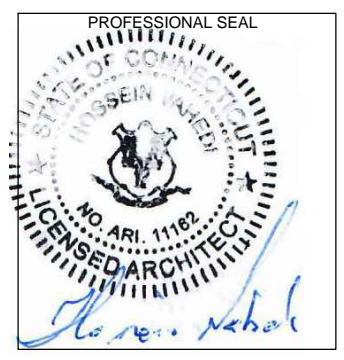SHEET TITLE:
A-4: GENERATOR SPECIFICATIONS

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AUTOMATIC TRANSFER SWITCH DETAILS
SCALE: N.T.S.

1
A-5

APPLICANT:
T-Mobile
T-MOBILE NORTHEAST LLC

35 GRIFFIN ROAD SOUTH
BLOOMFIELD, CT 06002
860-692-7100

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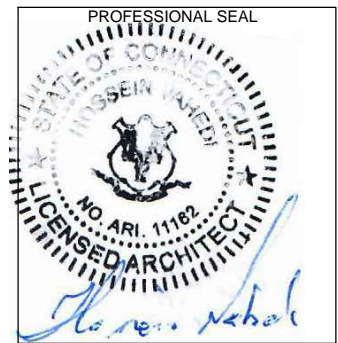
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STURBRIDGE, MA 01566
203-275-6669

CONSULTANT:

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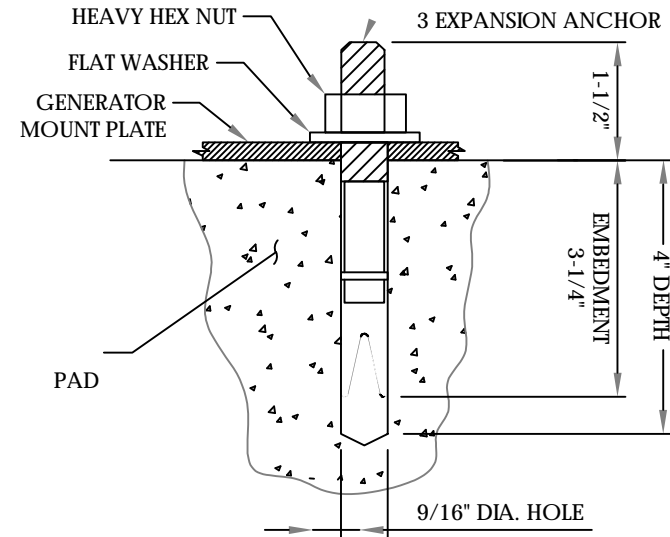
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SITE NUMBER: CT11494B
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SITE ADDRESS:
347 EAST STREET
WOLCOTT, CT 06716

SHEET TITLE:
A-5: AUTOMATIC TRANSFER SWITCH
DETAILS AND SPECIFICATIONS

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CONSTRUCTION NOTES:

- (HAND-DUG EXCAVATION REQUIRED):
- EXISTING UNDERGROUND UTILITY LOCATIONS ARE UNKNOWN. GENERAL CONTRACTOR SHALL HAND-EXCAVATE TO REQUIRED SUB-GRADE DEPTH, SUFFICIENT TEST HOLES.
- ALL EXCAVATIONS SHALL BE HAND-EXCAVATE AS REQUIRED.
- GENERAL CONTRACTOR IS RESPONSIBLE FOR ANY REQUIRED SPECIAL TEMPORARY PROTECTION OF, PHYSICAL DAMAGE TO, OR REPAIR OF EXISTING UNDERGROUND CONDUIT INCLUDING RESTORATION OF SERVICE.




NOTES:

1. BOLTS CAN BE INSTALLED 2 DAYS AFTER POURING CONCRETE PROVIDED THE KWIK BOLTS ARE ONLY TIGHTENED TO A SNUG TIGHT CONDITION.
2. APPLY "HILTI" HIT-RE 500-SD EPOXY TO ALL GAPS TO PREVENT WATER/MOISTURE BUILD-UP.
3. PROVIDE 6 (SEE MANUFACTURERS INSTALLATION DRAWINGS) ANCHOR BOLTS PER SIDE.

ANCHORAGE DETAILS
SCALE: N.T.S.

1
A-6

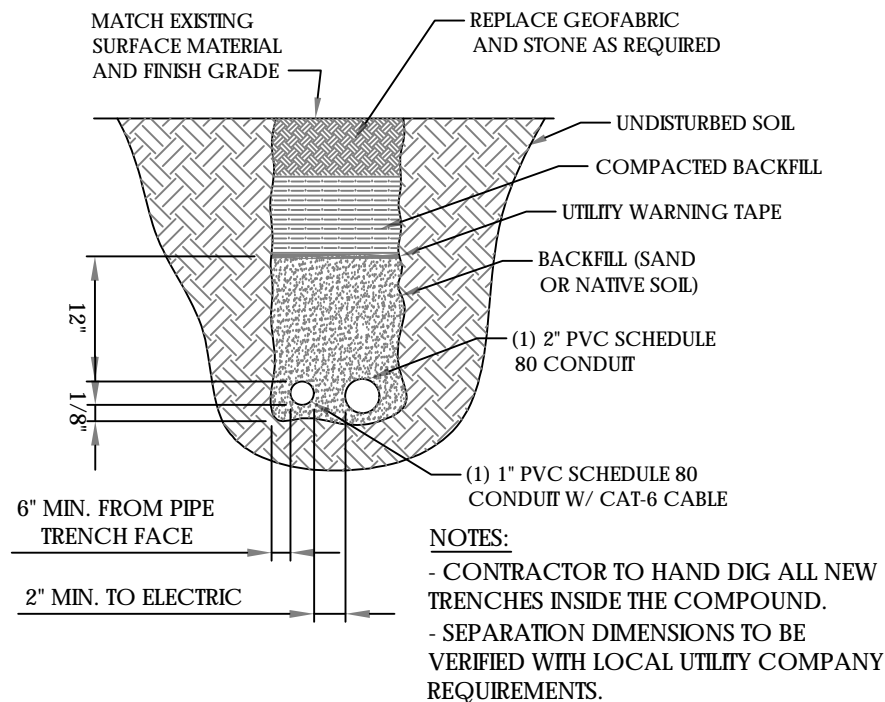


NOTES:

- CONTRACTOR TO HAND DIG ALL NEW TRENCHES INSIDE THE COMPOUND.
- SEPARATION DIMENSIONS TO BE VERIFIED WITH LOCAL UTILITY COMPANY REQUIREMENTS.

TRENCH DETAIL
SCALE: N.T.S.

2
A-6

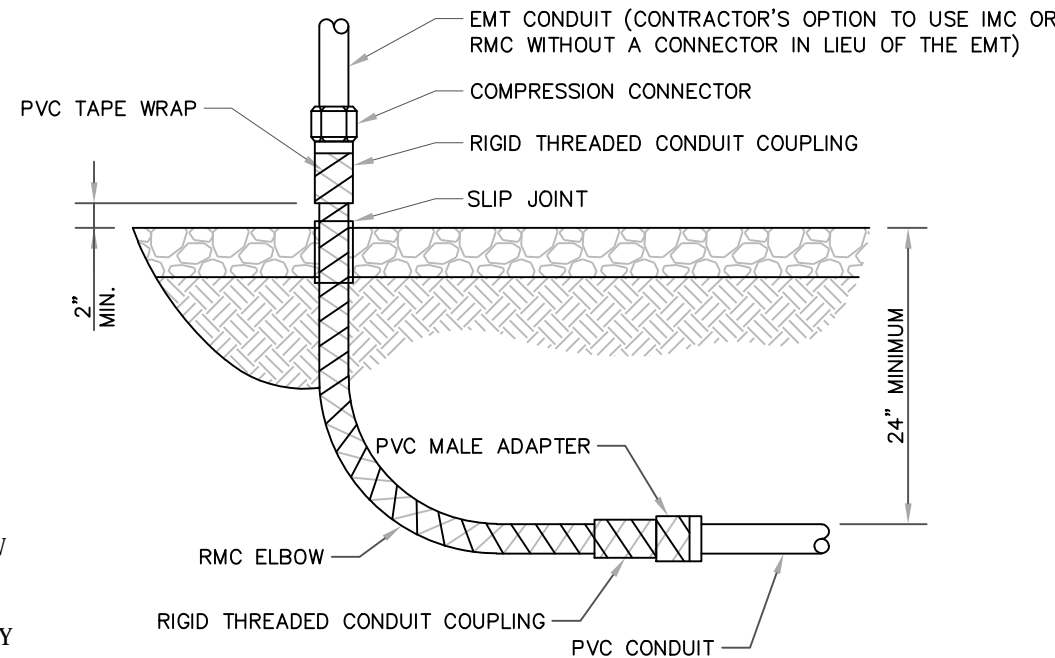

UNDERGROUND CONDUIT STUB UP
SCALE: N.T.S.

ALL METAL CONDUIT INSTALLED IN DIRECT CONTACT WITH THE EARTH SHALL BE CONSIDERED TO BE INSTALLED IN A SEVERELY CORROSIVE ENVIRONMENT AND IS REQUIRED TO HAVE SUPPLEMENTAL PROTECTION AGAINST CORROSION (NEC ARTICLE 342.10(B) & 344.10(B)(1)). THIS PROTECTION SHALL EITHER BE AN APPROVED MANUFACTURER INSTALLED PROTECTIVE COATING ON THE CONDUIT OR SHALL BE (2) LAYERS OF 10 MIL PVC PIPE WRAP TAPE INSTALLED USING OPPOSING SPIRAL WRAPS. ON VERTICAL PIPE THE OUTSIDE LAYER OF TAPE SHALL BE WRAPPED SO AS TO PROVIDE SHEDDING OF WATER (i.e. TAPE SHOULD WRAP IN AN UPWARD DIRECTION WITH LOWER WRAP BEING BENEATH THE WRAP ABOVE). SPIRAL WRAPS SHALL HAVE A MINIMUM OF 1/4" OVERLAP WITH THE PRECEDING TAPE WRAP. ANY OTHER METHODS OF CORROSION PROTECTION SHALL REQUIRE APPROVAL BY THE ENGINEER OF RECORD PRIOR TO BEING USED.

3
A-6

APPLICANT:
T-Mobile
T-MOBILE NORTHEAST LLC

35 GRIFFIN ROAD SOUTH
BLOOMFIELD, CT 06002
860-692-7100

PROJECT MANAGER




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203-275-6669

CONSULTANT:

FORESITE LLC

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347 EAST STREET
WOLCOTT, CT 06716

SHEET TITLE:
A-6: UNDERGROUND CONDUIT DETAILS
A-2: SITE PLAN
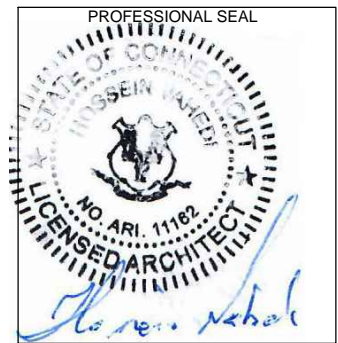
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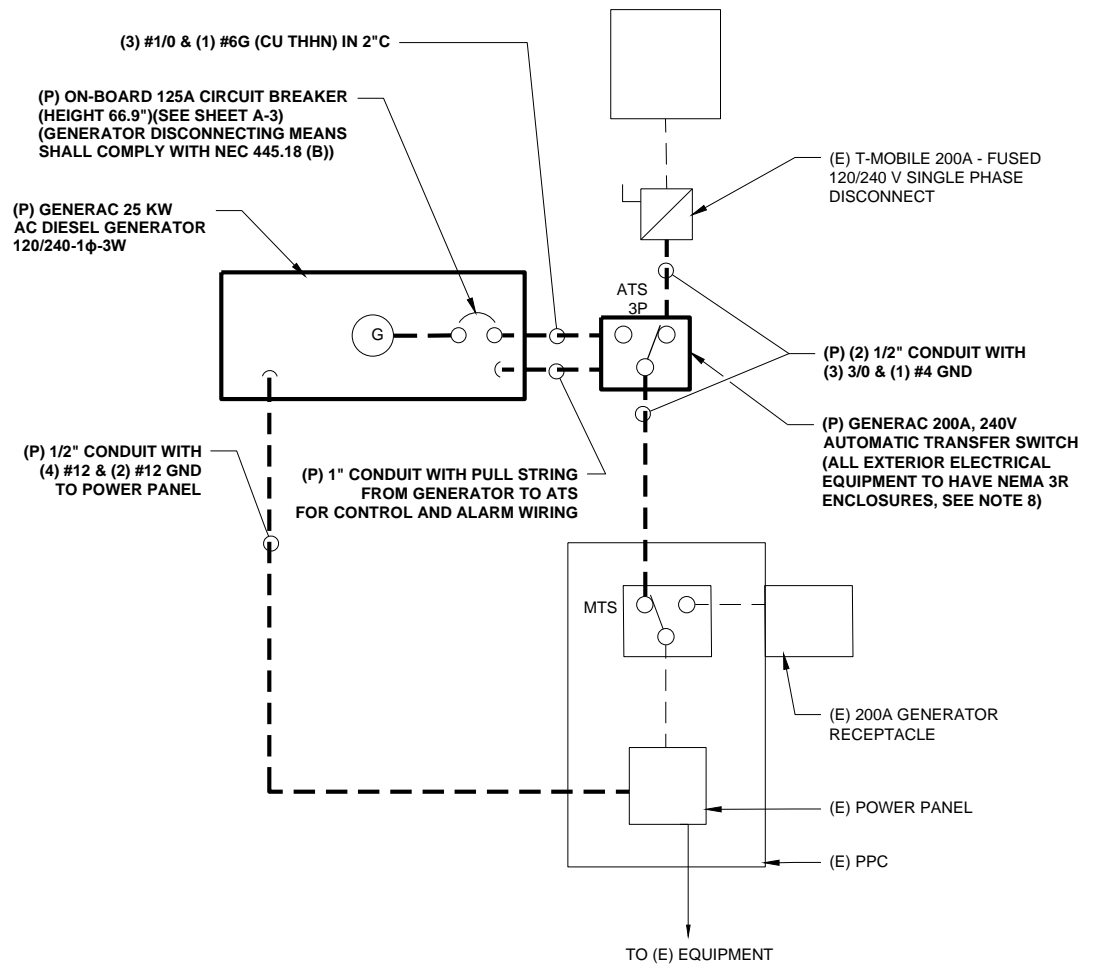
GENERAL ELECTRICAL NOTES

- ALL ELECTRICAL WORK SHALL CONFORM TO THE REQUIREMENTS OF THE NATIONAL ELECTRICAL CODE (NEC) AS WELL AS APPLICABLE STATE AND LOCAL CODES INCLUDING LATEST EDITIONS OF:
 NFPA - NATIONAL FIRE PROTECTION ASSOCIATION
 UL - UNDERWRITERS LABORATORIES
 NEC - 2017 NATIONAL ELECTRICAL CODE NEMA - NATIONAL ELECTRIC MANUFACTURERS ASSOCIATION
 OSHA - OCCUPATIONAL SAFETY AND HEALTH ACT
 IBC - 2015 INTERNATIONAL BUILDING CODE
- ALL ELECTRICAL ITEMS SHALL BE U.L. APPROVED OR LISTED AND PRODUCED PER SPECIFICATION REQUIREMENTS.
- THE ELECTRICAL WORK INCLUDES ALL LABOR AND MATERIAL DESCRIBED BY DRAWINGS AND SPECIFICATION INCLUDING INCIDENTAL WORK TO PROVIDE COMPLETE OPERATING AND APPROVED ELECTRICAL SYSTEM.
- GENERAL CONTRACTOR SHALL PAY FEES FOR PERMITS, AND RESPONSIBLE FOR OBTAINING SAID PERMITS AND COORDINATION OF INSPECTIONS.
- ELECTRICAL AND TELCO WIRING OUTSIDE A BUILDING AND EXPOSED TO WEATHER SHALL BE IN WATER TIGHT GALVANIZED RIGID STEEL CONDUITS OR SCHEDULE 80 PVC (AS PERMITTED BY CODE) AND WHERE REQUIRED IN LIQUID TIGHT FLEXIBLE METAL OR NONMETALLIC CONDUITS.
- RIGID STEEL CONDUITS SHALL BE GROUNDED AT BOTH ENDS.
- ELECTRICAL WIRING SHALL BE COPPER WITH TYPE XHHW, THWN, OR THIN INSULATION.
- ALL EQUIPMENT LOCATED OUTSIDE SHALL HAVE NAME 3R ENCLOSURE.
- GROUNDED SHALL COMPLY WITH NEC ART. 250.
- GROUNDED COAX CABLE SHIELDS MINIMUM AT BOTH ENDS USING MANUFACTURES COAX CABLE GROUNDED KITS SUPPLIED BY PROJECT OWNER.
- USE #6 COPPER STRANDED WIRE WITH GREEN COLOR INSTALLATION FOR ABOVE GRADE GROUNDED (UNLESS OTHERWISE SPECIFIED) AND #2 SOLID TINNED BARE COPPER WIRE FOR BELOW GRADE GROUNDED AS INDICATED ON THE GROUND.
- ALL GROUND CONNECTION TO BE BURNDY HYGROUND COMPRESSION TYPE CONNECTORS OR CADWELD EXOTHERMIC WELD. DO NOT ALLOW BARE COPPER WIRE TO BE IN CONTACT WITH GALVANIZED STEEL.
- ROUTE GROUNDED CONDUCTORS ALONG THE SHORTEST AND STRAIGHTEST PATH POSSIBLE, EXCEPT AS OTHERWISE INDICATED. GROUNDED LEADS SHOULD NEVER BE BENT AS RIGHT ANGLE. ALWAYS MAKE AT LEAST 12" RADIUS BENDS. #6 WIRE CAN BE BENT AT 6" RADIUS WHEN NECESSARY BOND ANY METER OBJECTS WITHIN 7 FEET OF PROPOSED EQUIPMENT OR CABINET TO MASTER GROUND BAR.
- CONNECTIONS TO MGB SHALL BE ARRANGED IN THREE MAIN GROUPS: SURGE PROCEDURES (COAXIAL CABLE GROUND KITS, TELCO AND POWER PANEL GROUND); (GROUNDING ELECTRODE RING OR BUILDING STEEL); NON-SURGING OBJECTS (EGB GROUND IN RBS UNIT).
- CONNECTIONS TO GROUND BARS SHALL BE MADE WITH TWO HOLE COMPRESSION TYPE COPPER LUGS. APPLY OXIDE INHIBITING COMPOUND TO ALL LOCATIONS.
- APPLY OXIDE INHIBITING COMPOUND TO ALL COMPRESSION TYPE GROUND CONNECTION.
- TEST COMPLETED GROUND SYSTEM AND RECORD RESULTS FOR PROJECT CLOSE-OUT DOCUMENTATION.
- BOND ANY METAL OBJECTS WITHIN 7 FEET OF PROPOSED EQUIPMENT OR CABINET TO MASTER GROUND BAR.
- VERIFY PROPOSED SERVICE UPGRADE WITH LOCAL UTILITY COMPANY PRIOR TO CONSTRUCTION.
- EXISTING UNDERGROUND UTILITY LOCATIONS ARE UNKNOWN. GENERAL CONTRACTOR SHALL HAND-EXCAVATE TO REQUIRED SUB-GRADE DEPTH, SUFFICIENT TEST HOLES OR AS DIRECTED / REQUIRED BY CONSTRUCTION MANAGER. ALL PROPOSED UNDERGROUND UTILITY TRENCHES SHALL BE HAND-EXCAVATE AS REQUIRED. GENERAL CONTRACTOR IS RESPONSIBLE FOR ANY REQUIRED SPECIAL TEMPORARY PROTECTION OF, PHYSICAL DAMAGE TO, OR REPAIR OF EXISTING UNDERGROUND CONDUIT INCLUDING RESTORATION OF SERVICE.
- PROVIDE SLIP JOINS WHERE CONDUITS TRANSITION FROM UNDERGROUND TO ABOVE GROUND.


NOTES:
 DIAGRAM AS SHOWN, IS A GENERIC ROUTING SCHEMATIC BASED ON AVAILABLE INFORMATION AND MAY NOT REPRESENT ACTUAL FIELD CONDITIONS. CONTRACTOR SHOULD INSTALL THE GENERATOR, EQUIPMENT AND CONNECTIONS BASED ON VERIFIED ELECTRICAL AUDITS AND PER MANUFACTURER'S INSTALLATION GUIDELINES AS WELL AS ALL APPLICABLE LOCAL AND NATIONAL CODES AND REQUIREMENTS.

GROUNDED NOTES:

- GROUNDED SHALL COMPLY WITH NEC ART. 250 AND MANUFACTURER'S RECOMMENDATIONS. TIE INTO THE EXISTING GROUNDED SYSTEM.
- CONTRACTOR SHALL INSTALL GROUND RODS ON ALL UNDERGROUND GROUNDED RUNS LONGER THAN 10'. GROUND RODS WILL BE INSTALLED ON 20' CENTERS MAXIMUM.
- ALL DOWN CONDUCTORS MUST GO DOWN PER NFPA 780.
- CONTRACTOR SHALL NOTIFY THE CONSTRUCTION MANAGER WHEN THE GROUNDED SYSTEM IS COMPLETE. THE CONSTRUCTION MANAGER SHALL INSPECT THE GROUNDED SYSTEM PRIOR TO BACKFILLING.
- CONTRACTOR MY USE EXISTING CONDUITS AND CONDUCTORS PROVIDED THEY ARE IN GOOD CONDITION AND ARE SUFFICIENTLY RATED.



TYP. ONE LINE DIAGRAM
 FIELD VERIFY 1
E-1

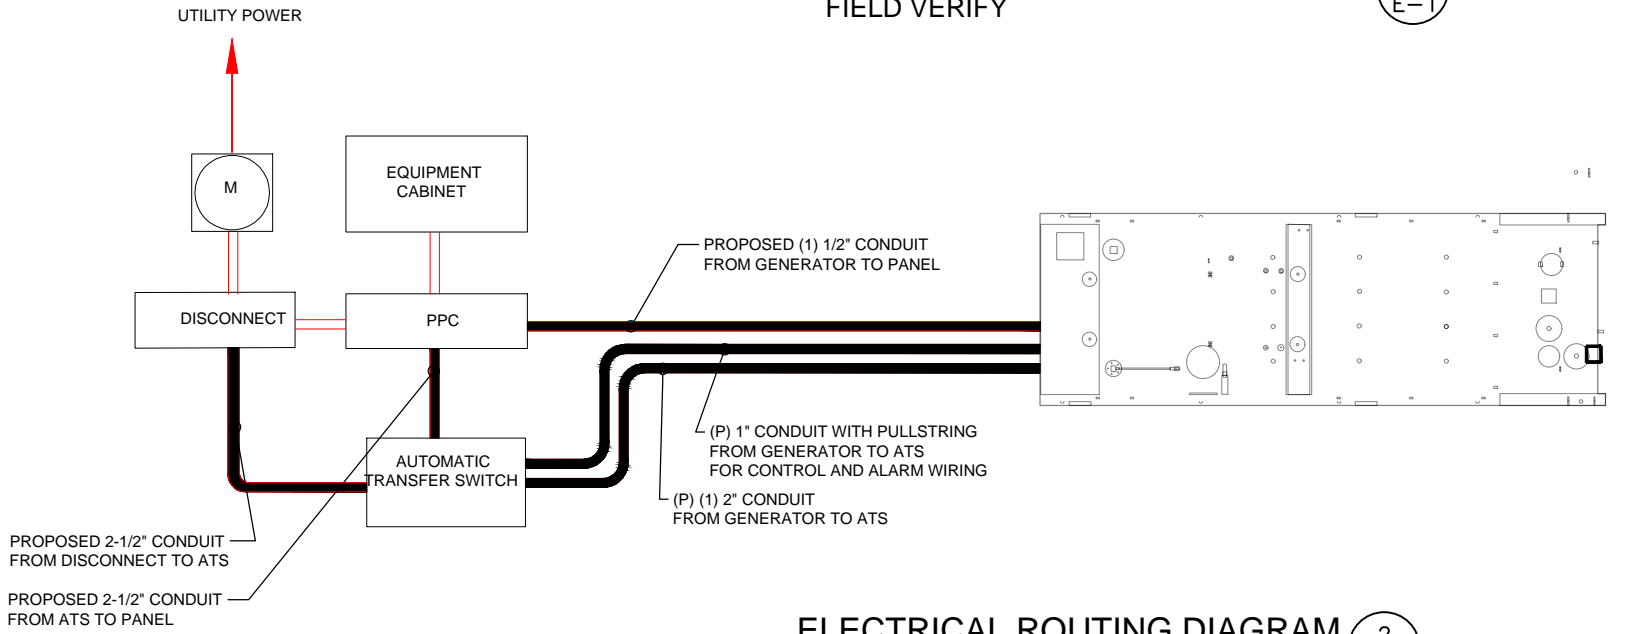

ELECTRICAL ROUTING DIAGRAM
 SCALE: N.T.S 2
E-1

APPLICANT:
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T-MOBILE NORTHEAST LLC
 35 GRIFFIN ROAD SOUTH
 BLOOMFIELD, CT 06002
 860-692-7100

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 203-275-6669

CONSULTANT:
FORESITE LLC
 Architects . Engineers . Surveyors
 462 WALNUT STREET
 NEWTON, MA 02460
 617-212-3123


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 SITE ADDRESS:
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 WOLCOTT, CT 06716

SHEET TITLE:
E-1: ELECTRICAL DETAILS


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GROUND PLAN 1
NTS G-1

NOTES:


1. CONNECTION SHALL BE COVERED BY NO LESS THAN 2" OF CONCRETE.
2. ATTEMPT TO MAKE CONNECTION TO A 6'-0" RUN OF REBAR OR GREATER.
3. APPLY HEAT SHRINK OR ELECTRICAL TAPE AROUND THE CONDUCTOR TO AVOID CORROSION.

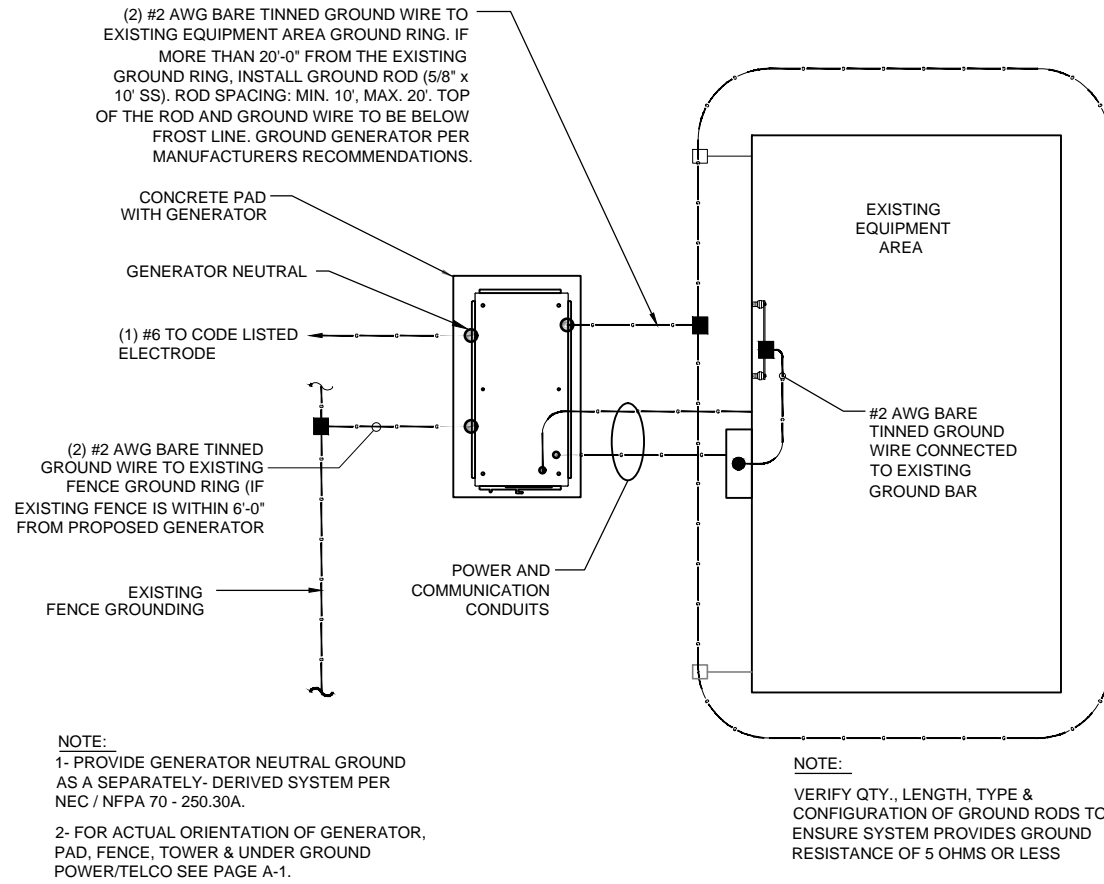

EQUIPMENT PAD GROUNDING 2
NTS G-1

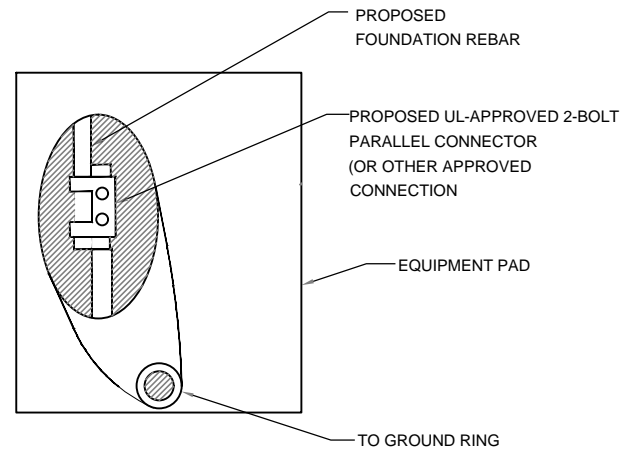NOTE:

CONTRACTOR TO USE CLEAR OR GRAY SILICONE AS NECESSARY TO SEAL LIQUID TIGHT FLEXIBLE NON-METALLIC CONDUIT.

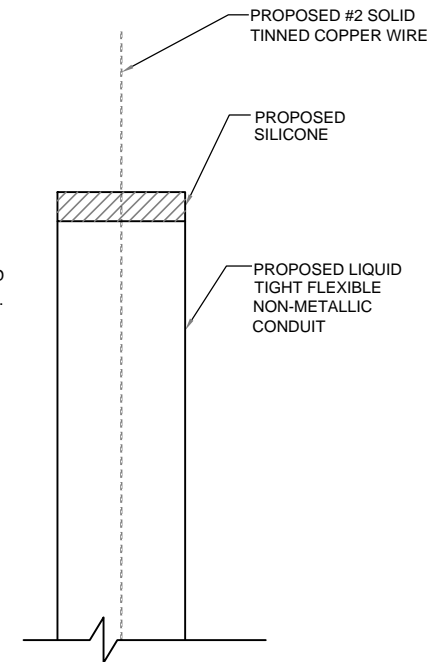


GROUND WIRE WEATHERPROOFING 3
NTS G-1

APPLICANT:
T-Mobile
T-MOBILE NORTHEAST LLC
35 GRIFFIN ROAD SOUTH
BLOOMFIELD, CT 06002
860-692-7100

PROJECT MANAGER

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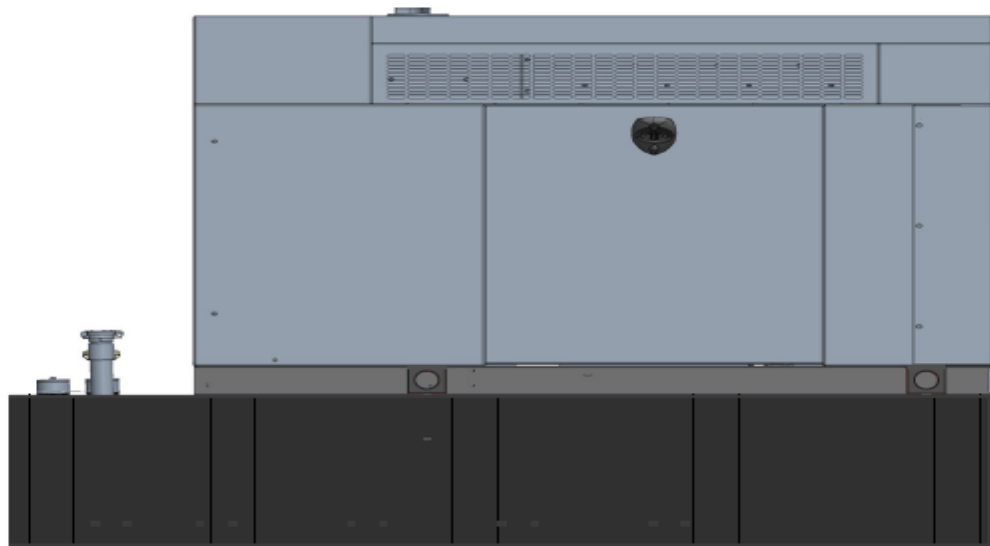
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WOLCOTT, CT 06716

SHEET TITLE:
G-1: GROUNDING DETAILS

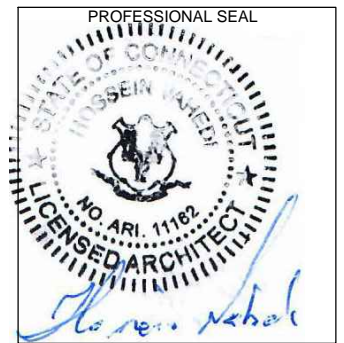Exhibit D

Generac RD025 Design Document

Diesel, AC, 25kW External Fill Tank Model#7192-0 SKU#33651



The following are responsible for this project document:

Kevin Smith

SR. Engineer (770) 256-3594

Project Design Spec Revision	1.0	Last Date:08/23/2018	5/14/2018
Final doc URL (~Dnnnnn):			
Location	Use the InfoRouter Search (Advanced) putting the Document ID (nnnnn without the D) to find the location of the master document.		
Template URL:	http://docs.eng.t-mobile.com/InfoRouter/docs/~D423750 Slightly updated 1/2011		

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1.2	Feature Description	3
1.3	Dimensions	3
2	Fuel Tanks.....	4
3	RXSC200A3 ATS/ Controller	4
3.1	Hardware	4
4	Architecture/Alarms.....	7
4.1	Interfaces and Alarming	7
5	Regulatory Requirements	9
6	Configuration/Diagrams	9
7	Maintenance.....	14

1 Introduction / Project Summary

1.1 Purpose of Project


T-Mobile’s nationwide cell site hardening plan is providing a refuellable backup power system capable of powering a site for a minimum of 48 hours before refueling is required. The purpose of this project is to give T-Mobile customers reliable service during power outages and provide a sufficient layer of coverage. This design document is for Generac’s RD025 model#7192-0, which is a Diesel AC generator with a capacity of 25kW.

1.2 Feature Description

The Generac RD025 is a 25kW AC, diesel generator is one of the generators selected as part of the T-Mobile RFP in support of the nationwide cell site hardening plan. The RD025 has a Level 2 acoustic enclosure, 3 phase sensing, and +/-0.25% digital voltage regulation. It is equipped with RS232, RS485 and canbus remote ports and Evolution control panel. It is also equipped with a automatic transfer switch, the RXSC200A3 (Automatic Transfer Switch) Controls the process of transferring commercial AC power and generator power. The RXSC200A3 is a 200Amp, switch that is programmed to perform engine test runs and also has adjustable engine run time capabilities. For RXSC200A3 Owners Manual and full feature descriptions [LINK](#).

1.3 Dimensions

The dimensions of a level 2 Acoustic Enclosure L x W x H in inches 103.4 x 35 x 91.7. T-Mobile requires a 36-inch radius around the generator that will cover the 18” door swing on the generator.

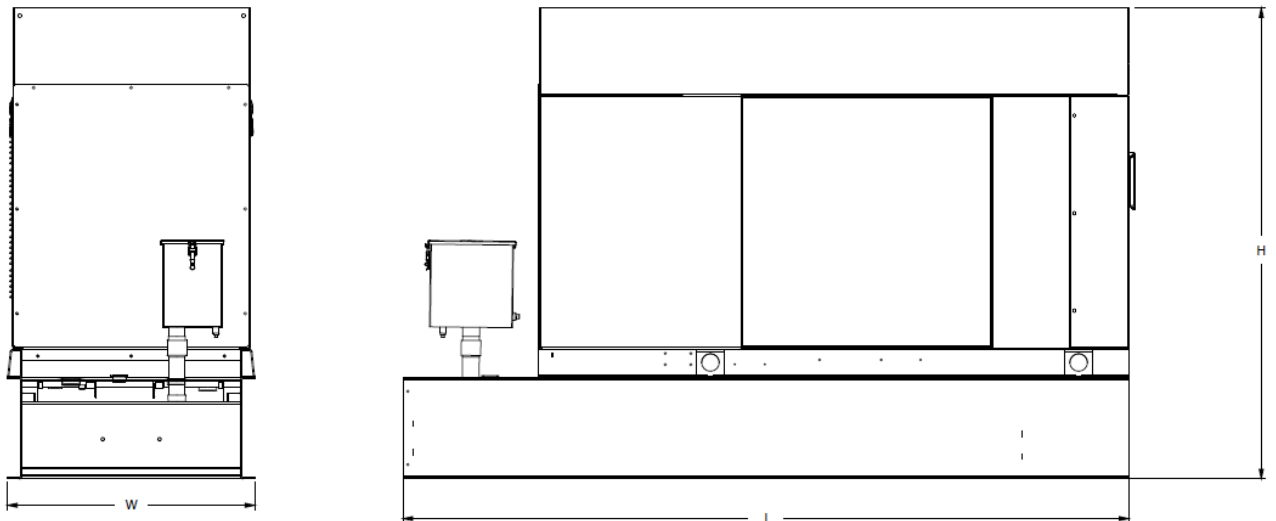


Weights and Dimensions

Unit Weight - lbs	Unit Weight with Skid - lbs	Dimensions (L x W x H) - in
2,123	2,161	103.4 x 35.0 x 73.8

2 Fuel Tanks

The RD025 has a 102.7" 240 Gallon Double-Wall UL142 Base tank to provide 98 hours of backup power at full load deployed on site. Below is the Install drawing for the 240-gallon tank for the RD025kW.

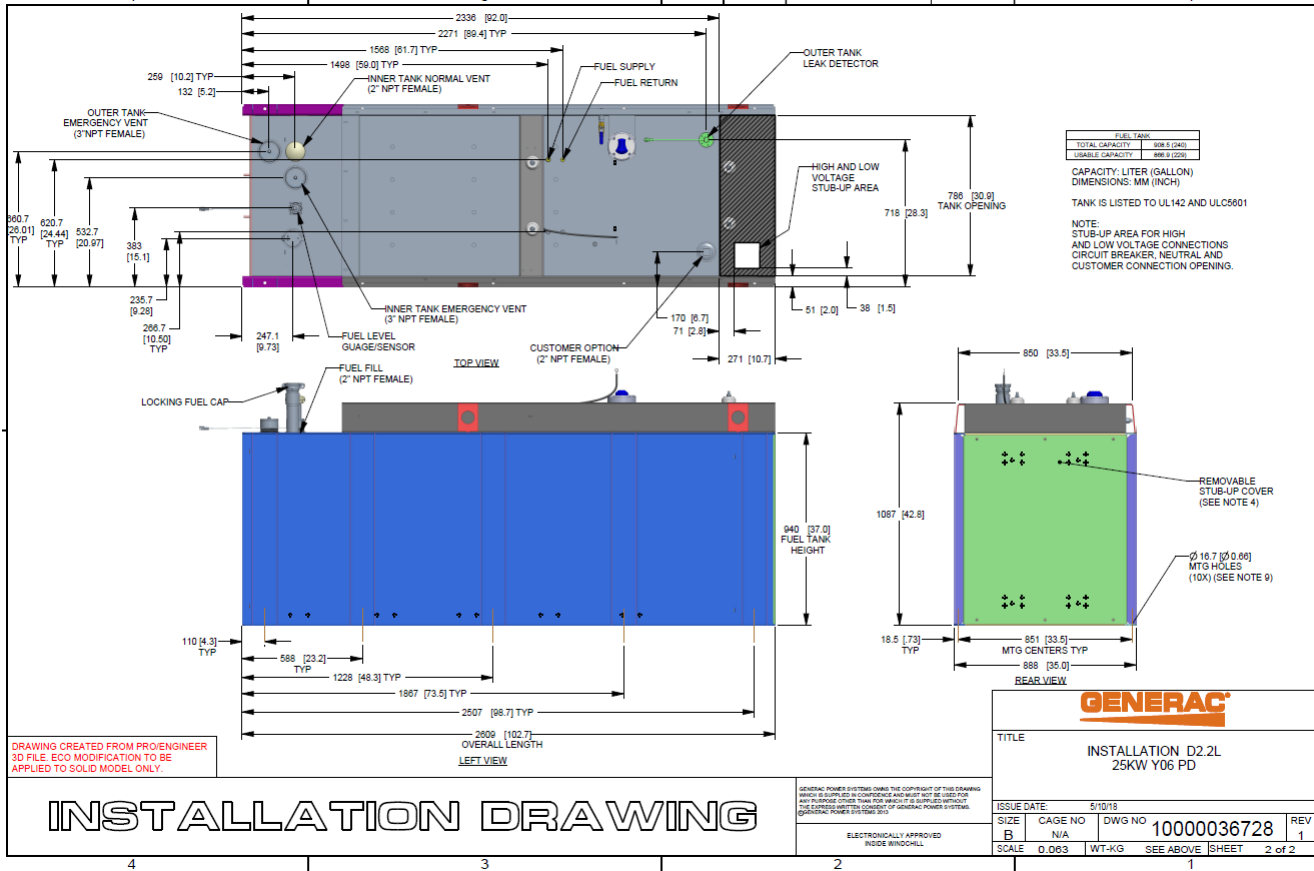

3 RXSC200A3 ATS/ Controller

3.1 Hardware


The RD025 will come with a RXSC200A3 and an Evollution controller. The sites considered for the RD025 should not have a DC power consumption above 20kW

RXSC200A3 [Link](#)

RXSC200A3 install drawing [Link](#)

Evolution controller spec sheet [Link](#)

RD025 installation drawings and supporting documentation [Link](#)

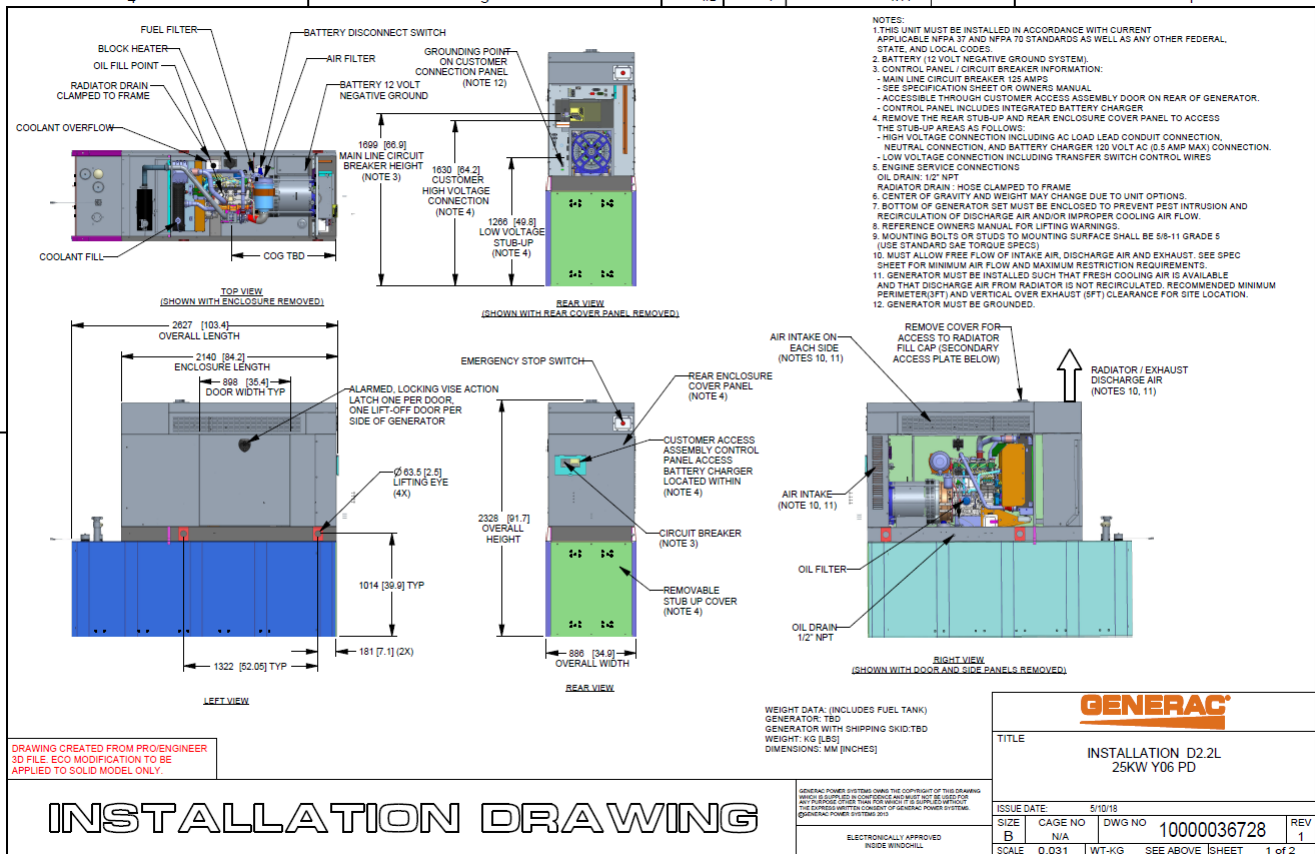


3.2 RXSC200A3 Automatic Transfer Switch

The RXSC200A3 (Automatic Transfer Switch) is equipped with the following functions. Utility voltage drop-out <65%. Timer to Generator start: 10 second factory set, adjustable between 2-1500 seconds. Engine Warm up delay: 5 seconds. Standby Voltage Sensor: 65% for 5 seconds. Utility Voltage Pickup >80%. Re-Transfer Time Delay: 15 seconds. Engine Cool-Down Timer: 60 seconds. Exerciser: 5 or 12 minute adjustable weekly/by-weekly/monthly. The transfer switch can also be operated manually without power applied

RXSC200A3 Dimensions

Model		RXSC200A3
Height (in./mm)	H1	17.24/437.9
	H2	20/508
Width (in./mm)	W1	12.5/317.5
	W2	14.6/370.8
Depth (in./mm)		7.09/180.1
Weight (lbs./kilos)		20/9.07

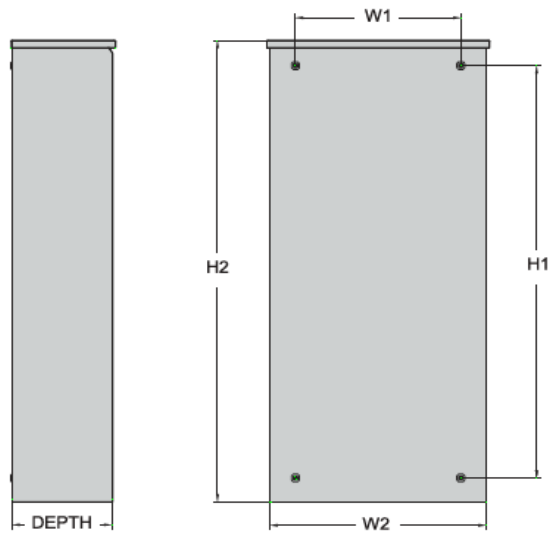

4 Architecture/Alarms

4.1 Interfaces and Alarming

The generator will be monitored by external alarms, conduit and cat five cables have to be installed from the Evolution Controllers Low Voltage Box located in the Generac generator to the appropriate cell site equipment. Nokia FSEB or FSEE and in Ericsson the SAU.

At a Nokia site, this connection is at the FSEB or an FSEE module. For the wiring diagram and instructions for the FSEB click the [Link](#). (The FSEE is the Nokia module that will be replacing the FSEB. For details on the FSEE contact: HQNokiaCellsiteDesigns@T-Mobile.com)

Ericsson sites will connect to the SAU module via OVP Expansion Kit for 8 External Alarms. Product number: UTOVP-ALM8EXP. For the wiring diagram and instructions for this click the [link](#).

The RXSC200A3 has auxiliary contacts that will facilitate the *ATS in Emergency position* alarm and will be a Normally Closed contact. Below is the wiring schematic for this contact and it can be found in the RXSC200A3 owners manual.

Auxiliary Contact

See [Figure 3-4](#). If desired, there is one normally-closed Auxiliary Contact (A) on the transfer switch to operate customer accessories, remote advisory lights, or remote annunciator devices. A suitable power source must be connected to the common terminal. If needed, an extra auxiliary contact can be added.

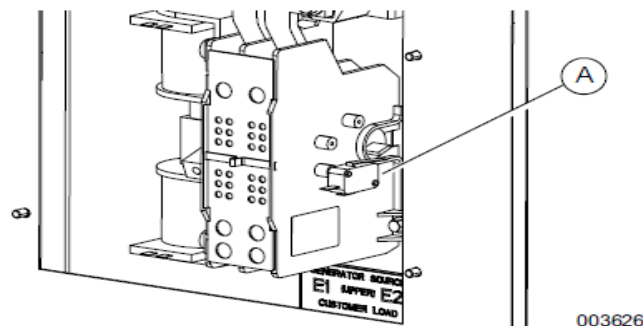


Figure 3-4. Auxiliary Contact

The auxiliary contact is normally closed when the transfer switch is in utility mode. The contacts will open when the transfer switch is in the standby power mode.

NOTE: Auxiliary Contact is rated 10 amps at 125 or 250 volts AC, and 0.6 amps at 125 volts DC.


CAUTION

Equipment damage. Exceeding rated voltage and current will damage the auxiliary contacts. Verify that voltage and current are within specification before energizing this equipment.

(000134a)

T-Mobile has four relays available from the Generac controller that are user-defined. T-Mobile can have four-alarm categories and a limitless number of subcategories. T-Mobile will utilize Normally Closed (NC) dry contacts for alarms in Low Voltage Connection box in the spare outputs section. Ericsson cabinets need to be equipped with the alarm expansion kit (UTOVP-ALM8EXP) to handle external alarms.

Customer Connections Inside the RD025

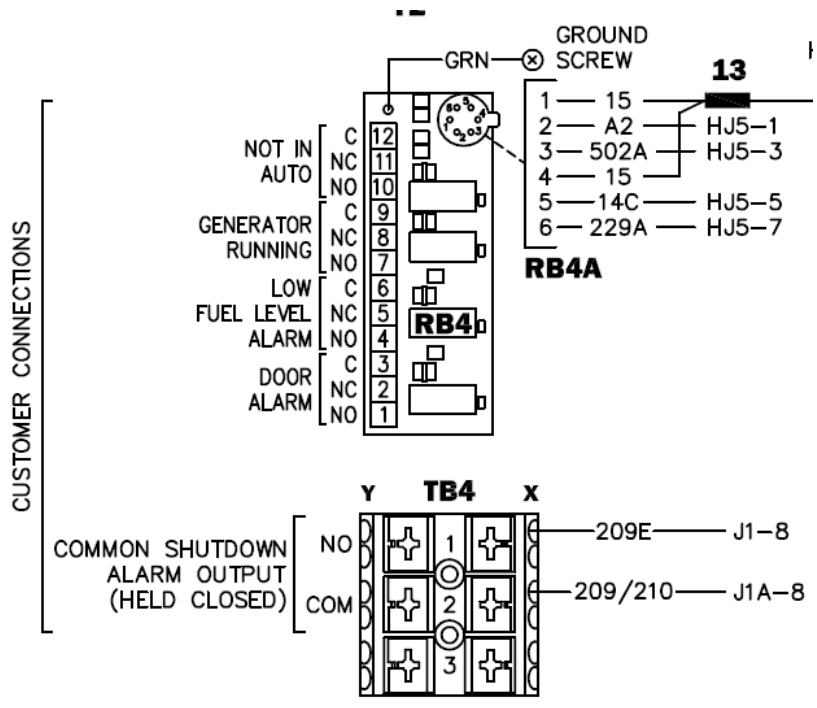

Ericsson UTOVP- ALM8EXP



UTOVP-ALM8EXP	OVP Expansion Kit for 8 External Alarms	Qty
Product no	Denomination	
UTOVP-ALM8EXP	OVP Expansion Kit for 8 External Alarms	1
NFD30234/08	OVERVOLTAGE ARRESTER/OVP-ALM 8	1
RPM777143/01200	CABLE WITH CONNECTOR/SIGNAL CABLE	2

Evolution Controller Customer Connections	Nokia FSEB Alarm Connections 13-24	T-Mobile Standard Alarms
NC#8-Gen Running	NC 4110 grd 4111 pin 13	Generator Running
NC#11-Not In Auto	NC 4110 grd 4111 pin 14	Generator Alarm Critical
NC#2-Door Alarm	NC 4110 grd 4111 pin 15	Generator Alarm NSI
NC#5-Low Fuel	NC 4110 grd 4111 pin 16	Low Fuel
RXSC200A3-Auxiliary Contacts	NC 4110 grd 4111 pin 17	ATS in Emergency Position

Evolution Controller Customer Connections	Ericsson Alarm 8expConnections	T-Mobile Standard Alarms
NC#8- Gen. Running	NC - A5	Generator Running
NC#11-Not In Auto	NC - A6	Generator Alarm Critical
NC#2-Door Alarm	NC - A7	Generator Alarm NSI
NC#5-Low Fuel	NC - A8	Low Fuel
RXSC200A3-Auxiliary Contacts	NC - A9	ATS in Emergency Position


5 Regulatory Requirements


Level 2 Acoustic Enclosure provides a noise level of 67.5dBA. It is EPA certified and meets NFPA 99 and 110 requirements(NFPA National Fire Protection Association). The RD025 generator engines is a tier 4 engine and meets the EPA final standards.

6 Configuration/Diagrams


The physical configuration of the Generator and the RXSC200A3 is, ATS before the PPC to ensure overcurrent protection when commercial power is restored. The RD025 and the RXSC200A3 has to be wired to Commercial AC power.

Commercial Power Connection Points
On The RXSC200A3

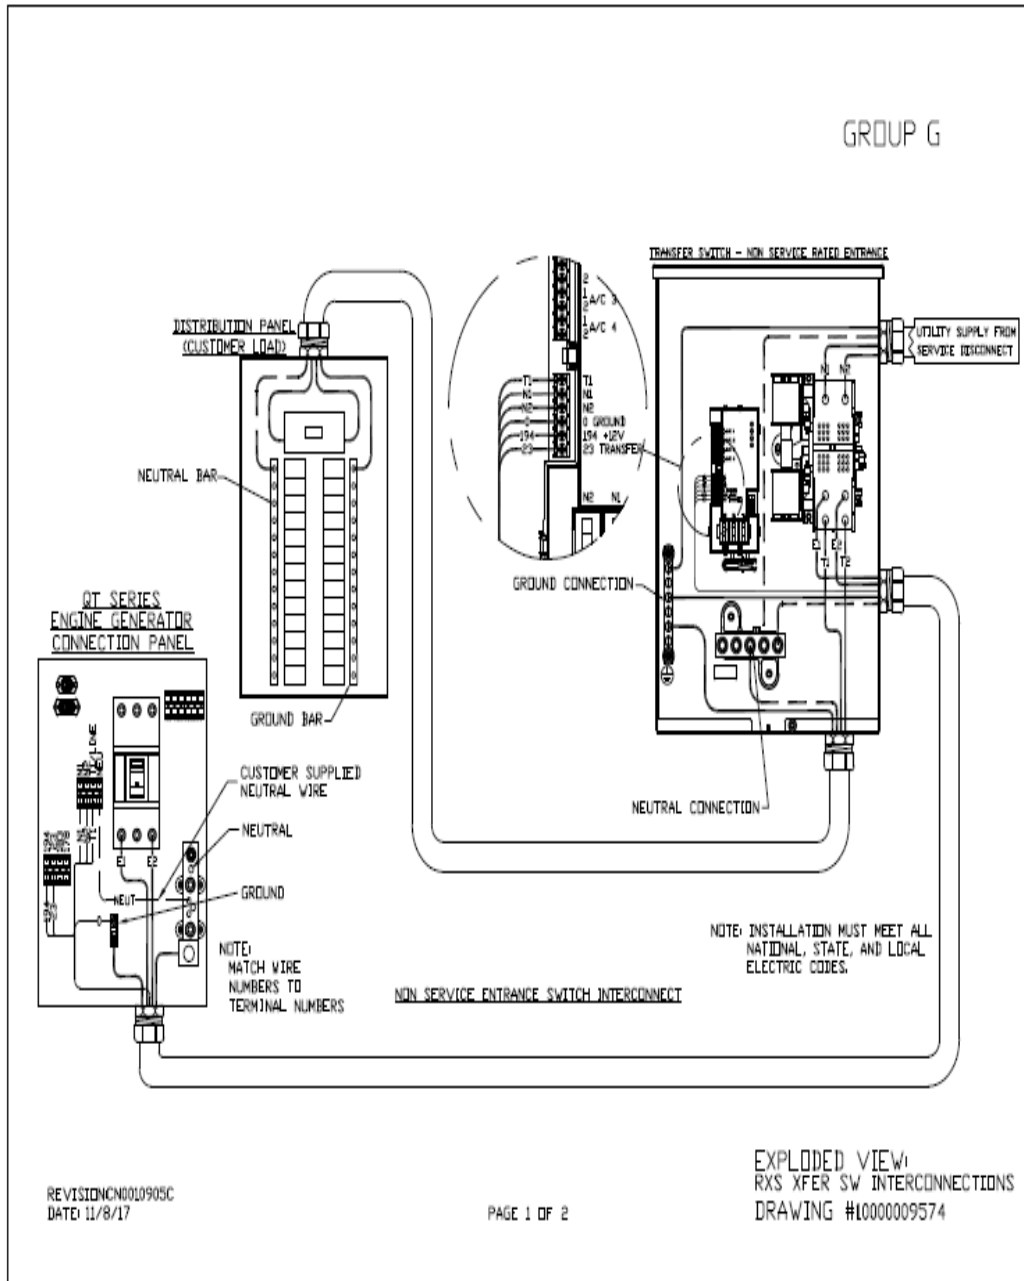

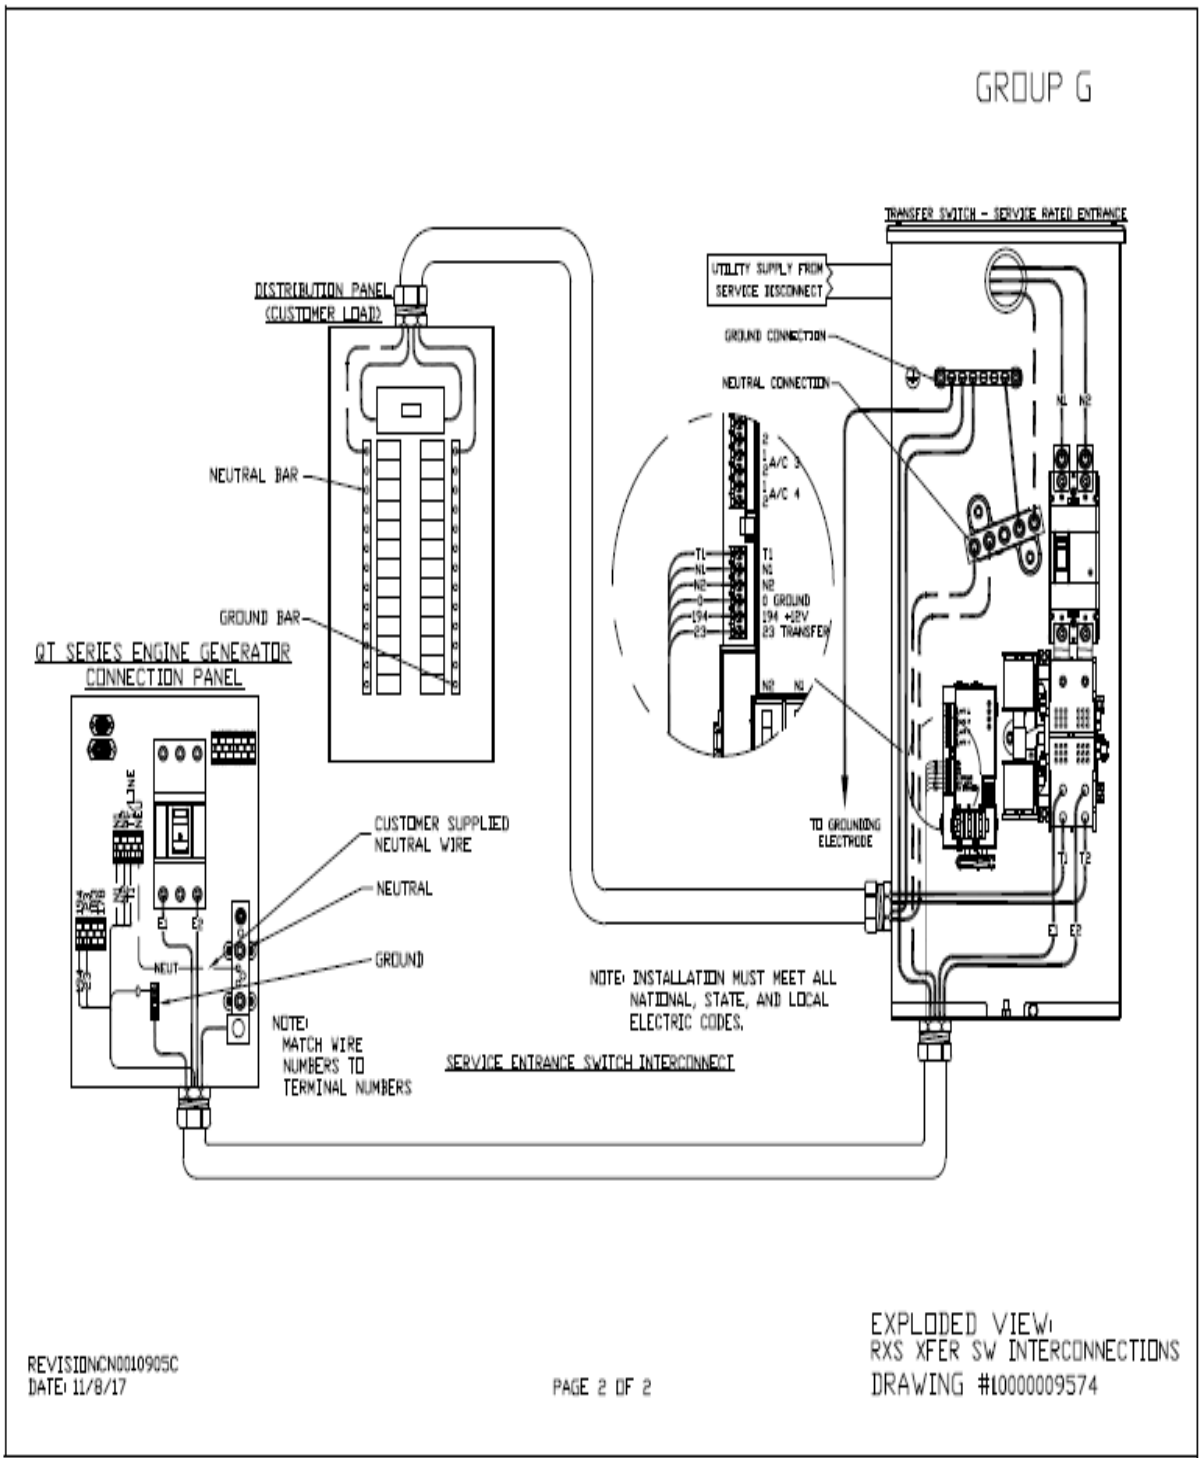

Compound Diagram:

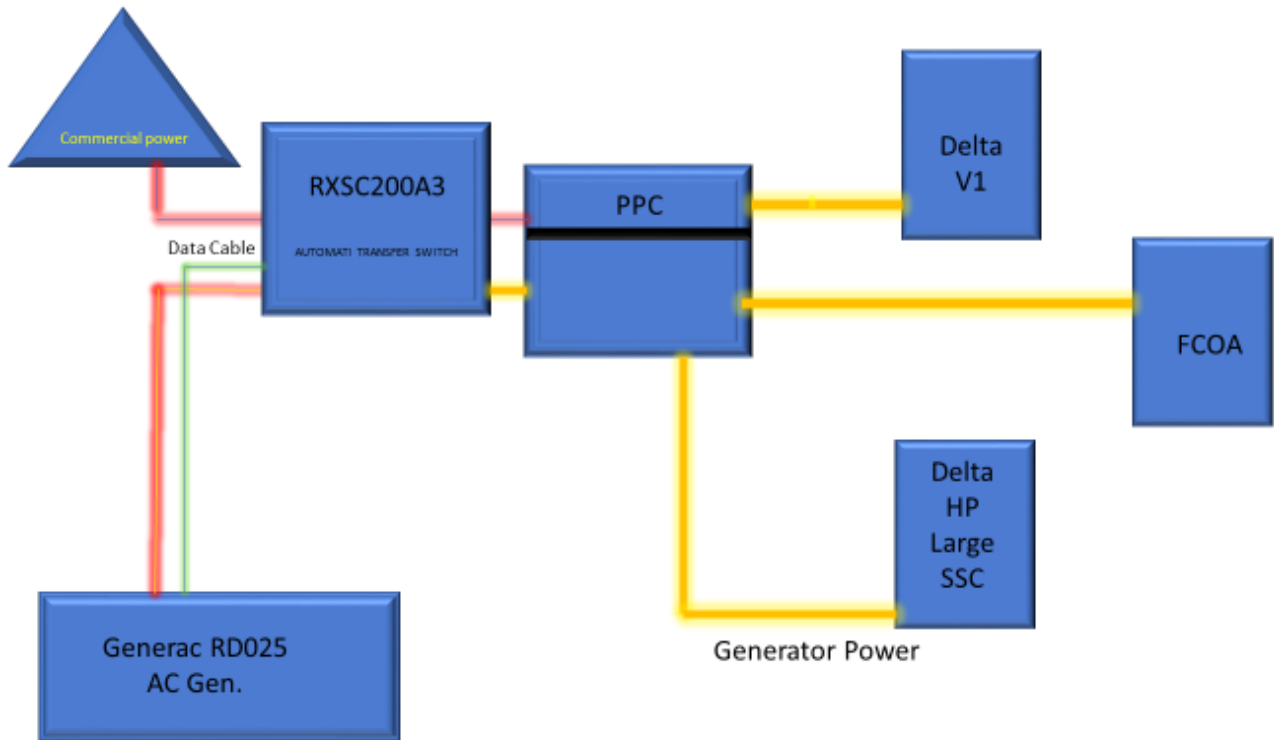

7 Maintenance

T-Mobile is recommending preventive maintenance to be performed every 250 hours of run-time or every 12 months, whichever comes first.


T-Mobile requires this minimum service checklist for the generator engine:

- Check engine mounts and support. Tighten fasteners.
- Check all the engine hoses and clamps for proper fit, and any signs of cracking and fatigue from wear.
- Inspect all belts for signs of cracking and fatigue from wear and adjust for proper tension.
- Inspect the exhaust system for leaks, burns and wet stacking. Drain exhaust line and tighten any clamps and flange bolts.
- Inspect silencer and plumbing for leaks, cracks or any other signs of wear.
- Inspect the system for fuel, oil and coolant leaks and signs of corrosion.
- Replace water separator.
- Replace water filter/ conditioner.
- Check Anti-Freeze (Spector-Analysis).
- Check coolant level and add, if needed.
- Inspect radiator mounting for signs or wear and cracking.
- Inspect/ clean air filter and change per manufacturer specifications.
- Inspect air intakes and outlets and tighten clamps and brackets, if applicable.
- Replace fuel filter.
- Inspect the carburetor fuel injection system, fuel injection pump and choke, if equipped. Adjust to manufacturers specifications.
- Change engine oil, oil filter and record the date on the filter casing.
- Check engine heater operation, if equipped.
- Check and adjust the battery charger operations, and charge rate within the manufacturer's recommended operating specifications.

- Inspect the battery housing, hardware connections, and cables for corrosion and wear.
- Check the battery electrolyte levels and specific gravity levels.
- Load test generator battery.
- Check, adjust and record generator output voltage, as necessary.
- Check and record the alternator charge rate.
- During inspection run the generator for 30 minutes under load. During this time, and after the engine is at full operational speed and has reached engine operating temperature; determine and record the condition of all inspection points: oil pressure, water/ coolant temperature, Fuel pressure, generator gauge, indicator operations, generator battery.
- Check the engine timing and adjust to manufacturers specifications, if necessary.
- Inspect, adjust and record governor and frequency, if necessary.
- Verify that the low fuel alarm is operational and configured correctly to trigger when the fuel tank reaches 50% of fuel tank capacity.

Check fuel level and refuel the generator during the preventive/ corrective maintenance visit.

Exhibit E



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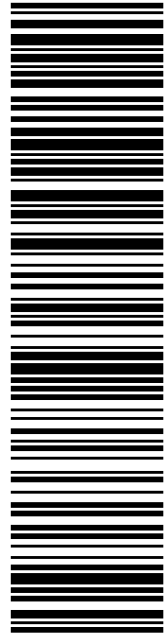
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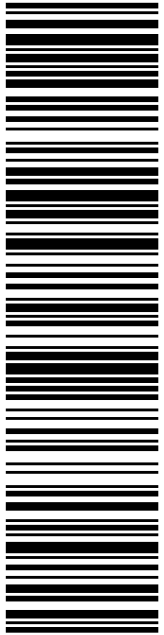
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Exhibit F



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STE 1
STURBRIDGE MA 01566-1359


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MAYOR OF WOLCOTT
10 KENEA AVE
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
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 ZONING INSPECTOR
 10 KENEA AVE
 WOLCOTT CT 06716-2114

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
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 STE 1
 STURBRIDGE MA 01566-1359

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 ZONING INSPECTOR
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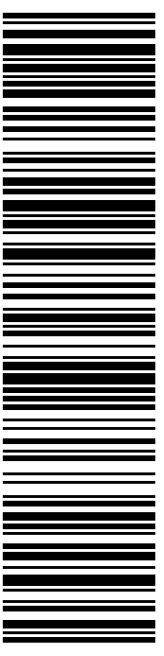
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 AUGUSTINHO & JOANNE RODRIGUES
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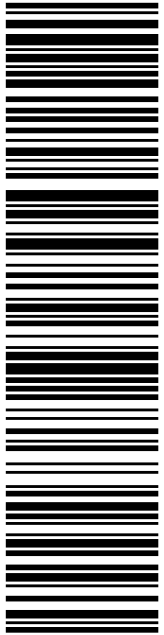
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STE 101
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
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STURBRIDGE
 316 MAIN ST
 STURBRIDGE, MA 01566-9998
 (800)275-8777

08/13/2021 01:55 PM

 Product Qty Unit Price
 Price

Prepaid Mail 1 \$0.00
 Wolcott, CT 06716
 Weight: 0 lb 11.20 oz
 Acceptance Date:
 Fri 08/13/2021
 Tracking #:
 9405 5036 9930 0470 6757 21

*CT11494B
 WOLCOTT*

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 Fri 08/13/2021
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