From: Daniel Hatab <daniel.hatab@ramapocom.com>

Sent: Friday, April 2, 2021 10:34 AM

To: CSC-DL Siting Council <Siting.Council@ct.gov> **Subject:** EM-CING-162-201026 (AT&T Site CTL01071)

Good Morning,

The site below has been completed on 3/15, CSC letter is attached for reference and also CCA letter.

AT&T Site: CTL01071

Address: 15 Oakdale Avenue, Windsted CT 06098

Thank You,

Daniel Hatab

daniel.hatab@ramapocom.com
20 Romanelli Ave, S. Hackensack, NJ 07606

Cell Phone: (201) 742-1070 Office Phone: (201) 343-2995



Date: March 30, 2021

State of Connecticut Connecticut Siting Council Ten Franklin Square New Britain, Ct. 06051 Phone: (860) 827-2935

SMW Engineering Group, Inc. 158 Business Center Dr Birmingham AL. 35244 (205) 252-6985

RE: EM-CING-162-201026

Subject: Special Inspection Letter – Final Certification

ATC Site: Winchester CT 3 – 302506

AT&T site: CTL01071 – FA:10035017

Site Address: 15 Oakdale Avenue

Winsted, Ct. 06098-1862

AT&T Scope of work: 5C,6C,5G NR – Antenna Amendment Drawings

SMW Engineering Project: 20-10208.1

Dear Sir or Madam,

On March 30, 2021, SMW Engineering Group, Inc., reviewed detailed photographs of the AT&T telecommunication facility located at the above referenced site. The purpose of these pictures was to inspect the installation in accordance with the following codes:

- International Building Code (IBC)
- National Electric Code (NEC)
- Local Building Code
- City / County Ordinances

Proposed scope of work on tower from Construction Drawings:

- Removal of (3) existing KMW AM-X-CD-16-65-00T-RET antennas (1) per sector
- Removal of (3) existing Powerwave 7770 antennas (1) per sector
- Removal of (6) existing Powerwave LGP 21901 Diplexers (2) per sector
- Removal of (3) existing Powerwave TT19-08BP111-001 TMA's (1) per sector
- Removal of (3) existing RRUS-11 B12 (1) per sector
- Removal of (3) existing RRUS-12 B2 (1) per sector
- Installation of (3) new Site Pro 1 HRK-12 Platform handrail Kit (1) per sector

- Installation of (3) new CCI OPA65R-BU6BA antennas (1) per sector
- Installation of (3) new CCI DMP65R-BU6DA antennas (1) per sector
- Installation of (3) RRUS 8843 B2/B66A (1) per sector
- Installation of (3) RRUS 4449 B5/B12 (1) per sector
- Installation of (3) RRUS E2 B29 (1) per sector
- Installation of (1) DC6-48-60-18-8F squid

Discrepancies from Permitted Drawings:


None


To the best of our knowledge, belief, and professional judgment, the connections of the installed equipment were performed **in substantial compliance** with the approved construction drawings prepared by SMW Engineering Group, Inc. dated 01-25-21 Rev.1.

Should you have any questions or wish to discuss any aspect of this letter, please do not hesitate to contact the undersigned.

Sincerely,

John T. Liu, PE **SMW Engineering Group, INC.** Principal Engineer Connecticut Registration #33076

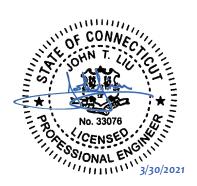

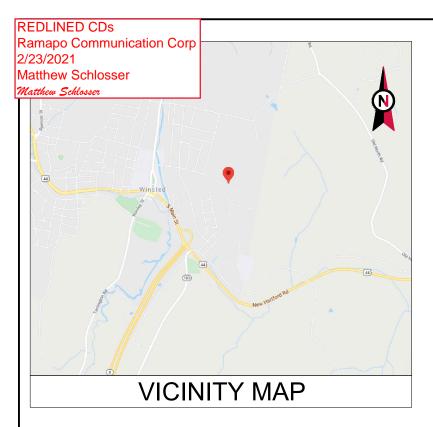



AMERICAN TOWER®

ATC SITE NAME: WINCHESTER CT 3

ATC SITE NUMBER: 302506

AT&T PACE NUMBER: MRCTB045239/MRCTB045192/

MRCTB045293/MRCTB045295/MRCTB045202

AT&T SITE ID: CTL01071 AT&T FA CODE:10035017 PROJECTS: 5C,6C,5G NR

SITE ADDRESS: 15 OAKDALE AVENUE

WINSTED, CT 06098-1862

AT&T MOBILITY ANTENNA AMENDMENT DRAWINGS



LOCATION MAP

COMPLIANCE CODE	PROJECT SU	JMMARY	PROJECT DESCRIPTION		SHEET INDEX			
ALL WORK SHALL BE PERFORMED AND MATERIALS INSTALLED IN ACCORDANCE WITH THE CURRENT EDITIONS OF THE	SITE ADDR		THE PROPOSED PROJECT INCLUDES MODIFYING GROUND BASED AND TOWER MOUNTED EQUIPMENT AS INDICATED PER BELOW:	SHEET NO:	DESCRIPTION:	REV:	DATE:	BY:
FOLLOWING CODES AS ADOPTED BY THE LOCAL GOVERNMENT AUTHORITIES. NOTHING IN THESE PLANS IS	15 OAKDALE A		TOWER WORK: REMOVE (6) ANTENNAS, (6) RRH'S, (6) DIPLEXERS, (3) TMA'S, AND	G-001	COVER SHEET	0	05/26/20	ZDS
TO BE CONSTRUED TO PERMIT WORK NOT CONFORMING TO THESE CODES.	WINSTED, CT 06 COUNTY: LITC		(6) 1-5/8" COAX CABLES.	G-002	GENERAL NOTES	0	05/26/20	ZDS
INTERNATIONAL BUILDING CODE (IBC)	GEOGRAPHIC COO		INSTALL (6) ANTENNAS, (9) RRH'S, (1) SQUID, (2) 0.78" 8AWG6 DC CABLES, AND (2) 0.39" FIBER CABLES	C-101	DETAILED SITE PLAN	0	05/26/20	ZDS
NATIONAL ELECTRIC CODE (NEC) LOCAL BUILDING CODE	LATITUDE: 41.9		EXISTING (3) ANTENNAS, (5) RRHS, (6) TMA'S, (2) SQUIDS, (6) 1-5/8"	C-201	TOWER ELEVATION	0	05/26/20	ZDS
CITY/COUNTY ORDINANCES	LONGITUDE: -		COAX CABLES, (2) 0.78" 8AWG6 DC CABLES, AND (1) 0.40" FIBER CABLES TO REMAIN.	C-401	EXISTING RF SCHEDULE AND ANTENNA INSTALLATION	0	05/26/20	ZDS
	GROUND ELEVATION	N: 1073' AMSL	GROUND WORK:	C-402	FINAL RF SCHEDULE AND ANTENNA INSTALLATION	0	05/26/20	ZDS
			INSTALL (1) 6630 AND (1) IDLE CABLE.	C-501	CONSTRUCTION DETAILS	0	05/26/20	ZDS
			INSTALL (1) RAYCAP IN FIF RACK	C-502	EQUIPMENT SPECIFICATIONS	0	05/26/20	ZDS
	PROJECT TEAM			E-501	GROUNDING DETAILS	0	05/26/20	ZDS
			PROJECT NOTES	R-601	SUPPLEMENTAL	0	05/26/20	ZDS
	TOWER OWNER:	APPLICANT: 1. THE FACILITY IS UNMANNED.	R-602	SUPPLEMENTAL	0	05/26/20	ZDS	
	AMERICAN TOWER	AT&T MOBILITY	A TECHNICIAN WILL VISIT THE SITE APPROXIMATELY ONCE A MONTH FOR ROUTINE INSPECTION AND MAINTENANCE.					
	10 PRESIDENTIAL WAY WOBURN, MA 01801		THE PROJECT WILL NOT RESULT IN ANY SIGNIFICANT LAND DISTURBANCE OR EFFECT OF STORM WATER DRAINAGE.					
UTILITY COMPANIES	ENGINEER:	PROPERTY OWNER:	NO SANITARY SEWER, POTABLE WATER OR TRASH DISPOSAL IS REQUIRED.					
POWER COMPANY: EVER SOURCE PHONE: (877) 659-6326	JEREMY SHARIT	WILLIAM P. STOW	5. HANDICAP ACCESS IS NOT REQUIRED.					
TELEPHONE COMPANY: FRONTIER COMMUNICATIONS	SMW ENGINEERING GROUP INC. 158 BUSINESS CENTER DR.	6674 HIBISCUS ST BUNNELL, FL - 32110	PROJECT LOCATION DIRECTIONS					
PHONE: (800) 376-6843	BIRMINGHAM, AL. 35244 JOB# 20-10208							
677	CONSULTING ENGINEER							
28411	JOHN LIU, PE		FROM HARTFORD TAKE RT 44 TO WINCHESTER. JUST BEFORE					
	JOHN LIU, PE (423) 541-0561 JOHNLIU@TELECOM.TEAM		JUNCTION FOR RT 8 TURN RIGHT AT LIGHT. TAKE SECOND LEFT ONTO OAKDALE AVENUE. GO TO END OF STREET AND					
, halam	2 2		THROUGH ACCESS ROAD GATE TO SITE.					
Know what's below. Call before you dig.								





TOGETHER PLANNING A BETTER TOMORROW

158 BUSINESS CENTER DRIVE
BIRMINGHAM. AL 35244

TEL: 205-252-6985 FAX: 205-320-1504

REV.	DESCRIPTION	BY	DATE
<u> </u>	FOR CONSTRUCTION	ZDS	05/26/20
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ATC SITE NUMBER:

302506

ATC SITE NAME:

WINCHESTER CT 3

SITE ADDRESS: 15 OAKDALE AVENUE WINSTED, CT 06098-1862

SEAL:

OF CONNECTION

ON THE CONNECTION

No. 33076

CENSE OF THE CONNECTION

OF CONNECTION

NO. 33076



COVER SHEET

SHEET NUMBER

CUSTOMER ID: 13201995
CUSTOMER #: 20-10208

G-001

0

REDLINED CDs OTES: Ramapo Communication Corp 2/23/2021

Matthew Schlosser

Matthew Schlosser

C. ICE BRIDGE (CABLE TRAY WITH COVER) (GROUND BUILD/CO-LOCATE ONLY, GC TO FURNISH AND INSTALL FOR ROOFTOP INSTALLATION)

AND ICEBRIDGE SHELTER (GROUND

- D. TOWERS, MONOPOLES
- TOWER LIGHTING
- GENERATORS & LIQUID PROPANE TANK
- ANTENNA STANDARD BRACKETS, FRAMES AND PIPES FOR MOUNTING
- ANTENNAS (INSTALLED BY OTHERS)
- TRANSMISSION LINE
- TRANSMISSION LINE JUMPERS
- TRANSMISSION LINE CONNECTORS WITH WEATHERPROOFING KITS
- TRANSMISSION LINE GROUND KITS
- HANGERS
- HOISTING GRIPS
- O. BTS EQUIPMENT
- THE CONTRACTOR IS RESPONSIBLE TO PROVIDE ALL OTHER MATERIALS FOR THE COMPLETE INSTALLATION OF THE SITE INCLUDING, BUT NOT LIMITED TO, SUCH MATERIALS AS FENCING, STRUCTURAL STEEL SUPPORTING SUB-FRAME FOR PLATFORM ROOFING LABOR AND MATERIALS GROUNDING RINGS GROUNDING WIRES COPPER-CLAD OR XIT CHEMICAL GROUND ROD(S), BUSS BARS, TRANSFORMERS AND DISCONNECT SWITCHES WHERE APPLICABLE, TEMPORARY ELECTRICAL POWER, CONDUIT, LANDSCAPING COMPOUND STONE, CRANES, CORE DRILLING, SLEEPERS AND RUBBER MATTING, REBAR, CONCRETE CAISSONS, PADS AND/OR AUGER MOUNTS,
 MISCELLANEOUS FASTENERS, CABLE TRAYS, NON-STANDARD ANTENNA FRAMES AND ALL OTHER MATERIAL AND LABOR REQUIRED TO COMPLETE THE JOB ACCORDING TO THE DRAWINGS AND SPECIFICATIONS. IT IS THE POSITION OF AT&T MOBILITY TO APPLY FOR PERMITTING AND CONTRACTOR RESPONSIBLE FOR PICKUP AND PAYMENT OF
- ALL WORK SHALL CONFORM TO ALL CURRENT APPLICABLE FEDERAL, STATE, AND LOCAL CODES, INCLUDING ANSI/EIA/TIA-222, AND COMPLY WITH ATC CONSTRUCTION
- CONTRACTOR SHALL CONTACT LOCAL 811 FOR IDENTIFICATION OF UNDERGROUND
- CONTRACTOR SHALL BE RESPONSIBLE FOR COORDINATING ALL REQUIRED INSPECTIONS.
- ALL DIMENSIONS TO, OF, AND ON EXISTING BUILDINGS, DRAINAGE STRUCTURES, AND SITE IMPROVEMENTS SHALL BE VERIFIED IN FIELD BY CONTRACTOR WITH ALL DISCREPANCIES REPORTED TO THE ENGINEER.
- DO NOT CHANGE SIZE OR SPACING OF STRUCTURAL ELEMENTS
- DETAILS SHOWN ARE TYPICAL; SIMILAR DETAILS APPLY TO SIMILAR CONDITIONS UNLESS 32.
- THESE DRAWINGS DO NOT INCLUDE NECESSARY COMPONENTS FOR CONSTRUCTION SAFETY WHICH SHALL BE THE SOLE RESPONSIBILITY OF THE CONTRACTOR
- CONTRACTOR SHALL BRACE STRUCTURES UNTIL ALL STRUCTURAL ELEMENTS NEEDED 33. FOR STABILITY ARE INSTALLED. THESE ELEMENTS ARE AS FOLLOWS: LATERAL BRACING,
- CONTRACTOR SHALL DETERMINE EXACT LOCATION OF EXISTING UTILITIES, GROUNDS DRAINS, DRAIN PIPES, VENTS, ETC, BEFORE COMMENCING WORK
- INCORRECTLY FABRICATED, DAMAGED, OR OTHERWISE MISFITTING OR NONCONFORMING MATERIALS OR CONDITIONS SHALL BE REPORTED TO THE AT&T MOBILITY REP PRIOR TO REMEDIAL OR CORRECTIVE ACTION. ANY SUCH REMEDIAL ACTION SHALL REQUIRE WRITTEN APPROVAL BY THE AT&T MOBILITY REP PRIOR TO
- EACH CONTRACTOR SHALL COOPERATE WITH THE AT&T MOBILITY REP, AND OORDINATE HIS WORK WITH THE WORK OF OTHERS
- CONTRACTOR SHALL REPAIR ANY DAMAGE CAUSED BY CONSTRUCTION OF THIS PROJECT TO MATCH EXISTING PRE-CONSTRUCTION CONDITIONS TO THE SATISFACTION OF THE AT&T MOBILITY CONSTRUCTION MANAGER.
- ALL CABLE/CONDUIT ENTRY/EXIT PORTS SHALL BE WEATHERPROOFED DURING
- WHERE EXISTING CONDITIONS DO NOT MATCH THOSE SHOWN IN THIS PLAN SET, CONTRACTOR SHALL NOTIFY THE AT&T MOBILITY REP AND ENGINEER OF RECORD
- CONTRACTOR SHALL ENSURE ALL SUBCONTRACTORS ARE PROVIDED WITH A COMPLETE AND CURRENT SET OF DRAWINGS AND SPECIFICATIONS FOR THIS PROJECT.
- CONTRACTOR SHALL REMOVE ALL RUBBISH AND DEBRIS FROM THE SITE AT THE END OF EACH DAY.
- CONTRACTOR SHALL COORDINATE WORK SCHEDULE WITH AMERICAN TOWER CORPORATION (ATC) AND TAKE PRECAUTIONS TO MINIMIZE IMPACT AND DISRUPTION OF OTHER OCCUPANTS OF THE FACILITY.
- CONTRACTOR SHALL FURNISH AT&T MOBILITY AND AMERICAN TOWER CORPORATION (ATC) WITH A PDF MARKED UP AS-BUILT SET OF DRAWINGS UPON COMPLETION OF
- PRIOR TO SUBMISSION OF BID, CONTRACTOR SHALL COORDINATE WITH AT&T MOBILITY REP TO DETERMINE WHAT, IF ANY, ITEMS WILL BE PROVIDED. ALL ITEMS NOT PROVIDED SHALL BE PROVIDED AND INSTALLED BY THE CONTRACTOR. CONTRACTOR WILL INSTALL 2. ALL EXTERIOR #6 GREED GROUND WIRE "DAISY CHAIN" CONNECTIONS ARE TO BE

ALL ITEMS PROVIDED.

- LITY "THE COMPANY" WILL PROVIDE AND THE 22. PRIOR TO SUBMISSION OF BID. CONTRACTOR SHALL COORDINATE WITH AT&T MOBILITY REP TO DETERMINE IF ANY PERMITS WILL BE OBTAINED BY CONTRACTOR. ALL
 REQUIRED PERMITS NOT OBTAINED BY AT&T MOBILITY MUST BE OBTAINED, AND PAID FOR, BY THE CONTRACTOR
 - 23. CONTRACTOR SHALL INSTALL ALL SITE SIGNAGE IN ACCORDANCE WITH AT&T MOBILITY SPECIFICATIONS AND REQUIREMENTS
 - CONTRACTOR SHALL SUBMIT ALL SHOP DRAWINGS TO AT&T MOBILITY FOR REVIEW AND APPROVAL PRIOR TO FABRICATION.
 - 25. ALL EQUIPMENT SHALL BE INSTALLED ACCORDING TO MANUFACTURER'S SPECIFICATIONS AND LOCATED ACCORDING TO AT&T MOBILITY SPECIFICATIONS, AND AS SHOWN IN THESE PLANS.
 - THE CONTRACTOR SHALL SUPERVISE AND DIRECT THE PROJECT DESCRIBED HEREIN. THE CONTRACTOR SHALL BE SOLELY RESPONSIBLE FOR ALL THE CONSTRUCTION MEANS, METHODS, TECHNIQUES, SEQUENCES AND PROCEDURES AND FOR COORDINATING ALL PORTIONS OF THE WORK UNDER THE CONTRACT.
 - CONTRACTOR SHALL NOTIFY AT&T MORILITY REP A MINIMUM OF 48 HOURS IN ADVANCE OF POURING CONCRETE OR BACKFILLING ANY UNDERGROUND UTILITIES, FOUNDATIONS OR SEALING ANY WALL, FLOOR OR ROOF PENETRATIONS FOR ENGINEERING REVIEW
 - CONTRACTOR SHALL BE RESPONSIBLE FOR SITE SAFETY INCLUDING COMPLIANCE WITH ALL APPLICABLE OSHA STANDARDS AND RECOMMENDATIONS AND SHALL PROVIDE ALL NECESSARY SAFETY DEVICES INCLUDING PPE AND PPM AND CONSTRUCTION DEVICES SUCH AS WELDING AND FIRE PREVENTION, TEMPORARY SHORING, SCAFFOLDING, TRENCH BOXES/SLOPING, BARRIERS, ETC.
 - THE CONTRACTOR SHALL PROTECT AT HIS OWN EXPENSE, ALL EXISTING FACILITIES AND SUCH OF HIS NEW WORK LIABLE TO INJURY DURING THE CONSTRUCTION PERIOD. ANY DAMAGE CAUSED BY NEGLECT ON THE PART OF THIS CONTRACTOR OR HIS REPRESENTATIVES, OR BY THE ELEMENTS DUE TO NEGLECT ON THE PART OF THIS CONTRACTOR OR HIS REPRESENTATIVES. FITHER TO THE EXISTING WORK, OR TO HIS WORK OR THE WORK OF ANY OTHER CONTRACTOR, SHALL BE REPAIRED AT HIS EXPENSE TO THE OWNER'S SATISFACTION.
 - 30. ALL WORK SHALL BE INSTALLED IN A FIRST CLASS, NEAT AND WORKMANLIKE MANNER BY MECHANICS SKILLED IN THE TRADE INVOLVED. THE QUALITY OF WORKMANSHIP SHALL BE SUBJECT TO THE APPROVAL OF THE AT&T MOBILITY REP. ANY WORK FOUND BY THE AT&T MOBILITY, REP TO BE OF INFERIOR QUALITY AND/OR WORKMANSHIP SHALL BE REPLACED AND/OR REWORKED AT CONTRACTOR EXPENSE UNTIL APPROVAL IS
 - IN ORDER TO ESTABLISH STANDARDS OF QUALITY AND PERFORMANCE, ALL TYPES OF MATERIALS LISTED HEREINAFTER BY MANUFACTURER'S NAMES AND/OF MANUFACTURER'S CATALOG NUMBER SHALL BE PROVIDED BY THESE MANUFACTURERS
 - AT&T MOBILITY FURNISHED EQUIPMENT SHALL BE PICKED-UP AT THE AT&T MOBILITY WAREHOUSE, NO LATER THAN 48HR AFTER BEING NOTIFIED INSURED, STORED, UNCRATE, PROTECTED AND INSTALLED BY THE CONTRACTOR WITH ALL APPURTENANCES REQUIRED TO PLACE THE EQUIPMENT IN OPERATION, READY FOR USE. THE CONTRACTOR SHALL BE RESPONSIBLE FOR THE EQUIPMENT AFTER PICKING IT
 - AT&T MOBILITY OR HIS ARCHITECT/ENGINEER RESERVES THE RIGHT TO REJECT ANY FOLIPMENT OR MATERIALS WHICH, IN HIS OWN OPINION ARE NOT IN COMPLIANCE WITH THE CONTRACT DOCUMENTS, EITHER BEFORE OR AFTER INSTALLATION AND THE EQUIPMENT SHALL BE REPLACED WITH EQUIPMENT CONFORMING TO THE REQUIREMENTS OF THE CONTRACT DOCUMENTS BY THE CONTRACTOR AT NO COST TO AT&T MOBILITY OR THEIR ARCHITECT/ENGINEER

SPECIAL CONSTRUCTION ANTENNA INSTALLATION NOTES:

- WORK INCLUDED
 - ANTENNA AND COAXIAL CABLES ARE FURNISHED BY AT&T MOBILITY UNDER A SEPARATE CONTRACT. THE CONTRACTOR SHALL ASSIST ANTENNA INSTALLATION CONTRACTOR IN TERMS OD COORDINATION AND SITE ACCESS. ERECTION SUBCONTRACTOR SHALL BE RESPONSIBLE FOR THE PROTECTION OF
 - B. INSTALL ANTENNA AS INDICATE ON DRAWINGS AND AT&T MOBILITY
 - C. INSTALL GALVANIZED STEEL ANTENNA MOUNTS AS INDICATED ON DRAWINGS
 - D. INSTALL FURNISHED GALVANIZED STEEL OR ALUMINUM WAVEGUIDE AND PROVIDE PRINTOUT OF THAT TEST.
 - E. CONTRACTOR SHALL PROVIDE FOUR (4) SETS OF SWEEP TESTS USING ANRITZU-PACKARD 8713B RF SCALAR NETWORK ANALYZER. SUBMIT FREQUENCY DOMAIN REFLECTOMETER(FDR) TESTS RESULTS TO THE PROJECT MANAGER. SWEEP TESTS SHALL BE AS PER ATTACHED RFS "MINIMUM FIELD TESTING RECOMMENDED FOR ANTENNA AND HELIAX COAXIAL CABLE SYSTEMS" DATED 10/5/93. TESTING SHALL BE PERFORMED BY AN INDEPENDENT TESTING SERVICE AND BE BOUND AND SUBMITTED WITHIN ONE WEEK OF WORK COMPLETION.
 - INSTALL COAXIAL CABLES AND TERMINATING BETWEEN ANTENNAS AND EQUIPMENT PER MANUFACTURER'S RECOMMENDATIONS. WEATHERPROOF ALL CONNECTIONS RETWEEN THE ANTENNA AND FOLIPMENT PER MANUFACTURER'S REQUIREMENTS. TERMINATE ALL COAXIAL CABLE THREE (3) FEET IN EXCESS OF ENTRY PORT LOCATION UNLESS OTHERWISE STATED.
 - G. ANTENNA AND COAXIAL CABLE GROUNDING:

WEATHER SEALED WITH RES CONNECTORS/SPLICE WEATHERPROOFING KIT #221213 OR

ALL COAXIAL CABLE GROUNDING KITS ARE TO BE INSTALLED ON STRAIGHT RUNS OF COAXIAL CABLE (NOT WITHIN BENDS)

> ALL DISCREPANCIES FROM WHAT IS SHOWN ON THESE CONSTRUCTION DRAWINGS SHALL BE COMMUNICATED TO ATC ENGINEERING IMMEDIATELY FOR CORRECTION OR RE-DESIGN. FAILURE TO COMMUNICATE DIRECTLY WITH ATC ENGINEERING OR ANY CHANGES FROM THE DESIGN CONDUCTED WITHOUT PRIOR APPROVAL FROM ATC ENGINEERING SHALL BE THE SOLE RESPONSIBILITY OF THE GENERAL CONTRACTOR.





158 BUSINESS CENTER DRIVE BIRMINGHAM AL 35244 TEL: 205-252-6985 FAX: 205-320-1504

REV. DESCRIPTION BY DATE FOR CONSTRUCTION

ATC SITE NUMBER:

302506

ATC SITE NAME:

WINCHESTER CT 3

SITE ADDRESS: 15 OAKDALE AVENUE WINSTED, CT 06098-1862





ATC JOB NO: 302506 CUSTOMER ID: 13201995 CUSTOMER #: | 20-10208

GENERAL NOTES

SHEET NUMBER:

REVISION

G-002

REDLINED CDs Ramapo Communication Corp 2/23/2021 Matthew Schlosser


EST PRESENT KNOWLEDGE AVAILABLE TO THE ENGINEER AT THE TIME OF THIS DESIGN. THE CONTRACTOR SHALL VISIT THE SITE IFY ALL EXISTING CONDITIONS RELATED TO THE SCOPE OF WORK FOR THIS PROJECT.

PORT. AND COAX CABLE ARE SHOWN FOR REFERENCE ONLY. CONTRACTOR SHALL CONFIRM THE EXACT LOCATION OF ALL NT AND STRUCTURES DEPICTED ON THIS PLAN. BEFORE UTILIZING EXISTING CABLE SUPPORTS, COAX PORTS, INSTALLING NEW PORTS OR ANY OTHER EQUIPMENT, CONTRACTOR SHALL VERIFY ALL ASPECTS OF THE COMPONENTS MEET THE ATC SPECIFICATIONS.

3. THIS PROJECT INCLUDES NO INSTALL OR MODIFICATION AT GRADE.

LEGEND GROUNDING TEST WELL ATS AUTOMATIC TRANSFER SWITCH BOLLARD CSC CELL SITE CABINET D DISCONNECT ELECTRICAL **FIBER** GEN GENERATOR GENERATOR RECEPTACAL HH, V HAND HOLE, VAULT ΙB ICE BRIDGE KENTROX BOX LC LIGHTING CONTROL M METER PB PULL BOX POWER POLE TELCO TRN TRANSFORMER

CHAINLINK FENCE

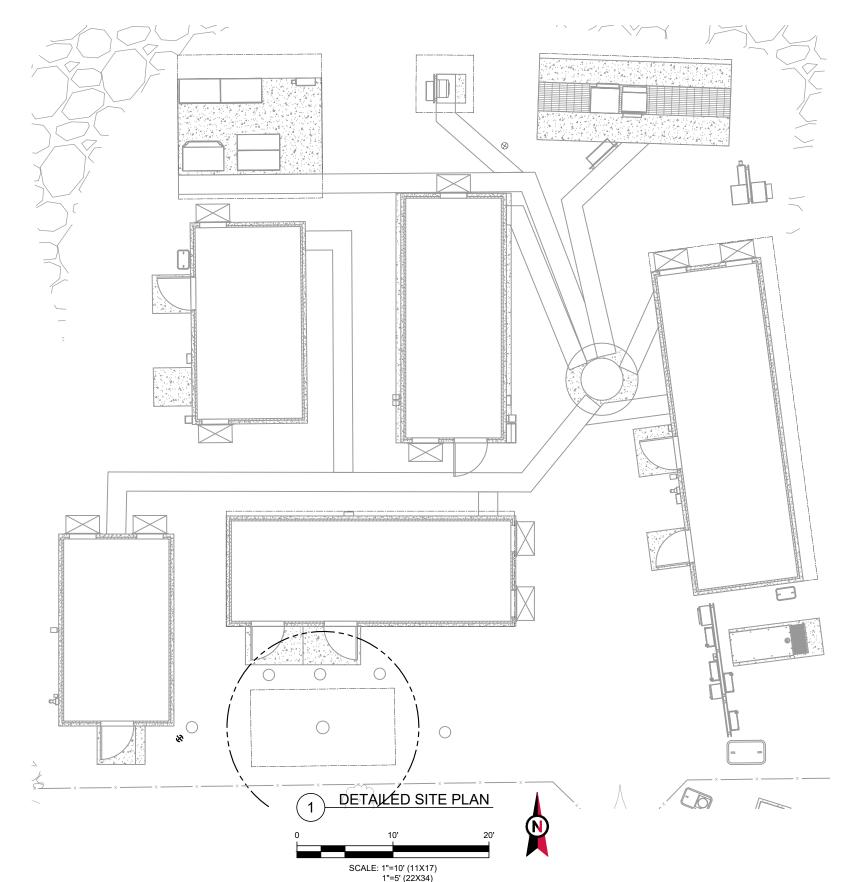

PROPOSED CABLE LENGTH:

- ESTIMATED LENGTH OF PROPOSED CABLE IS XXX.
 ESTIMATED LENGTH OF CABLE WAS PROVIDED BY CUSTOMER OR CALCULATED BY ADDING THE RAD CENTER AND THE DISTANCE FROM THE SHELTER ENTRY PLATE TO THE TOWER (ALONG THE ICE BRIDGE) AND A SAFETY FACTOR MEASUREMENT OF 15% (OF THE TWO PREVIOUS VALUES), CDS DEFER TO GREATEST CABLE LENGTH.
- ROUTE PROPOSED CABLES ALONG SAME PATH AS EXISTING CABLES AND IN ACCORDANCE WITH STRUCTURAL ANALYSIS. WHERE POSSIBLE UTILIZE EXISTING CABLE SUPPORT STRUCTURES AS PROVIDED FOR CARRIER TO ADEQUATELY SECURE CABLES, USING EITHER APPROPRIATELY SIZED STAINLESS STEEL SNAP-INS OR MOUNTING HARDWARE AND BRACKETS AS SPECIFIED BY CABLE MANUFACTURER. OTHERWISE, ATTACH CABLES TO HORIZONTAL OR DIAGONAL TOWER MEMBERS USING PROPOSED STAINLESS STEEL ADAPTERS (DO NOT ATTACH TO TOWER LEG).





TOGETHER PLANNING A BETTER TOMORROW 158 BUSINESS CENTER DRIVE BIRMINGHAM, AL 35244 TEL: 205-252-6985 FAX: 205-320-1504

REV.	DESCRIPTION	BY	DATE
<u> </u>	FOR CONSTRUCTION	ZDS	05/26/20
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ATC SITE NUMBER:

302506

ATC SITE NAME:

WINCHESTER CT 3

SITE ADDRESS: 15 OAKDALE AVENUE WINSTED, CT 06098-1862






	DATE DRAWN:	05/26/20
	ATC JOB NO:	302506
	CUSTOMER ID:	13201995
	CUSTOMER #:	20-10208

DETAILED SITE PLAN

SHEET NUMBER:

C-101

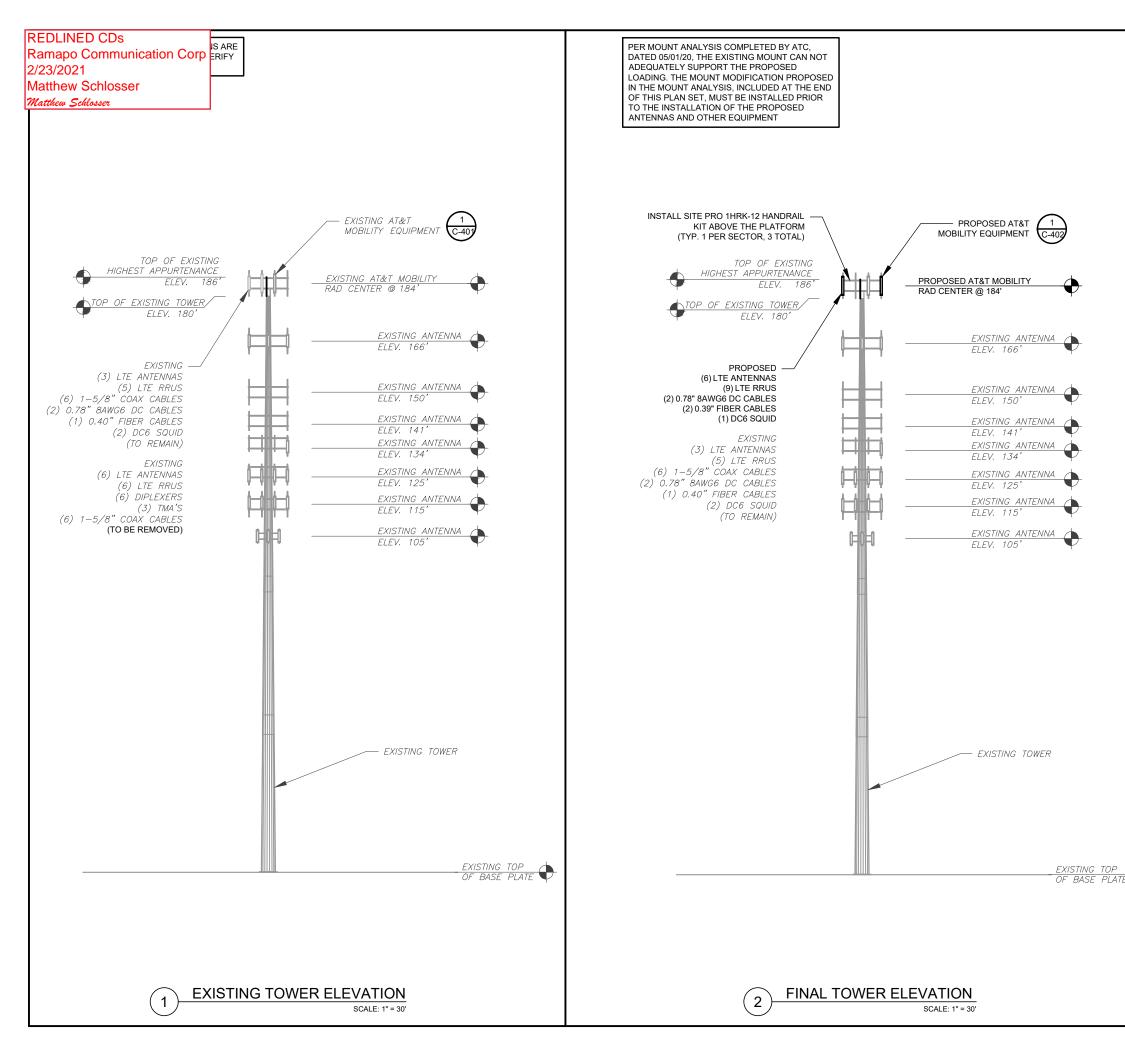

TOWER NOTE:

1. IT IS THE CONTRACTOR'S RESPONSIBILITY TO CONFIRM WITH THE AMERICAN TOWER CONSTRUCTION MANAGER THAT THEY HAVE THE MOST RECENT VERSION OF THE STRUCTURAL ANALYSIS BEFORE COMMENCING WORK. EXISTING AND PROPOSED TOWER APPURTENANCES, MOUNTS, AND ANTENNAS ARE SHOWN BASED ON THE STRUCTURAL ANALYSIS.

2. ROUTE PROPOSED CABLES ALONG SAME PATH AS EXISTING CABLES AND IN ACCORDANCE WITH STRUCTURAL ANALYSIS. IF ADEQUATE SPACE EXISTS, ROUTE CABLES THROUGH ENTRY PORT HOLE, UP INSIDE OF MONOPOLE, AND THROUGH EXIT PORT HOLE. IF ROUTING OUTSIDE THE MONOPOLE, ATTACH CABLES USING STAND-OFF ADAPTERS MOUNTED TO TOWER USING STAINLESS STEEL BANDING ADEQUATELY SECURE CABLES USING EITHER APPROPRIATELY SIZED STAINLESS STEEL SNAP-INS OR MOUNTING HARDWARE AND BRACKETS AS SPECIFIED BY CABLE MANUFACTURER.

TOWER ELEVATIONS ARE MEASURED FROM TOP OF BASE PLATE TO MATCH STRUCTURAL ANALYSIS, ELEVATIONS DO NOT REFLECT TRUE ABOVE GROUND LEVEL (A.G.L.)

SCOPE OF WORK:

- WHEN STACKING CABLES 3 OR MORE DEEP, USE STACKABLE SNAP-INS, TALLEY PART NUMBER SSH-158-3 (OR ENGINEER APPROVED EQUAL).
- CONTRACTOR SHALL CONFIRM THE FINAL CABLE ROUTING PLAN WITH THE STRUCTURAL ANALYSIS

- CONTRACTOR SHALL CONFIRM COAX COLOR CODING PRIOR TO CONSTRUCTION. REFER TO "ANTENNA SYSTEM LABELING STANDARD" ND-00027 LATEST VERSION
- CONTRACTOR SHALL WEATHERPROOF ALL ANTENNA CONNECTORS WITH SELF AMALGAMATING TAPE. WEATHERPROOFING SHALL BE COMPLETED IN STRICT ACCORDANCE WITH AT&T STANDARDS.
- CONTRACTOR SHALL GROUND ALL EQUIPMENT INCLUDING ANTENNAS, RET MOTORS, TMA'S, COAX CABLES, AND RET CONTROL CABLES AS A COMPLETE SYSTEM. GROUNDING SHALL BE EXECUTED BY QUALIFIED WIREMEN IN COMPLIANCE WITH MANUFACTURER'S SPECIFICATION AND RECOMMENDATION.
- CONTRACTOR TO VERIFY THAT EXISTING COAX HANGERS ARE STACKABLE SNAP IN HANGERS. IF EXISTING HANGERS ARE NOT STACKABLE SNAP IN HANGERS THE CONTRACTOR SHALL REPLACE EXISTING HANGERS WITH NEW SNAP IN HANGERS IF APPLICABLE.





TOGETHER PLANNING A BETTER TOMORROW 158 BUSINESS CENTER DRIVE BIRMINGHAM, AL 35244

TEL: 205-252-6985 FAX: 205-320-1504

REV.	DESCRIPTION	BY	DATE
<u> </u>	FOR CONSTRUCTION	ZDS	05/26/20
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ATC SITE NUMBER:


302506

ATC SITE NAME:

WINCHESTER CT 3

SITE ADDRESS: 15 OAKDALE AVENUE WINSTED, CT 06098-1862



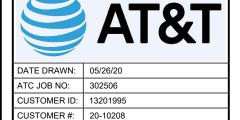

TOWER ELEVATION

SHEET NUMBER:


REVISION

C-201

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Matthew Schlosser



CURRENT ANTENNA PLAN 1" = 5'-0"

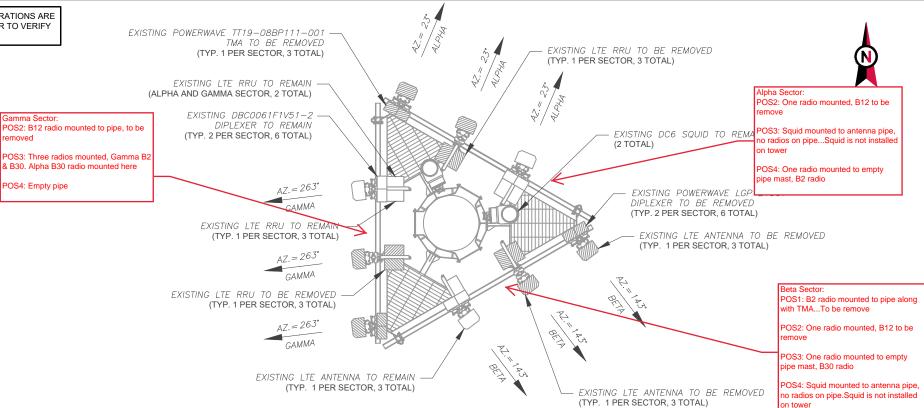NOTES					EXISTING	G ANTENNA SCHEDUL	.E				
BASED ON APPROVED ATC	LO	LOCATION				UMMARY		NON ANTENNA SUMMARY			
APPLICATION 302506, DATED 04/16/20. CONFIRM WITH AT&T	SECTOR	RAD	AZ	POS	ANTENNA	BAND	STATUS	ADDITIONAL TOWER MOUNTED EQUIPMENT	STATUS		
MOBILITY REP FOR APPLICABLE UPDATES/REVISIONS AND MOST RECENT RFDS FOR NSN				A1	POWERWAVE 7770	UMTS	RMV	(2) POWERWAVE LGP 21901 DIPLEXERS	RMV		
CONFIGURATION (CONFIG). GC TO								TT19-08BP111-001 TMA	RMV		
CAP ALL UNUSED PORTS. 2. ATC HAS NOT YET VERIFIED ANY				A2	KMW	LTE	RMV	RRUS-11 B12	RMV		
EXISTING ANTENNA CONFIG OR	ALPHA	104,	23°	AZ	AM-X-CD-16-65-00T-RET	LIE	KIVIV	RRUS-12 B2	RMV		
MOUNT CONFIG. CONTRACTOR TO VERIFY MOUNT CONFIG HAS	ALPHA	184'	23					RRUS-32 B30	RMN		
SUFFICIENT SPACE FOR				A.3	CCI HPA-65R-BUU-H6	LTE	RMN	RRUS-4478 B14	RMN		
PROPOSED LESSEE EQUIPMENT (EQUIP) (I.E. CLEARANCES,				, 10			7,000	(2) DBC0061F1V51-2 DIPLEXERS	RMN		
MOUNT PIPE, SUFFICIENT LENGTH, ETC.) ATC DID NOT				A4	_	_	_	_	_		
ANALYZE ANTÉNNA MOUNT TO DETERMINE ADEQUATE				B1	POWERWAVE 7770	UMTS	RMV	(2) POWERWAVE LGP 21901 DIPLEXERS	RMV		
STRUCTURAL CAPACITY FOR ANY LESSEE LOADING.								TT19-08BP111-001 TMA	RMV		
3. ALL PROPOSED EQUIP INCLUDING			143°	B2	kMW	LTE	RMV	RRUS-11 B12	RMV		
ANTENNAS, COAX, ETC. SHALL BE MOUNTED IN ACCORDANCE WITH	BETA	184'		DZ.	AM-X-CD-16-65-00T-RET	LIE	KIVIV	RRUS-12 B2	RMV		
THE TOWER STRUCTURAL								RRUS-32 B30	RMN		
ANALYSIS ON FILE WITH ATC'S CM. 4. CONFIRM SPACING OF PROPOSED				B3	CCI HPA-65R-BUU-H6	LTE	RMN	(2) DBC0061F1V51-2 DIPLEXERS	RMN		
EQUIP DOES NOT CAUSE TOWER CONFLICTS NOR IMPEDE TOWER				B4	_	_	_	_	-		
CLIMBING PEGS. 5. POSITIONS START WITH FIRST				C1	POWERWAVE 7770	UMTS	RMV	(2) POWERWAVE LGP 21901 DIPLEXERS	RMV		
PIPE ON THE LEFT SIDE (AS VIEWED FROM BEHIND THE								TT19-08BP111-001 TMA	RMV		
MOUNT).				C2	KMW	LTE	RMV	RRUS-11 B12	RMV		
	GAMMA	184	263°	- 02	AM-X-CD-16-65-00T-RET	LIL	IXIVIV	RRUS-12 B2	RMV		
	GAMINIA	104	200					RRUS-32 B30	RMN		
				C3	CCI HPA-65R-BUU-H6	LTE	LTE RMN	RRUS-4478 B14	RMN		
								(2) DBC0061F1V51-2 DIPLEXERS	RMN		
				C4	_	_	-	_	-		

CABLE LENGTHS FOR JUMPERS FIBER DISTRIBUTION/SQUID TO RRU: 15' RRU TO ANTENNA: 10'

STATUS ABBREVIATIONS RMV: TO BE REMOVED RMN: TO REMAIN REL: TO BE RELOCATED DSC: TO BE DISCONNECTED & REMAIN ADD: TO BE ADDED

EXISTING FIBER DISTRIBUTIO	EXISTING CABLING SUMMARY				
MODEL NUMBER	STATUS	COAX	DC	FIBER	STATUS
DC6-48-60-18-8F	RMN	(6) 1-5/8" COAX	(2) 0.78"	(1) 0.40"	RMN
DC6-48-60-18-8F	RMN	(6) 1-5/8" COAX	-	-	RMV





TOGETHER PLANNING A BETTER TOMORROW 158 BUSINESS CENTER DRIVE BIRMINGHAM, AL 35244

TEL: 205-252-6985 FAX: 205-320-1504

REV.	DESCRIPTION	BY	DATE
<u> </u>	FOR CONSTRUCTION	ZDS	05/26/20
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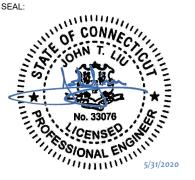
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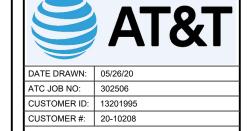
302506

ATC SITE NAME:

WINCHESTER CT 3

SITE ADDRESS: 15 OAKDALE AVENUE WINSTED, CT 06098-1862






EXISTING RF SCHEDULE AND ANTENNA INSTALLATION

SHEET NUMBER:

C-401

REVISION: 0

EQUIPMENT SCHEDULES

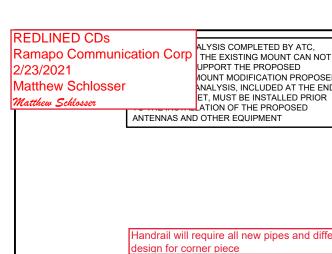


MOUNT).

JPPORT THE PROPOSED IOUNT MODIFICATION PROPOSED NALYSIS, INCLUDED AT THE END ET, MUST BE INSTALLED PRIOR ATION OF THE PROPOSED ANTENNAS AND OTHER EQUIPMENT

Handrail will require all new pipes and different

Can not mount squids to tower do to platform at op of tower with no monopole

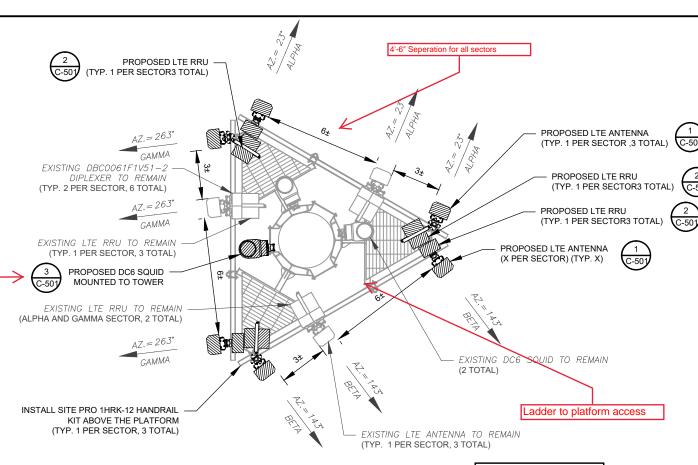

<u>Alpha</u>

- P1 Antenna only
- P2 Empty Pipe w/ Squid
- P3 Antenna w/ WCS & AWS/PCS radio
 - P4 Antenna w 700/850 and 700DE

² Beta sector

<u>Beta</u>

- P1 Antenna only
- P2 Empty Pipe w/ WCS & AWS/PCS
- P3 Antenna w/ Squid
- P4 Antenna w 700/850 and 700DE

Gamma sector

Gamma

- P1 Antenna only
- P2 Empty Pipe w/ Squid
- P3 Antenna w/ WCS & AWS/PCS radio
- P4 Antenna w 700/850 and 700DE

Alpha sector

FINAL ANTENNA PLAN

PROPOSED RRUS MUST BE INSTALLED A MINIMUM OF 8" AWAY FROM ALL ANTENNAS

								$\overline{}$	
NOTES					FINAL	ANTENNA SCHEDULE			
1. BASED ON APPROVED ATC	LO	CATION			ANTENNA S	UMMARY		NON ANTENNA SUMMAR	:Y
APPLICATION 302506, DATED 04/16/20. CONFIRM WITH AT&T	SECTOR	RAD	AZ	POS	ANTENNA	BAND	STATUS	ADDITIONAL TOWER MOUNTED EQUIPMENT	STATUS
MOBILITY REP FOR APPLICABLE UPDATES/REVISIONS AND MOST				A1	CCI OPA65R-BU6BA	LTE	ADD	RRUS-E2 B29	ADD
RECENT RFDS FOR NSN				A2	-	-	-	-	-
CONFIGURATION (CONFIG). GC TO CAP ALL UNUSED PORTS.								RRUS-32 B30	RMN
2. ATC HAS NOT YET VERIFIED ANY	ALPHA	184'	23°	A3	CCI HPA-65R-BUU-H6	LTE	RMN	RRUS-4478 B14	RMN
EXISTING ANTENNA CONFIG OR MOUNT CONFIG. CONTRACTOR								(2) DBC0061F1V51-2	RMN
TO VERIFY MOUNT CONFIG HAS								RRUS-4449 B5/B12	ADD
SUFFICIENT SPACE FOR PROPOSED LESSEE EQUIPMENT				A4	CCI DMP65R-BU6DA	LTE	ADD	RRUS-8843 B2/B66A	ADD
(EQUIP) (I.E. CLEARANCES,				B1	CCI OPA65R-BU6BA	LTE	ADD	RRUS-E2 B29	ADD
MOUNT PIPE, SUFFICIENT				B2	-	-	-	-	-
LENGTH, ETC.) ATC DID NOT ANALYZE ANTENNA MOUNT TO					001 1104 050 01111 110		0.44	RRUS-32 B30	RMN
DETERMINE ADEQUATE	BETA	184'	143°	В3	CCI HPA-65R-BUU-H6	LTE	RMN	(2) DBC0061F1V51-2	RMN
STRUCTURAL CAPACITY FOR ANY LESSEE LOADING.					00/ 01/00/00 01/00 1			RRUS-4449 B5/B12	ADD
3. ALL PROPOSED EQUIP INCLUDING				B4	CCI DMP65R-BU6DA	LTE	ADD	RRUS-8843 B2/B66A	ADD
ANTENNAS, COAX, ETC. SHALL BE MOUNTED IN ACCORDANCE WITH				C1	CCI OPA65R-BU6BA	LTE	ADD	RRUS-E2 B29	ADD
THE TOWER STRUCTURAL				C2	-	-	-	-	-
ANALYSIS ON FILE WITH ATC'S CM. 4. CONFIRM SPACING OF PROPOSED								RRUS-32 B30	RMN
EQUIP DOES NOT CAUSE TOWER	GAMMA	184'	263°	C3	CCI HPA-65R-BUU-H6	LTE	RMN	RRUS-4478 B14	RMN
CONFLICTS NOR IMPEDE TOWER CLIMBING PEGS.								(2) DBC0061F1V51-2	RMN
5. POSITIONS START WITH FIRST				- 0.4	OOL DAADOED DUODA	LTE	400	RRUS-4449 B5/B12	ADD
PIPE ON THE LEFT SIDE (AS VIEWED FROM BEHIND THE				C4	CCI DMP65R-BU6DA	LTE	ADD	RRUS-8843 B2/B66A	ADD

CABLE LENGTHS FOR JUMPERS FIBER DISTRIBUTION/SQUID TO RRU: 15' RRU TO ANTENNA: 10'

STATUS ABBREVIATIONS RMV: TO BE REMOVED

RMN: TO REMAIN

REL: TO BE RELOCATED

DSC: TO BE DISCONNECTED & REMAIN ADD: TO BE ADDED

FINAL FIBER DISTRIBUTION/	SQUID	FINAL CABLING SUMMARY				
MODEL NUMBER	STATUS	COAX	DC	FIBER	STATUS	
DC6-48-60-18-8F	RMN	(6) 1–5/8" COAX	(2) 0.78"	(1) 0.40"	RMN	
DC6-48-60-18-8F	RMN	(6) 1-5/8" COAX	-	-	RMV	
DC6-48-60-18-8F	ADD	-	(2) 0.78"	(2) 0.39"	ADD	





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REV.	DESCRIPTION	BY	DATE
<u></u>	FOR CONSTRUCTION	ZDS	05/26/20
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ATC SITE NUMBER:


302506

ATC SITE NAME:

WINCHESTER CT 3

SITE ADDRESS: 15 OAKDALE AVENUE WINSTED, CT 06098-1862



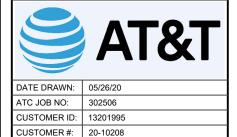

FINAL RF SCHEDULE AND ANTENNA **INSTALLATION**

SHEET NUMBER:


C-402

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REVISION:


EQUIPMENT SCHEDULES

REDLINED CDs Ramapo Communication Corp 2/23/2021 Matthew Schlosser Matthew Schlosser

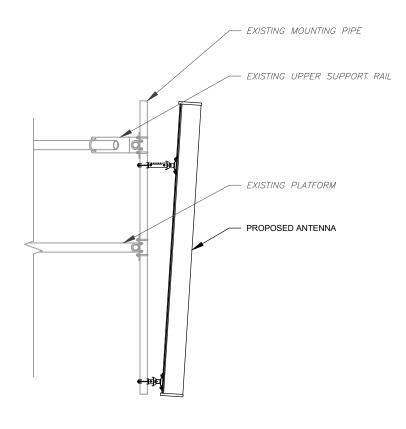


ANTENNA DETAIL

SCALE: N.T.S.

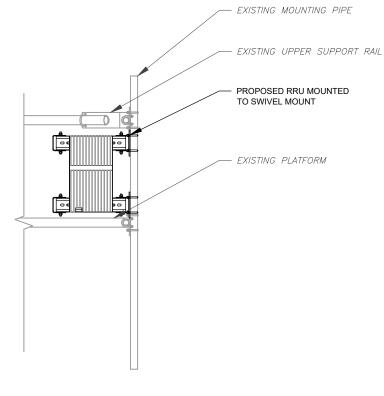



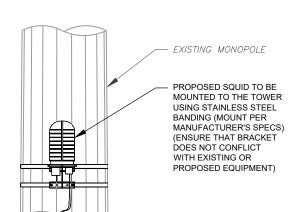

PROPOSED SQUID MOUNTING SCALE: NOT TO SCALE





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REV.	DESCRIPTION	BY	DATE
<u></u>	FOR CONSTRUCTION	_ ZDS	05/26/20
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ATC SITE NUMBER:

302506

ATC SITE NAME:

WINCHESTER CT 3

SITE ADDRESS: 15 OAKDALE AVENUE WINSTED, CT 06098-1862






		DATE DRAWN:	05/26/20
		ATC JOB NO:	302506
		CUSTOMER ID:	13201995
		CUSTOMER #:	20-10208


CONSTRUCTION **DETAILS**


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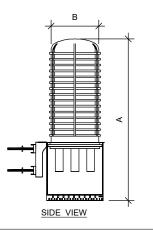
C-501

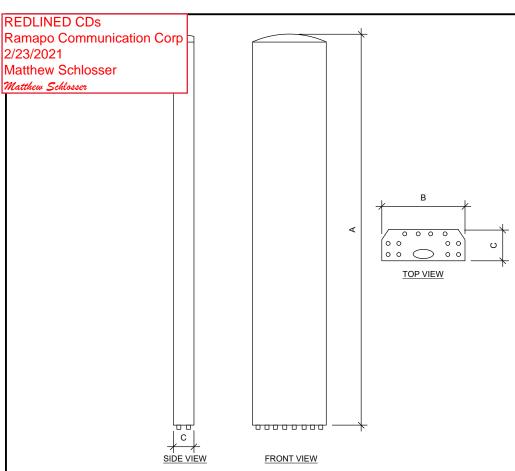


ANTENNA SPECIFICATIONS				
ANTENNA MODEL	А	В	С	WEIGHT (LBS)
CCI OPA65R-BU6BA	71.1"	11.7"	8.4"	55




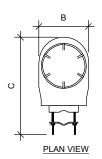

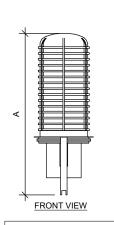

RAYCAP SPECIFICATIONS				
RAYCAP MODEL	А	В	С	WEIGHT (LBS)
DC6-48-60-18-8F	31.41"	10.24"	18.28"	16.0

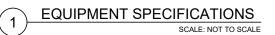

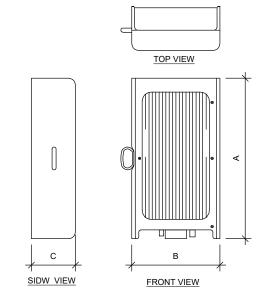

RRU SPECIFICATIONS				
RRU MODEL	А	В	С	WEIGHT (LBS)
RRUS-E2 B29	20.4"	18.5"	7.5"	60.0
RRUS-8843 B2/B66A	18.0"	13.2"	11.3"	75.0
RRUS-4449 B5/B12	17.9"	13.2"	9.4"	71.0





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158 BUSINESS CENTER DRIVE
BIRMINGHAM, AL 35244
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REV.	DESCRIPTION	BY	DATE
△_	FOR CONSTRUCTION	ZDS	05/26/20
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ATC SITE NUMBER:

302506

ATC SITE NAME:

WINCHESTER CT 3

SITE ADDRESS: 15 OAKDALE AVENUE WINSTED, CT 06098-1862






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П	DATE DRAWN:	05/26/20
П	ATC JOB NO:	302506
П	CUSTOMER ID:	13201995
П	CUSTOMER #:	20-10208

EQUIPMENT SPECIFICATIONS

SHEET NUMBER:


C-502

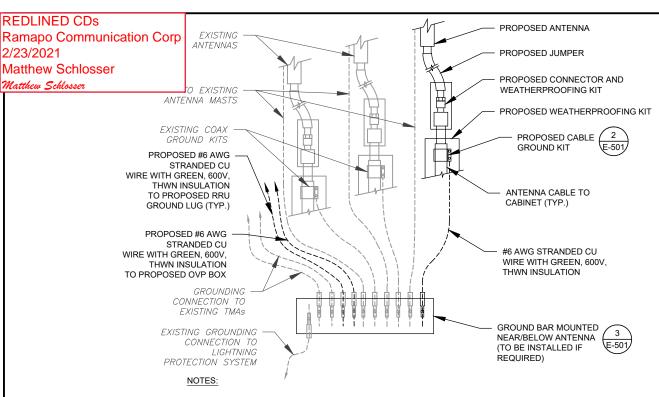

- THIS DETAIL IS INTENDED TO SHOW THE GENERAL GROUNDING REQUIREMENTS. SLIGHT ADJUSTMENTS MAY BE REQUIRED BASED ON EXISTING SITE CONDITIONS. THE CONTRACTOR SHALL MAKE FIELD ADJUSTMENTS AS NEEDED AND INFORM THE CONSTRUCTION MANAGER OF ANY CONFLICTS.
- SITE GROUNDING SHALL COMPLY WITH AT&T MOBILITY GROUNDING STANDARDS, LATEST EDITION, AND COMPLY WITH AT&T MOBILITY GROUNDING CHECKLIST, LATEST VERSION. WHEN NATIONAL AND LOCAL GROUNDING CODES ARE MORE STRINGENT THEY SHALL GOVERN



SCALE: N.T.S.

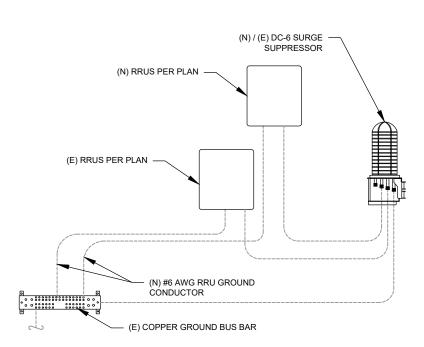

RRU GROUNDING

ANTENNA CABLE 2 1/2"Ø MAX

GROUNDING KIT PER CABLE
MANUFACTURER'S RECOMMENDATIONS
(ANDREW OR APPROVED EQUAL)

#6 AWG STRANDED COPPER GROUND
WIRE (GROUNDED TO GROUND BAR)

TO GROUND BAR

TO EQUIPMENT

GROUND KIT NOTES:


1. DO NOT INSTALL CABLE GROUND KIT AT A BEND AND ALWAYS DIRECT
GROUND WIRE DOWN TO GROUND BAR.

2. CONTRACTOR SHALL PROVIDE WEATHERPROOFING KIT (ANDREW PART

CABLE GROUND KIT CONNECTION DETAIL

NUMBER 221213) AND INSTALL/TAPE PER MANUFACTURER'S SPECIFICATIONS.

SCALE: N.T.S

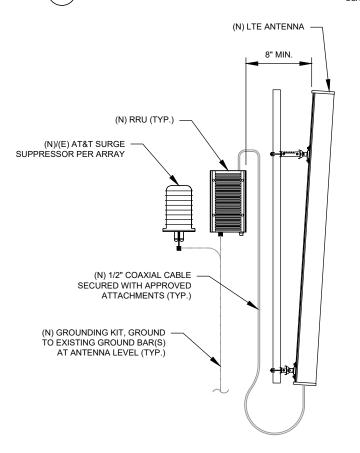

TO ANTENNA

0

4 ANTENNA/RRU GROUNDING
SCALE: N.T.S.





TOGETHER PLANNING A BETTER TOMORROW 158 BUSINESS CENTER DRIVE BIRMINGHAM. AL 35244

TEL: 205-252-6985 FAX: 205-320-1504

REV.	DESCRIPTION	BY	DATE
<u></u>	FOR CONSTRUCTION	ZDS	05/26/20
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ATC SITE NUMBER:

302506

ATC SITE NAME:

WINCHESTER CT 3

SITE ADDRESS: 15 OAKDALE AVENUE WINSTED, CT 06098-1862

SEA





 DATE DRAWN:
 05/26/20

 ATC JOB NO:
 302506

 CUSTOMER ID:
 13201995

 CUSTOMER #:
 20-10208

GROUNDING DETAILS

SHEET NUMBER:

E-501

0



Antenna Mount Analysis Report

ATC Site Name : Winchester CT 3, CT

ATC Site Number : 302506

Engineering Number : 13201995_C8_01

Mount Elevation : 184 ft

Carrier : AT&T Mobility

Carrier Site Name : MRCTB045239

Carrier Site Number : CTL01071

Site Location : 15 Oakdale Avenue

Winsted, CT 06098-1862 41.92169444, -73.0495


County : Litchfield

Date : May 1, 2020

Max Usage : 76%

Result : Contingent Pass

Prepared By: Rohith Koduru Structural Engineer Reviewed By:

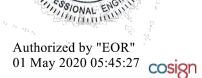

COA: PEC.0001553

A.T. Engineering Service, PLLC - 3500 Regency Parkway, Suite 100 - Cary, NC 27518 - 919.468.0112 Office - 919.466.5414 Fax - www.americantower.com



Eng. Number 13201995_C8_01 May 1, 2020 Page 1

Introduction

The purpose of this report is to summarize results of the antenna mount analysis performed for AT&T Mobility at 184 ft.

Supporting Documents

Mount Mapping	Mastec Project #10035017, dated April 16, 2020
Radio Frequency Data Sheet	RFDS ID #10035017, dated March 5, 2020
Reference Photos	Site photos from 2020

<u>Analysis</u>

This antenna mount was analyzed using American Tower Corporation's Mount Analysis Program and RISA-3D

Basic Wind Speed:	124 mph (3-Second Gust)
Basic Wind Speed w/ Ice:	50 mph (3-Second Gust) w/ 1" radial ice concurrent
Codes:	ANSI/TIA-222-H
Exposure Category:	В
Risk Category:	III
Topographic Factor Procedure:	Method 1
Topographic Category:	1
Spectral Response:	Ss = 0.169, S1 = 0.054
Site Class:	D - Stiff Soil
Live Loads: *	Lm = 500 lbs

^{*} Based on experience it has been determined that the maintenance load cases do not control over rigging load cases in platform mount analyses. Therefore, these load cases have been excluded from this analysis.

Conclusion

Based on the analysis results, the antenna mount does not meet the requirements per the applicable codes listed above. The mount can support the equipment as described in this report after the below listed modifications are completed:

• Install Site Pro 1 HRK-12 handrail kit 36" above the platform.

If you have any questions or require additional information, please contact American Tower via email at Engineering@americantower.com. Please include the American Tower site name, site number, and engineering number in the subject line for any questions.

A.T. Engineering Service, PLLC - 3500 Regency Parkway, Suite 100 - Cary, NC 27518 - 919.468.0112 Office - 919.466.5414 Fax - www.americantower.com

NOTE: THIS SHEET WAS CREATED BY OTHERS AND PROVIDED AT THE REQUEST OF THE CUSTOMER WITHOUT EDIT. PLEASE REFERENCE THE MOUNT ANALYSIS REPORT FOR COMPLETE MOUNT ANALYSIS CALCULATIONS AND DETAILS. SUPPLEMENTAL PAGES INCLUDED IN THE CONSTRUCTION DRAWINGS ARE FOR REFERENCE ONLY. GENERAL CONTRACTOR IS TO VERIFY THEY HAVE THE MOST RECENT MOUNT ANALYSIS PRIOR TO CONSTRUCTION.





TOGETHER PLANNING A BETTER TOMORROW

158 BUSINESS CENTER DRIVE

BIRMINGHAM, AL 35244

TEL: 205-252-6985 FAX: 205-320-1504

REV.	DESCRIPTION	BY	DATE
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ATC SITE NUMBER:

302506


ATC SITE NAME:

WINCHESTER CT 3

SITE ADDRESS: 15 OAKDALE AVENUE WINSTED, CT 06098-1862

SEAL:



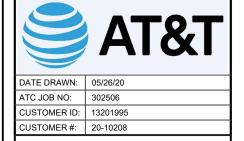

SUPPLEMENTAL

SUEET NI IMPE

R-602

REVISION:

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REDLINED CDs Ramapo Communication Corp am - Sector Diagram File Name - CT1071_ABC_Multicarrier_2.vsd 2/23/2021 CTV1071 WINSTED/WINCHESTER Site Name CONNECTICUT Market Cluster - NEW ENGLAND Matthew Schlosser ents: "Important Note: For detailed radio to antenna wiring refer to the latest field notice - Antenna_Radio Connection Drawings Playbook v6.0_Ericsson" Matthew Schlosser Antenna 1 Antenna 3 Antenna 4 LTE 700 DE / AWS LTE 700 BC / 850 / PCS / 5G 850 700 B14 / WCS / UMTS 850 Broadband Broadband Broadband Broadband **Broadband** Broadband Broadband Octo Octo Octo Octo Octo Octo Octo Octo Hex Low High High Low Low High Low High High 700 700/850 700/850 850 +45/-45 +45/-45 4Tx/4Rx 4Tx/4Rx 700/850 4Tx/4Rx 4Tx/4Rx +45/-45 +45/-45 4Tx/4Rx 4Tx/4Rx +45/-45 +45/-45 +45/-45 +45/-45 +45/-45 +45/-45 +45/-45 TEL: 205-252-6985 FAX: 205-320-1504 RET 一一一 LTE RRUS-4449 LTE RRUS-884 LTE RRUS-E2 700 (D/E) VO 011 011 10 1/0 Fiber/DC Demarcation Box (Squid) 3 Feet Minimum Separation between LTE Antennas 6 Feet Minimum Separation between 700BC & 700 DE DC Plant ANT A FU ANT B Decom OT OT 15 WO DO TM 84418442 FM3 TM 84618462 FM3 RU Note: B14 4478 Two Radios per site Busy sector will be on its own. UMTS 1st NodeB DB 5216 XMU 6630 Remaining sectors will share the radio. Section 16/17 is defining radio distribution ·IDLe PLUMBING DIAGRAM SCALE: NOT TO SCALE NOTE: THIS SHEET CREATED BY OTHERS AND PROVIDED





TOGETHER PLANNING A BETTER TOMORROW 158 BUSINESS CENTER DRIVE BIRMINGHAM, AL 35244

REV.	DESCRIPTION	BY	DATE
<u> </u>	FOR CONSTRUCTION	ZDS	05/26/20
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ATC SITE NUMBER:

302506

ATC SITE NAME:

WINCHESTER CT 3

SITE ADDRESS: 15 OAKDALE AVENUE WINSTED, CT 06098-1862





DATE DRAWN:	05/26/20
ATC JOB NO:	302506
CUSTOMER ID:	13201995
CUSTOMER #:	20-10208

SUPPLEMENTAL

SHEET NUMBER:

BY REQUEST OF CUSTOMER WITHOUT EDIT.

REVISION:

R-603

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