

Northeast Site Solutions Victoria Masse 420 Main Street #2, Sturbridge, MA 01566 860-306-2326 victoria@northeastsitesolutions.com

July 27, 2022

Members of the Siting Council Connecticut Siting Council Ten Franklin Square New Britain, CT 06051

RE: Notice of Exempt Modification

85 Plainfield Ave, West Haven, CT 06516

Latitude: 41.301275 Longitude: -72.976444

T-Mobile Site#: CTNH506A \_NHP

### Dear Ms. Bachman:

T-Mobile currently maintains nine (9) antennas at the 146-foot mount on the existing 149-foot monopole tower located at 85 Plainfield Ave in West Haven. The property is owned by Sprint/T-Mobile, C/O Crown Castle and the tower is owned by Crown Castle. T-Mobile now intends to add a 48Kw generator on a new 9'x4' concrete pad within the existing compound.

### Planned Modifications:

Ground work only-Install New:

- (1) GENERAC RD 48KW AC DIESEL GENERATOR 233-gallon double walled self-contained tank with fuel sensor. Requires two (2) 12-minute run cycles bi-weekly.
- (1) 9'x4' concrete pad



The facility was approved by the Connecticut Siting Council on February 19, 2009, Petition No 878. Please see attached.

Please accept this letter as notification pursuant to Regulations of Connecticut State Agencies §16-50j-73, for construction that constitutes an exempt modification pursuant to R.C.S.A. § 16-50j-72(b)(2). In accordance with R.C.S.A. § 16-50j-73, a copy of this letter is being sent to Nancy R. Rossi, Mayor, and Stephen Hotchkiss, Zoning Enforcement Officer/Inland Wetlands. A copy is also being sent to the tower owner and property owner.

The planned modifications to the facility fall squarely within those activities explicitly provided for in R.C.S;A. § 16-50j-72(b)(2).

- 1. The proposed modifications will not result in an increase in the height of the existing structure.
- 2. The proposed modifications will not require the extension of the site boundary.
- 3. The proposed modifications will not increase noise levels at the facility by six decibels or more, or to levels that exceed state and local criteria.
- 4. The operation of the replacement antennas will not increase radio frequency emissions at the facility to a level at or above the Federal Communications Commission safety standard.
- 5. The proposed modifications will not cause a change or alteration in the physical or environmental characteristics of the site.
- 6. The existing structure and its foundation can support the proposed loading.

For the foregoing reasons, T-Mobile respectfully submits that the proposed modifications to the above referenced telecommunications facility constitute an exempt modification under R.C.S.A. § 16-50j-72(b)(2).

### Sincerely,

Victoria Masse

Mobile: 860-306-2326 Fax: 413-521-0558

Office: 420 Main Street, Unit 2, Sturbridge MA 01566

Email: victoria@northeastsitesolutions.com



Attachments cc: Nancy R. Rossi, Mayor 355 Main Street West Haven, CT 06516

Stephen Hotchkiss, Zoning Enforcement Officer/Inland Wetlands 355 Main Street West Haven, CT 06516

Sprint/T-Mobile, C/O Crown Castle – as the property owner PMB 331 4017 Washington Road McMurray, PA 15317

Crown Castle - as the tower owner

# Exhibit A

# Petition No. 878 Pocket Communications 85 Plainfield Avenue, West Haven February 19, 2009 Staff Report

On December 15, 2008, the Connecticut Siting Council (Council) received a Petition (Petition) from Youghiogheny Communications-Northeast, LLC d/b/a Pocket Communications (Pocket) for a declaratory ruling that no Certificate of Environmental Compatibility and Public Need is required for the proposed modifications to an existing telecommunications facility located at 85 Plainfield Avenue, West Haven. Specifically, Pocket seeks to extend the 138-foot Crown Castle-owned monopole to 148 feet tall. Pocket would install three flush mounted panel antennas at the 146-foot level of the extended tower.

The total height with appurtenances would be approximately 151 feet tall. A Professional Engineer duly licensed in the State of Connecticut has certified that the tower is structurally adequate to support the proposed loading. The maximum worst case power density would be 32.1 percent of the applicable limit.

Pocket would also install a Nortel CDMA Micro BTS equipment cabinet on an H-frame to be located inside the existing fenced compound.

The site is in a wooded area. To the east is Plainfield Avenue and undeveloped land across the street. To the north and west is open (wooded) space. To the south is a parking lot, Maltby Avenue and a residential neighborhood. There are no wetlands at the site.

The tower is currently visible on portions of Plainfield Avenue, Maltby Street, and Timberland Drive. The tower extension is expected to visible from these areas as well. On January 9, 2009, Pocket submitted a notice to abutting property owners with a deadline for reply of January 23, 2009. To date, Pocket has received two inquiries about the project, but neither were opposed. No abutters have contacted the Council's office with any replies. No comments have been received by the City of West Haven either.

This Petition was field reviewed by Dr. Barbara Bell and Mike Perrone of the Council staff on January 12, 2009. Attorney Carrie Larson from Pullman and Comley, LLC (representing Pocket) and <a href="Eric Dahl"><u>Eric Dahl</u></a>, site acquisition specialist also attended the field review.

# Exhibit B

Map Block Lot

067-0005-0-CELL

Sketch

Building #

Section #

1 Account

00067597

## **Property Information**

Property Location	85 PLAINFIELD	85 PLAINFIELD AV			
Owner	SPRINT				
Co-Owner					
Mailing Address	PMB 331 4017 \	WASHINGTO	N RD		
Mailing Address	MCMURRAY	PA	15317		
Land Use	431V TE	L REL TW M	IDL-00		
Land Class	1				
Zoning Code					
Census Tract					

Street Index		
Acreage	0	
Utilities		
Lot Setting/Desc		
Additional Info		

# Photo No Photo Available



### **Primary Construction Details**

Year Built	0
Stories	
Building Style	UNKNOWN
Building Use	Vacant
Building Condition	
Occupancy	
Extra Fixtures	0
Bath Style	NA
Kitchen Style	NA
АС Туре	
Heating Type	
Heating Fuel	

Bedrooms	0	
Full Bathrooms	0	
Half Bathrooms	0	
Total Rooms	0	
Roof Style		
Roof Cover		
Interior Floors 1		
Interior Floors 2		
Exterior Walls		
Exterior Walls 2	NA	
Interior Walls		
Interior Walls 2	NA	

building Desc.	TEL REL TW
uilding Grade	NA
Ieat / AC	NA
rame Type	NA
aths / Plumbing	NA
eiling / Wall	NA
ooms / Prtns	NA
Vall Height	NA
irst Floor Use	NA

Property Listing Report

Map Block Lot

067-0005-0-CELL


Building #

Section #

1 Account

00067597

				T.			
Valuation Sum	Valuation Summary (Assessed value = 70% of Appraised Value)		Sub Areas				
Item	App	raised	Assessed	Subarea Ty	pe	Gross Area (sq ft)	Living Area (sq ft)
Buildings	0		0				
Extras	0		0				
Improvements							
Outbuildings	453600		317520				
Land	0		0				
Total	453600		317520				
Outbuilding ar	nd Extra F	eatures					
Туре		Descriptio	n				
TOWER		2 SITES					
CELL SHED		360 S.F.					
FENCE-8' CHAIN		400 L.F.					
<u></u>							
				Total Area			0
Sales History						•	
Owner of Record				Book/ Page	Sale Date	Sale P	rice
SPRINT				0000/0000	2010-10-	01 0	
SPRINT				0000/0000	2010-10-	01 0	

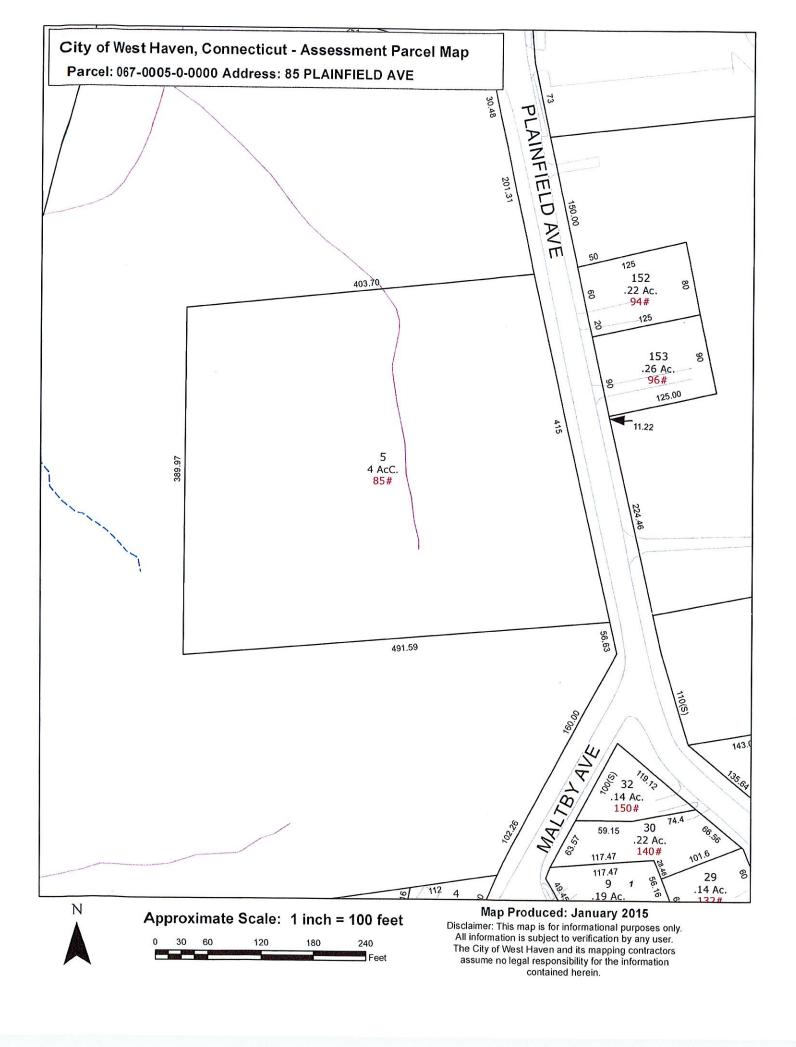

# Exhibit C

# T--Mobile

# T-MOBILE NORTHEAST LLC

# **UPGRADE:**

GENERATOR ADD

# LOCATION MAP CTNH506A

### APPLICABLE CODES/REFERENCE DOCUMENTS

ALL WORK SHALL BE PERFORMED AND MATERIALS INSTALLED IN ACCORDANCE WITH THE CURRENT EDITIONS OF THE FOLLOWING CODES AS ADOPTED BY THE LOCAL GOVERNING AUTHORITIES. NOTHING IN THESE PLANS IS TO BE CONSTRUED TO PERMIT WORK NOT CONFORMING TO THESE CODES:

MECHANICAL 2015 IMC ELECTRICAL. 2015 NEC



### **GENERAL NOTES**

OCCUPANCY CLASSIFICATION:

TYPE OF CONSTRUCTION:

A.D.A. COMPLIANCE: FACILITY IS UNMANNED AND NOT FOR HUMAN HABITATION

PLUMBING REQUIREMENTS: FACILITY HAS NO SANITARY OR POTABLE WATER.

# **SITE NAME:**

CROWN WEST HAVEN MONOPOLE

# **SITE NUMBER:**

CTNH506A

# **SITE ADDRESS:**

85 PLAINFIELD AVE WEST HAVEN, CT 06516

### SCOPE OF WORK

### SCOPE OF WORK:

- INSTALL (1) NEW 9'-0" x 4'-0" CONCRETE PAD
- INSTALL (1) NEW 48KW GENERATOR
- INSTALL (1) NEW ATS
- INSTALL (1) NEW H-FRAME

# PROJECT INFORMATION

SITE ADDRESS: 85 PLAINFIELD AVE WEST HAVEN, CT 06516

COUNTY NEW HAVEN

JURISDICTION: TOWN OF WINDHAM

LATITUDE: 41° 18' 04.6" N

LONGITUDE: -72° 58' 35.2" W

PARCEL/APN # UNKNOWN

ZONING

GROUND ELEVATION:

UNKNOWN

TOWER TYPE: MONOPOLE

149'-6" TOWER HEIGHT

PROPERTY OWNER: UNKNOWN UNKNOWN

UNKNOWN

APPLICANT: T-MOBILE 35 GRIFFIN ROAD

BLOOMFIELD, CT 06002

ENGINEER:

TRYLON TSF 1825 W. WALNUT HILL LANE, SUITE 302

UNKNOWN

IRVING, TX 75038 MIKE MOORE CONTACT:

MIKE.MOORE@TRYLON.COM FMAII:

PROJECT MANAGER: NORTHEAST SITE SOLUTIONS

420 MAIN STREET, BLDG 4

STURBRIDGE, MA 01566 CONTACT: FRIC PROLILY

EMAIL: EPROULX@NORTHEASTSITESOLUTIONS.COM

# **APPROVALS**

T-MOBILE CONSTRUCTION MANAGER

T-MOBILE RF ENGINEER

LAND USE PLANNER

NETWORK OPERATION

PROPERTY OWNER

CONTRACTOR

SHEET #	DESCRIPTION	REVISION #
T-1	TITLE SHEET	1
T-2	GENERAL NOTES	1
C-1.1	OVERALL SITE PLAN	1
C-1.2	EXISTING PLAN	1
C-1.3	PROPOSED PLAN	1
C-2	GENERATOR SPECS	1
S-1	DETAIL	1
C-4	CONCRETE PAD SPEC	1
E-1	AC PANEL SCHEDULES & ONE LINE DIAGRAM	1
G-1	GROUNDING DETAILS	1

**SHEET INDEX** 



35 GRIFFIN ROAD BLOOMFIELD, CT 06002






T-MOBILE SITE NUMBER: CTNH506A

85 PLAINFIELD AVE WEST HAVEN, CT 06516

EXISTING 149'-6" MONOPOLE

ISSUED FOR:						
REV	DATE	DRWN	DESCRIPTION	DES./QA		
Α	06/22/2022	YOG	PRELIMINARY			
0	07/11/2022	CP	ISSUE FOR CONSTRUCTION			
1	07/11/2022	CP	REV. AS PER CLIÉNT'S REOUEST			

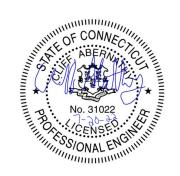

IT IS A VIOLATION OF LAW FOR ANY PERSON, UNLESS THEY ARE ACTING UNDER THE DIRECTION OF A LICENSED PROFESSIONAL ENGINEER, TO ALTER THIS DOCUMENT.

SHEET NUMBER:

SHOWN IN BOTH, THE MORE STRINGENT REQUIREMENTS SHALL APPLY.
2. THE INTENTION OF THE DOCUMENT IS TO INCLUDE ALL LABOR
AND MATERIALS REASONABLY NECESSARY FOR THE PROPER EXECUTION

OR DOING ANY WORK, NO EXTRA CHARGE OR COMPENSATION WILL BE ALLOWED DUE TO DIFFERENCES BETWEEN ACTUAL DIMENSIONS OR DIMENSIONS SHOWN ON PLANS SUBMIT NOTICE OF ANY DISCREPANCY IN

1. KEEP THE SITE FREE FROM ACCUMULATION OF WASTE AND RUBBISH CAUSED BY EMPLOYEES AT THE COMPLETION OF THE WORK, REMOVE ALL WASTE AND NON-CONSTRUCTION MATERIAL INCLUDING ALL CONTRAC

### A CODES

AUTHORITIES WITH JURISDICTION OVER THE SALTIER. THIS RESPONSIBILITY IS IN EFFECT REGARDLESS OF WEATHER THE LAW, ORDINANCE,

LICENSE FOR THE LOCATION IN WHICH THE WORK IS TO BE PERFORMED

I. FOLLOW ALL APPLICABLE RULES AND REGULATIONS OF THE WITH TOWER CONSTRUCTION AND SAFETY, EXCAVATION AND TRENCHING, AND WORK IN CONFINED SPACES ENSURE THAT EMPLOYEES AND

1 PROVIDE PHOTOGRAPHIC EVIDENCE OF ALL FOUNDATION

CONTRACTOR WILL SUBMIT CONSTRUCTION DOCUMENTS TO THE JURISDICTIONAL AUTHORITY FOR PLAN CHECK AND REVIEW. CONTRACTOR WILL SUBMIT LICENSING AND WORKMAN'S COMPENSATION INFORMATION TO THE JURISDICTION AS REQUIRED TO OBTAIN THE BUILDING PERMIT, CONTRACTOR SHALL COORDINATE AND SCHEDULE REQUIRED INSPECTIONS AND POST REQUIRED PERMITS AT THE JOB SITE COMPLY WITH SPECIFIC PROJECT RELATED REQUESTS AND SUGGESTIONS MADE BY BUILDING THAT MAY BE BEYOND THE SCOPE OF THE CONTRACT OR DEVIATE FROM THE CONSTRUCTION DOCUMENT. T-MOBILE WILL REIMBURSE THE CONTRACTOR FEES FOR PLAN REVIEW, BUILDING PERMIT, CONNECTIONS

. CONTRACTOR WILL SUBMIT ALL ZONING AND CONDITIONAL USE THE SITE RELATED TO CONSTRUCTION, SUCH AS NOISE REGULATIONS, HOURS OF WORK, ACCESS LIMITATIONS, ETC. THE CONSTRUCTION MANAGER WILL INFORM THE CONTRACTOR OF THESE REQUIREMENTS AT THE PRE-BID MEETING OR AS SHOWN IN THE CONSTRUCTION DOCUMENTS.

PERMANENTLY WITHIN 24 HOURS OF ERECTION, DO NOT ALLOW THE GATE ACCESSING THE TOWER AREA TO REMAIN OPEN OR UNATTENDED ANY TIME

CONTRACTOR AT NO EXPENSE TO THIMOBILE.

2. THE CONTRACTOR IS TO MAINTAIN ADEQUATE DRAINAGE AT ALL TIMES. DO NOT ALLOW WATER TO STAND OR POND. ANY DAMAGE TO STRUCTURES OR WORK ON THE SITE CAUSED BY INADEQUATE MAINTENANCE OF DRAINAGE PROVISIONS WILL BE THE RESPONSIBILITY OF THE CONTRACTOR AND ANY COST ASSOCIATED WITH REPAIRS FOR SUCH DAMAGE WILL BE AT THE CONTRACTOR'S EXPENSE

3. ALL WASTE MATERIAL SHALL BE PROPERLY DISPOSED OF OFF-SITE OR AS DIRECTED BY CONSTRUCTION MANAGER AND IN ACCORDANCE WITH

### M. LIVESTOCK PROTECTION

A. SCOPE OF WORK INCLUDES

MATERIALS WHICH MIGHT BE DAMAGED BY CONSTRUCTION ACTIVITIES

RUBBISH, DESIGNATED TREES AND SITE IMPROVEMENTS. 4. TOPSOIL STRIPPING AND STOCKPILING.

RE-INSTALLATION OF EXISTING FENCE AND OTHER SITE IMPROVEMENTS

A. SCOPE OF WORK INCLUDES

WALKWAYS WILL OBTAIN A 95% COMPACTION AT A MINIMUM DRY DENSITY

. LAWNS, UNPAVED AREAS AND WALKS PLUS OR MINUS 1

B. UNDER PAVEMENTS PLUS OR MINUS \$\frac{1}{2}\$ INCH.

3. GRADING TOLERANCES FOR FILL UNDER CONCRETE APPLICATIONS

A. PLUS OR MINUS 1 INCH MEASURED WITH 10 FOOT STRAIGHT

MANAGER OR AS NOTED IN CONSTRUCTION DOCUMENTS) 1. SUB-BASE MATERIAL: GRADED MIXTURE OF NATURAL OR CRUSHED GRAVEL, CRUSHED STONE OR SLAG, AND NATURAL SAND.

2. WASHED MATERIAL, EVENLY GRADED MIXTURE OF CRUSHED STONE OR GRAVEL WITH 95% PASSING A 1-1/2 INCH SIEVE

3. GRADING MATERIAL WILL CONSIST OF SATISFACTORY NATIVE OR IMPORTED SOIL MATERIALS FREE OF CLAY, ROCK OR GRAVEL NOT LARGER THAN 2 INCHES IN ANY DIMENSION, DEBRIS, WASTE, FROZEN MATERIALS AND OTHER UNSUITABLE MATERIALS WILL NOT BE ALLOWED FOR US

GRAVEL MATERIAL: EVENLY GRADED MIXTURE OF CRUSHED STONE OR GRAVEL WITH 95% PASSING A 1-1/2 INCH SIEVE.

THAT WILL UNDERLAY GRAVEL, PAVEMENT, NEW STRUCTURES OR EMBANKMENTS. STOCKPILE STRIPPING ON—SITE FOR RE—USE AND FINAL

CONSTRUCT EMBANKMENT FROM ON-SITE EXCAVATION MATERIAL WHEN

THE LAYERS MAY BE REQUIRED. SUCH OPERATIONS SHALL BE INCLUDED IN THE APPROPRIATE BID ITEM. SHOULD THE MATERIAL BE TOO WET TO PERMIT PROPER COMPACTION, IT IS THE CONTRACTOR'S RESPONSIBILITY TO UTILIZE MATERIAL WITH AN ACCEPTABLE MOISTURE CONTENT

EMBANKMENTS AND THE REPLACEMENT OF ANY PORTION WHICH HAS

8. ROUTE EQUIPMENT BOTH LOADED AND EMPTY, OVER THE FULL WIDTH OF THE EMBANKMENT TO ENSURE UNIFORMITY OF MATERIAL PLACEMENT. 9. COMPACT EMBANKMENT UNDERLYING NEW GRAVEL PAVING, FLOOR LABS AND STRUCTURES TO BE 95% COMPACTION AT A MINIMUM DRY DENSITY AS DETERMINED BY ASTM 0-1557 OR WITHIN PLUS OR MINUS 3% OF OPTIMUM MOISTURE CONTENT. COMPACT NON-STRUCTURAL AREA

COMPACT AREAS OF UNDERLYING NEW GRAVEL, PAVING, FLOOR SLABS AND STRUCTURES TO BE AT 95% COMPACTION AT A MAXIMUM DRY DENSITY AS DETERMINED BY THE ASTM 0-1557 OR WITHIN PLUS OR CONSTRUCT FINISH SURFACE OF SITE GRADING AREAS WITHIN 1 INCH

1. SHAPE TOP OF SUBGRADE TO THE LINES AND GRADES SHOWN ON

COMPACT THE TOP 12 INCHES OF SUBGRADE TO A 95% COMPACTION AT A MAXIMUM DRY DENSITY AS DETERMINED BY ASTM 0-1557 OR WITHIN PLUS OR MINUS 3% OF THE OPTIMUM MOISTURE CONTENT.
5. CONSTRUCT TOP OF SUBGRADE WITHIN 1 INCH OF ESTABLISHED

COMPOUND AREA AND UNDER LENGTH OF ROAD (WHEN REQUIRED). LAP

1. FURNISH, INSTALL AND MAINTAIN LANDSCAPE WORK AS SHOWN

### M. CONCRETE FORM WORK

RECEIVE A  $\frac{3}{4}$  INCH BY  $\frac{3}{4}$  INCH 45 DEGREE CHAMFER. OTHER EXPOSED EDGES SHALL RECEIVE A TOOLED RADIUS FINISH.

### 4. GENERAL NOTES

SHEETS AND SPECIFICATIONS AND COORDINATE HIS WORK WITH THE WORK OF ALL OTHER CONTRACTORS TO ENSURE THAT WORK

AND ORDERLY SITE, YARD AND GROUNDS. CONTRACTOR SHALL REMOVE AND DISPOSE OFF SITE ALL RUBBISH, WASTE MATERIAL, LITTER AND ALL FOREIGN SUBSTANCES. REMOVE PETROCHEMICAL

THE PLANS SHOW SOME KNOWN SUBSURFACE STRUCTURE ABOVE THE LOCATION INDICATED. IN PARTICULAR THE CONTRACTOR IS WARNED THAT THE EXACT OR EVEN APPROXIMATE LOCATION OF SHALL BE HIS RESPONSIBILITY TO PROCEED WITH GREAT CARE IN 48 HOURS BEFORE YOU DIG, DRILL OR BLAST CALL LOCAL UTILITIES LOCATOR COMPANY.

WRITING OF ANY CONDITIONS THAT VARY FROM THOSE SHOWN OF THE PLANS. THE CONTRACTOR'S WORK SHALL NOT VARY FROM THE PLANS WITHOUT THE EXPRESSED APPROVAL OF THE OWNER

OR THE OWNER'S REPRESENTATIVE.
THE CONTRACTOR IS INSTRUCTED TO COOPERATE WITH ANY AND ALL OTHER CONTRACTORS PERFORMING WORK ON THE SITE

THE CONTRACTOR SHALL COMPLY WITH ALL REQUIRED PERMITS.
THE CONTRACTOR SHALL PROTECT EXISTING PROPERTY LINE

DESTROYED, AS JUDGED BY THE OWNER OR OWNER'S

REGULATIONS FOR CONSTRUCTION.

10. CONTRACTOR SHALL BE RESPONSIBLE FOR DEWATERING AND THE MAINTENANCE OF SURFACE DRAINAGE DURING THE COURSE OF

11. ALL UTILITY WORK INVOLVING CONNECTIONS TO EXISTING SYSTEMS SHALL BE COORDINATED WITH THE OWNER OR OWNER'S REPRESENTATIVE BEFORE EACH AND EVERY CONNECTION TO

12. MAINTAIN FLOW FOR ALL EXISTING UTILITIES
13. ALL SITE FILL SHALL MEET SELECTED FILL STANDARDS AS

14. CONTRACTOR TO GRADE ALL AREAS OF THE SITE TO PROVIDE

AND REGRADING ROADWAY AND ANY DISTURBED AREAS FOLLOWING

17. WATER AND SEWER SERVICES ARE NOT REQUIRED FOR THE

### SITE LEGENDS

— CENTERLINE ----- GROUND CONDUCTOR ----- A----- COAXIAL CABLE ----X---- CHAIN LINK FENCING ---- E ----- POWER RUN F/P FIBER/POWER RUN T/E POWER/TELCO RUN ---- GROUNDING CONDUCTOR ----- SPARK ZONE AND WORKING CLEARANCE

### SYMBOLS & MATERIAL



DETAIL REFERENCE



ELEVATION REFERENCE



SECTION REFERENCE

# T··Mobile··· T-MOBILE NORTHEAST LLC

35 GRIFFIN ROAD BLOOMFIELD, CT 06002






### T-MOBILE SITE NUMBER: CTNH506A

85 PLAINFIELD AVE WEST HAVEN, CT 06516

EXISTING 149'-6" MONOPOLE


	ISSUED FOR:						
REV	DATE	DRWN	DESCRIPTION	DES./QA			
Α	06/22/2022	YOG	PRELIMINARY				
0	07/11/2022	CP	ISSUE FOR CONSTRUCTION REV. AS PER CLIENT'S				
1	07/11/2022	CP	REV. AS PER CLIENT'S REOUEST				
			· ·				

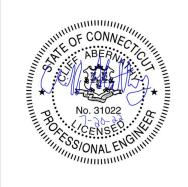

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SHEET NUMBER:

REVISION:

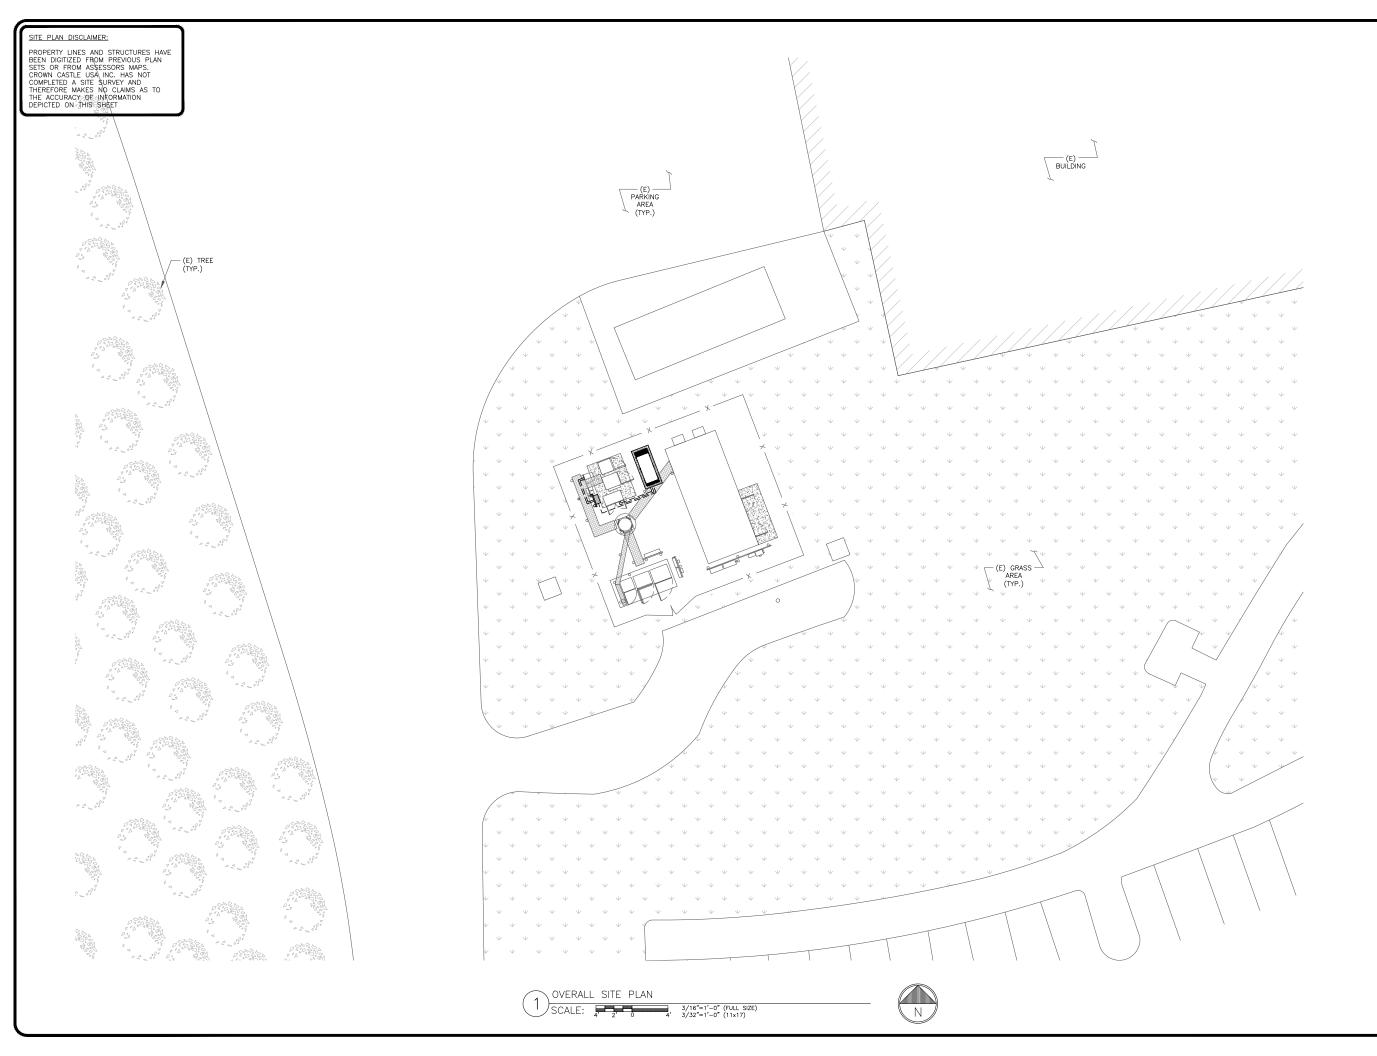

T--Mobile--T-MOBILE NORTHEAST LLC

35 GRIFFIN ROAD BLOOMFIELD, CT 06002





1825 W. WALNUT HILL LANE, SUITE 120 IRVING, TEXAS 75038

T-MOBILE SITE NUMBER: **CTNH506A** 

85 PLAINFIELD AVE WEST HAVEN, CT 06516

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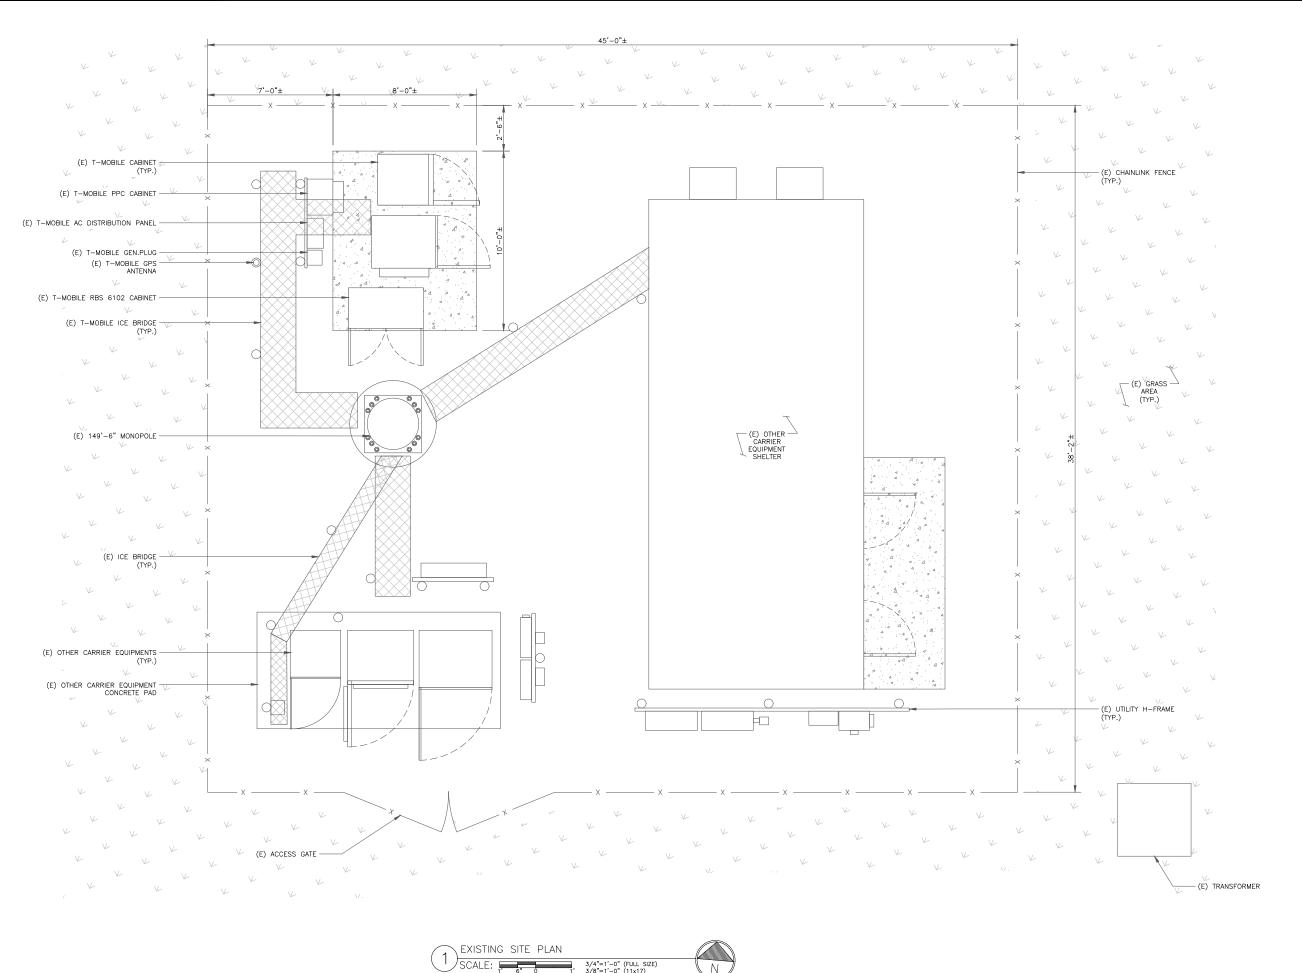


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SHEET NUMBER:

C-1.1

REVISION:



T-Mobile T-Mobile T-MOBILE NORTHEAST LLC

35 GRIFFIN ROAD
BLOOMFIELD, CT 06002






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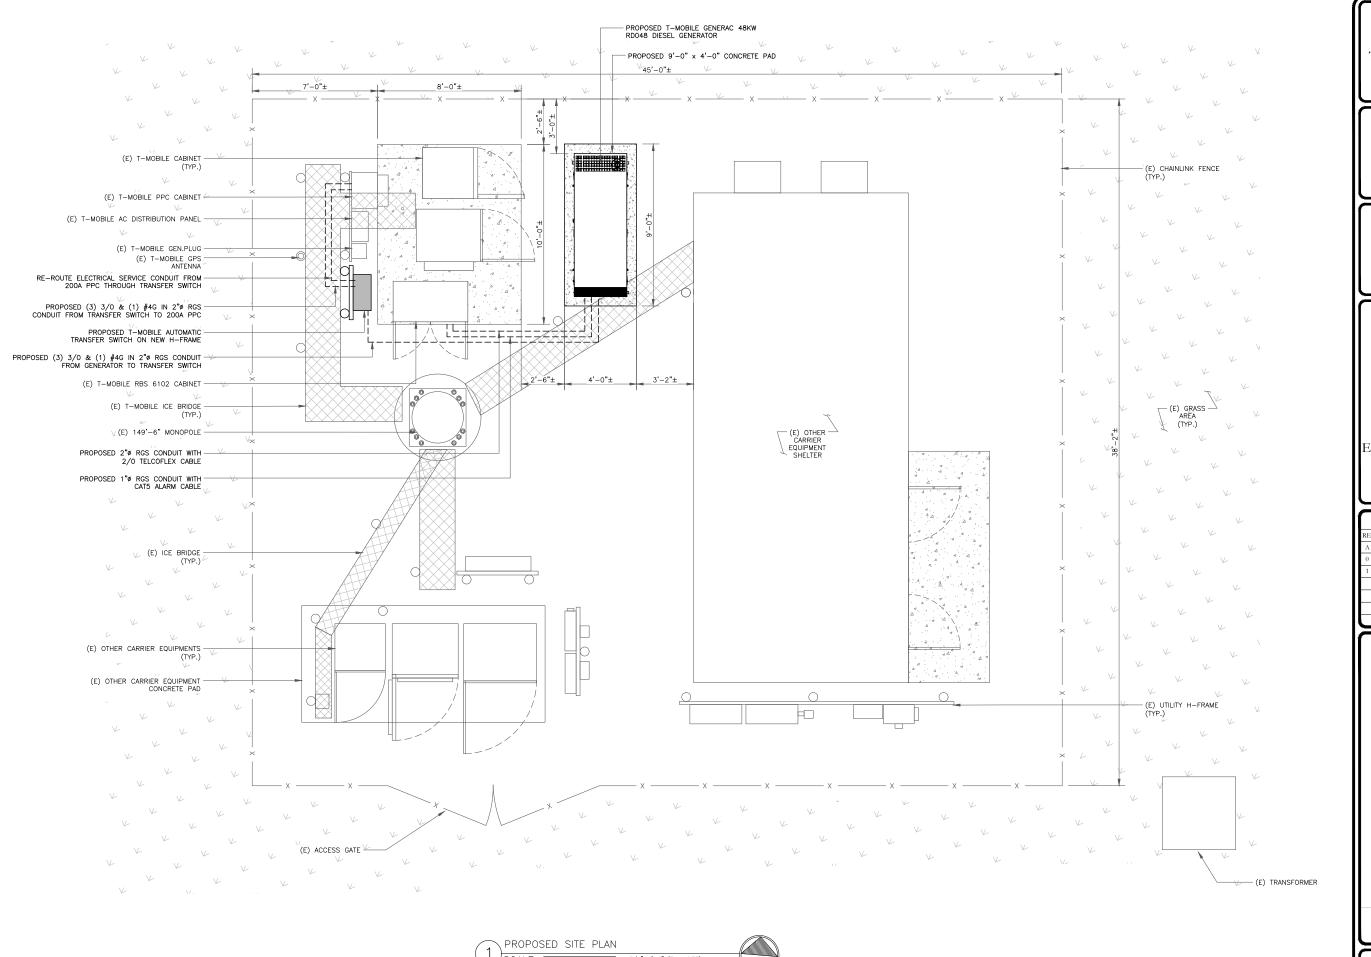


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SHEET NUMBER:

C-1.2

1

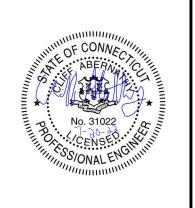

T-Mobile - T-MOBILE NORTHEAST LLC

35 GRIFFIN ROAD
BLOOMFIELD, CT 06002





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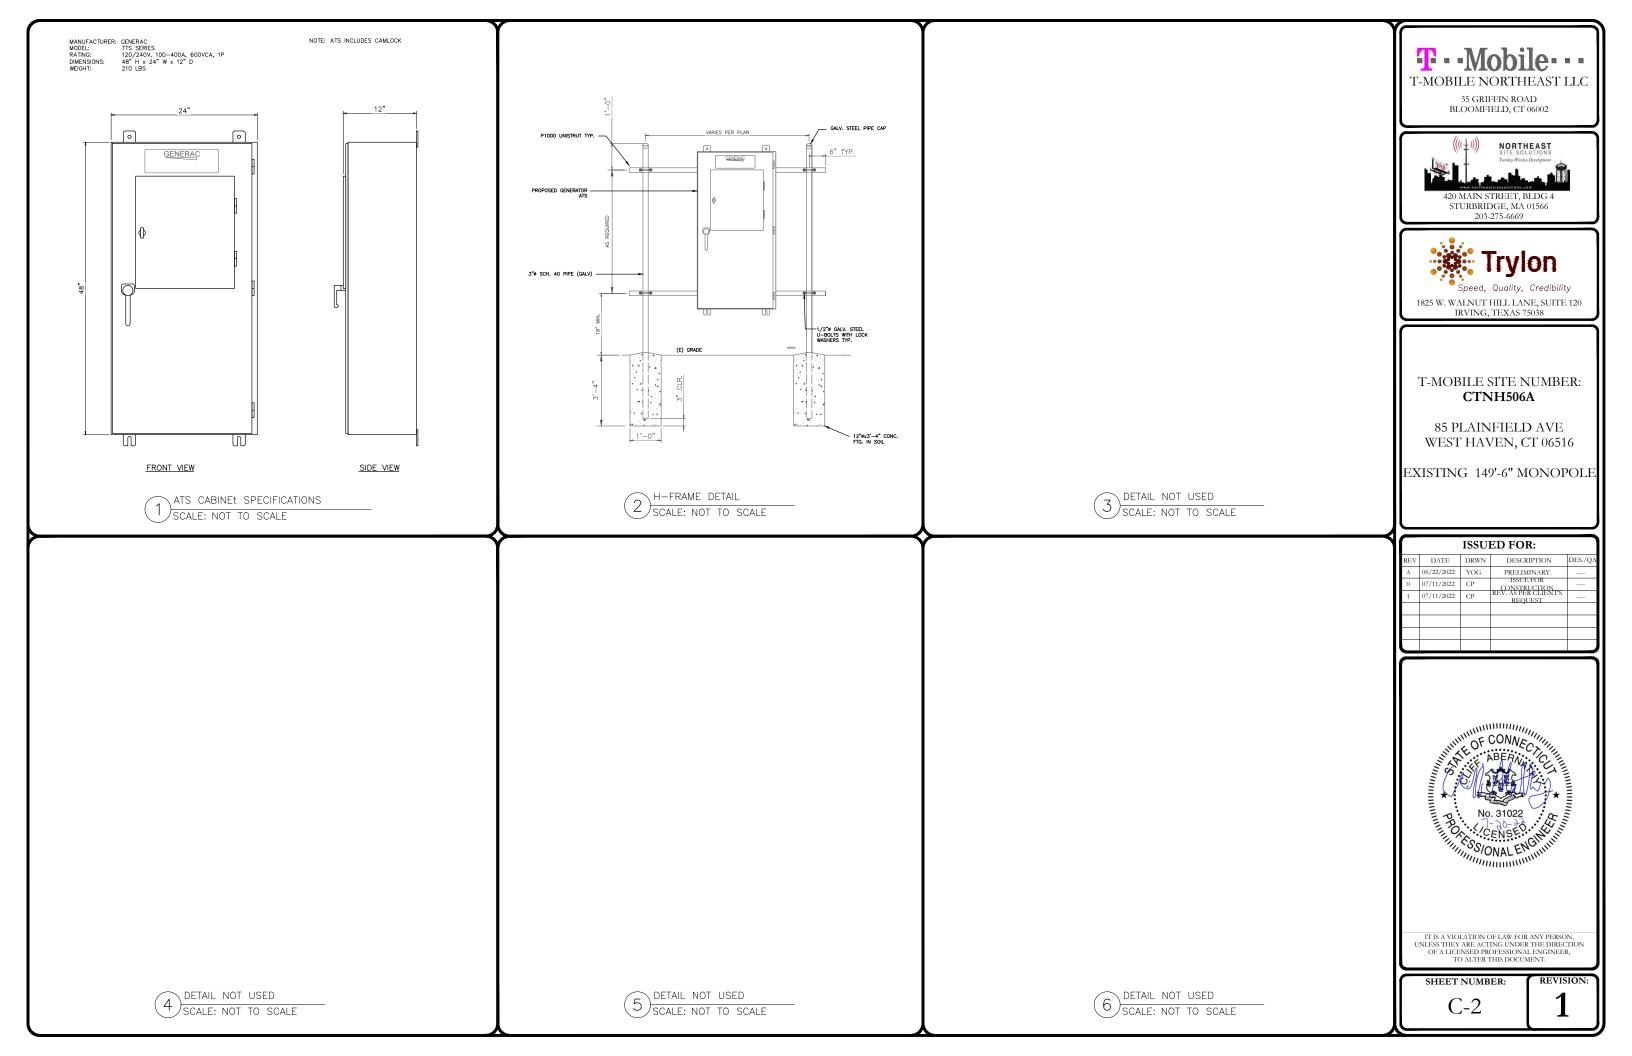


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SHEET NUMBER:

C-1.3

1



GENERAC' INDUSTRIAL

INDUSTRIAL DIESEL GENERATOR SET EPA Certified Stationary Emergency

Standby Power Rating 48 kW, 60 kVA, 60 Hz







### **Codes and Standards**

Not all codes and standards apply to all configurations. Contact factory for details.



UL2200, UL508, UL489, UL142



CSA 22.2





BS5514 and DIN 6271





NFPA 37, 70, 99



ISO 3046, 8528, 9001



NEMA ICS1, ICS10, MG1, 250, ICS6,



ANSI/IEEE C62.41

# **Powering Ahead**

For over 50 years, Generac has led the industry with innovative design and superior manufacturing.

Generac ensures superior quality by designing and manufacturing most of its generator components, including alternators, enclosures and base tanks, control systems and communications software.


Generac's gensets utilize a wide variety of options, configurations and arrangements, allowing us to meet the standby power needs of practically every application.

Generac searched globally to ensure the most reliable engines power our generators. We choose only engines that have already been proven in heavy-duty industrial application under adverse conditions.

Generac is committed to ensuring our customers' service support continues after their generator purchase.

RD048 | 3.4L | 48 kW INDUSTRIAL DIESEL GENERATOR SET **EPA Certified Stationary Emergency** 

### **DIMENSIONS AND WEIGHTS\***

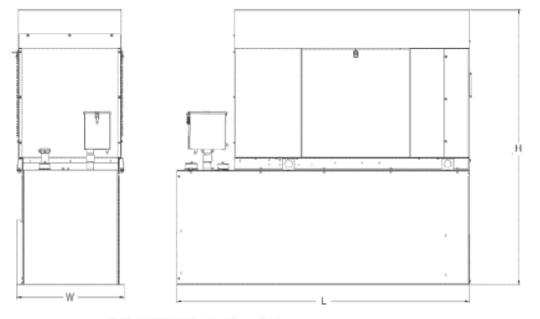

GENERAC INDUSTRIAL

### **ENCLOUSED UNIT with 48hour Tank**

L x W x H in (mm)	95.4 (2,422) x 35.0 (880) x 89.3 (2,269)
Sound output in dB(A) at 23ft with generator operating at normal Load	65








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SHEET NUMBER:

C-3

REVISION:


GENERATOR SPECIFICATIONS SCALE: NOT TO SCALE

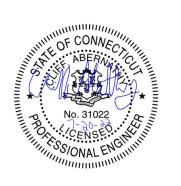
### NOTES:

- 1. ALL CONCRETE CONSTRUCTION SHALL MEET THE REQUIREMENTS OF THE AMERICAN CONCRETE INSTITUTE (ACI 318-14) BUILDING CODE REQUIREMENTS FOR REINFORCED CONCRETE AND (ACI 301) STANDARD SPECIFICATION FOR STRUCTURAL CONCRETE. ALL CONCRETE WORK SHALL BE IN ACCORDANCE WITH THE ACIW301, ACIW318, ASTM A184
- 2. MINIMUM ALLOWABLE CONCRETE COMPRESSIVE STRENGTH SHALL BE 2500 PSI AT 28 DAYS WHEN TESTED IN ACCORDANCE WITH THE
- ASTM C172, ASTM C31 AND ASTM C39 UNLESS OTHERWISE NOTED. REINFORCING STEEL SHALL CONFORM TO ASTM A615, GRADE 60, DEFORMED UNLESS NOTED OTHERWISE. WELDING WIRE FABRIC SHALL CONFORM TO ASTM A185 WELDED STEEL WIRE FABRIC UNLESS NOTED OTHERWISE. SPLICES SHALL BE CLASS "8" AND ALL HOOKS SHALL BE STANDARD, UNLESS NOTED OTHERWISE.

  DETAILING SHALL BE IN ACCORDANCE WITH MANUAL OF STANDARD
- PRACTICE OF DETAILING REINFORCED CONCRETE STRUCTURES (ACI
- AMERICAN SOCIETY FOR TESTING AND MATERIALS METHODS STANDARDS 5. CHAMFER ALL EXPOSED EDGES OF CONCRETE 3/4" IN ACCORDANCE
  - WITH ACI 301 SECTION 4.2.2. UNLESS OTHERWISE NOTED.
    REINFORCING STEEL SHALL BE ACCURATELY PLACED AND ADEQUATELY
    SECURED IN POSITION. LOCATION OF REINFORCEMENT SHALL BE
    INDICATED ON THE DRAWINGS. CONCRETE COVER SHALL DEPEND ON WHETHER CONCRETE IS PRE-CAST OR CAST IN PLACE.
  - TOP OF FOUNDATION TO HAVE A "BRUSH FINISH".


  - EXPOSED FINISHED SURFACE IS NOT TO HOLD WATER.
    ALL SURFACES ARE TO BE CLEANED OF ANY RESIDUAL CONCRETE FROM SPLASHING OR SPILLS.

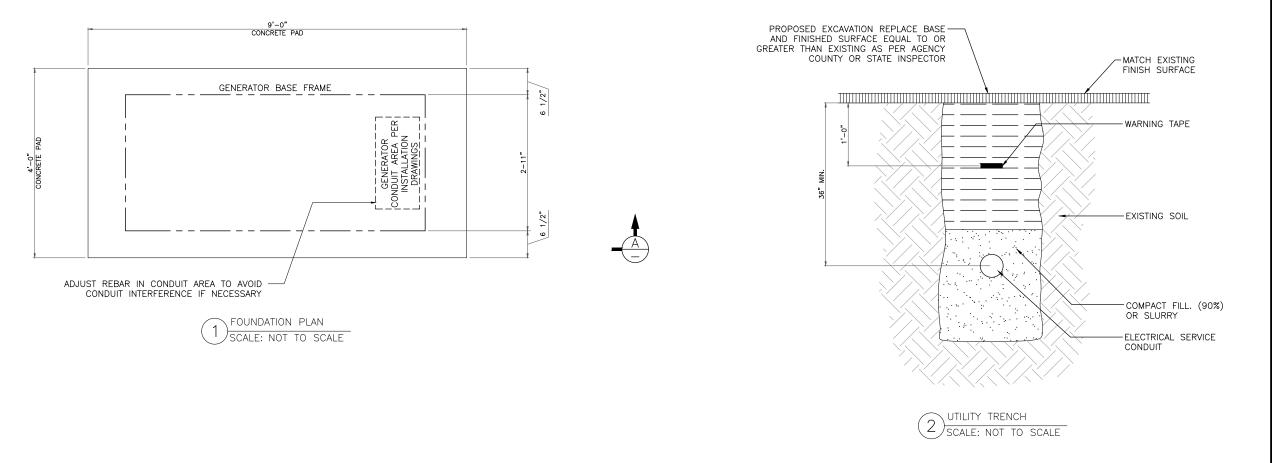

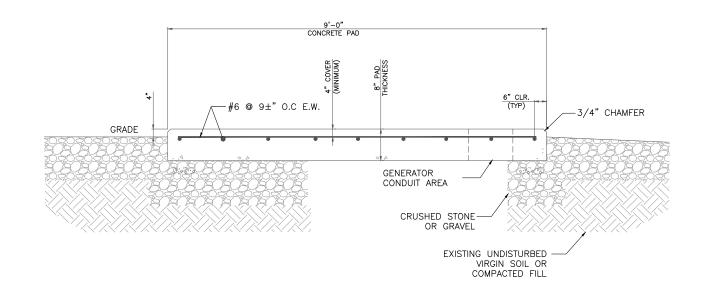

SECTION A-A

SCALE: 3

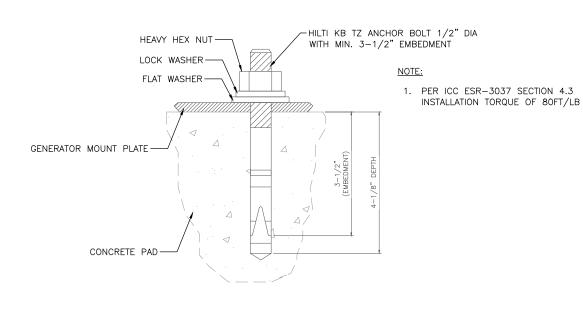

ANCHOR BOLT DETAIL 4) scale: not to scale

T··Mobile··· T-MOBILE NORTHEAST LLC 35 GRIFFIN ROAD BLOOMFIELD, CT 06002






T-MOBILE SITE NUMBER: CTNH506A

85 PLAINFIELD AVE WEST HAVEN, CT 06516

EXISTING 149'-6" MONOPOLE

	ISSUED FOR:			
REV	DATE	DRWN	DESCRIPTION	DES./QA
Α	06/22/2022	YOG	PRELIMINARY	
0	07/11/2022	CP	ISSUE FOR CONSTRUCTION	
1	07/11/2022	CP	REV. AS PER CLIENT'S REOUEST	

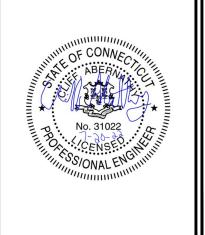


IT IS A VIOLATION OF LAW FOR ANY PERSON, UNLESS THEY ARE ACTING UNDER THE DIRECTION OF A LICENSED PROFESSIONAL ENGINEER, TO ALTER THIS DOCUMENT

SHEET NUMBER:

S-1

REVISION:

PENDING

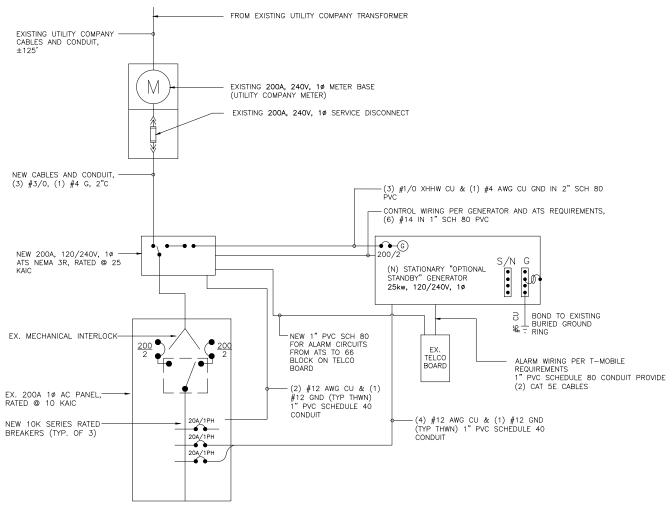





420 MAIN STREET, BLDG 4 STURBRIDGE, MA 01566 203-275-6669




T-MOBILE SITE NUMBER: CTNH506A

85 PLAINFIELD AVE WEST HAVEN, CT 06516

EXISTING 149'-6" MONOPOLE

	ISSUED FOR:			
REV	DATE	DRWN	DESCRIPTION	DES./QA
Α	06/22/2022	YOG	PRELIMINARY	
0	07/11/2022	CP	ISSUE FOR CONSTRUCTION	
1	07/11/2022	CP	REV. AS PER CLIENT'S REQUEST	
			,	

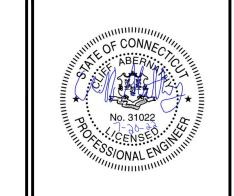



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SHEET NUMBER:

REVISION: E-1

ONE LINE DIAGRAM SCALE: NOT TO SCALE



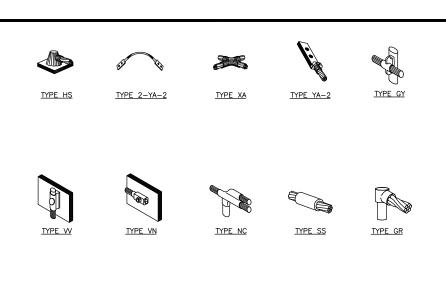


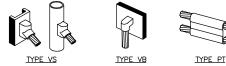- 1. ERICO EXOTHERMIC "MOLD TYPES" SHOWN HERE ARE EXAMPLES. CONSULT WITH CONSTRUCTION MANAGER FOR SPECIFIC
- MOLDS TO BE USED FOR THIS PROJECT.

  2. MOLD TYPE ONLY TO BE USED BELOW GRADE WHEN CONNECTING GROUND RING TO GROUND ROD.

### CADWELD GROUNDING CONNECTIONS SCALE: NOT TO SCALE

CONDUIT SCHEDULE		
DESCRIPTION		
1" CONDUIT W/PULLSTRINGS FOR ALARM CABLES (FROM GENERATOR TO BTS)		
2" CONDUIT W/PULLSTRING (FROM GENERATOR TO PPC FOR BLOCK HEATER/BATTERY CHARGER))		
2" CONDUIT W/ PULLSTRING (FROM ATS TO PPC, FOR POWER FEEDERS)		
2" CONDUIT W/ PULLSTRING (FROM GENERATOR TO ATS FOR EMERGENCY POWER FEEDERS)		
1" CONDUIT W/ PULLSTRING (FROM GENERATOR TO ATS, FOR CONTROL CABLE)		

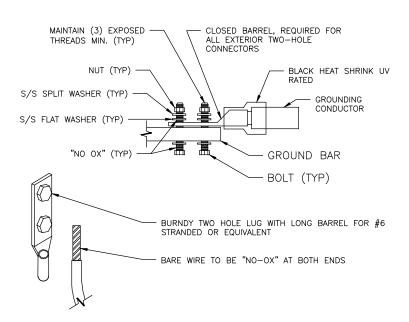

NOTES:

1. ALL HARDWARE SHALL BE 18–8
STAINLESS STEEL. COAT ALL SURFACES WITH
ANTIOXIDANT COMPOUND BEFORE ALL EXPOSED EASILY ACCESSIBLE GROUND BAI SHALL BE TAGGED "DO NOT DISCONNECT".

4. COAT ALL BARRELS WITH

ANTIOXIDANT BEFORE CRIMPING. EXTERIOR GROUND BAR LUG

SCALE: NOT TO SCALE

## NOTES:

- 1. BOND PPC AND EQUIPMENT ENCLOSURES TO BURIED GROUNDING CONDUCTOR. USE A NEMA DRILLING, TWO—HOLE CONNECTOR FOR BONDS TO EQUIPMENT ENCLOSURES; USE AN APPROVED CONDUIT CLAMP FOR CONNECTIONS TO SERVICE CONDUITS. EXOTHERMICALLY WELD CONNECTIONS TO GROUNDING
- 2. BOND ALL EXTERIOR CONDUITS, PIPES, AND CYLINDRICAL METALLIC OBJECTS WITH A PENN-UNION GT SERIES CLAMP, BLACKBURN GUV SERIES CLAMP, OR A BURNDY GAR 3900BU SERIES CLAMP ONLY. NO SUBSTITUTES ACCEPTED.
- 3. AFTER INSTALLATION IS COMPLETED IN CONFORMANCE WITH THESE DRAWINGS AND THE STANDARD SPECIFICATIONS, THE CONTRACTOR SHALL CONFIRM THE IMPEDANCE (GROUND RESISTANCE) TO EARTH AND BETWEEN GROUNDING CIRCUITS. THE GROUNDING SYSTEM IS EXPECTED TO PROVIDE FOR A MAXIMUM EARTH RESISTANCE OF 6 OHMS. THE CONTRACTOR SHALL NOTIFY T-MOBILE PRIOR TO ALL TESTING AND SHALL FURTHER NOTIFY T-MOBILE IN THE EVENT THE EARTH RESISTANCE IS GREATER THAN 5 OHMS.
- 4. ALL GROUNDING INSTALLATION IS TO BE IN ACCORDANCE WITH THE T-MOBILE WIRELESS STANDARDS AND SUPPLEMENTS PROVIDED BY THE PROJECT
- 5. ALL BENDS ON THE GROUND CONDUCTOR TO BE MADE WITH A MINIMUM 24"
- 6. ALL GROUND LEADS MUST TERMINATE AT MGB, NOT HALO.
- 7. MUST USE INSPECTION HOLE LUGS FOR GROUNDING
- 8. NO OVERLAPPING GROUND HARDWARE.
- 9. WHERE MECHANICAL CONNECTIONS ARE USED (TWO HOLE OR CRIMP), APPLY A LIBERAL PROTECTIVE COATING OF A CONDUCTIVE ANTI-OXIDE COMPOUND ON ALL CONNECTORS SUCH AS NO-OX OR APPROVED EQUAL.

GENERAL GROUNDING NOTES SCALE: NOT TO SCALE



T··Mobile···

T-MOBILE NORTHEAST LLC

35 GRIFFIN ROAD

BLOOMFIELD, CT 06002

NORTHEAST



### T-MOBILE SITE NUMBER: CTNH506A

85 PLAINFIELD AVE WEST HAVEN, CT 06516

EXISTING 149'-6" MONOPOLE

	ISSUED FOR:			
REV	DATE	DRWN	DESCRIPTION	DES./QA
Α	06/22/2022	YOG	PRELIMINARY	
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			· ·	




G-1

IT IS A VIOLATION OF LAW FOR ANY PERSON UNLESS THEY ARE ACTING UNDER THE DIRECTION OF A LICENSED PROFESSIONAL ENGINEER, TO ALTER THIS DOCUMENT.

SHEET NUMBER:

REVISION:

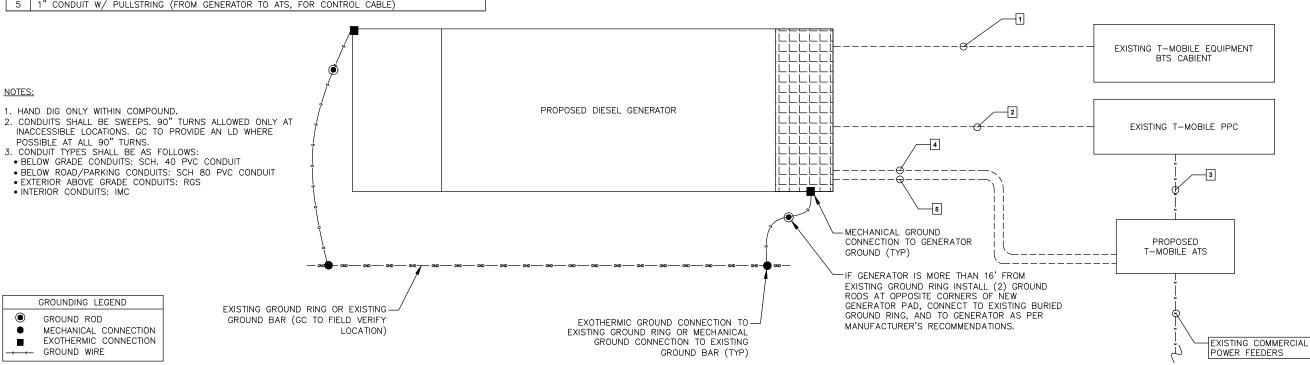

GENERATOR GROUNDING DETAIL

SCALE: NOT TO SCALE

# Exhibit D

**EPA Certified Stationary Emergency** 



Standby Power Rating 48 kW, 60 kVA, 60 Hz







Image used for illustration purposes only

## **Codes and Standards**

Not all codes and standards apply to all configurations. Contact factory for details.



UL2200, UL508, UL489, UL142



CSA 22.2





BS5514 and DIN 6271



**SAE J1349** 



NFPA 37, 70, 99



ISO 3046, 8528, 9001



NEMA ICS1, ICS10, MG1, 250, ICS6, AB1



an National Standards Institute ANSI/IEEE C62.41

# **Powering Ahead**

For over 50 years, Generac has led the industry with innovative design and superior manufacturing.

Generac ensures superior quality by designing and manufacturing most of its generator components, including alternators, enclosures and base tanks, control systems and communications software.

Generac's gensets utilize a wide variety of options, configurations and arrangements, allowing us to meet the standby power needs of practically every application.

Generac searched globally to ensure the most reliable engines power our generators. We choose only engines that have already been proven in heavy-duty industrial application under adverse conditions.

Generac is committed to ensuring our customers' service support continues after their generator purchase.

### INDUSTRIAL DIESEL GENERATOR SET

**EPA Certified Stationary Emergency** 

### **Standard Features**

### **ENGINE SYSTEM**

- Cold Weather Kit
- Oil Drain Extension
- Fan Guard
- Stainless Steel Flexible Exhaust Connection
- · Factory Filled Oil & Coolant

### **Fuel System**

Primary Fuel Filter

### **Cooling System**

- Closed Coolant Recovery System
- Factory-Installed Radiator
- 50/50 Ethylene Glycol Antifreeze
- Radiator Drain Extension
- Can Operate at up to 122°F (50°C) Ambient Temperature

### **Electrical System**

- Battery Charging Alternator
- Battery Cables
- Battery Tray
- Rubber-Booted Engine Electrical Connections
- Solenoid Activated Starter Motor
- Smart Battery Charger

### **ALTERNATOR SYSTEM**

- Class H Insulation Material
- 2/3 Pitch
- Skewed Stator
- Sealed Bearings
- Low Temperature Rise (<120°C)
- Low THD (<5%)

### **GENERATOR SET**

GENERAC

Sound Attenuated Aluminum Enclosure

**INDUSTRIAL** 

- Internal Genset Vibration Isolation
- Separation of Circuits High/Low Voltage
- Wrapped Exhaust Piping
- Standard Factory Testing
- 5 Year Limited Warranty
- Ready to Accept Full Load in <10 Seconds</li>
- E-Stop

### **TANKS**

- 48 Hour Run Time Tank
- UL 142 Listed Tank

### **CONTROL SYSTEM**



### **Evolution ™ Controller**

- Two-Line Plain Text LCD Display
- Programmable Start Delay Between 10-30 seconds
- 10 second Engine Start Sequence
- 5 second Engine Warm Up
- 1 minute Engine Cool-Down
- Starter Lock-Out
- Smart Battery Charger
- Automatic Voltage Regulation with Over and Under Protection
- Automatic Low Oil Pressure Shutdown
- Overspeed Shutdown
- High Temperature Shutdown

- Overcrank Protection
- · Safety Fused
- · Failure to Transfer Protection
- Low Battery Protection
- 50 Even Run Log
- Future Set Capable Exerciser
- Incorrect Wiring Protection
- Internal Fault Protection
- Common External Fault Capability
- · Governor Failure Protection

### **Optional Shipped Loose and Field Install Kits**

### **GENERATOR SET**

- O Paint Kit
- O Scheduled Maintance Kit

### **CONTROL SYSTEM**

○ Mobile Link <sup>TM</sup> and Adapter Kit

### **TANKS**

- O Spill Box
- O 90% Fuel Alarm
- Tank Risers
- O Spill Box Drainback Kit
- O Vent Extension Support Kit
- 5 Day Run Time Tank
- Overfill Prevention Valve
- O Fuel Fill Drop Tube
- Lockable Fuel Cap

### INDUSTRIAL DIESEL GENERATOR SET

**EPA Certified Stationary Emergency** 



### **APPLICATION AND ENGINEERING DATA**

### **ENGINE SPECIFICATIONS**

General

Make	Generac
Cylinder #	4
Туре	In-Line
Displacement - in <sup>3</sup> (L)	3.4 (207.48)
Bore - in (mm)	3.86 (98)
Stroke - in (mm)	4.45 (113)
Compression Ratio	18.5:1
Intake Air Method	Turbocharged/Aftercooled

Cast Iron OHV

Aluminum

### **Engine Governing**

Cylinder Head

Piston Type

Governor	Electronic
Frequency Regulation (Steady State)	±0.25%

### Lubrication System

Oil Pump Type	Gear
Oil Filter Type	Full Flow Spin-On Canister
Crankcase Capacity with Filters- qt (L)	7.4 (7.0)

### Cooling System

Cooling System Type	Closed Recovery
Fan Type	Pusher
Fan Speed- rpm	2,029
Fan Diameter - in (mm)	22 (559)

### Fuel System

Fuel Type	Ultra Low Sulfur Diesel Fuel
Fuel Specification	ASTM
Fuel Pump Type	Mechanical Engine Driven Gear
Injector Type	Mechanical
Fuel Supply Lin (mm/in)	7.94/0.31 (ID)
Fuel Return Line (mm/in)	7.94/0.31 (ID)
Fuel Filtering (microns)	25

### Engine Electrical System

System Voltage	12 VDC
Battery Charger Alternator	Standard
Battery Size	Group 27F
Battery Voltage	12 VDC
Ground Polarity	Negative

### **ALTERNATOR SPECIFICATIONS**

Standard Model	Generac
Poles	4
Field Type	Rotating
Insulation Class - Rotor	Н
Insulation Class - Stator	Н
Total Harmonic Distortion	<5%
Telephone Interference Factor (TIF)	<50

Standard Excitation	Direct
Bearings	Single Sealed
Coupling	Flexible Disc
Prototype Short Circuit Test	Yes
Voltage Regulator Type	Full Digital
Number of Sensed Phases	2
Regulation Accuracy (Steady State)	±1.0%

### INDUSTRIAL DIESEL GENERATOR SET

**EPA Certified Stationary Emergency** 



### **OPERATING DATA**

### **POWER RATINGS**

Standby

Single-Phase 120/480 VAC @0.1pf

48 kW

Amps: 200

### **MOTOR STARTING CAPABILITIES (SKVA)**

sKVA vs. Voltage Dip at 30%

120/240 V, Single-Phase at 0.4pf	189
----------------------------------	-----

### **FUEL CONSUMPTION RATES\***

Percent Load	Diesel gal/hr (L/hr)
25%	1.35 (5.11)
50%	2.15 (8.14)
75%	3.06 (11.58)
100%	3.98 (15.07)

<sup>\*</sup> Fuel supply installation must accommodate fuel consumption rates at 100% load.

### **COOLING**

		Standby
Air Flow (Radiator and Alternator)	ft³/min (m³/min)	2824 (80)
Coolant System Capacity	gal (L)	2.8 (10.6)
Heat Rejection to Coolant	BTU/hr (MJ/hr)	135,900 (143.4)
Temperature Deration	3% for every 5°C above 25°C or 1	.7% for every 5°F over 77°F
Altitude Deration	1% for every 100 m above 915 or 3% fo	r every 1000 ft over 3000 ft
Maximum Radiator Backpressure	in H <sub>2</sub> O (kPa)	0.50 (0.12)

### **COMBUSTION AIR REQUIREMENTS**

	Standby
Flow at Rated Power ft <sup>3</sup> /min (m <sup>3</sup> /min)	190 (5.38)


ENGINE			EXHAUST		
		Standby			Standby
Rated Engine Speed	rpm	1,800	Exhaust Flow (Rated Output)	ft³/min (m³/min)	448 (12.7)
Horsepower at rated kW	HP	85	Exhaust Temp (Rated Output - Post Silencer)	°F (°C)	1120 (604.4)

Deration – Operational characteristics consider maximum ambient conditions. Derate factors may apply under atypical site conditions.

Please consult a Generac Power Systems Industrial Dealer for additional details. All performance ratings in accordance with ISO3046, BS5514, ISO8528 and DIN6271 standards. Standby - See Bulletin 0187500SSB



### **DIMENSIONS AND WEIGHTS\***

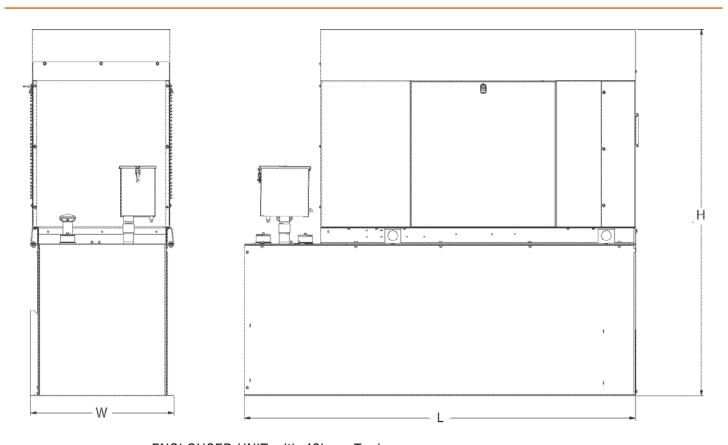

### **ENCLOUSED UNIT with 48hour Tank**


L x W x H in (mm)	95.4 (2,422) x 35.0 (880) x 89.3 (2,269)
Sound output in dB(A) at 23ft with generator operating at normal Load	65

\* All measurements are approximate and for estimation purposes only.

YOUR FACTORY RECOGNIZED GENERAC INDUSTRIAL DEALER					

Specification characteristics may change without notice. Dimensions and weights are for preliminary purposes only. Please consult a Generac Power Systems Industrial Dealer for detailed installation drawings.

# Exhibit E

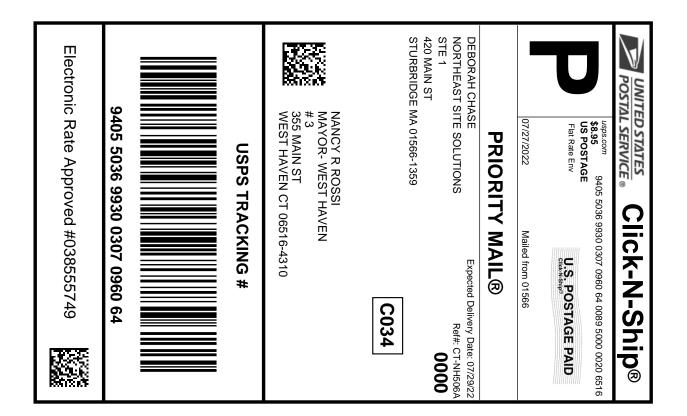



### Instructions

- 1. Each Click-N-Ship® label is unique. Labels are to be used as printed and used only once. DO NOT PHOTO **COPY OR ALTER LABEL.**
- 2. Place your label so it does not wrap around the edge of the package.
- 3. Adhere your label to the package. A self-adhesive label is recommended. If tape or glue is used, DO NOT TAPE OVER BARCODE. Be sure all edges are secure.
- 4. To mail your package with PC Postage®, you may schedule a Package Pickup online, hand to your letter carrier, take to a Post Office™, or drop in a USPS collection box.
- 5. Mail your package on the "Ship Date" you selected when creating this label.

### Click-N-Ship® Label Record

### **USPS TRACKING #:** 9405 5036 9930 0307 0960 64

Trans. #: 568475852 Print Date: 07/27/2022 07/27/2022 Ship Date: 07/29/2022 Delivery Date:

Priority Mail® Postage: Total:

\$8.95 \$8.95

Ref#: CT-NH506A

From: **DEBORAH CHASE** 

NORTHEAST SITE SOLUTIONS

STE 1

420 MAIN ST

STURBRIDGE MA 01566-1359


NANCY R ROSSI

MAYOR- WEST HAVEN

#3

355 MAIN ST

WEST HAVEN CT 06516-4310

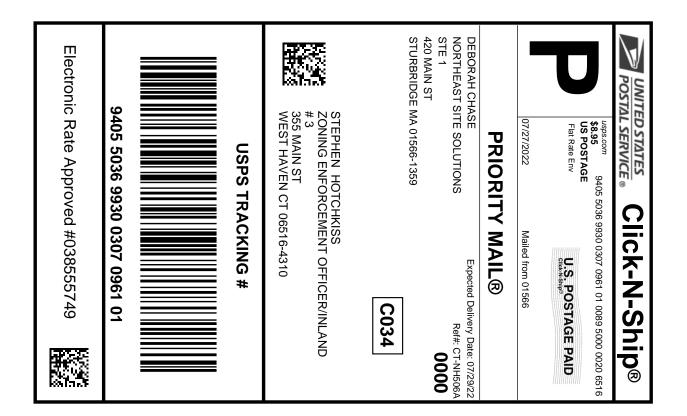



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### Click-N-Ship® Label Record

### **USPS TRACKING #:** 9405 5036 9930 0307 0961 01

Trans. #: 568475852 Print Date: 07/27/2022 07/27/2022 Ship Date: Delivery Date: 07/29/2022 Priority Mail® Postage: Total:

\$8.95 \$8.95

Ref#: CT-NH506A

From: **DEBORAH CHASE** 

NORTHEAST SITE SOLUTIONS

STE 1

420 MAIN ST

**STURBRIDGE MA 01566-1359** 


STEPHEN HOTCHKISS

ZONING ENFORCEMENT OFFICER/INLAND WETLANDS

#3

355 MAIN ST

WEST HAVEN CT 06516-4310

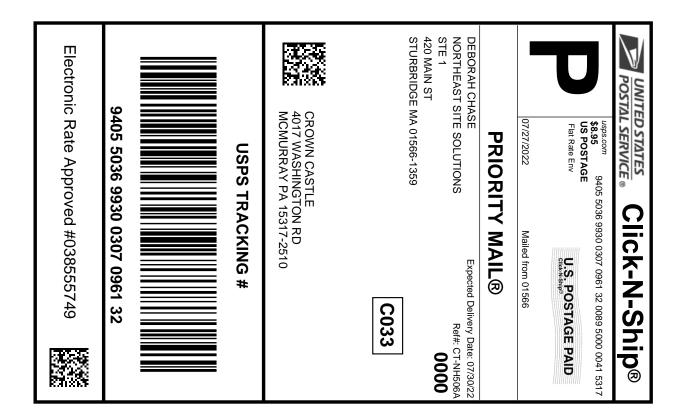



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### Click-N-Ship® Label Record

### **USPS TRACKING #:** 9405 5036 9930 0307 0961 32

Trans. #: 568475852 Print Date: 07/27/2022 07/27/2022 Ship Date: Delivery Date: 07/30/2022 Priority Mail® Postage: Total:

\$8.95 \$8.95

Ref#: CT-NH506A

From: **DEBORAH CHASE** 

NORTHEAST SITE SOLUTIONS


STE 1

420 MAIN ST

STURBRIDGE MA 01566-1359

**CROWN CASTLE** 

4017 WASHINGTON RD MCMURRAY PA 15317-2510

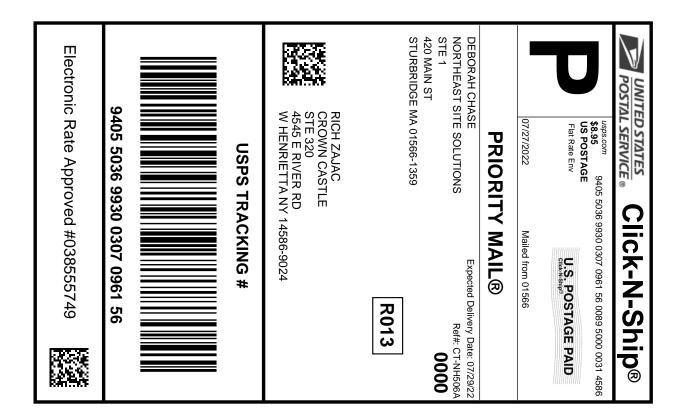



### Instructions

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# Click-N-Ship® Label Record

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Trans. #: 568475852 Print Date: 07/27/2022 07/27/2022 Ship Date: 07/29/2022 Delivery Date:

Priority Mail® Postage: Total:

\$8.95 \$8.95

Ref#: CT-NH506A

From: **DEBORAH CHASE** 

NORTHEAST SITE SOLUTIONS

STE 1

420 MAIN ST

STURBRIDGE MA 01566-1359

**RICH ZAJAC** 

**CROWN CASTLE STE 320** 4545 E RIVER RD

W HENRIETTA NY 14586-9024



FARMINGTON 210 MAIN ST FARMINGTON, CT 06032-9998

(800) 275-8777 07/28/2022 08:59 AM Product Qty Unit Price Price Prepaid Mail \$0.00 West Henrietta, NY 14586 Weight: 0 lb 2.00 oz Acceptance Date: Thu 07/28/2022 Tracking #: 9405 5036 9930 0307 0961 56 Prepaid Mail \$0,00 Canonsburg, PA 15317 Weight: 0 lb 6.20 oz Acceptance Date: Thu 07/28/2022 Tracking #: 9405 5036 9930 0307 0961 32 Prepaid Mail \$0.00 West Haven, CT 06516 Weight: 0 lb 4.20 oz Acceptance Date: Thu 07/28/2022 Tracking #: 9405 5036 9930 0307 0961 01 Prepaid Mail \$0.00 West Haven, CT 06516 Weight: 0 lb 6.20 oz Acceptance Date: Thu 07/28/2022 Tracking #: 9405 5036 9930 0307 0960 64

Grand Total: \$0.00

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