

COMPLIANCE CODE



ATC SITE NAME: WATERTOWN CT

ATC SITE NUMBER: 283424

PROJECT SUMMARY

VERIZON SITE NAME: WATERTOWN NE CT

VERIZON SITE NUMBER:470386 SITE ADDRESS: 655 BASSETT RD.

WATERTOWN, CT 06795

PROJECT DESCRIPTION



LOCATION MAP

SHEET INDEX

VERIZON 5G L-SUB6 - CARRIER ADD DRAWINGS

ALL WORK SHALL BE PERFORMED AND MATERIALS INSTALLED IN ACCORDANCE WITH THE CURRENT EDITIONS OF THE FOLLOWING CODES AS ADOPTED BY THE LOCAL	SITE ADDRE		THE PROPOSED PROJECT INCLUDES MODIFYING GROUND BASED AND TOWER MOUNTED EQUIPMENT AS INDICATED PER BELOW:	SHEET NO:	DESCRIPTION:	REV:	DATE:	BY:
GOVERNMENT AUTHORITIES. NOTHING IN THESE PLANS IS	655 BASSETT		REMOVE (3) RRH(s) (1) HYBRID CABLE, AND (1) OVP BOX	G-001	TITLE SHEET	0	06/15/21	EA
TO BE CONSTRUED TO PERMIT WORK NOT CONFORMING TO THESE CODES.	WATERTOWN, C		INSTALL (3) ANTENNA(s), (3) DIPLEXER(s), (9) RRH(s), (1) OVP BOX,	G-002	GENERAL NOTES	0	06/15/21	EA
1. 2018 CONNECTICUT STATE BUILDING CODE-AMENDMENTS	COUNTY: SUFF	FOLK	AND (2) HYBRID CABLE(s)	C-101	DETAILED SITE PLAN	0	06/15/21	EA
TO IBC 2015	GEOGRAPHIC COOF	RDINATES:	EXISTING (6) ANTENNA(s) TO REMAIN					
INTERNATIONAL BUILDING CODE 2015, INTERNATIONAL CODE COUNCIL	LATITUDE: 41.6	65707		C-201	TOWER ELEVATION	0	06/15/21	EA
3. TIA-222-G-4, STRUCTURAL STANDARD FOR ANTENNA	LONGITUDE: -73	.13626		C-401	ANTENNA INFORMATION & SCHEDULE	0	06/15/21	EA
SUPPORTING STRUCTURES AND ANTENNAS	GROUND ELEVATION	I: 833' AMSL		C-501	CONSTRUCTION DETAILS	0	06/15/21	EA
ASCE 7-10 MINIMUM DESIGN LOADS FOR BUILDINGS AND OTHER STRUCTURES, AMERICAN SOCIETY OF CIVIL ENGINEERS				E-501	GROUNDING DETAILS	0	06/15/21	EA
5. STEEL CONSTRUCTION MANUAL 14TH EDITION, AMERICAN				R-601	SUPPLEMENTAL			
INSTITUTE OF STEEL CONSTRUCTION				R-602	SUPPLEMENTAL			
6. CITY/COUNTY ORDINANCES	PROJECT T	EAM	PROJECT NOTES					
	TOWER OWNER: AMERICAN TOWER 10 PRESIDENTIAL WAY WOBURN. MA 01801	APPLICANT: VERIZON WIRELESS 118 FLANDERS ROAD VESTBOROUGH, MA 01581	THE FACILITY IS UNMANNED. A TECHNICIAN WILL VISIT THE SITE APPROXIMATELY ONCE A MONTH FOR ROUTINE INSPECTION AND MAINTENANCE. THE PROJECT WILL NOT RESULT IN ANY SIGNIFICANT LAND DISTURBANCE OR EFFECT OF STORM WATER DRAINAGE.					
UTILITY COMPANIES	ENGINEER:	NO SANITARY SEWER, POTABLE WATER OR TRASH DISPOSAL IS REQUIRED.						
POWER COMPANY: N/A PHONE: N/A TELEPHONE COMPANY: N/A PHONE: N/A	DEWBERRY ENGINEERS, INC. 99 SUMMER STREET SUITE 700 BOSTON, MA 02110		5. HANDICAP ACCESS IS NOT REQUIRED.					
000	PROPERTY OWNER:		PROJECT LOCATION DIRECTIONS					
Know what's below. Call before you dig.	GUSTAFSON FRANK E (EST) ET AL 655 BASSETT RD WATERTOWN, CT 67951139		FROM DOWNTOWN WATERBURY START OUT GOING WEST ON E MAIN ST TOWARD MAPLE ST. TURN RIGHT ONTO RIVERSIDE ST. MERGE ONTO CT-8 N/JAMES H DARCEY MEMORIAL HWY N TOWARD WATERTOWN / TORRINGTON. TAKE THE CT-262 EXIT, EXIT 37, TOWARD WATERTOWN. TURN LEFT ONTO FROST BRIDGE RD/CT-262. CONTINUE TO FOLLOW CT-262. TURN RIGHT ONTO BUCKINGHAM ST/CT-262. BUCKINGHAM ST/CT-262. BUCKINGHAM ST/CT-262. BUCKINGHAM ST/CT-264. BUCKINGHAM ST/CT-265.					





Dewberry Engineers Inc.

99 SUMMER STREET
SUITE 700
BOSTON, MA 02110
PHONE: 617.531.0801
FAX: 617.695.3310

I	REV.	DESCRIPTION	BY	DATE
ı	\mathbb{A}_{-}	PRELIM	PMG	05/14/21
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283424

ATC SITE NAME: WATERTOWN CT

VERIZON SITE NAME:

WATERTOWN NE CT

SITE ADDRESS: 655 BASSETT RD. WATERTOWN, CT 06795





DATE DRAWN:	05/14/21
ATC JOB NO:	13668995
CUSTOMER ID:	WATERTOWN NE CT
CUSTOMER #:	470386

TITLE SHEET

SHEET NUMBER:

G-001

GENERAL CONSTRUCTION NOTES:

- OWNER FURNISHED MATERIALS, VERIZON "THE COMPANY" WILL PROVIDE AND THE CONTRACTOR WILL INSTALL
- BTS EQUIPMENT FRAME (PLATFORM) AND ICEBRIDGE SHELTER (GROUND
- BUILD/CO-LOCATE ONLY) AC/TELCO INTERFACE BOX (PPC)
- ICE BRIDGE (CABLE TRAY WITH COVER) (GROUND BUILD/CO-LOCATE ONLY, GC
 TO FURNISH AND INSTALL FOR ROOFTOP INSTALLATION)

 24. CONTRACTOR SHALL SUBMIT ALL SHOP DRAWINGS TO VERIZON FOR REVIEW AND
 APPROVAL PRIOR TO FARRICATION
- TOWERS, MONOPOLES
- TOWER LIGHTING
- GENERATORS & LIQUID PROPANE TANK
- ANTENNA STANDARD BRACKETS, FRAMES AND PIPES FOR MOUNTING
- ANTENNAS (INSTALLED BY OTHERS)
- TRANSMISSION LINE
- TRANSMISSION LINE JUMPERS
- TRANSMISSION LINE CONNECTORS WITH WEATHERPROOFING KITS
- TRANSMISSION LINE GROUND KITS
- HANGERS
- HOISTING GRIPS
- BTS EQUIPMENT
- THE CONTRACTOR IS RESPONSIBLE TO PROVIDE ALL OTHER MATERIALS FOR THE COMPLETE INSTALLATION OF THE SITE INCLUDING, BUT NOT LIMITED TO, SUCH MATERIALS AS FENCING STRUCTURAL STEEL SUPPORTING SUB-FRAME FOR PLATFORM ROOFING LABOR AND MATERIALS, GROUNDING RINGS, GROUNDING WIRES,
 COPPER-CLAD OR XIT CHEMICAL GROUND ROD(S), BUSS BARS, TRANSFORMERS AND DISCONNECT SWITCHES WHERE APPLICABLE, TEMPORARY ELECTRICAL POWER. CONDUIT, LANDSCAPING COMPOUND STONE, CRANES, CORE DRILLING, SLEEPERS AND RUBBER MATTING, REBAR, CONCRETE CAISSONS, PADS AND/OR AUGER MOUNTS, MISCELLANEOUS FASTENERS, CABLE TRAYS, NON-STANDARD ANTENNA FRAMES AND ALL OTHER MATERIAL AND LABOR REQUIRED TO COMPLETE THE JOB ACCORDING TO THE DRAWINGS AND SPECIFICATIONS. IT IS THE POSITION OF VERIZON TO APPLY FOR PERMITTING AND CONTRACTOR RESPONSIBLE FOR PICKUP AND PAYMENT OF REQUIRED
- ALL WORK SHALL CONFORM TO ALL CURRENT APPLICABLE FEDERAL, STATE, AND LOCAL CODES, INCLUDING ANSI/EIA/TIA-222, AND COMPLY WITH ATC CONSTRUCTION
- CONTRACTOR SHALL CONTACT LOCAL 811 FOR IDENTIFICATION OF UNDERGROUND UTILITIES PRIOR TO START OF CONSTRUCTION.
- CONTRACTOR SHALL BE RESPONSIBLE FOR COORDINATING ALL REQUIRED
- ALL DIMENSIONS TO, OF, AND ON EXISTING BUILDINGS, DRAINAGE STRUCTURES, AND SITE IMPROVEMENTS SHALL BE VERIFIED IN FIELD BY CONTRACTOR WITH ALL DISCREPANCIES REPORTED TO THE ENGINEER.
- DO NOT CHANGE SIZE OR SPACING OF STRUCTURAL ELEMENTS.
- DETAILS SHOWN ARE TYPICAL; SIMILAR DETAILS APPLY TO SIMILAR CONDITIONS UNLESS
- THESE DRAWINGS DO NOT INCLUDE NECESSARY COMPONENTS FOR CONSTRUCTION SAFETY WHICH SHALL BE THE SOLE RESPONSIBILITY OF THE CONTRACTOR
- CONTRACTOR SHALL BRACE STRUCTURES UNTIL ALL STRUCTURAL ELEMENTS NEEDED FOR STABILITY ARE INSTALLED. THESE ELEMENTS ARE AS FOLLOWS: LATERAL BRACING, ANCHOR BOLTS, ETC.
- CONTRACTOR SHALL DETERMINE EXACT LOCATION OF EXISTING UTILITIES. GROUNDS DRAINS, DRAIN PIPES, VENTS, ETC. BEFORE COMMENCING WORK
- INCORRECTLY FABRICATED, DAMAGED, OR OTHERWISE MISFITTING OR NONCONFORMING MATERIALS OR CONDITIONS SHALL BE REPORTED TO THE VERIZON REP PRIOR TO REMEDIAL OR CORRECTIVE ACTION. ANY SUCH REMEDIAL ACTION SHALL REQUIRE WRITTEN APPROVAL BY THE VERIZON REP PRIOR TO PROCEEDING.
- EACH CONTRACTOR SHALL COOPERATE WITH THE VERIZON REP, AND COORDINATE HIS WORK WITH THE WORK OF OTHERS.
- CONTRACTOR SHALL REPAIR ANY DAMAGE CALISED BY CONSTRUCTION OF THIS PROJECT TO MATCH EXISTING PRE-CONSTRUCTION CONDITIONS TO THE SATISFACTION OF THE VERIZON CONSTRUCTION MANAGER.
- ALL CABLE/CONDUIT ENTRY/EXIT PORTS SHALL BE WEATHERPROOFED DURING
- WHERE EXISTING CONDITIONS DO NOT MATCH THOSE SHOWN IN THIS PLAN SET, CONTRACTOR SHALL NOTIFY THE VERIZON REP AND ENGINEER OF RECORD IMMEDIATELY.
- CONTRACTOR SHALL ENSURE ALL SUBCONTRACTORS ARE PROVIDED WITH A COMPLETE AND CURRENT SET OF DRAWINGS AND SPECIFICATIONS FOR THIS PROJECT
- CONTRACTOR SHALL REMOVE ALL RUBBISH AND DEBRIS FROM THE SITE AT THE END OF
- CONTRACTOR SHALL COORDINATE WORK SCHEDULE WITH AMERICAN TOWER CORPORATION (ATC) AND TAKE PRECAUTIONS TO MINIMIZE IMPACT AND DISRUPTION OF OTHER OCCUPANTS OF THE FACILITY.
- CONTRACTOR SHALL FURNISH VERIZON, AND AMERICAN TOWER CORPORATION (ATC) NITH A PDF MARKED UP AS-BUILT SET OF DRAWINGS UPON COMPLETION OF WORK
- PRIOR TO SUBMISSION OF BID, CONTRACTOR SHALL COORDINATE WITH VERIZON REP TO DETERMINE WHAT, IF ANY, ITEMS WILL BE PROVIDED. ALL ITEMS NOT PROVIDED SHALL BE PROVIDED AND INSTALLED BY THE CONTRACTOR. CONTRACTOR WILL INSTALL

- PRIOR TO SUBMISSION OF BID, CONTRACTOR SHALL COORDINATE WITH VERIZON REP TO DETERMINE IF ANY PERMITS WILL BE OBTAINED BY CONTRACTOR. ALL REQUIRED PERMITS NOT OBTAINED BY VERIZON MUST BE OBTAINED, AND PAID FOR, BY THE
- SPECIFICATIONS AND REQUIREMENTS
- ALL EQUIPMENT SHALL BE INSTALLED ACCORDING TO MANUFACTURER'S SPECIFICATIONS AND LOCATED ACCORDING TO VERIZON SPECIFICATIONS, AND AS
- THE CONTRACTOR SHALL SUPERVISE AND DIRECT THE PROJECT DESCRIBED HEREIN. THE CONTRACTOR SHALL BE SOLELY RESPONSIBLE FOR ALL THE CONSTRUCTION MEANS, METHODS, TECHNIQUES, SEQUENCES AND PROCEDURES AND FOR COORDINATING ALL PORTIONS OF THE WORK UNDER THE CONTRACT
- CONTRACTOR SHALL NOTIFY VERIZON REP A MINIMUM OF 48 HOURS IN ADVANCE OF POURING CONCRETE OR BACKFILLING ANY UNDERGROUND UTILITIES. FOUNDATIONS OR SEALING ANY WALL, FLOOR OR ROOF PENETRATIONS FOR ENGINEERING REVIEW AND
- CONTRACTOR SHALL BE RESPONSIBLE FOR SITE SAFETY INCLUDING COMPLIANCE WITH ALL APPLICABLE OSHA STANDARDS AND RECOMMENDATIONS AND SHALL PROVIDE ALL NECESSARY SAFETY DEVICES INCLUDING PPE AND PPM AND CONSTRUCTION DEVICES SUCH AS WELDING AND FIRE PREVENTION, TEMPORARY SHORING, SCAFFOLDING, TRENCH BOXES/SLOPING, BARRIERS, ETC.
- THE CONTRACTOR SHALL PROTECT AT HIS OWN EXPENSE ALL EXISTING FACILITIES AND SUCH OF HIS NEW WORK LIABLE TO INJURY DURING THE CONSTRUCTION PERIOD. ANY DAMAGE CAUSED BY NEGLECT ON THE PART OF THIS CONTRACTOR OR HIS DAMAGE CAUSE IT NEGLECT ON THE PART OF THIS CONTRACTOR OR HIS
 REPRESENTATIVES, OR BY THE ELEMENTS DUE TO NEGLECT ON THE PART OF THIS
 CONTRACTOR OR HIS REPRESENTATIVES, EITHER TO THE EXISTING WORK, OR TO HIS
 WORK OR THE WORK OF ANY OTHER CONTRACTOR, SHALL BE REPAIRED AT HIS EXPENSE TO THE OWNER'S SATISFACTION.
- ALL WORK SHALL BE INSTALLED IN A FIRST CLASS, NEAT AND WORKMANLIKE MANNER BY MECHANICS SKILLED IN THE TRADE INVOLVED. THE QUALITY OF WORKMANSHIP SHALL BE SUBJECT TO THE APPROVAL OF THE VERIZON REP. ANY WORK FOUND BY THE VERIZON REP TO BE OF INFERIOR QUALITY AND/OR WORKMANSHIP SHALL BE REPLACED AND/OR REWORKED AT CONTRACTOR EXPENSE UNTIL APPROVAL IS
- IN ORDER TO ESTABLISH STANDARDS OF QUALITY AND PERFORMANCE, ALL TYPES OF MATERIALS LISTED HEREINAFTER BY MANUFACTURER'S NAMES AND/OR MANUFACTURER'S CATALOG NUMBER SHALL BE PROVIDED BY THESE MANUFACTURERS
- VERIZON FURNISHED EQUIPMENT SHALL BE PICKED-UP AT THE VERIZON WAREHOUSE, NO LATER THAN 48HR AFTER BEING NOTIFIED INSURED, STORED, UNCRATE, PROTECTED AND INSTALLED BY THE CONTRACTOR WITH ALL APPURTENANCES REQUIRED TO PLACE THE EQUIPMENT IN OPERATION, READY FOR USE. THE CONTRACTOR SHALL BE RESPONSIBLE FOR THE EQUIPMENT AFTER PICKING IT UP.
- VERIZON OR HIS ARCHITECT/ENGINEER RESERVES THE RIGHT TO REJECT ANY 33. EQUIPMENT OR MATERIALS WHICH, IN HIS OWN OPINION ARE NOT IN COMPLIANCE WITH THE CONTRACT DOCUMENTS, EITHER BEFORE OR AFTER INSTALLATION AND THE EQUIPMENT SHALL BE REPLACED WITH EQUIPMENT CONFORMING TO THE REQUIREMENTS OF THE CONTRACT DOCUMENTS BY THE CONTRACTOR AT NO COST TO

SPECIAL CONSTRUCTION ANTENNA INSTALLATION NOTES:

- WORK INCLUDED:
 - A. ANTENNA AND COAXIAL CABLES ARE FURNISHED BY VERIZON UNDER A SEPARATE CONTRACT. THE CONTRACTOR SHALL ASSIST ANTENNA INSTALLATION CONTRACTOR IN TERMS OD COORDINATION AND SITE ACCESS. ERECTION SUBCONTRACTOR SHALL BE RESPONSIBLE FOR THE PROTECTION OF
 - B. INSTALL ANTENNA AS INDICATE ON DRAWINGS AND VERIZON SPECIFICATIONS.
 - C. INSTALL GALVANIZED STEEL ANTENNA MOUNTS AS INDICATED ON DRAWINGS
 - D. INSTALL FURNISHED GALVANIZED STEEL OR ALUMINUM WAVEGUIDE.
 - CONTRACTOR SHALL PROVIDE FOUR (4) SETS OF SWEEP TESTS USING ANRITZU-PACKARD 8713B RF SCALAR NETWORK ANALYZER, SUBMIT FREQUENCY DOMAIN REFLECTOMETER(FDR) TESTS RESULTS TO THE PROJECT MANAGER. SWEEP TESTS SHALL BE AS PER ATTACHED RFS "MINIMUM FIELD TESTING RECOMMENDED FOR ANTENNA AND HELIAX COAXIAL CABLE SYSTEMS" DATED 10/5/93. TESTING SHALL BE PERFORMED BY AN INDEPENDENT TESTING SERVICE AND BE BOUND AND SUBMITTED WITHIN ONE WEEK OF WORK COMPLETION.
 - INSTALL COAXIAL CABLES AND TERMINATING BETWEEN ANTENNAS AND EQUIPMENT PER MANUFACTURER'S RECOMMENDATIONS. WEATHERPROOF ALL CONNECTIONS BETWEEN THE ANTENNA AND EQUIPMENT PER MANUFACTURER'S REQUIREMENTS. TERMINATE ALL COAXIAL CABLE THREE (3) FEET IN EXCESS OF ENTRY PORT LOCATION UNLESS OTHERWISE STATED.
 - G. ANTENNA AND COAXIAL CABLE GROUNDING:
- ALL EXTERIOR #6 GREED GROUND WIRE "DAISY CHAIN" CONNECTIONS ARE TO BE WEATHER SEALED WITH RES CONNECTORS/SPLICE WEATHERPROOFING KIT #221213 OR
- ALL COAXIAL CABLE GROUNDING KITS ARE TO BE INSTALLED ON STRAIGHT RUNS OF COAXIAL CABLE (NOT WITHIN BENDS)

23. CONTRACTOR SHALL INSTALL ALL SITE SIGNAGE IN ACCORDANCE WITH VERIZON





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ATC SITE NAME: WATERTOWN CT

VERIZON SITE NAME:

WATERTOWN NE CT

SITE ADDRESS: 655 BASSETT RD. WATERTOWN CT 06795



DATE DRAWN:	05/14/21
ATC JOB NO:	13668995
CUSTOMER ID:	WATERTOWN NE CT
CUSTOMER #:	470386

GENERAL NOTES

SHEET NUMBER:

ALL DISCREPANCIES FROM WHAT IS SHOWN ON THESE

CONSTRUCTION DRAWINGS SHALL BE COMMUNICATED TO ATC


ENGINEERING IMMEDIATELY FOR CORRECTION OR RE-DESIGN.

FAILURE TO COMMUNICATE DIRECTLY WITH ATC ENGINEERING OR

ANY CHANGES FROM THE DESIGN CONDUCTED WITHOUT PRIOR

APPROVAL FROM ATC ENGINEERING SHALL BE THE SOLE RESPONSIBILITY OF THE GENERAL CONTRACTOR.

G-002

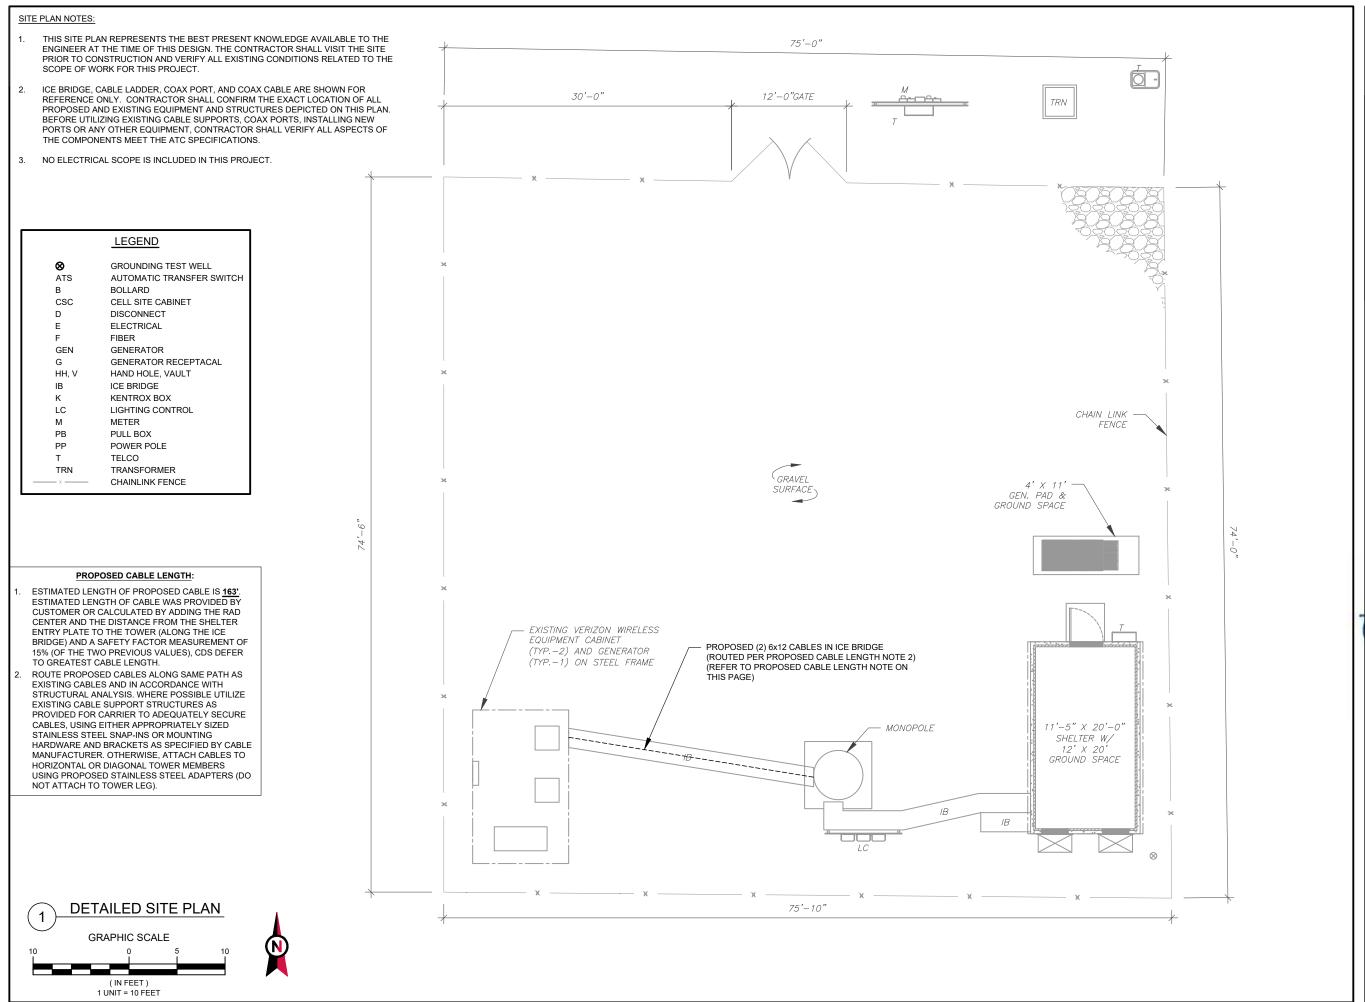





Dewberry Engineers Inc.

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VERIZON SITE NAME:

WATERTOWN NE CT

SITE ADDRESS: 655 BASSETT RD. WATERTOWN, CT 06795





DATE DRAWN:	05/14/21
ATC JOB NO:	13668995
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DETAILED SITE PLAN

SHEET NUMBER:

REVISION:

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PER MOUNT ANALYSIS COMPLETED BY MASER CONSULTING, DATED 05/19/21, THE EXISTING MOUNT CAN ADEQUATELY SUPPORT THE PROPOSED LOADING.

TOWER NOTE:

1. IT IS THE CONTRACTOR'S RESPONSIBILITY TO

CONFIRM WITH THE PROJECT MANAGER THAT THEY HAVE THE MOST RECENT VERSION OF THE STRUCTURAL ANALYSIS BEFORE COMMENCING WORK. EXISTING AND PROPOSED TOWER APPURTENANCES, MOUNTS, AND ANTENNAS ARE SHOWN BASED ON THE STRUCTURAL ANALYSIS. WHERE APPLICABLE, ALL NEW ANTENNAS, EQUIPMENT, MOUNTS, CABLING, ETC. SHALL BE PAINTED/SOCKED TO MATCH EXISTING EQUIPMENT

IN ACCORDANCE WITH FAA, JURISDICTION, AND/OR OTHER LOCAL REQUIREMENTS.


3. ROUTE PROPOSED CABLES ALONG SAME PATH AS EXISTING CABLES AND IN ACCORDANCE WITH STRUCTURAL ANALYSIS. IF ADEQUATE SPACE EXISTS, ROUTE CABLES THROUGH ENTRY PORT HOLE, UP INSIDE OF MONOPOLE, AND THROUGH EXIT PORT HOLE. IF ROUTING OUTSIDE THE MONOPOLE, ATTACH CABLES USING STAND-OFF ADAPTERS MOUNTED TO TOWER USING STAINLESS STEEL BANDING, ADEQUATELY SECURE CABLES USING EITHER APPROPRIATELY SIZED STAINLESS STEEL SNAP-INS OR MOUNTING HARDWARE AND

BRACKETS AS SPECIFIED BY CABLE

ABOVE GROUND LEVEL (A.G.L.)

TOWER ELEVATIONS ARE MEASURED FROM TOP OF BASE PLATE TO MATCH STRUCTURAL ANALYSIS. ELEVATIONS DO NOT REFLECT TRUE

MANUFACTURER.

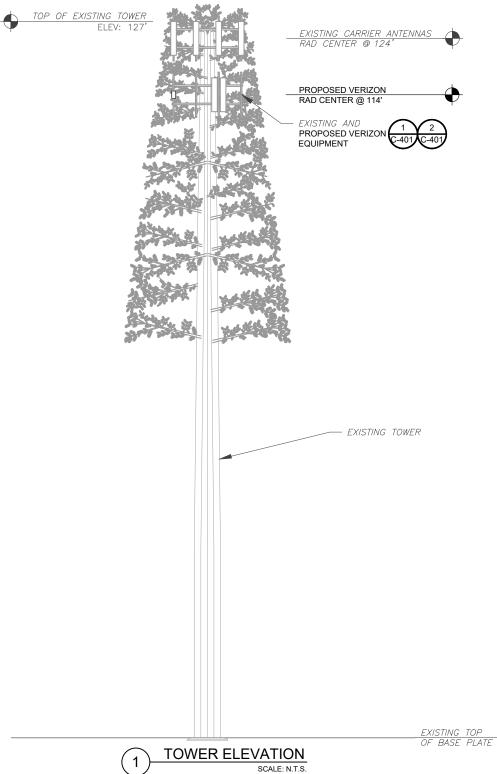





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SITE ADDRESS: 655 BASSETT RD. WATERTOWN, CT 06795



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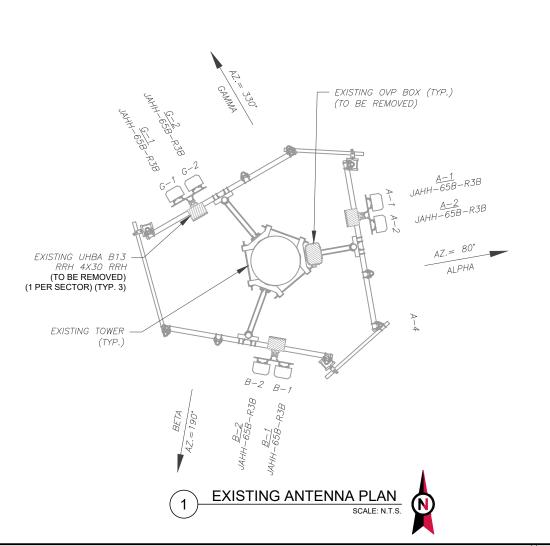
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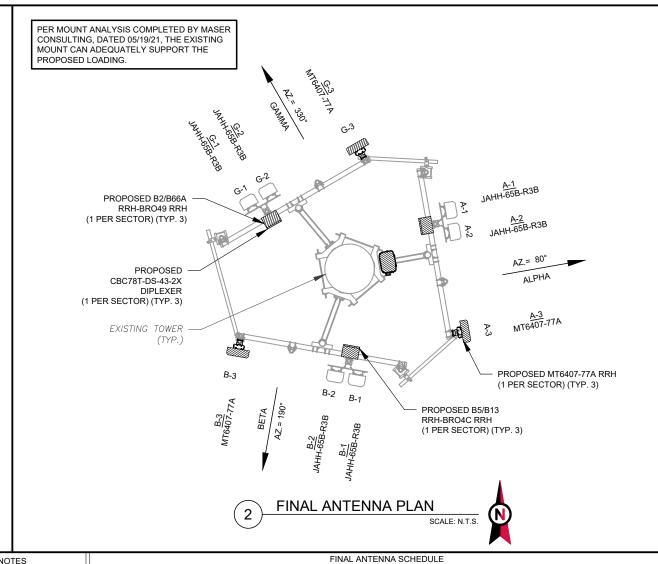
TOWER ELEVATION

SHEET NUMBER:

REVISION:

C-201





	EXISTING ANTENNA SCHEDULE									
LOCATION				AN	ITENNA SUMMARY			NON ANTENNA SUMMARY		
SECTOR	RAD	AZ	POS	ANTENNA	BAND	MECH/ELEC D-TILT	STATUS	ADDITIONAL TOWER MOUNTED EQUIPMENT	STATUS	
ALPHA	114'	80°	A1	JAHH-65B-R3B	700/850/1900/ AWS	0/5	RMN	UHBA B13 RRH 4X30	RMV	
ALPHA	114'	80°	A2	JAHH-65B-R3B	700/850/1900/ AWS	0/5	RMN	UHBA B13 RRH 4X30	RMV	
BETA	114'	190°	B1	JAHH-65B-R3B	700/850/1900/ AWS	0/4	RMN	UHBA B13 RRH 4X30	RMV	
BETA	114'	190°	B2	JAHH-65B-R3B	700/850/1900/ AWS	0/4	RMN	UHBA B13 RRH 4X30	RMV	
GAMMA	114'	330°	G1	JAHH-65B-R3B	700/850/1900/ AWS	0/6	RMN	UHBA B13 RRH 4X30	RMV	
GAMMA	114'	330°	G2	JAHH-65B-R3B	700/850/1900/ AWS	0/6	RMN	UHBA B13 RRH 4X30	RMV	

NOTES

1. CONFIRM WITH VERIZON REP FOR APPLICABLE UPDATES/REVISIONS AND MOST RECENT RFDS FOR NSN CONFIGURATION (CONFIG). GC TO CAP ALL UNUSED PORTS.

2. CONFIRM SPACING OF PROPOSED EQUIP DOES NOT CAUSE TOWER CONFLICTS NOR IMPEDE TOWER CLIMBING PEGS.

STATUS ABBREVIATIONS

RMV: TO BE REMOVED

RMM: TO REMAIN

REL: TO BE RELOCATED

ADD: TO BE ADDED

CABLE LENGTHS FOR JUMPERS

JUNCTION BOX TO RRH: 15'

RRH TO ANTENNA: 10'

P	LOCATION ANTENNA SUMMARY							NON ANTENNA SUMMARY				
SN	SECTOR	RAD	AZ	POS	ANTENNA	BAND	MECH/ELEC D-TILT	STATUS	ADDITIONAL TOWER MOUNTED EQUIPMENT	STATUS		
GC				A1	JAHH-65B-R3B	700/850/1900/AWS	0/5	RMN	CBC78T-DS-43-2X	ADD		
r NG	ALPHA	114'	80°						B2/B664 RRH-BR049	ADD		
NG				A2	JAHH-65B-R3B	700/850/1900/AWS	0/5	RMN	B5/B13 RRH-BR04C	ADD		
\neg				А3	MT6407-77A	L-SUB6	0/6	ADD	-	-		
				B1	JAHH-65B-R3B	700/850/1900/AWS	0/4	RMN	CBC78T-DS-43-2X	ADD		
	BETA	114'	190°						B2/B664 RRH-BR049	ADD		
						B2	JAHH-65B-R3B	700/850/1900/AWS	0/4	RMN	B5/B13 RRH-BR04C	ADD
<u>s</u>				В3	MT6407-77A	L-SUB6	0/6	ADD	-	-		
				G1	JAHH-65B-R3B	700/850/1900/AWS	0/6	RMN	CBC78T-DS-43-2X	ADD		
	GAMMA	114'	330°						B2/B664 RRH-BR049	ADD		
				G2	JAHH-65B-R3B	700/850/1900/AWS	0/6 RMN		B5/B13 RRH-BR04C	ADD		
				G3	MT6407-77A	L-SUB6	0/6	ADD	-	-		

EXISTING FIBER DISTRIBUTION/O	VP BOX	EXISTII	NG CABLING SUMMARY	
MODEL NUMBER	STATUS	COAX	HYBRID	STATUS
(1) OVP BOX	RMV	_	_	RMV

3 EQUIPMENT SCHEDULES

FINAL FIBER DISTRIBUTION / OVP BOX		FINAL CABLING SUMMARY		
MODEL NUMBER	STATUS	COAX	HYBRID	STATUS
(1) RCMDC-6627-PF-48	ADD	-	(2) 6X12	ADD





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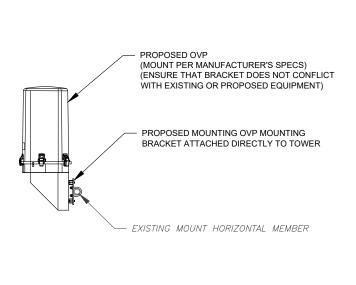



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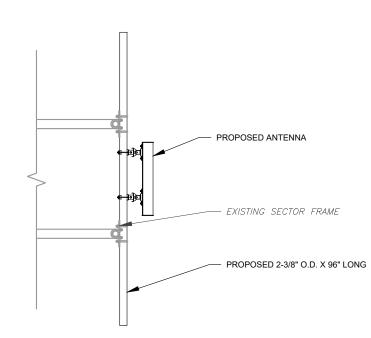
ANTENNA INFORMATION & SCHEDULE

SHEET NUMBER:

C-401





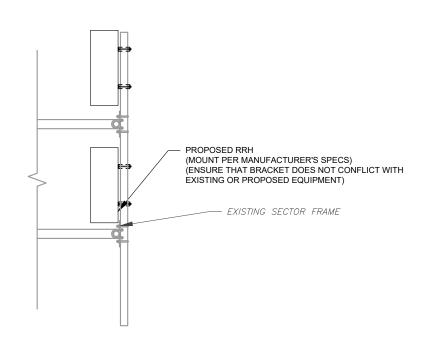

1 PROPOSED OVP MOUNTING
SCALE: N.T.S

PROPOSED RRH MOUNTING DETAIL - TYPICAL SCALE: N.T.S.

PROPOSED 5G ANTENNA MOUNTING DETAIL - TYPICAL

SCALE: N.T.S

AMERICAN TOWER®



Dewberry Engineers Inc.

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FAX: 617.695.3310

REV.	DESCRIPTION	BY	DATE
\mathbb{A}_{-}	PRELIM	PMG	05/14/21
\wedge	FINAL	EA	06/15/21
$ \overline{\wedge} $			
\square			

283424

ATC SITE NAME: WATERTOWN CT

VERIZON SITE NAME:

WATERTOWN NE CT

SITE ADDRESS: 655 BASSETT RD. WATERTOWN, CT 06795






DATE DRAWN:	05/14/21
ATC JOB NO:	13668995
CUSTOMER ID:	WATERTOWN NE CT
CUSTOMER #:	470386

CONSTRUCTION DETAILS


SHEET NUMBER:

C-501

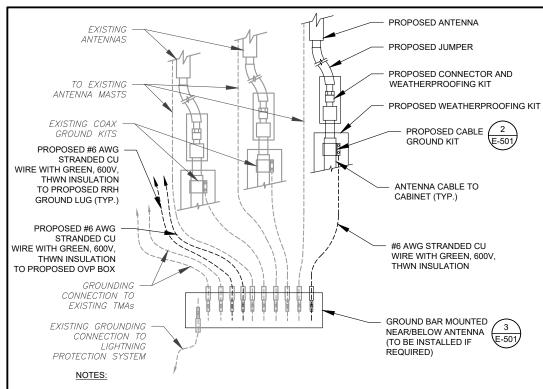

- THIS DETAIL IS INTENDED TO SHOW THE GENERAL GROUNDING REQUIREMENTS. SLIGHT ADJUSTMENTS MAY BE REQUIRED BASED ON EXISTING SITE CONDITIONS. THE CONTRACTOR SHALL MAKE FIELD ADJUSTMENTS AS NEEDED AND INFORM THE CONSTRUCTION MANAGER OF ANY CONFLICTS.
- SITE GROUNDING SHALL COMPLY WITH VERIZON GROUNDING STANDARDS, LATEST EDITION, AND COMPLY WITH VERIZON GROUNDING CHECKLIST, LATEST VERSION. WHEN NATIONAL AND LOCAL GROUNDING CODES ARE MORE STRINGENT THEY SHALL GOVERN.



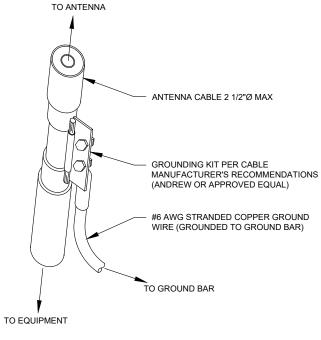


SROLIND KIT NOTES:

- DO NOT INSTALL CABLE GROUND KIT AT A BEND AND ALWAYS DIRECT GROUND WIRE DOWN TO GROUND BAR.
- 2. CONTRACTOR SHALL PROVIDE WEATHERPROOFING KIT (ANDREW PART NUMBER 221213) AND INSTALL/TAPE PER MANUFACTURER'S SPECIFICATIONS.



SCALE: N.T.S.

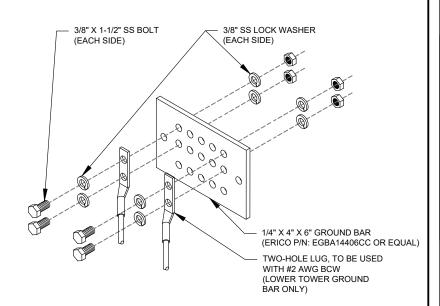

GROUND BAR NOTES:

- GROUND BAR KITS COME WITH ALL HARDWARE, NUTS, BOLTS, WASHERS, ETC. EXCEPT THE STRUCTURAL MOUNTING MEMBER(S).
- 2. GROUND BAR TO BE BONDED DIRECTLY TO TOWER.







Dewberry Engineers Inc.
99 SUMMER STREET

SUITE 700 BOSTON, MA 02110 PHONE: 617.531.0801 FAX: 617.695.3310

REV.	DESCRIPTION	BY	DATE
<u>A</u>	PRELIM	PMG	05/14/21
<u></u>	FINAL	EA_	06/15/21
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verizon[/]


DATE DRAWN:	05/14/21
ATC JOB NO:	13668995
CUSTOMER ID:	WATERTOWN NE CT
CUSTOMER #:	470386

GROUNDING DETAILS

SHEET NUMBER:

E-501


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ANTENNA SPECIFICATIONS FOR ILLUSTRATIVE PURPOSES ONLY - NOT TO SCALE

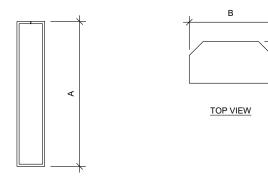ANTENNA SPECIFICATIONS				
ANTENNA MODEL	А	В	С	WEIGHT (LBS)
MT6407-77A	35.1"	16.1"	5.5"	81.6



RRH SPECIFICATIONS

FOR ILLUSTRATIVE PURPOSES ONLY - NOT TO SCALE

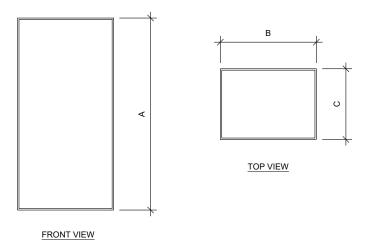RRH SPECIFICATIONS				
RRH MODEL	А	В	С	WEIGHT (LBS)
B2/B66A RRH-BR049	15.0"	15.0"	10.0"	84.4
B5/B13 RRH-BR04C	15.0"	15.0"	8.1"	70.3





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ı		
ı	DATE DRAWN:	05/14/21
ı	ATC JOB NO:	13668995
ı	CUSTOMER ID:	WATERTOWN NE CT
ı	CUSTOMER #:	470386

SUPPLEMENTAL

SHEET NUMBER:

R-601





Maser Consulting Connecticut 2000 Midlantic Drive, Suite 100 Mt. Laurel, NJ 08054 856.797.0412 Peter.Albano@colliersengineering.com

Antenna Mount Analysis Report and PMI Requirements

Mount Analysis

SMART Tool Project #: 10050449 Maser Consulting Connecticut Project #: 21777471A

May 19, 2021

Site Information Site ID: 470386-VZW/

Site Name: WATERTOWN NE CT - American Tower
WATERTOWN NE CT - American Tower

Carrier Name: Verizon Wireless

Address: 655 Bassett Rd

Watertown, Connecticut 06795

Litchfield County
Latitude: 41.65707778°
Longitude: -73.13626111°

Structure Information Tower

Tower Type: Monopole
Mount Type: 12.50-Ft T-Arm

FUZE ID # 16272135

Analysis Results

T-Arm: 63.3% Pass

***Contractor PMI Requirements:

Included at the end of this MA report
Available & Submitted via portal at https://pmi.vzwsmart.com
Contractor - Please Review Specific Site PMI Requirements Upon Award
Requirements also Noted on Mount Modification Drawings
Requirements may also be Noted on A & E drawings

Report Prepared By: Abigail Enriquez



Mount Structural Analysis Report (3) 12.50-Ft T-Arms May 19, 2021 Site ID: 470386-VZW / WATERTOWN NE CT - American Tower Page | 4

- All services are performed, results obtained, and recommendations made in accordance with generally accepted engineering principles and practices. Maser Consulting Connecticut is not responsible for the conclusion, opinions, and recommendations made by others based on the information supplied.
- Structural Steel Grades have been assumed as follows, if applicable, unless otherwise noted in this analysis:

Channel, Solid Round, Angle, Plate
 HSS (Rectangular)
 Pipe
 Threaded Rod
 Bolts
 ASTM A36 (Gr. 36)
 ASTM 500 (Gr. B-46)
 ASTM A53 (Gr. B-35)
 F1554 (Gr. 36)
 ASTM A325

Discrepancies between in-field conditions and the assumptions listed above may render this analysis invalid unless explicitly approved by Maser Consulting Connecticut.

Analysis Results:

Component	Utilization %	Pass/Fail
Tiebacks	16.5%	Pass
Kickers	9.4%	Pass
Support Rail	34.5%	Pass
Antenna Pipe	63.3%	Pass
Horizontal	56.4%	Pass
Standoff Pipe	0.0%	Pass
Standoff Arm	28.9%	Pass
Connection Check - Mount	36.7%	Pass
Connection Check - Kickers	14.3%	Pass

Structure Rating – (Controlling Utilization of all Components)	63.3%
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Recommendation:

The existing mounts are SUFFICIENT for the final loading configuration and do not require modifications.

ANSI/ASSP rigging plan review services compliant with the requirements of ANSI/TIA 322 are available for a Construction Class IV site or other, if required. Separate review fees will apply.

Attachments:

- 1. Mount Photos
- 2. Mount Mapping Report (for reference only)
- 3. Analysis Calculations
- 4. Contractor Required Post Installation Inspection (PMI) Report Deliverables
- 5. Antenna Placement Diagrams
- 6. TIA Adoption and Wind Speed Usage Letter





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 470386

SUPPLEMENTAL

SHEET NUMBER:

R-602