From: Daniel Hatab <daniel.hatab@ramapocom.com>

Sent: Friday, April 2, 2021 10:34 AM

**To:** CSC-DL Siting Council <Siting.Council@ct.gov> **Subject:** EM-CING-153-201105 (AT&T Site CTL01835)

Good Morning,

The site below has been completed on 3/19, CSC letter is attached for reference and also CCA letter.

AT&T Site: CTL01835

Address: 655 Bassett Road, Watertown CT 06795

Thank You,

# Daniel Hatab

daniel.hatab@ramapocom.com
20 Romanelli Ave, S. Hackensack, NJ 07606

Cell Phone: (201) 742-1070 Office Phone: (201) 343-2995



Date: March 30, 2021

State of Connecticut Connecticut Siting Council Ten Franklin Square New Britain, Ct. 06051 Phone: (860) 827-2935

SMW Engineering Group, Inc. 158 Business Center Dr Birmingham AL. 35244 (205) 252-6985

RE: EM-CING-153-201105

Subject: Special Inspection Letter – Final Certification

ATC Site: Watertown CT – 283424

AT&T site: CTL01835 – FA:10128117

Site Address: 655 Bassett Road

Watertown, Ct. 06795-1139

AT&T Scope of work: 3C,4C,4TX4RX Retrofit, 5G NR – Antenna Amendment Drawings

SMW Engineering Project: 20-10237.1

Dear Sir or Madam,

On March 30, 2021, SMW Engineering Group, Inc., reviewed detailed photographs of the AT&T telecommunication facility located at the above referenced site. The purpose of these pictures was to inspect the installation in accordance with the following codes:

- International Building Code (IBC)
- National Electric Code (NEC)
- Local Building Code
- City / County Ordinances

# Proposed scope of work on tower from Construction Drawings:

- Removal of (6) existing Andrew SBNH-1D6565C antennas (2) per sector
- Relocate of (3) existing CCI HPA-65R-BUU-H8 antennas (1) per sector
- Removal of (6) existing RRUS-11 B12 (2) per sector
- Removal of (3) existing RRUS-12 B2 + A2 B25 (1) per sector
- Installation of Site Pro 1 Handrail Kit Part # HRK12 Typ. of (3) sectors
- Installation of Site Pro 1 Crossover Plates Part number SCX1-K Typ. of (3) sectors
- Installation of (3) new CCI OPA65R-BU8DA antennas (1) per sector
- Installation of (3) new CCI DMP65R-BU8DA antennas (1) per sector

- Installation of (3) RRUS 11 B5 (1) per sector
- Installation of (3) RRUS 4449 B5/B12 (1) per sector
- Installation of (3) RRUS 4478 B14 (1) per sector
- Installation of (3) RRUS 8843 B2/B66A (1) per sector
- Installation of (1) DC2-48-60-8-18F-02 squid

# **Discrepancies from Permitted Drawings:**


None


To the best of our knowledge, belief, and professional judgment, the connections of the installed equipment were performed **in substantial compliance** with the approved construction drawings prepared by SMW Engineering Group, Inc. dated 11-30-20.

Should you have any questions or wish to discuss any aspect of this letter, please do not hesitate to contact the undersigned.

Sincerely,

John T. Liu, PE **SMW Engineering Group, INC.** Principal Engineer Connecticut Registration #33076

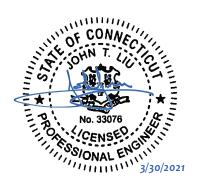

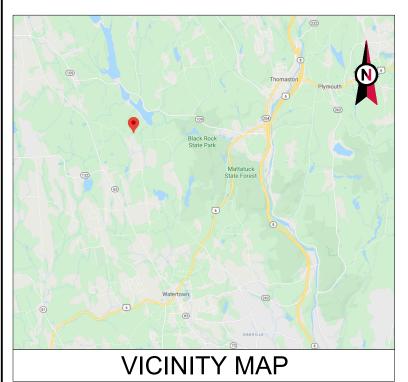



# **AMERICAN TOWER®**

ATC SITE NAME: WATERTOWN CT

ATC SITE NUMBER: 283424

AT&T PACE NUMBER: MRCTB046623/MRCTB046543/

MRCTB046501/MRCTB046499/MRCTB046647

AT&T SITE ID: CTL01835 AT&T FA CODE:10128117

AT&T SITE NAME: WATERTOWN BASSETT ROAD

PROJECTS: 3C/4C/4TX4RX RETROFIT/5G NR


SITE ADDRESS: 655 BASSETT ROAD

WATERTOWN, CT 06795-1139

# AT&T MOBILITY ANTENNA AMENDMENT DRAWINGS



**LOCATION MAP** 

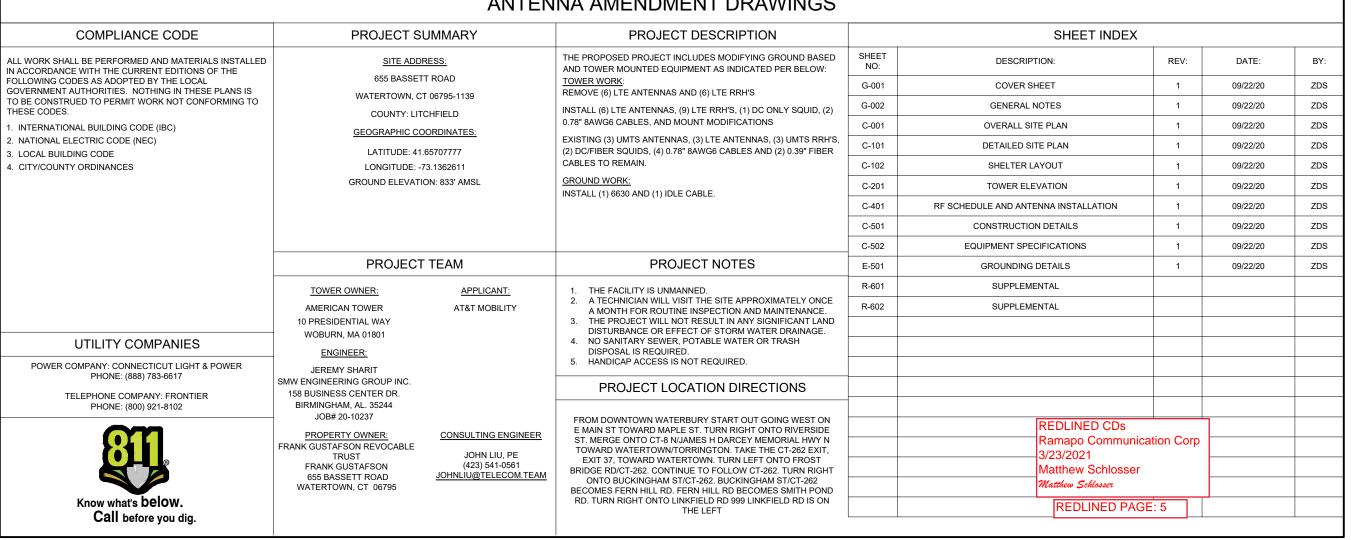





1506 THER PLANNING A BETTER TOMORROY 158 BUSINESS CENTER DRIVE BIRMINGHAM, AL 35244 TEL: 205-252-6985 FAX: 205-320-1504

REV.	DESCRIPTION	BY	DATE
$\Lambda_{-}$	FOR CONSTRUCTION	ZDS	09/22/20
$\Lambda_{-}$			
$\overline{\wedge}^{-}$			
$\overline{\wedge}$			
$\square$			

ATC SITE NUMBER

283424

ATC SITE NAME:

# WATERTOWN CT

SITE ADDRESS: 655 BASSETT ROAD WATERTOWN, CT 06795-1139



	AT&T
DATE DRAWN:	05/29/20

DATE DRAWN: 05/29/20
ATC JOB NO: 283424
CUSTOMER ID: 10128117
CUSTOMER #: 20-10237

**COVER SHEET** 

SHEET NUMBER:

G-001

#### **GENERAL CONSTRUCTION NOTES:**

- OWNER FURNISHED MATERIALS, AT&T MOBILITY "THE COMPANY" WILL PROVIDE AND THE  $\,$  22. CONTRACTOR WILL INSTALL
- A. BTS EQUIPMENT FRAME (PLATFORM) AND ICEBRIDGE SHELTER (GROUND BUILD/CO-LOCATE ONLY)
- AC/TELCO INTERFACE BOX (PPC)
- ICE BRIDGE (CABLE TRAY WITH COVER) (GROUND BUILD/CO-LOCATE ONLY, GC TO FURNISH AND INSTALL FOR ROOFTOP INSTALLATION)
- D. TOWERS, MONOPOLES
- TOWER LIGHTING
- GENERATORS & LIQUID PROPANE TANK
- ANTENNA STANDARD BRACKETS, FRAMES AND PIPES FOR MOUNTING
- ANTENNAS (INSTALLED BY OTHERS)
- TRANSMISSION LINE
- TRANSMISSION LINE JUMPERS
- TRANSMISSION LINE CONNECTORS WITH WEATHERPROOFING KITS
- TRANSMISSION LINE GROUND KITS
- HANGERS
- HOISTING GRIPS
- O. BTS EQUIPMENT
- THE CONTRACTOR IS RESPONSIBLE TO PROVIDE ALL OTHER MATERIALS FOR THE COMPLETE INSTALLATION OF THE SITE INCLUDING, BUT NOT LIMITED TO, SUCH
  MATERIALS AS FENCING, STRUCTURAL STEEL SUPPORTING SUB-FRAME FOR PLATFORM ROOFING LABOR AND MATERIALS GROUNDING RINGS GROUNDING WIRES COPPER-CLAD OR XIT CHEMICAL GROUND ROD(S), BUSS BARS, TRANSFORMERS AND DISCONNECT SWITCHES WHERE APPLICABLE, TEMPORARY ELECTRICAL POWER, CONDUIT, LANDSCAPING COMPOUND STONE, CRANES, CORE DRILLING, SLEEPERS AND RUBBER MATTING, REBAR, CONCRETE CAISSONS, PADS AND/OR AUGER MOUNTS,
  MISCELLANEOUS FASTENERS, CABLE TRAYS, NON-STANDARD ANTENNA FRAMES AND ALL OTHER MATERIAL AND LABOR REQUIRED TO COMPLETE THE JOB ACCORDING TO THE DRAWINGS AND SPECIFICATIONS. IT IS THE POSITION OF AT&T MOBILITY TO APP FOR PERMITTING AND CONTRACTOR RESPONSIBLE FOR PICKUP AND PAYMENT OF
- ALL WORK SHALL CONFORM TO ALL CURRENT APPLICABLE FEDERAL, STATE, AND LOCAL CODES, INCLUDING ANSI/EIA/TIA-222, AND COMPLY WITH ATC CONSTRUCTION
- CONTRACTOR SHALL CONTACT LOCAL 811 FOR IDENTIFICATION OF UNDERGROUND
- CONTRACTOR SHALL BE RESPONSIBLE FOR COORDINATING ALL REQUIRED INSPECTIONS.
- ALL DIMENSIONS TO, OF, AND ON EXISTING BUILDINGS, DRAINAGE STRUCTURES, AND SITE IMPROVEMENTS SHALL BE VERIFIED IN FIELD BY CONTRACTOR WITH ALL DISCREPANCIES REPORTED TO THE ENGINEER.
- DO NOT CHANGE SIZE OR SPACING OF STRUCTURAL ELEMENTS
- DETAILS SHOWN ARE TYPICAL; SIMILAR DETAILS APPLY TO SIMILAR CONDITIONS UNLESS 32.
- THESE DRAWINGS DO NOT INCLUDE NECESSARY COMPONENTS FOR CONSTRUCTION SAFETY WHICH SHALL BE THE SOLE RESPONSIBILITY OF THE CONTRACTOR
- CONTRACTOR SHALL BRACE STRUCTURES UNTIL ALL STRUCTURAL ELEMENTS NEEDED 33. FOR STABILITY ARE INSTALLED. THESE ELEMENTS ARE AS FOLLOWS: LATERAL BRACING,
- CONTRACTOR SHALL DETERMINE EXACT LOCATION OF EXISTING UTILITIES, GROUNDS DRAINS, DRAIN PIPES, VENTS, ETC, BEFORE COMMENCING WORK
- INCORRECTLY FABRICATED, DAMAGED, OR OTHERWISE MISFITTING OR NONCONFORMING MATERIALS OR CONDITIONS SHALL BE REPORTED TO THE AT&T MOBILITY REP PRIOR TO REMEDIAL OR CORRECTIVE ACTION. ANY SUCH REMEDIAL ACTION SHALL REQUIRE WRITTEN APPROVAL BY THE AT&T MOBILITY REP PRIOR TO
- EACH CONTRACTOR SHALL COOPERATE WITH THE AT&T MOBILITY REP, AND COORDINATE HIS WORK WITH THE WORK OF OTHERS
- CONTRACTOR SHALL REPAIR ANY DAMAGE CAUSED BY CONSTRUCTION OF THIS PROJECT TO MATCH EXISTING PRE-CONSTRUCTION CONDITIONS TO THE SATISFACTION OF THE AT&T MOBILITY CONSTRUCTION MANAGER.
- ALL CABLE/CONDUIT ENTRY/EXIT PORTS SHALL BE WEATHERPROOFED DURING
- WHERE EXISTING CONDITIONS DO NOT MATCH THOSE SHOWN IN THIS PLAN SET, CONTRACTOR SHALL NOTIFY THE AT&T MOBILITY REP AND ENGINEER OF RECORD
- CONTRACTOR SHALL ENSURE ALL SUBCONTRACTORS ARE PROVIDED WITH A COMPLETE AND CURRENT SET OF DRAWINGS AND SPECIFICATIONS FOR THIS PROJECT.
- CONTRACTOR SHALL REMOVE ALL RUBBISH AND DEBRIS FROM THE SITE AT THE END OF
- CONTRACTOR SHALL COORDINATE WORK SCHEDULE WITH AMERICAN TOWER CORPORATION (ATC) AND TAKE PRECAUTIONS TO MINIMIZE IMPACT AND DISRUPTION OF OTHER OCCUPANTS OF THE FACILITY.
- CONTRACTOR SHALL FURNISH AT&T MOBILITY AND AMERICAN TOWER CORPORATION (ATC) WITH A PDF MARKED UP AS-BUILT SET OF DRAWINGS UPON COMPLETION OF
- PRIOR TO SUBMISSION OF BID, CONTRACTOR SHALL COORDINATE WITH AT&T MOBILITY REP TO DETERMINE WHAT, IF ANY, ITEMS WILL BE PROVIDED. ALL ITEMS NOT PROVIDED SHALL BE PROVIDED AND INSTALLED BY THE CONTRACTOR. CONTRACTOR WILL INSTALL 2. ALL EXTERIOR #6 GREED GROUND WIRE "DAISY CHAIN" CONNECTIONS ARE TO BE

- ALL ITEMS PROVIDED.
- PRIOR TO SUBMISSION OF BID. CONTRACTOR SHALL COORDINATE WITH AT&T MOBILITY REP TO DETERMINE IF ANY PERMITS WILL BE OBTAINED BY CONTRACTOR. ALL
  REQUIRED PERMITS NOT OBTAINED BY AT&T MOBILITY MUST BE OBTAINED, AND PAID
- 23. CONTRACTOR SHALL INSTALL ALL SITE SIGNAGE IN ACCORDANCE WITH AT&T MOBILITY
- CONTRACTOR SHALL SUBMIT ALL SHOP DRAWINGS TO AT&T MOBILITY FOR REVIEW AND APPROVAL PRIOR TO FABRICATION.
- 25. ALL EQUIPMENT SHALL BE INSTALLED ACCORDING TO MANUFACTURER'S SPECIFICATIONS AND LOCATED ACCORDING TO AT&T MOBILITY SPECIFICATIONS, AND AS SHOWN IN THESE PLANS.
- THE CONTRACTOR SHALL SUPERVISE AND DIRECT THE PROJECT DESCRIBED HEREIN. THE CONTRACTOR SHALL BE SOLELY RESPONSIBLE FOR ALL THE CONSTRUCTION MEANS, METHODS, TECHNIQUES, SEQUENCES AND PROCEDURES AND FOR COORDINATING ALL PORTIONS OF THE WORK UNDER THE CONTRACT.
- 27. CONTRACTOR SHALL NOTIFY AT&T MOBILITY REP A MINIMUM OF 48 HOURS IN ADVANCE OF POURING CONCRETE OR BACKFILLING ANY UNDERGROUND UTILITIES, FOUNDATIONS OR SEALING ANY WALL, FLOOR OR ROOF PENETRATIONS FOR ENGINEERING REVIEW
- CONTRACTOR SHALL BE RESPONSIBLE FOR SITE SAFETY INCLUDING COMPLIANCE WITH ALL APPLICABLE OSHA STANDARDS AND RECOMMENDATIONS AND SHALL PROVIDE ALL NECESSARY SAFETY DEVICES INCLUDING PPE AND PPM AND CONSTRUCTION DEVICES SUCH AS WELDING AND FIRE PREVENTION, TEMPORARY SHORING, SCAFFOLDING TRENCH BOXES/SLOPING, BARRIERS, ETC.
- THE CONTRACTOR SHALL PROTECT AT HIS OWN EXPENSE, ALL EXISTING FACILITIES AND SUCH OF HIS NEW WORK LIABLE TO INJURY DURING THE CONSTRUCTION PERIOD. ANY DAMAGE CAUSED BY NEGLECT ON THE PART OF THIS CONTRACTOR OR HIS REPRESENTATIVES, OR BY THE ELEMENTS DUE TO NEGLECT ON THE PART OF THIS CONTRACTOR OR HIS REPRESENTATIVES. FITHER TO THE EXISTING WORK, OR TO HIS WORK OR THE WORK OF ANY OTHER CONTRACTOR, SHALL BE REPAIRED AT HIS EXPENSE TO THE OWNER'S SATISFACTION.
- 30. ALL WORK SHALL BE INSTALLED IN A FIRST CLASS, NEAT AND WORKMANLIKE MANNER BY MECHANICS SKILLED IN THE TRADE INVOLVED. THE QUALITY OF WORKMANSHIP SHALL BE SUBJECT TO THE APPROVAL OF THE AT&T MOBILITY REP. ANY WORK FOUND BY THE AT&T MOBILITY, REP TO BE OF INFERIOR QUALITY AND/OR WORKMANSHIP SHALL BE REPLACED AND/OR REWORKED AT CONTRACTOR EXPENSE UNTIL APPROVAL IS
- IN ORDER TO ESTABLISH STANDARDS OF QUALITY AND PERFORMANCE, ALL TYPES OF MATERIALS LISTED HEREINAETER BY MANUFACTURER'S NAMES AND/OF MANUFACTURER'S CATALOG NUMBER SHALL BE PROVIDED BY THESE MANUFACTURERS
- AT&T MOBILITY FURNISHED EQUIPMENT SHALL BE PICKED-UP AT THE AT&T MOBILITY WAREHOUSE, NO LATER THAN 48HR AFTER BEING NOTIFIED INSURED, STORED, UNCRATE, PROTECTED AND INSTALLED BY THE CONTRACTOR WITH ALL APPURTENANCES REQUIRED TO PLACE THE EQUIPMENT IN OPERATION, READY FOR USE. THE CONTRACTOR SHALL BE RESPONSIBLE FOR THE EQUIPMENT AFTER PICKING IT
- AT&T MOBILITY OR HIS ARCHITECT/ENGINEER RESERVES THE RIGHT TO REJECT ANY FOLIPMENT OR MATERIALS WHICH, IN HIS OWN OPINION ARE NOT IN COMPLIANCE WITH THE CONTRACT DOCUMENTS, EITHER BEFORE OR AFTER INSTALLATION AND THE EQUIPMENT SHALL BE REPLACED WITH EQUIPMENT CONFORMING TO THE REQUIREMENTS OF THE CONTRACT DOCUMENTS BY THE CONTRACTOR AT NO COST TO AT&T MOBILITY OR THEIR ARCHITECT/ENGINEER

# SPECIAL CONSTRUCTION ANTENNA INSTALLATION NOTES:

- WORK INCLUDED
  - ANTENNA AND COAXIAL CABLES ARE FURNISHED BY AT&T MOBILITY UNDER A SEPARATE CONTRACT. THE CONTRACTOR SHALL ASSIST ANTENNA INSTALLATION CONTRACTOR IN TERMS OD COORDINATION AND SITE ACCESS. ERECTION SUBCONTRACTOR SHALL BE RESPONSIBLE FOR THE PROTECTION OF
  - B. INSTALL ANTENNA AS INDICATE ON DRAWINGS AND AT&T MOBILITY
  - C. INSTALL GALVANIZED STEEL ANTENNA MOUNTS AS INDICATED ON DRAWINGS
  - D. INSTALL FURNISHED GALVANIZED STEEL OR ALUMINUM WAVEGUIDE AND PROVIDE PRINTOUT OF THAT TEST.
  - E. CONTRACTOR SHALL PROVIDE FOUR (4) SETS OF SWEEP TESTS USING ANRITZU-PACKARD 8713B RF SCALAR NETWORK ANALYZER. SUBMIT FREQUENCY DOMAIN REFLECTOMETER(FDR) TESTS RESULTS TO THE PROJECT MANAGER. SWEEP TESTS SHALL BE AS PER ATTACHED RES "MINIMUM FIELD TESTING RECOMMENDED FOR ANTENNA AND HELIAX COAXIAL CABLE SYSTEMS" DATED 10/5/93. TESTING SHALL BE PERFORMED BY AN INDEPENDENT TESTING SERVICE AND BE BOUND AND SUBMITTED WITHIN ONE WEEK OF WORK COMPLETION.
  - INSTALL COAXIAL CABLES AND TERMINATING BETWEEN ANTENNAS AND EQUIPMENT PER MANUFACTURER'S RECOMMENDATIONS. WEATHERPROOF ALL CONNECTIONS RETWEEN THE ANTENNA AND FOLIPMENT PER MANUFACTURER'S REQUIREMENTS. TERMINATE ALL COAXIAL CABLE THREE (3) FEET IN EXCESS OF ENTRY PORT LOCATION UNLESS OTHERWISE STATED.
  - G. ANTENNA AND COAXIAL CABLE GROUNDING:

WEATHER SEALED WITH RFS CONNECTORS/SPLICE WEATHERPROOFING KIT #221213 OR

ALL COAXIAL CABLE GROUNDING KITS ARE TO BE INSTALLED ON STRAIGHT RUNS OF COAXIAL CABLE (NOT WITHIN BENDS)

> REDLINED CDs Ramapo Communication Corp 3/23/2021 Matthew Schlosser Matthew Schlosser

ALL DISCREPANCIES FROM WHAT IS SHOWN ON THESE CONSTRUCTION DRAWINGS SHALL BE COMMUNICATED TO ATC ENGINEERING IMMEDIATELY FOR CORRECTION OR RE-DESIGN. FAILURE TO COMMUNICATE DIRECTLY WITH ATC ENGINEERING OR ANY CHANGES FROM THE DESIGN CONDUCTED WITHOUT PRIOR APPROVAL FROM ATC ENGINEERING SHALL BE THE SOLE RESPONSIBILITY OF THE GENERAL CONTRACTOR.

**AMERICAN TOWER** 



together planning a better tomorrow 158 BUSINESS CENTER DRIVE BIRMINGHAM AL 35244 TEL: 205-252-6985 FAX: 205-320-1504

DESCRIPTION BY DATE FOR CONSTRUCTION

ATC SITE NUMBER:

283424

ATC SITE NAME:

WATERTOWN CT

SITE ADDRESS: 655 BASSETT ROAD WATERTOWN, CT 06795-1139

CONNECT OF CONNECTION CENSED CHE SS/ONAL ENGIN 9/22/2020



DATE DRAWN: | 05/29/20 ATC JOB NO: CUSTOMER ID: 10128117 CUSTOMER #: 20-10237

**GENERAL NOTES** 

SHEET NUMBER:


G-002

### SITE PLAN NOTES:

PP

TRN


- THIS SITE PLAN REPRESENTS THE BEST PRESENT KNOWLEDGE AVAILABLE TO THE ENGINEER AT THE TIME OF THIS DESIGN. THE CONTRACTOR SHALL VISIT THE SITE PRIOR TO CONSTRUCTION AND VERIFY ALL EXISTING CONDITIONS RELATED TO THE SCOPE OF WORK FOR THIS PROJECT.
- ICE BRIDGE, CABLE LADDER, COAX PORT, AND COAX CABLE ARE SHOWN FOR REFERENCE ONLY, CONTRACTOR SHALL CONFIRM THE EXACT LOCATION OF ALL PROPOSED AND EXISTING EQUIPMENT AND STRUCTURES DEPICTED ON THIS PLAN. BEFORE UTILIZING EXISTING CABLE SUPPORTS, COAX PORTS, INSTALLING NEW

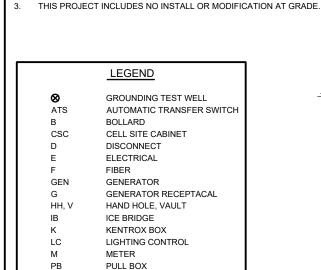

POWER POLE TELCO

TRANSFORMER


CHAINLINK FENCE

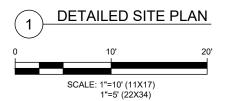



#### PROPOSED CABLE LENGTH:

- ESTIMATED LENGTH OF PROPOSED CABLE IS <u>171'</u>. ESTIMATED LENGTH OF CABLE WAS PROVIDED BY CUSTOMER OR CALCULATED BY ADDING THE RAD CENTER AND THE DISTANCE FROM THE SHELTER ENTRY PLATE TO THE TOWER (ALONG THE ICE BRIDGE) AND A SAFETY FACTOR MEASUREMENT OF 15% (OF THE TWO PREVIOUS VALUES), CDS DEFER TO GREATEST CABLE LENGTH.
- ROUTE PROPOSED CABLES ALONG SAME PATH AS EXISTING CABLES AND IN ACCORDANCE WITH STRUCTURAL ANALYSIS. WHERE POSSIBLE UTILIZE EXISTING CABLE SUPPORT STRUCTURES AS PROVIDED FOR CARRIER TO ADEQUATELY SECURE CABLES, USING EITHER APPROPRIATELY SIZED STAINLESS STEEL SNAP-INS OR MOUNTING HARDWARE AND BRACKETS AS SPECIFIED BY CABLE MANUFACTURER. OTHERWISE, ATTACH CABLES TO HORIZONTAL OR DIAGONAL TOWER MEMBERS USING PROPOSED STAINLESS STEEL ADAPTERS (DO NOT ATTACH TO TOWER LEG).

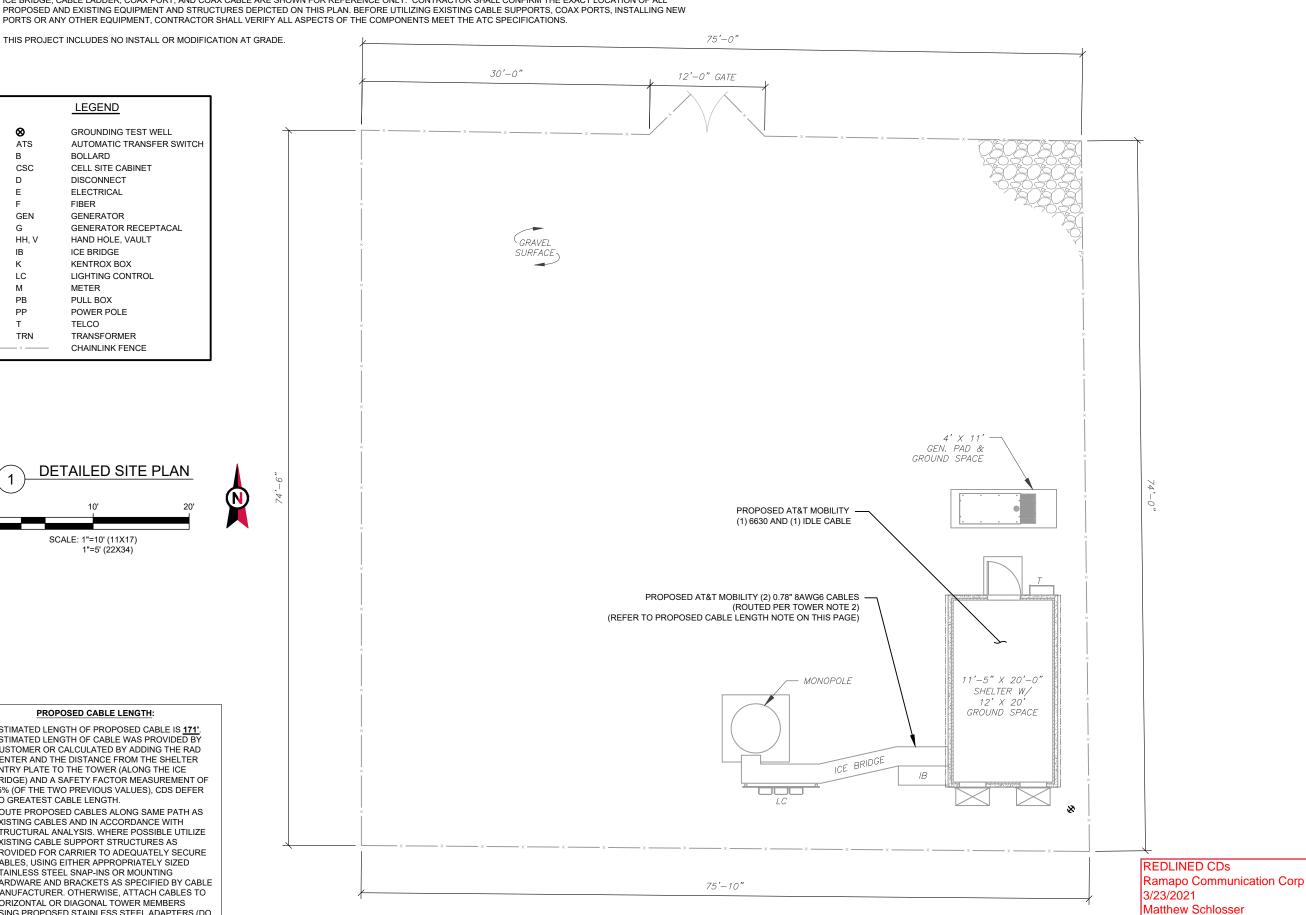





# together planning a better tomorrow

158 BUSINESS CENTER DRIVE BIRMINGHAM, AL 35244 TEL: 205-252-6985 FAX: 205-320-1504

DESCRIPTION	BY	DATE
FOR CONSTRUCTION	ZDS	09/22/20

ATC SITE NUMBER:

283424

ATC SITE NAME:

# WATERTOWN CT

SITE ADDRESS: 655 BASSETT ROAD WATERTOWN, CT 06795-1139

SONAL ENGINEERS (19/22/2020




DATE DRAWN:	05/29/20
ATC JOB NO:	283424
CUSTOMER ID:	10128117
CUSTOMER #:	20-10237

# **DETAILED SITE PLAN**

SHEET NUMBER:

Matthew Schlosser

C-101

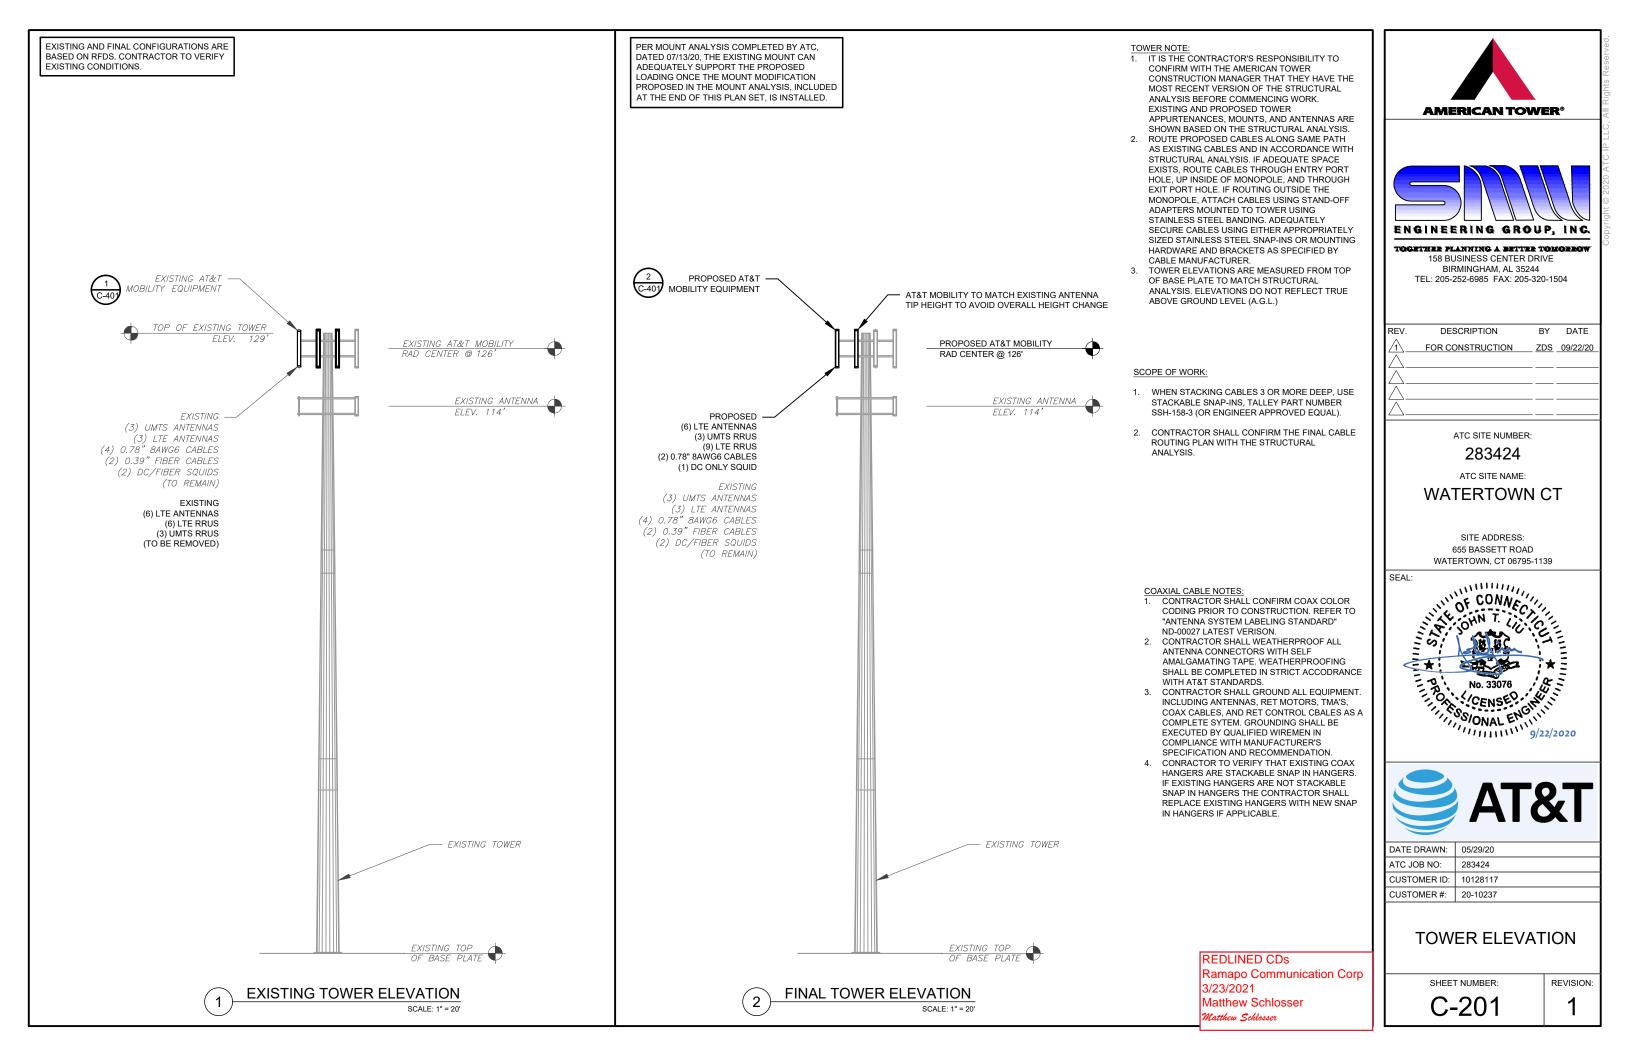

EXISTING AND FINAL CONFIGURATIONS ARE BASED ON RFDS. CONTRACTOR TO VERIFY EXISTING CONDITIONS.

EXISTING UMTS ANTENNA TO REMAIN -

(TYP. 1 PER SECTOR, 3 TOTAL)

CAMMA

 $AZ. = 270^{\circ}$ 

GAMMA

 $AZ. = 270^{\circ}$ 

GAMMA

GAMMA

(TYP. 2 PER SECTOR, 6 TOTAL)

EXISTING LTE RRU TO BE REMOVED


EXISTING LTE UMTS TO BE REMOVED -


(TYP. 1 PER SECTOR, 3 TOTAL)



PER MOUNT ANALYSIS COMPLETED BY ATC, DATED 07/13/20, THE EXISTING MOUNT CAN ADEQUATELY SUPPORT THE PROPOSED LOADING ONCE THE MOUNT MODIFICATION PROPOSED IN THE MOUNT ANALYSIS, INCLUDED AT THE END OF THIS PLAN SET, IS INSTALLED.



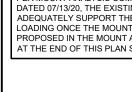

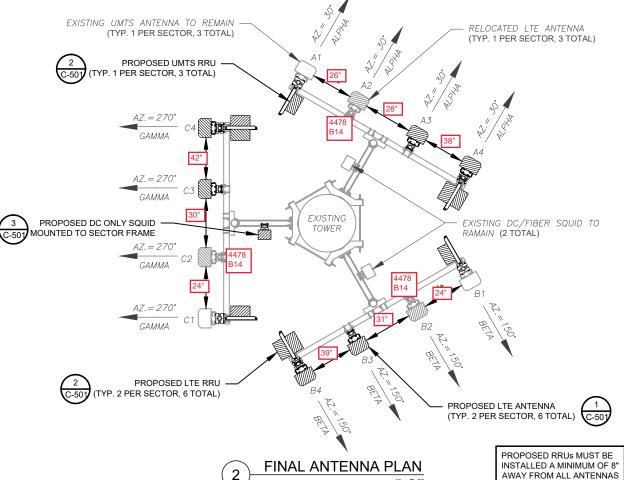

EXISTING LTE ANTENNA TO BE RELOCATED -(TYP. 1 PER SECTOR, 3 TOTAL) **CURRENT ANTENNA PLAN** FINAL ANTENNA SCHEDULE

LO	CATION			ANTENNA S	SUMMARY		NON ANTENNA SUMMAR	Y	ıŀ
SECTOR	RAD	AZ	POS	ANTENNA	BAND	STATUS	ADDITIONAL TOWER MOUNTED EQUIPMENT	STATUS	
			A1	SBNH-1D6565C	UMTS	RMN	RRUS-11 B12	RMV	П
			A2	SBNH-1D6565C	LTE	RMV	_	_	
ALPHA	126'	30°	A3	SBNH-1D6565C	LTE	RMV	_	_	П
				LIDA CED DUILLIO	LTE	DEL	RRUS-11 B12	RMV	
			A4	HPA-65R-BUU-H8	LTE	REL	RRUS-12 B2+A2 B25	RMV	
			B1	SBNH-1D6565C	UMTS	RMN	RRUS-11 B12	RMV	
			B2	SBNH-1D6565C	LTE	RMV	_	_	
BETA	126'	150°	<i>B3</i>	SBNH-1D6565C	LTE	RMV	_	_	
			0.4	LIDA CED DUILLIO	LTE	REL	RRUS-11 B12	RMV	
			B4	HPA-65R-BUU-H8	LTE	KEL	RRUS-12 B2+A2 B25	RMV	
			C1	SBNH-1D6565C	UMTS	RMN	RRUS-11 B12	RMV	
			C2	SBNH-1D6565C	LTE	RMV	_	_	
GAMMA	126'	270°	C3	SBNH-1D6565C	LTE	RMV	_	_	,  ;
							RRUS-11 B12	RMV	П

LTE

TOWER

EXISTING FIBER DISTRIBUTION	EXISTING CABLING SUMMARY				
MODEL NUMBER	STATUS	COAX	DC	FIBER	STATUS
(2) DC2-48-60-8-18F-02	RMN	_	(4) 0.78"	(2) 0.39"	RMN
-	-	_	-	_	-

HPA-65R-BUU-H8

C4

RMV: TO BE REMOVED RMN: TO REMAIN

RRUS-12 B2+A2 B25

REL

REL: TO BE RELOCATED DSC: TO BE DISCONNECTED & REMAIN ADD: TO BE ADDED

STATUS ABBREVIATIONS

RMV

EXISTING DC/FIBER SQUID TO

EXISTING LTE ANTENNA TO BE REMOVED

(TYP. 1 PER SECTOR, 3 TOTAL)

RAMAIN (2 TOTAL)

NOTES	
BASED ON APPROVED ATC	LO
APPLICATION 283424, DATED 05/08/20. CONFIRM WITH AT&T	SECTOR
MOBILITY REP FOR APPLICABLE UPDATES/REVISIONS AND MOST RECENT RFDS FOR NSN CONFIGURATION (CONFIG). GC TO CAP ALL UNUSED PORTS. ATC HAS NOT YET VERIFIED ANY EXISTING ANTENNA CONFIG OR	ALPHA
MOUNT CONFIG. CONTRACTOR TO VERIFY MOUNT CONFIG HAS SUFFICIENT SPACE FOR PROPOSED LESSEE EQUIPMENT	

ATC HAS NOT YET VER EXISTING ANTENNA CO MOUNT CONFIG. CONT TO VERIFY MOUNT CON SUFFICIENT SPACE FO PROPOSED LESSEE EQ (EQUIP) (I.E. CLEARANCES, MOUNT PIPE, SUFFICIENT LENGTH, ETC.) ATC DID NOT ANALYZE ANTENNA MOUNT TO DETERMINE ADEQUATE STRUCTURAL CAPACITY FOR ANY LESSEE LOADING.

ALL PROPOSED EQUIP INCLUDING ANTENNAS, COAX, ETC. SHALL BE MOUNTED IN ACCORDANCE WITH THE TOWER STRUCTURAL ANALYSIS ON FILE WITH ATC'S CM. CONFIRM SPACING OF PROPOSED

EQUIP DOES NOT CAUSE TOWER CONFLICTS NOR IMPEDE TOWER

CLIMBING PEGS. POSITIONS START WITH FIRST PIPE ON THE LEFT SIDE (AS VIEWED FROM BEHIND THE MOUNT).

LO	CATION			ANTENNA S	SUMMARY		NON ANTENNA SUMMARY		
SECTOR	RAD	AZ	POS	ANTENNA	BAND	STATUS	ADDITIONAL TOWER MOUNTED EQUIPMENT	STATUS	
			A1	SBNH-1D6565C	UMTS	RMN	RRUS-11 B5	ADD	
			A2	HPA-65R-BUU-H8	LTE	REL	-	-	
ALPHA	126'	30°	A3	OPA65R-BU8DA	LTE	ADD	RRUS-4478 B14	ADD	
			A4	DMP65R-BU8DA	LTE	ADD	RRUS-4449 B5/B12	ADD	
			A4	DIVIPODR-BUODA	LIE	ADD	RRUS-8843 B2/B66A	ADD	
			B1	SBNH-1D6565C	UMTS	RMN	RRUS-11 B5	ADD	
			B2	HPA-65R-BUU-H8	LTE	REL	-	-	
BETA	126'	150°	В3	OPA65R-BU8DA	LTE	ADD	RRUS-4478 B14	ADD	
			B4	DMP65R-BU8DA	LTE	ADD	RRUS-4449 B5/B12	ADD	
			D4	DIVIPODR-BUODA	LIE	ADD	RRUS-8843 B2/B66A	ADD	
			C1	SBNH-1D6565C	UMTS	RMN	RRUS-11 B5	ADD	
			C2	HPA-65R-BUU-H8	LTE	REL	-	-	
GAMMA	126'	270°	C3	OPA65R-BU8DA	LTE	ADD	RRUS-4478 B14	ADD	
			C4	DMP65R-BU8DA	LTE	ADD	RRUS-4449 B5/B12	ADD	
			04	DIVIPOSK-BUSDA	LIE	ADD	RRUS-8843 B2/B66A	ADD	

FINAL ANTENNA SCHEDULE

CABLE LENGTHS FOR JUMPERS FIBER DISTRIBUTION/SQUID TO RRU: 15' RRU TO ANTENNA: 10'

**EQUIPMENT SCHEDULES** 

FINAL FIBER DISTRIBUTION/S	QUID	REDLINED CDs
MODEL NUMBER	STATUS	Ramapo Communication Corp
(2) DC2-48-60-8-18F-02	RMN	3/23/2021  Matthew Schlosser
DC2-48-60-8-18F-02	ADD	Matthew Schlosser





together planning a better tomorrow 158 BUSINESS CENTER DRIVE BIRMINGHAM, AL 35244 TEL: 205-252-6985 FAX: 205-320-1504

REV.	DESCRIPTION	BY	DATE
<u> </u>	FOR CONSTRUCTION	ZDS	09/22/20
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ATC SITE NUMBER:

283424

ATC SITE NAME:

# WATERTOWN CT

SITE ADDRESS: 655 BASSETT ROAD WATERTOWN, CT 06795-1139






DATE DRAWN:	05/29/20
ATC JOB NO:	283424
CUSTOMER ID:	10128117
CUSTOMER #:	20-10237

# RF SCHEDULE AND ANTENNA INSTALLATION


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C-401

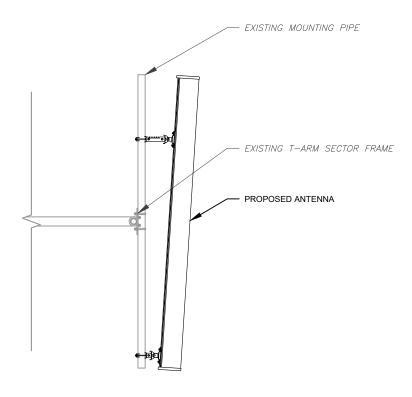


ANTENNA DETAIL

SCALE: N.T.S.

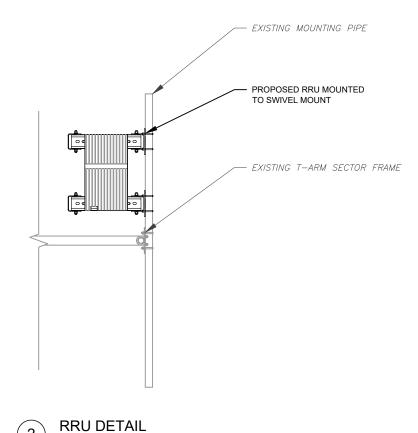

SCALE: N.T.S.

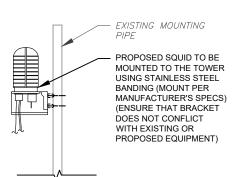

PROPOSED SQUID MOUNTING

SCALE: NOT TO SCALE



Matthew Schlosser





158 BUSINESS CENTER DRIVE BIRMINGHAM, AL 35244 TEL: 205-252-6985 FAX: 205-320-1504

REV.	DESCRIPTION	BY	DATE
<u> </u>	FOR CONSTRUCTION	ZDS	09/22/20
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ATC SITE NUMBER:

283424

ATC SITE NAME:

# WATERTOWN CT

SITE ADDRESS: 655 BASSETT ROAD WATERTOWN, CT 06795-1139






ı		
П	DATE DRAWN:	05/29/20
l	ATC JOB NO:	283424
	CUSTOMER ID:	10128117
	CUSTOMER #:	20-10237

# CONSTRUCTION DETAILS


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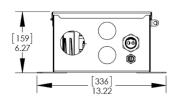
C-501

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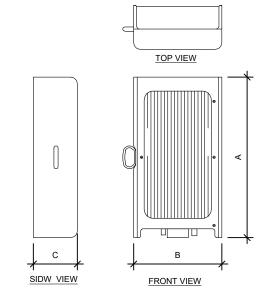


ANTENNA SPECIFICATIONS					
ANTENNA MODEL	А	В	С	WEIGHT (LBS)	
OPA65R-BU8DA	96.0"	21"	7.8"	76.5	
DMP65R-BU8DA	96.0"	20.7"	7.7"	95.7	

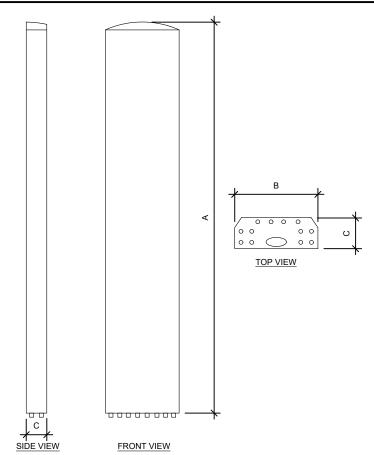

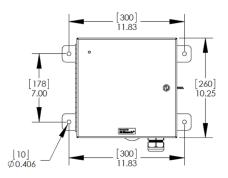

RAYCAP SPECIFICATIONS				
RAYCAP MODEL A B		В	С	WEIGHT (LBS)
DC2-48-60-8-18F-02	13.22"	11.64"	6.27"	16.0



RRU SPECIFICATIONS					
RRU MODEL	А	В	С	WEIGHT (LBS)	
RRUS-11 B5	19.69"	16.97"	7.17"	55.0	
RRUS-4478 B14	18.1"	13.4"	8.3"	59.4	
RRUS-4449 B5/B12	17.9"	13.2"	9.4"	71.0	
RRUS-8843 B2/B66A	18.0"	13.2"	11.3"	75.0	





# 158 BUSINESS CENTER DRIVE BIRMINGHAM, AL 35244 TEL: 205-252-6985 FAX: 205-320-1504

REV.	DESCRIPTION	BY	DATE
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ATC SITE NUMBER:

283424

ATC SITE NAME:

# WATERTOWN CT

SITE ADDRESS: 655 BASSETT ROAD WATERTOWN, CT 06795-1139

CENSED MENTILLE SONAL ENGINEERS (19/22/2020)



DATE DRAWN:	05/29/20
ATC JOB NO:	283424
CUSTOMER ID:	10128117
CUSTOMER #:	20-10237

# **EQUIPMENT SPECIFICATIONS**


REVISION:

SHEET NUMBER:

C-502


**EQUIPMENT SPECIFICATIONS** SCALE: NOT TO SCALE REDLINED CDs Ramapo Communication Corp 3/23/2021 Matthew Schlosser

Matthew Schlosser

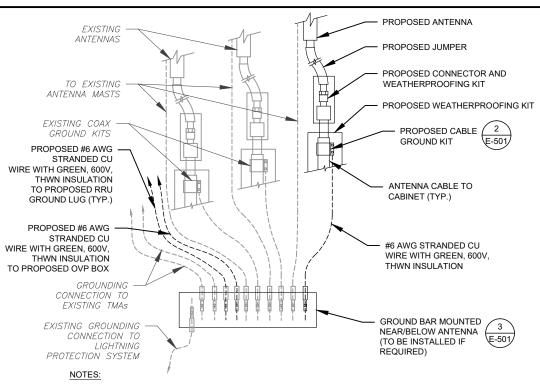


- THIS DETAIL IS INTENDED TO SHOW THE GENERAL GROUNDING REQUIREMENTS. SLIGHT ADJUSTMENTS MAY BE REQUIRED BASED ON EXISTING SITE CONDITIONS. THE CONTRACTOR SHALL MAKE FIELD ADJUSTMENTS AS NEEDED AND INFORM THE CONSTRUCTION MANAGER OF ANY CONFLICTS.
- 2. SITE GROUNDING SHALL COMPLY WITH AT&T MOBILITY GROUNDING STANDARDS, LATEST EDITION, AND COMPLY WITH AT&T MOBILITY GROUNDING CHECKLIST, LATEST VERSION. WHEN NATIONAL AND LOCAL GROUNDING CODES ARE MORE STRINGENT THEY SHALL



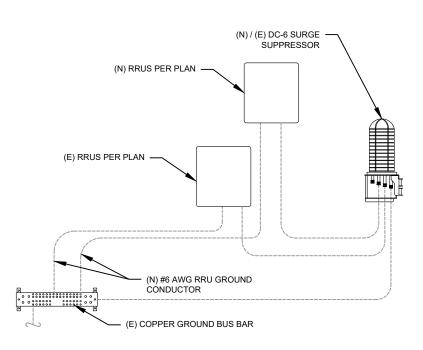


RRU GROUNDING

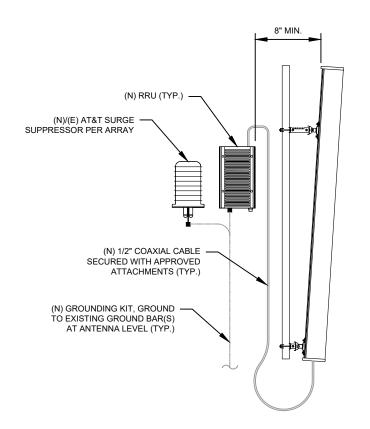

ANTENNA/RRU GROUNDING SCALE: N.T.S.

REDLINED CDs Ramapo Communication Corp 3/23/2021 Matthew Schlosser Matthew Schlosser

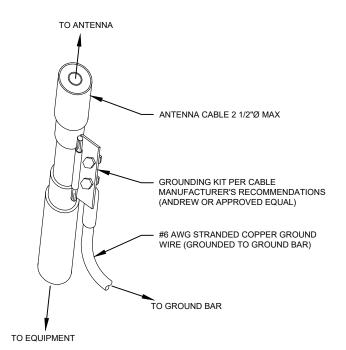

- GROUND KIT NOTES:

  1. DO NOT INSTALL CABLE GROUND KIT AT A BEND AND ALWAYS DIRECT GROUND WIRE DOWN TO GROUND BAR.
- CONTRACTOR SHALL PROVIDE WEATHERPROOFING KIT (ANDREW PART NUMBER 221213) AND INSTALL/TAPE PER MANUFACTURER'S SPECIFICATIONS.

# CABLE GROUND KIT CONNECTION DETAIL




283424

ATC SITE NAME:

# WATERTOWN CT

SITE ADDRESS: 655 BASSETT ROAD WATERTOWN, CT 06795-1139




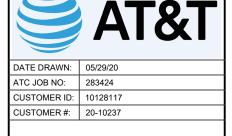

# **GROUNDING DETAILS**

SHEET NUMBER:

E-501

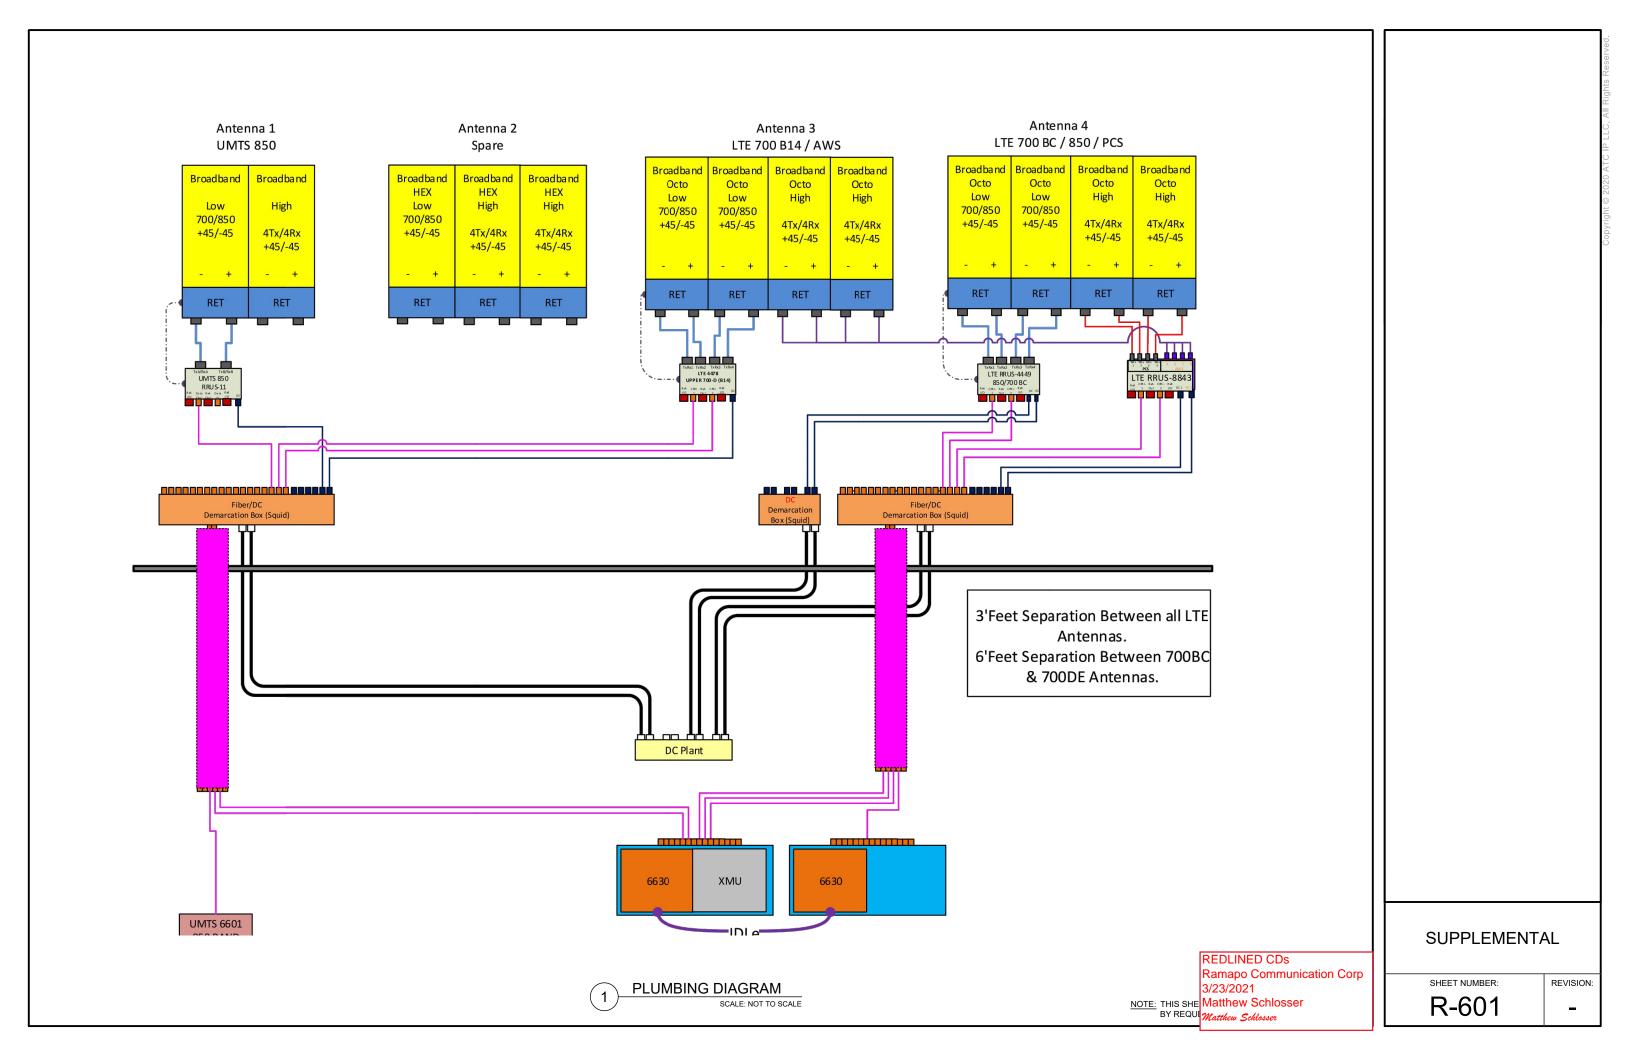



# **Antenna Mount Analysis Report**

**ATC Site Name** : WATERTOWN CT, CT

**ATC Site Number** : 283424

**Engineering Number** : 13213496\_C9\_06

**Mount Elevation** : 124 ft

Carrier : AT&T Mobility

**Carrier Site Name** : MRCTB046623

**Carrier Site Number** : CTL01835

Site Location : 655 Bassett Road

Watertown, CT 06795-1139

41.65707777, -73.1362611

Reviewed By:

: Litchfield County

Date : July 13, 2020

: 98% Max Usage

Result : Contingent Pass

Prepared By: Mitchell Chen Structural Engineer I

COA: PEC.0001553

A.T. Engineering Service, PLLC - 3500 Regency Parkway, Suite 100 - Cary, NC 27518 - 919.468.0112 Office - 919.466.5414 Fax - www.americantower.com



Eng. Number 13213496\_C9\_06 July 13, 2020 Page 1

#### Introduction

The purpose of this report is to summarize results of the antenna mount analysis performed for AT&T Mobility at 124 ft.

### **Supporting Documents**

Mount Mapping	MasTec Project #202197, dated June 17, 2020
Radio Frequency Data Sheet	RFDS ID #10128117, dated March 24, 2020
Reference Photos	Site photos from 2020

### **Analysis**

This antenna mount was analyzed using American Tower Corporation's Mount Analysis Program and RISA-3D

Basic Wind Speed:	115 mph (3-Second Gust)
Basic Wind Speed w/ Ice:	50 mph (3-Second Gust) w/ 1" radial ice concurrent
Codes:	ANSI/TIA-222-H
Exposure Category:	С
Risk Category:	II
Topographic Factor Procedure:	Method 2
Feature:	Flat
Crest Height (H):	0 ft
Crest Length (L):	0 ft
Spectral Response:	Ss = 0.185, S1 = 0.054
Site Class:	D - Stiff Soil
Live Loads:	Lm = 500 lbs, Lv = 250 lbs

# Conclusion

Based on the analysis results, the antenna mount does not meet the requirements per the applicable codes listed above. The mount can support the equipment as described in this report after the below listed modifications are completed:

• Install modifications per ATC drawing #13213496\_C9\_06.

If you have any questions or require additional information, please contact American Tower via email at Engineering@americantower.com. Please include the American Tower site name, site number, and engineering number in the subject line for any questions.

A.T. Engineering Service, PLLC - 3500 Regency Parkway, Suite 100 - Cary, NC 27518 - 919.468.0112 Office - 919.466.5414 Fax - www.americantower.com

**MOUNT ANALYSIS** 


REDLINED CDs NOTE: THIS SHEET WAS CREATED BY OTHERS AND PROVIDED Ramapo Communication Corp WITHOUT EDIT. PLEASE REFERENCE THE MOUNT ANAI ANALYSIS CALCULATIONS AND DETAILS. SUPPLEMENT 3/23/2021 CONSTRUCTION DRAWINGS ARE FOR REFERENCE ON Matthew Schlosser VERYIFY THEY HAVE THE MOST RECENT MOUNT ANALY

SUPPLEMENTAL

SHEET NUMBER:

REVISION:

R-602

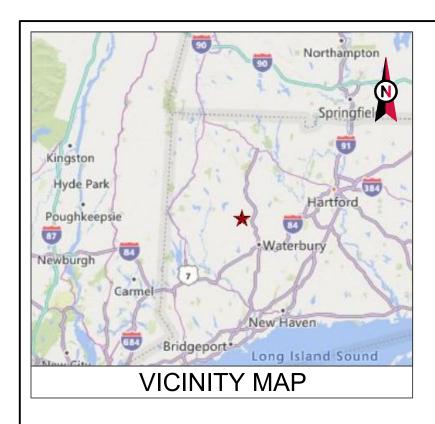



SITE NAME: WATERTOWN CT

SITE NUMBER: 283424

ATC PROJECT NUMBER: 13213496\_C9\_06

SITE ADDRESS: 655 BASSETT ROAD

WATERTOWN, CT 06795



# MOUNT REINFORCEMENT DRAWINGS PREPARED FOR AT&T MOBILITY

PROJECT TEAM	PROJECT DESCRIPTION	SHEET	SHEET TITLE	RE\
		G-002	IBC GENERAL NOTES AND MOUNT MODIFICATION INSPECTION	0
TOWER OWNER	THE MODIFICATIONS PRESENTED ON THESE DRAWINGS ARE BASED ON THE	S-101	MODIFICATION PROFILE	0
AMERICAN TOWER	RECOMMENDATIONS OUTLINED IN THE MOUNT ANALYSIS COMPLETED UNDER ENGINEERING PROJECT NUMBER 13213496_C8_03 DATED 07/02/20.	R-601	SUPPLEMENTAL	0
10 PRESIDENTAL WAY	SATISFACTORY COMPLETION OF THE WORK INDICATED ON THESE DRAWINGS WILL RESULT IN THE MOUNT MEETING THE REQUIREMENTS OF THE	R-602	SUPPLEMENTAL	0
WOBURN, MA 01801	SPECIFICATIONS UNDER WHICH THE MOUNT ANALYSIS WAS COMPLETED.			
ENGINEERED BY	COMPLIANCE CODE			
ATC TOWER SERVICES	331111 211 11132 3332			
3500 REGENCY PARKWAY, SUITE 100	ALL WORK SHALL BE PERFORMED AND MATERIALS INSTALLED IN			
CARY, NC 27518	ACCORDANCE WITH THE CURRENT EDITIONS OF THE FOLLOWING CODES AS ADOPTED BY THE LOCAL GOVERNMENT AUTHORITIES. NOTHING IN THESE			
	PLANS IS TO BE CONSTRUED TO PERMIT WORK NOT CONFORMING TO THESE CODES.			
CARRIER INFORMATION				
CARRIER: AT&T MOBILITY	1. ANSI/TIA/EIA: STRUCTURAL STANDARDS (222-H EDITION)			
CARRIER SITE NAME: MRCTB046623	2. INTERNATIONAL BUILDING CODE (2015 IBC)			
CARRIER SITE NUMBER: CTL01835	3. CONNECTICUT STATE BUILDING CODE (2018)			
	PROJECT LOCATION			
	GEOGRAPHIC COORDINATES			
	LATITUDE: 41.65707777			
W. J. H. Halam	LONGITUDE: -73.1362611		REDLINE	
Know what's <b>below. Call</b> before you dig.			Ramapo (	Communication
Call belone you dig.			3/23/2021 Matthew 9	
			Matthew Sci	



3500 REGENCY PARKWAY
SUITE 100
CARY, NC 27518
PHONE: (919) 468-0112
COA: PEC.0001553

THESE DRAWINGS AND/OR THE ACCOMPANYING SPECIFICATION AS INSTRUMENTS OR SERVICE ARE THE EXCLUSIVE PROPERTY OF AMERICAN TOWER. THEIR USE AND PUBLICATION SHALL BE RESTRICTED TO THE ORIGINAL SITE FOR WHICH THEY ARE PREPARED. ANY USE OR DISCLOSURE OTHER THAN THAT WHICH RELATES TO AMERICAN TOWER OR THE SPECIFIED CARRIER IS STRICTLY PROHIBITED. TITLE TO THESE DOCUMENTS SHALL REMAIN THE PROPERTY OF AMERICAN TOWER WHETHER OR NOT THE PROJECT IS EXECUTED. NEITHER THE ARCHITECT NOR THE ENGINEER WILL BE PROVIDING ON-SITE CONSTRUCTION REVIEW OF THIS PROJECT. CONTRACTOR(S) MUST VERIFY ALL DIMENSIONS AND ADVISE AMERICAN TOWER OF ANY DISCREPANCIES. ANY PRIOR ISSUADEC OF THIS DRAWING IS SUPERSEDED BY THE LATEST VERSION ON FILE WITH AMERICAN TOWER

l	REV.	DESCRIPTION	BY	DATE
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ATC SITE NUMBER:

283424

ATC SITE NAME:

# WATERTOWN CT

CONNECTICUT

SITE ADDRESS: 655 BASSETT ROAD WATERTOWN, CT 06795



DRAWN BY:	CGM
APPROVED BY:	MCC
DATE DRAWN:	07/15/20
ATC JOB NO:	13213496_C9_06

COVER

SHEET NUMBER:


G-001

#### **GENERAL**

- ALL WORK TO BE COMPLETED PER APPLICABLE LOCAL STATE FEDERAL CODES AND ORDINANCES AND COMPLY WITH ATC CONSTRUCTION SPECIFICATIONS FOR WIRELESS TOWER SITES. THE CONTRACTOR IS RESPONSIBLE FOR OBTAINING AND ABIDING BY ALL REQUIRED PERMITS
- ALL WORK INDICATED ON THESE DRAWINGS SHALL BE PERFORMED BY QUALIFIED CONTRACTORS EXPERIENCED IN TOWER AND FOUNDATION CONSTRUCTION
- 3. THE CONTRACTOR SHALL NOTIFY THE ENGINEER OF RECORD IMMEDIATELY OF ANY INSTALLATION INTERFERENCES. ALL NEW WORK SHALL ACCOMMODATE EXISTING CONDITIONS DETAILS NOT SPECIFICALLY SHOWN ON THE DRAWINGS SHALL FOLLOW SIMILAR DETAILS FOR THIS JOB.
- ANY SUBSTITUTIONS SHALL CONFORM TO THE REQUIREMENTS OF THESE NOTES AND SPECIFICATIONS, AND SHOULD BE SIMILAR TO THOSE SHOWN. ALL SUBSTITUTIONS SHALL BE SUBMITTED TO THE ENGINEER OF RECORD FOR REVIEW AND APPROVAL PRIOR TO FABRICATION
- ANY MANUFACTURED DESIGN ELEMENTS SHALL CONFORM TO THE REQUIREMENTS OF THESE NOTES AND SPECIFICATIONS AND SHOULD BE SIMILAR TO THOSE SHOWN. THESE DESIGN ELEMENTS MUST BE STAMPED BY AN ENGINEER PROFESSIONALLY REGISTERED IN THE STATE OF THE PROJECT, AND SUBMITTED TO THE ENGINEER OF RECORD FOR APPROVAL PRIOR TO FABRICATION.
- 6. ALL WORK SHALL BE DONE IN ACCORDANCE WITH LOCAL CODES AND OSHA SAFETY REGULATIONS.
- THE CONTRACTOR IS RESPONSIBLE FOR THE DESIGN AND EXECUTION OF ALL MISCELLANEOUS SHORING, BRACING, TEMPORARY SUPPORTS, ETC. NECESSARY, PER ANSI/TIA-322 AND ANSI/ASSE A10.48. TO PROVIDE A COMPLETE AND STABLE STRUCTURE AS SHOWN ON THESE DRAWINGS.
- CONTRACTOR'S PROPOSED INSTALLATION SHALL NOT INTERFERE, NOR DENY ACCESS TO, ANY EXISTING OPERATIONAL AND SAFETY EQUIPMENT.

## STRUCTURAL STEEL

- ALL DETAILING, FABRICATION AND ERECTION OF STRUCTURAL STEEL SHALL CONFORM TO THE AISC SPECIFICATIONS LATEST EDITION
- 2. ALL EXPOSED STRUCTURAL STEEL MEMBERS SHALL BE HOT-DIPPED GALVANIZED AFTER FABRICATION PER ASTM A123. EXPOSED STEEL HARDWARE AND ANCHOR BOLTS SHALL BE GALVANIZED PER ASTM A153 OR B695.
- ALL U-BOLTS SHALL BE ASTM A36 OR EQUIVALENT, WITH LOCKING DEVICE, UNLESS NOTED OTHERWISE
- 4. FIELD CUT EDGES, EXCEPT DRILLED HOLES, SHALL BE GROUND SMOOTH.
- ALL FIELD CUT SURFACES, FIELD DRILLED HOLES & GROUND SURFACES WHERE EXISTING PAINT OR GALVANIZATION REMOVAL WAS REQUIRED SHALL BE REPAIRED WITH (2) BRUSHED COATS OF ZRC GALVILITE COLD GALVANIZING COMPOUND PER ASTM A780 AND MANUFACTURERS RECOMMENDATIONS.
- ALL STRUCTURAL STEEL EMBEDDED IN THE CONCRETE SHALL BE APPLIED WITH (2) BRUSHED COATS OF POLYGUARD CA-14 MASTIC OR FOLIVALENT. REFER TO THE MANUFACTURER SPECIFICATIONS FOR SURFACE PREPARATION AND APPLICATION. APPLICATION OF POLYGUARD 400 WRAP IS NOT ESSENTIAL
- CONTRACTOR SHALL PERFORM WORK ON ONLY ONE (1) TOWER FACE AND REPLACE/REINFORCE ONE (1) BOLT/MEMBER AT A TIME
- 8. ALL FIELD DRILLED HOLES TO BE USED FOR FIELD BOLTING INSTALLATION SHALL BE STANDARD HOLES, AS DEFINED BY AISC, UNLESS NOTED OTHERWISE.

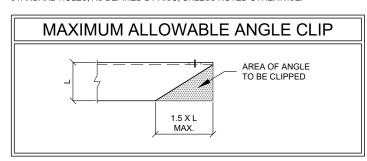

### **PAINT**

AS REQUIRED, CLEAN AND PAINT PROPOSED STEEL ACCORDING TO FAA ADVISORY CIRCULAR AC 70/7460-1L

#### WELDING

- 1. ALL WELDING TO BE PERFORMED BY AWS CERTIFIED WELDERS AND CONDUCTED IN ACCORDANCE WITH THE LATEST EDITION OF THE AWS WELDING CODE D1.1.
- 2. ALL WELDS SHALL BE INSPECTED VISUALLY. IF DIRECTED BY ENGINEER OF RECORD, 25% OF WELDS SHALL BE INSPECTED WITH DYE PENETRANT OR MAGNETIC PARTICLE (100% IF REJECTABLE DEFECTS ARE FOUND) TO MEET THE ACCEPTANCE CRITERIA OF AWS D1.1. REPAIR ALL WELDS AS NECESSARY.
- 3. INSPECTION SHALL BE PERFORMED BY AN AWS CERTIFIED WELD INSPECTOR.
- 4. ALL ELECTRODES TO BE LOW HYDROGEN, MATCHING FILLER AND/OR BASE METAL, PER AWS D1.1, UNLESS NOTED OTHERWISE
- 5. IN CASES WHERE BASE METAL GRADE IS UNKNOWN, ALL WELDING ON LATTICE TOWERS SHALL BE DONE WITH E70XX ELECTRODES; ALL WELDING ON POLE STRUCTURES SHALL BE DONE WITH E80XX FLECTRODES UNLESS NOTED OTHERWISE
- 6. PRIOR TO FIELD WELDING GALVANIZED MATERIAL, CONTRACTOR SHALL GRIND OFF GALVANIZING 1/2" BEYOND ALL FIELD WELD SURFACES. AFTER WELD AND WELD INSPECTION IS COMPLETE, REPAIR ALL GROUND AND WELDED SURFACES WITH ZRC GALVILITE COLD GALVANIZING COMPOUND PER ASTM A780 AND MANUFACTURERS RECOMMENDATIONS.

#### **BOLT TIGHTENING PROCEDURE**

- 1. STRUCTURAL CONNECTIONS TO BE ASSEMBLED AND INSPECTED IN ACCORDANCE WITH RCSC SPECIFICATIONS.
- 2 FLANGE BOLTS SHALL BE INSTALLED AND TIGHTENED USING DIRECT TENSION INDICATING (DTI) SQUIRTER WASHERS. DTI SQUIRTER WASHERS ARE TO BE INSTALLED AND ORIENTED / TIGHTENED PER MANUFACTURER SPECIFICATIONS TO ACHIEVE DESIRED LEVEL OF BOLT PRE-TENSION
- 3. IN LIEU OF USING DTI SQUIRTER WASHERS, FLANGE BOLTS MAY BE TIGHTENED USING AISC / RCSC "TURN-OF-THE-NUT" METHOD, PENDING APPROVAL BY THE ENGINEER OF RECORD (EOR). TIGHTEN FLANGE BOLTS USING THE CHART BELOW:

#### **BOLT LENGTHS UP TO AND INCLUDING FOUR DIAMETERS**

1/2"	BOLTS UP TO AND INCLUDING 2.0 INCH LENGTH	+1/3 TURN BEYOND SNUG TIGHT
5/8"	BOLTS UP TO AND INCLUDING 2.5 INCH LENGTH	+1/3 TURN BEYOND SNUG TIGHT
3/4"	BOLTS UP TO AND INCLUDING 3.0 INCH LENGTH	+1/3 TURN BEYOND SNUG TIGHT
7/8"	BOLTS UP TO AND INCLUDING 3.5 INCH LENGTH	+1/3 TURN BEYOND SNUG TIGHT
1"	BOLTS UP TO AND INCLUDING 4.0 INCH LENGTH	+1/3 TURN BEYOND SNUG TIGHT
1-1/8"	BOLTS UP TO AND INCLUDING 4.5 INCH LENGTH	+1/3 TURN BEYOND SNUG TIGHT
1-1/4"	BOLTS UP TO AND INCLUDING 5.0 INCH LENGTH	+1/3 TURN BEYOND SNUG TIGHT
1-3/8"	BOLTS UP TO AND INCLUDING 5.5 INCH LENGTH	+1/3 TURN BEYOND SNUG TIGHT
1-1/2"	BOLTS UP TO AND INCLUDING 6.0 INCH LENGTH	+1/3 TURN BEYOND SNUG TIGHT

#### **BOLT LENGTHS OVER FOUR DIAMETERS BUT NOT EXCEEDING EIGHT DIAMETERS**

1/2"	BOLTS 2.25 TO 4.0 INCH LENGTH	+1/2 TURN BEYOND SNUG TIGHT
5/8"	BOLTS 2.75 TO 5.0 INCH LENGTH	+1/2 TURN BEYOND SNUG TIGHT
3/4"	BOLTS 3.25 TO 6.0 INCH LENGTH	+1/2 TURN BEYOND SNUG TIGHT
7/8"	BOLTS 3.75 TO 7.0 INCH LENGTH	+1/2 TURN BEYOND SNUG TIGHT
1"	BOLTS 4.25 TO 8.0 INCH LENGTH	+1/2 TURN BEYOND SNUG TIGHT
1-1/8"	BOLTS 4.75 TO 9.0 INCH LENGTH	+1/2 TURN BEYOND SNUG TIGHT
1-1/4"	BOLTS 5.25 TO 10.0 INCH LENGTH	+1/2 TURN BEYOND SNUG TIGHT
1-3/8"	BOLTS 5.75 TO 11.0 INCH LENGTH	+1/2 TURN BEYOND SNUG TIGHT
1-1/2"	BOLTS 6.25 TO 12.0 INCH LENGTH	+1/2 TURN BEYOND SNUG TIGHT

### **BOLT TIGHTENING PROCEDURE (CONTINUED)**

SPLICE BOLTS SUBJECT TO DIRECT TENSION SHALL BE INSTALLED AND TIGHTENED AS PER SECTION 8.2.1 OF THE AISC "SPECIFICATION FOR STRUCTURAL JOINTS USING A325 OR A490 BOLTS", LOCATED IN THE AISC MANUAL OF STEEL CONSTRUCTION. THE INSTALLATION PROCEDURE IS PARAPHRASED AS FOLLOWS:

FASTENERS SHALL BE INSTALLED IN PROPERLY ALIGNED HOLES AND TIGHTENED BY ONE OF THE METHODS DESCRIBED IN SUBSECTION 8.2.1 THROUGH 8.2.4.

#### 8.2.1 TURN-OF-NUT PRETENSIONING

BOLTS SHALL BE INSTALLED IN ALL HOLES OF THE CONNECTION AND BROUGHT TO A SNUG TIGHT CONDITION AS DEFINED IN SECTION 8.1. UNTIL ALL THE BOLTS ARE SIMULTANEOUSLY SNUG TIGHT AND THE CONNECTION IS FULLY COMPACTED. FOLLOWING THIS INITIAL OPERATION ALL BOLTS IN THE CONNECTION SHALL BE TIGHTENED FURTHER BY THE APPLICABLE AMOUNT OF ROTATION SPECIFIED ABOVE DURING THE TIGHTENING OPERATION THERE SHALL BE NO ROTATION OF THE PART NOT TURNED BY THE WRENCH. TIGHTENING SHALL PROGRESS SYSTEMATICALLY.

ALL OTHER BOLTED CONNECTIONS SHALL BE BROUGHT TO A SNUG TIGHT CONDITION AS DEFINED IN SECTION 8.1 OF THE SPECIFICATION

ALL BOLT HOLES SHALL BE ALIGNED TO PERMIT INSERTION OF THE BOLTS WITHOUT UNDUE DAMAGE TO THE THREADS. BOLTS SHALL BE PLACED IN ALL HOLES WITH WASHERS POSITIONED AS REQUIRED AND NUTS THREADED TO COMPLETE THE ASSEMBLY. COMPACTING THE JOINT TO THE SNUG-TIGHT CONDITION SHALL PROGRESS SYSTEMATICALLY FROM THE MOST RIGID PART OF THE JOINT. THE SNUG-TIGHTENED. CONDITION IS THE TIGHTNESS THAT IS ATTAINED WITH A FEW IMPACTS OF AN IMPACT WRENCH OR THE FULL EFFORT OF AN IRONWORKER USING AN ORDINARY SPUD WRENCH TO BRING THE CONNECTED PLIES INTO FIRM CONTACT.

# **AMERICAN TOWER**

A.T. ENGINEERING SERVICE. PLLC 3500 REGENCY PARKWAY SUITE 100 **CARY, NC 27518** PHONE: (919) 468-0112

COA: PEC.0001553

THESE DRAWINGS AND/OR THE ACCOMPANYING SPECIFICATION THESE DRAWINGS AND/OR THE ACCOMPANYING SPECIFICATION AS INSTRUMENTS OR SERVICE ARE THE EXCLUSIVE PROPERTY OF AMERICAN TOWER. THEIR USE AND PUBLICATION SHALL BE RESTRICTED TO THE ORIGINAL SITE FOR WHICH THEY ARE PREPARED. ANY USE OR DISCLOSURE OTHER THAN THAT WHICH STANDARD AND SERVICES OF THE STANDARD AND THE S RELATES TO AMERICAN TOWER OR THE SPECIFIED CARRIER IS STRICTLY PROHIBITED. TITLE TO THESE DOCUMENTS SHALL REMAIN THE PROPERTY OF AMERICAN TOWER WHETHER OR NO THE PROJECT IS EXECUTED, NEITHER THE ARCHITECT NOR THE ENGINEER WILL BE PROVIDING ON-SITE CONSTRUCTION REVIEW OF THIS PROJECT, CONTRACTOR(S) MUST VERIEY ALL DIMENSIONS AND ADVISE AMERICAN TOWER OF ANY DISCREPANCIES. ANY PRIOR ISSUANCE OF THIS DRAWING IS SUPERSEDED BY THE LATEST VERSION ON FILE WITH AMERICAN

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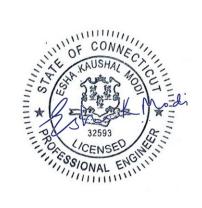
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ATC SITE NAME:

WATERTOWN CT

CONNECTICUT

SITE ADDRESS: 655 BASSETT ROAD WATERTOWN, CT 06795



DRAWN BY:	CGM
APPROVED BY:	MCC
DATE DRAWN:	07/15/20
ATC JOB NO:	13213496_C9_06

**IBC GENERAL NOTES** AND MOUNT MODIFICATION INSPECTION

REVISION

SHEET NUMBER:

G-002

# MODIFICATION INSPECTION NOTES

MMI - MOUNT MODIFICATION INSPECTION

ATC - AMERICAN TOWER CORPORATION

GC - GENERAL CONTRACTOR

THE MOUNT MODIFICATION INSPECTION (MMI) PROCEDURE IS INTENDED TO CONFIRM THAT CONSTRUCTION AND INSTALLATION MEETS ENGINEERING DESIGN. ATC PROCEDURES AND ATC STANDARD SPECIFICATIONS FOR WIRELESS TOWER SITES.

TO ENSURE THAT THE REQUIREMENTS OF THE MMI ARE MET, IT IS VITAL THAT THE GENERAL CONTRACTOR SUBMIT ALL REQUIRED PHOTOGRAPHS AND DRAWINGS TO AMERICAN TOWER CORPORATION (ATC).

# **GENERAL CONTRACTOR**

THE GENERAL CONTRACTOR IS REQUIRED TO:


- REVIEW THE REQUIREMENTS OF THE MMI CHECKLIST.
- UNDERSTAND ALL INSPECTION REQUIREMENTS.

THE GENERAL CONTRACTOR SHALL PERFORM AND RECORD THE INSPECTION RESULTS IN ACCORDANCE WITH THE REQUIREMENTS OF THE MMI CHECKLIST.

3/23/2021

Matthew Schlosser

MOUNT MODIFICATION INSPECTION CHECKLIST			
INSPECTION DOCUMENT	DESCRIPTION	INSPECTION TESTING REQUIRED	RESPONSIBILITY
ON-SITE COLD GALVANIZING VERIFICATION	PHOTOGRAPHIC EVIDENCE OF COLD GALVANIZATION TYPE AND APPLICATION IN ALL APPLICABLE LOCATIONS TO BE INCLUDED WITHIN THE MMI REPORT	<b>*</b>	GC
GC AS-BUILT DRAWINGS WITH CONSTRUCTION RED-LINES	"AS-BUILT" DRAWINGS INDICATING ANY APPROVED CHANGES TO ENGINEERED PLANS TO MMI FOR APPROVAL/REVIEW AND INCLUSION IN MMI REPORT	<b>*</b>	GC
PHOTOGRAPHS	PHOTOGRAPHIC EVIDENCE OF MOUNT MODIFICATION INSPECTION, ON SITE REMEDIATION, AND ITEMS FAILING INSPECTION & REQUIRING FOLLOW UP TO BE INCLUDED WITHIN THE MMI REPORT. COMPLETE PHOTO LOG IS TO BE SUBMITTED WITHIN MMI REPORT.	REDLINED CDs	GC
TABLE KEY:			unication Corp

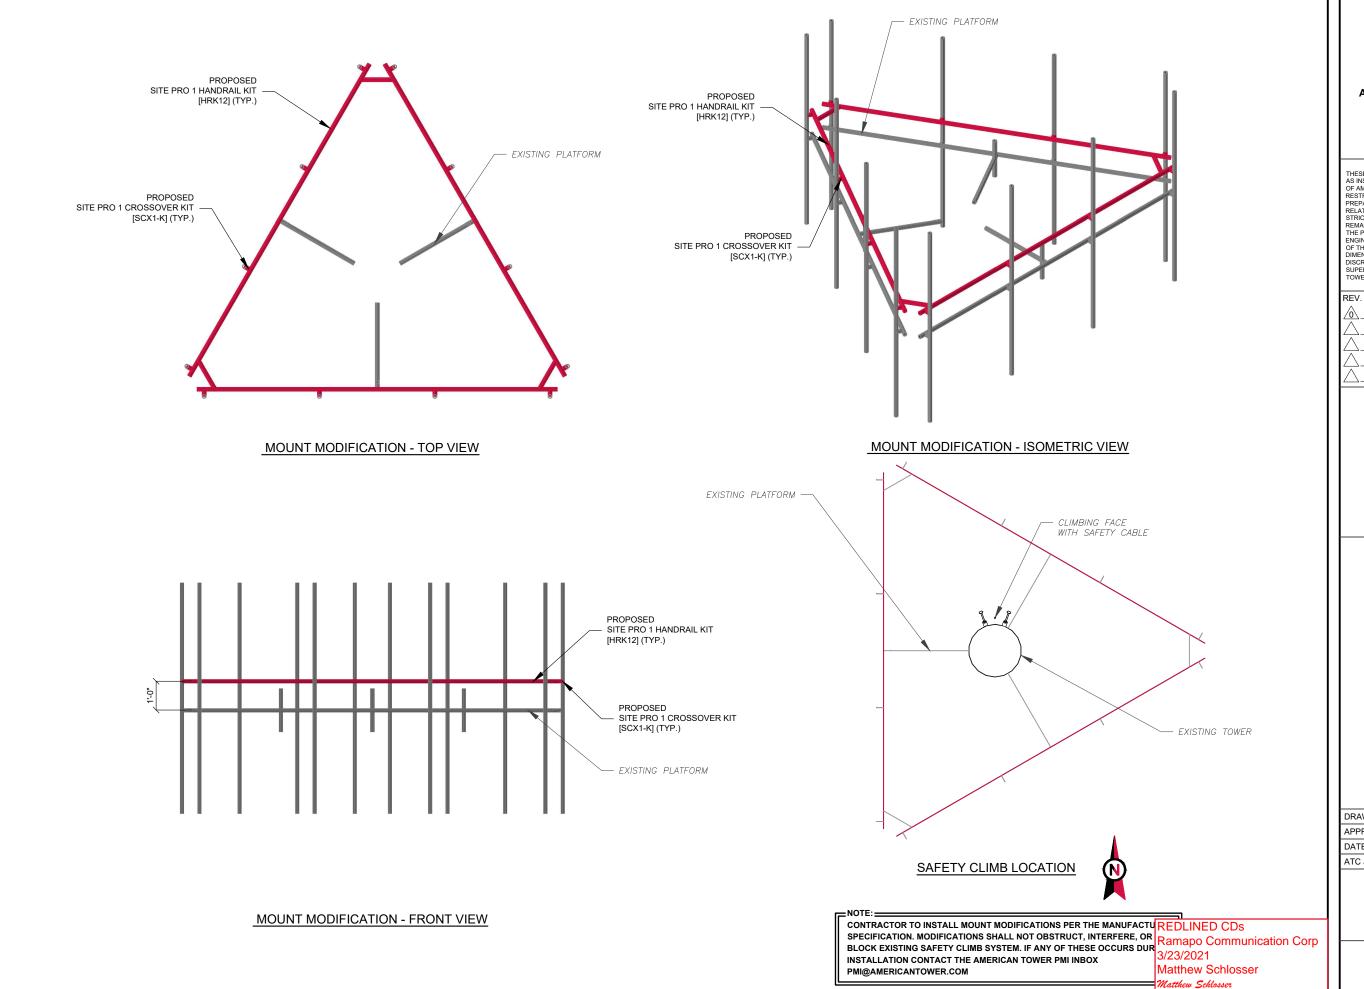



3500 REGENCY PARKWAY SUITE 100 CARY, NC 27518 PHONE: (919) 468-0112 COA: PEC.0001553

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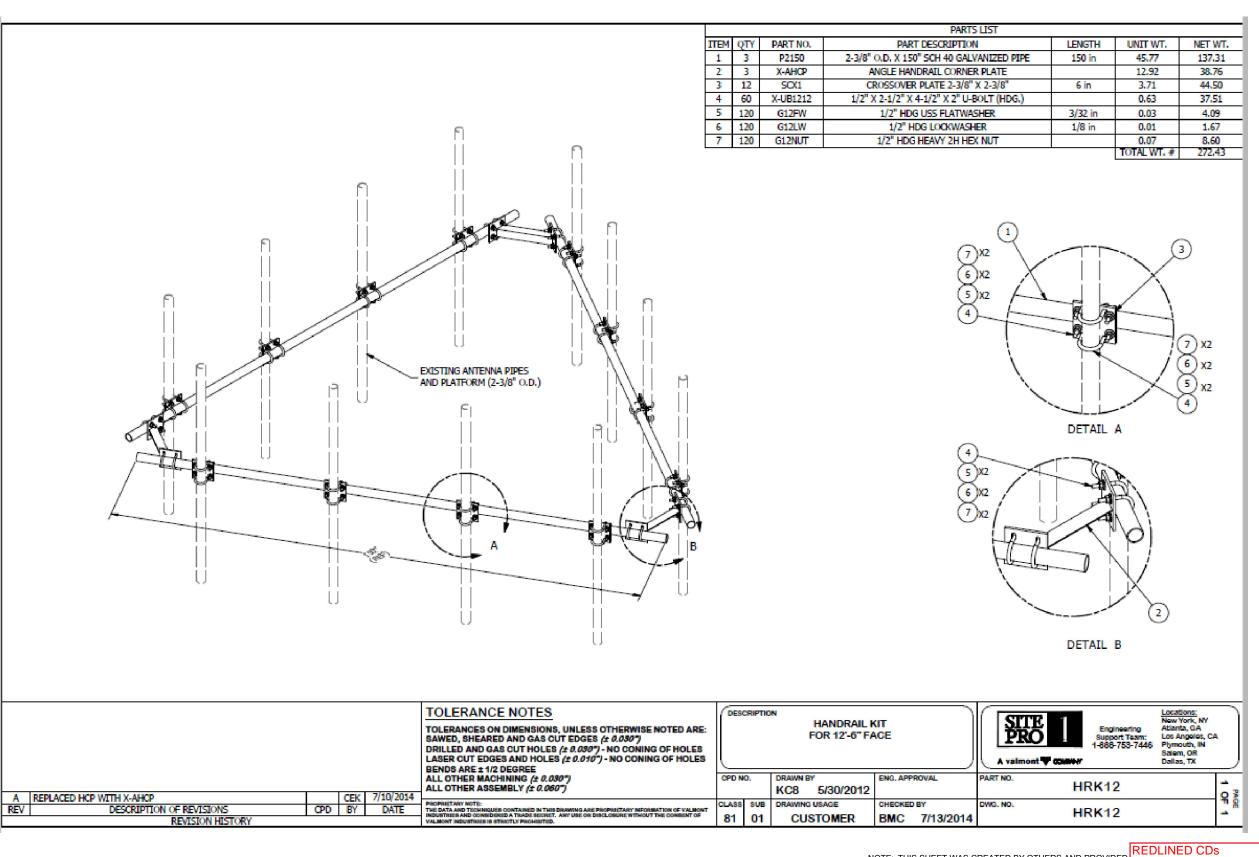
# MODIFICATION PROFILE

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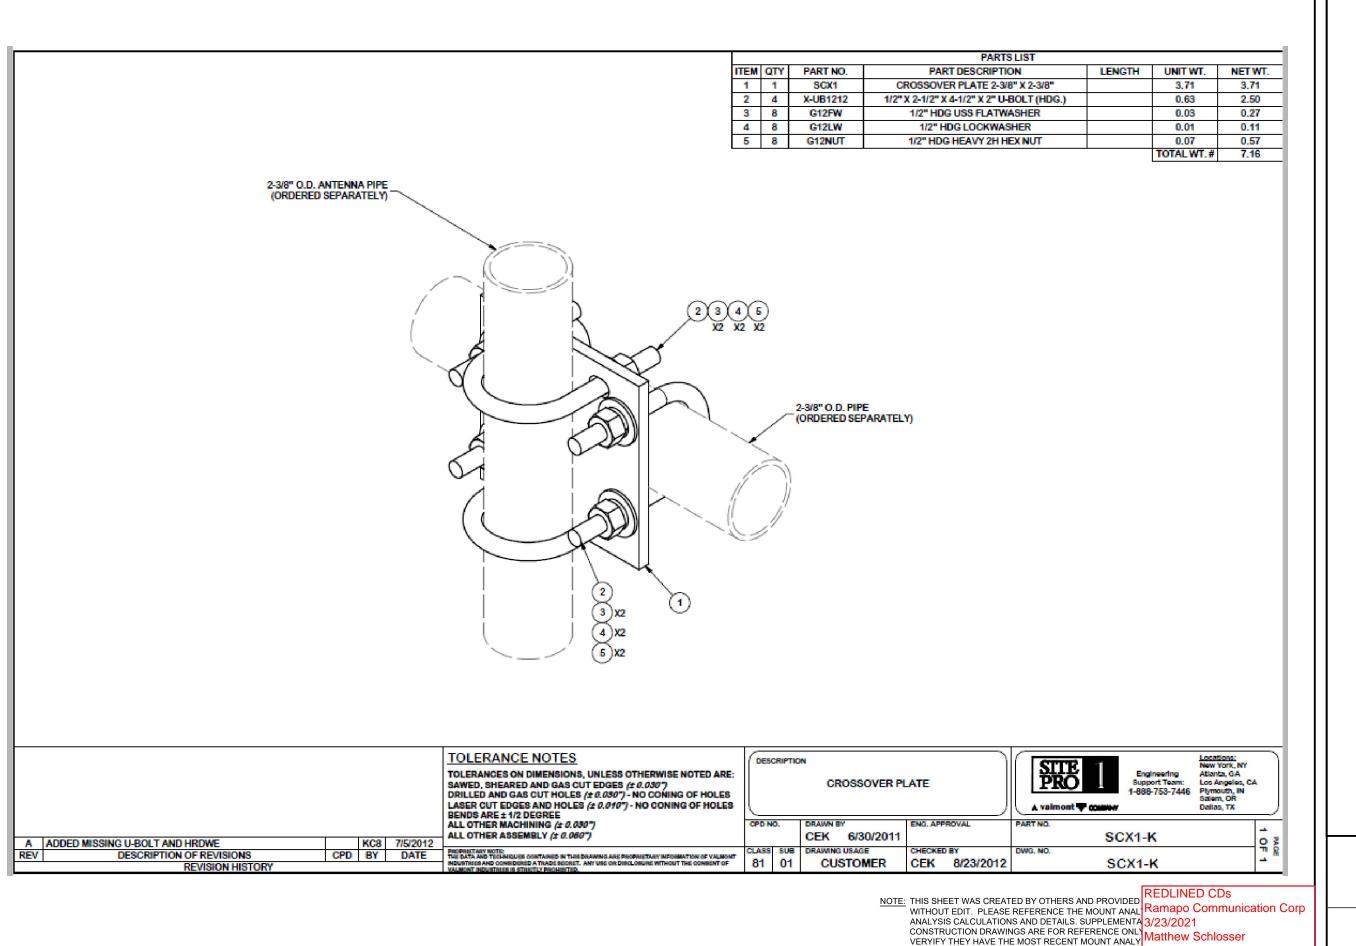
NOTE: THIS SHEET WAS CREATED BY OTHERS AND PROVIDED WITHOUT EDIT. PLEASE REFERENCE THE MOUNT ANALYSIS CALCULATIONS AND DETAILS. SUPPLEMENTA 3/23/2021 CONSTRUCTION DRAWINGS ARE FOR REFERENCE ONLY
VERYIFY THEY HAVE THE MOST RECENT MOUNT ANALY
Matthew Schlosser

Matthew Schlosser

SUPPLEMENTAL

SHEET NUMBER:

REVISION: R-601



SUPPLEMENTAL

SHEET NUMBER:

Matthew Schlosser

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