

## **AMERICAN TOWER®**

ATC SITE NAME: STONEYBROOK RD CT

ATC SITE NUMBER: 283420

AT&T PACE NUMBERS: MRCTB052098, MRCTB051448,

MRCTB053107


AT&T SITE ID: CTL02381 AT&T FA CODE: 12906923

AT&T SITE NAME: STRATFORD STONYBROOK RD

SITE ADDRESS: 23 STONYBROOK ROAD

STRATFORD, CT 06614

### AT&T LTE 7C/5G NR 1SR CBAND AMENDMENT PLAN

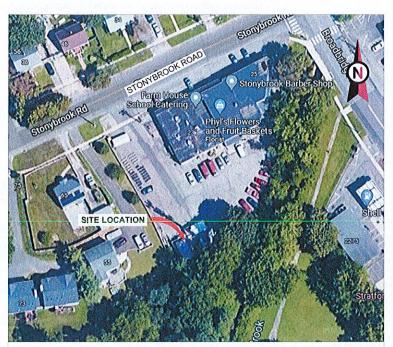

**LOCATION MAP** 

### **COMPLIANCE CODE**

ALL WORK SHALL BE PERFORMED AND MATERIALS INSTALLED IN ACCORDANCE WITH THE CURRENT EDITIONS OF THE FOLLOWING CODES AS ADOPTED BY THE LOCAL GOVERNMENT AUTHORITIES. NOTHING IN THESE PLANS IS TO BE CONSTRUED TO PERMIT WORK NOT CONFORMING TO

- 1. 2022 CONNECTICUT STATE BUILDING CODE-AMENDMENTS
- 2. INTERNATIONAL BUILDING CODE 2021, INTERNATIONAL CODE COUNCIL
- 3. TIA-222-H, STRUCTURAL STANDARD FOR ANTENNA SUPPORTING STRUCTURES AND ANTENNAS
- 4. ASCE 7-10 MINIMUM DESIGN LOADS FOR BUILDINGS AND OTHER STRUCTURES, AMERICAN SOCIETY OF CIVIL
- 5. STEEL CONSTRUCTION MANUAL 15TH EDITION, AMERICAN INSTITUTE OF STEEL CONSTRUCTION
- 6. CITY/COUNTY ORDINANCES

#### UTILITY COMPANIES

POWER COMPANY: N/A PHONE: N/A TELEPHONE COMPANY: N/A PHONE: N/A



Know what's below. Call before you dig.

#### PROJECT SUMMARY

#### SITE ADDRESS:

23 STONYBROOK ROAD STRATFORD, CT 06614 COUNTY: FAIRFIELD

#### GEOGRAPHIC COORDINATES:

LATITUDE: 41,20327777 LONGITUDE: -73,148625 **GROUND ELEVATION: 77' AMSL** 

#### **PROJECT TEAM**

AT&T MOBILITY

550 COCHITUATE ROAD

SUITES 13 & 14

FRAMINGHAM, MA 01701

#### TOWER OWNER:

AMERICAN TOWER 10 PRESIDENTIAL WAY WOBURN, MA 01801

#### ENGINEER:

DEWBERRY ENGINEERS INC. 99 SUMMER STREET SUITE 700

BOSTON MA 02110 PHONE: 617,695,3400 FAX: 617.695.3310

#### PROPERTY OWNER:

JOHN D MIRANDA 23 STONYBROOK ROAD STRATFORD.CT 06614-3715

### PROJECT DESCRIPTION

THE PROPOSED PROJECT INCLUDES MODIFYING GROUND BASED AND TOWER MOUNTED FOUIPMENT AS INDICATED PER BELOW

REMOVE (3) T-ARM MOUNT(s), (9) ANTENNA(S) AND (1) SQUID(S) INSTALL (1) MOUNT REPLACEMENT W/ SUPORT RAIL KIT, (12) ANTENNA(S), (4) RRH(S) AND (2) SQUID(S)

EXISTING (15) RRH(S), (3) DC TRUNK(S), (1) SQUID(S) AND (1) FIBER TRUNK(S) TO REMAIN

INSTALL (1) FRONTHAUL GATEWAY, (1) IDLE XCEDE

#### **PROJECT NOTES**

- THE FACILITY IS UNMANNED.
- DISTURBANCE OR EFFECT OF STORM WATER DRAINAGE.
- HANDICAP ACCESS IS NOT REQUIRED.
- ELIGIBLE FACILITIES REQUEST ENTITLED TO EXPEDITED COLLOCATION, REMOVAL, AND/OR REPLACEMENT OF TRANSMISSION EQUIPMENT THAT IS NOT A SUBSTANTIAL CHANGE UNDER CFR § 1.61000 (B)(7).

#### PROJECT LOCATION DIRECTIONS

## CHEET INDEX

	SHEET INDEX						
)	SHEET NO:	DESCRIPTION:	REV:	DATE:	BY:		
	G-001	TITLE SHEET	1	03/10/23	НМР		
₹	G-002 GENERAL NOTES		1	03/10/23	НМР		
	C-101	DETAILED SITE PLAN	encot Jack	03/10/23	НМР		
	C-201	TOWER ELEVATION	MANA .	03/10/23	НМР		
	C-401	RF SCHEDULE AND ANTENNA INSTALLATION	1	03/10/23	НМР		
	C-501	CONSTRUCTION DETAILS	1	03/10/23	НМР		

**GROUNDING DETAILS** 

SUPPLEMENTAL

SUPPLEMENTAL

SUPPLEMENTAL

### R-602

E-501

R-601

R-603

- A TECHNICIAN WILL VISIT THE SITE APPROXIMATELY ONCE A MONTH FOR ROUTINE INSPECTION AND MAINTENANCE.
- 3. THE PROJECT WILL NOT RESULT IN ANY SIGNIFICANT LAND 4. NO SANITARY SEWER, POTABLE WATER OR TRASH DISPOSAL
- IS REQUIRED.
- THE PROJECT DEPICTED IN THESE PLANS QUALIFIES AS AN REVIEW UNDER 47 U.S.C. § 1455(A) AS A MODIFICATION OF AN EXISTING WIRELESS TOWER THAT INVOLVES THE

FROM DOWNTOWN NEW HAVEN START OUT GOING NORTHEAST ON CHURCH ST TOWARD WALL ST. CHURCH ST BECOMES WHITNEY AVE. TURN RIGHT ONTO TRUMBULL ST. TURN SLIGHT LEFT TO TAKE THE I-91 S/I-91 N RAMP MERGE ONTO I-91 S TOWARD I-95/NEW LONDON/N, Y, CITY, MERGE ONTO I-95 S VIA THE EXIT ON THE LEFT TOWARD N Y CITY. TAKE EXIT 32 TOWARD W BROAD ST/STRATFORD, MERGE ONTO LINDEN AVE. TAKE THE 1ST RIGHT ONTO W BROAD ST. TAKE THE 1ST RIGHT ONTO W BROAD ST. TURN RIGHT ONTO BARNUM AVE/US-1 N. TAKE THE 2ND LEFT ONTO BROADBRIDGE AVE. TURN LEFT ONTO STONYBROOK RD SITE IS ON THE LEFT



# Dewberry®

Dewberry Engineers Inc. SUITE 700 BOSTON, MA 02110 PHONE: 617.695.3400 FAX: 617.695.3310

REV.	DESCRIPTION	BY	DATE
Â	PRELIM	BR	01/14/22
0	FINAL	BR	04/20/22
1	FINAL	HMP	03/10/23

ATC SITE NUMBER: 283420

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AT&T SITE NAME:

#### STRATFORD STONYBROOK RD

SITE ADDRESS: 23 STONYBROOK ROAD STRATFORD, CT 06614

03/10/23

HMP





	DATE DRAWN:	01/14/22			
	ATC JOB NO:	13682835_D1			
	CUSTOMER ID:	CTL02381			
	CUSTOMER #:	12906923			

TITLE SHEET

SHEET NUMBER:

G-001

REVISION

#### **GENERAL CONSTRUCTION NOTES:**

- OWNER FURNISHED MATERIALS, AT&T "THE COMPANY" WILL PROVIDE AND THE CONTRACTOR WILL INSTALL
  - A. BTS EQUIPMENT FRAME (PLATFORM) AND ICEBRIDGE SHELTER (GROUND
  - BUILD/CO-LOCATE ONLY)

    B. AC/TELCO INTERFACE BOX (PPC)
  - C. ICE BRIDGE (CABLE TRAY WITH COVER) (GROUND BUILD/CO-LOCATE ONLY, GC TO FURNISH AND INSTALL FOR ROOFTOP INSTALLATION)
  - . TOWERS, MONOPOLES
  - E. TOWER LIGHTING
  - F. GENERATORS & LIQUID PROPANE TANK
  - 6. ANTENNA STANDARD BRACKETS, FRAMES AND PIPES FOR MOUNTING
  - H. ANTENNAS (INSTALLED BY OTHERS)
  - I. TRANSMISSION LINE
  - J. TRANSMISSION LINE JUMPERS
  - K. TRANSMISSION LINE CONNECTORS WITH WEATHERPROOFING KITS
  - L. TRANSMISSION LINE GROUND KITS
  - M, HANGERS
  - N. HOISTING GRIPS
  - O. BTS EQUIPMENT
- 2. THE CONTRACTOR IS RESPONSIBLE TO PROVIDE ALL OTHER MATERIALS FOR THE COMPLETE INSTALLATION OF THE SITE INCLUDING, BUT NOT LIMITED TO, SUCH MATERIALS AS FENCING, STRUCTURAL STEEL SUPPORTING SUB-FRAME FOR PLATFORM, ROOFING LABOR AND MATERIALS, GROUNDING RINGS, GROUNDING WIRES, COPPER-CLAD OR XIT CHEMICAL GROUND ROD(S), BUSS BARS, TRANSFORMERS AND DISCONNECT SWITCHES WHERE APPLICABLE, TEMPORARY ELECTRICAL POWER, CONDUIT, LANDSCAPING COMPOUND STONE, GRANES, CORE DRILLING, SLEEPERS AND RUBBER MATTING, REBAR, CONCRETE CAISSONS, PADS AND/OR AUGER MOUNTS, MISCELLANEOUS FASTENERS, CABLE TRAYS, NON-STANDARD ANTENNA FRAMES AND ALL OTHER MATERIAL AND LABOR REQUIRED TO COMPLETE THE JOB ACCORDING TO THE DRAWINGS AND SPECIFICATIONS. IT IS THE POSITION OF ATAT TO APPLY FOR PERMITTING AND CONTRACTOR RESPONSIBLE FOR PICKUP AND PAYMENT OF REQUIRED
- ALL WORK SHALL CONFORM TO ALL CURRENT APPLICABLE FEDERAL, STATE, AND LOCAL CODES, INCLUDING ANSI/EIA/TIA-222, AND COMPLY WITH ATC CONSTRUCTION SPECIFICATIONS.
- CONTRACTOR SHALL CONTACT LOCAL 811 FOR IDENTIFICATION OF UNDERGROUND UTILITIES PRIOR TO START OF CONSTRUCTION.
- 5. CONTRACTOR SHALL BE RESPONSIBLE FOR COORDINATING ALL REQUIRED
- ALL DIMENSIONS TO, OF, AND ON EXISTING BUILDINGS, DRAINAGE STRUCTURES, AND SITE IMPROVEMENTS SHALL BE VERIFIED IN FIELD BY CONTRACTOR WITH ALL DISCREPANCIES REPORTED TO THE ENGINEER.
- 7. DO NOT CHANGE SIZE OR SPACING OF STRUCTURAL ELEMENTS.
- DETAILS SHOWN ARE TYPICAL; SIMILAR DETAILS APPLY TO SIMILAR CONDITIONS UNLESS OTHERWISE NOTED.
- THESE DRAWINGS DO NOT INCLUDE NECESSARY COMPONENTS FOR CONSTRUCTION SAFETY WHICH SHALL BE THE SOLE RESPONSIBILITY OF THE CONTRACTOR.
- CONTRACTOR SHALL BRACE STRUCTURES UNTIL ALL STRUCTURAL ELEMENTS NEEDED FOR STABILITY ARE INSTALLED. THESE ELEMENTS ARE AS FOLLOWS: LATERAL BRACING ANCHOR BOLTS. ETC.
- CONTRACTOR SHALL DETERMINE EXACT LOCATION OF EXISTING UTILITIES, GROUNDS DRAINS, DRAIN PIPES, VENTS, ETC. BEFORE COMMENCING WORK.
- 12. INCORRECTLY FABRICATED, DAMAGED, OR OTHERWISE MISFITTING OR NONCONFORMING MATERIALS OR CONDITIONS SHALL BE REPORTED TO THE AT&T REP PRIOR TO REMEDIAL OR CORRECTIVE ACTION. ANY SUCH REMEDIAL ACTION SHALL REQUIRE WRITTEN APPROVAL BY THE AT&T REP PRIOR TO PROCEEDING.
- EACH CONTRACTOR SHALL COOPERATE WITH THE AT&T REP, AND COORDINATE HIS WORK WITH THE WORK OF OTHERS.
- 14. CONTRACTOR SHALL REPAIR ANY DAMAGE CAUSED BY CONSTRUCTION OF THIS PROJECT TO MATCH EXISTING PRE-CONSTRUCTION CONDITIONS TO THE SATISFACTION OF THE ATST CONSTRUCTION MANAGER.
- 15. ALL CABLE/CONDUIT ENTRY/EXIT PORTS SHALL BE WEATHERPROOFED DURING INSTALLATION USING A SILICONE SEALANT.
- 16. WHERE EXISTING CONDITIONS DO NOT MATCH THOSE SHOWN IN THIS PLAN SET, CONTRACTOR SHALL NOTIFY THE AT&T REP AND ENGINEER OF RECORD IMMEDIATELY.
- CONTRACTOR SHALL ENSURE ALL SUBCONTRACTORS ARE PROVIDED WITH A COMPLETE AND CURRENT SET OF DRAWINGS AND SPECIFICATIONS FOR THIS PROJECT.
- CONTRACTOR SHALL REMOVE ALL RUBBISH AND DEBRIS FROM THE SITE AT THE END OF EACH DAY.
- CONTRACTOR SHALL COORDINATE WORK SCHEDULE WITH AMERICAN TOWER CORPORATION (ATC), AND TAKE PRECAUTIONS TO MINIMIZE IMPACT AND DISRUPTION OF OTHER OCCUPANTS OF THE FACILITY.
- 20. CONTRACTOR SHALL FURNISH AT&T AND AMERICAN TOWER CORPORATION (ATC) WITH A PDF MARKED UP AS-BUILT SET OF DRAWINGS UPON COMPLETION OF WORK.
- PRIOR TO SUBMISSION OF BID, CONTRACTOR SHALL COORDINATE WITH AT&T REP TO
  DETERMINE WHAT, IF ANY, ITEMS WILL BE PROVIDED. ALL ITEMS NOT PROVIDED SHALL
  BE PROVIDED AND INSTALLED BY THE CONTRACTOR. CONTRACTOR WILL INSTALL ALL
  ITEMS PROVIDED.
- 22. PRIOR TO SUBMISSION OF BID, CONTRACTOR SHALL COORDINATE WITH AT&T REP TO

DETERMINE IF ANY PERMITS WILL BE OBTAINED BY CONTRACTOR. ALL REQUIRED PERMITS NOT OBTAINED BY AT&T MUST BE OBTAINED, AND PAID FOR, BY THE CONTRACTOR.

- CONTRACTOR SHALL INSTALL ALL SITE SIGNAGE IN ACCORDANCE WITH AT&T SPECIFICATIONS AND REQUIREMENTS.
- CONTRACTOR SHALL SUBMIT ALL SHOP DRAWINGS TO AT&T FOR REVIEW AND APPROVAL PRIOR TO FABRICATION.
- ALL EQUIPMENT SHALL BE INSTALLED ACCORDING TO MANUFACTURER'S SPECIFICATIONS AND LOCATED ACCORDING TO AT&T SPECIFICATIONS, AND AS SHOWN IN THESE PLANS.
- 26. THE CONTRACTOR SHALL SUPERVISE AND DIRECT THE PROJECT DESCRIBED HEREIN. THE CONTRACTOR SHALL BE SOLELLY RESPONSIBLE FOR ALL THE CONSTRUCTION MEANS, METHODS, TECHNIQUES, SEQUENCES AND PROCEDURES AND FOR COORDINATING ALL PORTIONS OF THE WORK UNDER THE CONTRACT.
- CONTRACTOR SHALL NOTIFY AT&T REP A MINIMUM OF 48 HOURS IN ADVANCE OF POURING CONCRETE OR BACKFILLING ANY UNDERGROUND UTILITIES, FOUNDATIONS OR SEALING ANY WALL, FLOOR OR ROOF PENETRATIONS FOR ENGINEERING REVIEW AND APPROVAL
- 28. CONTRACTOR SHALL BE RESPONSIBLE FOR SITE SAFETY INCLUDING COMPLIANCE WITH ALL APPLICABLE OSHA STANDARDS AND RECOMMENDATIONS AND SHALL PROVIDE ALL NECESSARY SAFETY DEVICES INCLUDING PPE AND PPM AND CONSTRUCTION DEVICES SUCH AS WELDING AND FIRE PREVENTION, TEMPORARY SHORING, SCAFFOLDING, TRENCH BOXES/SLOPING, BARRIERS, ETC.
- 29. THE CONTRACTOR SHALL PROTECT AT HIS OWN EXPENSE, ALL EXISTING FACILITIES AND SUCH OF HIS NEW WORK LIABLE TO INJURY DURING THE CONSTRUCTION PERIOD. ANY DAMAGE CAUSED BY NEGLECT ON THE PART OF THIS CONTRACTOR OR HIS REPRESENTATIVES, OR BY THE ELEMENTS DUE TO NEGLECT ON THE PART OF THIS CONTRACTOR OR HIS REPRESENTATIVES, £ITHER TO THE EXISTING WORK, OR TO HIS WORK OR THE WORK OF ANY OTHER CONTRACTOR, SHALL BE REPAIRED AT HIS EXPENSE TO THE OWNER'S SATISFACTION.
- 30. ALL WORK SHALL BE INSTALLED IN A FIRST CLASS, NEAT AND WORKMANLIKE MANNER BY MECHANICS SKILLED IN THE TRADE INVOLVED. THE QUALITY OF WORKMANSHIP SHALL BE SUBJECT TO THE APPROVAL OF THE AT&T REP. ANY WORK FOUND BY THE AT&T REP TO BE OF INFERIOR QUALITY AND/OR WORKMANSHIP SHALL BE REPLACED AND/OR REWORKED AT CONTRACTOR EXPENSE UNTIL APPROVAL IS OBTAINED.
- IN ORDER TO ESTABLISH STANDARDS OF QUALITY AND PERFORMANCE, ALL TYPES OF MATERIALS LISTED HEREINAFTER BY MANUFACTURER'S NAMES AND/OR MANUFACTURER'S CATALOG NUMBER SHALL BE PROVIDED BY THESE MANUFACTURERS AS SPECIFIED.
- 32. ATET FURNISHED EQUIPMENT SHALL BE PICKED-UP AT THE AT&T WAREHOUSE, NO LATER THAN 48HR AFTER BEING NOTIFIED INSURED, STORED, UNCRATE, PROTECTED AND INSTALLED BY THE CONTRACTOR WITH ALL APPURTENANCES REQUIRED TO PLACE THE EQUIPMENT IN OPERATION, READY FOR USE, THE CONTRACTOR SHALL BE RESPONSIBLE FOR THE EQUIPMENT AFTER PICKING IT UP.
- 33. AT&T OR HIS ARCHITECT/ENGINEER RESERVES THE RIGHT TO REJECT ANY EQUIPMENT OR MATERIALS WHICH, IN HIS OWN OPINION ARE NOT IN COMPLIANCE WITH THE CONTRACT DOCUMENTS, EITHER BEFORE OR AFTER INSTALLATION AND THE EQUIPMENT SHALL BE REPLACED WITH EQUIPMENT CONFORMING TO THE REQUIREMENTS OF THE CONTRACT DOCUMENTS BY THE CONTRACTOR AT NO COST TO AT&T OR THEIR ARCHITECT/ENGINEER.

# SPECIAL CONSTRUCTION ANTENNA INSTALLATION NOTES:

- WORK INCLUDED.
  - A. ANTENNA AND COAXIAL CABLES ARE FURNISHED BY AT&T UNDER A SEPARATE CONTRACT. THE CONTRACTOR SHALL ASSIST ANTENNA INSTALLATION CONTRACTOR IN TERMS OF COORDINATION AND SITE ACCESS. ERECTION SUBCONTRACTOR SHALL BE RESPONSIBLE FOR THE PROTECTION OF PERSONNEL.
  - B. INSTALL ANTENNAS AS INDICATED ON DRAWINGS AND AT&T SPECIFICATIONS.
  - C. INSTALL GALVANIZED STEEL ANTENNA MOUNTS AS INDICATED ON DRAWINGS.
  - D. INSTALL FURNISHED GALVANIZED STEEL OR ALUMINUM WAVEGUIDE.
  - E. CONTRACTOR SHALL PROVIDE FOUR (4) SETS OF SWEEP TESTS USING ANRITZU-PACKARD 8713B RF SCALAR NETWORK ANALYZER, SUBMIT FREQUENCY DOMAIN REFLECTOMETER (FDR) TESTS RESULTS TO THE PROJECT MANAGER. SWEEP TESTS SHALL BE AS PER ATTACHED RFS "MINIMUM FIELD TESTING RECOMMENDED FOR ANTENNA AND HELIAX COAXIAL CABLE SYSTEMS" DATED 105/93. TESTING SHALL BE PERFORMED BY AN INDEPENDENT TESTING SERVICE AND BE BOUND AND SUBMITTED WITHIN ONE WEEK OF WORK COMPLETION.
  - F. INSTALL COAXIAL CABLES AND TERMINATING BETWEEN ANTENNAS AND EQUIPMENT PER MANUFACTURER'S RECOMMENDATIONS, WEATHERPROOF ALL CONNECTIONS BETWEEN THE ANTENNA AND EQUIPMENT PER MANUFACTURER'S REQUIREMENTS. TERMINATE ALL COAXIAL CABLE THREE (3) FEET IN EXCESS OF ENTRY PORT LOCATION UNLESS OTHERWISE STATEO.
  - G. ANTENNA AND COAXIAL CABLE GROUNDING:
- ALL EXTERIOR #6 GREEN GROUND WIRE "DAISY CHAIN" CONNECTIONS ARE TO BE WEATHER SEALED WITH RFS CONNECTORS/SPLICE WEATHERPROOFING KIT #221213 OR EQUAL.
- ALL COAXIAL CABLE GROUNDING KITS ARE TO BE INSTALLED ON STRAIGHT RUNS OF COAXIAL CABLE (NOT WITHIN BENDS)

ALL DISCREPANCIES FROM WHAT IS SHOWN ON THESE
CONSTRUCTION DRAWINGS SHALL BE COMMUNICATED TO ATC
ENGINEERING IMMEDIATELY FOR CORRECTION OR RE-DESIGN.
FAILURE TO COMMUNICATE DIRECTLY WITH ATC ENGINEERING OR
ANY CHANGES FROM THE DESIGN CONDUCTED WITHOUT PRIOR
APPROVAL FROM ATC ENGINEERING SHALL BE THE SOLE
RESPONSIBILITY OF THE GENERAL CONTRACTOR.





Dewberry Engineers Inc.
99 SUMMER STREET

SUITE 700 BOSTON, MA 02110 PHONE: 617.695.3400 FAX: 617.695.3310

REV.	DESCRIPTION	BY	DATE
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A	PRELIM	BR	01/14/22
0	FINAL	BR	04/20/22
1	FINAL	HMP	03/10/23

ATC SITE NUMBER: 283420

ATC SITE NAME: STONEYBROOK RD CT

AT&T SITE NAME:

#### STRATFORD STONYBROOK RD

SITE ADDRESS: 23 STONYBROOK ROAD STRATFORD, CT 06614

SEAL





DATE DRAWN: 01/14/22
ATC JOB NO: 13682835\_D1
CUSTOMER ID: CTL02381
CUSTOMER #: 12906923

**GENERAL NOTES** 

SHEET NUMBER


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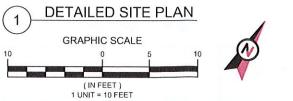
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#### SITE PLAN NOTES:

- 1. THIS SITE PLAN REPRESENTS THE BEST PRESENT KNOWLEDGE AVAILABLE TO THE ENGINEER AT THE TIME OF THIS DESIGN. THE CONTRACTOR SHALL VISIT THE SITE PRIOR TO CONSTRUCTION AND VERIFY ALL EXISTING CONDITIONS RELATED TO THE SCOPE OF WORK FOR THIS PROJECT.
- ICE BRIDGE, CABLE LADDER, COAX PORT, AND COAX CABLE ARE SHOWN FOR REFERENCE ONLY. CONTRACTOR SHALL CONFIRM THE EXACT LOCATION OF ALL PROPOSED AND EXISTING EQUIPMENT AND STRUCTURES DEPICTED ON THIS PLAN. BEFORE UTILIZING EXISTING CABLE SUPPORTS, COAX PORTS, INSTALLING NEW PORTS OR ANY OTHER EQUIPMENT, CONTRACTOR SHALL VERIFY ALL ASPECTS OF THE COMPONENTS MEET THE ATC SPECIFICATIONS.
- 3. THIS PROJECT INCLUDES NO INSTALL OR MODIFICATION AT GRADE.

	LEGEND
8	GROUNDING TEST WELL
ATS	AUTOMATIC TRANSFER SWITCH
В	BOLLARD
CSC	CELL SITE CABINET
D	DISCONNECT
E	ELECTRICAL
F	FIBER
GEN	GENERATOR
G	GENERATOR RECEPTACAL
HH, V	HAND HOLE, VAULT
IB	ICE BRIDGE
K	KENTROX BOX
LC	LIGHTING CONTROL
M	METER
PB	PULL BOX
PP	POWER POLE
тт	TELCO
TRN	TRANSFORMER
motorium X materium	CHAINLINK FENCE





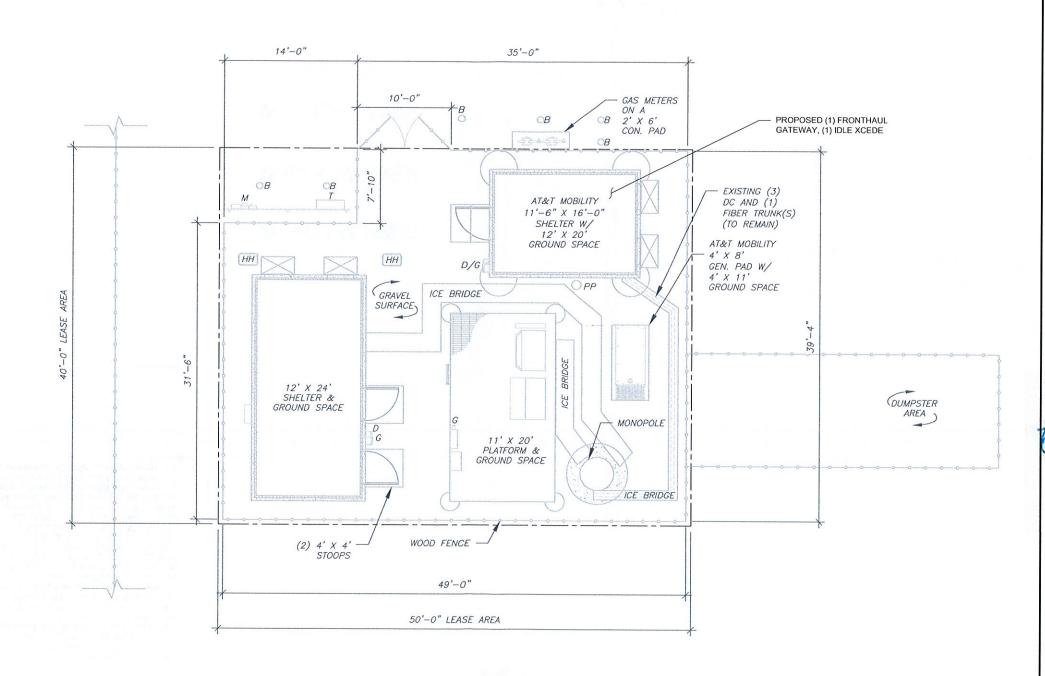



Dewberry Engineers Inc. 99 SUMMER STREET SUITE 700

SUITE 700 BOSTON, MA 02110 PHONE: 617.695.3400 FAX: 617.695.3310

REV.	DESCRIPTION	BY	DATE
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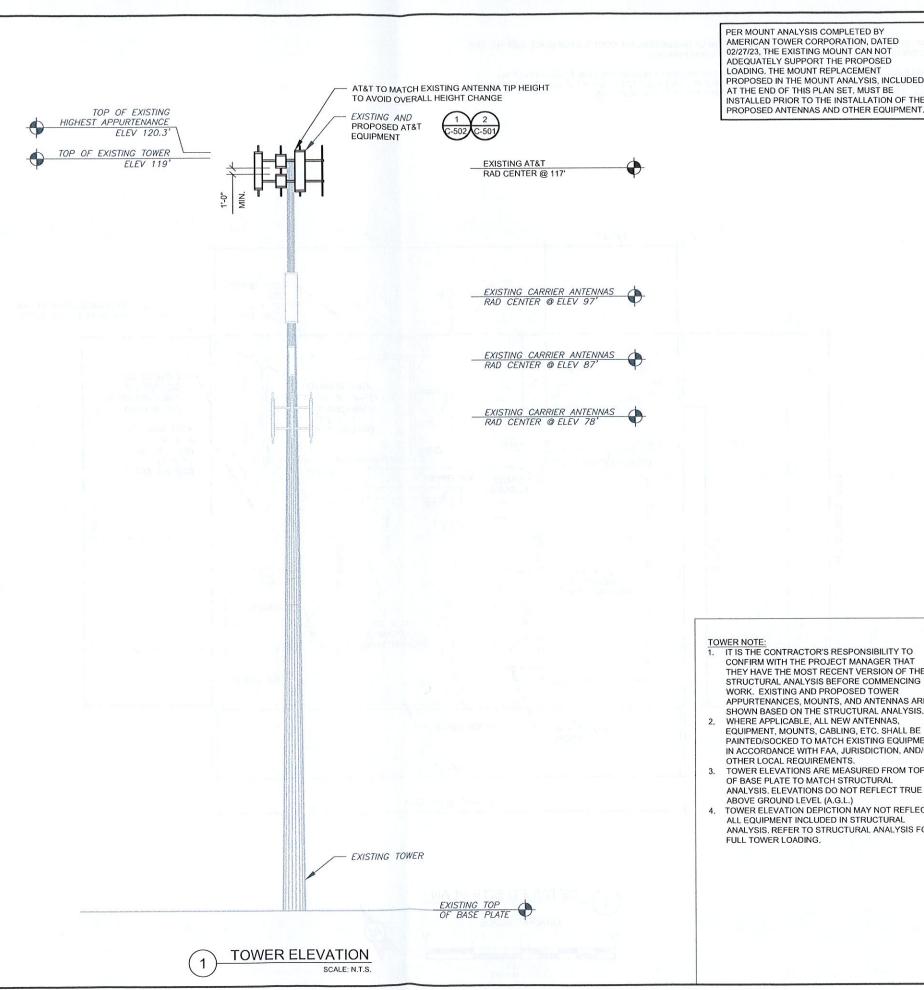
ì	DATE DRAWN:	01/14/22		
	ATC JOB NO:	13682835_D1		
	CUSTOMER ID:	CTL02381		
	CUSTOMER #:	12906923		

DETAILED SITE PLAN

SHEET NUMBER:

C-101

REVISION:



PER MOUNT ANALYSIS COMPLETED BY AMERICAN TOWER CORPORATION, DATED 02/27/23, THE EXISTING MOUNT CAN NOT ADEQUATELY SUPPORT THE PROPOSED LOADING. THE MOUNT REPLACEMENT PROPOSED IN THE MOUNT ANALYSIS, INCLUDED AT THE END OF THIS PLAN SET, MUST BE INSTALLED PRIOR TO THE INSTALLATION OF THE PROPOSED ANTENNAS AND OTHER EQUIPMENT.

IT IS THE CONTRACTOR'S RESPONSIBILITY TO CONFIRM WITH THE PROJECT MANAGER THAT THEY HAVE THE MOST RECENT VERSION OF THE STRUCTURAL ANALYSIS BEFORE COMMENCING WORK. EXISTING AND PROPOSED TOWER APPURTENANCES, MOUNTS, AND ANTENNAS ARE SHOWN BASED ON THE STRUCTURAL ANALYSIS.

PAINTED/SOCKED TO MATCH EXISTING EQUIPMENT IN ACCORDANCE WITH FAA, JURISDICTION, AND/OR

TOWER ELEVATIONS ARE MEASURED FROM TOP OF BASE PLATE TO MATCH STRUCTURAL ANALYSIS. ELEVATIONS DO NOT REFLECT TRUE

TOWER ELEVATION DEPICTION MAY NOT REFLECT ALL EQUIPMENT INCLUDED IN STRUCTURAL ANALYSIS, REFER TO STRUCTURAL ANALYSIS FOR FULL TOWER LOADING.

OTHER LOCAL REQUIREMENTS.

ABOVE GROUND LEVEL (A.G.L.)





Dewberry Engineers Inc. 99 SUMMER STREET SUITE 700

BOSTON, MA 02110 PHONE: 617.695.3400 FAX: 617.695.3310

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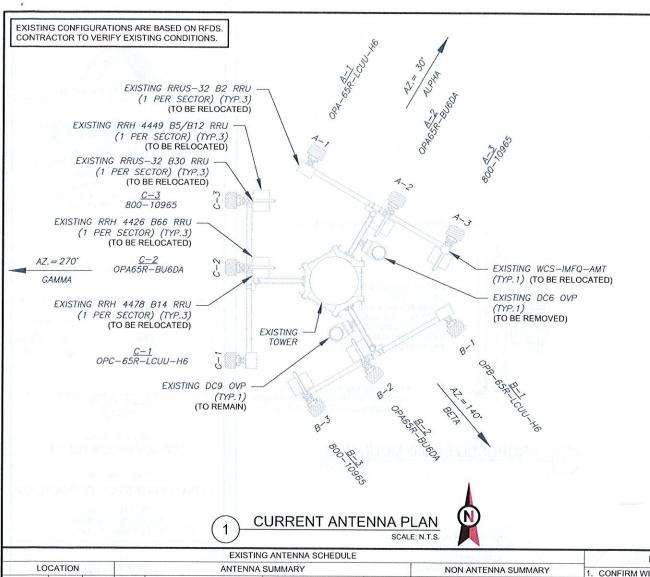
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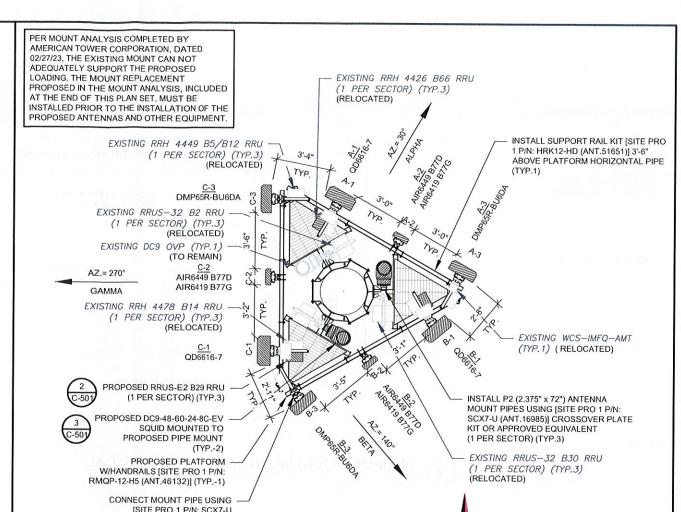
**TOWER ELEVATION** 

SHEET NUMBER:

REVISION:

C-201





ADDITIONAL TOWER SECTOR RAD AZ POS **ANTENNA** BAND STATUS STATUS MOUNTED EQUIPMENT OPA-65R-LCUU-H6 LTE 1900 RMV RRUS-32 B2 REL RRH 4478 B14 REL A2 OPA65R-BU6DA LTE AWS, LTE 700 RMV RRH 4426 B66 117' 30 AI PHA LTE 850, 5G 850, LTE WCS, LTE 700 RRH 4449 B5/B12 A3 800-10965 RRUS-32 830 REL REL WCS-IMFQ-AMT R1 OPA-65R-LCUU-H6 LTE 1900 RMV RRUS-32 B2 REL RRH 4478 R14 REL B2 OPA65R-BU6DA LTE AWS, LTE 700 RMV BETA 117' 140 RRH 4426 B66 REL LTE 850, 5G 850, LTE WCS, LTE 700 RRH 4449 B5/B12 **B**3 800-10965 RRUS-32 B30 REL CI OPA-65R-LCUU-H6 LTE 1900 RMV RRUS-32 B2 RFI RRH 4478 B14 REL C2 OPA65R-BU6DA LTE AWS, LTE 700 RMV 270 **GAMMA** 117' RRH 4426 B66 LTE 850, 5G 850, RRH 4449 B5/B12 RRUS-32 B30 REI C3 800-10965 RMV LTE WCS, LTE 700

EXISTING CABLING SUMMARY

NOTES CONFIRM WITH AT&T REP FOR APPLICABLE UPDATES/REVISIONS AND MOST RECENT RFDS FOR NSN CONFIGURATION (CONFIG) GC TO CAP ALL UNUSED PORTS CONFIRM SPACING OF PROPOSED EQUIP DOES NOT CAUSE TOWER CONFLICTS NOR IMPEDE TOWER CLIMBING PEGS. THE ANTENNA ORIENTATION PLAN IS A SCHEMATIC. ATC DID NOT CONFIRM EXISTING SITE CONDITIONS INCLUDING BUT NOT LIMITED TO, ANTENNA AZIMUTHS, MOUNT CONFIGURATIONS AND TOWER ORIENTATION SCALES SHOWN ARE FOR REFERENCE ONLY AND EXISTING DIMENSIONS ARE APPROXIMATE. THE CONTRACTOR SHALL VERIFY ALL **EXISTING CONDITIONS PRIOR TO** INSTALLATION AND NOTIFY ATC OF ANY DISCREPANCIES CONTRACTOR TO ENSURE PROPER SEPARATION IN ACCORDANCE WITH AT&T'S FIRSTNET REQUIREMENTS (SEE SHEET R-602)

FINAL ANTENNA SCHEDULE LOCATION ANTENNA SUMMARY NON ANTENNA SUMMARY ADDITIONAL TOWER SECTOR RAD AZ POS ANTENNA BAND STATUS STATUS MOUNTED EQUIPMENT REL RRH 4426 B66 LTE 700, 5G 1900, RRH 4478 B14 REL A1 QD6616-7 ADD 5G AWS RRUS-32 B2 REL RRUS-E2 B29 ADD ALPHA 117 30° AIR6449 B77D A2 5C CBAND AIR6419 B77G ADD RRH 4449 B5/B12 RFI **A3** DMP65R-BU6DA 5G 850 ADD RRUS-32 B30 REL WCS-IMFQ-AMT REL RRH 4426 B66 RFI LTE 700, 5G 1900, RRH 4478 B14 **B**1 REL QD6616-7 ADD 5G AWS RRUS-32 B2 REL RRUS-E2 B29 ADD 117' 140° AIR6449 B77D ADD B2 5C CBAND AIR6419 B77G ADD RRH 4449 B5/B12 RFI ВЗ DMP65R-BU6DA 5G 850 ADD RRUS-32 B30 REL RRH 4426 B66 REL LTE 700, 5G 1900, RRH 4478 B14 REL C1 QD6616-7 ADD 5G AWS RRUS-32 B2 REL RRUS-E2 B29 ADD GAMMA 117' 270° AIR6449 B77D ADD C2 5C CBAND AIR6419 B77G ADD RRH 4449 B5/B12 REL C3 DMP65R-BU6DA 5G 850 ADD RRUS-32 B30 REL

FINAL ANTENNA PLAN

STATUS ABBREVIATIONS

RMV: TO BE REMOVED RMN: TO REMAIN REL: TO BE RELOCATED CABLE LENGTHS FOR JUMPERS JUNCTION BOX TO RRU: 15' RRU TO ANTENNA: 10'

(ANT.16985)] CROSSOVER PLATE

KIT OR APPROVED EQUIVALENT

(6 PER SECTOR) (TYP.18)

THIS PAGE CONTAINS CONFIDENTIAL, PROPRIETARY OR TRADE SECRET INFORMATION EXEMPT FROM DISCLOSURE UNDER APPLICABLE LAW.

FINAL FIBER DISTRIBUTION/SQUID		FINAL CABLING SUMMARY			
MODEL NUMBER	STATUS	COAX	DC	FIBER	STATUS
(2) DC9-48-60-24-8C-EV	ADD	-	(3)	(1)	RMN
(1) DC9-48-60-24-8C-EV	RMN	-	4	-	=



# **Dewberry**®

Dewberry Engineers Inc.
99 SUMMER STREET

SUITE 700 BOSTON, MA 02110 PHONE: 617,695,3400 FAX: 617.695.3310

REV.	DESCRIPTION	BY	DATE
A	PRELIM	BR	01/14/22
0	FINAL	BR	04/20/22
1	FINAL	HMP	03/10/23

ATC SITE NUMBER: 283420

ATC SITE NAME: STONEYBROOK RD CT

AT&T SITE NAME:

STRATFORD STONYBROOK RD

SITE ADDRESS: 23 STONYBROOK ROAD STRATFORD, CT 06614

PROPOSED RRUS MUST BE

INSTALLED A MINIMUM OF 12'

AWAY FROM ALL ANTENNAS





- American	
DATE DRAWN:	01/14/22
ATC JOB NO:	13682835_D1
CUSTOMER ID:	CTL02381
CUSTOMER #:	12906923

### RF SCHEDULE AND ANTENNA INSTALLATION


SHEET NUMBER C-401


REVISION

MODEL NUMBER	STATUS	COAX	DC	FIBER	STATUS
(1) DC6-48-60-18-8F	RMV	_	(3)	(1)	RMN
(1) DC9-48-60-24-8C-FV	RMN		-		200


EXISTING FIBER DISTRIBUTION/SQUID

**EQUIPMENT SCHEDULES** 

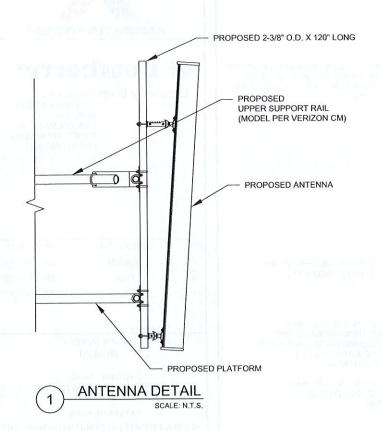

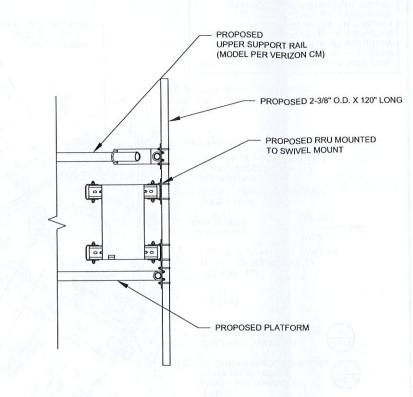


PROPOSED RRU MOUNTING DETAIL - TYPICAL SCALE: N.T.S.

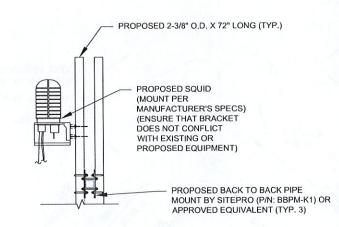


PROPOSED SQUID MOUNTING

SCALE: N.T.S.

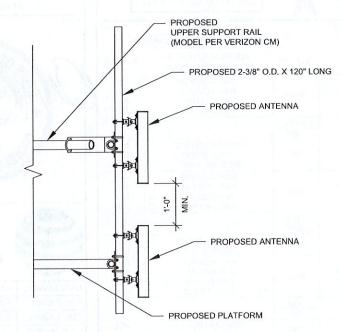

PROPOSED 5G ANTENNA MOUNTING DETAIL - TYPICAL
SCALE: N.T.S.

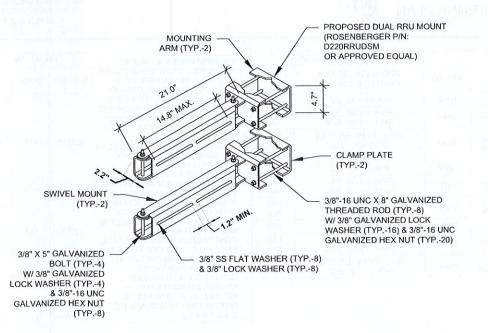

PROPOSED SWIVEL MOUNT DETAIL

SCALE: N.T.S.



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EV.	DESCRIPTION	BY	DATE
A .	PRELIM	BR.	01/14/22
0	FINAL	BR	04/20/22
1	FINAL	HMP	03/10/23

ATC SITE NUMBER: 283420

ATC SITE NAME: STONEYBROOK RD CT

AT&T SITE NAME:

#### STRATFORD STONYBROOK RD

SITE ADDRESS: 23 STONYBROOK ROAD STRATFORD, CT 06614

SE






DATE DRAWN:	01/14/22
ATC JOB NO:	13682835_D1
CUSTOMER ID:	CTL02381
CUSTOMER #:	12906923

# CONSTRUCTION DETAILS

SHEET NUMBER:


C-501

REVISION:

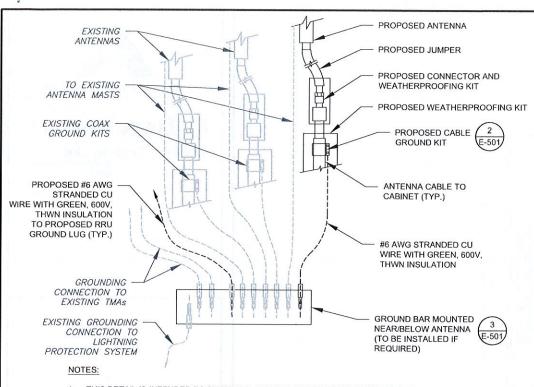

- 1. THIS DETAIL IS INTENDED TO SHOW THE GENERAL GROUNDING REQUIREMENTS. SLIGHT ADJUSTMENTS MAY BE REQUIRED BASED ON EXISTING SITE CONDITIONS. THE CONTRACTOR SHALL MAKE FIELD ADJUSTMENTS AS NEEDED AND INFORM THE CONSTRUCTION MANAGER OF ANY CONFLICTS.
- SITE GROUNDING SHALL COMPLY WITH AT&T GROUNDING STANDARDS, LATEST EDITION. AND COMPLY WITH AT&T GROUNDING CHECKLIST, LATEST VERSION. WHEN NATIONAL AND LOCAL GROUNDING CODES ARE MORE STRINGENT THEY SHALL GOVERN.


# TYPICAL ANTENNA GROUNDING DIAGRAM

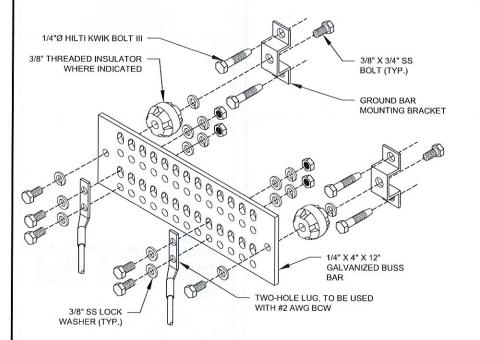


#### **GROUND BAR NOTES**

- GROUND KITS COME WITH ALL HARDWARE, NUTS, BOLTS, WASHERS, ETC. EXCEPT THE STRUCTURAL MOUNTING MEMBER(S).
- 2. GROUND BAR SHALL BE BOLTED TO STRUCTURAL MEMBER OR ANCHORED TO CONCRETE SLAB W/ HILTI KWIK BOLT III.



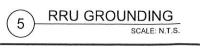


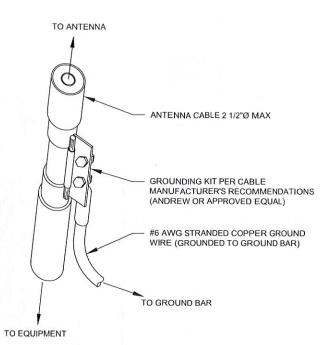


- GROUND KIT NOTES:

  1. DO NOT INSTALL CABLE GROUND KIT AT A BEND AND ALWAYS DIRECT GROUND WIRE DOWN TO GROUND BAR.
- 2. CONTRACTOR SHALL PROVIDE WEATHERPROOFING KIT (ANDREW PART NUMBER 221213) AND INSTALL/TAPE PER MANUFACTURER'S SPECIFICATIONS.

## CABLE GROUND KIT CONNECTION DETAIL

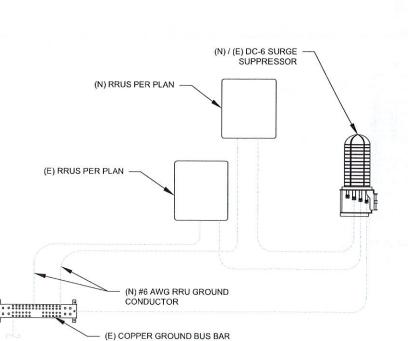

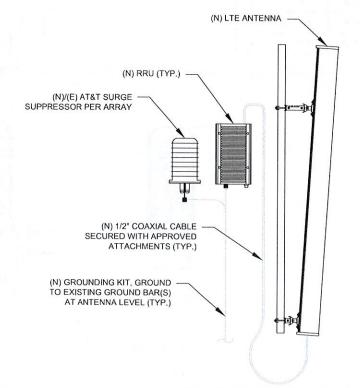

ANTENNA/RRU GROUNDING

#### **GROUND BAR NOTES:**

3/8" X 1-1/2" SS BOLT

(EACH SIDE)

GROUND BAR KITS COME WITH ALL HARDWARE, NUTS, BOLTS, WASHERS, ETC. EXCEPT THE STRUCTURAL MOUNTING MEMBER(S).

3/8" SS LOCK WASHER

1/4" X 4" X 6" GROUND BAR (ERICO P/N: EGBA14406CC OR EQUAL)

(LOWER TOWER GROUND

WITH #2 AWG BCW

BAR ONLY)

TWO-HOLE LUG, TO BE USED

(EACH SIDE)

GROUND BAR TO BE BONDED DIRECTLY TO TOWER.

# TOWER GROUND BAR DETAIL



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PHONE: 617.695.3400

HMP 03/10/23

FAX: 617.695.3310

REV.	DESCRIPTION	BY	DATE
A	PRELIM	BR	01/14/22
<u></u>	FINAL	BR	04/20/22

ATC SITE NUMBER: 283420

ATC SITE NAME: STONEYBROOK RD CT

FINAL

AT&T SITE NAME:

### STRATFORD STONYBROOK RD

SITE ADDRESS: 23 STONYBROOK ROAD STRATFORD, CT 06614

SEAL:






DATE DRAWN:	01/14/22
ATC JOB NO:	13682835_D1
CUSTOMER ID:	CTL02381
CUSTOMER #:	12906923

**GROUNDING DETAILS** 


SHEET NUMBER


REVISION: E-501

MAIN GROUND BAR DETAIL

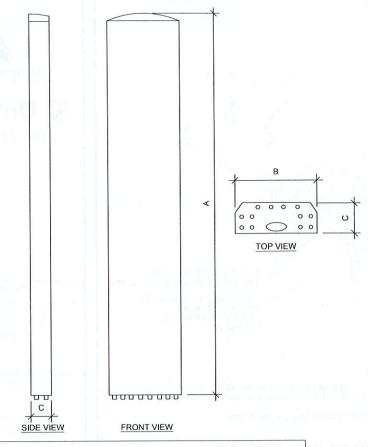


ANTE	NNA SPECIFIC	ATIONS		
ANTENNA MODEL	А	В	С	WEIGHT (LBS)
QD6616-7	72.0"	22.0"	9.6"	59.1
AIR6449 B77D	30.4"	15.9"	8.1"	81.6
AIR6419 B77G	30.4"	15.9"	8.1"	81.6
DMP65R-BU6DA	71.2"	20.2"	7.7"	79.4

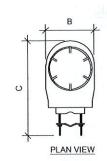

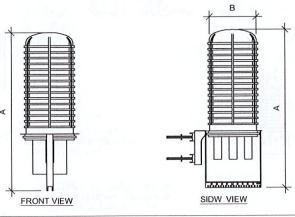

RAYO	AP SPECIFICA	ATIONS		
RAYCAP MODEL	А	В	С	WEIGHT (LBS)
DC9-48-60-24-8C-EV	31.4"	18.3"	10.2"	16.0



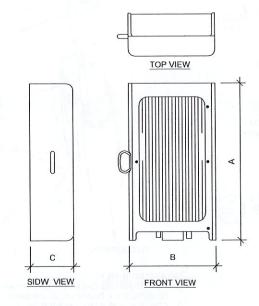

	R	RU SPECIFICAT	IONS		
Иΰ	RRU MODEL	) LIA	В	С	WEIGHT (LBS)
	4415 B30	16.5"	13.4"	5.9"	46.0





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ATC SITE NUMBER: 283420

ATC SITE NAME: STONEYBROOK RD CT

AT&T SITE NAME:

STRATFORD STONYBROOK RD

SITE ADDRESS: 23 STONYBROOK ROAD STRATFORD, CT 06614

SEAL



DATE DRAWN: 01/14/22

ATC JOB NO: 13682835\_D1


CUSTOMER ID: CTL02381

CUSTOMER #: 12906923

SUPPLEMENTAL

SHEET NUMBER:

R-601

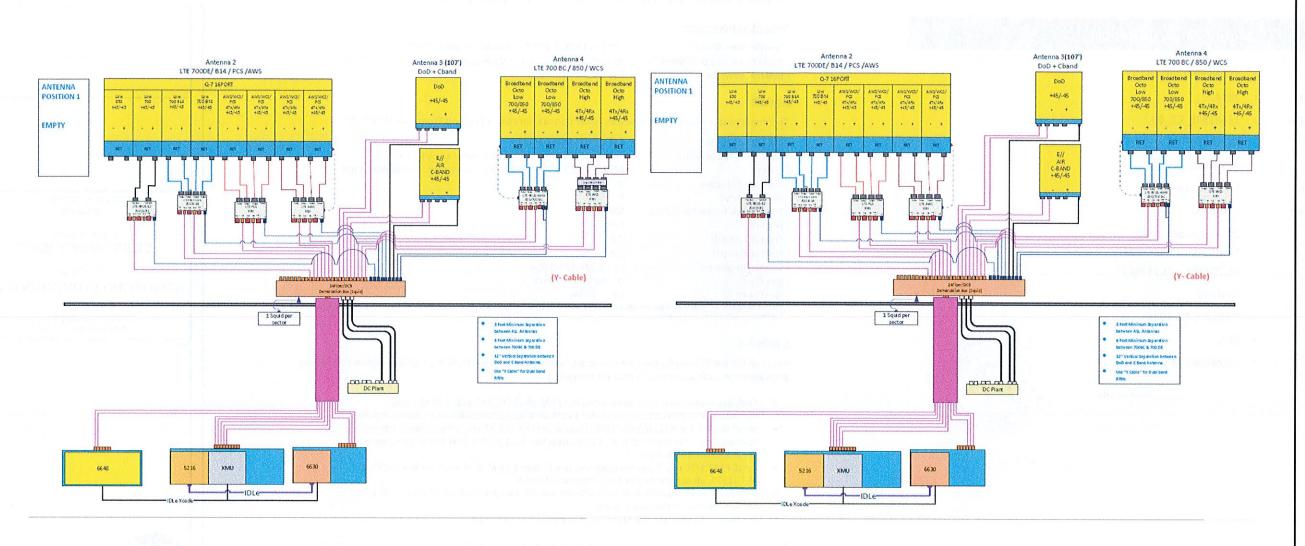





Dewberry Engineers Inc.
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SUITE 700
BOSTON, MA 02110
PHONE: 617.695.3400
FAX: 617.695.3310

ATC SITE NUMBER: 283420

ATC SITE NAME: STONEYBROOK RD CT

AT&T SITE NAME:

STRATFORD STONYBROOK RD

SITE ADDRESS: 23 STONYBROOK ROAD STRATFORD, CT 06614

SEAL:



DATE DRAWN: 01/14/22
ATC JOB NO: 13682835\_D1
CUSTOMER ID: CTL02381
CUSTOMER #: 12906923

SUPPLEMENTAL

SHEET NUMBER:

R-602

NOTE: THIS SHEET WAS CREATED BY OTHERS AND PROVIDED AT THE REQUEST OF THE CUSTOMER WITHOUT EDIT. GENERAL CONTRACTOR IS TO CHECK WITH THE AT&T CM TO ENSURE THIS IS THE MOST RECENT VERSION OF THE RFDS.



### **Mount Analysis Report**

**ATC Asset Name** 

: STONEYBROOK RD CT

**ATC Asset Number** 

: 283420

**Engineering Number** 

: 13682835\_C8\_09

**Mount Elevation** 

: 118.75 ft

**Proposed Carrier** 

: AT&T Mobility

: MRCTB051448

**Carrier Site Name Carrier Site Number** 

: CTL02381

Site Location

: 23 Stonybrook Road

Stratford, CT 06614-3715

41.203358, -73.148543

Reviewed By:

County

: Fairfield

Date

: February 27, 2023

Max Usage

: 65%

**Analysis Result** 

: Contingent Pass

Prepared By:

Aviskar Ghansam Structural Engineer I

Russens Glasson



Authorized by "EOR" 28 Feb 2023 08:06:55 cosign

COA: PEC.0001553

A.T. Engineering Service, PLLC - 3500 Regency Parkway, Suite 100 - Cary, NC 27318 - 919.468 0112 Office - 919.466 0414 Fax - www.americantower.com



Eng. Number 13682835\_C8\_09 February 27, 2023 Page 1

#### Introduction

The purpose of this report is to summarize results of the mount analysis performed for AT&T Mobility at 118.75 ft.

#### **Supporting Documents**

Site Pro 1 RMQP-12-H5, dated November 1, 2017 **Specifications Sheet:** RFDS ID #12906923, dated November 15, 2021 Radio Frequency Data Sheet: Reference Photos: Site photos from 2020

#### **Analysis**

This mount was analyzed using American Tower Corporation's Mount Analysis Program and RISA-3D

Basic Wind Speed:	119 mph (3-Second Gust)	
Basic Wind Speed w/ Ice:	50 mph (3-Second Gust) w/ 1.00" radial ice concurrent	
Codes:	ANSI/TIA-222-H/ 2021 IBC / 2022 Connecticut State Building Code	
Exposure Category:	В	
Risk Category:	A Lorentz Lore	
Topographic Factor Procedure:	Method 2	
Feature:	Flat	
Crest Height (H):	Oft	
Crest Length (L):	0 ft	
Spectral Response:	Ss = 0.207, S1 = 0.054	
Site Class:	D - Stiff Soil - Default	
Live Loads:	Lm = 500 lbs	

\* Based on experience, it has been determined that the Ly load cases will not control over Lm load cases in platform mount analyses. Therefore, these load cases have been excluded from this analysis.

#### Conclusion

Based on the analysis results, the antenna mount meets the requirements per the applicable codes listed above provided the modifications listed below are completed:

- Analysis based on new installation of Site Pro 1 RMQP-12-H5, ANT.46132, Platform w/ Handrails(s) (M2050R(2500)-4[6]). Do not install work support catwalk below purpose mount.
- Install Site Pro 1 HRK12-HD (ANT.51651) Support Rail kit at 3'-6" above the existing platform horizontal pipe. Connect to all mount pipes using Site Pro 1 SCX7-U, ANT.16985, crossover plate kits or approved equivalent.
- Install P2 (2.375" x 72") antenna mounting pipe (Mount Pipe M, N, O) with Site Pro 1 SCX7-U, ANT.16985, (or approved equivalent) crossover plate kits.
- No structural failures were addressed with the noted contingencies. Contingencies address Carrier's antenna spacing requirements.
- The rough cost estimate, pre-MOD design, is estimated to be ≤\$10k.

If you have any questions or require additional information, please contact American Tower via email at Engineering@americantower.com. Please include the American Tower site name, site number, and engineering number in the subject line for any questions.

A.T. Engineering Service, PLLC - 3500 Regency Perkway, Suite 100 - Cary, NC 27518 - 919.468 0112 Office - 919.466 0414 Fax - www.americantower.com

NOTE: THIS SHEET WAS CREATED BY OTHERS AND PROVIDED AT THE REQUEST OF THE CUSTOMER WITHOUT EDIT. PLEASE REFERENCE THE MOUNT ANALYSIS REPORT FOR COMPLETE MOUNT

CONSTRUCTION DRAWINGS ARE FOR REFERENCE ONLY. GENERAL CONTRACTOR IS TO

VERYIFY THEY HAVE THE MOST RECENT MOUNT ANALYSIS PRIOR TO CONTRUCTION.

ANALYSIS CALCULATIONS AND DETAILS. SUPPLEMENTAL PAGES INCLUDED IN THE



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> ATC SITE NUMBER: 283420

ATC SITE NAME: STONEYBROOK RD CT

AT&T SITE NAME:

STRATFORD STONYBROOK RD

SITE ADDRESS: 23 STONYBROOK ROAD STRATFORD, CT 06614



DATE DRAWN: 01/14/22 13682835\_D1 ATC JOB NO: CUSTOMER ID: CTL02381 CUSTOMER #: 12906923

SUPPLEMENTAL

SHEET NUMBER:

R-603

MOUNT ANALYSIS