

STATE OF CONNECTICUT CONNECTICUT SITING COUNCIL

Ten Franklin Square, New Britain, CT 06051 Phone: (860) 827-2935 Fax: (860) 827-2950 E-Mail: siting.council@ct.gov Web Site: portal.ct.gov/csc

VIA ELECTRONIC MAIL

December 8, 2021

David Hoogasian
Project Manager
Network Building + Consulting, LLC
100 Apollo Drive, Suite 303
Chelmsford, MA 01824
dhoogasian@nbcllc.com

RE: TS-DISH-137-211105 - Dish Wireless LLC request for an order to approve tower sharing at an existing telecommunications facility located at 166 Pawcatuck Avenue, Stonington, Connecticut.

Dear Mr. Hoogasian:

The Connecticut Siting Council (Council) is in receipt of your correspondence of December 7, 2021 submitted in response to the Council's December 6, 2021 notification of an incomplete request for tower sharing with regard to the above-referenced matter.

The submission renders the request for tower sharing complete and the Council will process the request in accordance with the Federal Communications Commission 60-day timeframe.

Thank you for your attention and cooperation. Sincerely,

Melanie A. Bachman Executive Director

Matrid Real

MAB/IN/laf

From: David Hoogasian < dhoogasian@nbcllc.com>

Sent: Tuesday, December 7, 2021 4:50 PMTo: Robidoux, Evan <Evan.Robidoux@ct.gov>Cc: CSC-DL Siting Council <Siting.Council@ct.gov>

Subject: RE: Council Incomplete Letter for TS-DISH-137-211105 (Pawcatuck Avenue, Stonington)

Good afternoon. Attached please find the requested documentation:

- Original Tower facility approval (CSC Docket No. 399 Decision and Order)
- Project Narrative referencing the original facility approval
- Property owner record card
- PE Stamped CD's

A hard copy of these materials will be mailed in to you shortly.

If you have any questions or need any further information, please feel free to contact me.

Thank you,

David Hoogasian

Project Manager

NETWORK BUILDING + CONSULTING

100 Apollo Drive | Suite 303 | Chelmsford, MA | 01824 M 508.344.3343







DOCKET NO. 399 – T-Mobile Northeast LLC application for a	}	Connecticut
Certificate of Environmental Compatibility and Public Need for		
the construction, management, and maintenance of a	}	Siting
telecommunications facility at 166 Pawcatuck Avenue,		
Stonington, Connecticut.	}	Council
		August 26, 2010

Decision and Order

Pursuant to the foregoing Findings of Fact and Opinion, the Connecticut Siting Council (Council) finds that the effects associated with the construction, management, and maintenance of a telecommunications facility, including effects on the natural environment; ecological integrity and balance; public health and safety; scenic, historic, and recreational values; forests and parks; air and water purity; and fish and wildlife are not disproportionate, either alone or cumulatively with other effects, when compared to need, are not in conflict with the policies of the State concerning such effects, and are not sufficient reason to deny the application, and therefore directs that a Certificate of Environmental Compatibility and Public Need, as provided by General Statutes § 16-50k, be issued to T-Mobile Northeast LLC, hereinafter referred to as the Certificate Holder, for a telecommunications facility located at 166 Pawcatuck Avenue in Stonington, Connecticut.

Unless otherwise approved by the Council, the facility shall be constructed, operated, and maintained substantially as specified in the Council's record in this matter, and subject to the following conditions:

- 1. The tower shall be constructed as a monopole, no taller than necessary to provide the proposed telecommunications services, sufficient to accommodate the antennas of T-Mobile Northeast LLC and other entities, both public and private, but such tower shall not exceed a height of 120 feet above ground level. The tower shall incorporate a yield point at a height approximately 100 feet above ground level.
- 2. The Certificate Holder shall prepare a Development and Management (D&M) Plan for this site in compliance with Sections 16-50j-75 through 16-50j-77 of the Regulations of Connecticut State Agencies. The D&M Plan shall be served on the Town of Stonington for comment, and all parties and intervenors as listed in the service list, and submitted to and approved by the Council prior to the commencement of facility construction and shall include:
 - a) a final site plan(s) of site development to include specifications for the tower, tower foundation, antennas, equipment compound, radio equipment, access road, utility line, and landscaping; and
 - b) construction plans for site clearing, grading, landscaping, water drainage, and erosion and sedimentation controls consistent with the <u>2002 Connecticut Guidelines for Soil Erosion and Sediment Control</u>, as amended.

Docket 399: Stonington Decision and Order

Page 2

- 3. Prior to the commencement of operation, the Certificate Holder shall provide the Council worst-case modeling of the electromagnetic radio frequency power density of all proposed entities' antennas at the closest point of uncontrolled access to the tower base, consistent with Federal Communications Commission, Office of Engineering and Technology, Bulletin No. 65, August 1997. The Certificate Holder shall ensure a recalculated report of the electromagnetic radio frequency power density be submitted to the Council if and when circumstances in operation cause a change in power density above the levels calculated and provided pursuant to this Decision and Order.
- 4. Upon the establishment of any new State or federal radio frequency standards applicable to frequencies of this facility, the facility granted herein shall be brought into compliance with such standards.
- 5. The Certificate Holder shall permit public or private entities to share space on the proposed tower for fair consideration, or shall provide any requesting entity with specific legal, technical, environmental, or economic reasons precluding such tower sharing.
- 6. The Certificate Holder shall provide reasonable space on the tower for no compensation for any Town of Stonington public safety services (police, fire and medical services), provided such use can be accommodated and is compatible with the structural integrity of the tower.
- 7. Unless otherwise approved by the Council, if the facility authorized herein is not fully constructed and providing wireless services within eighteen months from the date of the mailing of the Council's Findings of Fact, Opinion, and Decision and Order (collectively called "Final Decision"), this Decision and Order shall be void, and the Certificate Holder shall dismantle the tower and remove all associated equipment or reapply for any continued or new use to the Council before any such use is made. The time between the filing and resolution of any appeals of the Council's Final Decision shall not be counted in calculating this deadline.
- 8. At least one wireless telecommunications carrier shall install their equipment and shall become operational not later than 120 days after the tower is erected. Authority to monitor and modify this schedule, as necessary, is delegated to the Executive Director. The Certificate Holder shall provide written notice to the Executive Director of any schedule changes as soon as is practicable.
- 9. Any request for extension of the time period referred to in Condition 7 shall be filed with the Council not later than 60 days prior to the expiration date of this Certificate and shall be served on all parties and intervenors, as listed in the service list, and the Town of Stonington. Any proposed modifications to this Decision and Order shall likewise be so served.
- 10. If the facility ceases to provide wireless services for a period of one year, this Decision and Order shall be void, and the Certificate Holder shall dismantle the tower and remove all associated equipment or reapply for any continued or new use to the Council before any such use is made.
- 11. The Certificate Holder shall remove any nonfunctioning antenna, and associated antenna mounting equipment, within 60 days of the date the antenna ceased to function.

Docket 399: Stonington Decision and Order

Page 3

- 12. In accordance with Section 16-50j-77 of the Regulations of Connecticut State Agencies, the Certificate Holder shall provide the Council with written notice two weeks prior to the commencement of site construction activities. In addition, the Certificate Holder shall provide the Council with written notice of the completion of site construction, and the commencement of site operation.
- 13. The Certificate Holder shall remit timely payments associated with annual assessments and invoices submitted by the Council for expenses attributable to the facility under Conn. Gen. Stat. §16-50v.
- 14. This Certificate may be transferred in accordance with Conn. Gen. Stat. §16-50k(b), provided both the Certificate Holder\transferor and the transferee are current with payments to the Council for their respective annual assessments and invoices under Conn. Gen. Stat. §16-50v. In addition, both the Certificate Holder\transferor and the transferee shall provide the Council a written agreement as to the entity responsible for any quarterly assessment charges under Conn. Gen. Stat. §16-50v(b)(2) that may be associated with this facility.

Pursuant to General Statutes § 16-50p, the Council hereby directs that a copy of the Findings of Fact, Opinion, and Decision and Order be served on each person listed below, and notice of issuance shall be published in the New London Day.

By this Decision and Order, the Council disposes of the legal rights, duties, and privileges of each party named or admitted to the proceeding in accordance with Section 16-50j-17 of the Regulations of Connecticut State Agencies.

The parties and intervenors to this proceeding are:

Applicant

T-Mobile Northeast, LLC

Its Representative

Julie D. Kohler, Esq. Jesse A. Langer, Esq. Cohen and Wolf, P.C. 1115 Broad Street Bridgeport, CT 06604

Intervenor

Cellco Partnership d/b/a Verizon Wireless

Its Representative

Kenneth C. Baldwin, Esq. Robinson & Cole LLP 280 Trumbull Street Hartford, CT 06103-3597



TOTALLY COMMITTED.

December 7, 2021

Melanie A. Bachman Executive Director Connecticut Siting Council 10 Franklin Square New Britain, CT 06051

Re: Request of DISH Wireless LLC for an Order to Approve the Shared Use of an Existing Tower 166 Pawcatuck Ave., Stonington, CT 06379 Latitude: 41'21'37.77" /Longitude: -71'51'08.65"

Dear Ms. Bachman:

Pursuant to Connecticut General Statutes ("C.G.S.") §16-50aa, as amended, DISH Wireless LLC ("DISH") hereby requests an order from the Connecticut Siting Council ("Council") to approve the shared use by DISH of an existing telecommunication tower at 166 Pawcatuck Ave in Stonington (the "Property"). The existing 119-foot monopole tower is owned by American Tower Corporation ("ATC"). The underlying property is owned by Alan D. Main Jr., Alan D Main Sr., and Jill N M Main. DISH requests that the Council find that the proposed shared use of the ATC tower satisfies the criteria of C.G.S. §16-50aa and issue an order approving the proposed shared use. A copy of this filing is being sent to Danielle Chesebrough, First Selectman for the Town of Stonington, Lawrence Stannard, Town of Stonington Building Official and Alan D. Main Jr., Alan D Main Sr., and Jill N M Main as the property owners.

Background

This facility was approved by the Council under Docket No. 399 on August 26, 2010. A copy of the Decision and Order is included in the filing attachments. The existing ATC facility consists of a 119-foot monopole tower located within an existing leased area. T-Mobile currently maintains antennas at the 117-foot level. Equipment associated with these antennas are located at various positions within the tower and compound.

DISH is licensed by the Federal Communications Commission ("FCC") to provide wireless services throughout the State of Connecticut. DISH and Crown Castle have agreed to the proposed shared use of the 166 Pawcatuck Ave tower pursuant to mutually acceptable terms and conditions. Likewise, DISH and ATC have agreed to the proposed installation of equipment cabinets on the ground within the existing compound. ATC has authorized DISH to apply for all necessary permits and approvals that may be required to share the existing tower. (See attached Letter of Authorization)



TOTALLY COMMITTED.

DISH proposes to install three (3) antennas, (1) Tower platform mount, (6) Remote radio units at the 104-foot level along with (1) over voltage protection device (OVP) and (1) Hybrid cable. DISH will install an equipment cabinet on a 5'x7' equipment platform. DISH's Construction Drawings provide project specifications for all proposed site improvement locations. The construction drawings also include specifications for DISH's proposed antenna and ground work.

- C.G.S. § 16-50aa(c)(1) provides that, upon written request for approval of a proposed shared use, "if the Council finds that the proposed shared use of the facility is technically, legally, environmentally and economically feasible and meets public safety concerns, the council shall issue an order approving such a shared use." DISH respectfully submits that the shared use of the tower satisfies these criteria.
- A. Technical Feasibility. The existing ATC tower is structurally capable of supporting DISH's proposed improvements. The proposed shared use of this tower is, therefore, technically feasible. A Feasibility Structural Analysis Report ("Structural Report") prepared for this project confirms that this tower can support DISH's proposed loading. A copy of the Structural Report has been included in this application.
- **B.** Legal Feasibility. Under C.G.S. § 16-50aa, the Council has been authorized to issue order approving the shared use of an existing tower such as the ATC tower. This authority complements the Council's prior-existing authority under C.G.S. § 16-50p to issue orders approving the construction of new towers that are subject to the Council's jurisdiction. In addition, § 16-50x(a) directs the Council to "give such consideration to the other state laws and municipal regulations as it shall deem appropriate" in ruling on requests for the shared use of existing tower facilities. Under the statutory authority vested in the Council, an order by the Council approving the requested shared use would permit the Applicant to obtain a building permit for the proposed installations.
- **C. Environmental Feasibility**. The proposed shared use of the ATC tower would have a minimal environmental effect for the following reasons:
 - 1. The proposed installation will have no visual impact on the area of the tower. DISH's equipment cabinet would be installed within the existing facility compound. DISH's shared use of this tower therefore will not cause any significant change or alteration in the physical or environmental characteristics of the existing site.
 - 2. Operation of DISH's antennas at this site would not exceed the RF emissions standard adopted by the Federal Communications Commission ("FCC"). Included in the EME report of this filing are the approximation tables that demonstrate that DISH's proposed facility will operate well within the FCC RF emissions safety standards.
 - 3. Under ordinary operating conditions, the proposed installation would not require the use of any water or sanitary facilities and would not generate air emissions or discharges to water bodies or sanitary facilities. After construction is complete the proposed installations would not generate any increased traffic to the ATC facility other than periodic maintenance. The proposed shared use of the ATC tower, would, therefore, have a minimal environmental effect, and is environmentally feasible.



TOTALLY COMMITTED.

- D. **Economic Feasibility**. As previously mentioned, DISH has entered into an agreement with ATC for the shared use of the existing facility subject to mutually agreeable terms. The proposed tower sharing is, therefore, economically feasible.
- E. **Public Safety Concerns**. As discussed above, the tower is structurally capable of supporting DISH's full array of three (3) antennas, (1) Tower platform mount, (6) Remote radio units, (1) over voltage protection device (OVP) and (1) Hybrid cable and all related equipment. DISH is not aware of any public safety concerns relative to the proposed sharing of the existing ATC tower

Conclusion


For the reasons discussed above, the proposed shared use of the existing ATC tower at 166 Pawcatuck Ave satisfies the criteria stated in C.G.S. §16-50aa and advances the Council's goal of preventing the unnecessary proliferation of towers in Connecticut. The Applicant, therefore, respectfully requests that the Council issue an order approving the prosed shared use.

Sincerely,

David Hoogasian

David Hoogasian

Project Manager

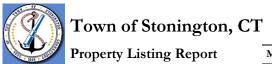

Map Block Lot

26-2-1

Building #

PID

3202

Account

00511500

Property Information


	•		
Property Location	166 PAWCATUCK AVE		
Owner	MAIN ALAN D JR & JILL N M & ALAN D SR		
Co-Owner			
Mailing Address	166 PAWCATUCK AVE		
8	PAWCATUCK CT 06379		
Land Use	0101 Single Fam M-01		
Land Class	R		
Zoning Code	RR-80		
Census Tract	7051		

Neighborhood	0035		
Acreage	5.02		
Utilities	Public Water,Public Sewer		
Lot Setting/Desc	Suburban Level		
Book / Page	804/68		
Additional Info			

Photo



Sketch

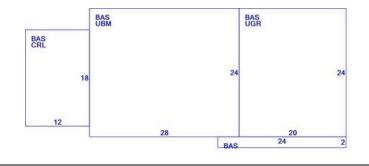

Primary Construction Details

-	
Year Built	1967
Building Desc.	Single Fam M-01
Building Style	Ranch
Building Grade	Average
Stories	1
Occupancy	1
Exterior Walls	Aluminum Sidng
Exterior Walls 2	NA
Roof Style	Gable/Hip
Roof Cover	Asph/F Gls/Cmp
Interior Walls	Drywall/Sheet
Interior Walls 2	NA
Interior Floors 1	Carpet
Interior Floors 2	Hardwood


Heating Fuel	Electric
Heating Type	Electr Basebrd
AC Type	None
Bedrooms	03
Full Bathrooms	0
Half Bathrooms	1
Extra Fixtures	
Total Rooms	6 Rooms
Bath Style	Average
Kitchen Style	Average
Fin Bsmt Area	
Fin Bsmt Quality	
Bsmt Gar	
Fireplaces	
·	

(*Industrial / Commercial Details)

("Industrial / Commercial Details)			
Building Use	Residential		
Building Condition	AV		
Sprinkler %			
Heat / AC			
Frame Type			
Baths / Plumbing			
Ceiling / Wall			
Rooms / Prtns			
Wall Height			
First Floor Use			
Foundation			
	•		

Report Created On

12/7/2021

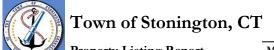

Property Listing Report

Map Block Lot

26-2-1

Building #

PID

3202

Account

00511500

Valuation Sumi	mary (As	ssessed value = 70%	6 of Appraised Value)	Sub Areas				
Item	Appr	aised	Assessed	Subarea Ty	ype	Gross Area (sq	ft) Living A	rea (sq f
Buildings	97900		68500	First Floor		1416	1416	
Extras	18200		12700	Crawl Space		216	0	
Improvements				Basement, Unfini	ished	672	0	
Outbuildings	189000		132200	Garage, Under		480	0	
Land	116400		76080					
Гotal	421500		289480					
Outbuilding an	nd Extra F	eatures						
Туре		Description	1					
W/LOFT-AVG		1944.00 S.F						
PLTRY HSE 1 ST		48.00 S.F.						
FENCE-8' CHAIN 180.00 L.F.								
SOLAR ELEC	SOLAR ELEC 28.00 UNITS							
CELL TOWER		1.00 UNIT						
				Total Area		2784	1416	
Sales History								
Owner of Record		Book/ Page	Sale Date	e Sa	le Price			
MAIN ALAN D JR & JILL N M & ALAN D SR		804/68	8/11/2020	8/11/2020 256000				
MAIN PATRICIA L				0771/0415	12/7/201	7 0		
MAIN WARREN D &	PATRICIA L			0399/0684	1/24/199	7 0		
MAIN WARREN D &	DATRICIA I			0158/0365	8/31/196	6 0		



Town of Stonington, CT

Property Listing Report

Map Block Lot

26-2-1

Building #


PID

3202

Account

00511500

Photo

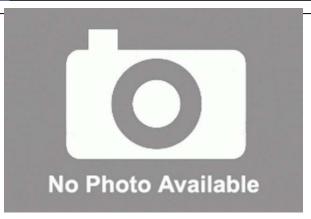

Sketch



Primary Construction Details

Year Built	
Building Desc.	Vacant
Building Style	
Building Grade	
Stories	
Occupancy	
Exterior Walls	
Exterior Walls 2	NA
Roof Style	
Roof Cover	
Interior Walls	
Interior Walls 2	NA
Interior Floors 1	
Interior Floors 2	

Heating Fuel	
Heating Type	
AC Type	
Bedrooms	0
Full Bathrooms	0
Half Bathrooms	0
Extra Fixtures	
Total Rooms	0
Bath Style	NA
Kitchen Style	NA
Fin Bsmt Area	
Fin Bsmt Quality	
Bsmt Gar	
Fireplaces	

(*Industrial / Commercial Details)

("Industrial"/ Commercial Details)			
TEL X STA M-00			

Sub Areas

Subarea Type	Gross Area (sq ft)	Living Area (sq ft)	
	(-1-7)	(94 11)	_
			_
			_
			_
			_
			_
			_
			_
			_

Subarea Type	Gross Area (sq ft)	Living Area (sq ft)
Total Area		0

dish wireless...

DISH Wireless L.L.C. SITE ID:

BOBOS00021A

DISH Wireless L.L.C. SITE ADDRESS:

166 PAWCATUCK AVE STONINGTON, CT 06378

CONNECTICUT CODE COMPLIANCE

ALL WORK SHALL BE PERFORMED AND MATERIALS INSTALLED IN ACCORDANCE WITH THE CURRENT EDITIONS OF THE FOLLOWING CODES AS ADOPTED BY THE LOCAL GOVERNING AUTHORITIES. NOTHING IN THESE PLANS IS TO BE CONSTRUED TO PERMIT WORK NOT CONFORMING TO THESE CODES:

2018 CT STATE BUILDING CODE/2015 IBC W/ CT AMENDMENTS 2018 CT STATE BUILDING CODE/2015 IMC W/ CT AMENDMENTS
2018 CT STATE BUILDING CODE/2017 NEC W/ CT AMENDMENTS MECHANICAL

	SHEET INDEX
SHEET NO.	SHEET TITLE
T-1	TITLE SHEET
LS1	SITE SURVEY
LS2	SITE SURVEY CONTINUED
A-1	OVERALL AND ENLARGED SITE PLAN
A-2	ELEVATION, ANTENNA LAYOUT AND SCHEDULE
A-3	EQUIPMENT PLATFORM AND H-FRAME DETAILS
A-4	EQUIPMENT DETAILS
A-5	EQUIPMENT DETAILS
A-6	EQUIPMENT DETAILS
E-1	ELECTRICAL/FIBER ROUTE PLAN AND NOTES
E-2	ELECTRICAL DETAILS
E-3	ELECTRICAL ONE-LINE, FAULT CALCS & PANEL SCHEDULE
G-1	GROUNDING PLANS AND NOTES
G-2	GROUNDING DETAILS
G-3	GROUNDING DETAILS
RF-1	RF CABLE COLOR CODE
GN-1	LEGEND AND ABBREVIATIONS
GN-2	GENERAL NOTES
GN-3	GENERAL NOTES
GN-4	GENERAL NOTES

THE PROJECT DEPICTED IN THESE PLANS QUALIFIES AS AN ELIGIBLE FACILITIES REQUEST ENTITLED TO EXPEDITED REVIEW UNDER 47 U.S.C. 1455(A) AS A MODIFICATION OF AN EXISTING WIRELESS TOWER THAT INVOLVES THE COLLOCATION REMOVAL AND/OR REPLACEMENT OF TRANSMISSION EQUIPMENT THAT IS NOT A SUBSTANTIAL CHANGE

SCOPE OF WORK

THIS IS NOT AN ALL INCLUSIVE LIST. CONTRACTOR SHALL UTILIZE SPECIFIED EQUIPMENT PART OR ENGINEER APPROVED EQUIVALENT. CONTRACTOR SHALL VERIFY ALL NEEDED EQUIPMENT TO PROVIDE A FUNCTIONAL SITE. THE PROJECT GENERALLY CONSISTS OF THE FOLLOWING:

TOWER SCOPE OF WORK:

• INSTALL (3) PROPOSED PANEL ANTENNAS (1 PER SECTOR)

• INSTALL (1) PROPOSED TOWER PLATFORM MOUNT

INSTALL PROPOSED JUMPERS

INSTALL (6) PROPOSED RRUS (2 PER SECTOR)

INSTALL (1) PROPOSED OVER VOLTAGE PROTECTION DEVICE (OVP)

INSTALL (1) PROPOSED HYBRID CABLE

GROUND SCOPE OF WORK:

INSTALL (1) PROPOSED METAL PLATFORM

INSTALL (1) PROPOSED ICE BRIDGE

INSTALL (1) PROPOSED PPC CABINET

PROPOSED EQUIPMENT CABINET

 INSTALL (1) PROPOSED POWER CONDUIT 1) PROPOSED TELCO CONDUIT INSTALL

INSTALL PROPOSED TELCO-FIBER BOX

INSTALL (1) PROPOSED GPS UNIT

INSTALL (1) PROPOSED FIBER NID (IF REQUIRED)

SITE PHOTO





UNDERGROUND SERVICE ALERT CBYD 811 UTILITY NOTIFICATION CENTER OF CONNECTICUT (800) 922-4455

CALL 2 WORKING DAYS UTILITY NOTIFICATION PRIOR TO CONSTRUCTION

THE FACILITY IS UNMANNED AND NOT FOR HUMAN HABITATION. A TECHNICIAN WILL VISIT THE SITE AS REQUIRED FOR ROUTINE MAINTENANCE. THE PROJECT WILL NOT RESULT IN ANY SIGNIFICANT DISTURBANCE OR EFFECT ON DRAINAGE. NO SANITARY SEWER SERVICE, POTABLE WATER, OR TRASH DISPOSAL IS REQUIRED AND NO COMMERCIAL

CONTRACTOR SHALL VERIFY ALL PLANS, EXISTING DIMENSIONS, AND CONDITIONS ON THE JOB SITE, AND SHALL IMMEDIATELY NOTIFY THE ENGINEER IN WRITING OF ANY DISCREPANCIES BEFORE

166 PAWCATUCK AVE PAWCATUCK, CT 06379

PROPERTY OWNER: ADDRESS:

SITE INFORMATION

TOWER TYPE: MONOPOLE

TOWER CO SITE ID:

TOWER APP NUMBER: 13693120

COUNTY: NEW LONDON

41.360492 N LONGITUDE (NAD 83): 71° 51' 08.65" W

71.852403 W ZONING JURISDICTION: CONNECTICUT SITING COUNCIL

41° 21' 37.77" N

ZONING DISTRICT: RESIDENTIAL

PARCEL NUMBER: 26-2-1

OCCUPANCY GROUP:

LATITUDE (NAD 83):

CONSTRUCTION TYPE: II-B

POWER COMPANY: EVERSOURCE ENERGY

DIRECTIONS FROM GROTON - NEW LONDON AIRPORT:

TELEPHONE COMPANY: XFINITY

NO SCALE

PROJECT DIRECTORY

DISH Wireless L.L.C.

5701 SOUTH SANTA FE DRIVE

LITTLETON, CO 80120

TOWER OWNER: AMERICAN TOWER CORPORATION 10 PRESIDENTIAL WAY

WOBURN, MA 01801

(781) 926-4500

SITE DESIGNER: B+T GROUP

RF FNGINFFR:

DIRECTIONS

HEAD NORTH TOWARD STATE HWY 649, TAKE I-95 N AND CT-234 E/PEQUOT TRAIL TO MECHANIC ST IN

STONINGTON, TURN RIGHT ONTO STATE HWY 649/SOUTH RD, TURN RIGHT ONTO US-1 N/POQUONNOCK RD, TURN LEFT ONTO CT-117 N, TURN RIGHT TO MERGE WITH I-95 N TOWARD PROVIDENCE, TAKE EXIT 91 FOR CT-234 TOWARD STONINGTON, CONTINUE ONTO CT-234 E/PEQUOT TRAIL, SLIGHT LEFT ONTO W BROAD ST, FOLLOW MECHANIC ST TO PAWCATUCK AVE, TURN RIGHT ONTO MECHANIC ST, TURN RIGHT ONTO CLARK ST, CLARK ST TURNS LEFT AND BECOMES PAWCATUCK AVE, DESTINATION WILL BE ON THE RIGHT. ARRIVING AT BOBOS00021A.

VICINITY MAP

SITE LOCATION

1717 S. BOULDER AVE, SUITE 300 TULSA. OK 74119 (918) 587-4630

KENNETH BRADBURY II SITE ACQUISITION: (781) 926-4770

CONSTRUCTION MANAGER: JAVIER SOTO

JAVIER.SOTO@DISH.COM

ARVIN SEBASTIAN

ARVIN.SEBASTIAN@DISH.COM



5701 SOUTH SANTA FE DRIVE

LITTLETON, CO 80120

AMERICAN TOWERS

B+T GRP

1717 S. BOULDER SUITE 300 TULSA, OK 74119 PH: (918) 587-4630 www.btgrp.com

B&T ENGINEERING, INC. PEC.0001564 Expires 2/10/22

IT IS A VIOLATION OF LAW FOR ANY PERSON, UNLESS THEY ARE ACTING UNDER THE DIRECTIO OF A LICENSED PROFESSIONAL ENGINEER, TO ALTER THIS DOCUMENT.

ı	П	DRAWN BY:	CHECKED BY:	APPROVED B
ı	Ш	RY	YF	YF

RFDS REV #:

CONSTRUCTION DOCUMENTS

	;	SUBMITTALS
REV	DATE	DESCRIPTION
Α	8/2/21	ISSUED FOR REVIEW
0	10/15/21	ISSUED FOR CONSTRUCTION
	∧ 0°E E	DOLECT NUMBER

A&E PROJECT NUMBER

153552.001.01

BOBOSO0021A 166 PAWCATUCK AVE STONINGTON, CT 06378

> SHEET TITLE TITLE SHEET

SHEET NUMBER

T-1







WWW.CBYD.COM

GENERAL NOTES

11"x17" PLOT WILL BE HALF SCALE UNLESS OTHERWISE NOTED

PROCEEDING WITH THE WORK.

PROJECT SUMMARY

FIELD SURVEY DATE: 08/14/2018

SITE ADDRESS: 166 PAWCATUCK AVENUE, PAWCATUCK, CT 06379

PARCEL INFORMATION WNER: PATRICIA L. MAIN, SURVIVING SPOUSE OF WARREN D. MAIN, AS TO

FEE SIMPLE INTEREST; MUNICIPAL BAY, LLC, A DELAWARE LIMITED LIABILITY COMPANY, AS TO LEASEHOLD INTEREST

OWNER ADDRESS: 166 PAWCATUCK AVE, STONINGTON, CT 06379 APN: 26-2-1

TOTAL AREAS:

ATC FEE AREA: 0.04± ACRES OR 1,891± SQUARE FEET

RENT PARCEL: 5.02± ACRES JURISDICTION. ACCESS & UTILITY EASEMENT AREA: 24.330± SQ. FT. OR 0.56± ACRES

GEOGRAPHIC COORDINATES OF TOWER:

ATITUDE: 41°21'37.71° N LONGITUDE: 71°51'08.62° W HORIZONTAL DATUM: NAD83 GROUND ELEVATION: 54.5°

HIS IS TO CERTIFY THAT THE ABOVE INFORMATION IS PROVIDED TO

MERIDIAN AND COORDINATES REFER TO CONNECTICUT STATE PLANE, IAD 83. CONNECTICUT ZONE AND ARE BASED ON GPS OBSERVATIONS.

FLOODPLAIN:

PER THE FEMA FLOODPLAIN MAPS, THE SITE IS LOCATED IN AN AREA DESIGNATED AS ZONE X. OMMUNITY PANEL NO : 0

FFECTIVE DATE: AUGUST 5, 2013

BOUNDARY NOTE

IIS SURVEY IS THE RESULT OF AN ACTUAL FIELD SURVEY BASED UPON SUFFICIENT RESEARCH AND FIELD EVIDENCE TO VERIFY THE PARENT PARCEL OF THE SUBJECT PROPERTY, HOWEVER, THIS SURVEYOR HAS ELIED UPON THE DEEDS OF RECORD, AS PROVIDED. THIS SURVEYOR MAKES NO GUARANTEE, EITHER EXPRESSED OR IMPLIED AS TO THE QUALITY OF THE DEED REPORT AND REFERENCE DOCUMENTS PROVIDE AND THE DOCUMENTS PROVED AFFECTING THE LEASE AND IMMEDIATE AREA HAVE BEEN PLOTTED. THE BOUNDARY SHOWN HEREON IS PLOTTED ROM THE RECORD INFORMATION PROVIDED AND DOES NOT CONSTITUTE A BOUNDARY SURVEY OF THE PROPERTY.

ENCROACHMENT NOTE

AT THE TIME OF THE SURVEY. THERE WAS VISIBLE EVIDENCE OF AN

GRAVEL DRIVE 20'± OUTSIDE THE PROVIDED ACCESS EASEMENT, WHICH WOULD BE REMEDIED BY THE AS-SURVEYED LEGAL

ATC FEE AREA IS CONTAINED ENTIRELY ON THE PARENT PARCEL

SURVEYOR'S NOTES

- THERE IS ACCESS TO THE SUBJECT PROPERTY VIA PAWCATUCK, A PUBLIC RIGHT OF WAY
- THE LOCATIONS OF ALL UTILITIES SHOWN ON THE SURVEY ARE FROM VISIBLE SURFACE EVIDENCE ONLY.
- AT THE TIME OF THIS SURVEY THERE WAS NO OBSERVABLE SURFACE EVIDENCE OF EARTH MOVING WORK, BUILDING CONSTRUCTION OR BUILDING ADDITIONS WITHIN RECENT MONTHS.
- AT THE TIME OF THIS SURVEY, THERE WAS NO OBSERVABLE EVIDENCE OF THE SUBJECT PROPERTY BEING USED AS A SOLID WASTE DUMP. SUMP OR SANITARY LANDFILL.
 AT THE TIME OF THIS SURVEY, THERE WAS NO OBSERVABLE EVIDENCE
- OF ANY RECENT CHANGES IN STREET RIGHT-OF-WAY LINES EITHER COMPLETED OR PROPOSED, AND AVAILABLE FROM THE CONTROLLING
- AT THE TIME OF THIS SURVEY, THERE WAS NO OBSERVABLE EVIDENCE OF ANY RECENT STREET OR SIDEWALK CONSTRUCTION OR REPAIRS. ANGLES OR BEARINGS SHOWN HEREON ARE FORMATTED IN DEGREES
- HEREON ARE IN U.S. SURVEY FEET, UNLESS NOTED OTHERWISE UNDERGROUND IMPROVEMENTS IF ANY AND NOT VISIBLE AT THE TIME OF THE SURVEY, HAVE NOT BEEN LOCATED IN THE FIELD OR SHOWN
- WETLANDS, IF PRESENT, HAVE NOT BEEN LOCATED OR SHOWN HEREON.

MINUTES, AND SECONDS. DISTANCES OR ELEVATIONS SHOWN

- NOT ALL IMPROVEMENTS ON THE PARENT PARCEL BEING SURVEYED ARE SHOWN HEREON.
- A. DEED: BOOK 158, PAGE 365

ZONING INFORMATION

	ZONE: RR-80 (RURA)	L RESIDENTIAL)	
4	SETBACKS:	REQUIRED:	EXISTING:
	FRONT:	50"	>400'±
	SIDE:	50'	35±'
	REAR:	50'	15'±
	HEIGHT:	N/A	N/A
D	BULK:	N/A	N/A
	ALL SITE DESTRICT	TONE WERE ORTAINED ERON	THE LOCAL MUNICIPALITY

SURVE	Y LEGEND
	EXISTING PROPERTY EXISTING ADJ. PROPERTY EXISTING LEASE EXISTING CASEMENT EXISTING CONTOUR (MAJOR) EXISTING CONTOUR (MINOR) EXISTING TREELINE EXISTING CHANLINK FENCE
DE THE PERSON OF	EXISTING OVERHEAD WIRES EXISTING BUILDING
\$ \$00 b	EXISTING ROAD (STONE) EXISTING ROAD (PAVED) SURVEY IRON PIN FOUND SURVEY BENCHMARK EXISTING UTILITY POLE EXISTING GUY ANCHOR EXISTING BOLLARD
(1)	MORTGAGE REFERENCE #

NOTES CORRESPONDING TO ALTA COMMITMENT


THE ALTA COMMITMENT FORM ISSUED BY CATIC, WITH AN EFFECTIVE DATE OF AUGUST 3, 2018 CONTAINS THE FOLLOWING SURVEY RELATED ITEMS.


- ALL MATTERS CONTAINED ON THE PLAN SHOWING PROPERTY TO BE CONVEYED BY CHARLES A. MAIN SR. TO WARREN D. AND PATRICIA MAIN RECORDED AS MAP NUMBER 1048, PUBLIC RECORDS OF NEW LONDON COUNTY, CT. NO PLOTTABLE MATTERS ON PLAN.
- ALL MATTERS CONTAINED ON THE PLAT OF MAP SHOWING EASEMENT AREA TO BE GRANTED TO THE CONNECTICUT LIGHT AND POWER COMPANY RECORDED AS MAP NUMBER 4170, PUBLIC RECORDS OF NEW LONDON COUNTY, CT. EASEMENT FROM PLAT SHOWN HEREON. TERMS AND CONDITIONS OF UNRECORDED LEASE AS EVIDENCED BY MEMORANDUM OF LEASE BETWEEN WARREN D. MAIN AND PATRICIA L. MAIN, AND
- OMNIPOINT COMMUNICATIONS, INC., DATED JUNE 29, 2009 AND RECORDED AUGUST 18, 2009, IN BOOK 860 PAGE 22, IN NEW LONDON COUNTY, CONNECTICUT. NOT PLOTTABLE, NO METES AND BOUNDS FOR LEASE PROVIDED. TERMS AND CONDITIONS OF UNRECORDED LEASE AS EVIDENCED BY MEMORANDUM OF LEASE BETWEEN WARREN D. MAIN AND PATRICIA MAIN, AND T-MOBILE
- NORTHEAST LLC, A DELAWARE LIMITED LIABILITY COMPANY, SUCCESSOR-IN-INTEREST TO OMNIPOINT COMMUNICATIONS, INC., DATED MARCH 26, 2013 AND RECORDED APRIL 12, 2013, IN BOOK 714 PAGE 373, IN NEW LONDON COUNTY, CONNECTICUT. NOT PLOTTABLE, NO METES AND BOUNDS FOR LEASE PROVIDED. AFFECTED BY TERMS AND CONDITIONS OF UNRECORDED ASSIGNMENT AS EVIDENCED BY ASSIGNMENT AND ASSUMPTION OF SITE LEASE BETWEEN T-MOBILE AFFELIED BY LEMBS AND COMDITIONS OF OWNED AND SIGNAMENT AS EVIDENCED BY ASSIGNMENT AND ASSIGNMENT ASSIGNMENT AND ASSIGNMENT ASSIGNMENT ASSIGNMENT ASSIGNMENT AND ASSIGNMENT A


AFFECTED BY TERMS AND CONDITIONS OF UNRECORDED ASSIGNMENT AS EVIDENCED BY MEMORANDUM OF ASSIGNMENT OF LEASE BETWEEN BAY COMMUNICATIONS II, LLC, A DELAWARE LIMITED LIABILITY COMPANY, AND MUNICIPAL BAY, LLC, A DELAWARE LIMITED LIABILITY COMPANY, DATED FEBRUARY 5, 2018 AND RECORDED FEBRUARY 22, 2018, IN BOOK 773 PAGE 678, IN NEW LONDON COUNTY, CONNECTICUT. NOT PLOTTABLE, NO METES AND BOUNDS


- TERMS AND CONDITIONS OF UNRECORDED AGREEMENT AS EVIDENCED BY MEMORANDUM OF SITE LICENSE AGREEMENT BETWEEN BAY COMMUNICATIONS II, LLC, AND T-MOBILE NORTHEAST LLC, DATED JANJARY 7, 2014 AND RECORDED MARCH 14, 2014, IN BOOK 726 PAGE 385, IN NEW LONDON COUNTY, AND T-MOBILE NORTHEAST LLC, DATED JANJARY 7, 2014 AN NECTICUT. NOT PLOTTABLE. LEGAL DESCRIPTION ILLEGIBLE
- ELECTRIC DISTRIBUTION EASEMENT BETWEEN WARREN D. MAIN AND PATRICIA L. MAIN, BAY COMMUNICATIONS II, LLC, SUCCESSOR IN INTEREST TO T-MOBILE NORTHEAST LLC, AND THE CONNECTICUT LIGHT AND POWER COMPANY, A SPECIALLY CHARTERED CONNECTICUT CORPORATION, DATED JANUARY 30, 2014 AND RECORDED APRIL 2, 2014, IN BOOK 727 PAGE 52, IN NEW LONDON COUNTY, CONNECTICUT. SHOWN HEREON.


AFFECTED BY PARTIAL ASSIGNMENT OF EASEMENT RIGHTS BETWEEN THE CONNECTICUT LIGHT AND POWER COMPANY DBA EVERSOURCE ENERGY, A SPECIALLY CHARTERED CONNECTICUT CORPORATION, AND THE SOUTHERN NEW ENGLAND TELEPHONE COMPANY DBA FRONTIER COMMUNICATIONS, CONNECTICUT CORPORATION. NOT PLOTTABLE, NO METES AND BOUNDS PROVIDED.

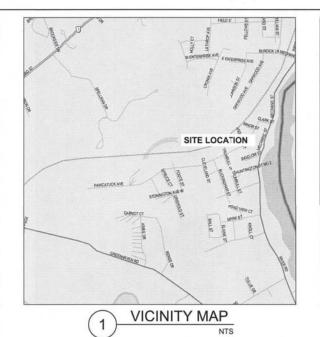


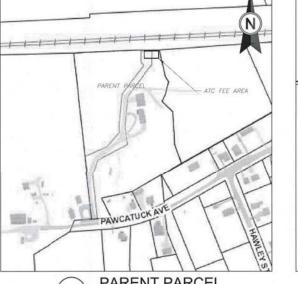

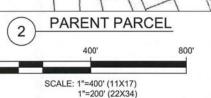

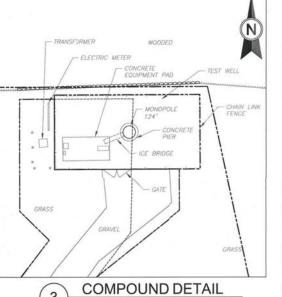

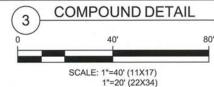

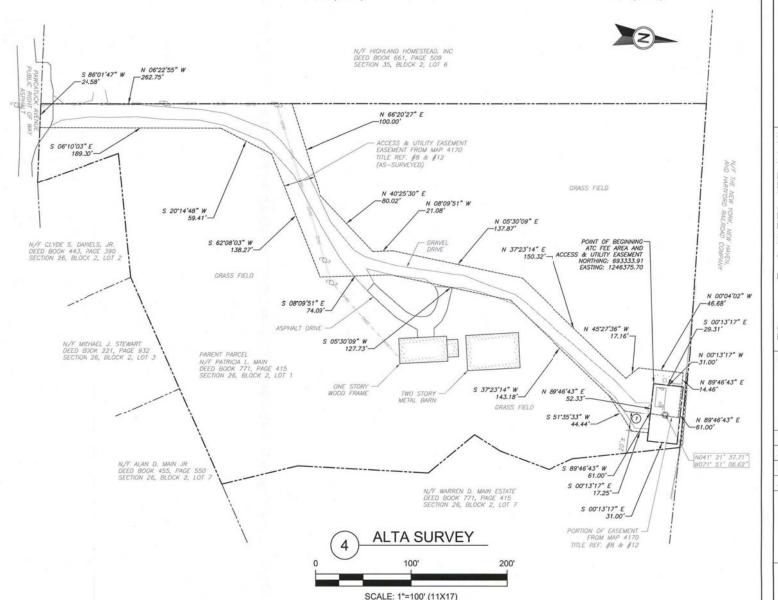

1"=50' (22X34)



AMERICAN TOWER® ATC TOWER SERVICES, INC

3533 REGENCY PARKWAY SUITE 133 **CARY, NC 27551** PHONE: (919) 468-0145 COA: D-0204

THESE DRAWINGS AND/OR THE ACCOMPANYING SPECIFICATION AS INSTRUMENTS OR SERVICE ARE THE EXCLUSIVE PROPERTY OF AMERICAN TOWER. THEIR USE AND CONTROL OF THE PROPERTY OF AMERICAN TO WERE THEIR USE AND CONTROL OF THE PROPERTY O PUBLICATION SHALL BE RESTRICTED TO THE ORIGINAL SITE FOR WHICH THEY ARE PREPARED. ANY USE OR DISCLOSURE OTHER THAN THAT WHICH RELATES TO AMERICAN TOWER OR THE SPECIFIED CARRIER IS STRICTLY PROHIBITED. TITLE TO THESE DOCUMENTS SHALL REMAIN THE PROPERTY OF AMERICAN TOWER WHETHER OR NOT THE PROJECT IS AMERICAN TOWER WHETHER OR NOT THE PROJECT IS EXECUTED. NEITHER THE ARCHITECT NOR THE ENGINEER WILL BE PROVIDING ON-SITE CONSTRUCTION REVIEW OF THIS PROJECT. CONTRACTOR(S) MUST VERIFY ALL DIMENSIONS AND ADVISE AMERICAN TOWER OF ANY DISCREPANCIES. ANY PRIOR ISSUANCE OF THIS DRAWING IS SUPFRESEDED BY THE LATEST VERSION ON FILE WITH AMERICAN TOWER.

REV.	DESCRIPTION	BY	DATE
<u></u>	ISSUED FOR COMMENT	DTS	08/23/18
1	ISSUED	SAA	11/20/18
1			

ATC SITE NUMBER:

284984

ATC SITE NAME:

PAWCATUCK

CT

SITE ADDRESS: 166 PAWCATUCK AVENUE PAWCATUCK, CT 06379

SURVEY CERTIFICATE: TO AMERICAN TOWER CORPORATION:

THIS IS TO CERTIFY THAT THIS MAP OR PLAT AND THE SURVEY ON WHICH IT IS BASED WERE MADE IN ACCORDANCE WITH 2016 MINIMUM STANDARD DETAIL REQUIREMENTS FOR ALTA/ACSM LAND TITLE SURVEYS, JOINTLY ESTABLISHED AND ADOPTED BY ALTA AND NSPS. AND INCLUDES ITEMS 2, 3, 4, 6(B) (TO THE EXTENT, GRAPHICALL) DEPICT ON SURVEY DRAWING THE ZONING SETBACK LINES), 7(A), 7(B)(1), 7(C), 8, 9, 11, AND 13 TABLE A THEREOF. THE FIELD WORK WAS COMPLETED ON 08/14/18.



SURVEY LOGO:

DRAWN BY: DTS APPROVED BY: TJH DATE DRAWN: 08/23/18 ATC JOB NO: 284984

ALTA/NSPS LAND TITLE SURVEY

SHEET NUMBER:

V-101

REVISION

LEGAL DESCRIPTION

PARENT PARCEL - AS PROVIDED: THE LAND REFERRED TO HEREIN BELOW IS SITUATED IN THE COUNTY OF NEW LONDON, CITY OF PAWCATUCK, STATE OF CONNECTICUT, AND IS

A LEASEHOLD INTEREST IN AND TO THE FOLLOWING DESCRIBED PROPERTY:

SEGINNING AT THE SOUTHEASTERLY CORNER OF THE PARCEL OF LAND HEREIN CONVEYED ON THE NORTHERLY LINE OF PAWCATUCK AVENUE. SAID BEGINNING AT THE SOUTHEASTERLY CORNER OF THE PARCEL OF LAND HEREIN CONVEYED ON THE NORTHERLY LINE OF PAWCATUCK AVENUE, SAID CORNER ALSO BEING THE SOUTHWESTERLY CORNER OF LAND OF LEE AND IRENE MORGAN. THENCE TURNING NORTHERLY, BOUNDED EASTERLY BY SAID MORGAN LAND 90.50 FEET TO AN IRON PIPE MARKING THE NORTHEASTERLY CORNER OF MORGAN LAND. THENCE TURNING AN INTERIOR ANGLE OF 181*-65*-30" AND CENTRO FEET TO A DRILL HOLE AT THE NORTHEASTERLY CORNER OS ADI MORGAN LAND. THENCE TURNING AN INTERIOR ANGLE OF 181*-65*-30" AND CONTINUING IN A GENERALLY EASTERLY DIRECTION BY AND ALONG A STONE WALL 235.63 FEET TO A DRILL HOLE MARKING A CORNER OF THE HEREIN CONVEYEDED PARCEL OF LAND, WITH SAID LAST COURSE BEINE GOIDE SOUTHERLY IN PART BY LAND OF JOSEPH AND IRENE ORLANDO AND PARTLY BY LAND OF MICHAEL AND BARBARA LYNCH. THENCE TURNING AN INTERIOR ANGLE OF 100*-27*-00" AND CONTINUING IN STONE WALL 136.25 FEET TO A DRILL HOLE MARKING AN ANGLE POINT, THENCE TURNING AN INTERIOR ANGLE OF 198*-27*-00" AND CONTINUING ALONG SAID WALL 136.25 FEET TO A DRILL HOLE AT AN ANGLE POINT, THENCE TURNING AN INTERIOR ANGLE OF 198*-27*-00" AND CONTINUING ALONG SAID WALL 136.25 FEET TO A DRILL HOLE AT AN ANGLE POINT, THENCE TURNING AN INTERIOR ANGLE OF 198*-27*-00" AND CONTINUING ALONG SAID WALL 136.26 FEET TO A DRILL HOLE AT AN ANGLE POINT, THENCE TURNING AN INTERIOR ANGLE OF 198*-45*-00" AND CONTINUING ALONG SAID WALL 16.25 FEET TO A DRILL HOLE AT AN ANGLE POINT, THENCE TURNING AN INTERIOR ANGLE OF 188*-41*-30" AND CONTINUING ALONG SAID WALL 17.55 FEET TO A DRILL HOLE OF THE NEED TURNING AN INTERIOR ANGLE OF 188*-41*-30" AND CONTINUING ALONG SAID WALL 112.35 WALL 27.55 FEET TO A DRILL HOLE AT AN ANGLE POINT: THENCE TURNING AN INTERIOR ANGLE OF 197"-42-07" AND CONTINUING ALONG SAID WALL 112.35
FEET TO A DRILL HOLE AT THE NORTHEASTERLY CORNER OF THE PARCEL OF LAND HERRIN CONVEYENT HAS DIL AST MENTIONED SEVEN COURSES ALL
BEING BOUNDED EASTERLY BY LAND NOW OR FORMERLY OF SAMUEL LARKIN; THENCE TURNING AN INTERIOR ANGLE OF 102"-02"-00" AND RUNNING
WESTERLY A LONG A STONE WALL 99 76 FEET TO A DRILL HOLE; THENCE RUNNING NO KITHERLY 18 FEINT OR FOR CHEST OF PROPERTY OF THE NEW YORK
NEW HAVEN AND HARTFORD PAUROAD; THENCE TURNING AND RUNNING WESTERLY, BOUNDED NORTHERLY BY SAID RAUROAD PROPERTY 266 FEET
MORE OR LESS TO THE NORTHWESTERLY CORNER OF THE PARCEL OF LAND HERRIN CONVEYED; THEN CURNING MOUNNING SOUTHERLY BY SELD THE NORTHWESTERLY SOON AND RUNNING SOUTHERLY 212.00 FEET TO A CORNER; THENCE
TURNING AN INTERIOR ANGLE OF 90"-00" O'AND RUNNING SOUTHERLY 212.00 FEET TO A CORNER TURNING AND INTERIOR ANGLE OF 90"-00" O'AND RUNNING SOUTHERLY 212.00 FEET TO A CORNER TURNING AND INTERIOR ANGLE OF 90"-00" O'O" AND RUNNING SOUTHERLY 212.00 FEET TO A CORNER TURNING AND INTERIOR ANGLE OF 90"-00" O'O" AND RUNNING SOUTHERLY 212.00 FEET TO A CORNER TURNING AND AN INTERIOR ANGLE OF 90"-00" O'O" AND RUNNING SOUTHERLY 212.00 FEET TO A CORNER TURNING AND AN INTERIOR ANGLE OF 90"-00" O'O" AND RUNNING SASTERLY 25.00 FEET TO A CORNER, THENCE TURNING AN INTERIOR ANGLE OF 90"-00" O'O" AND RUNNING SASTERLY 24.00 FEET TO A CORNER THENCE TURNING AN INTERIOR ANGLE OF 90"-00" O'O" AND RUNNING SASTERLY 24.00 FEET TO A CURVE HAVING A
RADIUS OF 30.00 FEET AND A CENTRAL ANGLE OF 91"-32"-25" AND CONTINUING ALONG THE ARC OF SAID CURVE 24.07 BOTH POINT OF TANGENCY OF SAID
CURVE: THENCE CONTINUING SOUTHERLY 54.91 FEET TO THE POINT OF CURVATURE OF A CURVE HAVING A RADIUS OF 30.00 FEET AND A CENTRAL ANGLE OF 81"-32"-25" AND CONTINUING BASTERLY 110 OF PAWCATUCK AVENUE, WITH SAID ALST NINE
COURSES BEIGN BOUNDED BY OTHER LAND OF SAID CURVE 46.76 FEET TO THE RORTHERLY LINE OF PAWCATUCK AVENUE, WITH SAID ALST NINE

ESS AND EXCEPT ALL THAT PROPERTY CONVEYED BY QUIT CLAIM DEED RECORDED JANUARY 24, 1997, IN BOOK 399 PAGE 684, AND QUIT CLAIM DEED RECORDED JANUARY 24, 1997, IN BOOK 399 PAGE 686, AND BEING MORE PARTICULARLY DESCRIBED AS FOLLOWS:

HAT CERTAIN TRACT OR PARCEL OF LAND LOCATED ON THE NORTHERLY SIDE OF PAWCATUCK AVENUE. IN THE TOWN OF STONINGTON COUNTY OF NEW ONDON AND STATE OF CONNECTICUT AND WHICH IS SHOWN AND DELINEATED ON A PLAN TITLED: "MONUMENTED PERIMETER SURVEY PREPARED FOR CHARLES MAIN HIGHLAND HOMESTEAD, PAWCATUCK AVENUE, MAP 26, BLOCK 2, LOT 1, STONINGTON, CONNECTICUT, SCALE 1" = 20', AUGUST 20, 1996, BY HERENZIA & ASSOCIATES, LTD., WESTERLY, RHODE ISLAND, SAID PARCEL IS MORE PARTICULARLY BOUNDED AND DESCRIBED AS FOLLOW:

BEGINNING AT A RAILROAD SPIKE SET IN THE NORTHERLY LINE OF PAWCATUCK AVENUE MARKING THE SOUTHEASTERLY CORNER OF THE PARCEL OF AND HEREIN DESCRIBED AND THE SOUTHWESTERLY CORNER OF THE REMAINING LAND OF WARREN D. AND PATRICIA MAIN

THENCE NORTH 19° 45° 18° EAST, BOUNDED EASTERLY BY SAID REMANING LAND OF MAIN, A DISTANCE OF 703,00 FEET MORE OR LESS TO THE SOUTHERLY INE OF LAND NOW OR FORMERLY OF THE NATIONAL RAILROAD PASSENGER CORPORATION AND THE NORTHEASTERLY CORNER OF THE PARCEL OF LAND HENCE WESTERLY, ALONG THE SOUTHERLY LINE OF SAID RAILROAD, A DISTANCE OF 20:00 FEET, MORE OR LESS, TO THE NORTHEASTERLY CORNER OF

AND NOW OR FORMERLY OF CHARLES N. MAIN. SR. AND THE NORTH/WESTERLY CORNER OF THE PARCEL OF LAND HEREIN DESCRIBED

HENCE SOUTHERLY, BOUNDED WESTERLY BY SAID CHARLES N. MAIN, SR., LAND, A DISTANCE OF 160,00 FEET, MORE OR LESS, TO AN ANGLE POINT: HENCE NORTH 68* 40' 30" WEST, BOUNDED NORTHERLY BY SAID CHARLES N. MAIN, SR., LAND, A DISTANCE OF 165.00 FEET TO AN ANGLE POINT;

ENCE SOUTH 21" 19' 30" WEST, BOUNDED NORTHERLY BY SAID CHARLES N. MAIN, SR., LAND, A DISTANCE OF 212.00 FEET TO AN ANGLE POINT.

IENCE SOUTH 62" 40" 30" EAST, BOUNDED SOUTHERLY BY SAID CHARLES N. MAIN, SR., LAND, A DISTANCE OF 25:00 FEET TO AN ANGLE POINT;

FINCE SOUTH 21" 19' 30" WEST, BOUNDED WESTERLY BY SAID CHARLES N. MAIN, SR., LAND, A DISTANCE OF 210,00 FEET TO AN ANGLE POINT:

HENCE SOUTH 68" 40" 30" EAST, BOUNDED SOUTHERLY BY SAID CHARLES N. MAIN, SR., LAND, A DISTANCE OF 109,28 FEET TO THE BEGINNING OF A IRCULAR CURVE HAVING A RADIUS OF 30.00 FEET AND A CENTRAL ANGLE OF 91° 32' 55"

THENCE EASTERLY, SOUTHEASTERLY AND SOUTHERLY, BOUNDED SOUTHERLY, SOUTHWESTERLY AND WESTERLY BY SAID CHARLES N. MAIN, SR., LAND, ALONG THE ARC OF SAID CURVE, A DISTANCE OF 47.93 FEET;

THENCE SOUTH 22" 51" 55" WEST, BOUNDED NORTHWESTERLY BY SAD CHARLES N. MAIN, SR., LAND, A DISTANCE OF 54.91 FEET TO THE BEGINNING OF A CIRCULAR CURVE HAVING A RADIUS OF 30.00 FEET AND A CENTRAL ANGLE OF 89" 19" 05";

HENCE SOUTHWESTERLY AND WESTERLY, BOUNDED NORTHWESTERLY AND NORTHERLY BY SAID CHARLES N. MAIN, SR., LAND, ALONG THE ARC OF SAID CURVE, A DISTANCE OF 46.76 FEET TO A POINT IN THE NORTHERLY LINE OF SAID PAWCATUCK AVENUE AT THE SOUTHEASTERLY CORNER OF SAID CHARLES N. MAIN, SR., LAND AND THE SOUTHWESTERLY CORNER OF THE PARCEL OF LAND HEREIN DESCRIBED;

HENCE SOUTH 67° 50' 00° EAST, ALONG THE NORTHERLY LINE OF PAWCATUCK AVENUE, A DISTANCE OF 72.71 FEET TO THE POINT AND PLACE OF

THIS BEING THE SAME PROPERTY CONVEYED TO WARREN D. MAIN AND PATRICIA L. MAIN, HUSBAND AND WIFE, AND UNTO THE SURVIVOR OF THEM, FROM CHARLES N. MAIN, SR., IN WARRANTY DEED DATED AUGUST 31, 1966 IND BOOK 158 PAGE 365.

ARREN D. MAIN HAVING PASSED AWAY ON DECEMBER 2, 2016, AS EVIDENCED BY CERTIFICATE RELEASING LIENS DATED DECEMBER 7, 2017 AND RECORDED DECEMBER 7, 2017, IN BOOK 771 PAGE 415.

THIS BEING THE SAME PROPERTY ASSIGNED TO MUNICIPAL BAY, LLC, A DELAWARE LIMITED LIABILITY COMPANY, AS TO A LEASEHOLD INTEREST, FROM BAY COMMUNICATIONS II, LLC, A DELAWARE LIMITED LIABILITY COMPANY, BY TERMS AND CONDITIONS OF UNRECORDED ASSIGNMENT AS EVIDENCED BY MEMORANDUM OF ASSIGNMENT OF LEASE DATED FEBRUARY 5, 2018 AND RECORDED FEBRUARY 22, 2018, IN BOOK 773 PAGE 678.

ATC FEE AREA - AS SURVEYED: (NONE PROVIDED)
ALL THAT CERTAIN PLOT, PIECE OR PARCEL OF LAND SITUATE, LYING AND BEING IN THE CITY OF PAWCATUCK, COUNTY OF NEW LONDON, STATE OF CONNECTION; BEING MORE PARTICULARLY BOUNDED AND DESCRIBED AS FOLLOWS:

BEGINNING AT SOUTHWESTERLY CORNER OF THE HEREIN DESCRIBED ATC FEE AREA WHOSE STATE PLANE COORDINATE IS 693333.91 NORTH AND 246375.70 EAST; RUNNING THENCE

NORTH 00°13'17" WEST FOR A DISTANCE OF 31.00 FEET TO A POINT; THENCE

NORTH 88°46'43" EAST FOR A DISTANCE OF 81.00 FEET TO A POINT; THENCE SOUTH 00"1317" EAST FOR A DISTANCE OF 31.00 FEET TO A POINT; THENCE SOUTH 89°46'43" WEST FOR A DISTANCE OF 61.00 FEET TO THE POINT OF BEGINNING

NTAINING 0.04± ACRES OR 1,891± SQUARE FEET. ATC RETAINS RIGHTS TO 2,100 SQUARE FEET PER THE SITE LEASE WITH OPTION, DATED JUNE 29, 2009.

ACCESS & UTILITY EASEMENT - AS SURVEYED; (NONE PROVIDED)
THIS BEING THE SAME PROPERTY ASSIGNED TO MUNICIPAL BAY, LLC, A DELAWARE LIMITED LIABILITY COMPANY, AS TO A LEASEHOLD INTEREST, FROM BAY COMMUNICATIONS II, LLC, A DELAWARE LIMITED LIABILITY COMPANY, BY TERMS AND CONDITIONS OF UNRECORDED ASSIGNMENT AS EVIDENCED BY MEMORANDUM OF ASSIGNMENT OF LEASE DATED FEBRUARY 5, 2018 AND RECORDED FEBRUARY 22, 2018, IN BOOK 773 PAGE 678.

ALL THAT CERTAIN PLOT, PIECE OR PARCEL OF LAND SITUATE, LYING AND BEING IN THE CITY OF PAWCATUCK, COUNTY OF NEW LONDON, STATE OF

CONNECTICUT, BEING MORE PARTICULARLY BOUNDED AND DESCRIBED AS FOLLOWS:
BEGINNING AT A NORTHEASTERLY CORNER OF THE HEREIN DESCRIBED ACCESS AND UTILITY EASEMENT WHOSE STATE PLANE COORDINATE IS 693333.91
NORTH AND 1246375.70 EAST: RUNNING THENCE

NORTH 89'46'45" EAST FOR A DISTANCE OF 52.33 FEET TO A POINT; THENCE SOUTH 60'13'17" EAST FOR A DISTANCE OF 17.25 FEET TO A POINT; THENCE SOUTH 51'35'33" WEST FOR A DISTANCE OF 44.44 FEET TO A POINT; THENCE SOUTH 57'23'14" WEST FOR A DISTANCE OF 44.44 FEET TO A POINT; THENCE SOUTH 60'30'09" WEST FOR A DISTANCE OF 127.73 FEET TO A POINT; THENCE SOUTH 60'09'51" EAST FOR A DISTANCE OF 128.27 FEET TO A POINT; THENCE SOUTH 60'09'51" EAST FOR A DISTANCE OF 138.27 FEET TO A POINT; THENCE SOUTH 60'10'32" EAST FOR A DISTANCE OF 59.41 FEET TO A POINT; THENCE SOUTH 60'10'37" EAST FOR A DISTANCE OF 189.30 FEET TO A POINT; THENCE SOUTH 60'10'37" EAST FOR A DISTANCE OF 28.27 FEET TO A POINT; THENCE NORTH 60'22'57" WEST FOR A DISTANCE OF 100.00 FEET TO A POINT; THENCE NORTH 66'20'37" EAST FOR A DISTANCE OF 100.00 FEET TO A POINT; THENCE NORTH 60'20'37" EAST FOR A DISTANCE OF 130.27 FEET TO A POINT; THENCE NORTH 60'30'30" EAST FOR A DISTANCE OF 130.27 FEET TO A POINT; THENCE NORTH 60'30'30" EAST FOR A DISTANCE OF 13.78 FEET TO A POINT; THENCE NORTH 60'30'07" EAST FOR A DISTANCE OF 13.78 FEET TO A POINT; THENCE NORTH 57'23'14" EAST FOR A DISTANCE OF 150.32 FEET TO A POINT; THENCE NORTH 57'23'14" EAST FOR A DISTANCE OF 150.32 FEET TO A POINT; THENCE NORTH 57'23'14" EAST FOR A DISTANCE OF 150.32 FEET TO A POINT; THENCE NORTH 57'23'14" EAST FOR A DISTANCE OF 150.32 FEET TO A POINT; THENCE NORTH 57'23'14" EAST FOR A DISTANCE OF 150.32 FEET TO A POINT; THENCE NORTH 57'23'14" EAST FOR A DISTANCE OF 17.10 FEET TO A POINT; THENCE NORTH 89'46'43" EAST FOR A DISTANCE OF 52:33 FEET TO A POINT: THENCE NORTH 45°27'36" WEST FOR A DISTANCE OF 17.16 FEET TO A POINT; THENCE NORTH 00"04'02" WEST FOR A DISTANCE OF 46.68 FEET TO A POINT; THENCE NORTH 89"46"43" EAST FOR A DISTANCE OF 14.46 FEET TO A POINT; THENCH SOUTH 00"13"17" EAST FOR A DISTANCE OF 29.31 FEET TO A POINT; THENCE TO THE POINT OF BEGINNING

SURVEY LEGEND

--- EXISTING CHAINLINK TENCE EXISTING OVERHEAD WIRES EXISTING BUILDING EXISTING BIOLUNG

EXISTING ROAD (STOILE)

EXISTING ROAD (PAVED)


SURVEY IRON PIN FOUND

SURVEY BENCHMARK


EXISTING UTILITY POLE

EXISTING GUY ANCHOR


EXISTING BOLLARD 1 MORTGAGE REFERENCE # ENCROACHMENT REFERENCE #

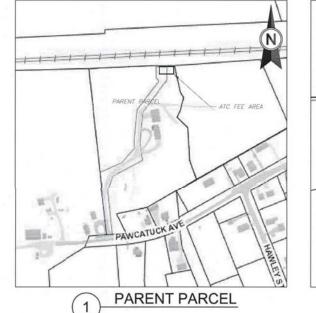


8001

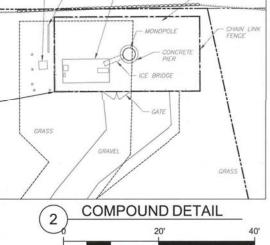

CONCRETE EQUIPMENT PAD

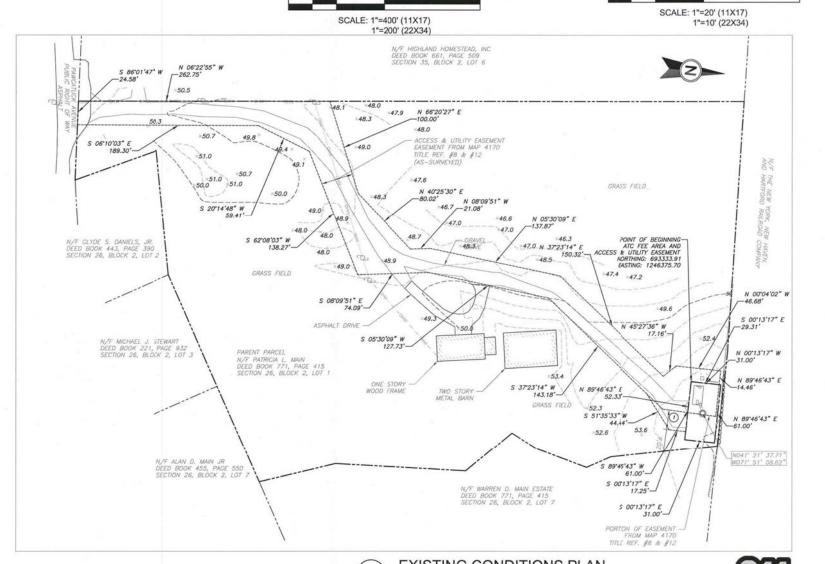

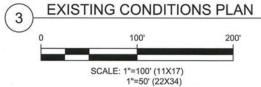





(N)

AMERICAN TOWER® ATC TOWER SERVICES, INC

3533 REGENCY PARKWAY SUITE 133 **CARY, NC 27551** PHONE: (919) 468-0145 COA: D-0204

THESE DRAWINGS AND/OR THE ACCOMPANYING SPECIFICATION AS INSTRUMENTS OR SERVICE ARE THE EXCLUSIVE PROPERTY OF AMERICAN TOWER. THEIR USE AND PUBLICATION SHALL BE RESTRICTED TO THE ORIGINAL SITE FOR WHICH THEY ARE PREPARED. ANY USE OR DISCLOSURE OTHER THAN THAT WHICH RELATES TO AMERICAN TOWER OR THE SPECIFIED CARRIER IS STRICTLY PROHIBITED. TITLE TO THESE DOCUMENTS SHALL REMAIN THE PROPERTY OF THESE DOCUMENTS SHALL REMAIN THE PROPERTY OF AMERICAN TOWER WHETHER OR NOT THE PROJECT IS EXECUTED. NEITHER THE ARCHITECT NOR THE ENGINEER WILL BE PROVIDING ON-SITE CONSTRUCTION REVIEW OF THIS PROJECT. CONTRACTOR(S) MUST VERIFY ALL DIMENSIONS AND ADVISE AMERICAN TOWER OF ANY DISCREPANCIES. ANY PRIOR ISSUANCE OF THIS DRAWING IS SUPPRESIDED BY THE LATEST VERSION ON FILE WITH AMERICAN TOWER.

	REV.	DESCRIPTION	BY	DATE
	<u> </u>	ISSUED FOR COMMENT	DTS	08/23/18
- 1	1	ISSUED	SAA	11/20/18
	A			

ATC SITE NUMBER:

284984

ATC SITE NAME:

PAWCATUCK

CT

SITE ADDRESS: 166 PAWCATUCK AVENUE PAWCATUCK, CT 06379

SURVEY CERTIFICATE:

TO AMERICAN TOWER CORPORATION: THIS IS TO CERTIFY THAT THIS MAP OR PLAT AND THE SURVEY ON WHICH IT IS BASED WERE MADE IN ACCORDANCE WITH 2016 MINIMUM STANDARD DETAIL REQUIREMENTS FOR ALTA/ACSM LAND TITLE SURVEYS, JOINTLY ESTABLISHED AND ADOPTED BY ALTA AND NSPS. AND INCLUDES ITEMS 2, 3, 4, 6(B) (TO THE EXTENT, GRAPHICALL) DEPICT ON SURVEY DRAWING THE ZONING SETBACK LINES), 7(A), 7(B)(1), 7(C), 8, 9, 11, AND 13 TABLE A THEREOF. THE FIELD WORK WAS COMPLETED ON 08/14/18.




DRAWN BY: DTS APPROVED BY: TJH DATE DRAWN: 08/23/18 ATC JOB NO: 284984

EXISTING CONDITIONS PLAN

SHEET NUMBER:

V-102

REVISION

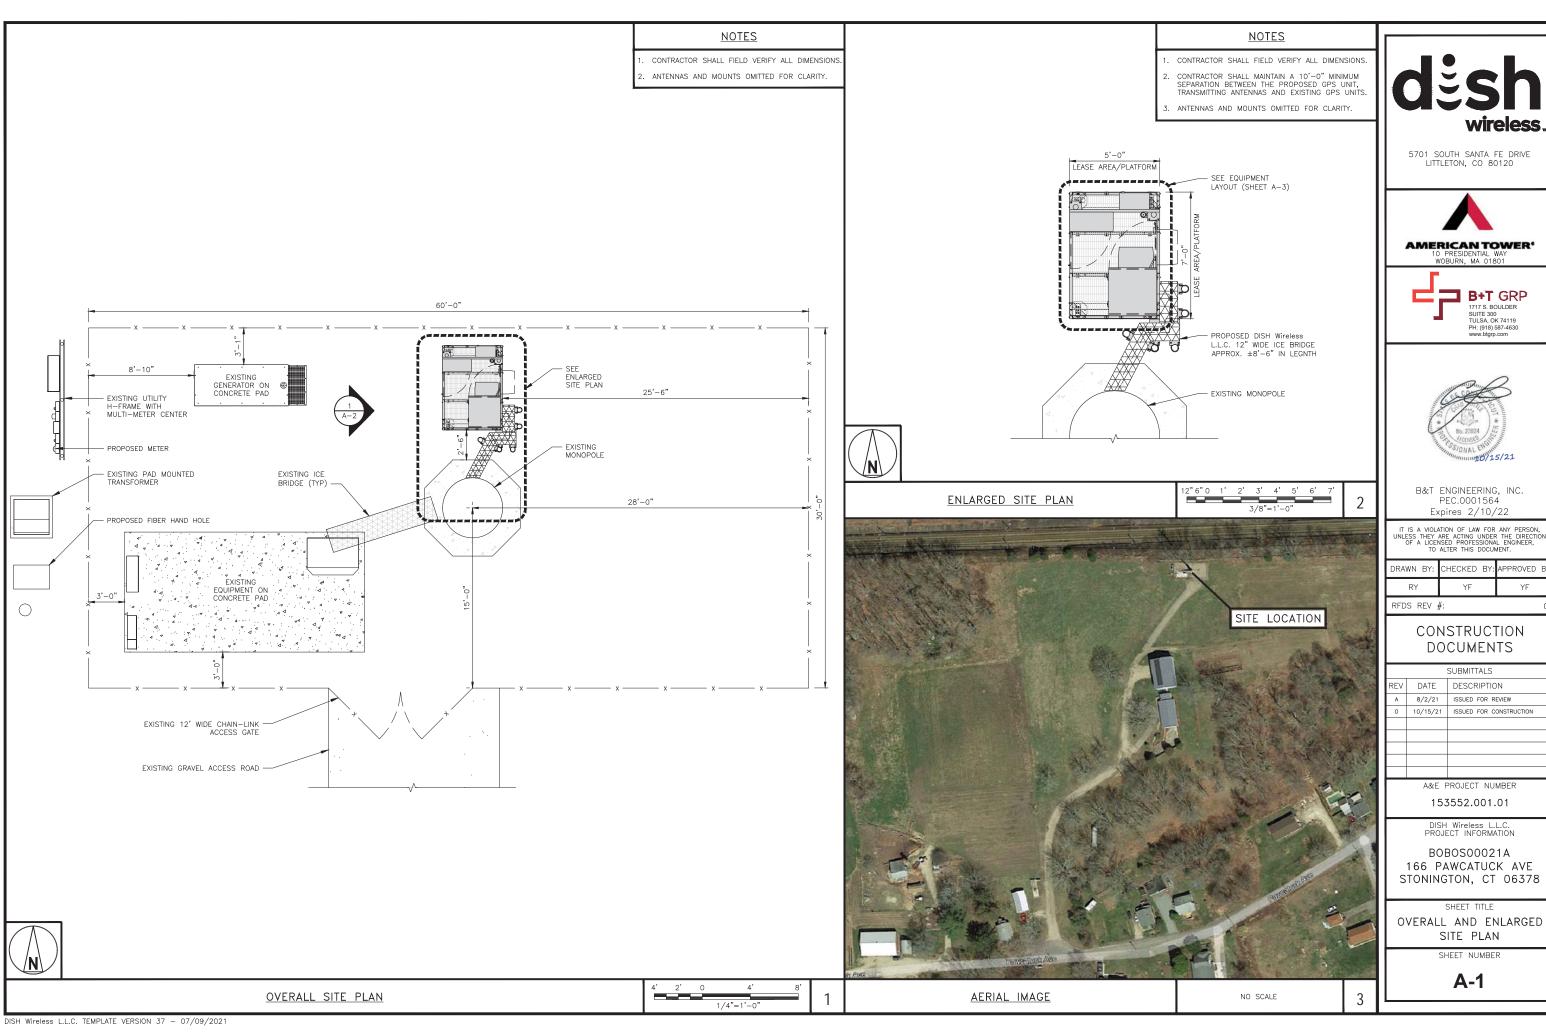





DRAWN	BY:	CHECKED	BY:	APPROVED	BY:
RY		YF		YF	

CONSTRUCTION

	SUBMITTALS						
	REV	DATE	DESCRIPTION				
	Α	8/2/21	ISSUED FOR REVIEW				
	0	10/15/21	ISSUED FOR CONSTRUCTION				
- 1							

166 PAWCATUCK AVE STONINGTON, CT 06378

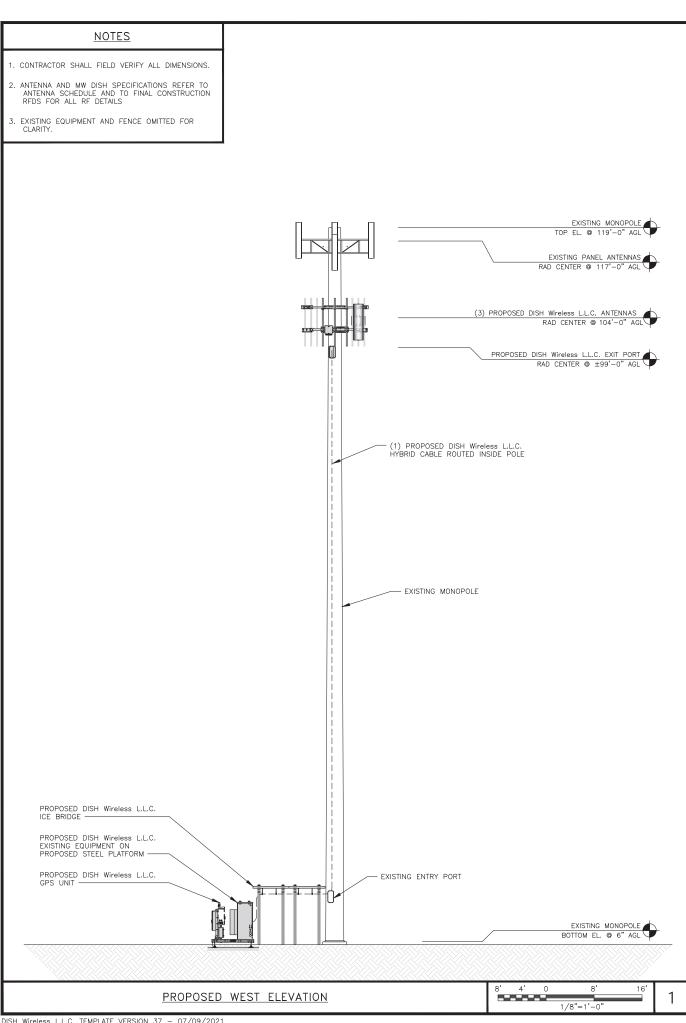

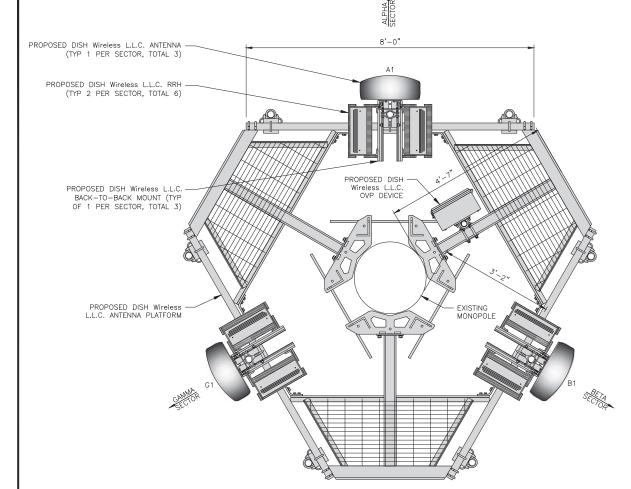

ANTENNA LAYOUT

			AA	ITENNA				TRANSMISSION CABLE
SECTOR	POSITION	EXISTING OR PROPOSED	MANUFACTURER — MODEL NUMBER	TECHNOLOGY	SIZE (HxW)	AZIMUTH	RAD CENTER	FEED LINE TYPE AND LENGTH
ALPHA	A1	PROPOSED	JMA - MX08FR0665-21	5G	72.0" x 20.0"	0,	104'-0"	(1) HIGH-CAPACITY
BETA	B1	PROPOSED	JMA - MX08FR0665-21	5G	72.0" × 20.0"	120°	104'-0"	(1) HIGH-CAPACITY HYBRID CABLE (135' LONG)
GAMMA	C1	PROPOSED	JMA - MX08FR0665-21	5G	72.0" x 20.0"	240*	104'-0"	(133 20119)

		RRH		NOTES
SECTOR	POSITION	MANUFACTURER — MODEL NUMBER	TECHNOLOGY	1. CON
ALPHA	A1	FUJITSU - TA08025-B605	5G	DET.
ALFHA	A1	FUJITSU - TA08025-B605	5G	AVAI REM
BETA	B1	FUJITSU - TA08025-B605	5G	STR
DETA	B1	FUJITSU - TA08025-B605	5G	
GAMMA	C1	FUJITSU - TA08025-B605	5G	
GAMMA	C1	FUJITSU - TA08025-B605	5G	

CONTRACTOR TO REFER TO FINAL CONSTRUCTION RFDS FOR ALL RF DETAILS.

ANTENNA AND RRH MODELS MAY CHANGE DUE TO EQUIPMENT AVAILABILITY. ALL EQUIPMENT CHANGES MUST BE APPROVED AND REMAIN IN COMPLIANCE WITH THE PROPOSED DESIGN AND STRUCTURAL ANALYSES.

	OVP	
EXISTING OR PROPOSED	MANUFACTURER — MODEL NUMBER	SIZE (HxWxD)
PROPOSED	RAYCAP-RDIDC-9181-PF-48	16"x14"x8"

5701 SOUTH SANTA FE DRIVE LITTLETON, CO 80120



AMERICAN TOWER'



B+T GRP
1717 S. BOULDER
SUITE 300
TULSA, OK 74119
PH: (918) 587-4630
www.btgrp.com



B&T ENGINEERING, INC. PEC.0001564 Expires 2/10/22

IT IS A VIOLATION OF LAW FOR ANY PERSON, UNLESS THEY ARE ACTING UNDER THE DIRECTION OF A LICENSED PROFESSIONAL ENGINEER, TO ALTER THIS DOCUMENT.

DRAWN	BY:	CHECKED	BY:	APPROVED	BY:
RY		YF		YF	

RFDS REV #:

CONSTRUCTION DOCUMENTS

П	SUBMITTALS					
П	REV	DATE	DESCRIPTION			
П	Α	8/2/21	ISSUED FOR REVIEW			
П	0	10/15/21	ISSUED FOR CONSTRUCTION			
П						
П						
П						
П						
L						

A&E PROJECT NUMBER

153552.001.01

DISH Wireless L.L.C. PROJECT INFORMATION

BOBOSO0021A 166 PAWCATUCK AVE STONINGTON, CT 06378

SHEET TITLE


ELEVATION, ANTENNA LAYOUT AND SCHEDULE


SHEET NUMBER


A-2


ANTENNA SCHEDULE

NO SCALE

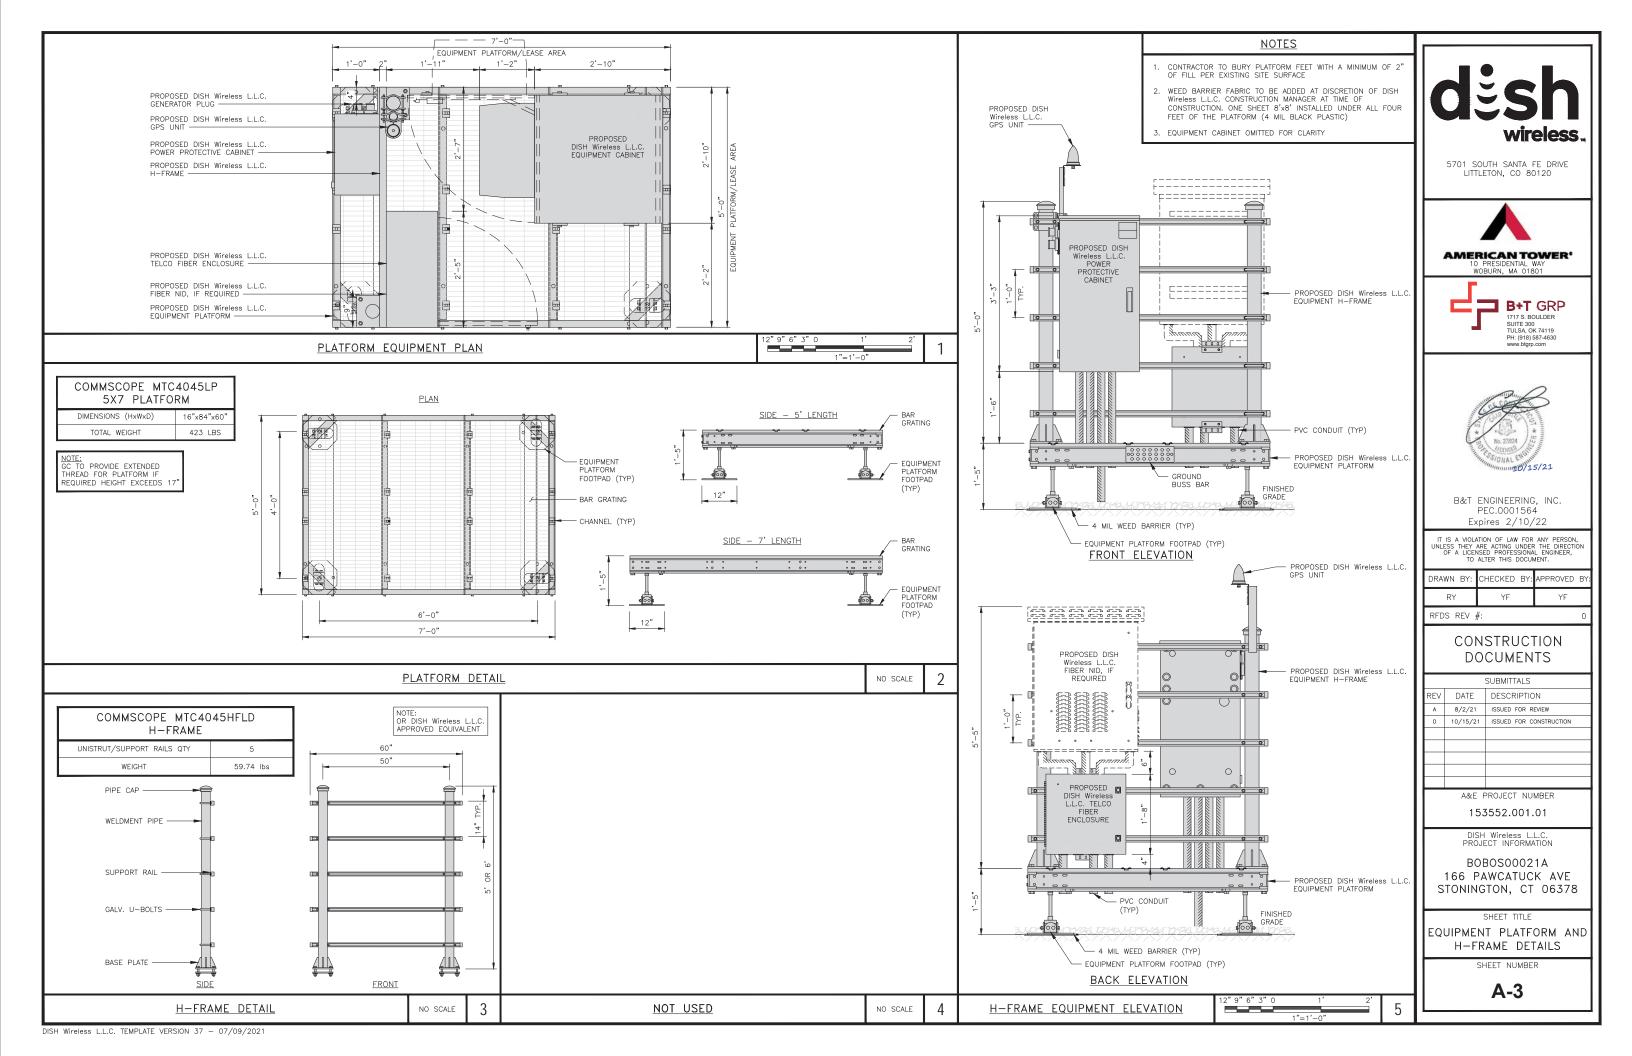

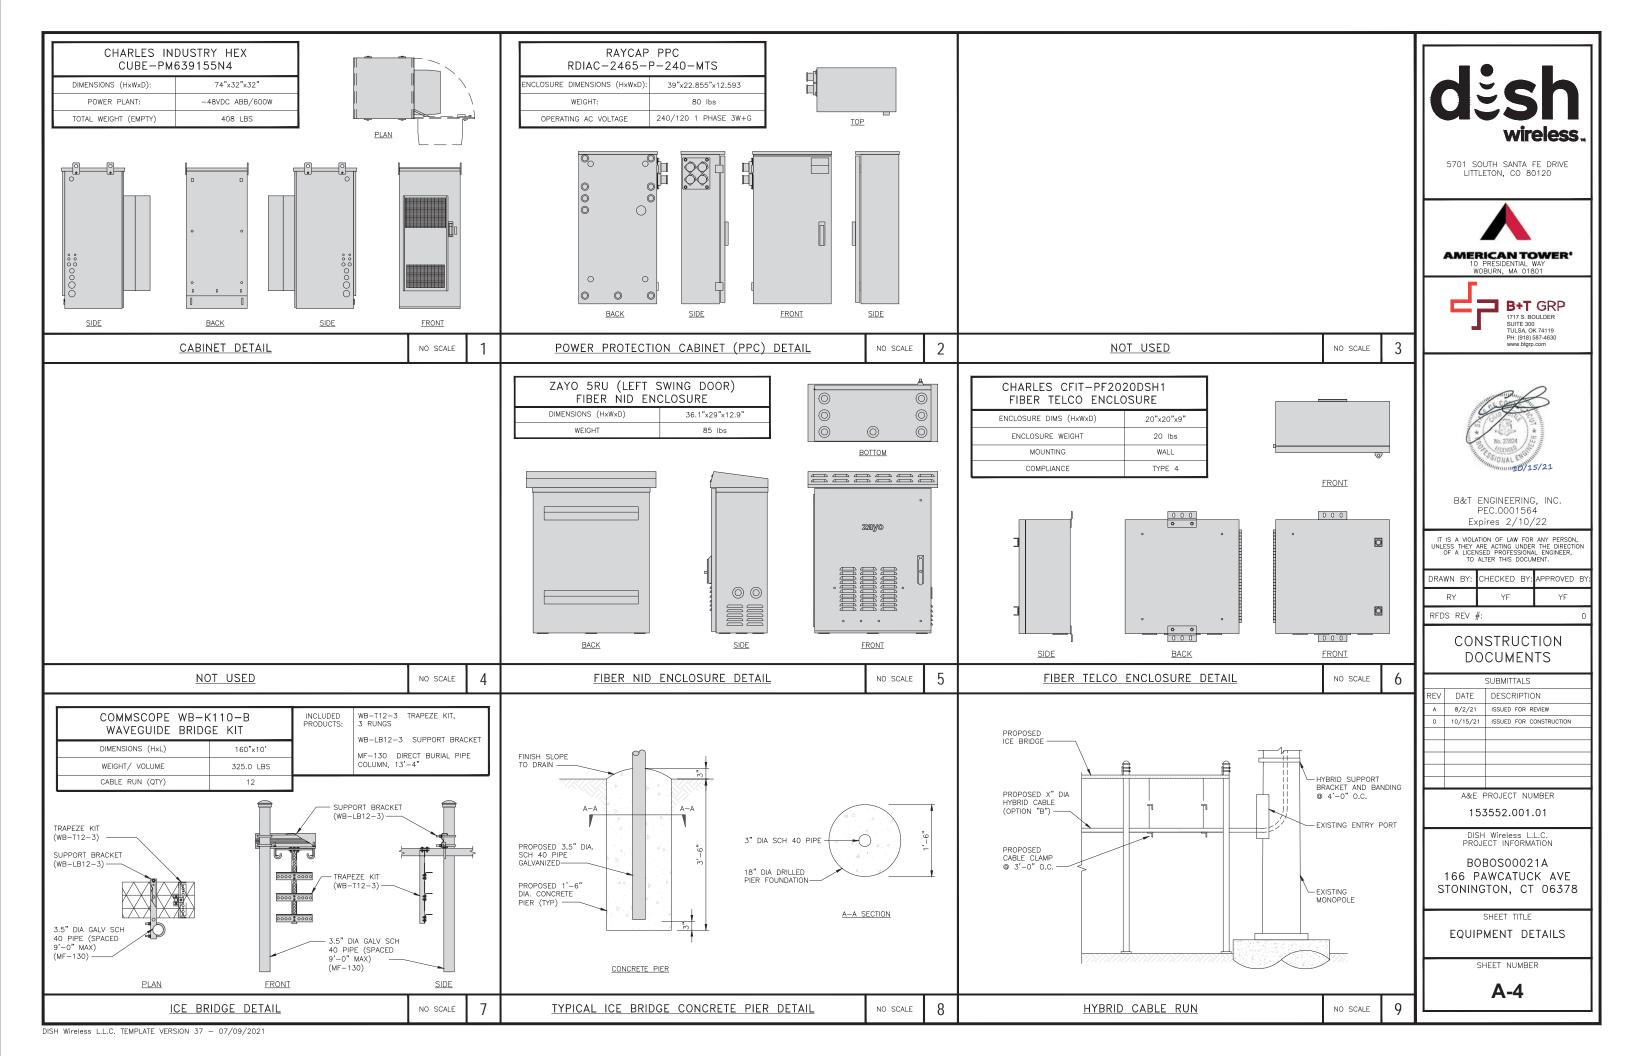

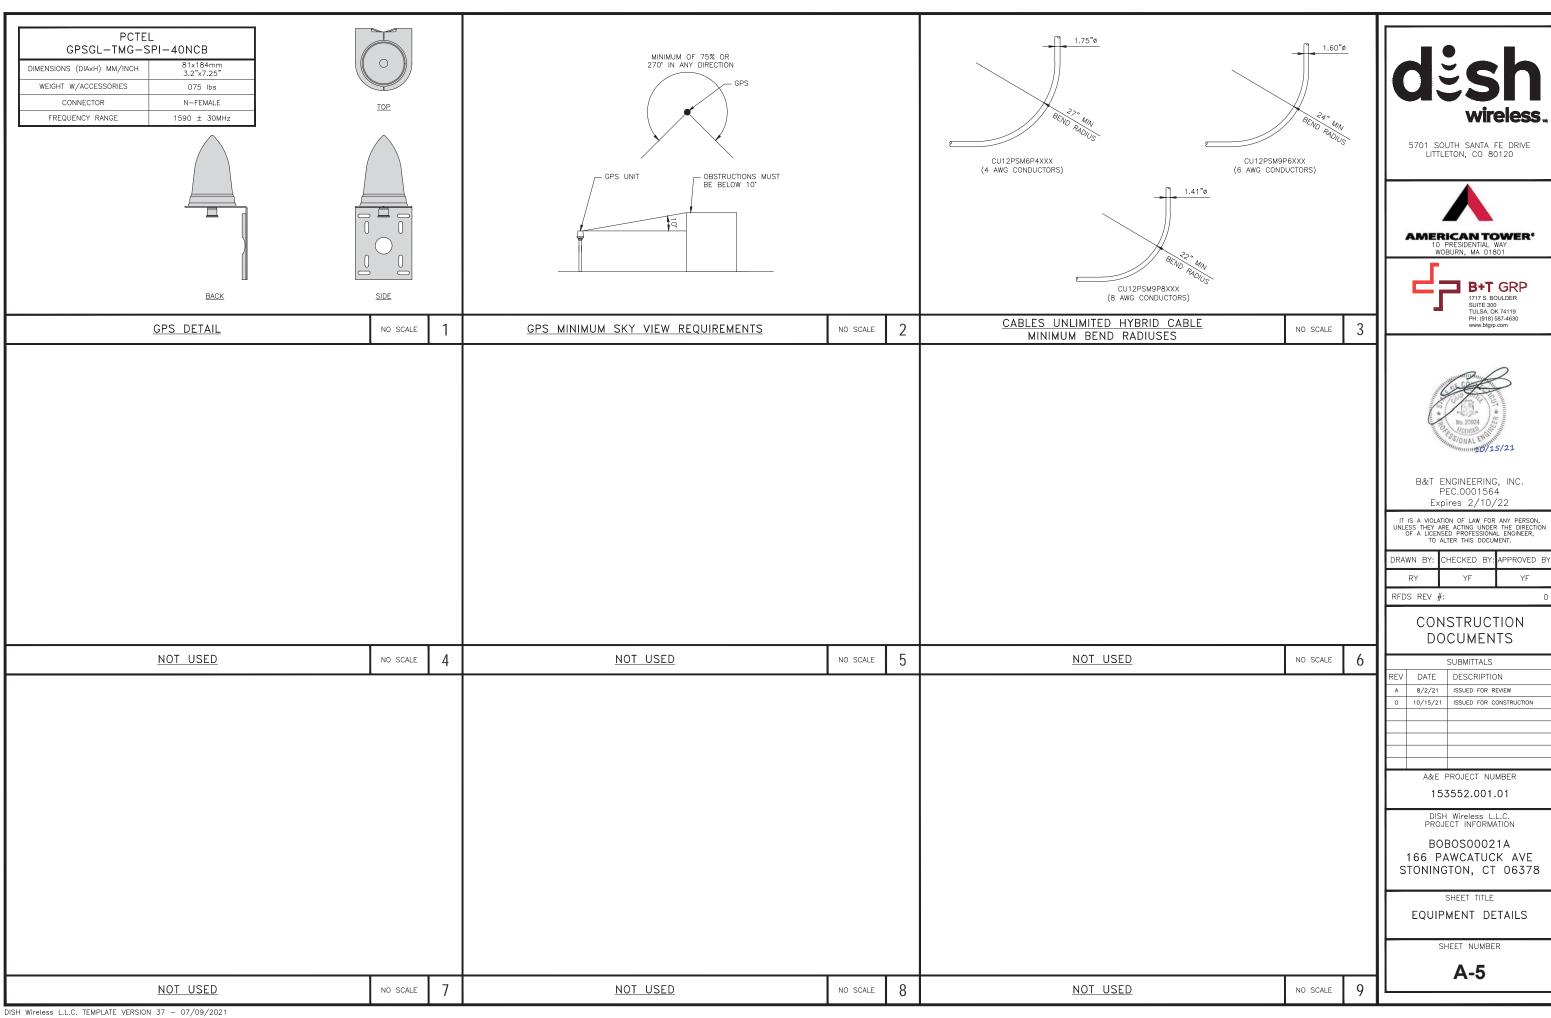

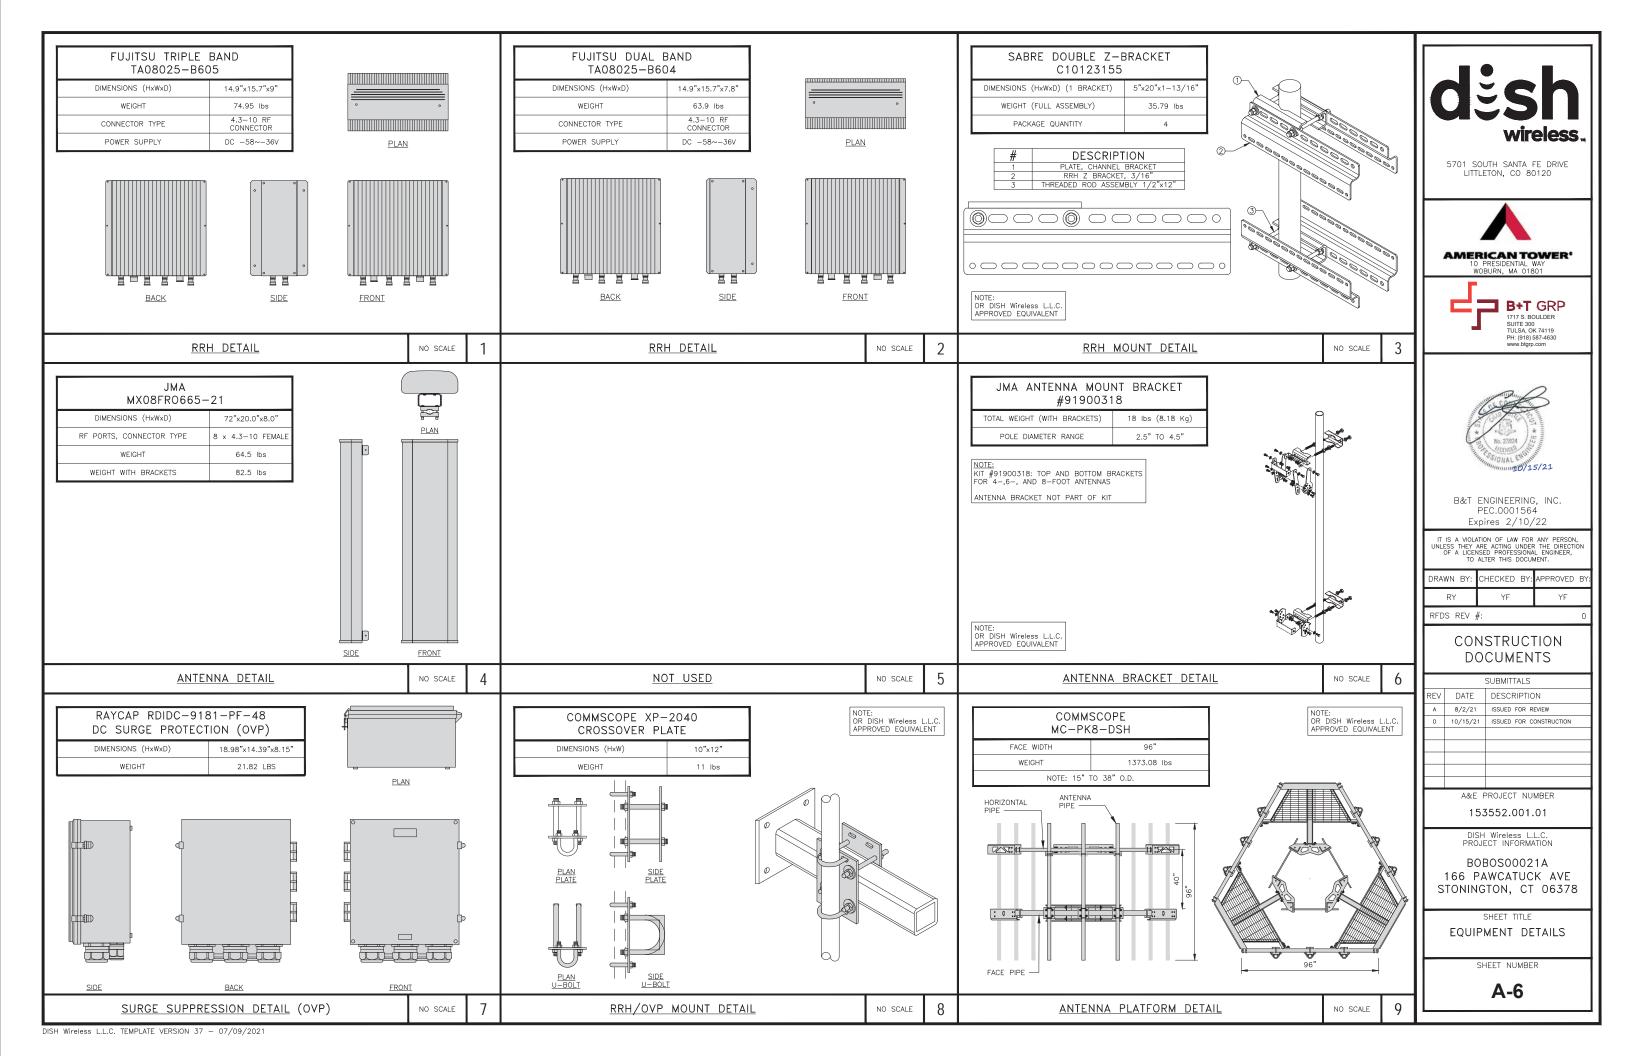

NOTES

- 1. CONTRACTOR SHALL FIELD VERIFY ALL PROPOSED UNDERGROUND UTILITY CONDUIT ROUTE.
- 2. ANTENNAS AND MOUNTS OMITTED FOR CLARITY.

PROPOSED UNDERGROUND FIBER

CONDUIT (LENGTH: 55'-0"±) -

. DUE TO UTILITY EASEMENT RIGHTS SPECIFIED IN THE GROUND LEASE, CUSTOMER MAY INSTALL EQUIPMENT WITHIN SPECIFIED UTILITY EASEMENT AREA. "PWR" AND "FBR" PATH DEPICTED ON A-1 AND E-1 REPRESENT PLANNED ROUTING BASED ON BEST AVAILABLE INFORMATION INCLUDING BUT NOT LIMITED TO A SURVEY, EXHIBITS, METES AND BOUNDS OF THE UTILITY EASEMENT, FIELD VERIFICATION, PRIOR PROJECT DOCUMENTATION AND OTHER REAL PROPETY RIGHTS DOCUMENTS. WHEN INSTALLING THE UTILITIES PLEASE LOCATE AND FOLLOW EXISTING PATH. IF EXISTING PATH IS MATERIALLY INCONSISTENT WITH "PWR" AND "FBR" PATH DEPICTED ON A-1 AND E-1 AND SAID VARIANCE IS NOT NOTED ON CDs, PLEASE NOTIFY TOWER OWNER AS FURTHER COORDINATION MAY BE NEEDED.

PROPOSED UNDERGROUND POWER CONDUIT (LENGTH: 55'-0"±) -60'-0" — PWR — — PWR — PWR — PWR —— PWR — — PWR — — PWR — — PWR -- PWR – FBR — — FBR — — FBR — — FBR — FBR — — FBR — 8'-10" GENERATOR ON CONCRETE PAD - FXISTING UTILITY 25'-6" H-FRAME WITH MULTI-METER CENTER - PROPOSED METER EXISTING MONOPOLE EXISTING PAD MOUNTED TRANSFORMER BRIDGE (TYP) 28'-0" PROPOSED FIBER HAND HOLE CONCRETE PAD EXISTING 12' WIDE CHAIN-LINE ACCESS GATE EXISTING GRAVEL ACCESS ROAD

DC POWER WIRING SHALL BE COLOR CODED AT EACH END FOR IDENTIFYING ± 24 V AND ± 48 V CONDUCTORS. RED MARKINGS SHALL IDENTIFY ± 24 V AND BLUE MARKINGS SHALL IDENTIFY ± 48 V.

- 1. CONTRACTOR SHALL INSPECT THE EXISTING CONDITIONS PRIOR TO SUBMITTING A BID. ANY QUESTIONS ARISING DURING THE BID PERIOD IN REGARDS TO THE CONTRACTOR'S FUNCTIONS, THE SCOPE OF WORK, OR ANY OTHER ISSUE RELATED TO THIS PROJECT SHALL BE BROUGHT UP DURING THE BID PERIOD WITH THE PROJECT MANAGER FOR CLARIFICATION, NOT AFTER THE CONTRACT HAS BEEN AWARDED.
- ALL ELECTRICAL WORK SHALL BE DONE IN ACCORDANCE WITH CURRENT NATIONAL ELECTRICAL CODES AND ALL STATE AND LOCAL CODES, LAWS, AND ORDINANCES. PROVIDE ALL COMPONENTS AND WIRING SIZES AS REQUIRED TO MEET NEC STANDARDS.
- 3. LOCATION OF EQUIPMENT, CONDUIT AND DEVICES SHOWN ON THE DRAWINGS ARE APPROXIMATE AND SHALL BE COORDINATED WITH FIELD CONDITIONS PRIOR TO CONSTRUCTION.
- 4. CONDUIT ROUGH—IN SHALL BE COORDINATED WITH THE MECHANICAL EQUIPMENT TO AVOID LOCATION CONFLICTS. VERIFY WITH THE MECHANICAL EQUIPMENT CONTRACTOR AND COMPLY AS REQUIRED.
- 5. CONTRACTOR SHALL PROVIDE ALL BREAKERS, CONDUITS AND CIRCUITS AS REQUIRED FOR A COMPLETE SYSTEM.
- 6. CONTRACTOR SHALL PROVIDE PULL BOXES AND JUNCTION BOXES AS REQUIRED BY THE NEC ARTICLE 314.
- 7. CONTRACTOR SHALL PROVIDE ALL STRAIN RELIEF AND CABLE SUPPORTS FOR ALL CABLE ASSEMBLIES. INSTALLATION SHALL BE IN ACCORDANCE WITH MANUFACTURER'S SPECIFICATIONS AND RECOMMENDATIONS.
- 8. ALL DISCONNECTS AND CONTROLLING DEVICES SHALL BE PROVIDED WITH ENGRAVED PHENOLIC NAMEPLATES INDICATING EQUIPMENT CONTROLLED, BRANCH CIRCUITS INSTALLED ON, AND PANEL FIELD LOCATIONS FED FROM.
- 9. INSTALL AN EQUIPMENT GROUNDING CONDUCTOR IN ALL CONDUITS PER THE SPECIFICATIONS AND NEC 250. THE EQUIPMENT GROUNDING CONDUCTORS SHALL BE BONDED AT ALL JUNCTION BOXES, PULL BOXES, AND ALL DISCONNECT SWITCHES, AND EQUIPMENT CABINETS.
- 10. ALL NEW MATERIAL SHALL HAVE A U.L. LABEL.
- 11. PANEL SCHEDULE LOADING AND CIRCUIT ARRANGEMENTS REFLECT POST-CONSTRUCTION EQUIPMENT.
- 12. CONTRACTOR SHALL BE RESPONSIBLE FOR AS-BUILT PANEL SCHEDULE AND SITE DRAWINGS.
- 13. ALL TRENCHES IN COMPOUND TO BE HAND DUG.



5701 SOUTH SANTA FE DRIVE LITTLETON, CO 80120



10 PRESIDENTIAL WAY WOBURN, MA 01801





B&T ENGINEERING, INC. PEC.0001564 Expires 2/10/22

IT IS A VIOLATION OF LAW FOR ANY PERSON, UNLESS THEY ARE ACTING UNDER THE DIRECTION OF A LICENSED PROFESSIONAL ENGINEER, TO ALTER THIS DOCUMENT.

П	DRAWN	BY:	CHECKED	BY:	APPROVED	BY:
	RY		YF		YF	

RFDS REV #:

CONSTRUCTION DOCUMENTS

ı	SUBMITTALS						
100	П	REV	DATE	DESCRIPTION			
	Ш	Α	8/2/21	ISSUED FOR REVIEW			
	П	0	10/15/21	ISSUED FOR CONSTRUCTION			
	Ш						
S	Ш						
g S	Ш						
į	Ш						
	Ш						
ı	1		405.5	DO IEST NUMBER			

A&E PROJECT NUMBER

153552.001.01

DISH Wireless L.L.

BOBOSO0021A 166 PAWCATUCK AVE STONINGTON, CT 06378

SHEET TITLE


ELECTRICAL/FIBER ROUTE
PLAN AND NOTES

SHEET NUMBER

E-1




UTILITY ROUTE PLAN

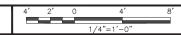


ELECTRICAL NOTES

NO SCALE

DISH Wireless L.L.C. TEMPLATE VERSION 37 - 07/09/2021

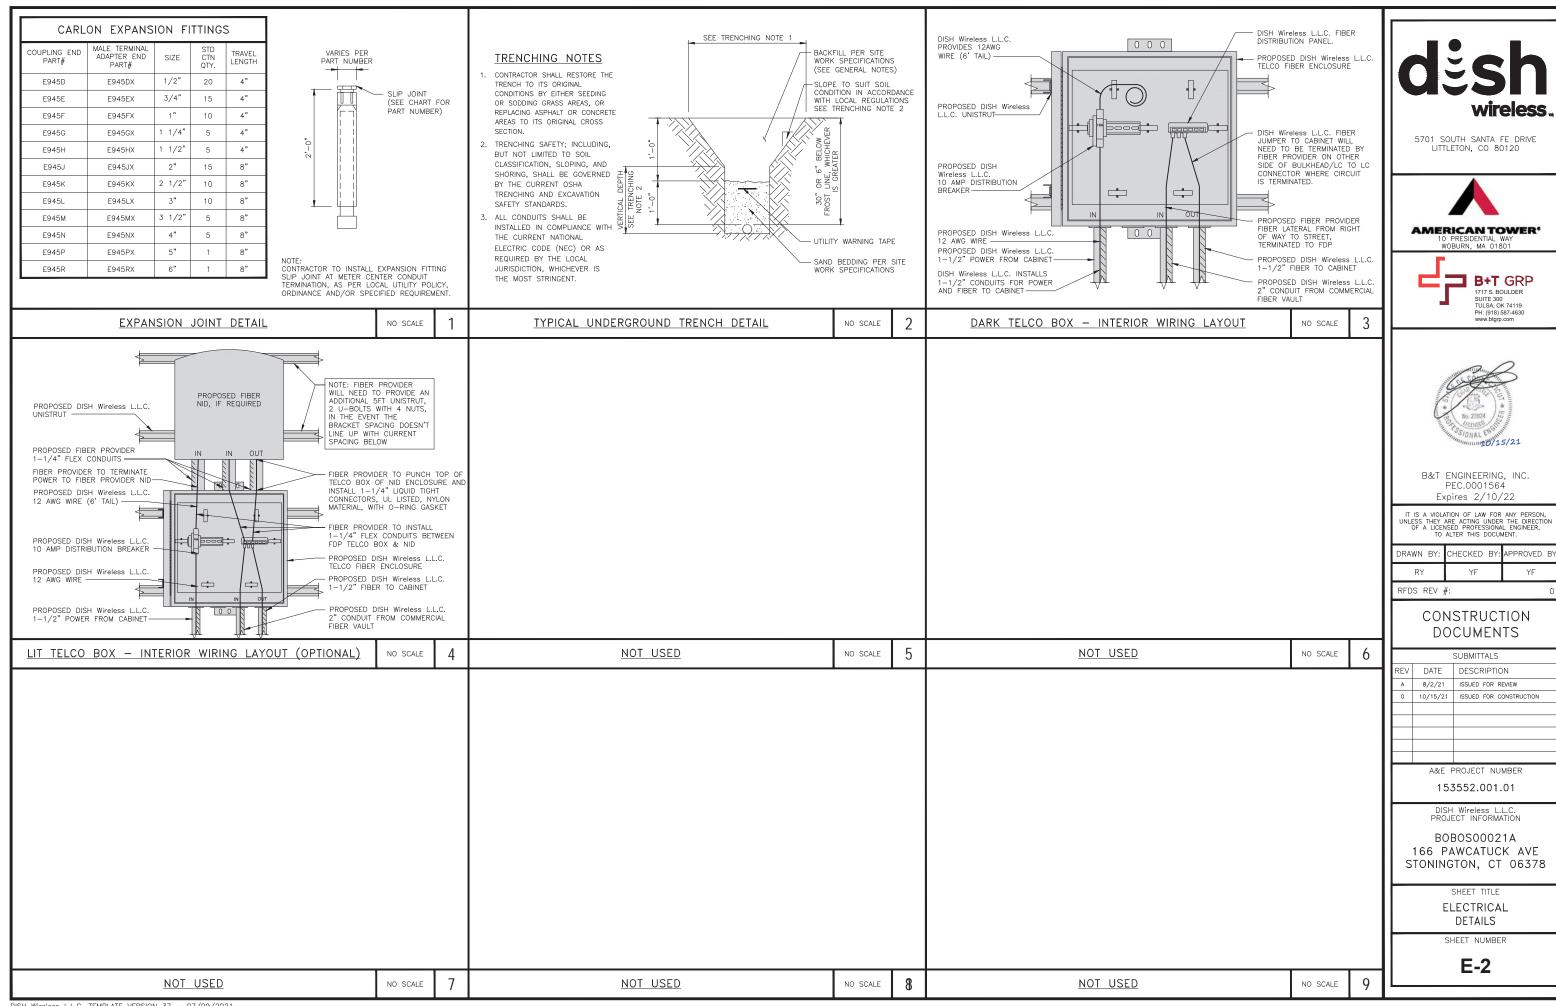

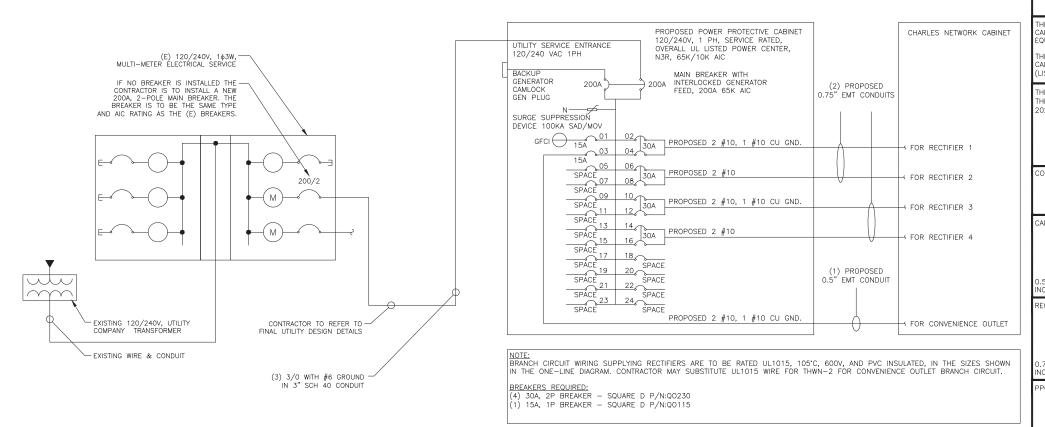

NOTES

THE ENGINEER OF RECORD HAS PERFORMED ALL REQUIRED SHORT CIRCUIT CALCULATIONS AND THE AIC RATINGS FOR EACH DEVICE IS ADEQUATE TO PROTECT THE COLIPMENT AND THE ELECTRICAL SYSTEM.

THE ENGINEER OF RECORD HAS PERFORMED ALL REQUIRED VOLTAGE DROP CALCULATIONS AND ALL BRANCH CIRCUIT AND FEEDERS COMPLY WITH THE NEC LISTED ON T-1) ARTICLE 210.19(A)(1) FPN NO. 4.

THE (2) CONDUITS WITH (4) CURRENT CARRYING CONDUCTORS EACH, SHALL APPLY THE ADJUSTMENT FACTOR OF 80% PER 2014/17 NEC TABLE 310.15(B)(3)(a) OR 2020 NEC TABLE 310.15(C)(1) FOR UL1015 WIRE.

> #12 FOR 15A-20A/1P BREAKER: 0.8 x 30A = 24.0A #10 FOR 25A-30A/2P BREAKER: 0.8 x 40A = 32.0A #8 FOR 35A-40A/2P BREAKER: 0.8 x 55A = 44.0A #6 FOR 45A-60A/2P BREAKER: 0.8 x 75A = 60.0A

0.5" CONDUIT - 0.122 SQ. IN AREA 0.75" CONDUIT - 0.213 SQ. IN AREA 2.0" CONDUIT - 1.316 SQ. IN AREA

ABINET CONVENIENCE OUTLET CONDUCTORS (1 CONDUIT): USING THWN-2, CU.

#10 - 0.0211 SQ. IN X 2 = 0.0422 SQ. IN #10 - 0.0211 SQ. IN X 1 = 0.0211 SQ. IN <GROUND

D.5" EMT CONDUIT IS ADEQUATE TO HANDLE THE TOTAL OF (3) WIRES, NCLUDING GROUND WIRE, AS INDICATED ABOVE.

RECTIFIER CONDUCTORS (2 CONDUITS): USING UL1015, CU.

#10 - 0.0266 SQ, IN X 4 = 0.1064 SQ, IN #10 - 0.0082 SQ. IN X 1 = 0.0082 SQ. IN <BARE GROUND = 0.1146 SQ. IN

0.75" EMT CONDUIT IS ADEQUATE TO HANDLE THE TOTAL OF (5) WIRES, NCLUDING GROUND WIRE, AS INDICATED ABOVE.

PPC FEED CONDUCTORS (1 CONDUIT): USING THWN, CU.

3/0 - 0.2679 SQ. IN X 3 = 0.8037 SQ. IN #6 - 0.0507 SQ. IN X 1 = 0.0507 SQ. IN <GROUND = 0.8544 SQ. IN

3.0" SCH 40 PVC CONDUIT IS ADEQUATE TO HANDLE THE TOTAL OF (4) WIRES, NCLUDING GROUND WIRE, AS INDICATED ABOVE.

PPC ONE-LINE DIAGRAM

2

NO SCALE

NO SCALE

PROPOSED CHARLES PANEL SCHEDULE (WATTS) LOAD SERVED ABB/GE INFINITY RECTIFIER 1 30A ABB/GE INFINITY RECTIFIER 2 30A ABB/GE INFINITY RECTIFIER 3 30A ABB/GE INFINITY 30A VOLTAGE AMPS MB RATING: 65,000 AIC 98 98

PANEL SCHEDULE

NOT USED

NO SCALE

wireless

5701 SOUTH SANTA FE DRIVE LITTLETON, CO 80120







B&T ENGINEERING, INC. PEC.0001564 Expires 2/10/22

IT IS A VIOLATION OF LAW FOR ANY PERSON, UNLESS THEY ARE ACTING UNDER THE DIRECTIO OF A LICENSED PROFESSIONAL ENGINEER, TO ALTER THIS DOCUMENT.

П	DRAWN BY:	CHECKED BY:	APPROVED BY
П	RY	YF	YF

RFDS REV #:

CONSTRUCTION DOCUMENTS

	SUBMITTALS				
REV	DATE	DESCRIPTION			
Α	8/2/21	ISSUED FOR REVIEW			
0	10/15/21	ISSUED FOR CONSTRUCTION			
A & E DDO JECT NILIMBED					

A&E PROJECT NUMBER

153552.001.01

DISH Wireless L.L.C. PROJECT INFORMATION


BOBOSO0021A 166 PAWCATUCK AVE STONINGTON, CT 06378

SHEET TITLE

ELECTRICAL ONE-LINE, FAULT CALCS & PANEL SCHEDULE


SHEET NUMBER

E-3

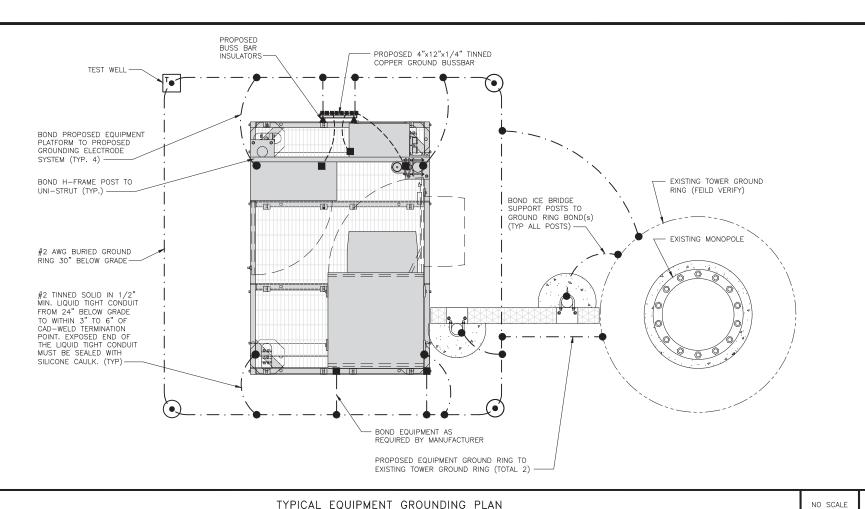

TYPICAL EQUIPMENT GROUNDING PLAN

NOTES

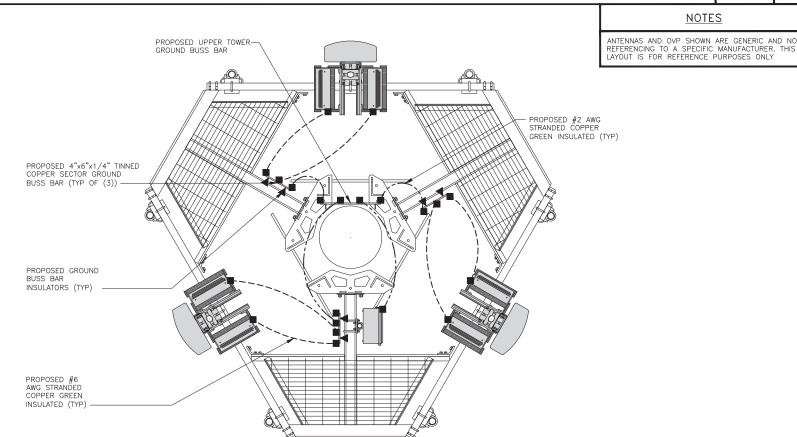

TYPICAL ANTENNA GROUNDING PLAN

 EXOTHERMIC CONNECTION MECHANICAL CONNECTION

GROUND BUS BAR

GROUND ROD

 \bullet

TEST GROUND ROD WITH INSPECTION SLEEVE

---- #6 AWG STRANDED & INSULATED

- · - +2 AWG SOLID COPPER TINNED

A BUSS BAR INSULATOR

GROUNDING LEGEND

- 1. GROUNDING IS SHOWN DIAGRAMMATICALLY ONLY.
- 2. CONTRACTOR SHALL GROUND ALL EQUIPMENT AS A COMPLETE SYSTEM. GROUNDING SHALL BE IN COMPLIANCE WITH NEC SECTION 250 AND DISH Wireless L.L.C. GROUNDING AND BONDING REQUIREMENTS AND MANUFACTURER'S SPECIFICATIONS.
- 3. ALL GROUND CONDUCTORS SHALL BE COPPER; NO ALUMINUM CONDUCTORS SHALL BE USED.

GROUNDING KEY NOTES

- EXTERIOR GROUND RING: #2 AWG SOLID COPPER, BURIED AT A DEPTH OF AT LEAST 30 INCHES BELOW GRADE, OR 6 INCHES BELOW THE FROST LINE AND APPROXIMATELY 24 INCHES FROM THE EXTERIOR WALL OR FOOTING.
- TOWER GROUND RING: THE GROUND RING SYSTEM SHALL BE INSTALLED AROUND AN ANTENNA TOWER'S LEGS. AND/OR GUY ANCHORS. WHERE SEPARATE SYSTEMS HAVE BEEN PROVIDED FOR THE TOWER AND THE BUILDING, AT LEAST TWO BONDS SHALL BE MADE BETWEEN THE TOWER RING GROUND SYSTEM AND THE BUILDING RING GROUND SYSTEM USING MINIMUM #2 AWG SOLID COPPER CONDUCTORS.
- C INTERIOR GROUND RING: #2 AWG STRANDED GREEN INSULATED COPPER CONDUCTOR EXTENDED AROUND THE PERIMETER OF THE EQUIPMENT AREA. ALL NON-TELECOMMUNICATIONS RELATED METALLIC OBJECTS FOUND WITHIN A SITE SHALL BE GROUNDED TO THE INTERIOR GROUND RING WITH #6 AWG STRANDED GREEN
- D BOND TO INTERIOR GROUND RING: #2 AWG SOLID TINNED COPPER WIRE PRIMARY BONDS SHALL BE PROVIDED AT LEAST AT FOUR POINTS ON THE INTERIOR GROUND RING, LOCATED AT THE CORNERS OF THE BUILDING.
- GROUND ROD: UL LISTED COPPER CLAD STEEL. MINIMUM 1/2" DIAMETER BY EIGHT FEET LONG. GROUND RODS SHALL BE INSTALLED WITH INSPECTION SLEEVES. GROUND RODS SHALL BE DRIVEN TO THE DEPTH OF GROUND RING CONDUCTOR.
- CELL REFERENCE GROUND BAR: POINT OF GROUND REFERENCE FOR ALL COMMUNICATIONS EQUIPMENT FRAMES. ALL BONDS ARE MADE WITH #2 AWG UNLESS NOTED OTHERWISE STRANDED GREEN INSULATED COPPER CONDUCTORS. BOND TO GROUND RING WITH (2) #2 SOLID TINNED COPPER CONDUCTORS.
- HATCH PLATE GROUND BAR: BOND TO THE INTERIOR GROUND RING WITH TWO #2 AWG STRANDED GREEN INSULATED COPPER CONDUCTORS. WHEN A HATCH-PLATE AND A CELL REFERENCE GROUND BAR ARE BOTH PRESENT, THE CRGB MUST BE CONNECTED TO THE HATCH-PLATE AND TO THE INTERIOR GROUND RING USING (2) TWO #2 AWG STRANDED GREEN INSULATED COPPER CONDUCTORS EACH.
- (H) <u>EXTERIOR CABLE ENTRY PORT GROUND BARS:</u> LOCATED AT THE ENTRANCE TO THE CELL SITE BUILDING. BOND TO GROUND RING WITH A #2 AWG SOLID TINNED COPPER CONDUCTORS WITH AN EXOTHERMIC WELD AND
- (I) TELCO GROUND BAR: BOND TO BOTH CELL REFERENCE GROUND BAR OR EXTERIOR GROUND RING.
- J FRAME BONDING: THE BONDING POINT FOR TELECOM EQUIPMENT FRAMES SHALL BE THE GROUND BUS THAT IS NOT ISOLATED FROM THE EQUIPMENTS METAL FRAMEWORK.
- K INTERIOR UNIT BONDS: METAL FRAMES, CABINETS AND INDIVIDUAL METALLIC UNITS LOCATED WITH THE AREA OF THE INTERIOR GROUND RING REQUIRE A #6 AWG STRANDED GREEN INSULATED COPPER BOND TO THE
- L FENCE AND GATE GROUNDING: METAL FENCES WITHIN 7 FEET OF THE EXTERIOR GROUND RING OR OBJECTS BONDED TO THE EXTERIOR GROUND RING SHALL BE BONDED TO THE GROUND RING WITH A #2 AWG SOLID TINNED COPPER CONDUCTOR AT AN INTERVAL NOT EXCEEDING 25 FEET. BONDS SHALL BE MADE AT EACH GATE POST AND ACROSS GATE OPENINGS.
- M EXTERIOR UNIT BONDS: METALLIC OBJECTS, EXTERNAL TO OR MOUNTED TO THE BUILDING, SHALL BE BONDED TO THE EXTERIOR GROUND RING. USING #2 TINNED SOLID COPPER WIRE
- N ICE BRIDGE SUPPORTS: EACH ICE BRIDGE LEG SHALL BE BONDED TO THE GROUND RING WITH #2 AWG BARE TINNED COPPER CONDUCTOR. PROVIDE EXOTHERMIC WELDS AT BOTH THE ICE BRIDGE LEG AND BURIED GROUND RING.
- DURING ALL DC POWER SYSTEM CHANGES INCLUDING DC SYSTEM CHANGE UUIS, KEUIFIEK KEPLACEMENTS OR ADDITIONS, BREAKER DISTRIBUTION CHANGES, BATTERY ADDITIONS, BATTERY REPLACEMENTS AND INSTALLATIONS OR CHANGES TO DC CONVERTER SYSTEMS IT SHALL BE REQUIRED THAT SERVICE CONTRACTORS VERIFY ALL DC POWER SYSTEMS ARE EQUIPPED WITH A MASTER DC SYSTEM RETURN GROUND CONDUCTOR FROM THE DC POWER SYSTEM COMMON RETURN BUS DIRECTLY CONNECTED TO THE CELL SITE DURING ALL DC POWER SYSTEM CHANGES INCLUDING DC SYSTEM CHANGE OUTS, RECTIFIER REPLACEMENTS
- (P) TOWER TOP COLLECTOR BUSS BAR IS TO BE MECHANICALLY BONDED TO PROPOSED ANTENNA MOUNT COLLAR.
- (Q) REFER TO DISH Wireless L.L.C. GROUNDING NOTES.

5701 SOUTH SANTA FE DRIVE LITTLETON, CO 80120







B&T ENGINEERING, INC. PEC.0001564 Expires 2/10/22

IT IS A VIOLATION OF LAW FOR ANY PERSON, UNLESS THEY ARE ACTING UNDER THE DIRECTION OF A LICENSED PROFESSIONAL ENGINEER, TO ALTER THIS DOCUMENT.

DRAWN	BY:	CHECKED	BY:	APPROVED	BY:
RY		YF		YF	

RFDS REV #

CONSTRUCTION **DOCUMENTS**

l			SUBMITTALS
ı	REV	DATE	DESCRIPTION
ı	Α	8/2/21	ISSUED FOR REVIEW
ı	0	10/15/21	ISSUED FOR CONSTRUCTION
ı			
ı			
ı			
ı			

A&E PROJECT NUMBER

153552.001.01

DISH Wireless L.L.C. PROJECT INFORMATION

BOBOSO0021A 166 PAWCATUCK AVE STONINGTON, CT 06378

SHEET TITLE


GROUNDING PLANS AND NOTES


SHEET NUMBER


G-1


NO SCALE

GROUNDING KEY NOTES

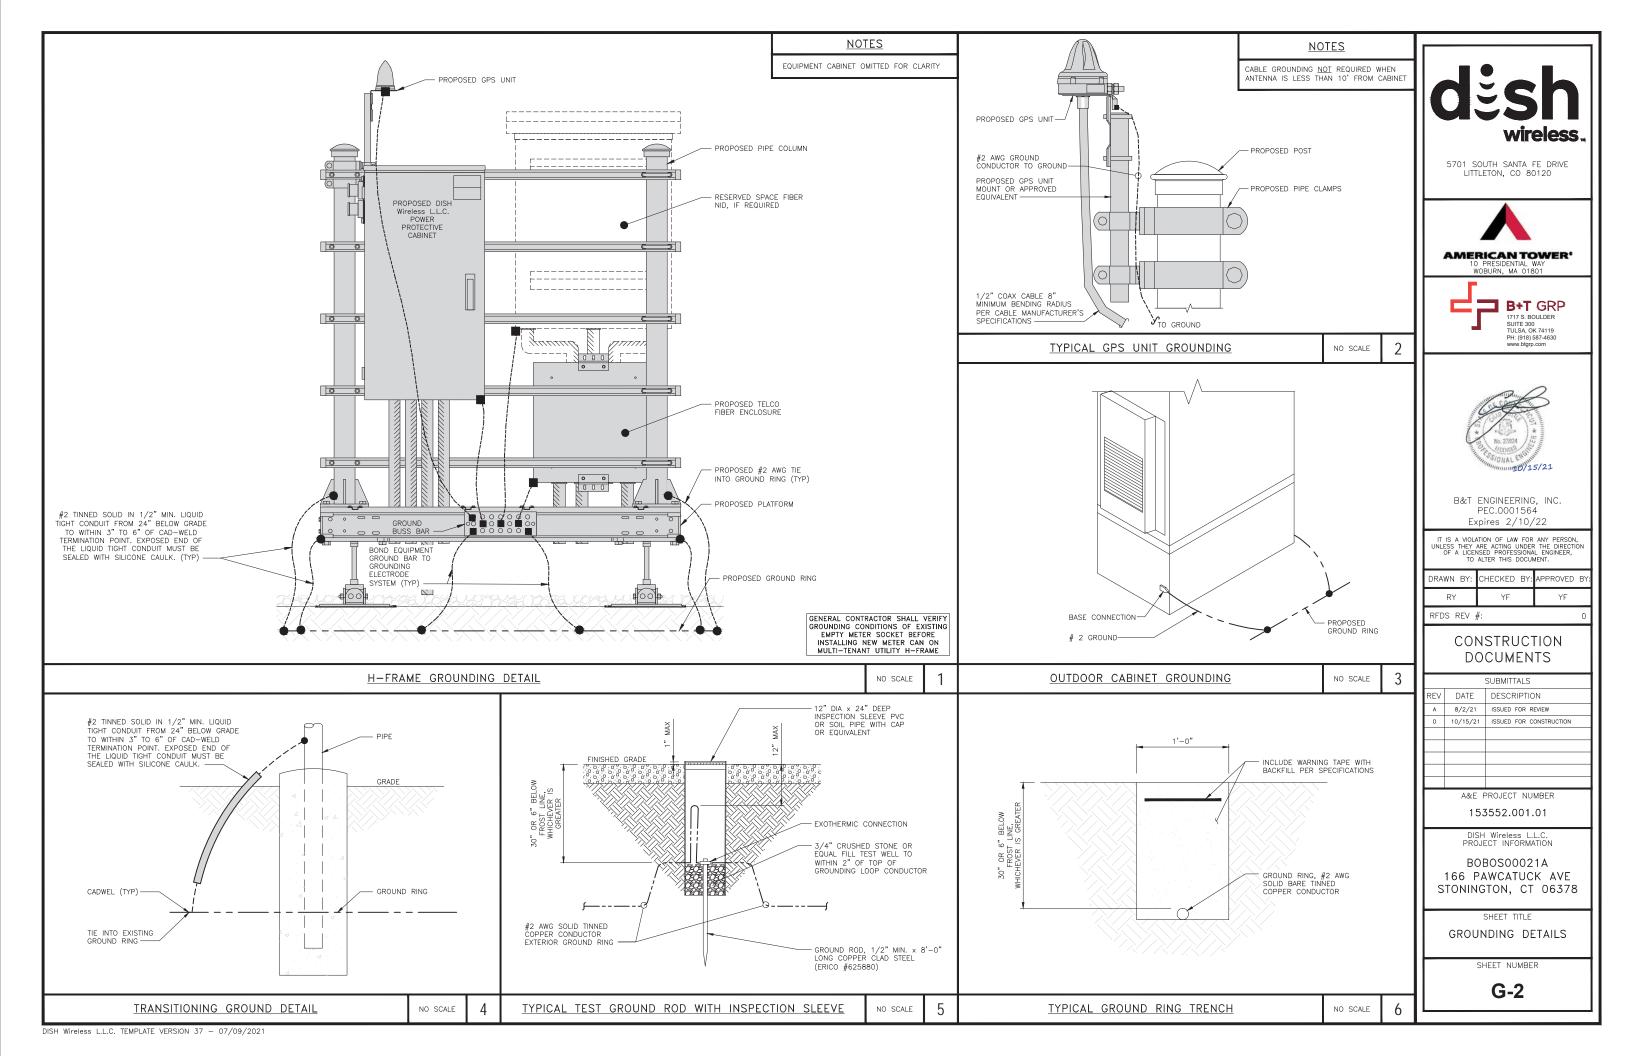

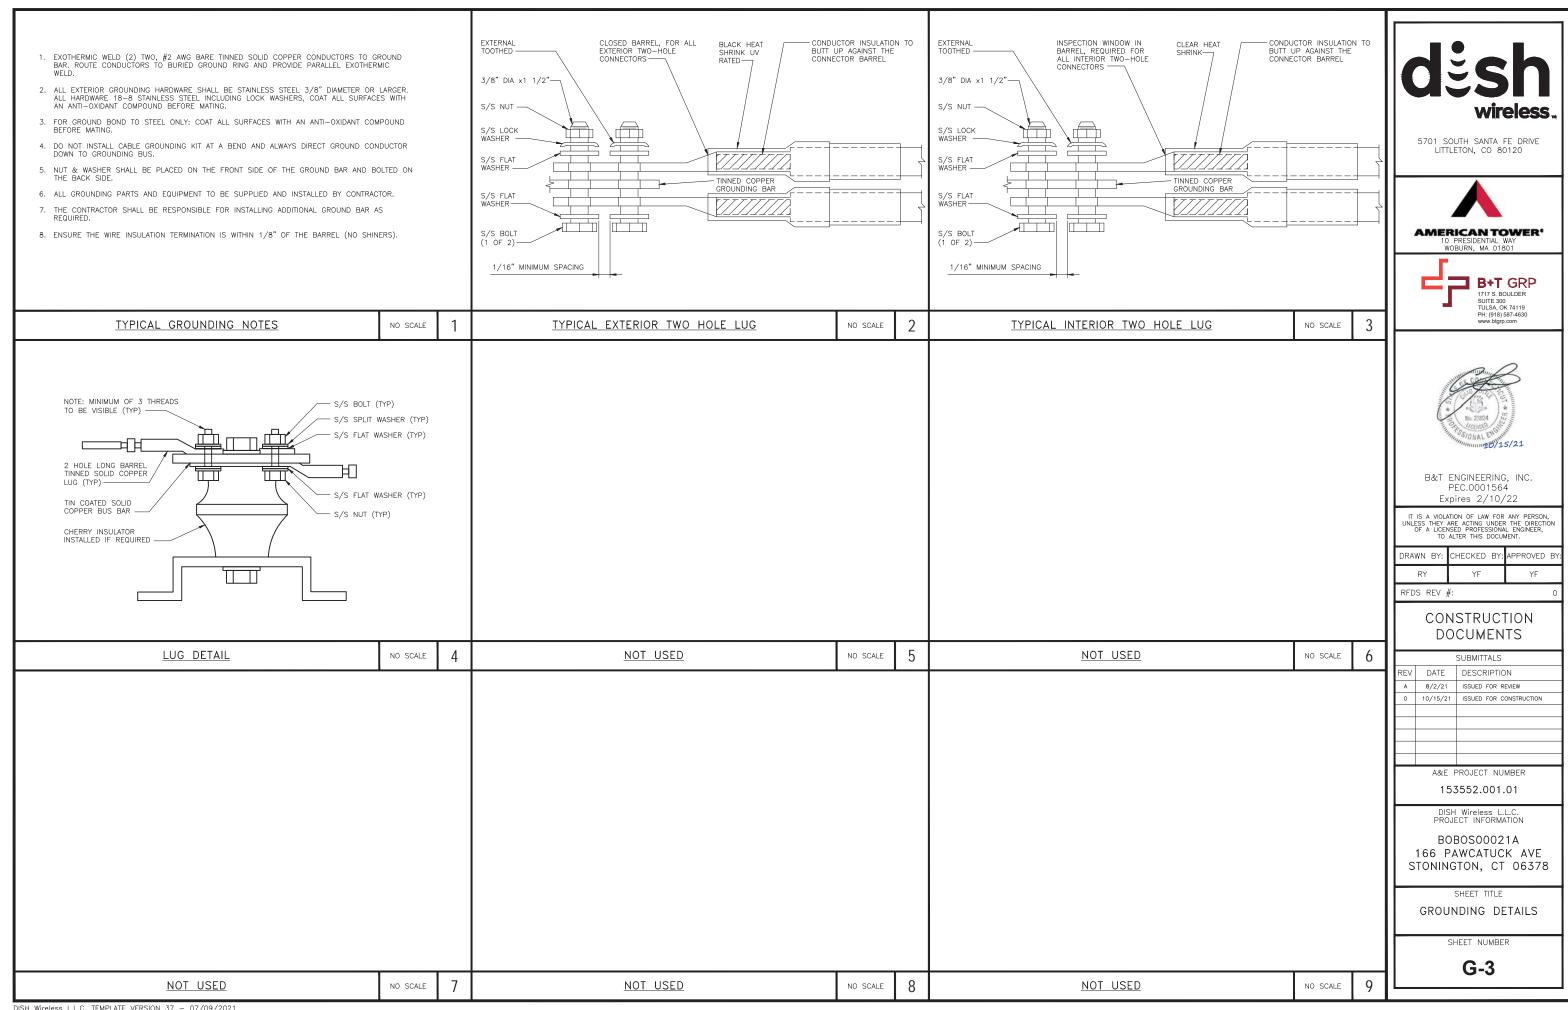

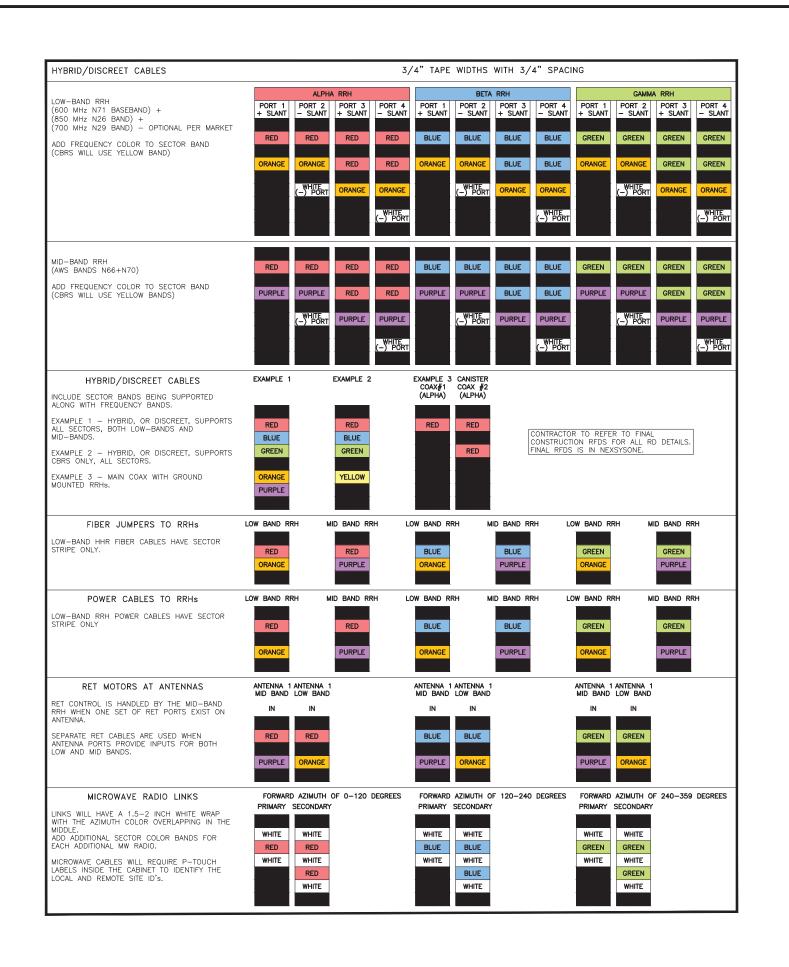

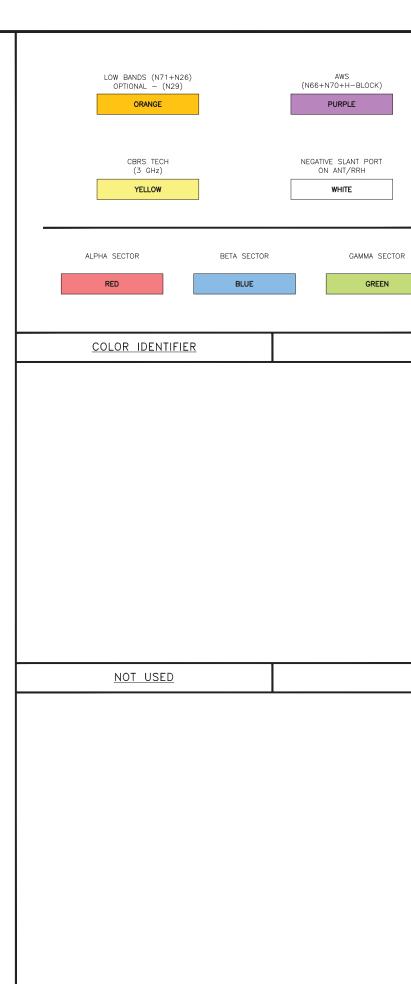

NOT USED



5701 SOUTH SANTA FE DRIVE LITTLETON, CO 80120







B&T ENGINEERING, INC. PEC.0001564 Expires 2/10/22

IT IS A VIOLATION OF LAW FOR ANY PERSON, UNLESS THEY ARE ACTING UNDER THE DIRECTION OF A LICENSED PROFESSIONAL ENGINEER, TO ALTER THIS DOCUMENT.

П	DRAWN	BY:	CHECKED	BY:	APPROVED	BY:
	RY		YF		YF	

RFDS REV #:

CONSTRUCTION DOCUMENTS

ı	SUBMITTALS					
ı	REV	DATE	DESCRIPTION			
П	Α	8/2/21	ISSUED FOR REVIEW			
П	0	10/15/21	ISSUED FOR CONSTRUCTION			
П						
П						
П						
П						

A&E PROJECT NUMBER

153552.001.01

PROJECT INFORMATIO

BOBOSO0021A 166 PAWCATUCK AVE STONINGTON, CT 06378


SHEET TITLE

CABLE COLOR CODES

SHEET NUMBER

RF-1

RF CABLE COLOR CODES

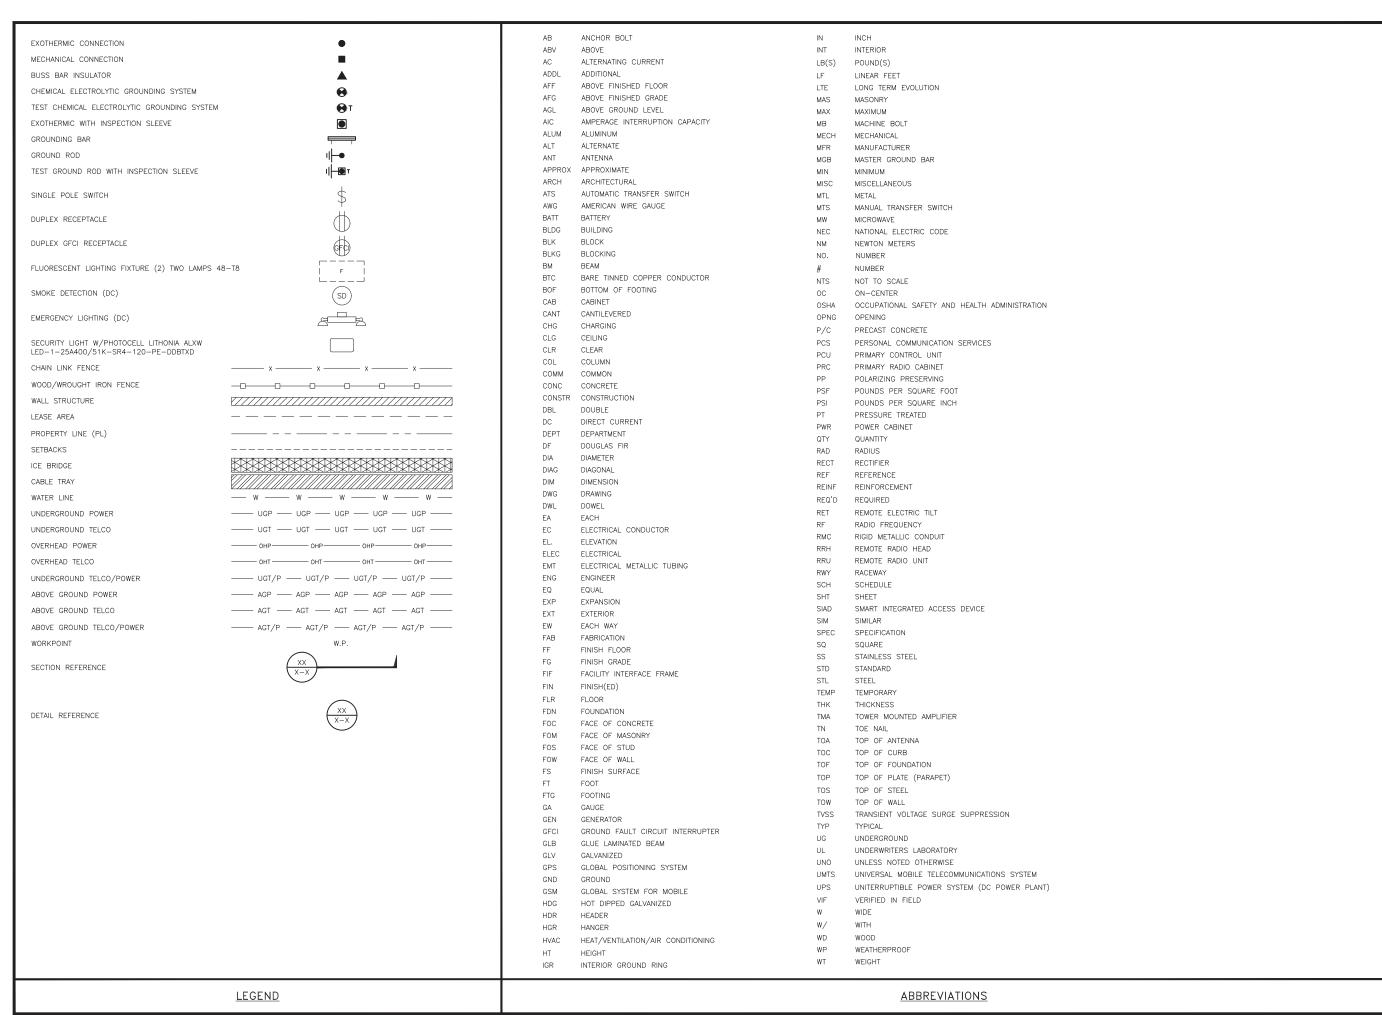



5701 SOUTH SANTA FE DRIVE LITTLETON, CO 80120



WOBURN, MA 01801



1717 S. BOULDER SUITE 300 TULSA, OK 74119 PH: (918) 587-4630 www.btgrp.com



B&T ENGINEERING, INC. PEC.0001564 Expires 2/10/22

IT IS A VIOLATION OF LAW FOR ANY PERSON, UNLESS THEY ARE ACTING UNDER THE DIRECTION OF A LICENSED PROFESSIONAL ENGINEER,
TO ALTER THIS DOCUMENT.

DRAWN	BY:	CHECKED	BY:	APPROVED	BY:
RY		YF		YF	

RFDS REV #:

CONSTRUCTION DOCUMENTS

ı	SUBMITTALS					
ı	REV	DATE	DESCRIPTION			
	Α	8/2/21	ISSUED FOR REVIEW			
	0	10/15/21	ISSUED FOR CONSTRUCTION			
ı						
П						
Ш						

A&E PROJECT NUMBER

153552.001.01

BOBOSO0021A 166 PAWCATUCK AVE STONINGTON, CT 06378

SHEET TITLE

LEGEND AND **ABBREVIATIONS**

SHEET NUMBER

SITE ACTIVITY REQUIREMENTS:

- 1. NOTICE TO PROCEED NO WORK SHALL COMMENCE PRIOR TO CONTRACTOR RECEIVING A WRITTEN NOTICE TO PROCEED (NTP) AND THE ISSUANCE OF A PURCHASE ORDER. PRIOR TO ACCESSING/ENTERING THE SITE YOU MUST CONTACT THE DISH Wireless L.L.C. AND TOWER OWNER NOC & THE DISH Wireless L.L.C. AND TOWER OWNER CONSTRUCTION MANAGER.
- 2. "LOOK UP" DISH Wireless L.L.C. AND TOWER OWNER SAFETY CLIMB REQUIREMENT:

THE INTEGRITY OF THE SAFETY CLIMB AND ALL COMPONENTS OF THE CLIMBING FACILITY SHALL BE CONSIDERED DURING ALL STAGES OF DESIGN, INSTALLATION, AND INSPECTION. TOWER MODIFICATION, MOUNT REINFORCEMENTS, AND/OR EQUIPMENT INSTALLATIONS SHALL NOT COMPROMISE THE INTEGRITY OR FUNCTIONAL USE OF THE SAFETY CLIMB OR ANY COMPONENTS OF THE CLIMBING FACILITY ON THE STRUCTURE. THIS SHALL INCLUDE, BUT NOT BE LIMITED TO: PINCHING OF THE WIRE ROPE, BENDING OF THE WIRE ROPE FROM ITS SUPPORTS, DIRECT CONTACT OR CLOSE PROXIMITY TO THE WIRE ROPE WHICH MAY CAUSE FRICTIONAL WEAR, IMPACT TO THE ANCHORAGE POINTS IN ANY WAY, OR TO IMPEDE/BLOCK ITS INTENDED USE. ANY COMPROMISED SAFETY CLIMB, INCLUDING EXISTING CONDITIONS MUST BE TAGGED OUT AND REPORTED TO YOUR DISH WIRELESS L.L.C. AND DISH WIRELESS L.L.C. AND TOWER OWNER POC OR CALL THE NOC TO GENERATE A SAFETY CLIMB MAINTENANCE AND CONTRACTOR NOTICE TICKET.

- 3. PRIOR TO THE START OF CONSTRUCTION, ALL REQUIRED JURISDICTIONAL PERMITS SHALL BE OBTAINED. THIS INCLUDES, BUT IS NOT LIMITED TO, BUILDING, ELECTRICAL, MECHANICAL, FIRE, FLOOD ZONE, ENVIRONMENTAL, AND ZONING. AFTER ONSITE ACTIVITIES AND CONSTRUCTION ARE COMPLETED, ALL REQUIRED PERMITS SHALL BE SATISFIED AND CLOSED OUT ACCORDING TO LOCAL JURISDICTIONAL REQUIREMENTS.
- 4. ALL CONSTRUCTION MEANS AND METHODS; INCLUDING BUT NOT LIMITED TO, ERECTION PLANS, RIGGING PLANS, CLIMBING PLANS, AND RESCUE PLANS SHALL BE THE RESPONSIBILITY OF THE GENERAL CONTRACTOR RESPONSIBLE FOR THE EXECUTION OF THE WORK CONTAINED HEREIN, AND SHALL MEET ANSI/ASSE A10.48 (LATEST EDITION); FEDERAL, STATE, AND LOCAL REGULATIONS; AND ANY APPLICABLE INDUSTRY CONSENSUS STANDARDS RELATED TO THE CONSTRUCTION ACTIVITIES BEING PERFORMED. ALL RIGGING PLANS SHALL ADHERE TO ANSI/ASSE A10.48 (LATEST EDITION) AND DISH WIReless L.L.C. AND TOWER OWNER STANDARDS, INCLUDING THE REQUIRED INVOLVEMENT OF A QUALIFIED ENGINEER FOR CLASS IV CONSTRUCTION, TO CERTIFY THE SUPPORTING STRUCTURE(S) IN ACCORDANCE WITH ANSI/TIA-322 (LATEST EDITION).
- 5. ALL SITE WORK TO COMPLY WITH DISH Wireless L.L.C. AND TOWER OWNER INSTALLATION STANDARDS FOR CONSTRUCTION ACTIVITIES ON DISH Wireless L.L.C. AND TOWER OWNER TOWER SITE AND LATEST VERSION OF ANSI/TIA-1019-A-2012 "STANDARD FOR INSTALLATION, ALTERATION, AND MAINTENANCE OF ANTENNA SUPPORTING STRUCTURES AND ANTENNAS."
- 6. IF THE SPECIFIED EQUIPMENT CAN NOT BE INSTALLED AS SHOWN ON THESE DRAWINGS, THE CONTRACTOR SHALL PROPOSE AN ALTERNATIVE INSTALLATION FOR APPROVAL BY DISH Wireless L.L.C. AND TOWER OWNER PRIOR TO PROCEEDING WITH ANY SUCH CHANGE OF INSTALLATION.
- 7. ALL MATERIALS FURNISHED AND INSTALLED SHALL BE IN STRICT ACCORDANCE WITH ALL APPLICABLE CODES, REGULATIONS AND ORDINANCES. CONTRACTOR SHALL ISSUE ALL APPROPRIATE NOTICES AND COMPLY WITH ALL LAWS, ORDINANCES, RULES, REGULATIONS AND LAWFUL ORDERS OF ANY PUBLIC AUTHORITY REGARDING THE PERFORMANCE OF THE WORK. ALL WORK CARRIED OUT SHALL COMPLY WITH ALL APPLICABLE MUNICIPAL AND UTILITY COMPANY SPECIFICATIONS AND LOCAL JURISDICTIONAL CODES, ORDINANCES AND APPLICABLE REGULATIONS.
- 8. THE CONTRACTOR SHALL INSTALL ALL EQUIPMENT AND MATERIALS IN ACCORDANCE WITH MANUFACTURER'S RECOMMENDATIONS UNLESS SPECIFICALLY STATED OTHERWISE.
- 9. THE CONTRACTOR SHALL CONTACT UTILITY LOCATING SERVICES INCLUDING PRIVATE LOCATES SERVICES PRIOR TO THE START OF CONSTRUCTION.
- 10. ALL EXISTING ACTIVE SEWER, WATER, GAS, ELECTRIC AND OTHER UTILITIES WHERE ENCOUNTERED IN THE WORK, SHALL BE PROTECTED AT ALL TIMES AND WHERE REQUIRED FOR THE PROPER EXECUTION OF THE WORK, SHALL BE RELOCATED AS DIRECTED BY CONTRACTOR. EXTREME CAUTION SHOULD BE USED BY THE CONTRACTOR WHEN EXCAVATING OR DRILLING PIERS AROUND OR NEAR UTILITIES. CONTRACTOR SHALL PROVIDE SAFETY TRAINING FOR THE WORKING CREW. THIS WILL INCLUDE BUT NOT BE LIMITED TO A) FALL PROTECTION B) CONFINED SPACE C) ELECTRICAL SAFETY D) TRENCHING AND EXCAVATION E) CONSTRUCTION SAFETY PROCEDURES.
- 11. ALL SITE WORK SHALL BE AS INDICATED ON THE STAMPED CONSTRUCTION DRAWINGS AND DISH PROJECT SPECIFICATIONS, LATEST APPROVED REVISION.
- 12. CONTRACTOR SHALL KEEP THE SITE FREE FROM ACCUMULATING WASTE MATERIAL, DEBRIS, AND TRASH AT THE COMPLETION OF THE WORK. IF NECESSARY, RUBBISH, STUMPS, DEBRIS, STICKS, STONES AND OTHER REFUSE SHALL BE REMOVED FROM THE SITE AND DISPOSED OF LEGALLY.
- 13. ALL EXISTING INACTIVE SEWER, WATER, GAS, ELECTRIC AND OTHER UTILITIES, WHICH INTERFERE WITH THE EXECUTION OF THE WORK, SHALL BE REMOVED AND/OR CAPPED, PLUGGED OR OTHERWISE DISCONTINUED AT POINTS WHICH WILL NOT INTERFERE WITH THE EXECUTION OF THE WORK, SUBJECT TO THE APPROVAL OF DISH WIRELESS L.L.C. AND TOWER OWNER, AND/OR LOCAL UTILITIES.
- 14. THE CONTRACTOR SHALL PROVIDE SITE SIGNAGE IN ACCORDANCE WITH THE TECHNICAL SPECIFICATION FOR SITE SIGNAGE REQUIRED BY LOCAL JURISDICTION AND SIGNAGE REQUIRED ON INDIVIDUAL PIECES OF EQUIPMENT, ROOMS, AND SHELTERS.
- 15. THE SITE SHALL BE GRADED TO CAUSE SURFACE WATER TO FLOW AWAY FROM THE CARRIER'S EQUIPMENT AND TOWER AREAS.
- 16. THE SUB GRADE SHALL BE COMPACTED AND BROUGHT TO A SMOOTH UNIFORM GRADE PRIOR TO FINISHED SURFACE APPLICATION.
- 17. THE AREAS OF THE OWNERS PROPERTY DISTURBED BY THE WORK AND NOT COVERED BY THE TOWER, EQUIPMENT OR DRIVEWAY, SHALL BE GRADED TO A UNIFORM SLOPE, AND STABILIZED TO PREVENT EROSION AS SPECIFIED ON THE CONSTRUCTION DRAWINGS AND/OR PROJECT SPECIFICATIONS.
- 18. CONTRACTOR SHALL MINIMIZE DISTURBANCE TO EXISTING SITE DURING CONSTRUCTION. EROSION CONTROL MEASURES, IF REQUIRED DURING CONSTRUCTION, SHALL BE IN CONFORMANCE WITH THE LOCAL GUIDELINES FOR EROSION AND SEDIMENT CONTROL.
- 19. THE CONTRACTOR SHALL PROTECT EXISTING IMPROVEMENTS, PAVEMENTS, CURBS, LANDSCAPING AND STRUCTURES. ANY DAMAGED PART SHALL BE REPAIRED AT CONTRACTOR'S EXPENSE TO THE SATISFACTION OF OWNER.
- 20. CONTRACTOR SHALL LEGALLY AND PROPERLY DISPOSE OF ALL SCRAP MATERIALS SUCH AS COAXIAL CABLES AND OTHER ITEMS REMOVED FROM THE EXISTING FACILITY. ANTENNAS AND RADIOS REMOVED SHALL BE RETURNED TO THE OWNER'S DESIGNATED LOCATION.
- 21. CONTRACTOR SHALL LEAVE PREMISES IN CLEAN CONDITION. TRASH AND DEBRIS SHOULD BE REMOVED FROM SITE ON A DAILY BASIS.
- 22. NO FILL OR EMBANKMENT MATERIAL SHALL BE PLACED ON FROZEN GROUND. FROZEN MATERIALS, SNOW OR ICE SHALL NOT BE PLACED IN ANY FILL OR EMBANKMENT.

GENERAL NOTES:

1.FOR THE PURPOSE OF CONSTRUCTION DRAWING, THE FOLLOWING DEFINITIONS SHALL APPLY:

CONTRACTOR: GENERAL CONTRACTOR RESPONSIBLE FOR CONSTRUCTION

CARRIER:DISH Wireless L.L.C.

TOWER OWNER: TOWER OWNER

- 2. THESE DRAWINGS HAVE BEEN PREPARED USING STANDARDS OF PROFESSIONAL CARE AND COMPLETENESS NORMALLY EXERCISED UNDER SIMILAR CIRCUMSTANCES BY REPUTABLE ENGINEERS IN THIS OR SIMILAR LOCALITIES. IT IS ASSUMED THAT THE WORK DEPICTED WILL BE PERFORMED BY AN EXPERIENCED CONTRACTOR AND/OR WORKPEOPLE WHO HAVE A WORKING KNOWLEDGE OF THE APPLICABLE CODE STANDARDS AND REQUIREMENTS AND OF INDUSTRY ACCEPTED STANDARD GOOD PRACTICE. AS NOT EVERY CONDITION OR ELEMENT IS (OR CAN BE) EXPLICITLY SHOWN ON THESE DRAWINGS, THE CONTRACTOR SHALL USE INDUSTRY ACCEPTED STANDARD GOOD PRACTICE FOR MISCELLANEOUS WORK NOT EXPLICITLY SHOWN.
- 3. THESE DRAWINGS REPRESENT THE FINISHED STRUCTURE. THEY DO NOT INDICATE THE MEANS OR METHODS OF CONSTRUCTION. THE CONTRACTOR SHALL BE SOLELY RESPONSIBLE FOR THE CONSTRUCTION MEANS, METHODS, TECHNIQUES, SEQUENCES, AND PROCEDURES. THE CONTRACTOR SHALL PROVIDE ALL MEASURES NECESSARY FOR PROTECTION OF LIFE AND PROPERTY DURING CONSTRUCTION. SUCH MEASURES SHALL INCLUDE, BUT NOT BE LIMITED TO, BRACING, FORMWORK, SHORING, ETC. SITE VISITS BY THE ENGINEER OR HIS REPRESENTATIVE WILL NOT INCLUDE INSPECTION OF THESE ITEMS AND IS FOR STRUCTURAL OBSERVATION OF THE FINISHED STRUCTURE ONLY.
- 4. NOTES AND DETAILS IN THE CONSTRUCTION DRAWINGS SHALL TAKE PRECEDENCE OVER GENERAL NOTES AND TYPICAL DETAILS. WHERE NO DETAILS ARE SHOWN, CONSTRUCTION SHALL CONFORM TO SIMILAR WORK ON THE PROJECT, AND/OR AS PROVIDED FOR IN THE CONTRACT DOCUMENTS. WHERE DISCREPANCIES OCCUR BETWEEN PLANS, DETAILS, GENERAL NOTES, AND SPECIFICATIONS, THE GREATER, MORE STRICT REQUIREMENTS, SHALL GOVERN. IF FURTHER CLARIFICATION IS REQUIRED CONTACT THE ENGINEER OF RECORD.
- 5. SUBSTANTIAL EFFORT HAS BEEN MADE TO PROVIDE ACCURATE DIMENSIONS AND MEASUREMENTS ON THE DRAWINGS TO ASSIST IN THE FABRICATION AND/OR PLACEMENT OF CONSTRUCTION ELEMENTS BUT IT IS THE SOLE RESPONSIBILITY OF THE CONTRACTOR TO FIELD VERIFY THE DIMENSIONS, MEASUREMENTS, AND/OR CLEARANCES SHOWN IN THE CONSTRUCTION DRAWINGS PRIOR TO FABRICATION OR CUTTING OF ANY NEW OR EXISTING CONSTRUCTION ELEMENTS. IF IT IS DETERMINED THAT THERE ARE DISCREPANCIES AND/OR CONFLICTS WITH THE CONSTRUCTION DRAWINGS THE ENGINEER OF RECORD IS TO BE NOTIFIED AS SOON AS POSSIBLE.
- 6. PRIOR TO THE SUBMISSION OF BIDS, THE BIDDING CONTRACTOR SHALL VISIT THE CELL SITE TO FAMILIARIZE WITH THE EXISTING CONDITIONS AND TO CONFIRM THAT THE WORK CAN BE ACCOMPLISHED AS SHOWN ON THE CONSTRUCTION DRAWINGS. ANY DISCREPANCY FOUND SHALL BE BROUGHT TO THE ATTENTION OF CARRIER POC AND TOWER OWNER.
- 7. ALL MATERIALS FURNISHED AND INSTALLED SHALL BE IN STRICT ACCORDANCE WITH ALL APPLICABLE CODES, REGULATIONS AND ORDINANCES. CONTRACTOR SHALL ISSUE ALL APPROPRIATE NOTICES AND COMPLY WITH ALL LAWS, ORDINANCES, RULES, REGULATIONS AND LAWFUL ORDERS OF ANY PUBLIC AUTHORITY REGARDING THE PERFORMANCE OF THE WORK. ALL WORK CARRIED OUT SHALL COMPLY WITH ALL APPLICABLE MUNICIPAL AND UTILITY COMPANY SPECIFICATIONS AND LOCAL JURISDICTIONAL CODES, ORDINANCES AND APPLICABLE REGULATIONS.
- 8. UNLESS NOTED OTHERWISE, THE WORK SHALL INCLUDE FURNISHING MATERIALS, EQUIPMENT, APPURTENANCES AND LABOR NECESSARY TO COMPLETE ALL INSTALLATIONS AS INDICATED ON THE DRAWINGS.
- 9. THE CONTRACTOR SHALL INSTALL ALL EQUIPMENT AND MATERIALS IN ACCORDANCE WITH MANUFACTURER'S RECOMMENDATIONS UNLESS SPECIFICALLY STATED OTHERWISE.
- 10. IF THE SPECIFIED EQUIPMENT CAN NOT BE INSTALLED AS SHOWN ON THESE DRAWINGS, THE CONTRACTOR SHALL PROPOSE AN ALTERNATIVE INSTALLATION FOR APPROVAL BY THE CARRIER AND TOWER OWNER PRIOR TO PROCEEDING WITH ANY SUCH CHANGE OF INSTALLATION.
- 11. CONTRACTOR IS TO PERFORM A SITE INVESTIGATION, BEFORE SUBMITTING BIDS, TO DETERMINE THE BEST ROUTING OF ALL CONDUITS FOR POWER, AND TELCO AND FOR GROUNDING CABLES AS SHOWN IN THE POWER, TELCO, AND GROUNDING PLAN DRAWINGS
- 12. THE CONTRACTOR SHALL PROTECT EXISTING IMPROVEMENTS, PAVEMENTS, CURBS, LANDSCAPING AND STRUCTURES. ANY DAMAGED PART SHALL BE REPAIRED AT CONTRACTOR'S EXPENSE TO THE SATISFACTION OF DISH Wireless L.L.C. AND TOWER OWNER
- 13. CONTRACTOR SHALL LEGALLY AND PROPERLY DISPOSE OF ALL SCRAP MATERIALS SUCH AS COAXIAL CABLES AND OTHER ITEMS REMOVED FROM THE EXISTING FACILITY. ANTENNAS REMOVED SHALL BE RETURNED TO THE OWNER'S DESIGNATED LOCATION.
- 14. CONTRACTOR SHALL LEAVE PREMISES IN CLEAN CONDITION. TRASH AND DEBRIS SHOULD BE REMOVED FROM SITE ON A DAILY BASIS.



5701 SOUTH SANTA FE DRIVE LITTLETON, CO 80120







B&T ENGINEERING, INC. PEC.0001564 Expires 2/10/22

IT IS A VIOLATION OF LAW FOR ANY PERSON, UNLESS THEY ARE ACTING UNDER THE DIRECTION OF A LICENSED PROFESSIONAL ENGINEER, TO ALTER THIS DOCUMENT.

-	DRAWN	BY:	CHECKED	BY:	APPROVED	BY:
1	RY		YF		YF	

RFDS REV #:

CONSTRUCTION DOCUMENTS

ΙГ	SUBMITTALS				
R	REV	DATE	DESCRIPTION		
Г	Α	8/2/21	ISSUED FOR REVIEW		
Г	0	10/15/21	ISSUED FOR CONSTRUCTION		
E					
L					
L					
L					
L					
Г	A&E PROJECT NUMBER				
I I					

153552.001.01

DISH Wireless L.L.C. PROJECT INFORMATION

BOBOSO0021A 166 PAWCATUCK AVE STONINGTON, CT 06378

SHEET TITLE

GENERAL NOTES

SHEET NUMBER

CONCRETE, FOUNDATIONS, AND REINFORCING STEEL:

- 1. ALL CONCRETE WORK SHALL BE IN ACCORDANCE WITH THE ACI 301, ACI 318, ACI 336, ASTM A184, ASTM A185 AND THE DESIGN AND CONSTRUCTION SPECIFICATION FOR CAST—IN—PLACE CONCRETE.
- 2. UNLESS NOTED OTHERWISE, SOIL BEARING PRESSURE USED FOR DESIGN OF SLABS AND FOUNDATIONS IS ASSUMED TO BE 1000 psf.
- 3. ALL CONCRETE SHALL HAVE A MINIMUM COMPRESSIVE STRENGTH (I'c) OF 3000 psi AT 28 DAYS, UNLESS NOTED OTHERWISE. NO MORE THAN 90 MINUTES SHALL ELAPSE FROM BATCH TIME TO TIME OF PLACEMENT UNLESS APPROVED BY THE ENGINEER OF RECORD. TEMPERATURE OF CONCRETE SHALL NOT EXCEED 90'F AT TIME OF PLACEMENT.
- 4. CONCRETE EXPOSED TO FREEZE-THAW CYCLES SHALL CONTAIN AIR ENTRAINING ADMIXTURES. AMOUNT OF AIR ENTRAINMENT TO BE BASED ON SIZE OF AGGREGATE AND F3 CLASS EXPOSURE (VERY SEVERE). CEMENT USED TO BE TYPE II PORTLAND CEMENT WITH A MAXIMUM WATER-TO-CEMENT RATIO (W/C) OF 0.45.
- 5. ALL STEEL REINFORCING SHALL CONFORM TO ASTM A615. ALL WELDED WIRE FABRIC (WWF) SHALL CONFORM TO ASTM A185. ALL SPLICES SHALL BE CLASS "B" TENSION SPLICES, UNLESS NOTED OTHERWISE. ALL HOOKS SHALL BE STANDARD 90 DEGREE HOOKS, UNLESS NOTED OTHERWISE. YIELD STRENGTH (Fy) OF STANDARD DEFORMED BARS ARE AS FOLLOWS:

#4 BARS AND SMALLER 40 ksi

#5 BARS AND LARGER 60 ksi

- 6. THE FOLLOWING MINIMUM CONCRETE COVER SHALL BE PROVIDED FOR REINFORCING STEEL UNLESS SHOWN OTHERWISE ON DRAWINGS:
- CONCRETE CAST AGAINST AND PERMANENTLY EXPOSED TO EARTH 3"
- . CONCRETE EXPOSED TO EARTH OR WEATHER:
- #6 BARS AND LARGER 2"
- #5 BARS AND SMALLER 1-1/2"
- CONCRETE NOT EXPOSED TO EARTH OR WEATHER:
- SLAB AND WALLS 3/4"
- BEAMS AND COLUMNS 1-1/2"
- 7. A TOOLED EDGE OR A 3/4" CHAMFER SHALL BE PROVIDED AT ALL EXPOSED EDGES OF CONCRETE, UNLESS NOTED OTHERWISE, IN ACCORDANCE WITH ACI 301 SECTION 4.2.4.

ELECTRICAL INSTALLATION NOTES:

- 1. ALL ELECTRICAL WORK SHALL BE PERFORMED IN ACCORDANCE WITH THE PROJECT SPECIFICATIONS, NEC AND ALL APPLICABLE FEDERAL, STATE, AND LOCAL CODES/ORDINANCES.
- 2. CONDUIT ROUTINGS ARE SCHEMATIC. CONTRACTOR SHALL INSTALL CONDUITS SO THAT ACCESS TO EQUIPMENT IS NOT BLOCKED AND TRIP HAZARDS ARE ELIMINATED.
- 3. WIRING, RACEWAY AND SUPPORT METHODS AND MATERIALS SHALL COMPLY WITH THE REQUIREMENTS OF THE NEC.
- 4. ALL CIRCUITS SHALL BE SEGREGATED AND MAINTAIN MINIMUM CABLE SEPARATION AS REQUIRED BY THE NEC.
- 4.1. ALL EQUIPMENT SHALL BEAR THE UNDERWRITERS LABORATORIES LABEL OF APPROVAL, AND SHALL CONFORM TO REQUIREMENT OF THE NATIONAL ELECTRICAL CODE.
- 4.2. ALL OVERCURRENT DEVICES SHALL HAVE AN INTERRUPTING CURRENT RATING THAT SHALL BE GREATER THAN THE SHORT CIRCUIT CURRENT TO WHICH THEY ARE SUBJECTED, 22,000 AIC MINIMUM. VERIFY AVAILABLE SHORT CIRCUIT CURRENT DOES NOT EXCEED THE RATING OF ELECTRICAL EQUIPMENT IN ACCORDANCE WITH ARTICLE 110.24 NEC OR THE MOST CURRENT ADOPTED CODE PRE THE GOVERNING JURISDICTION.
- 5. EACH END OF EVERY POWER PHASE CONDUCTOR, GROUNDING CONDUCTOR, AND TELCO CONDUCTOR OR CABLE SHALL BE LABELED WITH COLOR—CODED INSULATION OR ELECTRICAL TAPE (3M BRAND, 1/2" PLASTIC ELECTRICAL TAPE WITH UV PROTECTION, OR EQUAL). THE IDENTIFICATION METHOD SHALL CONFORM WITH NEC AND OSHA.
- 6. ALL ELECTRICAL COMPONENTS SHALL BE CLEARLY LABELED WITH LAMICOID TAGS SHOWING THEIR RATED VOLTAGE, PHASE CONFIGURATION, WIRE CONFIGURATION, POWER OR AMPACITY RATING AND BRANCH CIRCUIT ID NUMBERS (i.e. PANEL BOARD AND CIRCUIT ID'S).
- 7. PANEL BOARDS (ID NUMBERS) SHALL BE CLEARLY LABELED WITH PLASTIC LABELS.
- 8. TIE WRAPS ARE NOT ALLOWED.
- 9. ALL POWER AND EQUIPMENT GROUND WIRING IN TUBING OR CONDUIT SHALL BE SINGLE COPPER CONDUCTOR (#14 OR LARGER) WITH TYPE THHW, THWN, THWN-2, XHHW, XHHW-2, THW, THW-2, RHW, OR RHW-2 INSULATION UNLESS OTHERWISE SPECIFIED.
- 10. SUPPLEMENTAL EQUIPMENT GROUND WIRING LOCATED INDOORS SHALL BE SINGLE COPPER CONDUCTOR (#6 OR LARGER) WITH TYPE THHW, THWN, THWN-2, XHHW, XHHW-2, THW, THW-2, RHW, OR RHW-2 INSULATION UNLESS OTHERWISE SPECIFIED.
- 11. POWER AND CONTROL WIRING IN FLEXIBLE CORD SHALL BE MULTI-CONDUCTOR, TYPE SOOW CORD (#14 OR LARGER) UNLESS OTHERWISE SPECIFIED.
- 12. POWER AND CONTROL WIRING FOR USE IN CABLE TRAY SHALL BE MULTI-CONDUCTOR, TYPE TC CABLE (#14 OR LARGER), WITH TYPE THHW, THWN, THWN-2, XHHW, XHHW-2, THW, THW-2, RHW, OR RHW-2 INSULATION UNLESS OTHERWISE SPECIFIED.
- 13. ALL POWER AND GROUNDING CONNECTIONS SHALL BE CRIMP—STYLE, COMPRESSION WIRE LUGS AND WIRE NUTS BY THOMAS AND BETTS (OR EQUAL). LUGS AND WIRE NUTS SHALL BE RATED FOR OPERATION NOT LESS THAN 75° C (90° C IF AVAILABLE).
- 14. RACEWAY AND CABLE TRAY SHALL BE LISTED OR LABELED FOR ELECTRICAL USE IN ACCORDANCE WITH NEMA, UL, ANSI/IEEE AND NEC.
- 15. ELECTRICAL METALLIC TUBING (EMT), INTERMEDIATE METAL CONDUIT (IMC), OR RIGID METAL CONDUIT (RMC) SHALL BE USED FOR EXPOSED INDOOR LOCATIONS.

- ELECTRICAL METALLIC TUBING (EMT) OR METAL-CLAD CABLE (MC) SHALL BE USED FOR CONCEALED INDOOR LOCATIONS.
- 17. SCHEDULE 40 PVC UNDERGROUND ON STRAIGHTS AND SCHEDULE 80 PVC FOR ALL ELBOWS/90s AND ALL APPROVED ABOVE GRADE PVC CONDUIT.
- 18. LIQUID-TIGHT FLEXIBLE METALLIC CONDUIT (LIQUID-TITE FLEX) SHALL BE USED INDOORS AND OUTDOORS, WHERE VIBRATION OCCURS OR FLEXIBILITY IS NEEDED.
- 19. CONDUIT AND TUBING FITTINGS SHALL BE THREADED OR COMPRESSION—TYPE AND APPROVED FOR THE LOCATION USED. SET SCREW FITTINGS ARE NOT ACCEPTABLE.
- 20. CABINETS, BOXES AND WIRE WAYS SHALL BE LABELED FOR ELECTRICAL USE IN ACCORDANCE WITH NEMA, UL, ANSI/IEEE AND THE NEC.
- 21. WIREWAYS SHALL BE METAL WITH AN ENAMEL FINISH AND INCLUDE A HINGED COVER, DESIGNED TO SWING OPEN DOWNWARDS (WIREMOLD SPECMATE WIREWAY).
- 22. SLOTTED WIRING DUCT SHALL BE PVC AND INCLUDE COVER (PANDUIT TYPE E OR EQUAL).
- 23. CONDUITS SHALL BE FASTENED SECURELY IN PLACE WITH APPROVED NON-PERFORATED STRAPS AND HANGERS. EXPLOSIVE DEVICES (i.e. POWDER-ACTUATED) FOR ATTACHING HANGERS TO STRUCTURE WILL NOT BE PERMITTED. CLOSELY FOLLOW THE LINES OF THE STRUCTURE, MAINTAIN CLOSE PROXIMITY TO THE STRUCTURE AND KEEP CONDUITS IN TIGHT ENVELOPES. CHANGES IN DIRECTION TO ROUTE AROUND OBSTACLES SHALL BE MADE WITH CONDUIT OUTLET BODIES. CONDUIT SHALL BE INSTALLED IN A NEAT AND WORKMANLIKE MANNER. PARALLEL AND PERPENDICULAR TO STRUCTURE WALL AND CEILING LINES. ALL CONDUIT SHALL BE FISHED TO CLEAR OBSTRUCTIONS. ENDS OF CONDUITS SHALL BE TEMPORARILY CAPPED FLUSH TO FINISH GRADE TO PREVENT CONCRETE, PLASTER OR DIRT FROM ENTERING. CONDUITS SHALL BE RIGIDLY CLAMPED TO BOXES BY GALVANIZED MALLEABLE IRON BUSHING ON INSIDE AND GALVANIZED MALLEABLE IRON LOCKNUT ON OUTSIDE AND INSIDE.
- 24. EQUIPMENT CABINETS, TERMINAL BOXES, JUNCTION BOXES AND PULL BOXES SHALL BE GALVANIZED OR EPOXY-COATED SHEET STEEL. SHALL MEET OR EXCEED UL 50 AND BE RATED NEMA 1 (OR BETTER) FOR INTERIOR LOCATIONS AND NEMA 3 (OR BETTER) FOR EXTERIOR LOCATIONS.
- 25. METAL RECEPTACLE, SWITCH AND DEVICE BOXES SHALL BE GALVANIZED, EPOXY—COATED OR NON—CORRODING; SHALL MEET OR EXCEED UL 514A AND NEMA OS 1 AND BE RATED NEMA 1 (OR BETTER) FOR INTERIOR LOCATIONS AND WEATHER PROTECTED (WP OR BETTER) FOR EXTERIOR LOCATIONS.
- 26. NONMETALLIC RECEPTACLE, SWITCH AND DEVICE BOXES SHALL MEET OR EXCEED NEMA OS 2 (NEWEST REVISION) AND BE RATED NEMA 1 (OR BETTER) FOR INTERIOR LOCATIONS AND WEATHER PROTECTED (WP OR BETTER) FOR EXTERIOR LOCATIONS.
- 27. THE CONTRACTOR SHALL NOTIFY AND OBTAIN NECESSARY AUTHORIZATION FROM THE CARRIER AND/OR DISH Wireless L.L.C. AND TOWER OWNER BEFORE COMMENCING WORK ON THE AC POWER DISTRIBUTION PANELS.
- 28. THE CONTRACTOR SHALL PROVIDE NECESSARY TAGGING ON THE BREAKERS, CABLES AND DISTRIBUTION PANELS IN ACCORDANCE WITH THE APPLICABLE CODES AND STANDARDS TO SAFEGUARD LIFE AND PROPERTY.
- 29. INSTALL LAMICOID LABEL ON THE METER CENTER TO SHOW "DISH Wireless L.L.C.".
- 30. ALL EMPTY/SPARE CONDUITS THAT ARE INSTALLED ARE TO HAVE A METERED MULE TAPE PULL CORD INSTALLED.



5701 SOUTH SANTA FE DRIVE LITTLETON, CO 80120







B&T ENGINEERING, INC. PEC.0001564 Expires 2/10/22

IT IS A VIOLATION OF LAW FOR ANY PERSON, UNLESS THEY ARE ACTING UNDER THE DIRECTION OF A LICENSED PROFESSIONAL ENGINEER, TO ALTER THIS DOCUMENT.

П	DRAWN BY:	CHECKED BY:	APPROVED	BY
ı	RY	YF	YF	

RFDS REV #:

CONSTRUCTION DOCUMENTS

Г	SUBMITTALS			
ı	REV	DATE	DESCRIPTION	
ı	Α	8/2/21	ISSUED FOR REVIEW	
ı	0	10/15/21	ISSUED FOR CONSTRUCTION	
ı				
ı				
ı				
ı				
L				
		A&E F	PROJECT NUMBER	

153552.001.01

DISH Wireless L.L.C

BOBOSO0021A 166 PAWCATUCK AVE STONINGTON, CT 06378

SHEET TITLE

GENERAL NOTES

SHEET NUMBER

GROUNDING NOTES:

- 1. ALL GROUND ELECTRODE SYSTEMS (INCLUDING TELECOMMUNICATION, RADIO, LIGHTNING PROTECTION AND AC POWER GES'S) SHALL BE BONDED TOGETHER AT OR BELOW GRADE, BY TWO OR MORE COPPER BONDING CONDUCTORS IN ACCORDANCE WITH THE NEC.
- 2. THE CONTRACTOR SHALL PERFORM IEEE FALL—OF—POTENTIAL RESISTANCE TO EARTH TESTING (PER IEEE 1100 AND 81) FOR GROUND ELECTRODE SYSTEMS, THE CONTRACTOR SHALL FURNISH AND INSTALL SUPPLEMENTAL GROUND ELECTRODES AS NEEDED TO ACHIEVE A TEST RESULT OF 5 OHMS OR LESS.
- 3. THE CONTRACTOR IS RESPONSIBLE FOR PROPERLY SEQUENCING GROUNDING AND UNDERGROUND CONDUIT INSTALLATION AS TO PREVENT ANY LOSS OF CONTINUITY IN THE GROUNDING SYSTEM OR DAMAGE TO THE CONDUIT AND PROVIDE TESTING RESULTS.
- 4. METAL CONDUIT AND TRAY SHALL BE GROUNDED AND MADE ELECTRICALLY CONTINUOUS WITH LISTED BONDING FITTINGS OR BY BONDING ACROSS THE DISCONTINUITY WITH #6 COPPER WIRE UL APPROVED GROUNDING TYPE CONDUIT CLAMPS.
- 5. METAL RACEWAY SHALL NOT BE USED AS THE NEC REQUIRED EQUIPMENT GROUND CONDUCTOR. STRANDED COPPER CONDUCTORS WITH GREEN INSULATION, SIZED IN ACCORDANCE WITH THE NEC, SHALL BE FURNISHED AND INSTALLED WITH THE POWER CIRCUITS TO BTS FOUIPMENT.
- 6. EACH CABINET FRAME SHALL BE DIRECTLY CONNECTED TO THE MASTER GROUND BAR WITH GREEN INSULATED SUPPLEMENTAL EQUIPMENT GROUND WIRES, #6 STRANDED COPPER OR LARGER FOR INDOOR BTS; #2 BARE SOLID TINNED COPPER FOR OUTDOOR BTS.
- 7. CONNECTIONS TO THE GROUND BUS SHALL NOT BE DOUBLED UP OR STACKED BACK TO BACK CONNECTIONS ON OPPOSITE SIDE OF THE GROUND BUS ARE PERMITTED.
- 8. ALL EXTERIOR GROUND CONDUCTORS BETWEEN EQUIPMENT/GROUND BARS AND THE GROUND RING SHALL BE #2 SOLID TINNED COPPER UNLESS OTHERWISE INDICATED.
- 9. ALUMINUM CONDUCTOR OR COPPER CLAD STEEL CONDUCTOR SHALL NOT BE USED FOR GROUNDING CONNECTIONS.
- 10. USE OF 90° BENDS IN THE PROTECTION GROUNDING CONDUCTORS SHALL BE AVOIDED WHEN 45° BENDS CAN BE ADEQUATELY SUPPORTED.
- 11. EXOTHERMIC WELDS SHALL BE USED FOR ALL GROUNDING CONNECTIONS BELOW GRADE.
- 12. ALL GROUND CONNECTIONS ABOVE GRADE (INTERIOR AND EXTERIOR) SHALL BE FORMED USING HIGH PRESS CRIMPS.
- 13. COMPRESSION GROUND CONNECTIONS MAY BE REPLACED BY EXOTHERMIC WELD CONNECTIONS.
- 14. ICE BRIDGE BONDING CONDUCTORS SHALL BE EXOTHERMICALLY BONDED OR BOLTED TO THE BRIDGE AND THE TOWER GROUND BAR.
- 15. APPROVED ANTIOXIDANT COATINGS (i.e. CONDUCTIVE GEL OR PASTE) SHALL BE USED ON ALL COMPRESSION AND BOLTED GROUND CONNECTIONS.
- 16. ALL EXTERIOR GROUND CONNECTIONS SHALL BE COATED WITH A CORROSION RESISTANT MATERIAL.
- 17. MISCELLANEOUS ELECTRICAL AND NON-ELECTRICAL METAL BOXES, FRAMES AND SUPPORTS SHALL BE BONDED TO THE GROUND RING, IN ACCORDANCE WITH THE NEC.
- 18. BOND ALL METALLIC OBJECTS WITHIN 6 ft OF MAIN GROUND RING WITH (1) #2 BARE SOLID TINNED COPPER GROUND CONDUCTOR
- 19. GROUND CONDUCTORS USED FOR THE FACILITY GROUNDING AND LIGHTNING PROTECTION SYSTEMS SHALL NOT BE ROUTED THROUGH METALLIC OBJECTS THAT FORM A RING AROUND THE CONDUCTOR, SUCH AS METALLIC CONDUITS, METAL SUPPORT CLIPS OR SLEEVES THROUGH WALLS OR FLOORS. WHEN IT IS REQUIRED TO BE HOUSED IN CONDUIT TO MEET CODE REQUIREMENTS OR LOCAL CONDITIONS, NON-METALLIC MATERIAL SUCH AS PVC CONDUIT SHALL BE USED. WHERE USE OF METAL CONDUIT IS UNAVOIDABLE (i.e., NONMETALLIC CONDUIT PROHIBITED BY LOCAL CODE) THE GROUND CONDUCTOR SHALL BE BONDED TO EACH END OF THE METAL CONDUIT.
- 20. ALL GROUNDS THAT TRANSITION FROM BELOW GRADE TO ABOVE GRADE MUST BE #2 BARE SOLID TINNED COPPER IN 3/4"
 NON—METALLIC, FLEXIBLE CONDUIT FROM 24" BELOW GRADE TO WITHIN 3" TO 6" OF CAD—WELD TERMINATION POINT. THE EXPOSED END
 OF THE CONDUIT MUST BE SEALED WITH SILICONE CAULK. (ADD TRANSITIONING GROUND STANDARD DETAIL AS WELL).
- 21. BUILDINGS WHERE THE MAIN GROUNDING CONDUCTORS ARE REQUIRED TO BE ROUTED TO GRADE, THE CONTRACTOR SHALL ROUTE TWO GROUNDING CONDUCTORS FROM THE ROOFTOP, TOWERS, AND WATER TOWERS GROUNDING RING, TO THE EXISTING GROUNDING SYSTEM, THE GROUNDING CONDUCTORS SHALL NOT BE SMALLER THAN 2/O COPPER. ROOFTOP GROUNDING RING SHALL BE BONDED TO THE EXISTING GROUNDING SYSTEM, THE BUILDING STEEL COLUMNS, LIGHTNING PROTECTION SYSTEM, AND BUILDING MAIN WATER LINE (FERROUS OR NONFERROUS METAL PIPING ONLY). DO NOT ATTACH GROUNDING TO FIRE SPRINKLER SYSTEM PIPES.



5701 SOUTH SANTA FE DRIVE LITTLETON, CO 80120



10 PRESIDENTIAL WAY



B+T GRP
1717 S. BOULDER
SUITE 300
TULSA, OK 74119
PH: (918) 587-4630
www.btgrp.com



B&T ENGINEERING, INC. PEC.0001564 Expires 2/10/22

IT IS A VIOLATION OF LAW FOR ANY PERSON, UNLESS THEY ARE ACTING UNDER THE DIRECTION OF A LICENSED PROFESSIONAL ENGINEER, TO ALTER THIS DOCUMENT.

DRAWN	BY:	CHECKED	BY:	APPROVED	BY:
RY		YF		YF	

RFDS REV #:

CONSTRUCTION DOCUMENTS

ı	П	SUBMITTALS			
ı		REV	DATE	DESCRIPTION	
ı	П	Α	8/2/21	ISSUED FOR REVIEW	
ı	П	0	10/15/21	ISSUED FOR CONSTRUCTION	
ı	П				
ı	П				
ı	П				
ı	П				
ı					
- 1					

A&E PROJECT NUMBER

153552.001.01

DISH Wireless L.L PROJECT INFORMAT

BOBOSO0021A 166 PAWCATUCK AVE STONINGTON, CT 06378

SHEET TITLE

GENERAL NOTES

SHEET NUMBER