

TOTALLY COMMITTED.

December 15, 2021

Melanie A. Bachman Executive Director Connecticut Siting Council 10 Franklin Square New Britain, CT 06051

Notice of Exempt Modification Facility Address: 80 Shuttle Meadow Road, Southington, CT Facility Coordinates: (N) 41.63858333, (W) -72.8411

Dear Ms. Bachman,

American Tower (ATC) currently maintains an Existing Cellular Tower Facility (150' Monopole) at 80 Shuttle Meadow Road, Southington, CT 06371. The property is owned by Southern New England Telephone Co. c/o American Tower Land Management. American Tower (ATC) now intends to install an 80kw Generator within the leased, fenced ground space area of the facility. The purpose of the generator installation is to allow for a shared back up emergency power option for its current (and future) wireless carrier tenants.

Because this proposed generator is within the existing, approved compound space, and the applicant is NOT requesting expansion of ground space beyond the approved conditions, please accept this letter, as notification pursuant to Regulations of Connecticut State Agencies @16-50j-73, for construction that constitutes an exempt modification pursuant to R.C.S.A. @16-50j-72(b)(2). IN accordance with R.C.S.A.@16-50j-73, a copy of this letter is being sent to Victoria Triano, Chairwoman of the Town of Southington, Maryellen Edwards, Director of Planning and Community Development, as well as the property/tower owner.



ATTACHMENT A

The planned modifications to the facility fall squarely within those activities explicitly provided for in R.C.S.A @ 16-50j-72(b)(2).

- 1. The proposed modifications will not result in an increase in the height of the existing structure.
- 2. The proposed modifications will not require the extension of the site boundary
- 3. The proposed modifications will not increase noise levels at the facility by six decibels or more, or to levels that exceed state and local criteria.
- 4. The operation of the generator back up power facility will not increase radio frequency emissions at the facility to the level at or above the Federal Communications Commission safety standard.
- 5. The proposed modifications will not cause a change or alteration in the physical or environmental characteristics of the site.
- 6. The existing structure and its foundation can support the proposed loading if the tower will be reenforced to support them. <<< NOTE This condition is N/A. The proposed Generator is based on the ground, and not associated or loaded onto the tower or foundation.

For the foregoing reasons, American Tower (ATC) respectfully submits that the proposed modifications to the above referenced telecommunications facility constitute an exempt modification under R.C.S.A. @16-50j-72(b)(2).

If you have any questions, I can be reached at mweber@nbcllc.com or 215.416.0363

Best Regards,

Margie Weber

Attachments

cc: Victoria Triano, Town of Southington
Maryellen Edwards, Town of Southington
American Tower (ATC), Property Owner/Tower Owner



LETTER OF AUTHORIZATION

ATC SITE#/NAME/PROJECT: 302475 / Sttn - Southington / 13692115

SITE ADDRESS: 80 SHUTTLE MEADOW RD, SOUTHINGTON, CT 06489-1318

APN: SOUT-000184-000000-000019

LICENSEE: T-MOBILE

I, Margaret Robinson, Senior Counsel for American Tower*, owner of the tower facility located at the address identified above (the "Tower Facility"), do hereby authorize T-MOBILE, its successors and assigns, and/or its agent, (collectively, the "Licensee") to act as American Tower's non-exclusive agent for the sole purpose of filing and consummating any land-use or building permit application(s) as may be required by the applicable permitting authorities for Licensee's telecommunications' installation.

We understand that this application may be denied, modified or approved with conditions. The above authorization is limited to the acceptance by Licensee only of conditions related to Licensee's installation and any such conditions of approval or modifications will be Licensee's sole responsibility.

Signature:

Print Name: Margaret Robinson

Senior Counsel
American Tower*

NOTARY BLOCK

Commonwealth of MASSACHUSETTS County of Middlesex

This instrument was acknowledged before me by Margaret Robinson, Senior Counsel for American Tower*, personally known to me (or proved to me on the basis of satisfactory evidence) to be the person whose name is subscribed to the within instrument and acknowledged to me that he executed the same.

WITNESS my hand and official seal, this 11th day of November, 2021.

NOTARY SEAL

MELISSA ANN METZLER
Notary Public
Commonwealth of Massachusetts
My Commission Expires March 14, 2025

Notary Public My Commission Expires: March 14, 2025

*American Tower includes all affiliates and subsidiaries of American Tower Corporation.

80 SHUTTLE MEADOW RD

Location 80 SHUTTLE MEADOW RD **Mblu** 184//019//

Acct# 11918 Owner SOUTHERN NEW ENGLAND

TELEPHONE CO

Assessment \$176,420 **Appraisal** \$252,030

PID 16574 Building Count 1

Current Value

Appraisal				
Valuation Year Improvements Land Total				
2020	\$8,010	\$244,020	\$252,030	
	Assessment			
Valuation Year	Improvements	Land	Total	
2020	\$5,610	\$170,810	\$176,420	

Owner of Record

Owner SOUTHERN NEW ENGLAND TELEPHONE CO Sale Price \$0

Co-Owner SITE# 302475 - STTN SOUTHINGTON CT Certificate

 Address
 C/O AMERICAN TOWER LAND MNGMT
 Book & Page
 0331/0320

 10 PRESIDENTIAL WAY
 Sale Date
 02/14/1983

 WOBURN, MA 01801
 Instrument
 25

Ownership History

Ownership History					
Owner	Sale Price	Certificate	Book & Page	Instrument	Sale Date
SOUTHERN NEW ENGLAND TELEPHONE CO	\$0		0331/0320	25	02/14/1983

Building Information

Building 1 : Section 1

Year Built:

Living Area: 0

Building Percent Good:

Bu	lding Attributes
Field	Description

Style	Vacant w/OB
Model	
Grade:	
Stories	
Occupancy	
Exterior Wall 1	
Exterior Wall 2	
Roof Structure	
Roof Cover	
Interior Wall 1	
Interior Wall 2	
Interior Flr 1	
Interior Flr 2	
Heat Fuel	
Heat Type:	
AC Type:	
Total Bedrooms:	
Full Bthrms:	
Half Baths:	
Extra Fixtures	
Total Rooms:	
Bath Style:	
Kitchen Style:	
Total Kitchens	
Fireplaces	
Whirlpool Tubs	
Fin Bsmt Area	
Fin Bsmt Quality	
Bsmt Garages	
Bsmt Type	
Attic Type	
Cath Ceiling	
Fndtn Cndtn	
Basement	

Building Photo



184 019 05/24/2015

 $(http://images.vgsi.com/photos2/SouthingtonCTPhotos// \00 \04 \94 \50.JPG)$

Building Layout

(ParcelSketch.ashx?pid=16574&bid=16574)

Building Sub-Areas (sq ft)	<u>Legend</u>
No Data for Building Sub-Areas	

Extra Features

Extra Features	<u>Legend</u>
No Data for Extra Features	

Land

Land Use Land Line Valuation

Use Code 433V

Description Radio, Television Trans Ld

Zone R-80 **Alt Land Appr** No

Category

Size (Acres) 0.17

Depth


Outbuildings

	Outbuildings <u>Lege</u>				
Code	Description	Sub Code	Sub Description	Size	Bldg #
FN1	Fence - Chain			400.00 L.F.	1
SHD1	Shed	MS	Masonry	572.00 S.F.	1

Valuation History

Appraisal					
Valuation Year	Improvements	Land	Total		
2020	\$8,010	\$244,020	\$252,030		
2019	\$18,560	\$227,860	\$246,420		
2018	\$18,560	\$227,860	\$246,420		
2017	\$18,560	\$227,860	\$246,420		
2016	\$18,560	\$227,860	\$246,420		

Assessment				
Valuation Year	Improvements	Land	Total	
2020	\$5,610	\$170,810	\$176,420	
2019	\$12,990	\$159,500	\$172,490	
2018	\$12,990	\$159,500	\$172,490	
2017	\$12,990	\$159,500	\$172,490	
2016	\$12,990	\$159,500	\$172,490	

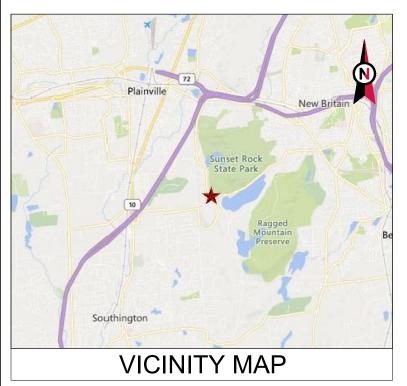



ATC SITE NAME: STTN - SOUTHINGTON

SITE NUMBER: 302475

SITE ADDRESS: 80 SHUTTLE MEADOW RD

SOUTHINGTON, CT 06489



LOCATION MAP

SHARED GENERATOR PROGRAM ANCHOR TENANT

COMPLIANCE CODE	PROJECT SUMMARY	PROJECT DESCRIPTION	SHEET INDEX				
ALL WORK SHALL BE PERFORMED AND MATERIALS INSTALLED IN ACCORDANCE WITH THE CURRENT EDITIONS OF THE	SITE ADDRESS:	THE PROPOSED PROJECT INSTALLS AN OPTIONAL STANDBY GENERATOR SYSTEM, AUTOMATIC TRANSFER SWITCH,		DESCRIPTION:	REV:	DATE:	BY:
FOLLOWING CODES AS ADOPTED BY THE LOCAL GOVERNMENT AUTHORITIES. NOTHING IN THESE PLANS IS	80 SHUTTLE MEADOW RD SOUTHINGTON, CT 06489	GENERATOR AUXILIARY POWER DISTRIBUTION, AND REMOTE MONITORING COMMUNICATIONS CIRCUITRY FOR A	G-001	TITLE SHEET	0	07/27/21	PL
TO BE CONSTRUED TO PERMIT WORK NOT CONFORMING TO THESE CODES.	COUNTY: HARTFORD	COMMUNICATION TOWER TENANT.	G-002	GENERAL NOTES	0	07/27/21	PL
INTERNATIONAL BUILDING CODE (IBC)	GEOGRAPHIC COORDINATES:	PROJECT NOTES	C-101	SITE PLAN	0	07/27/21	PL
2. NATIONAL ELECTRIC CODE (NEC)	LATITUDE: 41.63858333		C-501	CONCRETE PAD DETAILS	0	07/27/21	PL
LOCAL BUILDING CODE CITY/COUNTY ORDINANCES	LONGITUDE: -72.8411 GROUND ELEVATION: 489' AMSL	THE FACILITY IS UNMANNED.	E-601	ELECTRICAL ONE-LINE AND WIRING DETAILS	0	07/27/21	PL
4. CITT/COUNTY ORDINANCES		A TECHNICIAN WILL VISIT THE SITE APPROXIMATELY ONCE A MONTH FOR ROUTINE INSPECTION AND MAINTENANCE.	R-601	SUPPLEMENTAL		07727721	
	ZONING INFORMATION: JURISDICTION: TOWN OF SOUTHINGTON PARCEL NUMBER: SOUT-000184-00000-000019	THE PROJECT WILL NOT RESULT IN ANY SIGNIFICANT LAND DISTURBANCE OR EFFECT OF STORM WATER DRAINAGE.	R-601	SUPPLEMENTAL			
		NO SANITARY SEWER, POTABLE WATER OR TRASH DISPOSAL IS REQUIRED.					
	PROJECT TEAM	5. HANDICAP ACCESS IS NOT REQUIRED.					
	ATC REGIONAL NETWORK DEVELOPMENT PROJECT MANAGER: MICHAEL JOYCE (508) 326-5522	6. THE PROJECT DEPICTED IN THESE PLANS QUALIFIES AS AN ELIGIBLE FACILITIES REQUEST ENTITLED TO EXPEDITED REVIEW UNDER 47 U.S.C. § 1455(A) AS A MODIFICATION OF AN EXISTING WIRELESS TOWER THAT INVOLVES THE COLLOCATION, REMOVAL, AND/OR					
UTILITY COMPANIES	ATC NETWORK OPERATIONS CENTER: (877) 518-6937	NOT A CURRENANTIAL CHANCE UNDER 4 6400 (R)/7)					
POWER COMPANY: EVERSOURCE PHONE: (877) 659-6326	TOWER OWNER: AMERICAN TOWER	PROJECT LOCATION DIRECTIONS					
TELEPHONE COMPANY: FRONTIER COMMUNICATIONS PHONE: (800) 376-6843	10 PRESIDENTIAL WAY WOBURN, MA 01801 PROPERTY OWNER:						
811	AMERICAN TOWER 10 PRESIDENTIAL WAY WOBURN, MA 01801	FROM HARTFORD: 1-84 W TOWARD WATERBURY11.9 MI4.SLIGHT RIGHT AT CT-72 W (SIGNS FOR BRISTOL/CT-72 W/PLAINVILLE)0.6 MI5.TAKE EXIT 2 TOWARD CT-372/NEW BRITAIN AVE/PLAINVILLE0.3 MI6.TURN RIGHT AT CT-372/NEW					
Know what's below.	ENGINEERED BY: ATC TOWER SERVICES 3500 REGENCY PARKWAY SUITE 100	BRITAIN AVE0.5 MI7.TURN RIGHT AT CROOKED ST0.4 MI8.TURN RIGHT AT WHITE OAK AVE0.1 MI9.TURN LEFT AT LEDGE RD1.3 MI10.CONTINUE ON SHUTTLE MEADOW RD					
Call before you dig.	CARY, NC 27518						



A.T. ENGINEERING SERVICE, PLLC

3500 REGENCY PARKWAY SUITE 100 CARY, NC 27518 PHONE: (919) 468-0112 COA: P-1177

THESE DRAWINGS AND/OR THE ACCOMPANYING
SPECIFICATION AS INSTRUMENTS OR SERVICE ARE THE
EXCLUSIVE PROPERTY OF AMERICAN TOWER. THEIR USE AND
PUBLICATION SHALL BE RESTRICTED TO THE ORIGINAL SITE
FOR WHICH THEY ARE PREPARED, ANY USE OR DISCLOSURE
OTHER THAN THAT WHICH RELATES TO AMERICAN TOWER OR
THE SPECIFIED CARRIER IS STRICTLY PROHIBITED. TITLE TO
THESE DOCUMENTS SHALL REMAIN THE PROPERTY OF
AMERICAN TOWER WHETHER OR NOT THE PROJECT IS
EXECUTED. NEITHER THE ARCHITECT NOR THE ENGINEER WILL
BE PROVIDING ON-SITE CONSTRUCTION REVIEW OF THIS
PROJECT. CONTRACTOR(S) MUST VERIFY ALL DIMENSIONS AND
ADVISE AMERICAN TOWER OF ANY DISCREPANCIES. ANY PRIOR
ISSUANCE OF THIS DRAWING IS SUPERSEDED BY THE LATEST
VERSION ON FILE WITH AMERICAN TOWER.

I	REV	EV. DESCRIPTION		DATE
I	\triangle	FOR CONSTRUCTION	_PL_	07/27/21
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ATC SITE NUMBER:

302475

ATC SITE NAME:

STTN - SOUTHINGTON

SITE ADDRESS: 80 SHUTTLE MEADOW RD SOUTHINGTON, CT 06489

SEAL



T··Mobile

	DRAWN BY:	PL
	DATE DRAWN:	07/27/21
	ATC JOB NO:	13692115_M4

TITLE SHEET

SHEET NUMBER

REVISION:

G-001

0

GENERAL CONSTRUCTION NOTES:

- ALL WORK SHALL CONFORM TO ALL CURRENT APPLICABLE FEDERAL, STATE, AND LOCAL CODES, INCLUDING ANSI/EIA/TIA-222. AND COMPLY WITH ATC CONSTRUCTION SPECIFICATIONS.
- CONTRACTOR SHALL CONTACT LOCAL 811 FOR IDENTIFICATION OF UNDERGROUND UTILITIES
 PRIOR TO START OF CONSTRUCTION.
- 3. CONTRACTOR SHALL BE RESPONSIBLE FOR COORDINATING ALL REQUIRED INSPECTIONS.
- ALL DIMENSIONS TO, OF, AND ON EXISTING BUILDINGS, DRAINAGE STRUCTURES, AND SITE IMPROVEMENTS SHALL BE VERIFIED IN FIELD BY CONTRACTOR WITH ALL DISCREPANCIES REPORTED TO THE ENGINEER.
- 5. DO NOT CHANGE SIZE OR SPACING OF STRUCTURAL ELEMENTS.
- 6. DETAILS SHOWN ARE TYPICAL; SIMILAR DETAILS APPLY TO SIMILAR CONDITIONS UNLESS OTHERWISE NOTED.
- THESE DRAWINGS DO NOT INCLUDE NECESSARY COMPONENTS FOR CONSTRUCTION SAFETY WHICH SHALL BE THE SOLE RESPONSIBILITY OF THE CONTRACTOR.
- 8. CONTRACTOR SHALL BRACE STRUCTURES UNTIL ALL STRUCTURAL ELEMENTS NEEDED FOR STABILITY ARE INSTALLED. THESE ELEMENTS ARE AS FOLLOWS: LATERAL BRACING, ANCHOR BOLTS FTC.
- CONTRACTOR SHALL DETERMINE EXACT LOCATION OF EXISTING UTILITIES, GROUNDS DRAINS, DRAIN PIPES, VENTS, ETC. BEFORE COMMENCING WORK.
- INCORRECTLY FABRICATED, DAMAGED, OR OTHERWISE MISFITTING OR NONCONFORMING MATERIALS OR CONDITIONS SHALL BE REPORTED TO THE ATC CM PRIOR TO REMEDIAL OR CORRECTIVE ACTION. ANY SUCH REMEDIAL ACTION SHALL REQUIRE WRITTEN APPROVAL BY THE ATC CM PRIOR TO PROCEEDING.
- 11. EACH CONTRACTOR SHALL COOPERATE WITH THE ATC CM, AND COORDINATE HIS WORK WITH THE WORK OF OTHERS.
- 12. CONTRACTOR SHALL REPAIR ANY DAMAGE CAUSED BY CONSTRUCTION OF THIS PROJECT TO MATCH EXISTING PRE-CONSTRUCTION CONDITIONS TO THE SATISFACTION OF THE ATC CONSTRUCTION MANAGER
- 13. ALL CABLE/CONDUIT ENTRY/EXIT PORTS SHALL BE WEATHERPROOFED DURING INSTALLATION USING A SILICONE SEALANT.
- 14. WHERE EXISTING CONDITIONS DO NOT MATCH THOSE SHOWN IN THIS PLAN SET, CONTRACTOR SHALL NOTIFY THE ATC CONSTRUCTION MANAGER IMMEDIATELY.
- 15. CONTRACTOR SHALL ENSURE ALL SUBCONTRACTORS ARE PROVIDED WITH A COMPLETE AND CURRENT SET OF DRAWINGS AND SPECIFICATIONS FOR THIS PROJECT.
- CONTRACTOR SHALL REMOVE ALL RUBBISH AND DEBRIS FROM THE SITE AT THE END OF EACH DAY.
- 17. CONTRACTOR SHALL COORDINATE WORK SCHEDULE WITH LANDLORD AND TAKE PRECAUTIONS TO MINIMIZE IMPACT AND DISRUPTION OF OTHER OCCUPANTS OF THE FACILITY.
- CONTRACTOR SHALL FURNISH ATC WITH A PDF MARKED UP AS-BUILT SET OF DRAWINGS UPON COMPLETION OF WORK.
- 19. PRIOR TO SUBMISSION OF BID, CONTRACTOR SHALL COORDINATE WITH ATC CM TO DETERMINE WHAT, IF ANY, ITEMS WILL BE PROVIDED. ALL ITEMS NOT PROVIDED SHALL BE PROVIDED AND INSTALLED BY THE CONTRACTOR. CONTRACTOR WILL INSTALL ALL ITEMS PROVIDED.
- 20. PRIOR TO SUBMISSION OF BID, CONTRACTOR SHALL COORDINATE WITH ATC CONSTRUCTION MANAGER TO DETERMINE IF ANY PERMITS WILL BE OBTAINED BY ATC. ALL REQUIRED PERMITS NOT OBTAINED BY ATC MUST BE OBTAINED. AND PAID FOR, BY THE CONTRACTOR.
- 21. CONTRACTOR SHALL INSTALL ALL SITE SIGNAGE IN ACCORDANCE WITH ATC SPECIFICATIONS AND REQUIREMENTS.
- 22. CONTRACTOR SHALL SUBMIT ALL SHOP DRAWINGS TO ATC FOR REVIEW AND APPROVAL PRIOR TO FABRICATION.
- 23. ALL EQUIPMENT SHALL BE INSTALLED ACCORDING TO MANUFACTURER'S SPECIFICATIONS AND LOCATED ACCORDING TO ATC SPECIFICATIONS, AND AS SHOWN IN THESE PLANS.
- 24. THE CONTRACTOR SHALL SUPERVISE AND DIRECT THE PROJECT DESCRIBED HEREIN. THE CONTRACTOR SHALL BE SOLELY RESPONSIBLE FOR ALL THE CONSTRUCTION MEANS, METHODS, TECHNIQUES, SEQUENCES AND PROCEDURES AND FOR COORDINATING ALL PORTIONS OF THE WORK UNDER THE CONTRACT.
- 25. CONTRACTOR SHALL NOTIFY ATC CM A MINIMUM OF 48 HOURS IN ADVANCE OF POURING CONCRETE OR BACKFILLING ANY UNDERGROUND UTILITIES, FOUNDATIONS OR SEALING ANY WALL, FLOOR OR ROOF PENETRATIONS FOR ENGINEERING REVIEW AND APPROVAL.
- 26. CONTRACTOR SHALL BE RESPONSIBLE FOR SITE SAFETY INCLUDING COMPLIANCE WITH ALL APPLICABLE OSHA STANDARDS AND RECOMMENDATIONS AND SHALL PROVIDE ALL NECESSARY SAFETY DEVICES INCLUDING PPE AND PPM AND CONSTRUCTION DEVICES SUCH AS WELDING AND FIRE PREVENTION, TEMPORARY SHORING, SCAFFOLDING, TRENCH BOXES/SLOPING, BARRIERS, ETC.
- 27. THE CONTRACTOR SHALL PROTECT AT HIS OWN EXPENSE, ALL EXISTING FACILITIES AND SUCH OF HIS NEW WORK LIABLE TO INJURY DURING THE CONSTRUCTION PERIOD. ANY DAMAGE CAUSED BY NEGLECT ON THE PART OF THIS CONTRACTOR OR HIS REPRESENTATIVES, OR BY THE ELEMENTS DUE TO NEGLECT ON THE PART OF THIS CONTRACTOR OR HIS

- REPRESENTATIVES, EITHER TO THE EXISTING WORK, OR TO HIS WORK OR THE WORK OF ANY OTHER CONTRACTOR. SHALL BE REPAIRED AT HIS EXPENSE TO THE OWNER'S SATISFACTION.
- 28. ALL WORK SHALL BE INSTALLED IN A FIRST CLASS, NEAT AND WORKMANLIKE MANNER BY MECHANICS SKILLED IN THE TRADE INVOLVED. THE QUALITY OF WORKMANSHIP SHALL BE SUBJECT TO THE APPROVAL OF THE ATC CM. ANY WORK FOUND BY THE ATC CM TO BE OF INFERIOR QUALITY AND/OR WORKMANSHIP SHALL BE REPLACED AND/OR REWORKED AT CONTRACTOR EXPENSE UNTIL APPROVAL IS OBTAINED.
- 29. IN ORDER TO ESTABLISH STANDARDS OF QUALITY AND PERFORMANCE, ALL TYPES OF MATERIALS LISTED HEREINAFTER BY MANUFACTURER'S NAMES AND/OR MANUFACTURER'S CATALOG NUMBER SHALL BE PROVIDED BY THESE MANUFACTURERS AS SPECIFIED.

CONCRETE AND REINFORCING STEEL NOTES:

- DESIGN AND CONSTRUCTION OF ALL CONCRETE ELEMENTS SHALL CONFORM TO THE LATEST EDITIONS OF ALL APPLICABLE CODES INCLUDING: ACI 301 "SPECIFICATIONS FOR STRUCTURAL CONCRETE FOR BUILDINGS", ACI 117 "SPECIFICATIONS FOR TOLERANCES FOR CONCRETE CONSTRUCTION AND MATERIALS", AND ACI 318 "BUILDING CODE REQUIREMENTS FOR REINFORCED CONCRETE."
- 2. MIX DESIGN SHALL BE APPROVED BY ATC CM PRIOR TO PLACING CONCRETE.
- CONCRETE SHALL BE NORMAL WEIGHT, 6 % AIR ENTRAINED (+/- 1.5%) WITH A SLUMP RANGE OF 3-5" AND HAVE A MINIMUM 28-DAY COMPRESSIVE STRENGTH OF 4000 PSI UNLESS OTHERWISE NOTED.
- 4. THE FOLLOWING MATERIALS SHALL BE USED:

PORTLAND CEMENT: ASTM C150, TYPE 2

REINFORCEMENT: ASTM A185, PLAIN STEEL WELDED WIRE FABRIC

REINFORCEMENT BARS: ASTM A615, GRADE 60, DEFORMED

NORMAL WEIGHT AGGREGATE: ASTM C33
WATER: ASTM C 94/C 94M

ADMIXTURES

-WATER-REDUCING AGENT: ASTM C 494/C 494M, TYPE A

-AIR-ENTERING AGENT: ASTM C 260/C 260M

-SUPERPLASTICIZER: ASTM C494, TYPE F OR TYPE G

-RETARDING: ASTM C 494/C 494M, TYPE B

- 5. MINIMUM CONCRETE COVER FOR REINFORCING STEEL SHALL BE NO LESS THAN 3".
- A 3/4" CHAMFER SHALL BE PROVIDED AT ALL EXPOSED EDGES OF CONCRETE IN ACCORDANCE WITH ACI 301 SECTION 4.2.4, UNLESS NOTED OTHERWISE.
- 7. INSTALLATION OF CONCRETE EXPANSION/WEDGE ANCHOR SHALL BE PER MANUFACTURER'S WRITTEN RECOMMENDED PROCEDURE. THE ANCHOR BOLT, DOWEL, OR ROD SHALL CONFORM TO MANUFACTURER'S RECOMMENDATION FOR EMBEDMENT DEPTH OR AS SHOWN ON THE DRAWINGS. NO REBAR SHALL BE CUT WITHOUT PRIOR ATC CM APPROVAL WHEN DRILLING HOLES IN CONCRETE.
- ADMIXTURES SHALL CONFORM TO THE APPROPRIATE ASTM STANDARD AS REFERENCED IN "METHOD 1" OF ACI 301.
- DO NOT WELD OR TACK WELD REINFORCING STEEL.
- ALL DOWELS, ANCHOR BOLTS, EMBEDDED STEEL, ELECTRICAL CONDUITS, PIPE SLEEVES, GROUNDS AND ALL OTHER EMBEDDED ITEMS AND FORMED DETAILS SHALL BE IN PLACE BEFORE START OF CONCRETE PLACEMENT.
- 11. REINFORCEMENT SHALL BE COLD BENT WHENEVER BENDING IS REQUIRED.
- 12. DO NOT PLACE CONCRETE IN WATER, ICE, OR ON FROZEN GROUND.
- 13. DO NOT ALLOW REINFORCEMENT, CONCRETE OR SUBBASE TO FREEZE DURING CONCRETE CURING AND SETTING PERIOD, OR FOR A MINIMUM OF 3 DAYS AFTER PLACEMENT.
- 14. FOR COLD-WEATHER(ACI 306) AND HOT-WEATHER(ACI 301M) CONCRETE PLACEMENT, CONFORM TO APPLICABLE ACI CODES AND RECOMMENDATIONS. IN EITHER CASE, MATERIALS CONTAINING CHLORIDE, CALCIUM, SALTS, ETC. SHALL NOT BE USED. PROTECT FRESH CONCRETE FROM WEATHER FOR 7 DAYS, MINIMUM.
- 15. ALL CONCRETE SHALL HAVE A "SMOOTH FORM FINISH."
- 16. UNLESS OTHERWISE NOTED:
 - ALL REINFORCING STEEL SHALL BE DEFORMED BARS CONFORMING TO ASTM A615/A 615M/A-996, GRADE 60.
 - B. WELDED WIRE FABRIC SHALL CONFORM TO ASTM A185.
- 17. SPLICING OF REINFORCEMENT IS PERMITTED ONLY AT LOCATIONS SHOWN IN THE CONTRACT DRAWINGS OR AS ACCEPTED BY THE ENGINEER. UNLESS OTHERWISE SHOWN OR NOTED REINFORCING STEEL SHALL BE SPLICED TO DEVELOP ITS FULL TENSILE CAPACITY (CLASS A) IN ACCORDANCE WITH ACI 318.
- 18. REINFORCING BAR DEVELOPMENT LENGTHS, AS COMPUTED IN ACCORDANCE WITH ACI 318, FORM THE BASIS FOR BAR EMBEDMENT LENGTHS AND BAR SPLICED LENGTHS SHOWN IN THE

- DRAWINGS. APPLY APPROPRIATE MODIFICATION FACTORS FOR TOP STEEL, BAR SPACING, COVER AND THE LIKE.
- DETAILING OF REINFORCING STEEL SHALL CONFORM TO "ACI MANUAL OF STANDARD PRACTICE FOR DETAILING REINFORCED CONCRETE STRUCTURES" (ACI 315).
- 20. ALL SLAB CONSTRUCTION SHALL BE CAST MONOLITHICALLY WITHOUT HORIZONTAL CONSTRUCTION JOINTS. UNLESS SHOWN IN THE CONTRACT DRAWINGS.
- 21. LOCATION OF ALL CONSTRUCTION JOINTS ARE SUBJECT TO THE REQUIREMENTS OF THE CONTRACT DOCUMENTS, CONFORMANCE WITH ACI 318, AND ACCEPTANCE OF THE ENGINEER. DRAWINGS SHOWING LOCATION OF DETAILS OF THE PROPOSED CONSTRUCTION JOINTS SHALL BE SUBMITTED WITH REINFORCING STEEL PLACEMENT DRAWINGS.
- 2. SPLICES OF WWF, AT ALL SPLICED EDGES, SHALL BE SUCH THAT THE OVERLAP MEASURED BETWEEN OUTERMOST CROSS WIRES OF EACH FABRIC SHEET IS NOT LESS THAN THE SPACING OF THE CROSS WIRE PLUS 2 INCHES, NOR LESS THAN 6".
- BAR SUPPORTS SHALL BE ALL-GALVINIZED METAL WITH PLASTIC TIPS.
- 24. ALL REINFORCEMENT SHALL BE SECURELY TIED IN PLACE TO PREVENT DISPLACEMENT BY CONSTRUCTION TRAFFIC OR CONCRETE. TIE WIRE SHALL BE OF SUFFICIENT STRENGTH FOR INTENDED PURPOSE, BUT NOT LESS THAN NO. 18 GAUGE.
- 25. SLAB ON GROUND:
 - A. COMPACT SUBGRADE AND ENSURE THERE IS PLACE 6" GRAVEL BENEATH SLAB.
 - B. PROVIDE VAPOR BARRIER BENEATH SLAB ON GROUND.

STRUCTURAL STEEL NOTES:

- STRUCTURAL STEEL SHALL CONFORM TO THE LATEST EDITION OF THE AISC "SPECIFICATION FOR THE DESIGN, FABRICATION AND ERECTION OF STRUCTURAL STEEL FOR BUILDINGS."
- STRUCTURAL STEEL ROLLED SHAPES, PLATES AND BARS SHALL CONFORM TO THE FOLLOWING ASTM DESIGNATIONS:
 - A. ASTM A-572, GRADE 50 ALL W SHAPES, UNLESS NOTED OR A992 OTHERWISE
 - B. ASTM A-36 ALL OTHER ROLLED SHAPES, PLATES AND BARS UNLESS NOTED OTHERWISE
 - C. ASTM A-500, GRADE B HSS SECTION (SQUARE, RECTANGULAR, AND ROUND)
 - D. ASTM A-325, TYPE SC OR N ALL BOLTS FOR CONNECTING STRUCTURAL MEMBERS
 - E. ASTM F-1554 07 ALL ANCHOR BOLTS, UNLESS NOTED OTHERWISE
- ALL EXPOSED STRUCTURAL STEEL MEMBERS SHALL BE HOT-DIPPED GALVANIZED AFTER FABRICATION PER ASTM A123. EXPOSED STEEL HARDWARE AND ANCHOR BOLTS SHALL BE GALVANIZED PER ASTM A153 OR B695.
- ALL FIELD CUT SURFACES, FIELD DRILLED HOLES AND GROUND SURFACES WHERE EXISTING PAINT OR GALVANIZATION REMOVAL WAS REQUIRED SHALL BE REPAIRED WITH (2) BRUSHED COATS OF ZRC GALVILITE COLD GALVANIZING COMPOUND PER ASTM A780 AND MANI JEACTURER'S RECOMMENDATIONS
- 5. DO NOT DRILL HOLES THROUGH STRUCTURAL STEEL MEMBERS EXCEPT AS SHOWN AND DETAILED ON STRUCTURAL DRAWINGS.
- 6. CONNECTIONS:
 - A. ALL WELDING TO BE PERFORMED BY AWS CERTIFIED WELDERS AND CONDUCTED IN ACCORDANCE WITH THE LATEST EDITION OF THE AWS WELDING CODE D1.1.
 - B. ALL WELDS SHALL BE INSPECTED VISUALLY. 25% OF WELDS SHALL BE INSPECTED WITH DYE PENETRANT OR MAGNETIC PARTICLE TO MEET THE ACCEPTANCE CRITERIA OF AWS D1.1. REPAIR ALL WELDS AS NECESSARY.
 - C. INSPECTION SHALL BE PERFORMED BY AN AWS CERTIFIED WELD INSPECTOR.
 - D. IT IS THE CONTRACTORS RESPONSIBILITY TO PROVIDE BURNING/WELDING PERMITS AS REQUIRED BY LOCAL GOVERNING AUTHORITY AND IF REQUIRED SHALL HAVE FIRE DEPARTMENT DETAIL FOR ANY WELDING ACTIVITY.
 - E. ALL ELECTRODES TO BE LOW HYDROGEN, MATCHING FILLER METAL, PER AWS D1.1, UNLESS NOTED OTHERWISE.
 - F. MINIMUM WELD SIZE TO BE 0.1875 INCH FILLET WELDS, UNLESS NOTED OTHERWISE.
 - G. PRIOR TO FIELD WELDING GALVANIZING MATERIAL, CONTRACTOR SHALL GRIND OFF GALVANIZING ½" BEYOND ALL FIELD WELD SURFACES. AFTER WELD AND WELD INSPECTION IS COMPLETE, REPAIR ALL GROUND AND WELDED SURFACES WITH ZRC GALVILITE COLD GALVANIZING COMPOUND PER ASTM A780 AND MANUFACTURERS RECOMMENDATIONS.



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SUITE 100 CARY, NC 27518 PHONE: (919) 468-0112 COA: P-1177

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REV. DESCRIPTION BY	DATE
6 FOR CONSTRUCTION PL 0	7/27/21

ATC SITE NUMBER:

302475

ATC SITE NAME:

STTN - SOUTHINGTON

SITE ADDRESS: 80 SHUTTLE MEADOW RD SOUTHINGTON, CT 06489

SEAL:



T·Mobile

DRAWN BY: PL

DATE DRAWN: 07/27/21

ATC JOB NO: 13692115_M4

GENERAL NOTES

SHEET NUMBER

G-002

U

REVISION

SITE PLAN NOTES:


- THIS SITE PLAN REPRESENTS THE BEST PRESENT KNOWLEDGE AVAILABLE TO THE ENGINEER AT THE TIME OF THIS DESIGN. THE CONTRACTOR SHALL VISIT THE SITE PRIOR TO CONSTRUCTION AND VERIFY ALL EXISTING CONDITIONS RELATED TO THE SCOPE OF WORK FOR THIS PROJECT.
- 2. ICE BRIDGE, CABLE LADDER, COAX PORT, AND COAX CABLE ARE SHOWN FOR REFERENCE ONLY. CONTRACTOR SHALL CONFIRM THE EXACT LOCATION OF ALL PROPOSED AND EXISTING EQUIPMENT AND STRUCTURES DEPICTED ON THIS PLAN. BEFORE UTILIZING EXISTING CABLE SUPPORTS, COAX PORTS, INSTALLING NEW PORTS OR ANY OTHER EQUIPMENT, CONTRACTOR SHALL VERIFY ALL ASPECTS OF THE COMPONENTS MEET THE ATC SPECIFICATIONS.
- 3. IT IS THE RESPONSIBILITY OF THE CONTRACTOR TO COORDINATE WITH THE ATC CONSTRUCTION MANAGER AND LOCAL UTILITY COMPANY FOR THE INSTALLATION OF CONDUITS, CONDUCTORS, BREAKERS, DISCONNECTS, OR ANY OTHER EQUIPMENT REQUIRED FOR ELECTRICAL SERVICE. ALL ELECTRICAL WORK SHALL BE PERFORMED IN ACCORDANCE WITH LATEST EDITION OF THE STATE AND NATIONAL CODES, ORDINANCES AND REGULATIONS APPLICABLE TO THIS PROJECT.
- 4. CONTRACTOR SHALL INSURE THAT ALL WORKING SPACE REQUIREMENTS ARE MET PER APPLICABLE CODES AND MANUFACTURER SPECIFICATIONS.
- 5. ABOVE GROUND CONDUITS NEED TO BE SUPPORTED/FASTENED PER NEC 344, NEC 352, AND PER ATC CONSTRUCTION SPECIFICATIONS.
- 6. THE FOLLOWING SIGNS SHALL BE INSTALLED AT TENANT SERVICE MAIN DISCONNECT PER NEC 702.7.
- 6.1. "CAUTION: TWO SOURCES OF SUPPLY STANDBY GENERATOR LOCATED OUTDOORS"
- 6.2. "WARNING: SHOCK HAZARD EXISTS IF GROUNDING ELECTRODE CONDUCTOR OR BONDING JUMPER CONNECTION IN THIS EQUIPMENT IS REMOVED WHILE ALTERNATE SOURCE IS ENERGIZED"

RODENT CONTROL AROUND GENERATOR ENVELOPE:

- INSTALL ALL PROVIDED SEALS, PLUGS, COVERS, ETC. IN GENERATOR AND FUEL
 TANK ENVELOPE. SEAL ALL REMAINING OPENINGS (EXCEPT NORMAL VENTING)
 WITH RODENT FOAM SEALANT. NO OPENING SHALL BE LARGER THAN 1/4 INCH ANY
 DIMFNSION
- SEAL ALL CONDUITS INCLUDING CONDUITS ENTERING GENERATOR EQUIPMENT, BOXES, ATTACHMENTS, ETC. WITH RODENT FOAM SEALANT.
- 3. SEAL ALL CONDUIT ACCESS OPENINGS THROUGH CONCRETE PAD WITH CONCRETE.
- 4. SLOPE GRAVEL BASE AT CONCRETE PAD PERIMETER FROM ABOVE PAD BASE TO EXISTING GRADE LEVEL TYPICAL ALL PERIMETER SIDES.


LEGEND

GROUNDING TEST WELL ATS AUTOMATIC TRANSFER SWITCH **BOLLARD** CSC CELL SITE CABINET D DISCONNECT **ELECTRICAL** FIBER GEN GENERATOR GENERATOR RECEPTACAL HH. V HAND HOLE, VAULT ΙB ICE BRIDGE KENTROX BOX LC LIGHTING CONTROL METER РΒ PULL BOX PΡ POWER POLE TELCO TRN TRANSFORMER

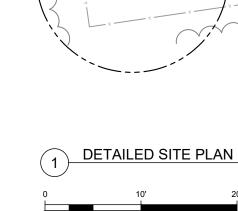

SCALE: 1"=10' (11X17) 1"=5' (22X34)



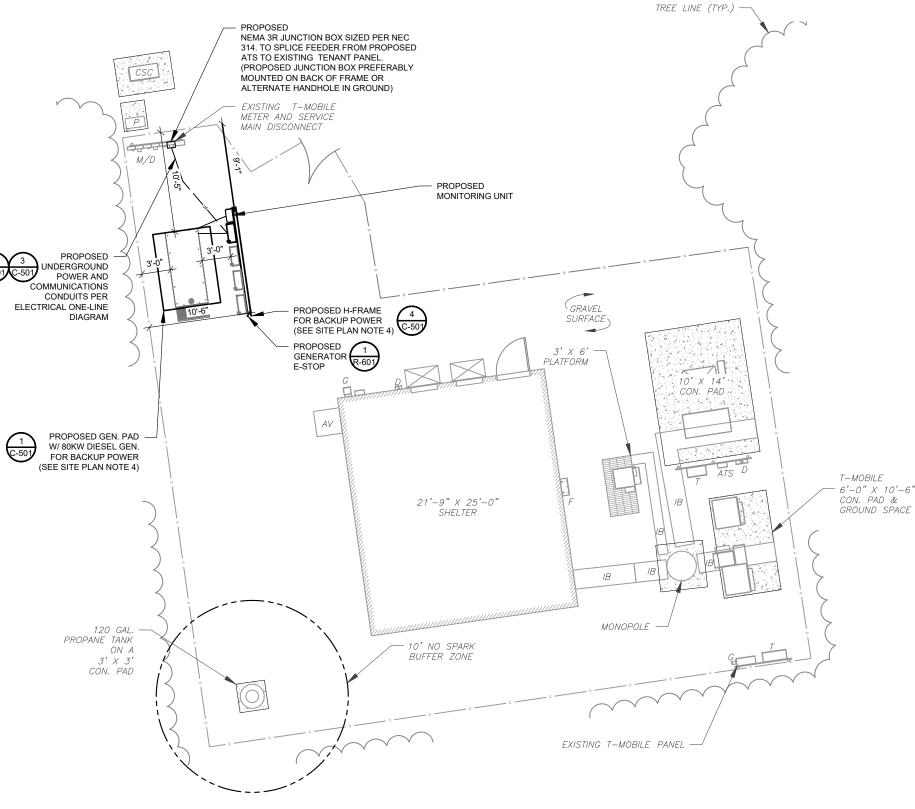

APPROXIMATE TRENCH DISTANCES

CHAINLINK FENCE

14' POWER CONDUIT TRENCH



AMERICAN TOWER®
A.T. ENGINEERING SERVICE, PLLC

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SEAL



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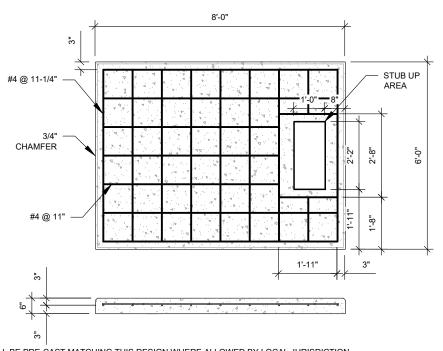
DRAWN BY:	PL
DATE DRAWN:	07/27/21
ATC JOB NO:	13692115_M4

SITE PLAN


SHEET NUMBER:

C-101

REVISION



- PADS SHALL BE PRE-CAST MATCHING THIS DESIGN WHERE ALLOWED BY LOCAL JURISDICTION
- PADS SHALL HAVE A MIN 28 DAY COMPRESSIVE STRENGTH AS SPECIFIED ON G-002. CONCRETE AND REINFORCING STEEL NOTES #3
- REFER TO CONCRETE & REINFORCED STEEL NOTES ON SHEET G-002 & ATC CONSTRUCTION SPECIFICATION 033000 FOR
- STUB UP AREA SHALL BE FILLED WITH QUIKRETE, OR APPROVED EQUAL, PRIOR TO FINAL SET OF GENERATOR ON PAD.
- AFTER FINAL SET OF GENERATOR ON PAD, GROUT ALL EXTERIOR OPENINGS AT PAD INTERFACE SO THAT FINISHED MAXIMUM
- 6. GROUT SHALL BE PER ATC CONSTRUCTION SPECIFICATION DIVISION 03, CONCRETE.

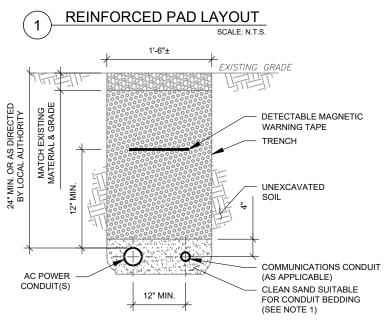

TRENCH NOTES:

PAD NOTES:

- IF FREE OF ORGANIC OR OTHER DELETERIOUS MATERIAL, EXCAVATED MATERIAL MAY BE USED FOR BACKFILL. IF NOT, PROVIDE CLEAN, COMPACTIBLE MATERIAL.
- COMPACT IN 8" LIFTS USING A MECHANICAL PLATE TAMPER, MIN 3 PASSES. REMOVE ANY LARGE ROCKS PRIOR TO BACKFILLING. CONTRACTOR TO VERIFY LOCATION OF EXISTING U/G UTILITIES PRIOR TO DIGGING. SEE ATC CONSTRUCTION SPECIFICATION 312000 SECTION 3.15.
- IF CURRENT AS-BUILT DRAWINGS ARE NOT AVAILABLE CONTRACTOR SHALL HAND DIG U/G TRENCHING.
- CONFIRM SPACING AND DEPTH WITH NEC OR LOCAL CODE REQUIREMENTS



PIPE/CONDUIT CLAMP P1119 OR P2558-35 (GALV.) (TYP.) FOLLOW MANÚFACTURER FOR BOLT TORQUE


CONDUCTOR LOOP

UNISTRUT

RECOMMENDATIONS


- IF IT IS NECESSARY TO EXTEND THE H-FRAME, AN ADDITIONAL POST SHALL BE REQUIRED.
- PROPOSED UNISTRUTS TO BE FIELD CUT AND SHALL NOT EXTEND MORE THAN 6 INCHES BEYOND THE LAST POST. SPRAY ENDS OF UNISTRUT WITH COLD GALVANIZING SPRAY PAINT, ALLOW TO DRY, THEN COVER WITH RUBBER
- PROTECTIVE CAPS FOR SAFETY.
- ALL PROPOSED HARDWARE TO BE MOUNTED AND GROUNDED PER MANUFACTURERS SPECS
- LAYOUT H-FRAME & PROPOSED EQUIPMENT EXACTLY AS SHOWN TO ALLOW FOR FUTURE EQUIPMENT. ANY DEVIATIONS MUST BE APPROVED BY ATC CM, IN WRITING, NO EXCEPTIONS.
- FOOTINGS SHALL BE ONE OF THE FOLLOWING: USS POLECRETE STABILIZER SYSTEM, PRECAST CONCRETE (WHERE ALLOWED BY JURISDICTION) OR CAST IN PLACE. FOR PRECAST FOOTINGS, CONTRACTORS SHALL THOROUGHLY



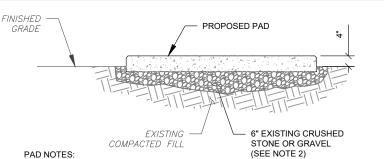

- SUBGRADE AND FILL SHALL CONSIST OF CLEAN SOIL. DELETRIOUS MATERIAL AND ORGANICS SHALL BE REMOVED.
- MECHANICALLY COMPACT FOOTPRINT OF PAD PLUS 2' PERIMETER USING A MECHANICAL PLATE TAMPER, MIN 3 PASSES. SEE ATC CONSTRUCTION SPECIFICATION 312000 ACCESS ROAD AND FARTH WORK
- 3. USE GALVANIZED HILTI EXPANSION ANCHORS OR, APPROVED EQUAL, FOR
- FOR SIZE AND LOCATION OF ANCHORS AND OTHER REQUIREMENT, SEE EQUIPMENT VENDOR DRAWINGS.



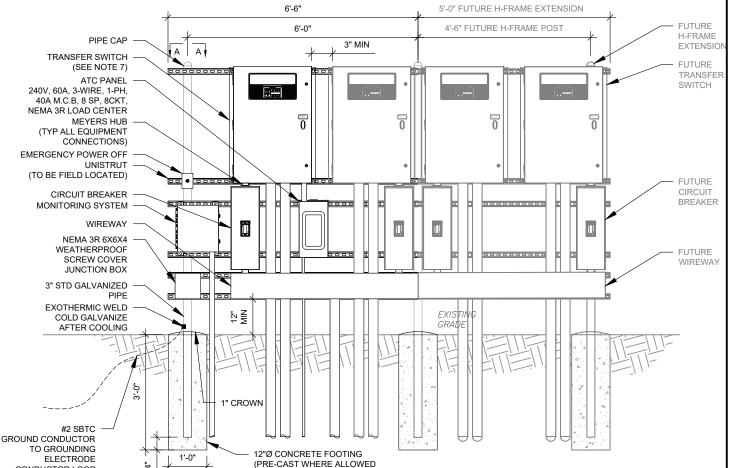

H-FRAME NOTES:

- UNISTRUT TO BE CUT FLUSH WITH NO SHARP OR JAGGED EDGES.
- ALL ITEMS ARE PROPOSED UNLESS OTHERWISE NOTED.
- COMPACT THE PERIMETER (2' MIN) OF FOOTING WITH MECHANICAL PLATE TAMPER.





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П	DATE DRAWN:	07/27/21
П	ATC JOB NO:	13692115_M4
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CONCRETE PAD DETAILS


SHEET NUMBER:

C-501

REVISION



CONDUIT TRENCH DETAILS

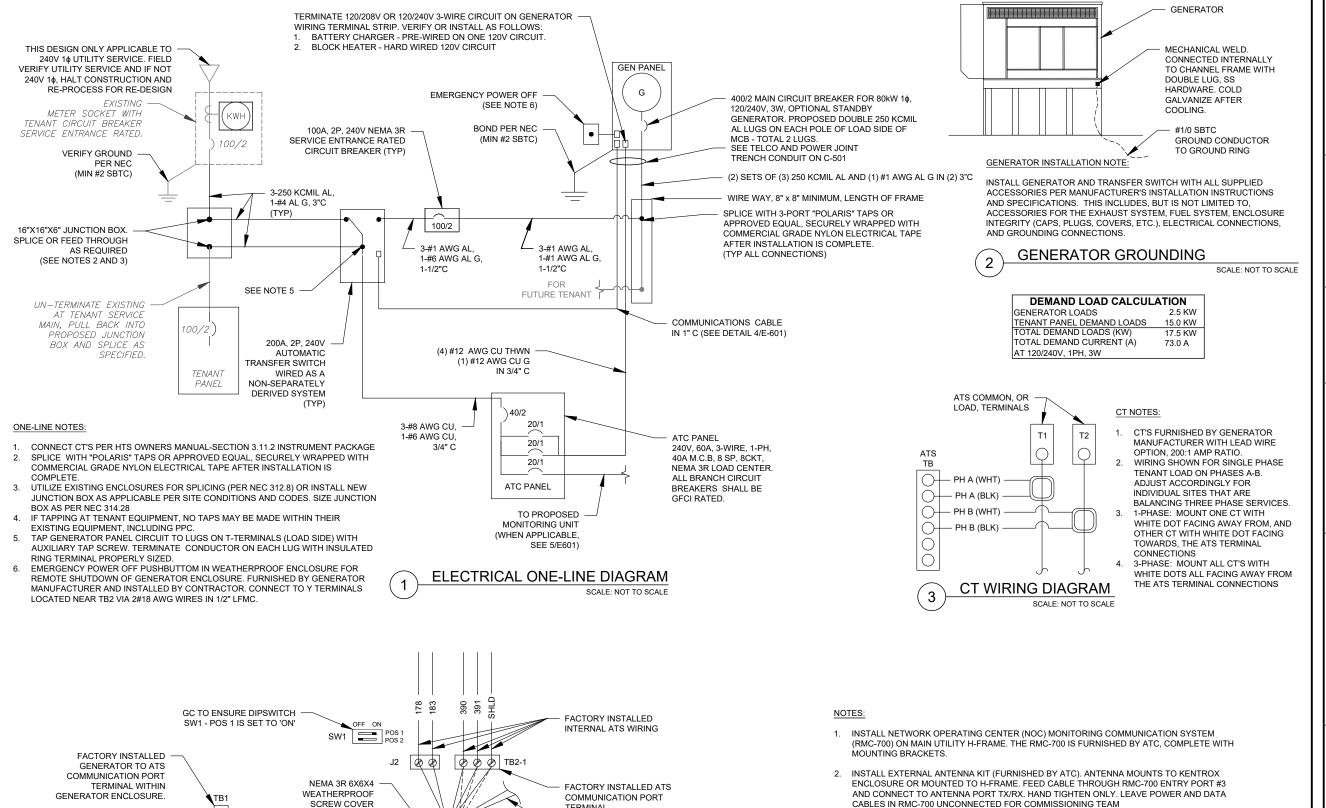

CONNECT TO E-STOP BUTTON

MOUNTED ON ATS H-FRAME

WIRING CONNECTION TO NEXT FUTURE ATS

KNOCK OUT REMOVED FOR

CONDUIT TO FUTURE ATS

1 - 0

2 - 183

15A/220A

15A1/220A1

4 - 390/485+

5 - 391/485-6 - SHLD

JUNCTION BOX

2-#14 AWG CU

2 WIRE ENGINE START

2 WIRE E-STOP

COMMUNICATIONS CABLE DETAIL

TO GENERATOR PANEL. CONNECT PER

SCALE: NOT TO SCALE

MANUFACTURER'S SPECIFICATIONS (DO NOT CONNECT "SHLD" AT GENERATOR)

2#18 AWG CU



OF CONNEC SSIONAL ENG! WOONAL ENGLY

AMERICAN TOWER

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CARY, NC 27518

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ATC SITE NUMBER:

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ATC SITE NAME:

STTN - SOUTHINGTON

BY DATE

PL 07/27/21

AMERICAN TOWER WHETHER OR NOT THE PROJECT IS

VERSION ON FILE WITH AMERICAN TOWER

DESCRIPTION

FOR CONSTRUCTION

BE PROVIDING ON-SITE CONSTRUCTION REVIEW OF THIS

THESE DRAWINGS AND/OR THE ACCOMPANYING

DRAWN BY: PL DATE DRAWN: 07/27/21 ATC JOB NO: 13692115_M4

> **ELECTRICAL ONE-LINE** AND WIRING DETAILS

> > SHEET NUMBER

BRANCH CIRCUIT WIRING FOR MONITORING DEVICE SHALL BE 2-#12 AWG CU. 1-#12 AWG CU

PROPOSED MONITORING

SCALE: NOT TO SCALE


G IN 3/4" C


E-601

REVISION

GENERAC INDUSTRIAL

REMOTE EMERGENCY STOP SWITCH SURFACE MOUNT, H-PANEL

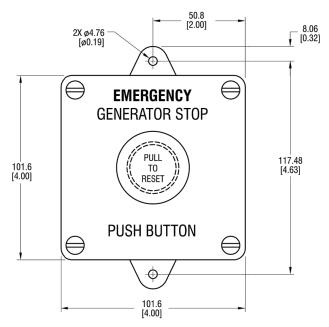

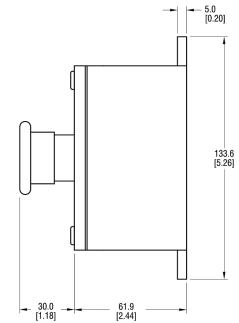


• MANUFACTURER: PILLA ELECTRICAL PRODUCTS, INC.


- MODEL SG120
- GENERAC PART NUMBER 061129E
- SURFACE MOUNT, NEMA 4X
- NONMETALLIC BACKBOX

DIMENSIONS: mm[INCHES]

GENERAC INDUSTRIAL POWER

REMOTE EMERGENCY STOP SWITCH SURFACE MOUNT, H-PANEL

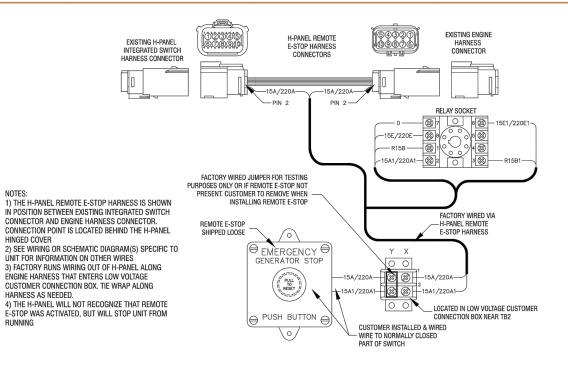

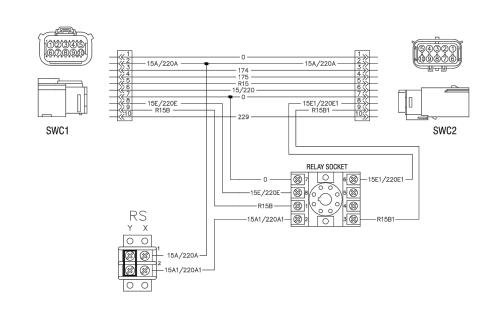

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Part No. 0L6260 Rev A 10/15/15 GENSET CONTROLS

SUPPLEMENTAL

SHEET NUMBER:

R-601

REVISION:

0

E-STOP SWITCH

1 OF 2

STANDBY POWER RATING

80 kW, 100 kVA, 60 Hz

PRIME POWER RATING*

72 kW, 90 kVA, 60 Hz





*Built in the USA using domestic and foreign parts

^{**}Certain options or customization may not hold certification valid.

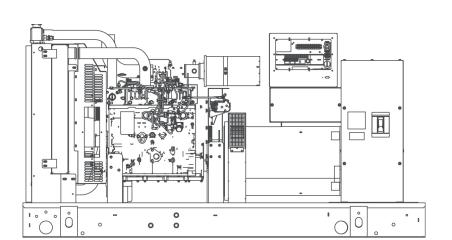


Image used for illustration purposes only

CODES AND STANDARDS

Generac products are designed to the following standards:



UL2200, UL508, UL142, UL498



NFPA70, 99, 110, 37



NEC700, 701, 702, 708



ISO9001, 8528, 3046, 7637, Pluses #2b, 4



NEMA ICS10, MG1, 250, ICS6, AB1



ANSI C62.41

POWERING AHEAD

For over 50 years, Generac has led the industry with innovative design and superior manufacturing.

Generac ensures superior quality by designing and manufacturing most of its generator components, including alternators, enclosures and base tanks, control systems and communications software.

Generac's gensets utilize a wide variety of options, configurations and arrangements, allowing us to meet the standby power needs of practically every application.

Generac searched globally to ensure the most reliable engines power our generators. We choose only engines that have already been proven in heavy-duty industrial application under adverse conditions.

Generac is committed to ensuring our customers' service support continues after their generator purchase.

^{*}EPA Certified Prime ratings are not available in the U.S. or its Territories.

SD080 | 4.5L | 80 kW

INDUSTRIAL DIESEL GENERATOR SET

EPA Certified Stationary Emergency

STANDARD FEATURES

ENGINE SYSTEM

General

- · Oil Drain Extension
- Air Cleaner
- · Fan Guard
- · Stainless Steel flexible exhaust connection
- · Critical Exhaust Silencer (enclosed only)
- · Factory Filled Oil
- · Radiator Duct Adapter (open set only)

Fuel System

- · Fuel lockoff solenoid
- · Primary fuel filter

Cooling System

- · Closed Coolant Recovery System
- · UV/Ozone resistant hoses
- · Factory-Installed Radiator
- · Radiator Drain Extension
- 50/50 Ethylene glycol antifreeze
- 120 VAC Coolant Heater

Engine Electrical System

- · Battery charging alternator
- Battery cables
- · Battery tray
- · Solenoid activated starter motor
- Rubber-booted engine electrical connections

ALTERNATOR SYSTEM

- UL2200 GENprotect™
- 12 leads (3-phase, non 600 V)
- · Class H insulation material
- Vented rotor
- 2/3 pitch
- · Skewed stator
- · Auxiliary voltage regulator power winding
- · Amortisseur winding
- · Brushless Excitation
- · Sealed Bearings
- Automated manufacturing (winding, insertion, lacing, varnishing)
- Rotor dynamically spin balanced
- · Full load capacity alternator
- · Protective thermal switch

GENERATOR SET

- · Internal Genset Vibration Isolation
- · Separation of circuits high/low voltage
- · Separation of circuits multiple breakers
- · Silencer Heat Shield
- Wrapped Exhaust Piping
- · Silencer housed in discharge hood (enclosed only)
- · Standard Factory Testing
- 2 Year Limited Warranty (Standby rated Units)
- 1 Year Limited Warranty (Prime rated Units)
- · Silencer mounted in the discharge hood (enclosed only)

ENCLOSURE (IF SELECTED)

- Rust-proof fasteners with nylon washers to protect finish
- · High performance sound-absorbing material
- Gasketed doors
- · Stamped air-intake louvers
- · Air discharge hoods for radiator-upward pointing
- · Stainless steel lift off door hinges
- · Stainless steel lockable handles
- Rhino Coat[™] Textured polyester powder coat

TANKS (IF SELECTED)

- UL 142
- · Double wall
- Vents
- Sloped top
- Sloped bottom
- · Factory pressure tested (2 psi)
- Rupture basin alarm
- Fuel level
- · Check valve in supply and return lines
- Rhino Coat[™]- Textured polyester powder coat
- Stainless hardware

CONTROL SYSTEM



Control Panel

- Digital H Control Panel Dual 4x20 Display
- · Programmable Crank Limiter
- 7-Day Programmable Exerciser
- · Special Applications Programmable PLC
- RS-232/485
- · All-Phase Sensing DVR
- · Full System Status
- · Utility Monitoring
- Low Fuel Pressure Indication
- 2-Wire Start Compatible
- · Power Output (kW)

- Power Factor
- kW Hours, Total & Last Run
- Real/Reactive/Apparent Power
- All Phase AC Voltage
- · All Phase Currents
- Oil Pressure
- · Coolant Temperature
- Coolant Level
- Engine Speed
- Battery Voltage
- FrequencyDate/Time Fault History (Event Log)
- Isochronous Governor Control
- · Waterproof/sealed Connectors
- Audible Alarms and Shutdowns
- Not in Auto (Flashing Light)Auto/Off/Manual Switch
- E-Stop (Red Mushroom-Type)
- NFPA110 Level I and II (Programmable)
- Customizable Alarms, Warnings, and Events
- Modbus protocol
- Predictive Maintenance algorithm
- Sealed Boards
- Password parameter adjustment protection

- Single point ground
- 15 channel data logging
- 0.2 msec high speed data logging
- Alarm information automatically comes up on the display

Alarms

- Oil Pressure (Pre-programmable Low Pressure Shutdown)
- Coolant Temperature (Pre-programmed High Temp Shutdown)
- Coolant Level (Pre-programmed Low Level Shutdown)
- Low Fuel Pressure Alarm
- Engine Speed (Pre-programmed Over speed Shutdown)
- Battery Voltage Warning
- Alarms & warnings time and date stamped
- Alarms & warnings for transient and steady state conditions
- Snap shots of key operation parameters during alarms & warnings
- Alarms and warnings spelled out (no alarm codes)

SD080

| 4.5L | 80 kW

INDUSTRIAL GENERAC

INDUSTRIAL DIESEL GENERATOR SET

EPA Certified Stationary Emergency

CONFIGURABLE OPTIONS

ENGINE SYSTEM

General

- O Oil Heater
- O Industrial Exhaust Silencer

Fuel System

- O Flexible fuel lines
- O Primary fuel filter

Engine Electrical System

- O 10A UL battery charger
- O 2.5A UL battery charger
- O Battery Warmer

ALTERNATOR SYSTEM

- O Alternator Upsizing
- O Anti-Condensation Heater
- O Tropical coating
- O Permanent Magnet Excitation

ENGINEERED OPTIONS

ENGINE SYSTEM

- O Coolant heater ball valves
- O Block Heaters
- O Fluid containment pans

ALTERNATOR SYSTEM

O 3rd Breaker Systems

CONTROL SYSTEM

- O Spare inputs (x4) / outputs (x4) H Panel Only
- O Battery Disconnect Switch

CIRCUIT BREAKER OPTIONS

- O Main Line Circuit Breaker
- O 2nd Main Line Circuit Breaker
- O Shunt Trip and Auxiliary Contact
- O Electronic Trip Breaker

GENERATOR SET

- O Gen-Link Communications Software (English Only)
- O IBC Seismic Certification
- O 8 Position Load Center
- O 2 Year Extended Warranty
- O 5 Year Warranty
- O 5 Year Extended Warranty

ENCLOSURE

- O Weather Protected
- O Level 1 Sound Attenuation
- O Level 2 Sound Attenuation
- O Steel Enclosure
- O Aluminum Enclosure
- O 150 MPH Wind Kit
- O 12 VDC Enclosure Lighting Kit
- O 120 VAC Enclosure Lighting Kit
- O AC/DC Enclosure Lighting Kit
- O Door Alarm Switch

TANKS (Size on last page)

- O Electrical Fuel Level
- O Mechanical Fuel Level
- O 8" Fill Extension
- O 13" Fill Extension
- O 19" Fill Extension

CONTROL SYSTEM

- O 21-Light Remote Annunciator
- O Remote Relay Panel (8 or 16)
- O Oil Temperature Sender with Indication Alarm
- O Remote E-Stop (Break Glass-Type, Surface Mount)
- O Remote E-Stop (Red Mushroom-Type, Surface Mount)
- O Remote E-Stop (Red Mushroom-Type, Flush Mount)
- O Remote Communication Modem
- O Remote Communication Ethernet
- O 10A Run Relay
- O Ground Fault Indication and Protection Functions

GENERATOR SET

O Special Testing

ENCLOSURE

- O Motorized Dampers
- O Door switched for intrusion alert
- O Enclosure ambient heaters

TANKS

- O Overfill Protection Valve
- O UL2085 Tank
- O ULC S-601 Tank
- O Stainless Steel Tank
- O Special Fuel Tanks (MIDEQ and FL DEP/DERM, etc.)
- O Vent Extensions

RATING DEFINITIONS

Standby - Applicable for a varying emergency load for the duration of a utility power outage with no overload capability.

Prime - Applicable for supplying power to a varying load in lieu of utility for an unlimited amount of running time. A 10% overload capacity is available for 1 out of every 12 hours. The Prime Power option is only available on International applications. Power ratings in accordance with ISO 8528-1, Second Edition

| **4.5L** | 80 kW INDUSTRIAL DIESEL GENERATOR SET

EPA Certified Stationary Emergency

APPLICATION AND ENGINEERING DATA

General		Cooling System	
Make	Iveco/FPT	Cooling System Type	Closed
EPA Emissions Compliance	Stationary Emergency	Water Pump	Belt Driven Centrifugal
EPA Emissions Reference	See Emissions Data Sheet	Fan Type	Pusher
Cylinder #	4	Fan Speed (rpm)	2538
Туре	In-Line	Fan Diameter mm (in)	660.4 (26)
Displacement - L (cu ln)	4.5 (274.6)	Coolant Heater Wattage	1500
Bore - mm (in)	105 (4.1)	Coolant Heater Standard Voltage	120 V /240 V
Stroke - mm (in)	132 (5.2)		
Compression Ratio	17.5:1		
Intake Air Method	Turbocharged/Aftercooled	Fuel System	
Cylinder Head Type	2 Valve	Fuel Type	Ultra Low Sulfur Diesel Fue
Piston Type	Aluminium	Fuel Specifications	ASTM
Crankshaft Type	Forged Steel	Fuel Filtering (microns)	5
		Fuel Injection	Stanadyne
Engine Governing		Fuel Pump Type	Engine Driven Gear
Governor	Electronic Isochronous	Injector Type	Mechanical
Frequency Regulation (Steady State)	+/- 0.25%	Fuel Supply Line mm (in)	12.7 (0.5) NPT
Lubrication System		Fuel Return Line mm (in)	12.7 (0.5) NPT
Oil Pump Type	Gear	- · · · · · · · · · · · · · · · · ·	
Oil Filter Type	Full Flow	Engine Electrical System	
Crankcase Capacity - L (qts)	13.6 (14.4)	System Voltage	12 VDC
		Battery Charging Alternator	20 A
		Battery Size	See Battery Index 0161970SBY
		Battery Voltage	12 VDC
		Ground Polarity	Negative

ALTERNATOR SPECIFICATIONS

Standard Model	390
Poles	4
Field Type	Revolving
Insulation Class - Rotor	Н
Insulation Class - Stator	Н
Total Harmonic Distortion	<3%
Telephone Interference Factor (TIF)	< 50

Standard Excitation	Synchronous Brushless
Bearings	One-Pre Lubed & Sealed
Coupling	Direct, Flexible Disc
Load Capacity - Standby	100%
Prototype Short Circuit Test	Yes
Voltage Regulator Type	Digital
Number of Sensed Phases	3
Regulation Accuracy (Steady State)	±0.25%

OPERATING DATA

POWER RATINGS

	Standby		
Single-Phase 120/240 VAC @1.0pf	80 kW	Amps:	333
Three-Phase 120/208 VAC @0.8pf	80 kW	Amps:	278
Three-Phase 120/240 VAC @0.8pf	80 kW	Amps:	241
Three-Phase 277/480 VAC @0.8pf	80 kW	Amps:	120
Three-Phase 346/600 VAC @0.8pf	80 kW	Amps:	96

STARTING CAPABILITIES (sKVA)

sKVA vs. Voltage Dip

			480 VAC					208/24	10 VAC				
<u>Alternator</u>	<u>kW</u>	10%	15%	20%	25%	30%	35%	10%	15%	20%	25%	30%	35%
Standard	80	59	88	117	147	176	205	44	66	88	110	132	154
Upsize 1	100	79	118	157	197	236	275	59	89	118	148	177	206
Upsize 2	130	116	174	232	290	348	406	87	131	174	218	261	305

FUEL CONSUMPTION RATES*

Diesel - gal/hr (l/hr)

INDUSTRIAL

Fuel Pump Lift - ft (m)	Percent Load	Standby
3 (1)	25%	2.1 (7.9)
	50%	3.7 (14.0)
Total Fuel Pump Flow (Combustion + Return)	75%	5.2 (19.7)
13.6 gal/hr	100%	6.3 (23.8)

^{*} Fuel supply installation must accommodate fuel consumption rates at 100% load.

COOLING

		Standby
Coolant Flow per Minute	gal/min (l/min)	32.7 (123.8)
Coolant System Capacity	gal (L)	4.5 (17.44)
Heat Rejection to Coolant	BTU/hr	232,270
Inlet Air	cfm (m³/hr)	6360 (180)
Max. Operating Radiator Air Temp	Fo (Co)	122 (50)
Max. Ambient Temperature (before derate)	Fo (Co)	104 (40)
Maximum Radiator Backpressure	in H ₂ O	0.5

COMBUSTION AIR REQUIREMENTS

		Standby
Flow at Rated Power	cfm (m³/min)	306 (8.67)


ENGINE			EXHAUST		
		Standby			Standby
Rated Engine Speed	rpm	1800	Exhaust Flow (Rated Output)	cfm (m³/min)	782 (22.14)
Horsepower at Rated kW**	hp	131	Max. Backpressure (Post Silencer)	inHg (Kpa)	1.5 (5.1)
Piston Speed	ft/min (m/min)	1559 (475)	Exhaust Temp (Rated Output)	°F (°C)	887 (475)
BMEP	psi	210	Exhaust Outlet Size (Open Set)	mm (in)	76.2 (3.0)


^{**} Refer to "Emissions Data Sheet" for maximum bHP for EPA and SCAQMD permitting purposes.


EPA Certified Stationary Emergency


DIMENSIONS AND WEIGHTS*




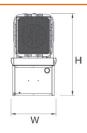


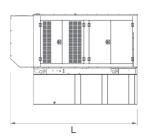


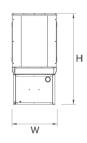

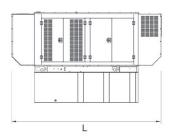

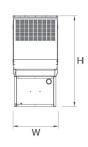

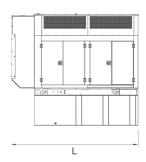

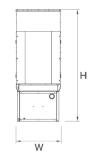

YOUR FACTORY RECOGNIZED GENERAC INDUSTRIAL DEALER

OPEN SET

RUN TIME HOURS	USABLE CAPACITY GAL (L)	L x W x H in (mm)	WT lbs (kg) - Tank & Open Set
NO TANK	-	93 (2362.2) x 40 (1016) x 49 (1244.6)	2425 (1100)
13	79 (299)	93 (2362.2) x 40 (1016) x 62 (1574.8)	2947 (1201)
30	189 (715.4)	93 (2362.2) x 40 (1016) x 74 (1879.6)	3183 (1444)
48	300 (1135.6)	93 (2362.2) x 40 (1016) x 86 (2184.4)	3407 (1545)
56	350 (1325)	110 (2794) x 40 (1016) x 86 (2184.4)	NA
81	510 (1930.5)	117 (2971.8) x 47 (1193.8) x 86 (2184.4)	3790 (1719)
93	589 (2229.6)	128 (3251.2) x 49 (1244.6) x 86 (2184.4)	4269 (1936)

STANDARD ENCLOSURE

RUN TIME USABLE CAPACITY	L v W v H in /mm\	WT lbs (kg) - Enclosure Only		
HOURS	GAL (L)	L x W x H in (mm)	Steel	Aluminum
NO TANK	-	112 (2844.8) x 41 (1041.4) x 56 (1422.4)	_	
13	79 (299)	112 (2844.8) x 41 (1041.4) x 69 (1752.6)		
30	189 (715.4)	112 (2844.8) x 41 (1041.4)x 81 (2057.4)	_	
48	300 (1135.6)	112 (2844.8) x 41 (1041.4) x 93 (2362.2)	425 (193)	155 (70)
56	350 (1325)	112 (2844.8) x 41 (1041.4) x 93 (2362.2)	_	
81	510 (1930.5)	117 (2971.8) x 47 (1193.8) x 93 (2362.2)	_	
93	589 (2229.6)	128 (3251.2) x 49 (1244.6) x 93 (2362.2)		

LEVEL 1 ACOUSTIC ENCLOSURE

RUN TIME USABLE CAPACITY	L v W v II in (mm)	WT lbs (kg) - Enclosure Only		
HOURS	GAL (L)	L x W x H in (mm)	Steel	Aluminum
NO TANK	-	130 (3302) x 41 (1041.4) x 56 (1422.4)	_	
13	79 (299)	130 (3302) x 41 (1041.4) x 69 (1752.6)	_	
30	189 (715.4)	130 (3302) x 41 (1041.4) x 81 (2057.4)	_	
48	300 (1135.6)	130 (3302) x 41 (1041.4) x 93 (2362.2)	450 (204)	285 (129)
56	350 (1325)	130 (3302) x 41 (1041.4) x 93 (2362.2)		
81	510 (1930.5)	130 (3302) x 47 (1193.8) x 93 (2362.2)	_	
93	589 (2229.6)	130 (3302) x 49 (1244.6) x 93 (2362.2)	_	

LEVEL 2 ACOUSTIC ENCLOSURE

RUN TIME USABLE CAPACITY GAL (L)		Lower Life (com)	WT lbs (kg) - Enclosure Only		
	L x W x H in (mm)	Steel	Aluminum		
NO TANK	-	112 (2844.8) x 41 (1041.4) x 69 (1752.6)			
13	79 (299)	112 (2844.8) x 41 (1041.4) x 82 (2082.8)			
30	189 (715.4)	112 (2844.8) x 41 (1041.4) x 94 (2387.6)			
48	300 (1135.6)	112 (2844.8) x 41 (1041.4) x 106 (2692.4)	625 (284)	395 (180)	
56	350 (1325)	112 (2844.8) x 41 (1041.4) x 106 (2692.4)			
81	510 (1930.5)	117 (2971.8) x 47 (1193.8) x 106 (2692.4)			
93	589 (2229.6)	128 (3251.2) x 49 (1244.6) x 106 (2692.4)			

^{*}All measurements are approximate and for estimation purposes only. Sound dBA can be found on the sound data sheet. Enclosure Only weight is added to Tank & Open Set weight to determine total weight.

Specification characteristics may change without notice. Dimensions and weights are for preliminary purposes only. Please consult a Generac Power Systems Industrial Dealer for detailed installation drawings.

Margie Weber

From: TrackingUpdates@fedex.com

Sent: Thursday, December 16, 2021 11:39 AM

To: Margie Weber

Subject: FedEx Shipment 775506724407: Your package has been delivered



Hi. Your package was delivered Thu, 12/16/2021 at 11:37am.



Delivered to 196 N MAIN ST, SOUTHINGTON, CT 06489 Received by M.EDWARDS

OBTAIN PROOF OF DELIVERY

TRACKING NUMBER <u>775506724407</u>

FROM NB+C

1777 Sentry Parkway W

Veva 17 Ste 400

BLUE BELL, PA, US, 19422

TO Town of Southington

Maryellen Edwards Municipal Center 196 N. Main Street

SOUTHINGTON, CT, US, 06489

REFERENCE 100510 / 302475

SHIPPER REFERENCE 100510 / 302475

SHIP DATE Wed 12/15/2021 03:53 PM

DELIVERED TO Receptionist/Front Desk

PACKAGING TYPE FedEx Envelope

ORIGIN BLUE BELL, PA, US, 19422


DESTINATION SOUTHINGTON, CT, US, 06489

SPECIAL HANDLING Deliver Weekday

NUMBER OF PIECES 1

TOTAL SHIPMENT WEIGHT 0.50 LB

SERVICE TYPE FedEx Priority Overnight

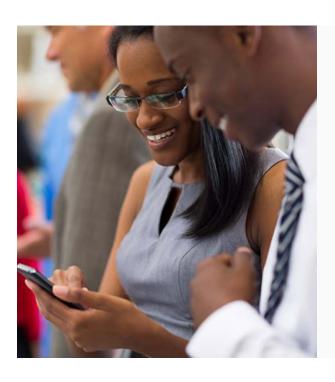

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Margie Weber

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Sent: Thursday, December 16, 2021 12:31 PM

To: Margie Weber

Subject: FedEx Shipment 775506687041: Your package has been delivered



Hi. Your package was delivered Thu, 12/16/2021 at 12:28pm.



Delivered to 75 MAIN ST, SOUTHINGTON, CT 06489

Received by R.POST

OBTAIN PROOF OF DELIVERY

TRACKING NUMBER <u>775506687041</u>

FROM NB+C

1777 Sentry Parkway W

Veva 17 Ste 400

BLUE BELL, PA, US, 19422

TO Town of Southington

Victoria Triano 75 Main Street

SOUTHINGTON, CT, US, 06489

REFERENCE 100510 / 302475

1

SHIPPER REFERENCE 100510 / 302475

SHIP DATE Wed 12/15/2021 03:53 PM

DELIVERED TO Receptionist/Front Desk

PACKAGING TYPE FedEx Envelope


ORIGIN BLUE BELL, PA, US, 19422

DESTINATION SOUTHINGTON, CT, US, 06489

NUMBER OF PIECES 1

TOTAL SHIPMENT WEIGHT 0.50 LB

SERVICE TYPE FedEx Priority Overnight

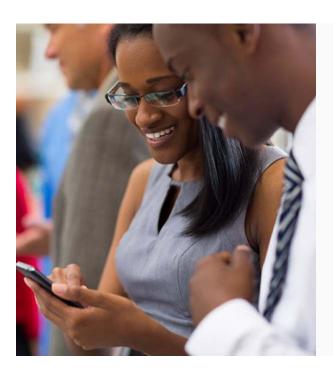

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