From: Karin Turner < kturner@qualtekwireless.com>

Sent: Tuesday, April 20, 2021 3:44 PM

**To:** CSC-DL Siting Council <Siting.Council@ct.gov>

Cc: Siyuan Liu <sliu@qualtekwireless.com>; David Cooper <dcooper@qualtekwireless.com>; Kevin

Bettencourt < kbettencourt@qualtekwireless.com>; ATT Closeouts

<attcloseouts@empiretelecomm.com>

Subject: EM-CING-130-200925 - 133 Horse Fence Hill Road, Southbury, CT - CT2126/LTE 5C

Good Afternoon,

We have completed the AT&T modifications on the existing telecommunications facilities at the subject site and are looking to close the CSC Permit. Attached is the FCCA/SSI.

Should you require any additional information, please let us know.

Thank you.

Karin

Karin L. Turner / Construction Operations Specialist / 978.437.0443 / <a href="mailto:kturner@qualtekwireless.com">kturner@qualtekwireless.com</a>
11 Northeastern Blvd, Suite 102, Nashua, NH 03062



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April 15, 2021

To: Town of Southbury

501 Main Street South Southbury, CT 06488

Re: ATC Site Name: SOUTHBURY

ATC Site Number: 302519
AT&T Site Name: SOUTHBURY

ATC Site Address: 133 HORSE FENCE HILL RD

**SOUTHBURY, CT 06488** 

To whom it may concern,

AT&T installed at the telecommunications facility at the above location. We have reviewed the provided construction photos and As-Built Drawings and have provided comments on the installation in the following summary. The installation was found to be in compliance with the issued construction drawings and applicable building codes.

#### **Equipment Removed:**

(3) antennas, (3) TTAs

#### Equipment Installed:

• (3) antennas, (6) RRHs, (1) squid, (2) DC trunks

#### **Discrepancy Note:**

- New antennas were installed at 156', while CDs depict a RAD of 153'.
- (3) antennas were removed. However, this was not indicated in the CDs.
- As-built CDs include mount modifications. However, revised mod drawings were issued based on reduced loading.
- These items have been reviewed by the EOR and no action is required.

Please contact Patrick Barry, PE with any questions regarding this matter.

Thank you,

**American Tower Corporation** 

Patrick P. Barry, PE Director, Architectural Engineering

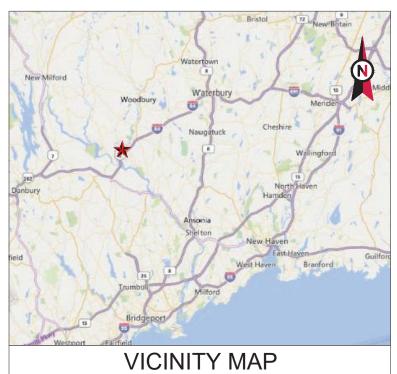




Photo	Description
2126 BETA POS 1 156 AZ 135 M .T. 0	Description: Antenna Tape Drop:  • Installation at RAD 156'  Note: Construction drawings depict a RAD of 153'  Recommendation: No Action Required
	Description: Installation of Equipment:
	<ul> <li>Description: Installation of Equipment:         <ul> <li>(1) new antenna and (2) new RRHs (typical all sectors)</li> </ul> </li> <li>Recommendation:         <ul> <li>No Action Required</li> </ul> </li> </ul>



## As-Built Drawings & Revised Mount Modification Drawings



#### CURRENT PROJECTS:

LTE 5C - PACE #: MRCTB046858 4TX4RX - PACE #: MRCTB046678 5G NR - PACE #: MRCTB046654



#### **AMERICAN TOWER®**

ATC SITE NAME: SOUTHBURY ATC SITE NUMBER: 302519

AT&T PACE NUMBER: MRCTB046858, MRCTB046678, AND MRCTB046654

AT&T SITE ID: CTV2126 AT&T FA CODE:10035064

AT&T SITE NAME: SOUTHBURY

SITE ADDRESS: 133 HORSE FENCE HILL RD

SOUTHBURY, CT 06488

### AT&T MOBILITY ANTENNA AMENDMENT PLAN



**LOCATION MAP** 

#### **COMPLIANCE CODE** PROJECT SUMMARY PROJECT DESCRIPTION SHEET INDEX SHEET THE PROPOSED PROJECT INCLUDES MODIFYING GROUND BASED ALL WORK SHALL BE PERFORMED AND MATERIALS INSTALLED SITE ADDRESS: DESCRIPTION REV: DATE: BY: IN ACCORDANCE WITH THE CURRENT EDITIONS OF THE AND TOWER MOUNTED EQUIPMENT AS INDICATED PER BELOW: 133 HORSE FENCE HILL RD FOLLOWING CODES AS ADOPTED BY THE LOCAL TITLE SHEET 0 TC GOVERNMENT AUTHORITIES. NOTHING IN THESE PLANS IS SOUTHBURY, CT 06488 TO BE CONSTRUED TO PERMIT WORK NOT CONFORMING TO REMOVE (3) TT19-08BP111-001 TTA(s) G-002 **GENERAL NOTES** 08/17/20 TC 0 COUNTY: NEW HAVEN INSTALL (3) DMP65R-BU6DA ANTENNA(s), (3) 4449 B5/B12 RRH(s), (3) C-101 DETAILED SITE PLAN Ω 08/17/20 TC 1. INTERNATIONAL BUILDING CODE (IBC) GEOGRAPHIC COORDINATES: RRUS-32 B66A RRH(s), (3) DBC0061F1V51-2 DIPLEXER(s), (1) 2. NATIONAL ELECTRIC CODE (NEC) DC6-48-60-18-8F SQUID, (2) #6 AWG DC TRUNKS, (1) 2" CONDUIT C-102 DETAILED EQUIPMENT LAYOUT 08/17/20 TC 0 LATITUDE: 41.45997222 3 LOCAL BUILDING CODE C-201 TOWER ELEVATION 08/17/20 TC 4. CITY/COUNTY ORDINANCES LONGITUDE: -73.245 EXISTING (3) 7770 ANTENNA(s), (3) QS66512-2 ANTENNA(s), (3) GROUND ELEVATION: 346' AMSL RE SCHEDULE AND ANTENNA INSTALLATION TC HPA-65R-BUU-H6 ANTENNA(s), (3) 4478 B14 RRH(s), (3) RRUS-32 B2 C-401 08/17/20 RRH(s), (3) RRUS-11 B12 RRH(s), (3) RRUS-32 B30 RRH(s), (3) C-501 CONSTRUCTION DETAILS 0 08/17/20 TC TT19-08BP111-001 TTA(s), 6 DBC0061F1V51-1 COMBINER(s), (2) DC6-48-60-18-8F SQUID(s), (4) #8 AWG DC TRUNKS, (2) 18 PAIR FIBER E-501 **GROUNDING DETAILS** 08/17/20 TRUNK(s), (12) 1-1/4" COAX CABLES, AND (2) 2" CONDUIT TO REMAIN R-601 SUPPLEMENTAL GROUND: PROJECT TEAM R-602 SUPPLEMENTAL INSTALL (2) 6630 BBU, IDLE CABLE, AND NETSURE 7100 SUPPLEMENTAL R-603 TOWER OWNER: PROJECT NOTES APPLICANT: R-604 SUPPLEMENTAL AMERICAN TOWER AT&T MOBILITY THE FACILITY IS UNMANNED. 10 PRESIDENTIAL WAY SUPPLEMENTAL A TECHNICIAN WILL VISIT THE SITE APPROXIMATELY ONCE R-605 WOBURN, MA 01801 A MONTH FOR ROUTINE INSPECTION AND MAINTENANCE. UTILITY COMPANIES S1 TITLE SHEET THE PROJECT WILL NOT RESULT IN ANY SIGNIFICANT LAND ENGINEER: DISTURBANCE OR EFFECT OF STORM WATER DRAINAGE POWER COMPANY: CONNECTICUT LIGHT & POWER S2 **GENERAL NOTES** NO SANITARY SEWER, POTABLE WATER OR TRASH ATC TOWER SERVICES, LLC PHONE: (800) 286-2000 DISPOSAL IS REQUIRED. 3500 REGENCY PKWY STE 100 HANDICAP ACCESS IS NOT REQUIRED. S3 ANTENNA PLATFORM MODIFICATION CARY, NC 27518 TELEPHONE COMPANY: FRONTIER COMMUNICATIONS S4 NECESSARY PARTS PHONE: (800) 921-8102 PROPERTY OWNER: PROJECT LOCATION DIRECTIONS LYNN SMITH FAMILY TRUST SOUTHBURY, CT 06488 FROM HARTFORD TAKE I-84 WEST TO EXIT 14. TAKE A RIGHT OFF EXIT, TAKE 3RD LEFT ON HORSE FENCE HILL RD. HALFWAY UP HILL LOOK FOR A GROUP OF 3 MAILBOXES ON LEFT, ONE WILL BE 113. FOLLOW DRIVEWAY TO END PAST LAST HOUSE TURN LEFT AFTER TREES. CHAIN AT BEGINNING OF Know what's below. ACCESS ROAD AT THAT POINT Call before you dig.



A.T. ENGINEERING SERVICE, PLLC

3500 REGENCY PARKWAY SUITE 100 CARY, NC 27518 PHONE: (919) 468-0112 COA: PEC.0001553

THESE DRAWINGS AND/OR THE ACCOMPANYING SPECIFICATION AS INSTRUMENTS OR SERVICE ARE THE EXCLUSIVE PROPERTY OF AMERICAN TOWER. THEIR USE AND PUBLICATION SHALL BE RESTRICTED TO THE ORIGINAL SITE FOR WHICH THEY ARE PEPARED. ANY USE OR DISCLOSURE OTHER THAN THAT WHICH RELATES TO AMERICAN TOWER OR THE SPECIFIED CARRIER IS STRICTLY PROHIBITED. TITLE TO THESE DOCUMENTS SHALL REMAIN THE PROPERTY OF AMERICAN TOWER WHETHER OR NOT THE PROJECT IS EXECUTED. NEITHER THE ARCHITECT NOR THE ENGINEER WILL BE PROVIDING ON-SITE CONSTRUCTION REVIEW OF THIS PROJECT CONTRACTORIS) MUST VERIFY ALL DIMENSIONS AND ADVISE AMERICAN TOWER OF ANY DISCREPANCIES. ANY PRIOR ISSUANCE OF THIS DRAWING IS SUPERSEDED BY THE LATEST VERSION ON FILE WITH AMERICAN TOWER.

REV.	DESCRIPTION	BY	DATE
<u> </u>	FOR CONSTRUCTION	TC	08/17/20
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	REV.	^	_

ATC SITE NUMBER:

302519

ATC SITE NAME:

SOUTHBURY

AT&T MOBILITY SITE NAME:

SOUTHBURY

SITE ADDRESS: 133 HORSE FENCE HILL RD SOUTHBURY, CT 06488

SEAL





DATE DRAWN:	08/17/20
ATC JOB NO:	13212284_G3
CUSTOMER ID:	SOUTHBURY
CUSTOMER #:	10035064

TITLE SHEET

G-001

REVISION

#### **GENERAL CONSTRUCTION NOTES:**

- OWNER FURNISHED MATERIALS, AT&T MOBILITY "THE COMPANY" WILL PROVIDE AND THE  $\,$  22. CONTRACTOR WILL INSTALL
- A. BTS EQUIPMENT FRAME (PLATFORM) AND ICEBRIDGE SHELTER (GROUND BUILD/CO-LOCATE ONLY)
- AC/TELCO INTERFACE BOX (PPC)
- C. ICE BRIDGE (CABLE TRAY WITH COVER) (GROUND BUILD/CO-LOCATE ONLY, GC TO FURNISH AND INSTALL FOR ROOFTOP INSTALLATION)
- D. TOWERS, MONOPOLES TOWER LIGHTING
- GENERATORS & LIQUID PROPANE TANK
- ANTENNA STANDARD BRACKETS, FRAMES AND PIPES FOR MOUNTING
- ANTENNAS (INSTALLED BY OTHERS)
- TRANSMISSION LINE
- TRANSMISSION LINE JUMPERS
- TRANSMISSION LINE CONNECTORS WITH WEATHERPROOFING KITS
- TRANSMISSION LINE GROUND KITS
- HANGERS
- HOISTING GRIPS
- O. BTS EQUIPMENT
- THE CONTRACTOR IS RESPONSIBLE TO PROVIDE ALL OTHER MATERIALS FOR THE COMPLETE INSTALLATION OF THE SITE INCLUDING, BUT NOT LIMITED TO, SUCH
  MATERIALS AS FENCING, STRUCTURAL STEEL SUPPORTING SUB-FRAME FOR PLATFORM ROOFING LABOR AND MATERIALS, GROUNDING RINGS, GROUNDING WIRES. COPPER-CLAD OR XIT CHEMICAL GROUND ROD(S), BUSS BARS, TRANSFORMERS AND DISCONNECT SWITCHES WHERE APPLICABLE, TEMPORARY ELECTRICAL POWER, CONDUIT, LANDSCAPING COMPOUND STONE, CRANES, CORE DRILLING, SLEEPERS AND RUBBER MATTING, REBAR, CONCRETE CAISSONS, PADS AND/OR AUGER MOUNTS, MISCELLANEOUS FASTENERS, CABLE TRAYS, NON-STANDARD ANTENNA FRAMES AND ALL OTHER MATERIAL AND LABOR REQUIRED TO COMPLETE THE JOB ACCORDING TO THE DRAWINGS AND SPECIFICATIONS. IT IS THE POSITION OF AT&T MOBILITY TO APPLY FOR PERMITTING AND CONTRACTOR RESPONSIBLE FOR PICKUP AND PAYMENT OF
- ALL WORK SHALL CONFORM TO ALL CURRENT APPLICABLE FEDERAL, STATE, AND LOCAL CODES, INCLUDING ANSI/EIA/TIA-222, AND COMPLY WITH ATC CONSTRUCTION
- CONTRACTOR SHALL CONTACT LOCAL 811 FOR IDENTIFICATION OF UNDERGROUND
- CONTRACTOR SHALL BE RESPONSIBLE FOR COORDINATING ALL REQUIRED
- ALL DIMENSIONS TO, OF, AND ON EXISTING BUILDINGS, DRAINAGE STRUCTURES, AND SITE IMPROVEMENTS SHALL BE VERIFIED IN FIELD BY CONTRACTOR WITH ALL DISCREPANCIES REPORTED TO THE ENGINEER.
- DO NOT CHANGE SIZE OR SPACING OF STRUCTURAL ELEMENTS
- DETAILS SHOWN ARE TYPICAL; SIMILAR DETAILS APPLY TO SIMILAR CONDITIONS UNLESS 32.
- THESE DRAWINGS DO NOT INCLUDE NECESSARY COMPONENTS FOR CONSTRUCTION SAFETY WHICH SHALL BE THE SOLE RESPONSIBILITY OF THE CONTRACTOR
- CONTRACTOR SHALL BRACE STRUCTURES UNTIL ALL STRUCTURAL ELEMENTS NEEDED 33. FOR STABILITY ARE INSTALLED. THESE ELEMENTS ARE AS FOLLOWS: LATERAL BRACING,
- CONTRACTOR SHALL DETERMINE EXACT LOCATION OF EXISTING UTILITIES, GROUNDS DRAINS, DRAIN PIPES, VENTS, ETC, BEFORE COMMENCING WORK
- INCORRECTLY FABRICATED, DAMAGED, OR OTHERWISE MISFITTING OR NONCONFORMING MATERIALS OR CONDITIONS SHALL BE REPORTED TO THE AT&T MOBILITY REP PRIOR TO REMEDIAL OR CORRECTIVE ACTION. ANY SUCH REMEDIAL ACTION SHALL REQUIRE WRITTEN APPROVAL BY THE AT&T MOBILITY REP PRIOR TO
- EACH CONTRACTOR SHALL COOPERATE WITH THE AT&T MOBILITY REP, AND COORDINATE HIS WORK WITH THE WORK OF OTHERS.
- CONTRACTOR SHALL REPAIR ANY DAMAGE CAUSED BY CONSTRUCTION OF THIS PROJECT TO MATCH EXISTING PRE-CONSTRUCTION CONDITIONS TO THE SATISFACTION OF THE AT&T MOBILITY CONSTRUCTION MANAGER.
- ALL CABLE/CONDUIT ENTRY/EXIT PORTS SHALL BE WEATHERPROOFED DURING
- WHERE EXISTING CONDITIONS DO NOT MATCH THOSE SHOWN IN THIS PLAN SET, CONTRACTOR SHALL NOTIFY THE AT&T MOBILITY REP AND ENGINEER OF RECORD
- CONTRACTOR SHALL ENSURE ALL SUBCONTRACTORS ARE PROVIDED WITH A COMPLETE AND CURRENT SET OF DRAWINGS AND SPECIFICATIONS FOR THIS PROJECT.
- CONTRACTOR SHALL REMOVE ALL RUBBISH AND DEBRIS FROM THE SITE AT THE END OF
- CONTRACTOR SHALL COORDINATE WORK SCHEDULE WITH AMERICAN TOWER CORPORATION (ATC) AND TAKE PRECAUTIONS TO MINIMIZE IMPACT AND DISRUPTION OF OTHER OCCUPANTS OF THE FACILITY.
- CONTRACTOR SHALL FURNISH AT&T MOBILITY AND AMERICAN TOWER CORPORATION (ATC) WITH A PDF MARKED UP AS-BUILT SET OF DRAWINGS UPON COMPLETION OF
- PRIOR TO SUBMISSION OF BID, CONTRACTOR SHALL COORDINATE WITH AT&T MOBILITY REP TO DETERMINE WHAT, IF ANY, ITEMS WILL BE PROVIDED. ALL ITEMS NOT PROVIDED SHALL BE PROVIDED AND INSTALLED BY THE CONTRACTOR. CONTRACTOR WILL INSTALL 2. ALL EXTERIOR #6 GREED GROUND WIRE "DAISY CHAIN" CONNECTIONS ARE TO BE

- ALL ITEMS PROVIDED.
- PRIOR TO SUBMISSION OF BID. CONTRACTOR SHALL COORDINATE WITH AT&T MOBILITY REP TO DETERMINE IF ANY PERMITS WILL BE OBTAINED BY CONTRACTOR. ALL
  REQUIRED PERMITS NOT OBTAINED BY AT&T MOBILITY MUST BE OBTAINED, AND PAID FOR, BY THE CONTRACTOR
- 23. CONTRACTOR SHALL INSTALL ALL SITE SIGNAGE IN ACCORDANCE WITH AT&T MOBILITY
- CONTRACTOR SHALL SUBMIT ALL SHOP DRAWINGS TO AT&T MOBILITY FOR REVIEW AND APPROVAL PRIOR TO FABRICATION.
- 25. ALL EQUIPMENT SHALL BE INSTALLED ACCORDING TO MANUFACTURER'S SPECIFICATIONS AND LOCATED ACCORDING TO AT&T MOBILITY SPECIFICATIONS, AND AS SHOWN IN THESE PLANS.
- THE CONTRACTOR SHALL SUPERVISE AND DIRECT THE PROJECT DESCRIBED HEREIN. THE CONTRACTOR SHALL BE SOLELY RESPONSIBLE FOR ALL THE CONSTRUCTION MEANS, METHODS, TECHNIQUES, SEQUENCES AND PROCEDURES AND FOR COORDINATING ALL PORTIONS OF THE WORK UNDER THE CONTRACT.
- 27. CONTRACTOR SHALL NOTIFY AT&T MOBILITY REP A MINIMUM OF 48 HOURS IN ADVANCE OF POURING CONCRETE OR BACKFILLING ANY UNDERGROUND UTILITIES, FOUNDATIONS OR SEALING ANY WALL, FLOOR OR ROOF PENETRATIONS FOR ENGINEERING REVIEW
- CONTRACTOR SHALL BE RESPONSIBLE FOR SITE SAFETY INCLUDING COMPLIANCE WITH ALL APPLICABLE OSHA STANDARDS AND RECOMMENDATIONS AND SHALL PROVIDE ALL NECESSARY SAFETY DEVICES INCLUDING PPE AND PPM AND CONSTRUCTION DEVICES SUCH AS WELDING AND FIRE PREVENTION, TEMPORARY SHORING, SCAFFOLDING RENCH BOXES/SLOPING, BARRIERS, ETC.
- THE CONTRACTOR SHALL PROTECT AT HIS OWN EXPENSE, ALL EXISTING FACILITIES AND SUCH OF HIS NEW WORK LIABLE TO INJURY DURING THE CONSTRUCTION PERIOD. ANY DAMAGE CAUSED BY NEGLECT ON THE PART OF THIS CONTRACTOR OR HIS REPRESENTATIVES, OR BY THE ELEMENTS DUE TO NEGLECT ON THE PART OF THIS CONTRACTOR OR HIS REPRESENTATIVES. FITHER TO THE EXISTING WORK, OR TO HIS WORK OR THE WORK OF ANY OTHER CONTRACTOR, SHALL BE REPAIRED AT HIS EXPENSE TO THE OWNER'S SATISFACTION.
- 30. ALL WORK SHALL BE INSTALLED IN A FIRST CLASS, NEAT AND WORKMANLIKE MANNER BY MECHANICS SKILLED IN THE TRADE INVOLVED. THE QUALITY OF WORKMANSHIP SHALL BE SUBJECT TO THE APPROVAL OF THE AT&T MOBILITY REP. ANY WORK FOUND BY THE AT&T MOBILITY, REP TO BE OF INFERIOR QUALITY AND/OR WORKMANSHIP SHALL BE REPLACED AND/OR REWORKED AT CONTRACTOR EXPENSE UNTIL APPROVAL IS
- IN ORDER TO ESTABLISH STANDARDS OF QUALITY AND PERFORMANCE, ALL TYPES OF MATERIALS LISTED HEREINAETER BY MANUFACTURER'S NAMES AND/OF MANUFACTURER'S CATALOG NUMBER SHALL BE PROVIDED BY THESE MANUFACTURERS
- AT&T MOBILITY FURNISHED EQUIPMENT SHALL BE PICKED-UP AT THE AT&T MOBILITY WAREHOUSE, NO LATER THAN 48HR AFTER BEING NOTIFIED INSURED, STORED, UNCRATE, PROTECTED AND INSTALLED BY THE CONTRACTOR WITH ALL APPURTENANCES REQUIRED TO PLACE THE EQUIPMENT IN OPERATION. READY FOR USE. THE CONTRACTOR SHALL BE RESPONSIBLE FOR THE EQUIPMENT AFTER PICKING IT
- AT&T MOBILITY OR HIS ARCHITECT/ENGINEER RESERVES THE RIGHT TO REJECT ANY FOLIPMENT OR MATERIALS WHICH, IN HIS OWN OPINION ARE NOT IN COMPLIANCE WITH THE CONTRACT DOCUMENTS, EITHER BEFORE OR AFTER INSTALLATION AND THE EQUIPMENT SHALL BE REPLACED WITH EQUIPMENT CONFORMING TO THE REQUIREMENTS OF THE CONTRACT DOCUMENTS BY THE CONTRACTOR AT NO COST TO AT&T MOBILITY OR THEIR ARCHITECT/ENGINEER

#### SPECIAL CONSTRUCTION ANTENNA INSTALLATION NOTES:

- WORK INCLUDED
  - ANTENNA AND COAXIAL CABLES ARE FURNISHED BY AT&T MOBILITY UNDER A SEPARATE CONTRACT. THE CONTRACTOR SHALL ASSIST ANTENNA INSTALLATION CONTRACTOR IN TERMS OD COORDINATION AND SITE ACCESS. ERECTION SUBCONTRACTOR SHALL BE RESPONSIBLE FOR THE PROTECTION OF PERSONNEL AND
  - B. INSTALL ANTENNA AS INDICATE ON DRAWINGS AND AT&T MOBILITY
  - C. INSTALL GALVANIZED STEEL ANTENNA MOUNTS AS INDICATED ON DRAWINGS
  - D. INSTALL FURNISHED GALVANIZED STEEL OR ALUMINUM WAVEGUIDE AND PROVIDE PRINTOUT OF THAT TEST.
  - E. CONTRACTOR SHALL PROVIDE FOUR (4) SETS OF SWEEP TESTS USING ANRITZU-PACKARD 8713B RF SCALAR NETWORK ANALYZER. SUBMIT FREQUENCY DOMAIN REFLECTOMETER(FDR) TESTS RESULTS TO THE PROJECT MANAGER. SWEEP TESTS SHALL BE AS PER ATTACHED RFS "MINIMUM FIELD TESTING RECOMMENDED FOR ANTENNA AND HELIAX COAXIAL CABLE SYSTEMS" DATED 10/5/93. TESTING SHALL BE PERFORMED BY AN INDEPENDENT TESTING SERVICE AND BE BOUND AND SUBMITTED WITHIN ONE WEEK OF WORK COMPLETION.
  - INSTALL COAXIAL CABLES AND TERMINATING BETWEEN ANTENNAS AND EQUIPMENT PER MANUFACTURER'S RECOMMENDATIONS. WEATHERPROOF ALL CONNECTIONS RETWEEN THE ANTENNA AND FOLIPMENT PER MANUFACTURER'S REQUIREMENTS. TERMINATE ALL COAXIAL CABLE THREE (3) FEET IN EXCESS OF ENTRY PORT LOCATION UNLESS OTHERWISE STATED.
  - G. ANTENNA AND COAXIAL CABLE GROUNDING:

WEATHER SEALED WITH RFS CONNECTORS/SPLICE WEATHERPROOFING KIT #221213 OR

ALL COAXIAL CABLE GROUNDING KITS ARE TO BE INSTALLED ON STRAIGHT RUNS OF COAXIAL CABLE (NOT WITHIN BENDS)

> ALL DISCREPANCIES FROM WHAT IS SHOWN ON THESE CONSTRUCTION DRAWINGS SHALL BE COMMUNICATED TO ATC ENGINEERING IMMEDIATELY FOR CORRECTION OR RE-DESIGN. FAILURE TO COMMUNICATE DIRECTLY WITH ATC ENGINEERING OR ANY CHANGES FROM THE DESIGN CONDUCTED WITHOUT PRIOR APPROVAL FROM ATC ENGINEERING SHALL BE THE SOLE RESPONSIBILITY OF THE GENERAL CONTRACTOR.



A.T. ENGINEERING SERVICE. PLLC 3500 REGENCY PARKWAY SUITE 100 **CARY, NC 27518** PHONE: (919) 468-0112 COA: PEC.0001553

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REV.	DESCRIPTION	BY	DATE
<u></u>	FOR CONSTRUCTION	TC	08/17/20
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ATC SITE NUMBER:

302519

ATC SITE NAME:

SOUTHBURY

AT&T MOBILITY SITE NAME:

SOUTHBURY

SITE ADDRESS: 133 HORSE FENCE HILL RD SOUTHBURY, CT 06488





DATE DRAWN: | 08/17/20 ATC JOB NO: 13212284 G3 CUSTOMER ID: SOUTHBURY CUSTOMER #: 10035064

**GENERAL NOTES** 

SHEET NUMBER

G-002


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#### SITE PLAN NOTES:

- 1. THIS SITE PLAN REPRESENTS THE BEST PRESENT KNOWLEDGE AVAILABLE TO THE ENGINEER AT THE TIME OF THIS DESIGN. THE CONTRACTOR SHALL VISIT THE SITE PRIOR TO CONSTRUCTION AND VERIFY ALL EXISTING CONDITIONS RELATED TO THE SCOPE OF WORK FOR THIS PROJECT.
- 2. ICE BRIDGE, CABLE LADDER, COAX PORT, AND COAX CABLE ARE SHOWN FOR REFERENCE ONLY. CONTRACTOR SHALL CONFIRM THE EXACT LOCATION OF ALL PROPOSED AND EXISTING EQUIPMENT AND STRUCTURES DEPICTED ON THIS PLAN. BEFORE UTILIZING EXISTING CABLE SUPPORTS, COAX PORTS, INSTALLING NEW PORTS OR ANY OTHER EQUIPMENT, CONTRACTOR SHALL VERIFY ALL ASPECTS OF THE COMPONENTS MEET THE ATC SPECIFICATIONS.
- 3. THIS PROJECT INCLUDES NO INSTALL OR MODIFICATION AT GRADE.


#### LEGEND

8	GROUNDING TEST WELL
ATS	AUTOMATIC TRANSFER SWITC
В	BOLLARD
CSC	CELL SITE CABINET
D	DISCONNECT
E	ELECTRICAL
F	FIBER
GEN	GENERATOR
G	GENERATOR RECEPTACAL
HH, V	HAND HOLE, VAULT
IB	ICE BRIDGE
K	KENTROX BOX
LC	LIGHTING CONTROL
M	METER
PB	PULL BOX
PP	POWER POLE
T	TELCO
TRN	TRANSFORMER
_ ×	CHAINLINK FENCE

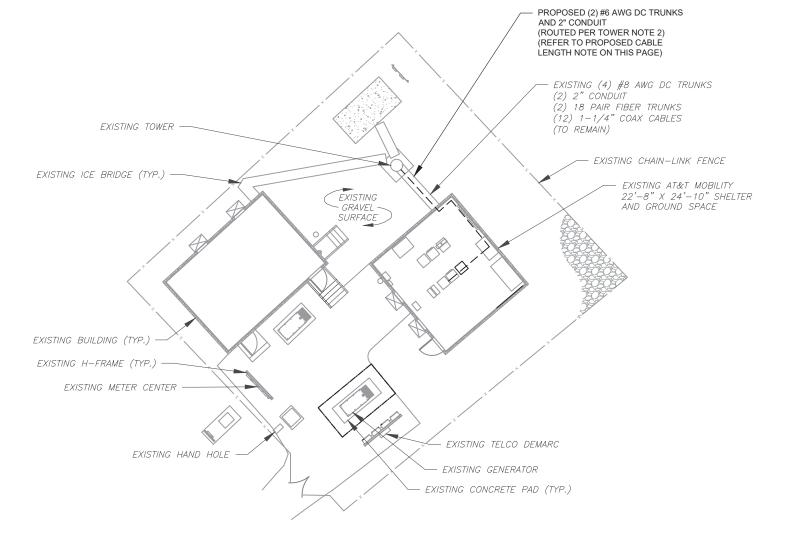

#### PROPOSED CABLE LENGTH:

- 1. ESTIMATED LENGTH OF PROPOSED CABLE IS 190'. ESTIMATED LENGTH OF CABLE WAS PROVIDED BY CUSTOMER OR CALCULATED BY ADDING THE RAD CENTER AND THE DISTANCE FROM THE SHELTER ENTRY PLATE TO THE TOWER (ALONG THE ICE BRIDGE) AND A SAFETY FACTOR MEASUREMENT OF 15% (OF THE TWO PREVIOUS VALUES), CDS DEFER TO GREATEST CABLE LENGTH.
- 2. ROUTE PROPOSED CABLES ALONG SAME PATH AS EXISTING CABLES AND IN ACCORDANCE WITH STRUCTURAL ANALYSIS. IF ADEQUATE SPACE EXISTS, ROUTE CABLES THROUGH ENTRY PORT HOLE, UP INSIDE OF MONOPOLE, AND THROUGH EXIT PORT HOLE. IF ROUTING OUTSIDE THE MONOPOLE, ATTACH CABLES USING STAND-OFF ADAPTERS MOUNTED TO TOWER USING STAINLESS STEEL BANDING. ADEQUATELY SECURE CABLES USING EITHER APPROPRIATELY SIZED STAINLESS STEEL SNAP-INS OR MOUNTING HARDWARE AND BRACKETS AS SPECIFIED BY CABLE MANUFACTURER.

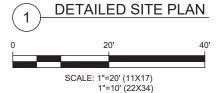





A.T. ENGINEERING SERVICE, PLLC 3500 REGENCY PARKWAY SUITE 100 CARY, NC 27518 PHONE: (919) 468-0112 COA: PEC.0001553

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ATC SITE NUMBER:

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ATC SITE NAME:

#### SOUTHBURY

AT&T MOBILITY SITE NAME:

#### SOUTHBURY

SITE ADDRESS: 133 HORSE FENCE HILL RD SOUTHBURY, CT 06488

SEAL:





П	DATE DRAWN:	08/17/20
П	ATC JOB NO:	13212284_G3
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		ATC JOB NO: CUSTOMER ID:


**DETAILED SITE PLAN** 

SHEET NUMBER:

C-101

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REVISION



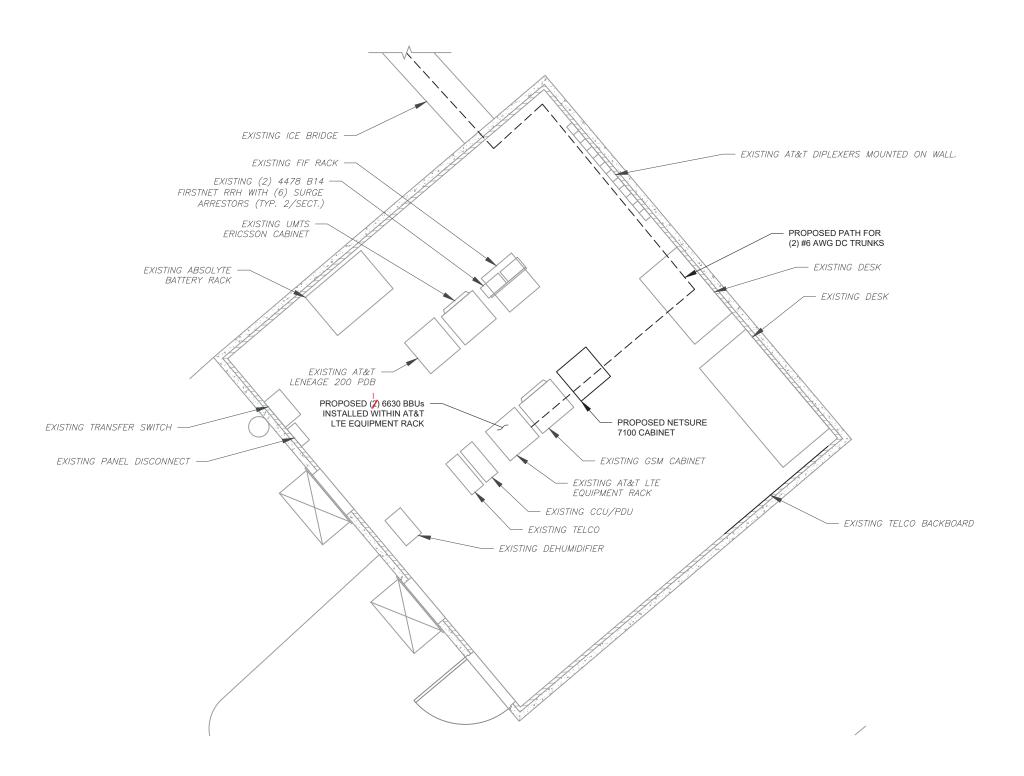



A.T. ENGINEERING SERVICE, PLLC

3500 REGENCY PARKWAY SUITE 100 CARY, NC 27518 PHONE: (919) 468-0112 COA: PEC.0001553

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REV.	DESCRIPTION	BY	DATE
$\triangle_{-}$	FOR CONSTRUCTION	TC	08/17/20
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ATC SITE NUMBER:

302519

ATC SITE NAME:

#### SOUTHBURY

AT&T MOBILITY SITE NAME:

#### SOUTHBURY

SITE ADDRESS: 133 HORSE FENCE HILL RD SOUTHBURY, CT 06488

SEAL






П	DATE DRAWN:	08/17/20
П	ATC JOB NO:	13212284_G3
П	CUSTOMER ID:	SOUTHBURY
П	CUSTOMER #:	10035064

#### DETAILED EQUIPMENT LAYOUT

SHEET NUMBER:

REVISION:

C-102

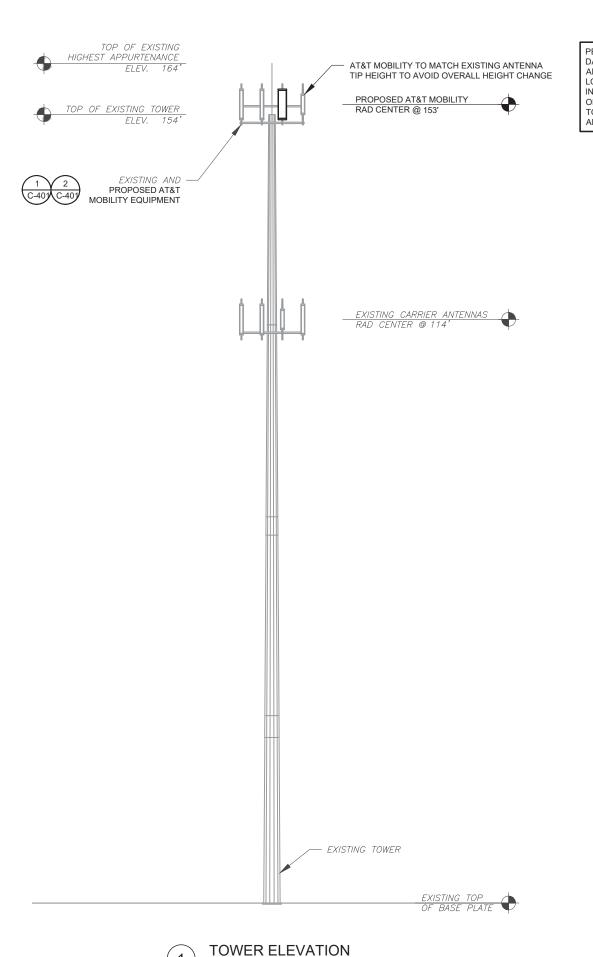

SCALE: N.T.S.

PER MOUNT ANALYSIS COMPLETED BY INFINIGY, DATED 08/04/20, THE EXISTING MOUNT CAN NOT ADEQUATELY SUPPORT THE PROPOSED LOADING. THE MOUNT MODIFICATION PROPOSED IN THE MOUNT ANALYSIS, INCLUDED AT THE END OF THIS PLAN SET, MUST BE INSTALLED PRIOR TO THE INSTALLATION OF THE PROPOSED ANTENNAS AND OTHER EQUIPMENT

TOWER NOTE:

1. IT IS THE CONTRACTOR'S RESPONSIBILITY TO CONFIRM WITH THE AMERICAN TOWER CONSTRUCTION MANAGER THAT THEY HAVE THE MOST RECENT VERSION OF THE STRUCTURAL ANALYSIS BEFORE COMMENCING WORK. EXISTING AND PROPOSED TOWER APPURTENANCES, MOUNTS, AND ANTENNAS ARE SHOWN BASED ON THE STRUCTURAL ANALYSIS.

2. ROUTE PROPOSED CABLES ALONG SAME PATH AS EXISTING CABLES AND IN ACCORDANCE WITH STRUCTURAL ANALYSIS, IF ADEQUATE SPACE EXISTS, ROUTE CABLES THROUGH ENTRY PORT HOLE, UP INSIDE OF MONOPOLE, AND THROUGH EXIT PORT HOLE. IF ROUTING OUTSIDE THE MONOPOLE, ATTACH CABLES USING STAND-OFF ADAPTERS MOUNTED TO TOWER USING STAINLESS STEEL BANDING, ADEQUATELY SECURE CABLES USING FITHER APPROPRIATELY SIZED STAINLESS STEEL SNAP-INS OR MOUNTING HARDWARE AND BRACKETS AS SPECIFIED BY CABLE MANUFACTURER.

TOWER ELEVATIONS ARE MEASURED FROM TOP OF BASE PLATE TO MATCH STRUCTURAL ANALYSIS. ELEVATIONS DO NOT REFLECT TRUE ABOVE GROUND LEVEL (A.G.L.)



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ATC SITE NUMBER:

302519

ATC SITE NAME:

SOUTHBURY

AT&T MOBILITY SITE NAME:

SOUTHBURY

SITE ADDRESS: 133 HORSE FENCE HILL RD SOUTHBURY, CT 06488






DATE DRAWN:	08/17/20
ATC JOB NO:	13212284_G3
CUSTOMER ID:	SOUTHBURY
CUSTOMER #:	10035064

TOWER ELEVATION


SHEET NUMBER:

REVISION:

C-201

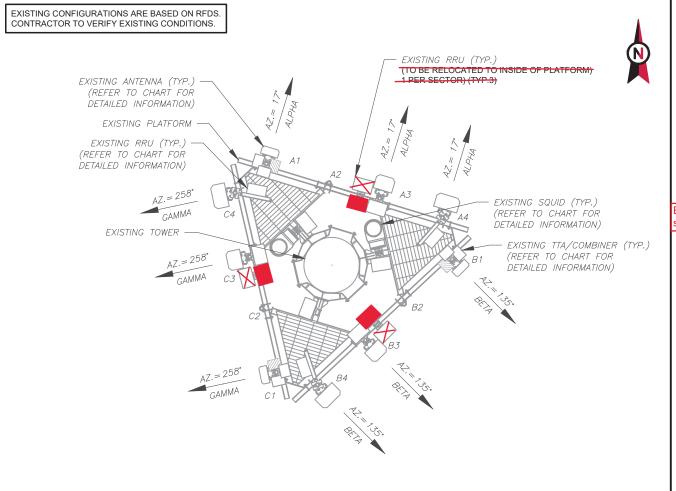

**CURRENT ANTENNA PLAN** 

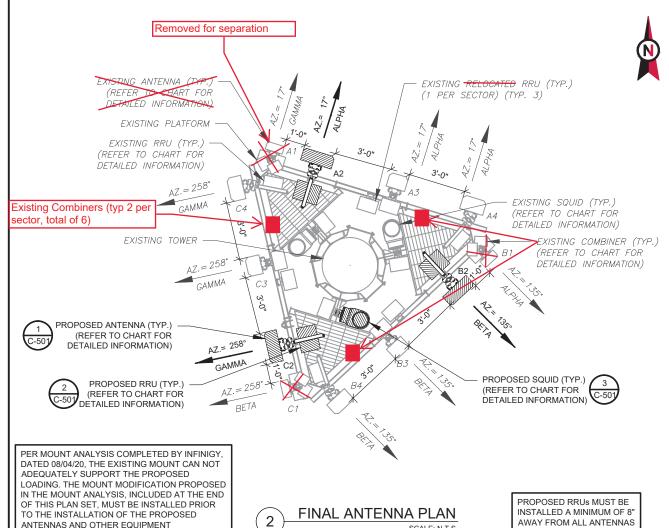

**EXISTING ANTENNA SCHEDULE** LOCATION ANTENNA SUMMARY NON ANTENNA SUMMARY ADDITIONAL TOWER MOUNTED SECTOR RAD ΑZ POS STATUS ANTENNA FOUIPMENT TT19-08BP111-001 7770 850 UMTS RMN DBC0061F1V51-1 RMN DBC0061F1V51-2 RMN 17° A2 ALPHA 153' 4478 B14 RMN A3 QS66512-2 700/1900 LTE RMN RRUS-32 B2 RMN RRUS-11 B12 RMN 44 HPA-65R-BUU-H6 700/WCS LTE RMN RMN RMV TT19-08BP111-00 TT19-08BP111-001 RMN B1 7770 850 UMTS RMN DBC0061F1V51-1 RMN DBC0061F1V51-2 RMN BETA 153' 135° B2 4478 B14 RMN В3 QS66512-2 700/1900 LTE RMN RRUS-32 B2 RMN RRUS-11 B12 RRUS-32 B30 RMN B4 HPA-65R-BUU-H6 700/WCS LTE RMN RMN TT19-08BP111-001 RMV TT19-08BP111-001 RMNC1 7770 850 UMTS DBC0061F1V51-1 RMN DBC0061F1V51-2 RMN GAMMA 153' 258° C2 4478 B14 RMN C3 QS66512-2 700/1900 LTE RRUS-32 B2 RMN RRUS-11 B12 RMN C4 700/WCS LTE RMN HPA-65R-BUU-H6 RRUS-32 B30 RMN

NOTES

1. CONFIRM WITH AT&T MOBILITY
REP FOR APPLICABLE
UPDATES/REVISIONS AND MOST
RECENT RFDS FOR NSN
CONFIGURATION (CONFIG). GC TO
CAP ALL UNUSED PORTS.
2. CONFIRM SPACING OF PROPOSED

EQUIP DOES NOT CAUSE TOWER
CONFLICTS NOR IMPEDE TOWER
CLIMBING PEGS.
3. THE ANTENNA ORIENTATION PLAI

. THE ANTENNA ORIENTATION PLAN IS A SCHEMATIC. ATC DID NOT CONFIRM EXISTING SITE CONDITIONS INCLUDING, BUT NOT LIMITED TO, ANTENNA AZIMUTHS, MOUNT CONFIGURATIONS AND TOWER ORIENTATION. SCALES SHOWN ARE FOR REFERENCE ONLY AND EXISTING DIMENSIONS ARE APPROXIMATE. THE CONTRACTOR SHALL VERIFY ALL EXISTING CONDITIONS PRIOR TO INSTALLATION AND NOTIFY ATC OF ANY DISCREPANCIES.

OF ANY DISCREPANCIES.

4. CONTRACTOR TO ENSURE PROPER SEPARATION IN ACCORDANCE WITH AT&T'S FIRSTNET REQUIREMENTS (SEE SHEET R-602)

FINAL ANTENNA SCHEDULE							
OCATION	I		ANTENNA S	SUMMARY		NON ANTENNA SUMMAR	Υ
R RAD	AZ	POS	ANTENNA	BAND	STATUS	ADDITIONAL TOWER MOUNTED EQUIPMENT	STATUS
						TT19 <u>=08BP111</u> =001	RMN
		C1	7770	850 UMTS	RMN		RMN
							ADD
153'	17°	A1	DMP65R-BU6DA	700/850/AWS LTE 850 5G	ADD	4449 B5/B12 RRUS-32 B66A	ADD ADD
		A3	QS66512-2	700/1900 LTE	RMN	4478 B14 RRUS-32 B2	RMN RMN
		11	UDA 65D DIII U6	WCC LTE	DIANI	RRUS-11 B12	RMN
		A4	HFA-63K-800-H6	WC3 LIE	TVIVITY	RRUS-32 B30	RMN
						TT19	RMN
		A1	7770	850 UMTS	RMN	DBC0061F1V51-1	RMN
						DBC0061F1V51-2	ADD
153'	135°	B1	DMP65R-BU6DA	700/850/AWS LTE 850 5G	ADD	4449 B5/B12 RRUS-32 B66A	ADD ADD
		<i>B3</i>	QS66512-2	700/1900 LTE	RMN	4478 B14 RRUS-32 B2	RMN RMN
		B4	HPA-65R-BUU-H6	WCS LTE	RMN	RRUS-11 B12 RRUS-32 B30	RMN RMN
						TT19-08RP111-001	RMN
		B1	7770	850 UMTS	RMN	DBC0061F1V51-1	RMN
						DBC0061F1V51-2	ADD
A 153'	258°	C1	DMP65R-BU6DA	700/850/AWS LTE 850 5G	ADD	4449 B5/B12 RRUS-32 B66A	ADD ADD
		C3	QS66512-2	700/1900 LTE	RMN	4478 B14 RRUS-32 B2	RMN RMN
		C4	HPA-65R-BUU-H6	WCS LTE	RMN	RRUS-11 B12 RRUS-32 B30	RMN RMN
	153'	153' 17°	A 153' 258° C1  R RAD AZ POS  C1  A1  A3  A4  A1  B1  B3  B4  B1  C3	A 153' A	A	A	A

 EXISTING FIBER DISTRIBUTION/SQUID
 EXISTING CABLING SUMMARY

 MODEL NUMBER
 STATUS
 COAX
 DC
 FIBER
 STATUS

 (2) DC6-48-60-18-8F
 RMN
 (12) 1-1/4"
 (4) #8 AWG
 (2) 18 PAIR
 RMN

 (2) 2" CONDUIT
 RMN

STATUS ABBREVIATIONS

RMV: TO BE REMOVED

RMN: TO REMAIN

REL: TO BE RELOCATED

ADD: TO BE ADDED

CABLE LENGTHS FOR JUMPERS

JUNCTION BOX TO RRU: 15'

RRU TO ANTENNA: 10'

2	<b>EQUIPMENT SCHEDULES</b>
J /	

FINAL FIBER DISTRIBUTION/	FINAL CABLING SUMMARY				
MODEL NUMBER	STATUS	COAX	DC	FIBER	STATUS
(2) DC6-48-60-18-8F	RMN	(12) 1-1/4"	(4) #8 AWG	(2) 18 PAIR	RMN
-	-	(2) 2" CONDUIT			RMN
DC6-48-60-18-8F	ADD	-	(2) #6 AWG	-	ADD
-	-		(1) 2" CONDUIT		ADD



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COA: PEC.0001553

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ı	$\overline{\wedge}$			

ATC SITE NUMBER:

302519

ATC SITE NAME:

**SOUTHBURY** 

AT&T MOBILITY SITE NAME:

SOUTHBURY

SITE ADDRESS: 133 HORSE FENCE HILL RD SOUTHBURY, CT 06488

SEAL






DATE DRAWN:	08/17/20
ATC JOB NO:	13212284_G3
CUSTOMER ID:	SOUTHBURY
CUSTOMER #:	10035064


RF SCHEDULE AND ANTENNA INSTALLATION


SHEET NUMBER:

C-401

REVISION

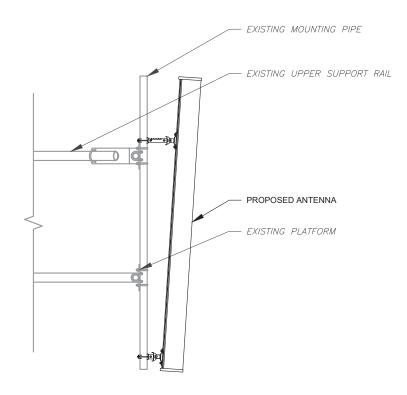


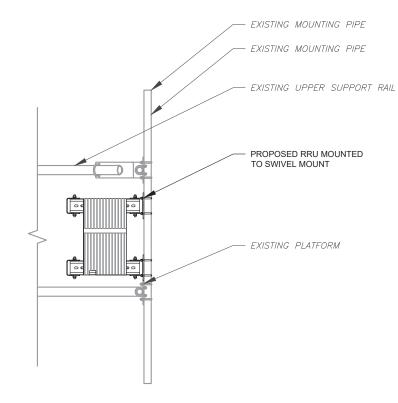

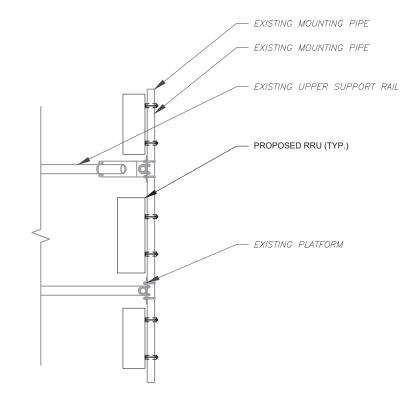

1 ANTENNA DETAIL
SCALE: N.T.S.

2 RRU DETAIL SCALE: N.T.S.

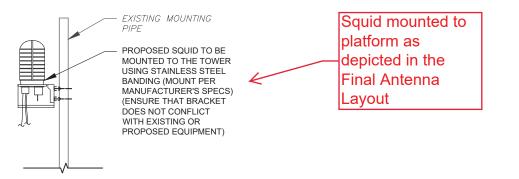

PROPOSED SQUID MOUNTING
SCALE: N.T.S.



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ATC SITE NUMBER:

302519

ATC SITE NAME:

SOUTHBURY

AT&T MOBILITY SITE NAME:

SOUTHBURY

SITE ADDRESS: 133 HORSE FENCE HILL RD SOUTHBURY, CT 06488

SEA





- 1	П	DATE DRAWN:	08/17/20
	П	ATC JOB NO:	13212284_G3
	П	CUSTOMER ID:	SOUTHBURY
	П	CUSTOMER #:	10035064


CONSTRUCTION DETAILS

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C-501


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REVISION:



- 1. THIS DETAIL IS INTENDED TO SHOW THE GENERAL GROUNDING REQUIREMENTS. SLIGHT ADJUSTMENTS MAY BE REQUIRED BASED ON EXISTING SITE CONDITIONS. THE CONTRACTOR SHALL MAKE FIELD ADJUSTMENTS AS NEEDED AND INFORM THE CONSTRUCTION MANAGER OF ANY CONFLICTS.
- SITE GROUNDING SHALL COMPLY WITH AT&T MOBILITY GROUNDING STANDARDS, LATEST EDITION, AND COMPLY WITH AT&T MOBILITY GROUNDING CHECKLIST, LATEST VERSION. WHEN NATIONAL AND LOCAL GROUNDING CODES ARE MORE STRINGENT THEY SHALL

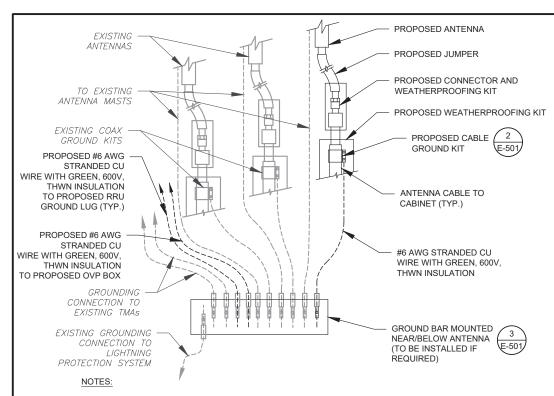


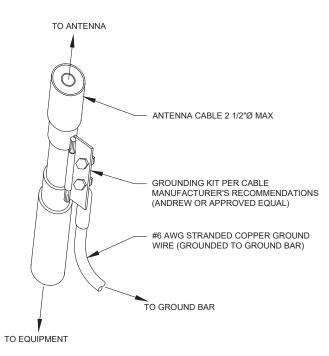

#### **GROUND KIT NOTES:**

- 1. DO NOT INSTALL CABLE GROUND KIT AT A BEND AND ALWAYS DIRECT GROUND WIRE DOWN TO GROUND BAR.
- 2. CONTRACTOR SHALL PROVIDE WEATHERPROOFING KIT (ANDREW PART NUMBER 221213) AND INSTALL/TAPE PER MANUFACTURER'S SPECIFICATIONS.

CABLE GROUND KIT CONNECTION DETAIL

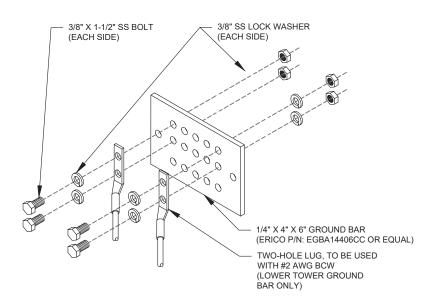

#### **GROUND BAR NOTES:**

- GROUND BAR KITS COME WITH ALL HARDWARE, NUTS, BOLTS, WASHERS, ETC. EXCEPT THE STRUCTURAL MOUNTING MEMBER(S).
- 2. GROUND BAR TO BE BONDED DIRECTLY TO TOWER.





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AT&T MOBILITY SITE NAME:

SOUTHBURY

SITE ADDRESS: 133 HORSE FENCE HILL RD SOUTHBURY, CT 06488





DATE DRAWN:	08/17/20
ATC JOB NO:	13212284_G3
CUSTOMER ID:	SOUTHBURY
CUSTOMER #:	10035064


**GROUNDING DETAILS** 

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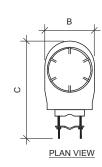
REVISION


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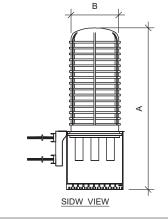
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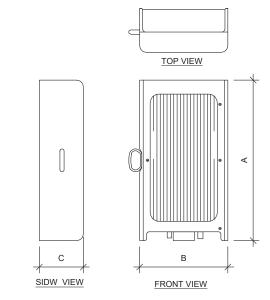
ANTENNA SPECIFICATIONS						
ANTENNA MODEL	A	В	С	WEIGHT (LBS)		
DMP65R-BU6DA	71.2"	20.7"	7.7"	79.4		





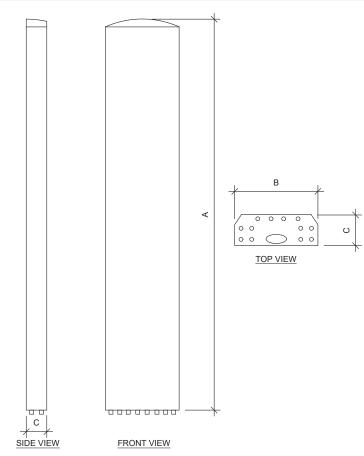

RAYCAP SPECIFICATIONS						
RAYCAP MODEL	А	В	С	WEIGHT (LBS)		
DC6-48-60-18-8F	24"	11"	11"	31.8		

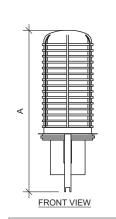

RRU SPECIFICATIONS					
RRU MODEL	А	В	С	WEIGHT (LBS)	
4449 B5, B12	17.9"	13.2"	9.4"	71.0	
RRUS 32 B66A	27.2"	12.0"	7.0"	50.7	


SUPPLEMENTAL


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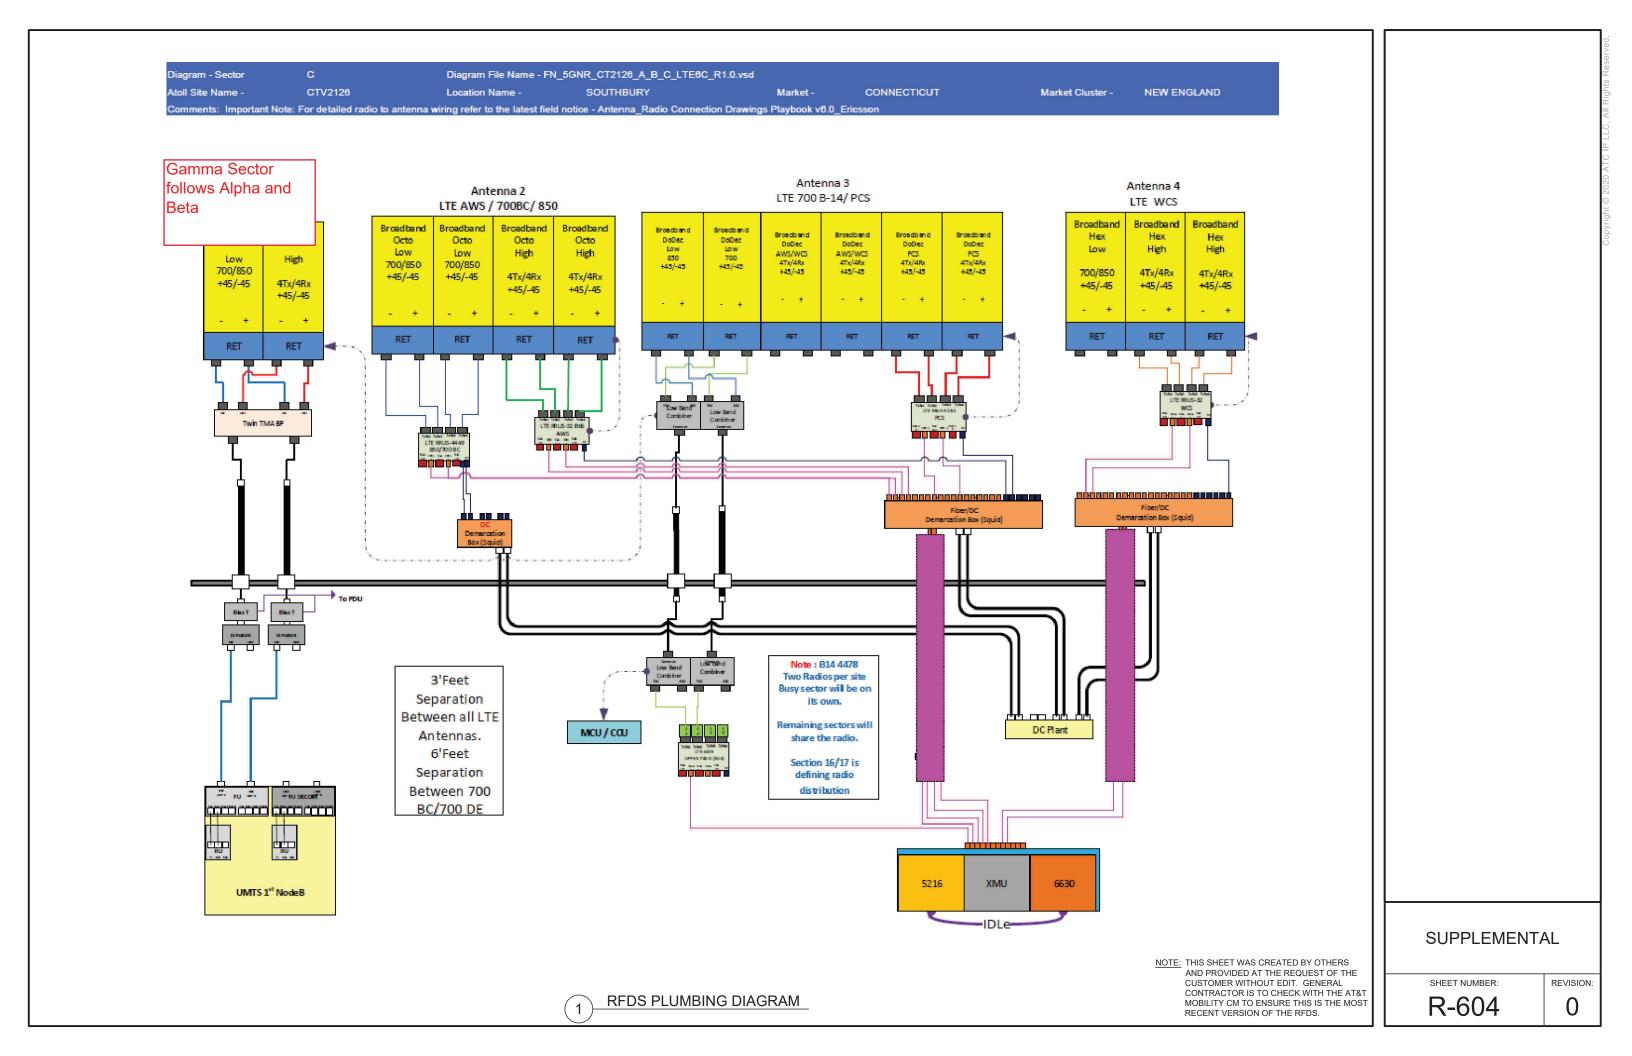
R-601

REVISION:





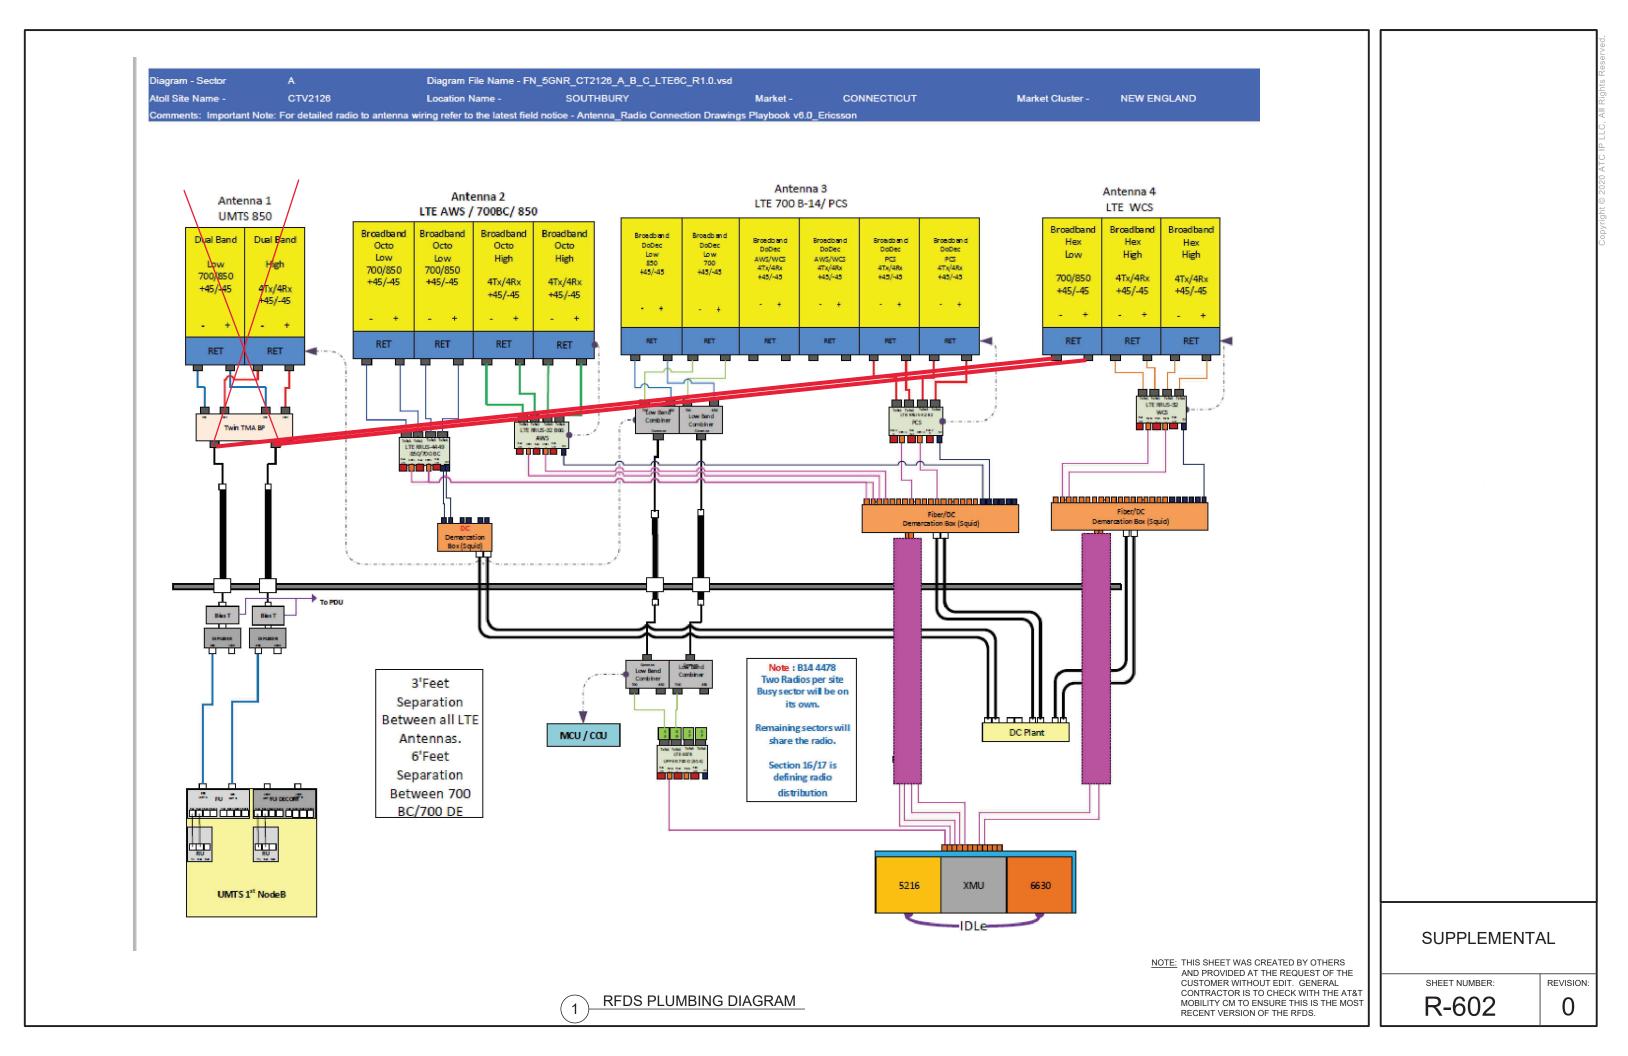

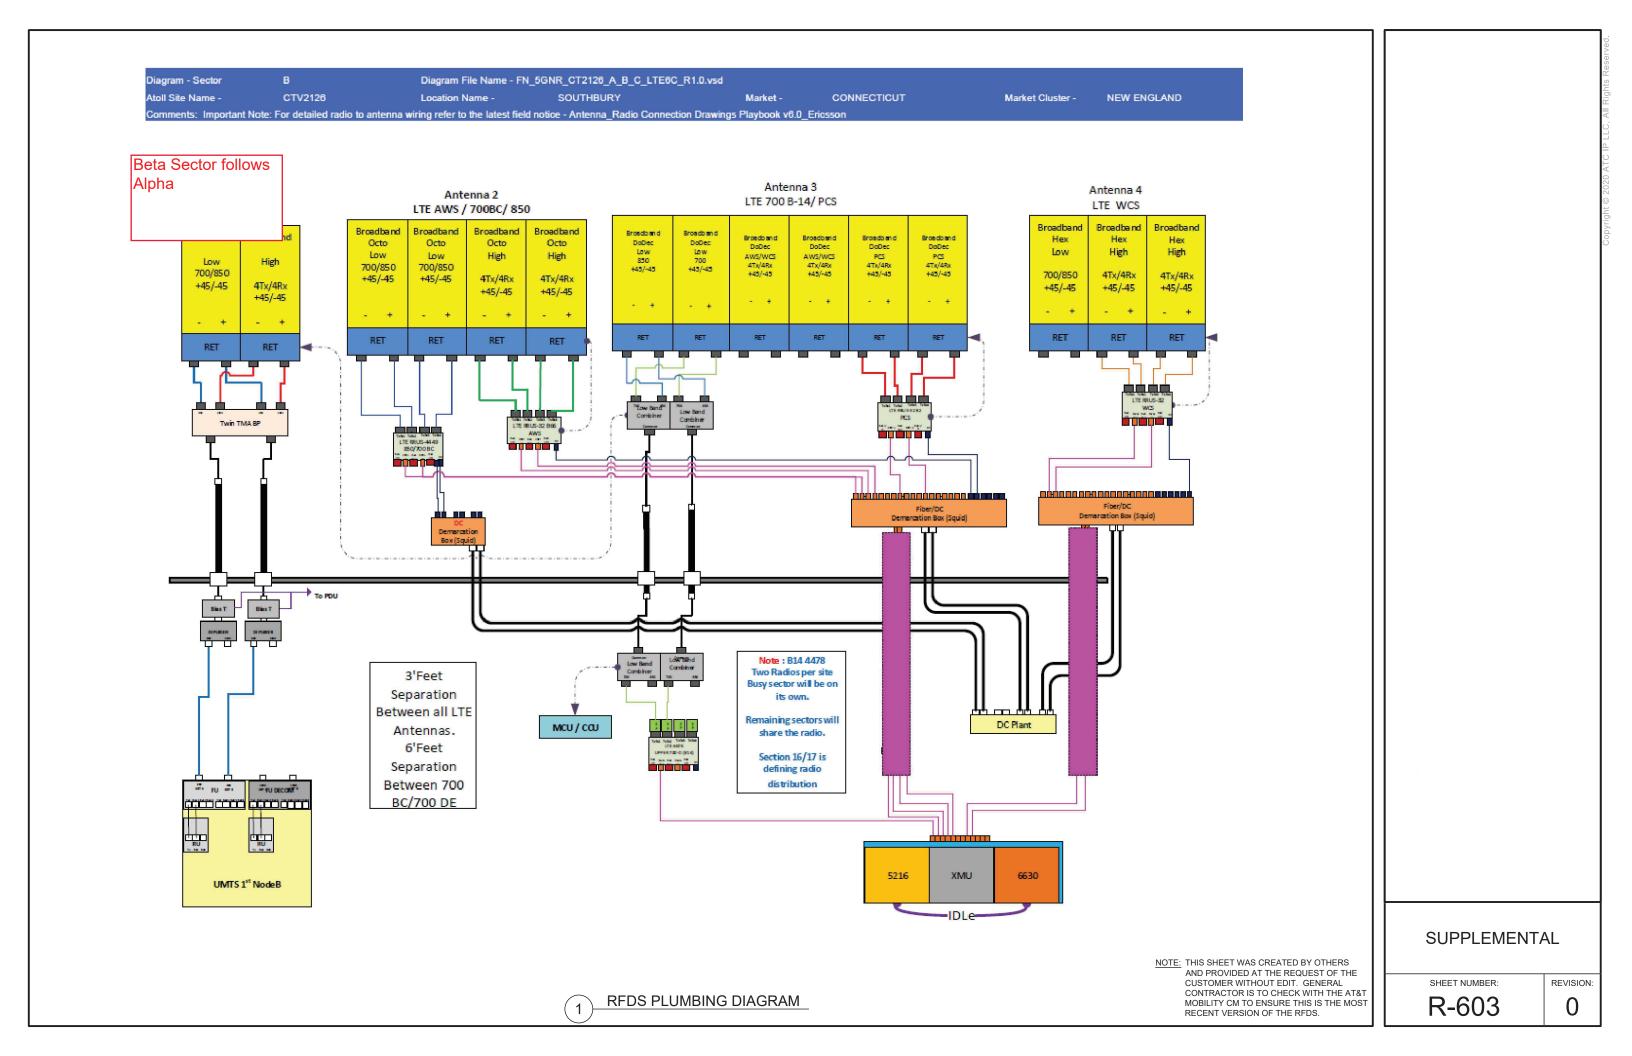



#### **Post Modification Mount Analysis Report**

#### August 4, 2020

ATC Site Name	Southbury, CT
ATC Site Number	302519
AT&T Site Name	MRCTB046858
AT&T Site Number	CTL02126
Infinigy Job Number	1009-Z0003-B
ATC Engineering Number	13212284_C9_04
Client	ATC
Carrier	AT&T
Site Location	133 Horse Fence Hill Road Southbury, CT 06488 New Haven County 41° 27' 35.9" N NAD83 73° 14' 42.0" W NAD83
Mount Centerline EL.	153.0 ft.
Mount Type	Platform w/ Handrails
Mount Usage Ratio	90.7%
Overall Result	Pass

Upon reviewing the results of this analysis, it is our opinion that the modified mount does meet the specified TIA code requirements. The modified mount and connections are therefore deemed adequate to support the final loading configuration as listed in this report.



Brenden Archer Project Engineer II



**INFINIGY**8

#### Post Modification Mount Analysis Report

#### August 4, 2020

#### Introduction

Infinigy Engineering has been requested to perform a post modification mount analysis on the existing AT&T mounts. All referenced supporting documents have been obtained from the client and are assumed to be accurate and applicable to this site. The mount was analyzed using RISA-3D Version 17.0.4 analysis software.

#### **Supporting Documentation**

Collocation Application	Collo App ID No. 13212284, dated May 20, 2020
Construction Drawings	ATC Job No. 13212284_G3, dated June 25, 2020
Proposed Loading	AT&T RFDS Application ID No. 3719805, dated March 25, 2020
Structural Analysis Report	ATC Engineering No. 13212284_C3_03, dated June 30, 2020
Mount Mapping Report	MasTec Network Solutions Job No. 202201, dated June 22, 2020
Mount Analysis Report	Centek Engineering Project No. 18000.13, dated May 3, 2018

#### **Analysis Code Requirements**

Wind Speed	116 mph (3-Second Gust)
Wind Speed w/ ice	50 mph (3-Second Gust) w/ 1" ice
TIA Revision	ANSI/TIA-222-H
Risk Category	II
Exposure Category	В
Topographic Factor Procedure	Method 2
Topographic Feature	Hill
Calculated Crest Height	132.0 ft.
Spectral Response	$S_s = 0.202 \text{ g} / S_1 = 0.055 \text{ g}$
Site Class	D-Stiff Soil (Assumed)
HMSL	345.2 ft.

#### Conclusion

Upon reviewing the results of this analysis, it is our opinion that the modified mount does meet the specified TIA code requirements. The modified mount and connections are therefore deemed adequate to support the final loading configuration as listed in this report.

If you have any questions, require additional information, or actual conditions differ from those as detailed in this report please contact me via the information below:

Brenden Archer Project Engineer II | **INFINIGY** 1033 Watervliet Shaker Rd, Albany, NY 12205 (518) 690-0790 barcher@infinigy.com | www.infinigy.com

302519 Southbury, CT

Page | 3

NOTE: THIS SHEET WAS CREATED BY OTHERS AND PROVIDED AT THE REQUEST OF THE CUSTOMER WITHOUT EDIT. GENERAL

CONTRACTOR IS TO CHECK WITH THE AT&T

MOBILITY CM TO ENSURE THIS IS THE MOST

SUPPLEMENTAL

SHEET NUMBER

R-605

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REVISION:

# ANTENNA PLATFORM MODIFICATION DRAWINGS

PREPARED BY:









302519 SOUTHBURY 133 HORSE FENCE HILL ROAD SOUTHBURY, CT 06488 08/04/20

INFINIGY JOB # 1009-Z0003-B

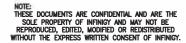

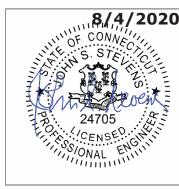

PROFESSIONAL SEA

IT IS A VIOLATION OF LAW FOR ANY PERSON
UNLESS THEY ARE ACTING UNDER THE
DIRECTION OF A LICENSED PROFESSIONAL
ENGINEER TO ALTER THESE DOCUMENTS

#### GENERAL NOTES:

- THESE DOCUMENTS WERE DESIGNED IN ACCORDANCE WITH THE LATEST VERSION OF APPLICABLE LOCAL/STATE/COUNTY/CITY BUILDING CODES, AS WELL AS ANSI/TIA-222 STANDARD, AWWA-D100 STANDARD, NDS, NEC, MSJC, AND/OR THE LATEST VERSION OF THE INTERNATIONAL BUILDING CODE, UNLESS NOTED OTHERWISE IN THE CORRESPONDING STRUCTURAL REPORT.
- 2. ALL CONSTRUCTION METHODS SHOULD FOLLOW STANDARDS OF GOOD CONSTRUCTION PRACTICE.
- 3. ALL WORK INDICATED ON THESE DRAWINGS SHALL BE PERFORMED BY QUALIFIED CONTRACTORS EXPERIENCED IN SIMILAR CONSTRUCTION
- 4. ALL NEW WORK SHALL ACCOMMODATE EXISTING CONDITIONS. IF OBSTRUCTIONS ARE FOUND. CONTRACTOR SHALL NOTIFY ENGINEER OF RECORD PRIOR TO CONTINUING WORK.
- ANY CHANGES OR ADDITIONS MUST CONFORM TO THE REQUIREMENTS OF THESE NOTES AND SPECIFICATIONS, AND SHOULD BE SIMILAR TO THOSE SHOWN. ALL CHANGES OR ADDITIONS SHALL BE SUBMITTED TO THE ENGINEER OF RECORD FOR REVIEW AND APPROVAL PRIOR TO FABRICATION
- 6. THE CONTRACTOR IS RESPONSIBLE FOR THE DESIGN AND EXECUTION OF ALL MISCELLANEOUS SHORING, BRACING, TEMPORARY SUPPORTS, ETC. NECESSARY TO PROVIDE A COMPLETE AND STABLE STRUCTURE DURING CONSTRUCTION. TIA-1019-A-2011 IS AN APPROPRIATE REFERENCE FOR THOSE DESIGNS MEETING TIA STANDARDS. THE ENGINEER OF RECORD MAY PROVIDE FORMAL RIGGING PLANS AT THE REQUEST AND EXPENSE OF THE CONTRACTOR.
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#### STEEL CONSTRUCTION NOTES:

- STRUCTURAL STEEL SHALL CONFORM TO THE AISC MANUAL OF STEEL CONSTRUCTION 14TH EDITION, FOR THE DESIGN AND FABRICATION OF STEEL COMPONENTS.
- 2. ALL FIELD CUT SURFACES, FIELD DRILLED HOLES, AND GROUND SURFACES WHERE EXISTING PAINT OR GALVANIZATION REMOVAL WAS REQUIRED SHALL BE REPAIRED WITH (2) BRUSHED COATS OF ZRC GALVILITE COLD GALVANIZING COMPOUND PER ASTM A780 AND MANUFACTURERS' RECOMMENDATIONS.
- 3. ALL FIELD DRILLED HOLES TO BE USED FOR FIELD BOLTING INSTALLATION SHALL BE STANDARD HOLES, AS DEFINED BY AISC, UNLESS NOTED OTHERWISE.
- 4. ALL EXTERIOR STEEL WORK SHALL BE GALVANIZED IN ACCORDANCE WITH ASTM A123.
- ALL STEEL MEMBERS AND CONNECTIONS SHALL MEET THE FOLLOWING GRADES:
   ANGLES, CHANNELS, PLATES AND BARS TO BE A36. Fy=36 KSI, U.N.O.

  - W SHAPES TO BE A992. Fy=50 KSI, U.N.O.
  - RECTANGULAR HSS TO BE A500, GRADE B. FY=46 KSI, U.N.O.
     ROUND HSS TO BE A500, GRADE B. FY=42 KSI, U.N.O.
  - STEEL PIPE TO BE A53, GRADE B. Fy=35 KSI, U.N.O.
  - BOLTS TO BE A325-X. Fu=120 KSI, U.N.O. • U-BOLTS AND LAG SCREWS TO BE A307 GR A. Fu=60 KSI, U.N.O.
- 6. ALL WELDING SHALL BE DONE USING E70XX ELECTRODES, U.N.O.
- 7. ALL WELDING SHALL CONFORM TO AISC AND AWS D1.1 LATEST EDITION.
- 8. ALL HILTI ANCHORS TO BE CARBON STEEL, U.N.O.
  - MECHANICAL ANCHORS: KWIK BOLT-TZ, U.N.O.
  - CMU BLOCK ANCHORS: ADHESIVE HY120, U.N.O. CONCRETE ANCHORS: ADHESIVE — HY150, Ú.N.O.
- 9. ALL STUDS TO BE NELSON CAPACITOR DISCHARGE 1/4"-20 LOW CARBON STEEL COPPER-FLASH AT 55 KSI ULT/50 KSI YIELD, U.N.O.
- 10. BOLTS SHALL BE TIGHTENED TO A "SNUG TIGHT" CONDITION AS DEFINED BY AISC.
- 11. MINIMUM EDGE DISTANCES SHALL CONFORM TO AISC TABLE J3.4.
- 12. REMOVAL/REPLACEMENT OF STRUCTURAL MEMBERS SHALL BE DONE ONE MEMBER AT A TIME. CONTRACTOR IS RESPONSIBLE FOR ENSURING THE STRUCTURAL INTEGRITY OF THE STRUCTURE DURING ALL PHASES OF CONSTRUCTION.

#### CONCRETE CONSTRUCTION NOTES:

- CONCRETE TO BE 4000 PSI @ 28 DAYS. REINFORCING BAR TO CONFORM TO ASTM A615 GRADE 60 SPECIFICATIONS. CONCRETE INSTALLATION TO CONFORM TO ACI-318 BUILDING REQUIREMENTS FOR REINFORCED CONCRETE ALL CONCRETE TO BE PLACED AGAINST LINDISTURBED FARTH FREE OF WATER AND ALL FOREIGN OBJECTS AND MATERIALS. A MINIMUM OF THREE INCHES OF CONCRETE SHALL COVER ALL REINFORCEMENT. WELDING OF REBAR IS NOT PERMITTED
- 2. EXISTING CONCRETE SURFACES THAT ARE TO BE IN CONTACT WITH NEW PROPOSED CONCRETE SHOULD BE WIRE BRUSHED CLEAN AND TREATED WITH APPROPRIATE MECHANICAL SCRATCH COAT AND REPAIR MATERIALS OR APPROPRIATE CHEMICAL METHODS SUCH AS THE APPLICATION OF A BONDING AGENT, EX. SAKRETE OR EQUIVALENT, TO ENSURE A QUALITY BOND BETWEEN EXISTING AND PROPOSED CONCRETE SURFACES.

#### FIBER REINFORCED POLYMER (FRP) NOTES:

- 1. FRP PLATES, SHAPES, BOLTS AND NUTS (STUD/NUT ASSEMBLIES) SHALL CONFORM TO ASTM D638, 695, 790. PLATES AND SHAPES TO BE FY = 5.35 KSI LW (SAFETY FACTOR OF 8), .945 KSI CW (SAFETY FACTOR OF 8) MIN.
- 2. IF FIELD FABRICATION IS REQUIRED, ALL CUT EDGES AND DRILLED HOLES TO BE SEALED USING VINYL ESTER SEALING KIT SUPPLIED BY THE MANUFACTURER.
- ALL FASTENERS TO BE 1/2" DIA FRP THREADED ROD WITH FIBER REINFORCED THERMOPLASTIC NUT. SPACED AT 12 INCHES ON CENTER MAXIMUM, U.N.O., FOR PANELS AND AS DESIGNED FOR
- 4. THE COLOR AND SURFACE PATTERN OF EXPOSED FRP PANELS SHALL MATCH THE EXTERIOR OF THE EXISTING BUILDING, U.N.O.
- 5. STUD/NUT ASSEMBLIES SHOULD BE LUBRICATED FOR INSTALLATION
- 6. ENSURE BEARING SURFACES OF THE NUTS ARE PARALLEL TO THE SURFACES BEING FASTENED.
- 7. TORQUE BOLTS ACCORDING TO THE FOLLOWING TABLE

INSTALLATION TORQUE TABLE			
SIZE	ULTIMATE TORQUE STRENGTH	RECOMMENDED MAXIMUM INSTALLATION TORQUE	
3/8-16 UNC	8 FT-LBS	4 FT-LBS	
1/2-13 UNC	18 FT-LBS	8 FT-LBS	
5/8-11 UNC	35 FT-LBS	16 FT-LBS	
3/4-10 UNC	50 FT-LBS	24 FT-LBS	
1-8 UNC	110 FT-LBS	50 FT-LBS	

- 8. WHEN TIGHTENING FRP STUD/NUT ASSEMBLIES, WRENCHES MUST MAKE FULL CONTACT WITH ALL NUT EDGES. A STANDARD SIX POINT SOCKET IS RECOMMENDED.
- STUD/NUT ASSEMBLIES SHOULD BE BONDED BY APPLYING BONDING AGENT TO ENTIRE NUT AND EXPOSED STUD.
- 10. ALL FRP MATERIALS TO BE PROVIDED BY FIBERGRATE COMPOSITE STRUCTURES, DALLAS TX, OR APPROVED EQUAL
- 11. ALL FRP SHAPES TO BE DYNAFORM PULTRUDED STRUCTURAL SHAPES
- 12. ALL FRP PLATES TO BE FIBERPLATE MOLDED FRP PLATE.
- 1.3. ALL FRP PANELS TO BE FIBERPLATE CLADDING PANEL
- 14. EACH FRP PANEL TO BE IDENTIFIED WITH LARR#25536 AND FIBERGRATE COMPOSITE STRUCTURAL
- 15. FRP MATERIAL TO BE CLASSIFIED AS CC1 OR BETTER, AND HAVE MAXIMUM FLAME SPREAD OF 50.
- 16. ALL DESIGN AND CONSTRUCTION TO BE COMPLETED IN ACCORDANCE WITH LOS ANGELES RESEARCH REPORT RR25536, DATED FEBRUARY 1, 2016.
- 17. SPECIAL INSPECTIONS MUST BE PROVIDED FOR ALL FRP INSTALLMENTS. SEE SPECIAL INSPECTION SECTION, THIS SHEET.

RATIO OF EDGE DISTANCE TO FRP FASTENER DIAMETER			
	RANGE	RECOMMENDED	
EDGE DISTANCE - CL* BOLT TO END	2.0-4.0	3.0	
EDGE DISTANCE - CL* BOLT TO SIDE	1.5-3.5	2.5	
BOLT PITCH - CL* TO CL*	4.0-5.0	5.0	

#### WOOD CONSTRUCTION NOTES:

- 1. ALL EXISTING WOOD SHAPES ARE ASSUMED TO BE DOUGLAS FIR-LARCH WITH A REFERENCE DESIGN BENDING VALUE OF 1000 PSI MIN.
- 2. ALL PROPOSED WOOD SHAPES ARE TO BE DOUGLAS FIR-LARCH WITH A REFERENCE DESIGN BENDING VALUE OF 1000 PSI MIN. U.N.O.
- 3. ALL EXISTING AND PROPOSED GLUED LAMINATED TIMBERS ARE TO BE 24F-1.8C DOUGLAS FIR BALANCED WITH A REFERENCE DESIGN BENDING VALUE OF 2400 PSI MIN. U.N.O.

#### MASONRY CONSTRUCTION NOTES:

- ALL BRICK TO BE 1500 PSI MIN. REINFORCING BAR (IF APPLICABLE) TO CONFORM TO ASTM A615 GRADE 60 SPECIFICATIONS. ALL MORTAR TO BE 2000 PSI MIN.
  - FOR INTERIOR/ABOVE GRADE APPLICATIONS TYPE N MORTAR HAVING MINIMUM MODULUS OF RUPTURE OF 100 PSI SHALL BE USED. FOR EXTERIOR/BELOW GRADE APPLICATIONS TYPE M OR S MORTAR HAVING A MINIMUM MODULUS OF RUPTURE OF 133 PSI.
  - BRICK AND MORTAR INSTALLATION TO CONFORM TO MSJC BUILDING CODE REQUIREMENTS FOR MASONRY STRUCTURES.
- 2. ALL CMU TO BE 1500 PSI MIN. REINFORCING BAR (IF APPLICABLE) TO CONFORM TO ASTM A615 GRADE 60 SPECIFICATIONS. ALL MORTAR TO BE 2000 PSI MIN.
  - FOR INTERIOR / ABOVE GRADE APPLICATIONS TYPE N MORTAR HAVING MINIMUM MODULUS OF RUPTURE OF 64 PSI SHALL BE USED FOR UNGROUTED BLOCKS, AND 158 PSI FOR FULLY GROUTED BLOCKS.
  - FOR EXTERIOR/BELOW GRADE APPLICATIONS TYPE M OR S MORTAR HAVING A MINIMUM MODULUS OF RUPTURE OF 84 PSI SHALL BE USED FOR UNGROUTED BLOCKS, AND 163 PSI FOR FULLY GROUTED BLOCKS
  - BRICK AND MORTAR INSTALLATION TO CONFORM TO MSJC BUILDING CODE REQUIREMENTS FOR MASONRY STRUCTURES.


#### TOWER PLUMB & TENSION NOTES:

- PLUMB AND TENSION TOWER UPON COMPLETION OF STRUCTURAL MODIFICATIONS DETAILED IN THESE
- RETENSIONING OF EXISTING GUY WIRES SHALL BE PERFORMED AT A TIME WHEN THE WIND VELOCITY IS LESS THAN 10 MPH AT GROUND LEVEL AND WITH NO ICE ON THE STRUCTURE AND GUY WIRES.
- PLUMB THE TOWER WHILE RETENSIONING THE EXISTING GLIY WIRES. THE HORIZONTAL DISTANCE BETWEEN THE VERTICAL CENTERLINES AT ANY TWO ELEVATIONS SHALL NOT EXCEED 0.25% OF THE VERTICAL DISTANCE BETWEEN TWO ELEVATIONS FOR LATTICED STRUCTURES.
- 4. THE TWIST BETWEEN ANY TWO ELEVATIONS THROUGHOUT THE HEIGHT OF A LATTICE STRUCTURE SHALL NOT EXCEED 0.5 DEGREES IN 10 FEET. THE MAXIMUM TWIST OVER THE LATTICE STRUCTURE HEIGHT SHALL NOT EXCEED 5 DEGREES.

#### SPECIAL INSPECTIONS NOTES:

- 1. A QUALIFIED INDEPENDENT TESTING LABORATORY, EMPLOYED BY THE OWNER AND APPROVED BY THE JURISDICTION, SHALL PERFORM INSPECTION AND TESTING IN ACCORDANCE WITH THE THE GOVERNING BUILDING CODE, APPLICABLE SECTION(S) AS REQUIRED BY PROJECT SPECIFICATIONS FOR THE FOLLOWING CONSTRUCTION WORK:
- a. STRUCTURAL WELDING (CONTINUOUS INSPECTION OF FIELD WELDS ONLY).
- HIGH STRENGTH BOLTS (PERIODIC INSPECTION OF A325 AND/OR A490 BOLTS) TO BE TIGHTENED PER "TURN-OF-THE-NUT" METHOD.
- c. MECHANICAL AND EPOXIED ANCHORAGES.
- d. FIBER REINFORCED POLYMER
  - THE SPECIAL INSPECTOR MUST VERIFY THAT THE FRP MATERIAL SPECIFIED ON THE APPROVED DESIGN DOCUMENTS IS BEING INSTALLED.
  - THE SPECIAL INSPECTOR MUST VERIFY THAT ALL CUT EDGES AND DRILLED HOLES ARE PROPERLY SEALED USING A VINYL ESTER SEALING KIT SUPPLIED BY THE MANUFACTURER.
  - THE SPECIAL INSPECTOR MUST VERIFY THAT THE STRUCTURE IS BUILT IN ACCORDANCE WITH THE APPROVED DESIGN DOCUMENTS.
- 2. THE INSPECTION AGENCY SHALL SUBMIT INSPECTION AND TEST REPORTS TO THE BUILDING DEPARTMENT. THE ENGINEER OF RECORD, AND THE OWNER UNLESS THE FABRICATOR IS APPROVED BY THE BUILDING OFFICIAL TO PERFORM WORK WITHOUT THE SPECIAL INSPECTIONS.

#### MAXIMUM ALLOWABLE ANGLE CLIP

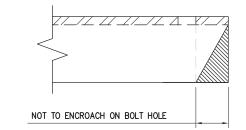

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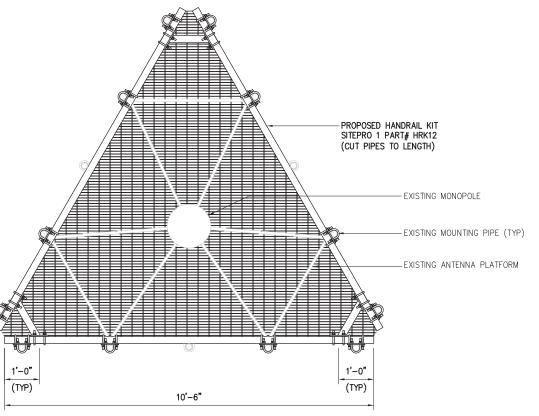





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**GENERAL** NOTES

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#### NOTES:

- 1. PROPOSED MODIFICATIONS ARE TYPICAL FOR ALL SECTORS.
- ALL DESIGNATED PARTS ARE TO BE INSTALLED PER MANUFACTURER'S SPECIFICATIONS, UNLESS OTHERWISE NOTED.
- 3. REMOVAL/REPLACEMENT OF STRUCTURAL MEMBERS SHALL BE DONE ONE MEMBER AT A TIME. CONTRACTOR IS RESPONSIBLE FOR ENSURING THE STRUCTURAL INTEGRITY OF THE STRUCTURE DURING ALL PHASES OF CONSTRUCTION.

Approved by EOR: Handrail no longer needed. Additional cross over plate for new antenna is needed.



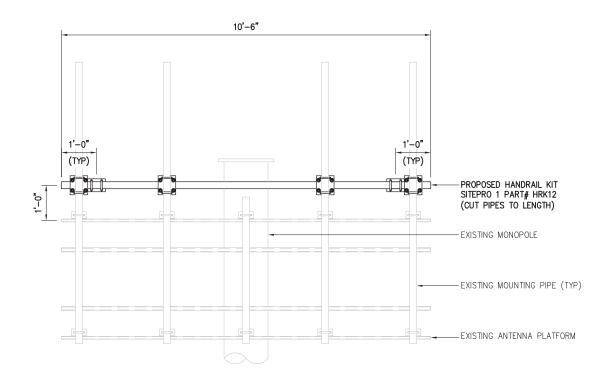



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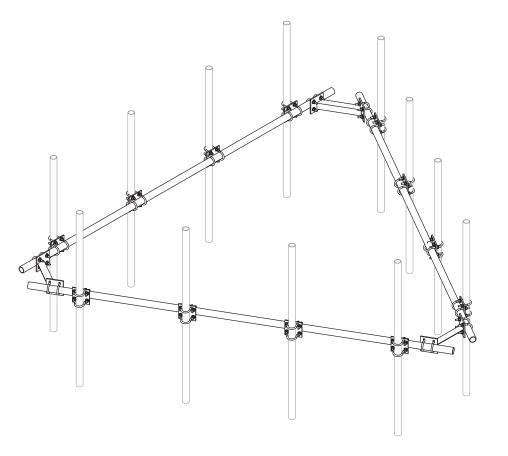
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ANTENNA PLATFORM MODIFICATION

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Project Title:

302519 133 HORSE FENCE HILL ROAD SOUTHBURY, CT 06488





Drawing Title

NECESSARY PARTS

Drawing Number

# ANTENNA PLATFORM MODIFICATION DRAWINGS

PREPARED BY:







302519 SOUTHBURY 133 HORSE FENCE HILL ROAD SOUTHBURY, CT 06488 12/09/20

INFINIGY JOB # 1009-Z0003-B



PROFESSIONAL SEAL

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- 2. IF FIELD FABRICATION IS REQUIRED, ALL CUT EDGES AND DRILLED HOLES TO BE SEALED USING VINYL ESTER SEALING KIT SUPPLIED BY THE MANUFACTURER.
- 3. ALL FASTENERS TO BE 1/2" DIA FRP THREADED ROD WITH FIBER REINFORCED THERMOPLASTIC NUT, SPACED AT 12 INCHES ON CENTER MAXIMUM, U.N.O., FOR PANELS AND AS DESIGNED FOR STRUCTURAL MEMBERS
- 4. THE COLOR AND SURFACE PATTERN OF EXPOSED FRP PANELS SHALL MATCH THE EXTERIOR OF THE EXISTING BUILDING, U.N.O.
- 5. STUD/NUT ASSEMBLIES SHOULD BE LUBRICATED FOR INSTALLATION
- 6. ENSURE BEARING SURFACES OF THE NUTS ARE PARALLEL TO THE SURFACES BEING FASTENED.
- 7. TORQUE BOLTS ACCORDING TO THE FOLLOWING TABLE:

INSTALLATION TORQUE TABLE			
SIZE	ULTIMATE TORQUE STRENGTH	RECOMMENDED MAXIMUM INSTALLATION TORQUE	
3/8-16 UNC	8 FT-LBS	4 FT-LBS	
1/2-13 UNC	18 FT-LBS	8 FT-LBS	
5/8-11 UNC	35 FT-LBS	16 FT-LBS	
3/4-10 UNC	50 FT-LBS	24 FT-LBS	
1-8 UNC	110 FT-LBS	50 FT-LBS	

- 8. WHEN TIGHTENING FRP STUD/NUT ASSEMBLIES, WRENCHES MUST MAKE FULL CONTACT WITH ALL NUT EDGES. A STANDARD SIX POINT SOCKET IS RECOMMENDED.
- 9. STUD/NUT ASSEMBLIES SHOULD BE BONDED BY APPLYING BONDING AGENT TO ENTIRE NUT AND **EXPOSED STUD**
- 10. ALL FRP MATERIALS TO BE PROVIDED BY FIBERGRATE COMPOSITE STRUCTURES, DALLAS TX, OR APPROVED EQUAL.
- 11. ALL FRP SHAPES TO BE DYNAFORM PULTRUDED STRUCTURAL SHAPES.
- 12. ALL FRP PLATES TO BE FIBERPLATE MOLDED FRP PLATE.
- 13. ALL FRP PANELS TO BE FIBERPLATE CLADDING PANEL.
- 14. EACH FRP PANEL TO BE IDENTIFIED WITH LARR#25536 AND FIBERGRATE COMPOSITE STRUCTURAL
- 15. FRP MATERIAL TO BE CLASSIFIED AS CC1 OR BETTER, AND HAVE MAXIMUM FLAME SPREAD OF 50.
- 16. ALL DESIGN AND CONSTRUCTION TO BE COMPLETED IN ACCORDANCE WITH LOS ANGELES RESEARCH REPORT RR25536, DATED FEBRUARY 1, 2016.
- 17. SPECIAL INSPECTIONS MUST BE PROVIDED FOR ALL FRP INSTALLMENTS. SEE SPECIAL INSPECTION SECTION, THIS SHEET.

RATIO OF EDGE DISTANCE TO FRP FASTENER DIAMETER		
	RANGE	RECOMMENDED
EDGE DISTANCE - CL* BOLT TO END	2.0-4.0	3.0
EDGE DISTANCE - CL* BOLT TO SIDE	1.5-3.5	2.5
BOLT PITCH - CL* TO CL*	4.0-5.0	5.0

#### WOOD CONSTRUCTION NOTES:

- ALL EXISTING WOOD SHAPES ARE ASSUMED TO BE DOUGLAS FIR-LARCH WITH A REFERENCE DESIGN BENDING VALUE OF 1000 PSI MIN.
- ALL PROPOSED WOOD SHAPES ARE TO BE DOUGLAS FIR-LARCH WITH A REFERENCE DESIGN BENDING VALUE OF 1000 PSI MIN. U.N.O.
- 3. ALL EXISTING AND PROPOSED GLUED LAMINATED TIMBERS ARE TO BE 24F-1.8C DOUGLAS FIR BALANCED WITH A REFERENCE DESIGN BENDING VALUE OF 2400 PSI MIN. U.N.O.

#### MASONRY CONSTRUCTION NOTES:

- 1. ALL BRICK TO BE 1500 PSI MIN. REINFORCING BAR (IF APPLICABLE) TO CONFORM TO ASTM A615 GRADE 60 SPECIFICATIONS. ALL MORTAR TO BE 2000 PSI MIN.
  - FOR INTERIOR/ABOVE GRADE APPLICATIONS TYPE N MORTAR HAVING MINIMUM MODULUS OF RUPTURE OF 100 PSI SHALL BE USED. FOR EXTERIOR/BELOW GRADE APPLICATIONS TYPE M OR S MORTAR HAVING A MINIMUM MODULUS OF RUPTURE OF 133 PSI
  - BRICK AND MORTAR INSTALLATION TO CONFORM TO MSJC BUILDING CODE REQUIREMENTS FOR
- 2. ALL CMU TO BE 1500 PSI MIN. REINFORCING BAR (IF APPLICABLE) TO CONFORM TO ASTM A615 GRADE 60 SPECIFICATIONS. ALL MORTAR TO BE 2000 PSI MIN.
  - FOR INTERIOR/ABOVE GRADE APPLICATIONS, TYPE N MORTAR HAVING MINIMUM MODULUS OF RUPTURE OF 64 PSI SHALL BE USED FOR UNGROUTED BLOCKS, AND 158 PSI FOR FULLY
  - FOR EXTERIOR/BELOW GRADE APPLICATIONS TYPE M OR S MORTAR HAVING A MINIMUM MODULUS OF RUPTURE OF 84 PSI SHALL BE USED FOR UNGROUTED BLOCKS, AND 163 PSI FOR FULLY GROUTED BLOCKS.
  - BRICK AND MORTAR INSTALLATION TO CONFORM TO MSJC BUILDING CODE REQUIREMENTS FOR


#### TOWER PLUMB & TENSION NOTES:

- PLUMB AND TENSION TOWER UPON COMPLETION OF STRUCTURAL MODIFICATIONS DETAILED IN THESE
- 2. RETENSIONING OF EXISTING GUY WIRES SHALL BE PERFORMED AT A TIME WHEN THE WIND VELOCITY IS LESS THAN 10 MPH AT GROUND LEVEL AND WITH NO ICE ON THE STRUCTURE AND GUY WIRES.
- PLUMB THE TOWER WHILE RETENSIONING THE EXISTING GUY WIRES. THE HORIZONTAL DISTANCE BETWEEN THE VERTICAL CENTERLINES AT ANY TWO ELEVATIONS SHALL NOT EXCEED 0.25% OF THE VERTICAL DISTANCE BETWEEN TWO ELEVATIONS FOR LATTICED STRUCTURES.
- 4 THE TWIST RETWEEN ANY TWO ELEVATIONS THROUGHOUT THE HEIGHT OF A LATTICE STRUCTURE SHALL NOT EXCEED 0.5 DEGREES IN 10 FEET. THE MAXIMUM TWIST OVER THE LATTICE STRUCTURE HEIGHT SHALL NOT EXCEED 5 DEGREES.

#### SPECIAL INSPECTIONS NOTES:

- 1. A QUALIFIED INDEPENDENT TESTING LABORATORY, EMPLOYED BY THE OWNER AND APPROVED BY THE JURISDICTION, SHALL PERFORM INSPECTION AND TESTING IN ACCORDANCE WITH THE THE GOVERNING BUILDING CODE, APPLICABLE SECTION(S) AS REQUIRED BY PROJECT SPECIFICATIONS FOR THE FOLLOWING CONSTRUCTION WORK:
- a. STRUCTURAL WELDING (CONTINUOUS INSPECTION OF FIELD WELDS ONLY).
- b. HIGH STRENGTH BOLTS (PERIODIC INSPECTION OF A325 AND/OR A490 BOLTS) TO BE TIGHTENED PER "TURN-OF-THE-NUT" METHOD.
- c. MECHANICAL AND EPOXIED ANCHORAGES.
- d. FIBER REINFORCED POLYMER.
  - THE SPECIAL INSPECTOR MUST VERIFY THAT THE FRP MATERIAL SPECIFIED ON THE APPROVED DESIGN DOCUMENTS IS BEING INSTALLED
  - THE SPECIAL INSPECTOR MUST VERIFY THAT ALL CUT EDGES AND DRILLED HOLES ARE PROPERLY SEALED USING A VINYL ESTER SEALING KIT SUPPLIED BY THE MANUFACTURER.
  - THE SPECIAL INSPECTOR MUST VERIFY THAT THE STRUCTURE IS BUILT IN ACCORDANCE WITH THE APPROVED DESIGN DOCUMENTS.
- THE INSPECTION AGENCY SHALL SUBMIT INSPECTION AND TEST REPORTS TO THE BUILDING DEPARTMENT, THE ENGINEER OF RECORD, AND THE OWNER UNLESS THE FABRICATOR IS APPROVED BY THE BUILDING OFFICIAL TO PERFORM WORK WITHOUT THE SPECIAL INSPECTIONS.

#### MAXIMUM ALLOWABLE ANGLE CLIP

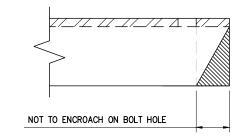

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No. 22947 12/9/20

SSUED FOR CONSTRUCTION JC 12/09/ ISSUED FOR REVIEW BD 08/04, Submittal / Revision App'd Dat Drawn: WJD

Designed: ML Checked: JC

roject Title

SOUTHBURY


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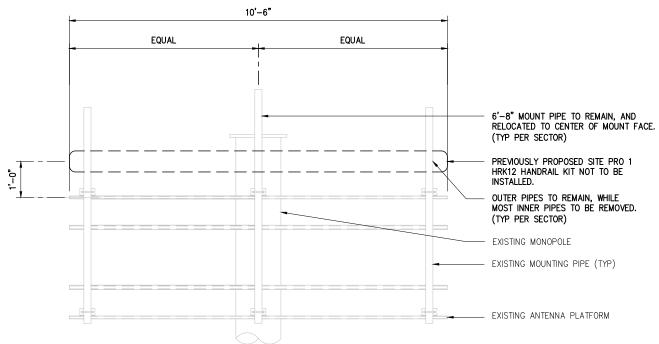
302519 133 HORSE FENCE HILL ROAD SOUTHBURY, CT 06488





GENERAL NOTES



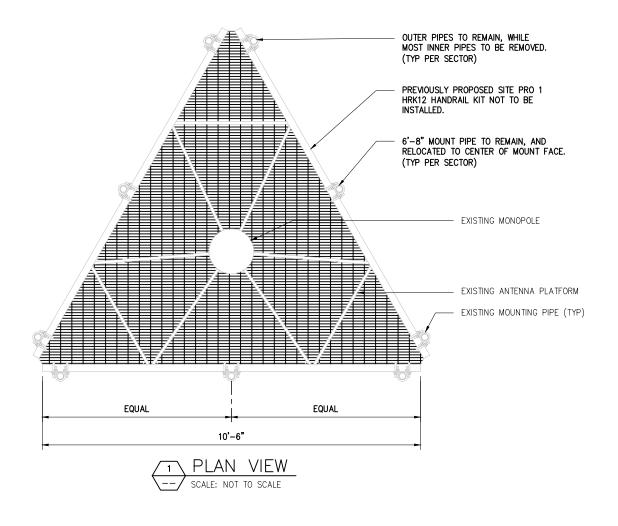



#### NOTES:

- PROPOSED MODIFICATIONS ARE TYPICAL FOR ALL SECTORS.
- 2. ALL DESIGNATED PARTS ARE TO BE INSTALLED PER MANUFACTURER'S SPECIFICATIONS, UNLESS OTHERWISE NOTED.
- REMOVAL/REPLACEMENT OF STRUCTURAL MEMBERS SHALL BE DONE ONE MEMBER AT A TIME. CONTRACTOR IS RESPONSIBLE FOR ENSURING THE STRUCTURAL INTEGRITY OF THE STRUCTURE DURING ALL PHASES OF CONSTRUCTION.

ENGINEERING, PLLC

8865 DEERPATH ROAD SUITE 152
ELKRIDGE, ND 21075



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12/9/20

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repared For:







ANTENNA PLATFORM MODIFICATION

Drawing Number