



ATC SITE NAME: SALEM CT ATC SITE NUMBER: 10027

VERIZON SITE NAME: SALEM SOUTH CT

VERIZON SITE NUMBER: 765832 VERIZON FUZE PID: 16990579

SITE ADDRESS: 153 EAST HADDAM ROAD

SALEM, CT 06420-3903



LOCATION MAP

VERIZON COLLOCATION PLAN

COMPLIANCE CODE	PROJECT SUMMARY PROJECT DESCRIPTION SHEET INDEX							
ALL WORK SHALL BE PERFORMED AND MATERIALS INSTALLED IN ACCORDANCE WITH THE CURRENT EDITIONS OF THE	SITE ADD		THE PROPOSED PROJECT INCLUDES PLACING EQUIPMENT CABINETS ON A PROPOSED CONCRETE PAD INSIDE A 12'x30'	SHEET NO:	DESCRIPTION:	REV:	DATE:	BY:
FOLLOWING CODES AS ADOPTED BY THE LOCAL GOVERNMENT AUTHORITIES. NOTHING IN THESE PLANS IS	153 EAST HAD SALEM, CT 0		(360 SQ FT) GROUND SPACE WITHIN THE EXISTING COMPOUND, AND PLACING NEW ANTENNAS ON PROPOSED SECTOR FRAMES	G-001	TITLE SHEET	1	01/22/24	VL
TO BE CONSTRUED TO PERMIT WORK NOT CONFORMING TO THESE CODES.	COUNTY: NEW LO	V LONDON	MOUNTED TO THE EXISTING TOWER. INSTALL (9) ANTENNAS, (6) RRUS, (1) 12-OVP & (2) 6X12 HYBRID CABLES.	G-002	GENERAL NOTES	1	01/22/24	VL
2022 CONNECTICUT STATE BUILDING CODE-AMENDMENTS	GEOGRAPHIC CO	OORDINATES:		C-001	OVERALL SITE PLAN	1	01/22/24	VL
TO IBC 2021 2. INTERNATIONAL BUILDING CODE 2021, INTERNATIONAL	LATITUDE: 41			C-101	DETAILED SITE PLAN	1	01/22/24	VL
CODE COUNCIL 3. TIA-222-G-4, STRUCTURAL STANDARD FOR ANTENNA	LONGITUDE: -7 GROUND ELEVATI			C-102	DETAILED EQUIPMENT PLAN	1	1 01/22/24 VL	
SUPPORTING STRUCTURES AND ANTENNAS				C-201	TOWER ELEVATION	1	01/22/24	VL
ASCE 7-10 MINIMUM DESIGN LOADS FOR BUILDINGS AND OTHER STRUCTURES, AMERICAN SOCIETY OF CIVIL			PROJECT NOTES	C-401	ANTENNA INFORMATION & SCHEDULE	1	01/22/24	VL
ENGINEERS 5. STEEL CONSTRUCTION MANUAL 14TH EDITION, AMERICAN INSTITUTE OF STEEL CONSTRUCTION			THE FACILITY IS UNMANNED.	C-501	MOUNT DETAILS	1	01/22/24	VL
			A TECHNICIAN WILL VISIT THE SITE APPROXIMATELY ONCE A MONTH FOR ROUTINE INSPECTION AND MAINTENANCE.	C-502	CONSTRUCTION DETAILS	1	01/22/24	VL
6. CITY/COUNTY ORDINANCES	PROJECT	TEAM	 THE PROJECT WILL NOT RESULT IN ANY SIGNIFICANT LAND DISTURBANCE OR EFFECT OF STORM WATER DRAINAGE. 	C-503	CONSTRUCTION DETAILS	1	01/22/24	VL
	TOWER OWNER:	APPLICANT:	NO SANITARY SEWER, POTABLE WATER OR TRASH DISPOSAL IS REQUIRED.	C-504	CONSTRUCTION DETAILS	1	01/22/24	VL
	AMERICAN TOWER	VERIZON WIRELESS	5. HANDICAP ACCESS IS NOT REQUIRED. 6. THE PROJECT DEPICTED IN THESE PLANS QUALIFIES AS	E-101	GROUNDING PLAN & NOTES	1	01/22/24	VL
	10 PRESIDENTIAL WAY WOBURN, MA 01801	21 ALDER STREET MEDWAY, MA 02053	AN ELIGIBLE FACILITIES REQUEST ENTITLED TO EXPEDITED REVIEW UNDER 47 U.S.C. § 1455(A) AS A	E-501	GROUNDING DETAILS	1	01/22/24	VL
	ENGINEER:	·	MODIFICATION OF AN EXISTING WIRELESS TOWER THAT INVOLVES THE COLLOCATION, REMOVAL, AND/OR	E-601	O1 ONE-LINE & PANEL SCHEDULE	1	01/22/24	VL
	DEWBERRY ENGINEERS INC.		REPLACEMENT OF TRANSMISSION EQUIPMENT THAT IS NOT A SUBSTANTIAL CHANGE UNDER CFR § 1.61000 (B)(7).	R-601	SUPPLEMENTAL			
UTILITY COMPANIES	99 SUMMER STREET SUITE 700		PROJECT LOCATION DIRECTIONS	R-602	SUPPLEMENTAL			
POWER COMPANY: UNKNOWN PHONE: N/A	BOSTON, MA 02110 PHONE: 617.695.3400 FAX: 617.695.3310		PROJECT LOCATION DIRECTIONS					
TELEPHONE COMPANY: UNKNOWN PHONE: N/A	PROPERTY OWNER: AMERICAN TOWER CORP PO BOX 723597 ATLANTA, GA 31139		FROM I-395 W (NORWICH ROAD). GO THROUGH THE INTERSECTION OF RT. 85 (HARTFORD RD./NEW LONDON RD.). PASS SHINGLE MILL RD AFTER PASSING GETTY GRANITE ON YOUR RIGHT, THE TOWER WILL BE ON YOUR LEFT.					





Dewberry Engineers Inc.
99 SUMMER STREET SUITE 700 BOSTON, MA 02110 PHONE: 617.695.3400 FAX: 617.695.3310

REV.	DESCRIPTION	BY	DATE
<u> </u>	PRELIM	VL_	05/10/23
<u> </u>	FINAL	VL_	12/14/23
<u></u>	FINAL	VL_	01/22/24
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SALEM CT

VERIZON SITE NAME:

SALEM SOUTH CT

SITE ADDRESS: 153 EAST HADDAM ROAD SALEM, CT 06420-3903



CUSTOMER ID: SALEM SOUTH CT CUSTOMER #: 765832

TITLE SHEET

SHEET NUMBER:

G-001

GENERAL CONSTRUCTION NOTES:

- OWNER FURNISHED MATERIALS, VERIZON "THE COMPANY" WILL PROVIDE AND THE CONTRACTOR WILL INSTALL
 - BTS EQUIPMENT FRAME (PLATFORM) AND ICEBRIDGE SHELTER (GROUND
 - BUILD/CO-LOCATE ONLY) AC/TELCO INTERFACE BOX (PPC)
 - C. ICE BRIDGE (CABLE TRAY WITH COVER) (GROUND BUILD/CO-LOCATE ONLY, GC TO FURNISH AND INSTALL FOR ROOFTOP INSTALLATION)
 - D. TOWERS, MONOPOLES
 - TOWER LIGHTING
 - GENERATORS & LIQUID PROPANE TANK
 - ANTENNA STANDARD BRACKETS, FRAMES AND PIPES FOR MOUNTING
 - ANTENNAS (INSTALLED BY OTHERS)
 - TRANSMISSION LINE
 - TRANSMISSION LINE JUMPERS
 - TRANSMISSION LINE CONNECTORS WITH WEATHERPROOFING KITS
 - TRANSMISSION LINE GROUND KITS
 - HANGERS
 - HOISTING GRIPS
 - O. BTS EQUIPMENT
- THE CONTRACTOR IS RESPONSIBLE TO PROVIDE ALL OTHER MATERIALS FOR THE COMPLETE INSTALLATION OF THE SITE INCLUDING, BUT NOT LIMITED TO, SUCH MATERIALS AS FENCING, STRUCTURAL STEEL SUPPORTING SUB-FRAME FOR PLATFORM, ROOFING LABOR AND MATERIALS GROUNDING RINGS GROUNDING WIRES COPPER-CLAD OR XIT CHEMICAL GROUND ROD(S), BUSS BARS, TRANSFORMERS AND DISCONNECT SWITCHES WHERE APPLICABLE, TEMPORARY ELECTRICAL POWER, CONDUIT LANDSCAPING COMPOUND STONE, CRANES, CORE DRILLING, SLEEPERS AND RUBBER MATTING, REBAR, CONCRETE CAISSONS, PADS AND/OR AUGER MOUNTS, MISCELLANEOUS FASTENERS, CABLE TRAYS, NON-STANDARD ANTENNA FRAMES AND ALL OTHER MATERIAL AND LABOR REQUIRED TO COMPLETE THE JOB ACCORDING TO THE DRAWINGS AND SPECIFICATIONS. IT IS THE POSITION OF VERIZON TO APPLY FOR PERMITTING AND CONTRACTOR RESPONSIBLE FOR PICKUP AND PAYMENT OF REQUIRED
- ALL WORK SHALL CONFORM TO ALL CURRENT APPLICABLE FEDERAL, STATE, AND LOCAL CODES, INCLUDING ANSI/EIA/TIA-222, AND COMPLY WITH ATC CONSTRUCTION
- CONTRACTOR SHALL CONTACT LOCAL 811 FOR IDENTIFICATION OF UNDERGROUND UTILITIES PRIOR TO START OF CONSTRUCTION.
- CONTRACTOR SHALL BE RESPONSIBLE FOR COORDINATING ALL REQUIRED INSPECTIONS.
- ALL DIMENSIONS TO, OF, AND ON EXISTING BUILDINGS, DRAINAGE STRUCTURES, AND SITE IMPROVEMENTS SHALL BE VERIFIED IN FIELD BY CONTRACTOR WITH ALL DISCREPANCIES REPORTED TO THE ENGINEER.
- DO NOT CHANGE SIZE OR SPACING OF STRUCTURAL ELEMENTS
- DETAILS SHOWN ARE TYPICAL: SIMILAR DETAILS APPLY TO SIMILAR CONDITIONS UNLESS
- THESE DRAWINGS DO NOT INCLUDE NECESSARY COMPONENTS FOR CONSTRUCTION SAFETY WHICH SHALL BE THE SOLE RESPONSIBILITY OF THE CONTRACTOR
- CONTRACTOR SHALL BRACE STRUCTURES UNTIL ALL STRUCTURAL ELEMENTS NEEDED FOR STABILITY ARE INSTALLED. THESE ELEMENTS ARE AS FOLLOWS: LATERAL BRACING,
- CONTRACTOR SHALL DETERMINE EXACT LOCATION OF EXISTING UTILITIES. GROUNDS DRAINS, DRAIN PIPES, VENTS, ETC, BEFORE COMMENCING WORK
- INCORRECTLY FABRICATED, DAMAGED, OR OTHERWISE MISFITTING OR NONCONFORMING MATERIALS OR CONDITIONS SHALL BE REPORTED TO THE VERIZON REP PRIOR TO REMEDIAL OR CORRECTIVE ACTION, ANY SUCH REMEDIAL ACTION SHALL REQUIRE WRITTEN APPROVAL BY THE VERIZON REP PRIOR TO PROCEEDING.
- EACH CONTRACTOR SHALL COOPERATE WITH THE VERIZON REP, AND COORDINATE HIS WORK WITH THE WORK OF OTHERS.
- CONTRACTOR SHALL REPAIR ANY DAMAGE CAUSED BY CONSTRUCTION OF THIS PROJECT TO MATCH EXISTING PRE-CONSTRUCTION CONDITIONS TO THE SATISFACTION
- ALL CABLE/CONDUIT ENTRY/EXIT PORTS SHALL BE WEATHERPROOFED DURING 15. INSTALLATION LISING A SILICONE SEALANT
- WHERE EXISTING CONDITIONS DO NOT MATCH THOSE SHOWN IN THIS PLAN SET. CONTRACTOR SHALL NOTIFY THE VERIZON REP AND ENGINEER OF RECORD
- CONTRACTOR SHALL ENSURE ALL SUBCONTRACTORS ARE PROVIDED WITH A COMPLETE AND CURRENT SET OF DRAWINGS AND SPECIFICATIONS FOR THIS PROJECT.
- CONTRACTOR SHALL REMOVE ALL RUBBISH AND DEBRIS FROM THE SITE AT THE END OF
- CONTRACTOR SHALL COORDINATE WORK SCHEDULE WITH AMERICAN TOWER CORPORATION (ATC) AND TAKE PRECAUTIONS TO MINIMIZE IMPACT AND DISRUPTION OF OTHER OCCUPANTS OF THE FACILITY.
- CONTRACTOR SHALL FURNISH VERIZON AND AMERICAN TOWER CORPORATION (ATC) WITH A PDF MARKED UP AS-BUILT SET OF DRAWINGS UPON COMPLETION OF WORK
- PRIOR TO SUBMISSION OF BID, CONTRACTOR SHALL COORDINATE WITH VERIZON REP TO DETERMINE WHAT, IF ANY, ITEMS WILL BE PROVIDED. ALL ITEMS NOT PROVIDED SHALL BE PROVIDED AND INSTALLED BY THE CONTRACTOR. CONTRACTOR WILL INSTALL

- 22. PRIOR TO SUBMISSION OF BID. CONTRACTOR SHALL COORDINATE WITH VERIZON REP TO DETERMINE IF ANY PERMITS WILL BE OBTAINED BY CONTRACTOR. ALL REQUIRED PERMITS NOT OBTAINED BY VERIZON MUST BE OBTAINED, AND PAID FOR, BY THE
- CONTRACTOR SHALL INSTALL ALL SITE SIGNAGE IN ACCORDANCE WITH VERIZON SPECIFICATIONS AND REQUIREMENTS.
- CONTRACTOR SHALL SUBMIT ALL SHOP DRAWINGS TO VERIZON FOR REVIEW AND 24. APPROVAL PRIOR TO FABRICATION
- ALL EQUIPMENT SHALL BE INSTALLED ACCORDING TO MANUFACTURER'S SPECIFICATIONS AND LOCATED ACCORDING TO VERIZON SPECIFICATIONS, AND AS SHOWN IN THESE PLANS
- 26. THE CONTRACTOR SHALL SUPERVISE AND DIRECT THE PROJECT DESCRIBED HEREIN THE CONTRACTOR SHALL BE SOLELY RESPONSIBLE FOR ALL THE CONSTRUCTION MEANS, METHODS, TECHNIQUES, SEQUENCES AND PROCEDURES AND FOR COORDINATING ALL PORTIONS OF THE WORK UNDER THE CONTRACT.
- CONTRACTOR SHALL NOTIFY VERIZON REP A MINIMUM OF 48 HOURS IN ADVANCE OF POURING CONCRETE OR BACKFILLING ANY UNDERGROUND UTILITIES, FOUNDATIONS OR SEALING ANY WALL, FLOOR OR ROOF PENETRATIONS FOR ENGINEERING REVIEW AND
- CONTRACTOR SHALL BE RESPONSIBLE FOR SITE SAFETY INCLUDING COMPLIANCE WITH ALL APPLICABLE OSHA STANDARDS AND RECOMMENDATIONS AND SHALL PROVIDE ALL NECESSARY SAFETY DEVICES INCLUDING PPE AND PPM AND CONSTRUCTION DEVICES SUCH AS WELDING AND FIRE PREVENTION, TEMPORARY SHORING, SCAFFOLDING, TRENCH BOXES/SLOPING, BARRIERS, ETC.
- THE CONTRACTOR SHALL PROTECT AT HIS OWN EXPENSE, ALL EXISTING FACILITIES AND SPECIAL CONSTRUCTION SUCH OF HIS NEW WORK LIABLE TO INJURY DURING THE CONSTRUCTION PERIOD. ANY DAMAGE CAUSED BY NEGLECT ON THE PART OF THIS CONTRACTOR OR HIS REPRESENTATIVES, OR BY THE ELEMENTS DUE TO NEGLECT ON THE PART OF THIS CONTRACTOR OR HIS REPRESENTATIVES, EITHER TO THE EXISTING WORK, OR TO HIS WORK OF ANY OTHER CONTRACTOR, SHALL BE REPAIRED AT HIS EXPENSE TO THE OWNER'S SATISFACTION.
- ALL WORK SHALL BE INSTALLED IN A FIRST CLASS, NEAT AND WORKMANLIKE MANNER BY MECHANICS SKILLED IN THE TRADE INVOLVED. THE QUALITY OF WORKMANSHIP SHALL BE SUBJECT TO THE APPROVAL OF THE VERIZON REP. ANY WORK FOUND BY THE VERIZON REP TO BE OF INFERIOR QUALITY AND/OR WORKMANSHIP SHALL BE REPLACED AND/OR REWORKED AT CONTRACTOR EXPENSE UNTIL APPROVAL IS
- 31. IN ORDER TO ESTABLISH STANDARDS OF QUALITY AND PERFORMANCE, ALL TYPES OF MATERIALS LISTED HEREINAFTER BY MANUFACTURER'S NAMES AND/OR
 MANUFACTURER'S CATALOG NUMBER SHALL BE PROVIDED BY THESE MANUFACTURERS AS SPECIFIED.
- VERIZON FURNISHED EQUIPMENT SHALL BE PICKED-UP AT THE VERIZON WAREHOUSE AND INSTALLED BY THE CONTRACTOR WITH ALL APPURTENANCES REQUIRED TO PLACE THE EQUIPMENT IN OPERATION, READY FOR USE. THE CONTRACTOR SHALL BE RESPONSIBLE FOR THE EQUIPMENT AFTER PICKING IT UP
- VERIZON OR HIS ARCHITECT/ENGINEER RESERVES THE RIGHT TO REJECT ANY FOLIPMENT OR MATERIALS WHICH IN HIS OWN OPINION ARE NOT IN COMPLIANCE WITH THE CONTRACT DOCUMENTS, EITHER BEFORE OR AFTER INSTALLATION AND THE EQUIPMENT SHALL BE REPLACED WITH EQUIPMENT CONFORMING TO THE REQUIREMENTS OF THE CONTRACT DOCUMENTS BY THE CONTRACTOR AT NO COST TO VERIZON OR THEIR ARCHITECT/ENGINEER

STRUCTURAL STEEL NOTES:

- STRUCTURAL STEEL SHALL CONFORM TO THE LATEST EDITION OF THE AISC "SPECIFICATION FOR THE DESIGN, FABRICATION AND ERECTION OF STRUCTURAL STEEL
- STRUCTURAL STEEL ROLLED SHAPES, PLATES AND BARS SHALL CONFORM TO THE FOLLOWING ASTM DESIGNATIONS:
 - A. ASTM A-572, GRADE 50 ALL W SHAPES, UNLESS NOTED OR A992 OTHERWISE
 - B. ASTM A-36 ALL OTHER ROLLED SHAPES, PLATES AND BARS UNLESS NOTED
 - C. ASTM A-500, GRADE B HSS SECTION (SQUARE, RECTANGULAR, AND ROUND)
 - D. ASTM A-325, TYPE SC OR N ALL BOLTS FOR CONNECTING STRUCTURAL
 - E. ASTM F-1554 07 ALL ANCHOR BOLTS, UNLESS NOTED OTHERWISE
- ALL EXPOSED STRUCTURAL STEEL MEMBERS SHALL BE HOT-DIPPED GALVANIZED AFTER FABRICATION PER ASTM A123. EXPOSED STEEL HARDWARE AND ANCHOR BOLTS SHALL BE GALVANIZED PER ASTM A153 OR B695
- ALL FIELD CUT SURFACES, FIELD DRILLED HOLES AND GROUND SURFACES WHERE EXISTING PAINT OR GALVANIZATION REMOVAL WAS REQUIRED SHALL BE REPAIRED WITH

 (2) BRUSHED COATS OF ZRC GALVILITE COLD GALVANIZING COMPOUND PER ASTM A780 AND MANUFACTURER'S RECOMMENDATIONS
- DO NOT DRILL HOLES THROUGH STRUCTURAL STEEL MEMBERS EXCEPT AS SHOWN AND DETAILED ON STRUCTURAL DRAWINGS.
- CONNECTIONS:
 - A. ALL WELDING TO BE PERFORMED BY AWS CERTIFIED WELDERS AND CONDUCTED IN ACCORDANCE WITH THE LATEST EDITION OF THE AWS WELDING CODE D1.1.

- ALL WELDS SHALL BE INSPECTED VISUALLY. 25% OF WELDS SHALL BE INSPECTED WITH DYE PENETRANT OR MAGNETIC PARTICLE TO MEET THE ACCEPTANCE CRITERIA OF AWS D1 1 REPAIR ALL WELDS AS NECESSARY
- C. INSPECTION SHALL BE PERFORMED BY AN AWS CERTIFIED WELD INSPECTOR.
- D. IT IS THE CONTRACTORS RESPONSIBILITY TO PROVIDE BURNING/WELDING PERMITS AS REQUIRED BY LOCAL GOVERNING AUTHORITY AND IF REQUIRED SHALL HAVE FIRE DEPARTMENT DETAIL FOR ANY WELDING ACTIVITY.
- E. ALL ELECTRODES TO BE LOW HYDROGEN, MATCHING FILLER METAL, PER AWS D1.1, UNLESS NOTED OTHERWISE
- F. MINIMUM WELD SIZE TO BE 0.1875 INCH FILLET WELDS, UNLESS NOTED
- G PRIOR TO FIELD WELDING GALVANIZING MATERIAL CONTRACTOR SHALL GRIND OFF GALVANIZING ½" BEYOND ALL FIELD WELD SURFACES. AFTER WELD AND WELD INSPECTION IS COMPLETE, REPAIR ALL GROUND AND WELDED SURFACES WITH ZRC GALVILITE COLD GALVANIZING COMPOUND PER ASTM A780 AND MANUFACTURERS RECOMMENDATIONS.
- THE CONTRACTOR SHALL PROVIDE ADEQUATE SHORING AND/OR BRACING WHERE REQUIRED DURING CONSTRUCTION UNTIL ALL CONNECTIONS ARE
- ANY FIELD CHANGES OR SUBSTITUTIONS SHALL HAVE PRIOR APPROVAL FROM THE ENGINEER, AND VERIZON PROJECT MANAGER IN WRITING

ANTENNA INSTALLATION NOTES:

- WORK INCLUDED:
 - ANTENNA AND COAXIAL CABLES ARE FURNISHED BY VERIZON UNDER A SEPARATE CONTRACT. THE CONTRACTOR SHALL ASSIST ANTENNA INSTALLATION CONTRACTOR IN TERMS OF COORDINATION AND SITE ACCESS ERECTION SUBCONTRACTOR SHALL BE RESPONSIBLE FOR THE PROTECTION OF
 - B. INSTALL ANTENNAS AS INDICATED ON DRAWINGS AND VERIZON SPECIFICATIONS.
 - C. INSTALL GALVANIZED STEEL ANTENNA MOUNTS AS INDICATED ON DRAWINGS.
 - D. INSTALL FURNISHED GALVANIZED STEEL OR ALUMINUM WAVEGUIDE AND PROVIDE PRINTOUT OF THAT TEST
 - F CONTRACTOR SHALL PROVIDE FOLIR (4) SETS OF SWEEP TESTS LISING ANRITZU-PACKARD 8713B RF SCALAR NETWORK ANALYZER. SUBMIT FREQUENCY DOMAIN REFLECTOMETER(FDR) TESTS RESULTS TO THE PROJECT MANAGER. SWEEP TESTS SHALL BE AS PER ATTACHED RES "MINIMUM FIELD TESTING RECOMMENDED FOR ANTENNA AND HELIAX COAXIAL CABLE SYSTEMS" DATED 10/5/93, TESTING SHALL BE PERFORMED BY AN INDEPENDENT TESTING SERVICE AND BE BOUND AND SUBMITTED WITHIN ONE WEEK OF WORK COMPLETION.
 - INSTALL COAXIAL CABLES AND TERMINATING BETWEEN ANTENNAS AND EQUIPMENT PER MANUFACTURER'S RECOMMENDATIONS. WEATHERPROOF ALL CONNECTIONS BETWEEN THE ANTENNA AND EQUIPMENT PER MANUFACTURER'S REQUIREMENTS. TERMINATE ALL COAXIAL CABLE THREE (3) FEET IN EXCESS OF ENTRY PORT LOCATION UNLESS OTHERWISE STATED.
 - G. ANTENNA AND COAXIAL CABLE GROUNDING:
- ALL EXTERIOR #6 GREEN GROUND WIRE "DAISY CHAIN" CONNECTIONS ARE TO BE WEATHER SEALED WITH RFS CONNECTORS/SPLICE WEATHERPROOFING KIT #221213 OR
- ALL COAXIAL CABLE GROUNDING KITS ARE TO BE INSTALLED ON STRAIGHT RUNS OF COAXIAL CABLE (NOT WITHIN BENDS).

CONCRETE AND REINFORCING STEEL NOTES:

- DESIGN AND CONSTRUCTION OF ALL CONCRETE ELEMENTS SHALL CONFORM TO THE LATEST EDITIONS OF ALL APPLICABLE CODES INCLUDING: ACI 301 "SPECIFICATIONS FOR STRUCTURAL CONCRETE FOR BUILDINGS", ACI 117 "SPECIFICATIONS FOR TOLERANCES FOR CONCRETE CONSTRUCTION AND MATERIALS", AND ACI 318 "BUILDING CODE REQUIREMENTS FOR REINFORCED CONCRETE.'
- 2. MIX DESIGN SHALL BE APPROVED BY VERIZON, REP PRIOR TO PLACING CONCRETE
- CONCRETE SHALL BE NORMAL WEIGHT, 6 % AIR ENTRAINED (+/- 1.5%) WITH A SLUMP RANGE OF 3-6" AND HAVE A MINIMUM 28-DAY COMPRESSIVE STRENGTH OF 4500 PSI UNLESS OTHERWISE NOTED.
- THE FOLLOWING MATERIALS SHALL BE USED: PORTLAND CEMENT: ASTM C150, TYPE 2

REINFORCEMENT: ASTM A185 PLAIN STEEL WELDED WIRE FARRIC

REINFORCEMENT BARS: ASTM A615, GRADE 60, DEFORMED

NORMAL WEIGHT AGGREGATE: ASTM C33 WATER: ASTM C 94/C 94M

WELDED WIRE FABRIC ASTM A185 ADMIXTURES: -WATER-REDUCING AGENT:

> -AIR-ENTERING AGENT: ASTM C 260/C 260M -SUPERPLASTICIZER: ASTM C494, TYPE F OR TYPE G -RETARDING: ASTM C 494/C 494M, TYPE B

ASTM C 494/C 494M, TYPE A

MINIMUM CONCRETE COVER FOR REINFORCING STEEL SHALL BE NO LESS THAN 3".

- A 3/4" CHAMFER SHALL BE PROVIDED AT ALL EXPOSED EDGES OF CONCRETE IN ACCORDANCE WITH ACI 301 SECTION 4.2.4 LINLESS NOTED OTHERWISE
- INSTALLATION OF CONCRETE EXPANSION/WEDGE ANCHOR SHALL BE PER MANUFACTURER'S WRITTEN RECOMMENDED PROCEDURE. THE ANCHOR BOLT, DOWEL OR ROD SHALL CONFORM TO MANUFACTURER'S RECOMMENDATION FOR EMBEDMENT DEPTH OR AS SHOWN ON THE DRAWINGS. NO REBAR SHALL BE CUT WITHOUT PRIOR APPROVAL FROM AN ATC ENGINEER WHEN DRILLING HOLES IN CONCRETE
- ADMIXTURES SHALL CONFORM TO THE APPROPRIATE ASTM STANDARD AS REFERENCED IN "METHOD 1" OF ACI 301.
- DO NOT WELD OR TACK WELD REINFORCING STEEL.
- ALL DOWELS, ANCHOR BOLTS, EMBEDDED STEEL, ELECTRICAL CONDUITS, PIPE SLEEVES, GROUNDS AND ALL OTHER EMBEDDED ITEMS AND FORMED DETAILS SHALL BE IN PLACE BEFORE START OF CONCRETE PLACEMENT.
- REINFORCEMENT SHALL BE COLD BENT WHENEVER BENDING IS REQUIRED.
- 12. DO NOT PLACE CONCRETE IN WATER, ICE, OR ON FROZEN GROUND.
- FOR COLD-WEATHER (ACI 306) AND HOT-WEATHER (ACI 301M) CONCRETE PLACEMENT CONFORM TO APPLICABLE ACI CODES AND RECOMMENDATIONS. IN EITHER CASE, MATERIALS CONTAINING CHLORIDE, CALCIUM, SALTS, ETC, SHALL NOT BE USED. PROTECT FRESH CONCRETE FROM WEATHER FOR 7 DAYS, MINIMUM.
- ALL CONCRETE SHALL HAVE A "SMOOTH FORM FINISH."
- SPLICING OF REINFORCEMENT IS PERMITTED ONLY AT LOCATIONS SHOWN IN THE CONTRACT DRAWINGS OR AS ACCEPTED BY THE ENGINEER. UNLESS OTHERWISE SHOWN OR NOTED REINFORCING STEEL SHALL BE SPLICED TO DEVELOP ITS FULL TENSILE CAPACITY (CLASS A) IN ACCORDANCE WITH ACI 318.
- DETAILING OF REINFORCING STEEL SHALL CONFORM TO "ACI MANUAL OF STANDARD PRACTICE FOR DETAILING REINFORCED CONCRETE STRUCTURES" (ACI 315)
- ALL SLAB CONSTRUCTION SHALL BE CAST MONOLITHICALLY WITHOUT HORIZONTAL CONSTRUCTION JOINTS, UNLESS SHOWN IN THE CONTRACT DRAWINGS.
- LOCATION OF ALL CONSTRUCTION JOINTS ARE SUBJECT TO THE REQUIREMENTS OF THE CONTRACT DOCUMENTS, CONFORMANCE WITH ACI 318, AND ACCEPTANCE OF THE ENGINEER. DRAWINGS SHOWING LOCATION OF DETAILS OF THE PROPOSED CONSTRUCTION JOINTS SHALL BE SUBMITTED WITH REINFORCING STEEL PLACEMENT
- SPLICES OF WWF, AT ALL SPLICED EDGES, SHALL BE SUCH THAT THE OVERLAP MEASURED BETWEEN OUTERMOST CROSS WIRES OF EACH FABRIC SHEET IS NOT LESS THAN THE SPACING OF THE CROSS WIRE PLUS 2 INCHES. NOR LESS THAN 6".
- BAR SUPPORTS SHALL BE ALL-GALVANIZED METAL WITH PLASTIC TIPS
- ALL REINFORCEMENT SHALL BE SECURELY TIED IN PLACE TO PREVENT DISPLACEMENT BY CONSTRUCTION TRAFFIC OR CONCRETE. TIE WIRE SHALL BE OF SUFFICIENT STRENGTH FOR INTENDED PURPOSE, BUT NOT LESS THAN NO. 18 GAUGE.
- SLAB ON GROUND: COMPACT STRUCTURAL FILL TO 95% DENSITY AND THEN PLACE 6"

ELECTRICAL NOTES:

- ELECTRICAL WORK SHALL BE PERFORMED BY ELECTRICAL CONTRACTOR. ELECTRICAL CONTRACTOR SHALL ENSURE THAT ALL WORK COMPLIES WITH ALL APPLICABLE LOCAL AND STATE CODES AND NATIONAL ELECTRICAL CODE.
- ALL SUGGESTED ELECTRICAL ELEMENTS (SUCH AS BREAKER SIZES, WIRE SIZES, CONDUITS SIZES) ARE FOR ZONING PURPOSES ONLY. IT IS THE RESPONSIBILITY TO OF THE ELECTRICAL CONTRACTOR TO CONFIRM COMPLIANCE WITH LOCAL ELECTRICAL CODES AND PASS ALL APPLICABLE AND NECESSARY INSPECTIONS. IN SOME EVENTS, IT MAY BE NECESSARY TO PERFORM AN ELECTRICAL LOAD STUDY TO VERIFY THE CAPACITY OF THE EXISTING SERVICE. THIS IS NOT THE RESPONSIBILITY OF ATC. IT IS THE RESPONSIBILITY OF THE ELECTRICAL CONTRACTOR.
- CONTRACTOR SHALL FIELD LOCATE ALL BELOW GRADE GROUNDING CABLES AND UTILITY LINES PRIOR TO CONSTRUCTION. CONTRACTOR IS RESPONSIBLE FOR RELOCATION OF ALL UTILITIES AND GROUNDING LINES THAT MAY BECOME DISTURBED OR CONFLICTING IN THE COURSE OF CONSTRUCTION.

ALL DISCREPANCIES FROM WHAT IS SHOWN ON THESE CONSTRUCTION DRAWINGS SHALL BE COMMUNICATED TO ATC ENGINEERING IMMEDIATELY FOR CORRECTION OR RE-DESIGN. FAILURE TO COMMUNICATE DIRECTLY WITH ATC ENGINEERING OR ANY CHANGES FROM THE DESIGN CONDUCTED WITHOUT PRIOR APPROVAL FROM ATC ENGINEERING SHALL BE THE SOLE RESPONSIBILITY OF THE GENERAL CONTRACTOR.





99 SUMMER STREET SUITE 700 BOSTON, MA 02110 PHONE: 617.695.3400 FAX: 617.695.3310

REV. DESCRIPTION BY DATE **PRELIM** VL__05/10/23 FINAL VL 12/14/23 FINAL VL 01/22/24

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SEAL





CUSTOMER ID: SALEM SOUTH CT

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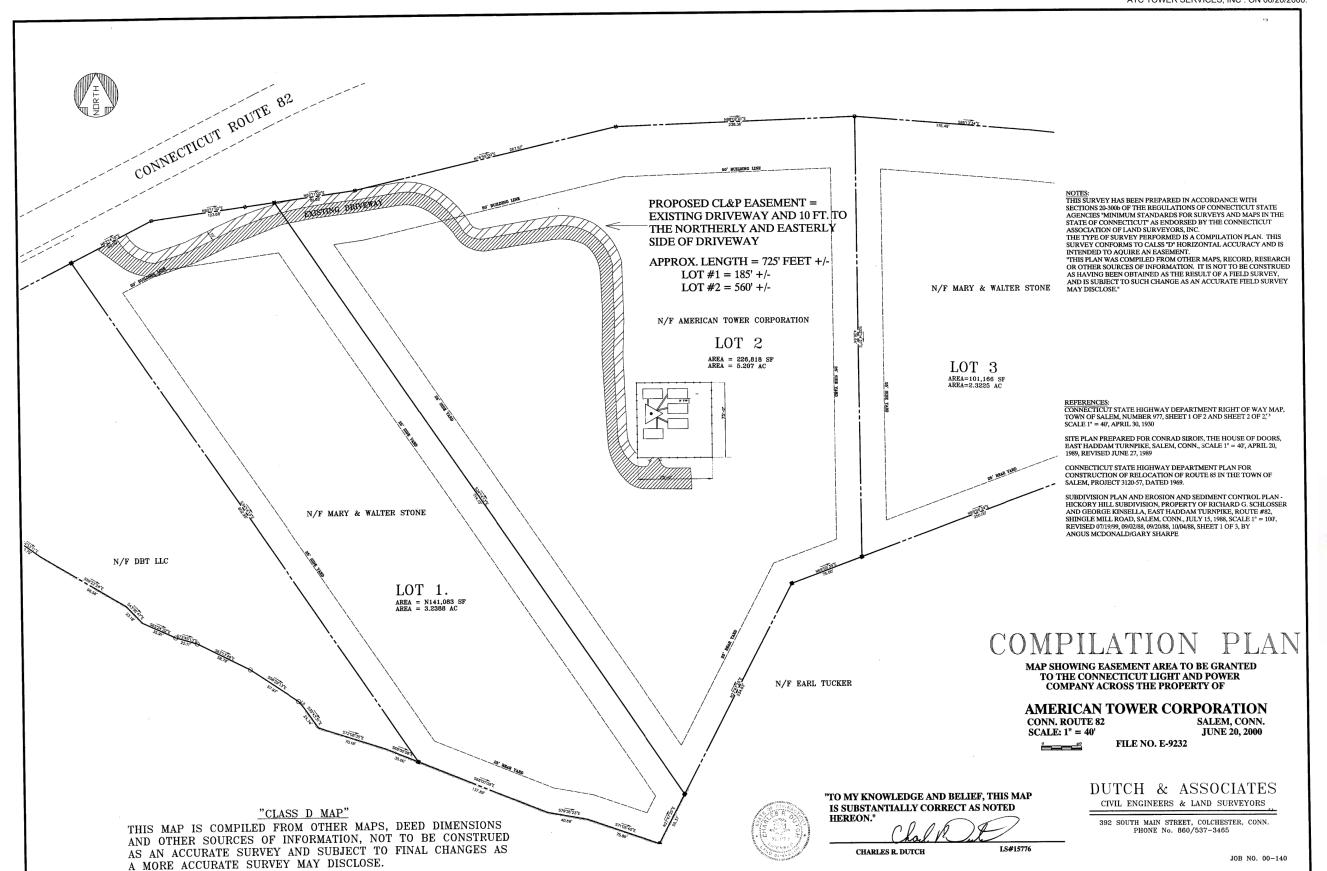
GENERAL NOTES

SHEET NUMBER:

G-002

NOTES:

- DEWBERRY HAS NOT BEEN CONTRACTED TO PERFORM AN BOUNDARY AND TOPOGRAPHIC SURVEY AT THIS SITE.
- 2. SURVEY INFORMATION OBTAINED FROM SURVEY PROVIDED BY ATC. PREPARED FOR ATC TOWER SERVICES, INC . ON 06/20/2000.







Dewberry Engineers Inc. 99 SUMMER STREET SUITE 700 BOSTON, MA 02110

PHONE: 617.695.3400 FAX: 617.695.3310

REV.	DESCRIPTION	BY	DATE
<u> </u>	PRELIM	VL	05/10/23
<u></u>	FINAL	VL	12/14/23
<u>1</u>	FINAL	VL	01/22/24
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VERIZON SITE NAME:

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SITE ADDRESS: 153 EAST HADDAM ROAD SALEM. CT 06420-3903





ATC JOB NO:

CUSTOMER ID: SALEM SOUTH CT

CUSTOMER #: 765832

OVERALL SITE PLAN

SHEET NUMBER:

C-001


SITE PLAN NOTES:

- THIS SITE PLAN REPRESENTS THE BEST PRESENT KNOWLEDGE AVAILABLE TO THE ENGINEER AT THE TIME OF THIS DESIGN. THE CONTRACTOR SHALL VISIT THE SITE PRIOR TO CONSTRUCTION AND VERIFY ALL EXISTING CONDITIONS RELATED TO THE SCOPE OF WORK FOR THIS PROJECT.
- ICE BRIDGE, CABLE LADDER, COAX PORT, AND COAX CABLE ARE SHOWN FOR REFERENCE ONLY. CONTRACTOR SHALL CONFIRM THE EXACT LOCATION OF ALL PROPOSED AND EXISTING **EQUIPMENT AND STRUCTURES DEPICTED ON** THIS PLAN. BEFORE UTILIZING EXISTING CABLE SUPPORTS, COAX PORTS, INSTALLING NEW PORTS OR ANY OTHER EQUIPMENT, CONTRACTOR SHALL VERIFY ALL ASPECTS OF THE COMPONENTS MEET THE ATC SPECIFICATIONS.
- IT IS THE RESPONSIBILITY OF THE CONTRACTOR TO COORDINATE WITH THE VERIZON REPRESENTATIVE AND LOCAL UTILITY COMPANY FOR THE INSTALLATION OF CONDUITS CONDUCTORS, BREAKERS, DISCONNECTS, OR ANY OTHER EQUIPMENT REQUIRED FOR ELECTRICAL SERVICE. ALL ELECTRICAL WORK SHALL BE PERFORMED IN ACCORDANCE WITH LATEST EDITION OF THE STATE AND NATIONAL CODES, ORDINANCES AND REGULATIONS APPLICABLE TO THIS PROJECT.

LEGEND GROUNDING TEST WELL AUTOMATIC TRANSFER SWITCH ATS BOLLARD CSC CELL SITE CABINET DISCONNECT ELECTRICAL FIBER GEN GENERATOR GENERATOR RECEPTACLE HH, V HAND HOLE, VAULT ΙB ICE BRIDGE KENTROX BOX LIGHTING CONTROL LC METER PB PULL BOX POWER POLE TELCO TRN TRANSFORMER CHAINLINK FENCE

PROPOSED CABLE NOTES:

- ESTIMATED LENGTH OF PROPOSED CABLE IS <u>220</u>'. ESTIMATED LENGTH OF CABLE WAS PROVIDED BY CUSTOMER OR CALCULATED BY ADDING THE RAD CENTER AND THE DISTANCE FROM THE SHELTER ENTRY PLATE TO THE TOWER (ALONG THE ICE BRIDGE) AND A SAFETY FACTOR MEASUREMENT OF 15% (OF THE TWO PREVIOUS VALUES), CDS DEFER TO GREATEST CABLE LENGTH.
- ROUTE PROPOSED CABLES ALONG SAME PATH AS EXISTING CABLES AND IN ACCORDANCE WITH STRUCTURAL ANALYSIS. WHERE POSSIBLE UTILIZE EXISTING CABLE SUPPORT STRUCTURES AS PROVIDED FOR CARRIER TO ADEQUATELY SECURE CABLES, USING EITHER APPROPRIATELY SIZED STAINLESS STEEL SNAP-INS OR MOUNTING HARDWARE AND BRACKETS AS SPECIFIED BY CABLE MANUFACTURER. OTHERWISE, ATTACH CABLES TO HORIZONTAL OR DIAGONAL TOWER MEMBERS USING PROPOSED STAINLESS STEEL ADAPTERS (DO NOT ATTACH TO TOWER LEG).

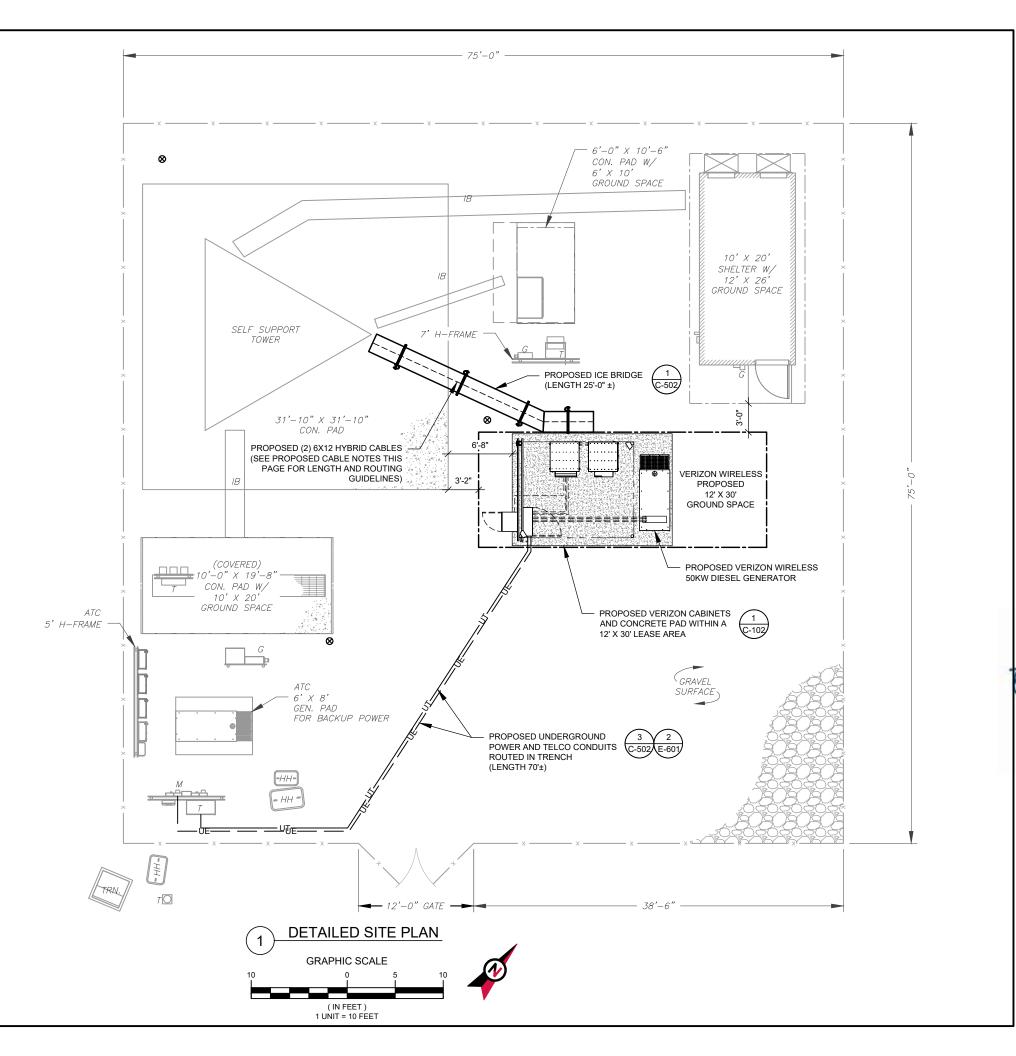





Dewberry Engineers Inc. 99 SUMMER STREET SUITE 700 BOSTON, MA 02110 PHONE: 617.695.3400 FAX: 617.695.3310

REV.	DESCRIPTION	BY	DATE
<u> </u>	PRELIM	VL	05/10/23
<u></u>	FINAL	VL	12/14/23
<u>/1\</u>	FINAL	VL	01/22/24
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ATC SITE NUMBER: 10027 ATC SITE NAME:

SALEM CT

VERIZON SITE NAME:

SALEM SOUTH CT

SITE ADDRESS: 153 EAST HADDAM ROAD SALEM. CT 06420-3903






ATC JOB NO: CUSTOMER ID: SALEM SOUTH CT

CUSTOMER #: 765832

DETAILED SITE PLAN

SHEET NUMBER:

C-101

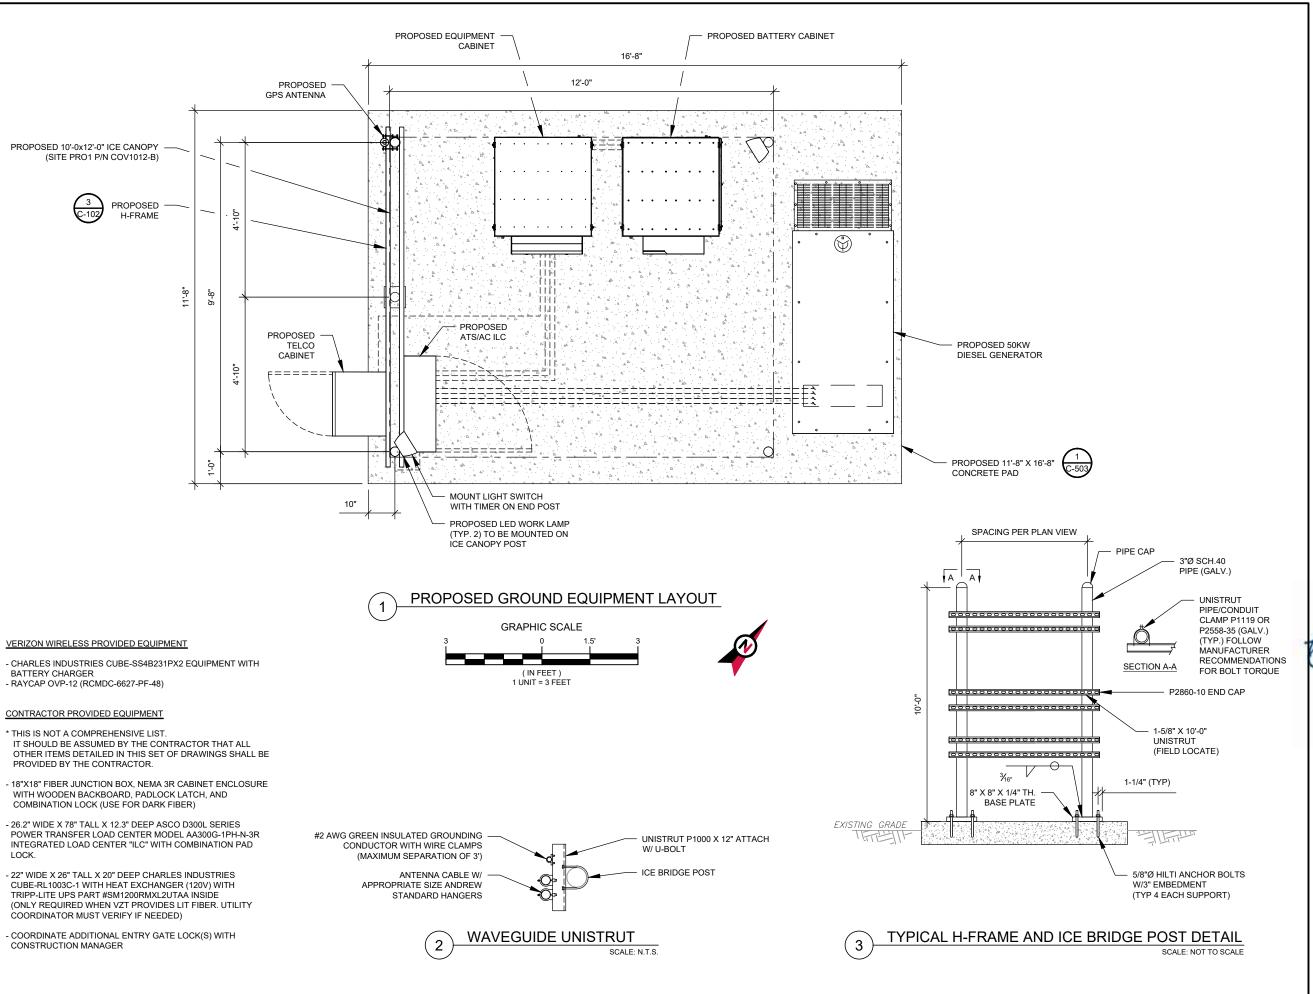





Dewberry Engineers Inc.

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SUITE 700
BOSTON, MA 02110
PHONE: 617.695.3400
FAX: 617.695.3310

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ATC SITE NAME:

SALEM CT

VERIZON SITE NAME:

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SITE ADDRESS: 153 EAST HADDAM ROAD SALEM, CT 06420-3903

SEAL





ATC JOB NO: 14430730_G2
CUSTOMER ID: SALEM SOUTH CT
CUSTOMER #: 765832

DETAILED EQUIPMENT PLAN

SHEET NUMBER:

C-102

ENGINEERING & DESIGN, DATED 11/07/23, THE PROPOSED MOUNT CAN ADEQUATELY SUPPORT THE PROPOSED LOADING.

PER MOUNT ANALYSIS COMPLETED BY COLLIERS





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ATC JOB NO:

14430730_G2 CUSTOMER ID: SALEM SOUTH CT


CUSTOMER #: 765832

TOWER ELEVATION


SHEET NUMBER:

REVISION:

C-201

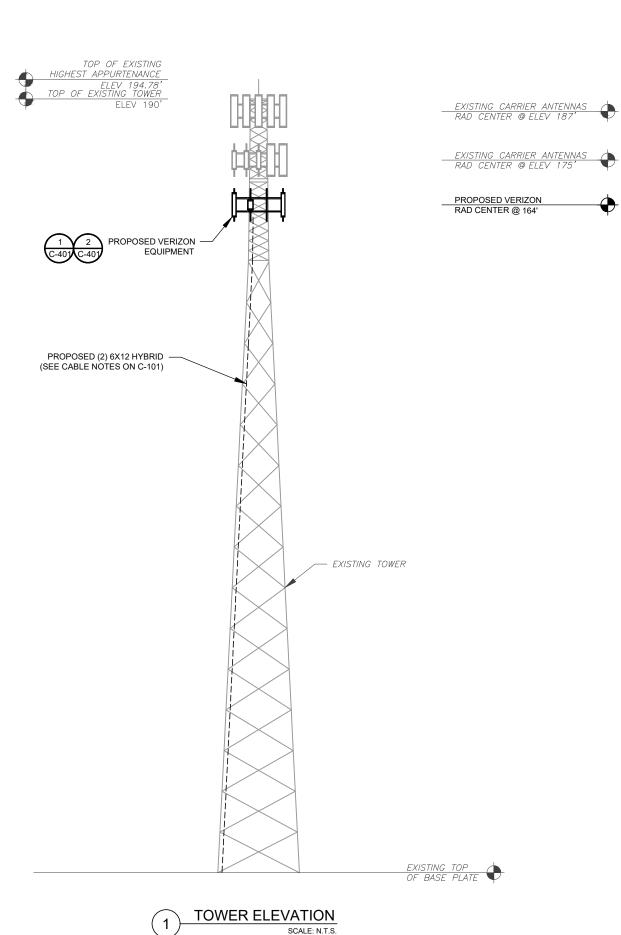

- IT IS THE CONTRACTOR'S RESPONSIBILITY TO CONFIRM WITH THE PROJECT MANAGER THAT THEY HAVE THE MOST RECENT VERSION OF THE STRUCTURAL ANALYSIS BEFORE COMMENCING WORK. EXISTING AND PROPOSED TOWER APPURTENANCES, MOUNTS, AND ANTENNAS ARE SHOWN BASED ON THE STRUCTURAL ANALYSIS.
- 2. WHERE APPLICABLE, ALL NEW ANTENNAS, EQUIPMENT, MOUNTS, CABLING, ETC. SHALL BE PAINTED/SOCKED TO MATCH EXISTING EQUIPMENT IN ACCORDANCE WITH FAA, JURISDICTION, AND/OR OTHER LOCAL REQUIREMENTS.
- 3. ROUTE PROPOSED CABLES ALONG SAME PATH AS EXISTING CABLES AND IN ACCORDANCE WITH STRUCTURAL ANALYSIS. WHERE POSSIBLE UTILIZE EXISTING CABLE SUPPORT STRUCTURES AS PROVIDED FOR CARRIER TO ADEQUATELY SECURE CABLES, USING EITHER APPROPRIATELY SIZED STAINLESS STEEL SNAP-INS OR MOUNTING HARDWARE AND BRACKETS AS SPECIFIED BY CABLE MANUFACTURER. OTHERWISE, ATTACH CABLES TO HORIZONTAL OR DIAGONAL TOWER MEMBERS USING PROPOSED STAINLESS STEEL ADAPTERS (DO NOT ATTACH TO TOWER LEG).
- TOWER ELEVATIONS ARE MEASURED FROM TOP OF BASE PLATE TO MATCH STRUCTURAL ANALYSIS. ELEVATIONS DO NOT REFLECT TRUE ABOVE GROUND LEVEL (A.G.L.)
- TOWER ELEVATION DEPICTION MAY NOT REFLECT ALL EQUIPMENT INCLUDED IN STRUCTURAL ANALYSIS. REFER TO STRUCTURAL ANALYSIS FOR FULL TOWER LOADING.

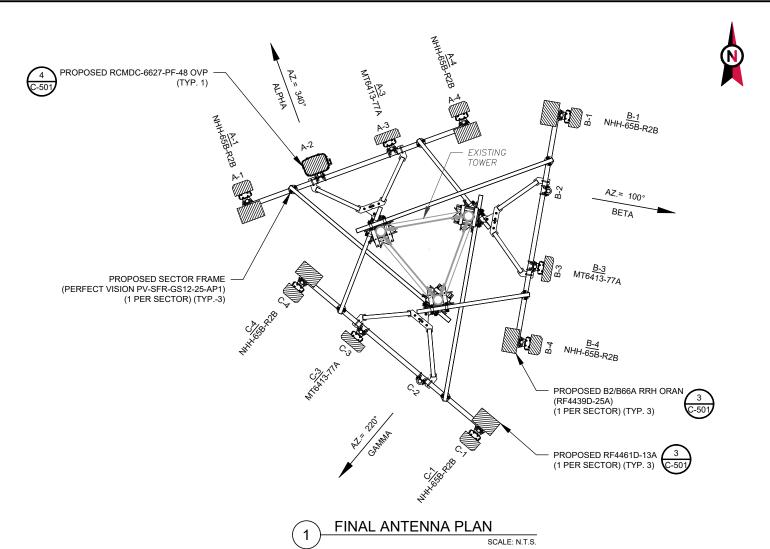

				FINAL EQU	PMENT SCHEDULE		
	LOCATION			ANT	ENNA SUMMARY	NON ANTENNA S	SUMMARY
SECTOR	RAD	AZ	POS	ANTENNA	BAND	ADDITIONAL TOWER MOUNTED EQUIPMENT	CABLE DESCRIPTION
			A1	NHH-65B-R2B	LTE 700, 5G 850, LTE 850, LTE 1900, LTE AWS	RF4461D-13A	
			A2	-	-	-	
ALPHA	ALPHA 164' 340°		A3	MT6413-77A	5G L-SUB6	-	
			A4	NHH-65B-R2B	LTE 700, 5G 850, LTE 850, LTE 1900, LTE AWS	B2/B66A RRH ORAN (RF4439D-25A)	
			B1	NHH-65B-R2B	LTE 700, 5G 850, LTE 850, LTE 1900, LTE AWS	RF4461D-13A	
			B2	-	-	-	
BETA	164'	100°	В3	MT6413-77A	5G L-SUB6	-	(2) 6X12 HYBR
			B4	NHH-65B-R2B	LTE 700, 5G 850, LTE 850, LTE 1900, LTE AWS	B2/B66A RRH ORAN (RF4439D-25A)	
			C1	NHH-65B-R2B	LTE 700, 5G 850, LTE 850, LTE 1900, LTE AWS	RF4461D-13A	
			C2	-	-	-]
GAMMA	164'	220°	C3	MT6413-77A	5G L-SUB6	-	1
			C4	NHH-65B-R2B	LTE 700, 5G 850, LTE 850, LTE 1900, LTE AWS	B2/B66A RRH ORAN (RF4439D-25A)	

- 1. CONFIRM WITH CARRIER REP FOR APPLICABLE UPDATES/REVISIONS AND MOST RECENT RFDS.
- 2. ALL PROPOSED EQUIPMENT INCLUDING ANTENNAS, COAX, ETC. SHALL BE MOUNTED IN ACCORDANCE WITH THE TOWER STRUCTURAL ANALYSIS ON FILE WITH THE ATC CM.
- 3. SPACING OF PROPOSED EQUIPMENT SHALL BE CONFIRMED FOR TOWER CONFLICTS AND PROPOSED MOUNTS SHALL NOT IMPEDE TOWER CLIMBING PEGS.
- 4. INSTALL (1) RCMDC-6627-PF-48 OVP.

PER MOUNT ANALYSIS COMPLETED BY COLLIERS ENGINEERING & DESIGN, DATED 11/07/23, THE PROPOSED MOUNT CAN ADEQUATELY SUPPORT THE PROPOSED LOADING.





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SALEM CT

VERIZON SITE NAME:

SALEM SOUTH CT

SITE ADDRESS: 153 EAST HADDAM ROAD SALEM, CT 06420-3903



ATC JOB NO:

CUSTOMER ID: SALEM SOUTH CT

CUSTOMER #: 765832

ANTENNA INFORMATION & SCHEDULE

SHEET NUMBER:

C-401


ANTENNA SCHEDULE


MONOPOLE = 15'±

GUYED / SELF SUPPORT = FACE WIDTH + 15'

RF JUMPER LENGTH


REFER TO FINAL RFDS FOR TYPE AND QUANTITY

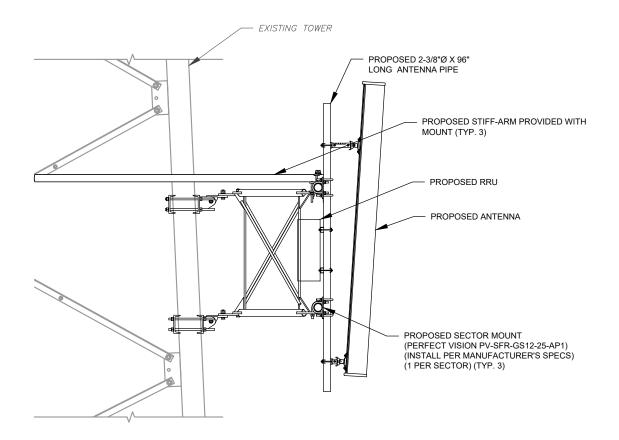

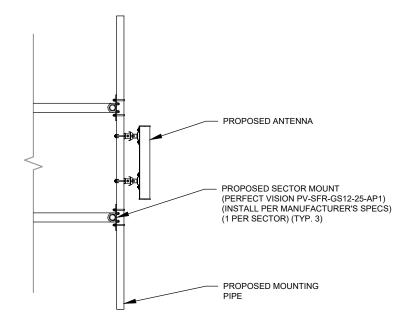


PROPOSED ANTENNA MOUNTING DETAIL (ELEVATION)

PROPOSED 5G ANTENNA MOUNTING DETAIL

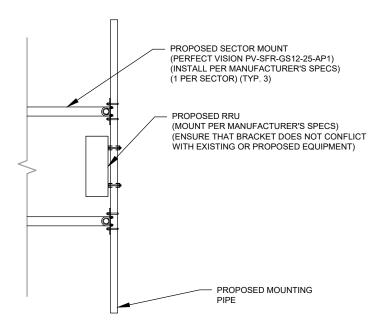

PROPOSED OVP (MOUNT PER MANUFACTURER'S SPECS) (ENSURE THAT BRACKET DOES NOT CONFLICT WITH EXISTING OR PROPOSED EQUIPMENT) PROPOSED MOUNTING PIPE ATTACHED TO BOTH HORIZONTAL MEMBERS ON PROPOSED STAND-OFF SUPPORT FOR 3-SIDE PROPOSED SECTOR FRAME ARRAY PROPOSED HORIZONTAL MEMBER ON PROPOSED STAND-OFF SUPPORT (TYP.) FOR 3-SIDED SECTOR FRAME ARRAY

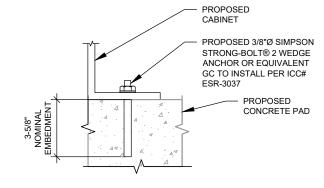

NOTE:

INSTALL SIMPSON STRONG-TIE® STRONG-BOLT® 2 WEDGE ANCHOR(S) STRICTLY PER INSTALLATION INSTRUCTIONS INCLUDED WITH PRODUCT OR FOUND ONLINE AT WWW.STRONGTIE.COM. PROPER INSTALLATION IS CRITICAL FOR FULL PERFORMANCE.

PROPOSED OVP MOUNTING

CABINET ATTACHMENT DETAIL

SCALE: N.T.S.





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ATC JOB NO: CUSTOMER ID: SALEM SOUTH CT CUSTOMER #: 765832

MOUNT DETAILS

SHEET NUMBER:


C-501


REVISION:

PROPOSED RRU MOUNTING DETAIL - TYPICAL

CONSTRUCTION NOTE:

INSTALL ICE BRIDGE TO ALLOW 7 FEET CLEARANCE ABOVE GRADE TO LOWEST APPURTENANCE.

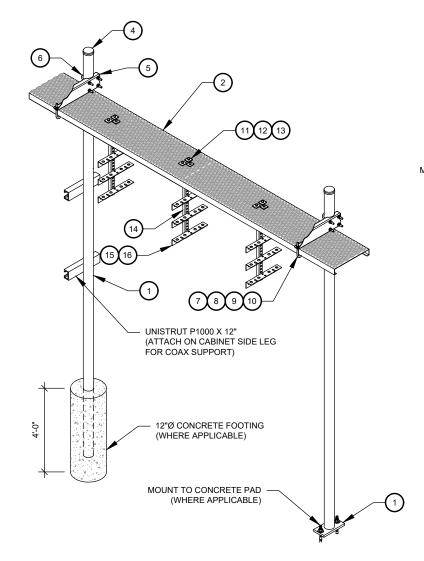


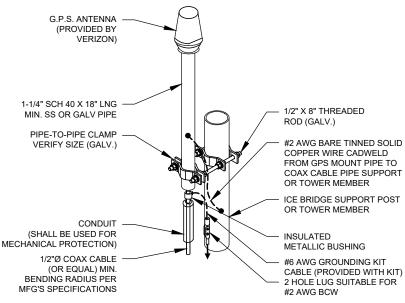

- 1. GPS SHALL BE PLACED WITH CLEAR SIGHT LINE TO THE SOUTHERN SKY.
- 2. CONTRACTOR TO SUPPLY COAX FOR GPS UNIT.

GPS ANTENNA ATTACHMENT DETAIL 2

SCALE: N.T.S.

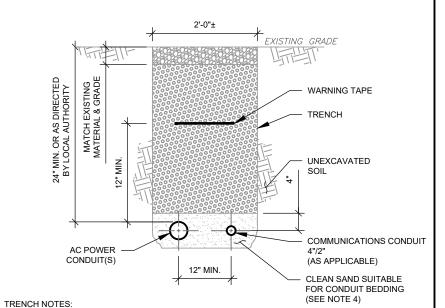

- IF FREE OF ORGANIC OR OTHER DELETERIOUS MATERIAL, EXCAVATED MATERIAL MAY BE USED FOR BACKFILL. IF NOT, PROVIDE CLEAN, COMPACTIBLE MATERIAL.
- COMPACT IN 8" LIFTS. REMOVE ANY LARGE ROCKS PRIOR TO BACKFILLING. CONTRACTOR TO VERIFY LOCATION OF EXISTING U/G UTILITIES PRIOR TO DIGGING.
- IF CURRENT AS-BUILT DRAWINGS ARE NOT AVAILABLE CONTRACTOR SHALL HAND DIG U/G TRENCHING.
- USE COMMUNICATIONS ONLY TRENCH FOR COMMUNICATIONS CONDUIT UNLESS TRAVELING UNDER PATH OF VEHICLE TRAVEL, THEN CONDUIT MUST BE 24" MIN. BELOW
- CONFIRM SPACING AND DEPTH WITH NEC OR LOCAL CODE REQUIREMENTS









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SITE ADDRESS: 153 EAST HADDAM ROAD SALEM. CT 06420-3903






14430730_G2 ATC JOB NO: CUSTOMER ID: SALEM SOUTH CT CUSTOMER #: 765832

> CONSTRUCTION **DETAILS**


SHEET NUMBER

C-502

REVISION

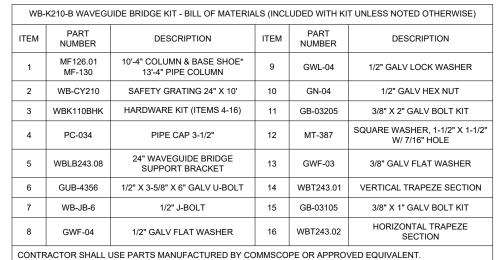

*BASE SHOE NOT INCLUDED IN WB-K210-B KIT, ORDER COLUMN SEPARATELY OR KIT WB-K210-S.

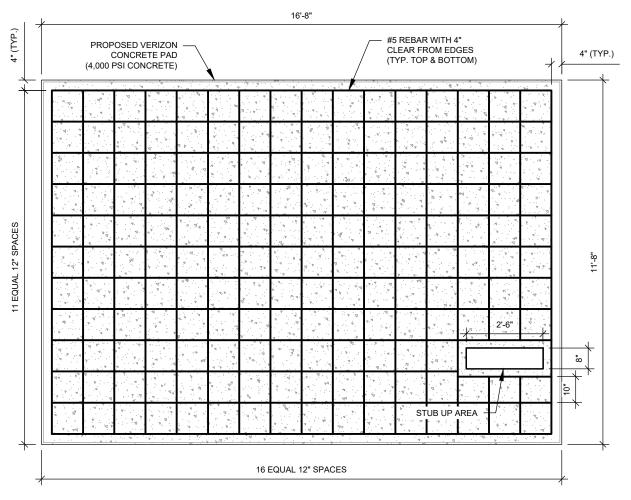


CONCRETE PAD #5 REBAR (SPACING PER PLAN) (TYP. TOP & BOTTOM) (4,000 PSI CONCRETE) COMPACTED #57 GRAVEL FILL VOIDS WITH #52 GRAVEL AFTER CONDUIT INSTALLATION COMPACTED #57 GRAVEL

THIS DESIGN ASSUMES A 1500 PSF SOIL BEARING PRESSURE

GENERATOR CONDUIT STUB UP DETAIL

PAD NOTES:


- PADS SHALL BE PRE-CAST MATCHING THIS DESIGN WHERE ALLOWED BY LOCAL JURISDICTION. REFER TO CONCRETE & REINFORCED STEEL NOTES ON SHEET G-002 & ATC SPEC 033000 FOR CAST-IN-PLACE PADS.
- CONCRETE EQUIPMENT PAD DESIGN SCALE: N.T.S.

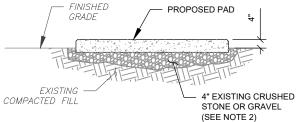


PAD NOTES:

- 1. SUBGRADE AND FILL SHALL CONSIST OF CLEAN SOIL. DELETRIOUS MATERIAL AND ORGANICS SHALL BE REMOVED.
- 2. MECHANICALLY COMPACT FOOTPRINT OF PAD PLUS 2' PERIMETER.
- 3. USE GALVANIZED HILTI EXPANSION ANCHORS OR, APPROVED EQUAL, FOR EQUIPMENT ANCHORAGE.
- 4. FOR SIZE AND LOCATION OF ANCHORS AND OTHER REQUIREMENT, SEE EQUIPMENT VENDOR DRAWINGS.



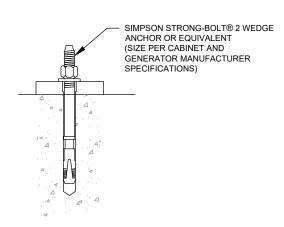

EXPANSION ANCHOR DETAIL

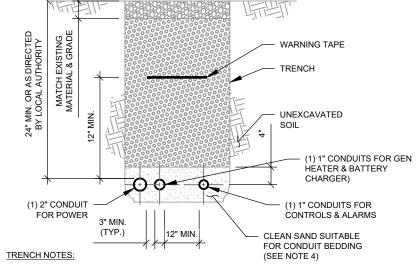

IF FREE OF ORGANIC OR OTHER DELETERIOUS MATERIAL, EXCAVATED MATERIAL MAY BE USED FOR BACKFILL. IF NOT, PROVIDE CLEAN, COMPACTIBLE MATERIAL.

- COMPACT IN 8" LIFTS. REMOVE ANY LARGE ROCKS PRIOR TO BACKFILLING. CONTRACTOR TO VERIFY LOCATION OF EXISTING U/G UTILITIES PRIOR TO DIGGING.
- IF CURRENT AS-BUILT DRAWINGS ARE NOT AVAILABLE CONTRACTOR SHALL HAND DIG U/G TRENCHING.
- USE COMMUNICATIONS ONLY TRENCH FOR COMMUNICATIONS CONDUIT UNLESS TRAVELING UNDER PATH OF VEHICLE TRAVEL, THEN CONDUIT MUST BE 24" MIN.
- CONFIRM SPACING AND DEPTH WITH NEC OR LOCAL CODE REQUIREMENTS

GENERATOR CONDUIT TRENCH DETAILS





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14430730_G2 ATC JOB NO: CUSTOMER ID: SALEM SOUTH CT CUSTOMER #: 765832


> CONSTRUCTION **DETAILS**

C-503




NOTES:

- . INTERCONNECTING CONDUITS SHALL BE INSTALLED AT OR ABOVE GRADE.
- 2. BOTTOM OF OVP'S SHALL NOT EXCEED 36" ABOVE FINISHED GRADE.

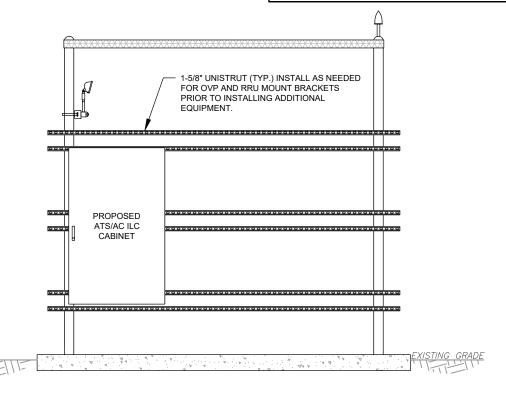

FRONT VIEW

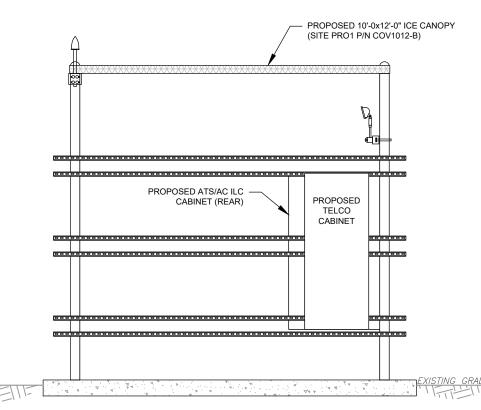

REAR VIEW

DETAILED H-FRAME LAYOUT





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14430730_G2


CUSTOMER #: 765832


CONSTRUCTION **DETAILS**

SHEET NUMBER:


C-504

REVISION:

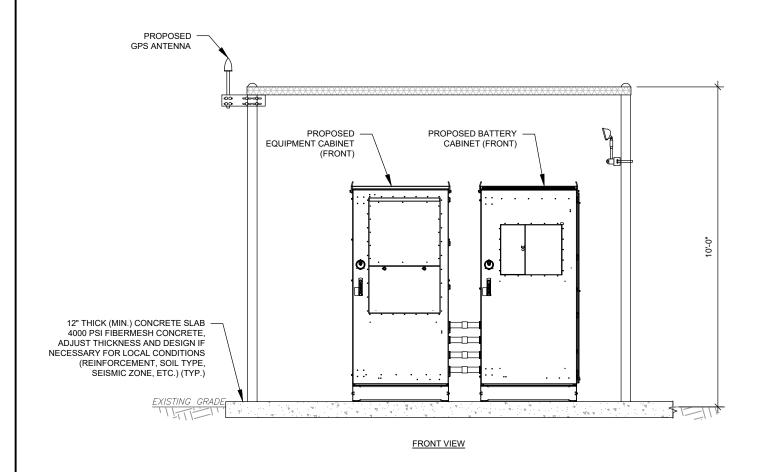

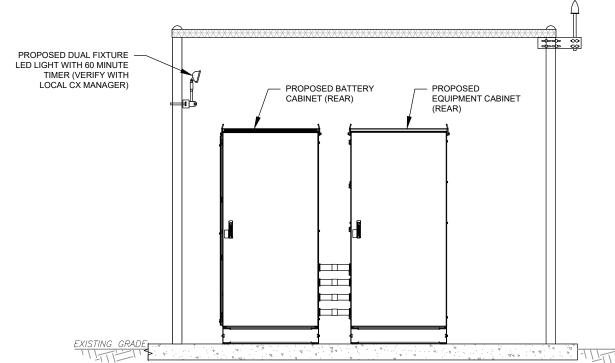

REAR VIEW DETAILED CABINET LAYOUT SCALE: NOT TO SCALE

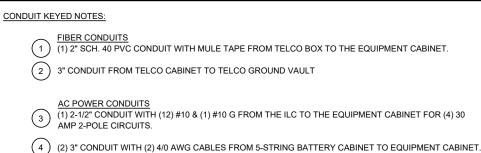

(1) 1" CONDUIT WITH (2) #12 & (1) #12 G FROM ILC TO GFI RECEPTACLE/LIGHT. LIGHT SWITCH. CONTINUE 1" TO 2ND LIGHT.

(1) 2" CONDUIT WITH PULLSTRING FOR FUTURE RECTIFIER CIRCUITS FROM EQUIPMENT CABINET TO ILC.

 $\left(7\right)$ (1) 2" CONDUIT WITH (3) #1/0 & (1) #6 G FROM THE ILC TO THE GENERATOR.

(1) 1" CONDUIT WITH (4) #12 & (1) #12 G FROM ILC TO GENERATOR. (GEN HEATER & BATTERY

ALARM/MISCELLANEOUS CONDUITS


(9) (1) 1" CONDUIT FROM ILC TO EQUIPMENT CABINET FOR ILC ALARMS.


(10) (2) 1" CONDUIT FROM ILC TO GENERATOR [(1) FOR GEN CONTROLS, (1) FOR ALARMS].

(11) (1) 1" CONDUIT FROM BATTERY CABINET TO EQUIPMENT CABINET FOR ALARMS.

NOTE:

BELOW GRADE CONDUIT SHALL BE SCHEDULE 80 PVC. ABOVE GRADE CONDUIT SHALL BE GALVANIZED RIGID CONDUIT. BELOW GRADE PVC CONDUIT SHALL TRANSITION TO GRC PRIOR TO RISING ABOVE GRADE. ALL BENDS SHALL HAVE MINIMUM 24" RADIUS. ALL FITTINGS SHALL BE SUITABLE FOR USE WITH THREADED RIGID CONDUIT. VERIFY CONDUIT TYPE WITH LOCAL CONSTRUCTION MANAGER AND ADJUST AS NECESSARY, ALL CONDUIT SHALL MEET NEC. STATE, AND LOCAL CODE REQUIREMENTS AS REQUIRED.

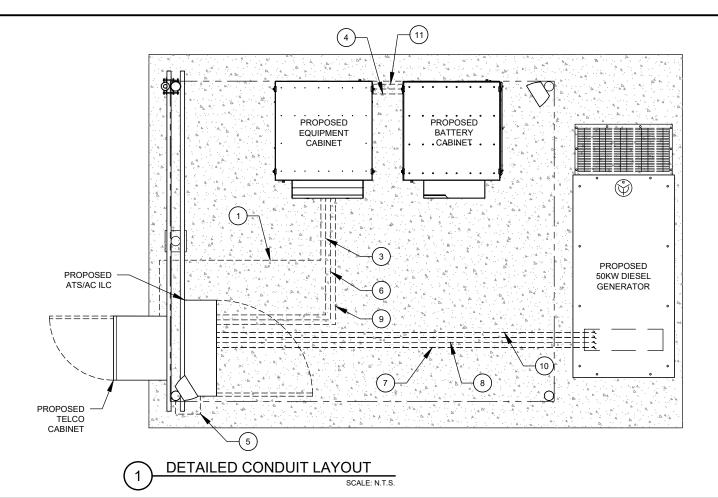

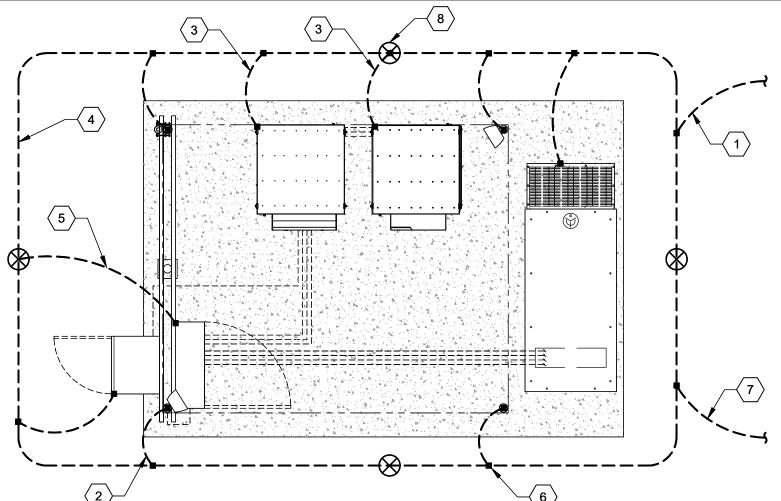

GROUNDING KEYED NOTES:

BOND TO TOWER GROUND RING

#2 AWG BOND FROM VERTICAL H-FRAME AND ICE BRIDGE POST TO EXTERNAL GROUND RING (TYP. EVERY POST).

 \langle 3 angle EQUIPMENT BOND TO GROUND RING (TYP.).

4 > #2 GROUND RING

5 GROUNDING ELECTRODE CONDUCTOR PER NEC

6 GROUNDING ELECTRODE (TYP.)

BOND TO COMPOUND GROUND RING

GROUNDING ELECTRODE WITH TEST WELL



BOSTON, MA 02110

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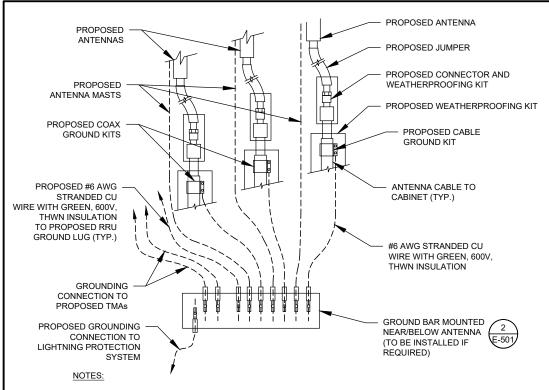
ATC JOB NO: CUSTOMER ID: SALEM SOUTH CT CUSTOMER #: 765832

GROUNDING PLAN & NOTES

E-101


REVISION:

DETAILED GROUNDING LAYOUT



- THIS DETAIL IS INTENDED TO SHOW THE GENERAL GROUNDING REQUIREMENTS. SLIGHT ADJUSTMENTS MAY BE REQUIRED BASED ON EXISTING SITE CONDITIONS. THE CONTRACTOR SHALL MAKE FIELD ADJUSTMENTS AS NEEDED AND INFORM THE CONSTRUCTION MANAGER OF ANY CONFLICTS.
- SITE GROUNDING SHALL COMPLY WITH VERIZON GROUNDING STANDARDS, LATEST EDITION, AND COMPLY WITH VERIZON GROUNDING CHECKLIST, LATEST VERSION. WHEN NATIONAL AND LOCAL GROUNDING CODES ARE MORE STRINGENT THEY SHALL GOVERN.




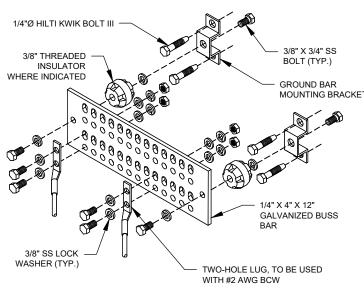

GROUND BAR NOTES

- GROUND KITS COME WITH ALL HARDWARE, NUTS, BOLTS, WASHERS, ETC. EXCEPT THE STRUCTURAL MOUNTING
- 2. GROUND BAR SHALL BE BOLTED TO STRUCTURAL MEMBER OR ANCHORED TO CONCRETE SLAB W/ HILTI KWIK BOLT III.



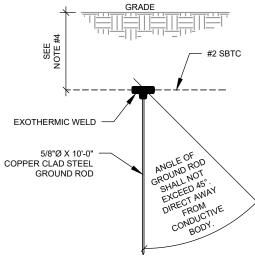

NOTES:

- SEPARATION DIMENSION TO BE VERIFIED WITH LOCAL UTILITY COMPANY REQUIREMENTS.
- 2. COORDINATE UTILITY, LOCATE BEFORE DIGGING.
- CONDUIT TRENCHING DEPTHS AT 36" OR 6" BELOW FROST LINE, WHICHEVER IS GREATER.
- ALL RING AND RADIAL DEPTHS AT 30" OR 6" BELOW FROST LINE, WHICHEVER IS GREATER.



TIE CONNECTION DETAIL

GENERATOR INSTALLATION NOTE:

GENERATOR GROUNDING

3/8" X 1-1/4" SS BOLT 3/8" SS LOCK WASHER (EACH SIDE) (EACH SIDE) 1/4" X 4" X 6" GROUND BAR (ERICO P/N: EGBA14406CC OR EQUAL) TWO-HOLE LUG, TO BE USED WITH #2 AWG BCW (LOWER TOWER GROUND


GROUND BAR NOTES:

GROUND BAR KITS COME WITH ALL HARDWARE, NUTS, BOLTS, WASHERS, ETC. EXCEPT THE STRUCTURAL MOUNTING MEMBER(S).

BAR ONLY)

2. GROUND BAR TO BE BONDED DIRECTLY TO TOWER.

TOWER GROUND BAR DETAIL

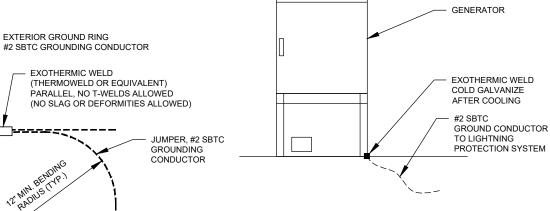

INSTALL GENERATOR AND TRANSFER SWITCH WITH ALL SUPPLIED ACCESSORIES PER MANUFACTURER'S INSTALLATION INSTRUCTIONS AND SPECIFICATIONS. THIS INCLUDES, BUT IS NOT LIMITED TO, ACCESSORIES FOR THE EXHAUST SYSTEM, FUEL SYSTEM, ENCLOSURE INTEGRITY (CAPS, PLUGS, COVERS, ETC.), ELECTRICAL CONNECTIONS, AND GROUNDING CONNECTIONS





Dewberry Engineers Inc. 99 SUMMER STREET SUITE 700 BOSTON, MA 02110 PHONE: 617.695.3400 FAX: 617.695.3310

REV.	DESCRIPTION	BY	DATE
<u> </u>	PRELIM	VL_	05/10/23
<u> </u>	FINAL	VL_	12/14/23
<u> 1</u>	FINAL	VL	01/22/24
\triangle			

ATC SITE NUMBER: 10027 ATC SITE NAME:

SALEM CT

VERIZON SITE NAME:

SALEM SOUTH CT

SITE ADDRESS: 153 EAST HADDAM ROAD SALEM, CT 06420-3903





ATC JOB NO: CUSTOMER ID: SALEM SOUTH CT CUSTOMER #: 765832


GROUNDING DETAILS

SHEET NUMBER:

E-501

PA NEL		TYPE	LIGHTING & A PPLIA NCE	SYSTEM:	120/240V, 3W, 30 CKT	LOCATION:	VZW LEASE AREA
DESIGNATION:	VZW	MOUNTING:	SURFACE	MAIN BREAKER (MB):	MLO		
_		ENCLOSURE -	N⊟MA 3R	MAIN BUS RATING:	200A	PANEL NOTES:	ASCO D300L SERIES
		_		MIN. A.I.C. RATING:	65K	_	

CONN	ECTED		FEE	DER OR BRANC	CH CIRCI	JIT			FEEDE	R OR BRANCH	CIRCUIT		CONN	ECTED
LOAD	(kVA)	BRIEF DESCRIPTION	В	BREAKER	POLE	C IR C .		BREAKER BREAKER		AKER	BRIEF DESCRIPTION	LOAD	(kVA)	
Α	В		AMPS	POLES	NO.	VO.		NOTES	NO.	POLES	AMPS		Α	В
2.88		RECTIFIER	30	2	1				2			SPACE	0.00	
	2.88		30	_	3				4			SPACE		0.00
2.88		RECTIFIER	30	2	5				6			SPACE	0.00	
	2.88	KECHEEN	30	_	7				8			SPACE		0.00
2.88		RECTIFIER	30	2	9				10			SPACE	0.00	
	2.88	KECHILIX	30	2	11				12			SPACE		0.00
2.88		RECTIFIER	30	2	13				14			SPACE	0.00	
	2.88	KECHFIEK	30	_	15				16			SPACE		0.00
0.68		GFI RECEPT / LIGHT	20	1	17				18			SPACE	0.00	
	1.92	GEN BLOCK HEATER	20	1	19				20			SPACE		0.00
1.92		BATTERY CHARGER	20	1	21				22			SPACE	0.00	
	0.00	SPACE			23				24			SPACE		0.00
0.00		SPACE			25				26			SPACE	0.00	
	0.00	SPACE			27				28			SPACE		0.00
0.00		SPACE			29				30			SPACE	0.00	
14.1	13.4				•	Α	В	TOTAL				0.0	0.0	
						14.1	13.4	27.6 CONNECTED LOAD (kVA)			OAD (kVA)		<u></u>	

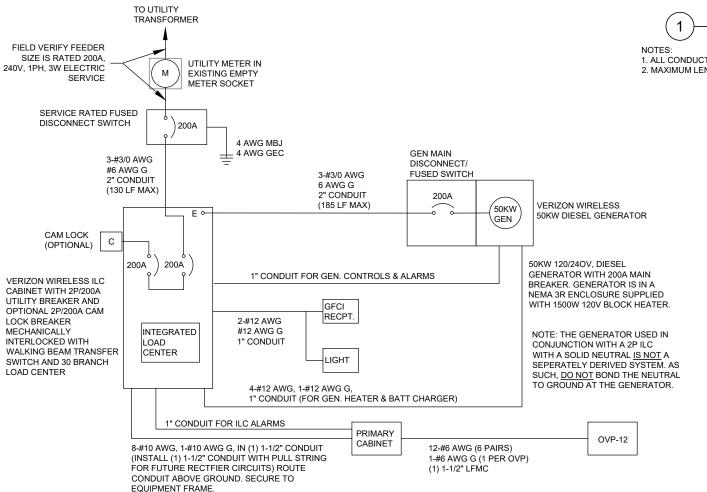

PANEL SCHEDULE

27.6

1. ALL CONDUCTORS ARE TYPE THWN (75°C) COPPER.

14.1 13.4

2. MAXIMUM LENGTH OF RUN FOR RECTIFIER CIRCUITS IS 50 FT.

ELECTRICAL SINGLE LINE DIAGRAM

DEMAND LOAD (KVA)

- NOTES: 1. ALL EQUIPMENT SHALL BE NEMA 3R RATED.
- 2. ALL EQUIPMENT SHALL BE GROUNDED IN ACCORDANCE WITH TIA-222-G AND VERIZON WIRELESS STANDARDS.
- 3. CONDUCTOR SIZES AND DISTANCES HAVE BEEN SIZED FOR 3% MAX VOLTAGE DROP. (TOTAL SYSTEM VOLTAGE DROP ON BOTH FEEDERS AND BRANCH CIRCUITS TO THE FARTHEST DEMAND SHALL NOT EXCEED 5%) 4. WIRE SIZING AND MAXIMUM DISTANCE FROM GENERATOR TO ILC ASSUMES POWER FACTOR OF 0.9.
- 5. BELOW GRADE PVC CONDUIT SHALL TRANSITION TO RMC PRIOR TO RISING ABOVE GRADE, ALL BENDS SHALL HAVE A MINIMUM 24" RADIUS, ALL FITTINGS SHALL BE SUITABLE FOR USE WITH THREADED RIGID CONDUIT, VERIFY CONDUIT TYPE WITH LOCAL CONSTRUCTION MANAGER AND ADJUST IF NECESSARY. ALL CONDUIT SHALL MEET NEC, STATE, AND LOCAL CODE REQUIREMENTS AS REQUIRED.





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REV.	DESCRIPTION	BY	DATE
A.	PRELIM	VL	05/10/23
<u></u>	FINAL	VL	12/14/23
1	FINAL	VL	01/22/24
$\overline{\triangle}$			
$\overline{\wedge}$			

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147 AMPS

DERATING FACTOR (80%)

DEMANDLOAD SIZING:





CUSTOMER ID: SALEM SOUTH CT

CUSTOMER #: 765832

ONE-LINE & PANEL SCHEDULE

SHEET NUMBER:

E-601

Antenna Summary											
Added Antenna 700 850 1900 AWS L-Sub6 Make Model Centerl Tip Azimuth Install Quantity											
				5G	Samsung	MT6413-77A	ine 164	Height 165.2	340(1),100(2),2	Type PHYSICAL	3
					,				20(3)		
LTE	5G,LTE	LTE	LTE		COMMSCOPE	NHH-65B-R2B	164	167	340(1),100(2),2 20(3)	PHYSICAL	6

Removed	Antenna								
700	850	1900	AWS	L-Sub6	Make	Model	Tip Height	Install Type	Quantity

Retained	Retained Antenna										
700	850	1900	AWS	L-Sub6	Make			Tip Height	Azimuth	Install	Quantity
							ine	neight		Туре	

Added: 9

	Non Antenna Summary										
Added Non Antenna											
Equipment Type	Location	700	850	1900	AWS	L-Sub6	Make	Model	Install Type	Quantity	
OVP	Tower							12 OVP	PHYSICAL	1	
Hybrid Cable	Tower						N/A	6x12 Hybrid Cable	PHYSICAL	2	
RRU	Tower			LTE	LTE		Samsung	B2/B66A RRH ORAN (RF4439d-25A)	PHYSICAL	3	
RRU	Tower					5G	Samsung	MT6413-77A	PHYSICAL	0	
RRU	Tower	LTE	5G,LTE				Samsung	RF4461d-13A	PHYSICAL	3	

Removed Non Antenna										
Equipment Type	Location	700	850	1900	AWS	L-Sub6	Make	Model	Install Type	Quantity

Retained Non Antenna										
Equipment Type	Location	700	850	1900	AWS	L-Sub6	Make		Install Type	Quantity

Added: 9	Demoused: 0	Deteined: 0	
I Added: A	l Removed: 0	I Retained: 0	







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CUSTOMER ID: SALEM SOUTH CT


ATC JOB NO: 14430730_G2

CUSTOMER #: 765832


SUPPLEMENTAL

SHEET NUMBER:

R-601

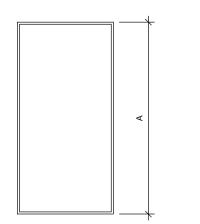


FRONT VIEW

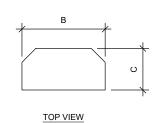






ANTENNA SPECIFICATIONS							
ANTENNA MODEL	А	В	С	WEIGHT (LBS)			
NHH-65B-R2B	72.0"	11.9"	7.1"	43.7			
MT6413-77A	29.5"	15.8"	5.5"	55.1			

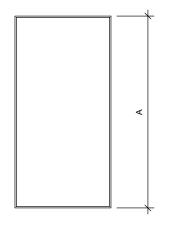

FRONT VIEW

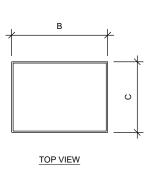

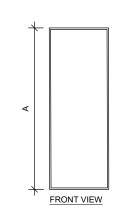

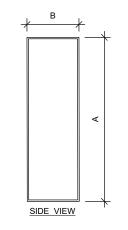

PLAN VIEW

RRU SPECIFICATIONS

FOR ILLUSTRATIVE PURPOSES ONLY - NOT TO SCALE

RRU SPECIFICATIONS						
RRU MODEL	A	В	С	WEIGHT (LBS)		
B2/B66A RRH ORAN (RF4439D-25A)	15.0"	15.0"	10.0"	74.7		
RF4461D-13A	15.0"	15.0"	10.2"	79.1		

OVP SPECIFICATIONS

FOR ILLUSTRATIVE PURPOSES ONLY - NOT TO SCALE

OVP SPECIFICATIONS							
OVP MODEL	А	В	С	WEIGHT (LBS)			
RCMDC-6627-PF-48	29.5"	16.5"	12.6"	32.0			





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ATC JOB NO: 14430730_G2 CUSTOMER ID: SALEM SOUTH CT

CUSTOMER #: 765832

SUPPLEMENTAL

SHEET NUMBER:

R-602