

COMPLIANCE CODE



AMERICAN TOWER®

ATC SITE NAME: MIDDLETOWN CT 3

AT&T PACE NUMBERS: MRCTB050837, MRCTB052325

AT&T SITE ID: CTL05121 AT&T FA CODE:10070983

PROJECT SUMMARY

ATC SITE NUMBER: 302537

AT&T SITE NAME: CROMWELL EAST SITE ADDRESS: 47 INWOOD ROAD

ROCKY HILL, CT 06067

PROJECT DESCRIPTION



LOCATION MAP

SHEET INDEX

AT&T 5G NR RADIO || 5G NR 1SR CBAND AMENDMENT PLAN

ALL WORK SHALL BE PERFORMED AND MATERIALS INSTALLED IN ACCORDANCE WITH THE CURRENT EDITIONS OF THE FOLLOWING CODES AS ADOPTED BY THE LOCAL	SITE ADDRESS: 47 INWOOD ROAD		THE PROPOSED PROJECT INCLUDES MODIFYING GROUND BASED AND TOWER MOUNTED EQUIPMENT AS INDICATED PER BELOW:	SHEET NO:	DESCRIPTION:	REV:	DATE:	BY:	
GOVERNMENT AUTHORITIES. NOTHING IN THESE PLANS IS TO BE CONSTRUED TO PERMIT WORK NOT CONFORMING TO			TOWER WORK: REMOVE (9) ANTENNA(S), (6) 1-5/8" COAX, (1) DC6 SQUID (6) DC AND		TITLE SHEET	0	04/29/22	BR]
THESE CODES.			(3) FIBER TRUNKS	G-002	GENERAL NOTES	0	04/29/22	BR	Ш
2018 CONNECTICUT STATE BUILDING CODE-AMENDMENTS TO IBC 2015	GEOGRAPHIC C	COORDINATES:	INSTALL (9) ANTENNA(S) (1) SQUID(S), (3) Y-CABLE(S), (8) DC TRUNK(S) AND (2) FIBER TRUNK(S)	C-101	DETAILED SITE PLAN	0	04/29/22	BR	
INTERNATIONAL BUILDING CODE 2015, INTERNATIONAL CODE COUNCIL	LATITUDE: 4' LONGITUDE: -'		EXISTING (3) ANTENNA(S), (15) RRH(S), (1) SQUID(S) AND (3) FIBER TRUNK(S) TO REMAIN	C-201	TOWER ELEVATION	0	04/29/22	BR	1
3. TIA-222-G-4, STRUCTURAL STANDARD FOR ANTENNA	GROUND ELEVAT		GROUND WORK:	C-401	RF SCHEDULE AND ANTENNA INSTALLATION	0	04/29/22	BR	
SUPPORTING STRUCTURES AND ANTENNAS 4. ASCE 7-10 MINIMUM DESIGN LOADS FOR BUILDINGS AND			REMOVE (1) UMTS BBU	C-501	CONSTRUCTION DETAILS	0	04/29/22	BR	
OTHER STRUCTURES, AMERICAN SOCIETY OF CIVIL			INSTALL (1) 6648 WITH XCEDE CABLE(S)	E-501	GROUNDING DETAILS	0	04/29/22	BR]
ENGINEERS 5. STEEL CONSTRUCTION MANUAL 14TH EDITION, AMERICAN			EXISTING (1) 6601, (1) 5216, 5216/XMU/ 6630 IDLe(S) AND (1) XMU03 TO REMAIN	R-601	SUPPLEMENTAL				
INSTITUTE OF STEEL CONSTRUCTION				R-602 SUPPLEMENTAL					11
6. CITY/COUNTY ORDINANCES	PROJEC	T TEAM	PROJECT NOTES	R-603 SUPPLEMENTAL					11
	TOWER OWNER:	APPLICANT:	THE FACILITY IS UNMANNED. A TECHNICIAN WILL VISIT THE SITE APPROXIMATELY ONCE A	R-604	SUPPLEMENTAL				
	AMERICAN TOWER AT&T MOBILITY	MONTH FOR ROUTINE INSPECTION AND MAINTENANCE. 3. THE PROJECT WILL NOT RESULT IN ANY SIGNIFICANT LAND DISTURBANCE OR EFFECT OF STORM WATER DRAINAGE.						Π	
	10 PRESIDENTIAL WAY 550 COCHITUATE ROAD WOBURN. MA 01801 SUITES 13 & 14							11	
UTILITY COMPANIES	, , , , , , , , , , , , , , , , , , , ,	FRAMINGHAM, MA 01701	4. NO SANITARY SEWER, POTABLE WATER OR TRASH DISPOSAL IS REQUIRED. 5. HANDICAP ACCESS IS NOT REQUIRED.						11
POWER COMPANY: N/A PHONE: N/A	ENGINEER: DEWBERRY ENGINEERS INC.		THE PROJECT DEPICTED IN THESE PLANS QUALIFIES AS AN ELIGIBLE FACILITIES REQUEST ENTITLED TO EXPEDITED]
TELEPHONE COMPANY: N/A	99 SUMMER STREET		REVIEW UNDER 47 U.S.C. § 1455(A) AS A MODIFICATION OF AN EXISTING WIRELESS TOWER THAT INVOLVES THE						ΗÌ
PHONE: N/A	SUITE 700 BOSTON, MA 02110		COLLOCATION, REMOVAL, AND/OR REPLACEMENT OF						11
000	PHONE: 617.695.3400		TRANSMISSION EQUIPMENT THAT IS NOT A SUBSTANTIAL CHANGE UNDER CFR § 1.61000 (B)(7).						11
911	FAX: 617.695.3310		PROJECT LOCATION DIRECTIONS						11
	PROPERTY OWNER:								11
	MERRIFIELD LLC 47 INWOOD ROAD		FROM HARTFORD CT - I 91 SOUTH TO EXIT 23 - TAKE RIGHT AT OFF						11
Know what's below.	ROCKY HILL,CT 06067-3453		RAMP AND THEN A LEFT AT THE LIGHTS ONTO RT 3 SOUTH . FOLLOW TO INWOOD ST ON RIGHT AND FOLLOW TO TOWER.						11
Call before you dig.								+	11





Dewberry Engineers Inc. SUITE 700 BOSTON, MA 02110 PHONE: 617.695.3400 FAX: 617.695.3310

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AT&T SITE NAME:

CROMWELL EAST SITE ADDRESS: 47 INWOOD ROAD

ROCKY HILL, CT 06067





	DATE DRAWN:	02/23/22
_	ATC JOB NO:	13747862_D1
	CUSTOMER ID:	CTL05121
	CUSTOMER #:	10070983

TITLE SHEET

G-001

REVISION:

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GENERAL CONSTRUCTION NOTES:

- OWNER FURNISHED MATERIALS, AT&T "THE COMPANY" WILL PROVIDE AND THE CONTRACTOR WILL INSTALL
 - A. BTS EQUIPMENT FRAME (PLATFORM) AND ICEBRIDGE SHELTER (GROUND BUILD/CO-LOCATE ONLY)
 - AC/TELCO INTERFACE BOX (PPC)
 - ICE BRIDGE (CABLE TRAY WITH COVER) (GROUND BUILD/CO-LOCATE ONLY, GC TO FURNISH AND INSTALL FOR ROOFTOP INSTALLATION)
 - D. TOWERS, MONOPOLES
 - TOWER LIGHTING
 - GENERATORS & LIQUID PROPANE TANK
 - ANTENNA STANDARD BRACKETS, FRAMES AND PIPES FOR MOUNTING
 - ANTENNAS (INSTALLED BY OTHERS)
 - TRANSMISSION LINE
 - TRANSMISSION LINE JUMPERS
 - TRANSMISSION LINE CONNECTORS WITH WEATHERPROOFING KITS
 - TRANSMISSION LINE GROUND KITS
 - HANGERS
 - HOISTING GRIPS
 - O. BTS EQUIPMENT
- THE CONTRACTOR IS RESPONSIBLE TO PROVIDE ALL OTHER MATERIALS FOR THE COMPLETE INSTALLATION OF THE SITE INCLUDING, BUT NOT LIMITED TO, SUCH MATERIALS AS FENCING, STRUCTURAL STEEL SUPPORTING SUB-FRAME FOR PLATFORM, ROOFING LABOR AND MATERIALS GROUNDING RINGS GROUNDING WIRES COPPER-CLAD OR XIT CHEMICAL GROUND ROD(S), BUSS BARS, TRANSFORMERS AND DISCONNECT SWITCHES WHERE APPLICABLE, TEMPORARY ELECTRICAL POWER CONDUIT, LANDSCAPING COMPOUND STONE, CRANES, CORE DRILLING, SLEEPERS AND RUBBER MATTING, REBAR, CONCRETE CAISSONS, PADS AND/OR AUGER MOUNTS, MISCELLANEOUS FASTENERS, CABLE TRAYS, NON-STANDARD ANTENNA FRAMES AND ALL OTHER MATERIAL AND LABOR REQUIRED TO COMPLETE THE JOB ACCORDING TO THE DRAWINGS AND SPECIFICATIONS. IT IS THE POSITION OF AT&T TO APPLY FOR PERMITTING AND CONTRACTOR RESPONSIBLE FOR PICKUP AND PAYMENT OF REQUIRED
- ALL WORK SHALL CONFORM TO ALL CURRENT APPLICABLE FEDERAL, STATE, AND LOCAL CODES, INCLUDING ANSI/EIA/TIA-222, AND COMPLY WITH ATC CONSTRUCTION
- CONTRACTOR SHALL CONTACT LOCAL 811 FOR IDENTIFICATION OF UNDERGROUND
- CONTRACTOR SHALL BE RESPONSIBLE FOR COORDINATING ALL REQUIRED
- ALL DIMENSIONS TO, OF, AND ON EXISTING BUILDINGS, DRAINAGE STRUCTURES, AND SITE IMPROVEMENTS SHALL BE VERIFIED IN FIELD BY CONTRACTOR WITH ALL DISCREPANCIES REPORTED TO THE ENGINEER.
- DO NOT CHANGE SIZE OR SPACING OF STRUCTURAL ELEMENTS
- DETAILS SHOWN ARE TYPICAL: SIMILAR DETAILS APPLY TO SIMILAR CONDITIONS UNLESS
- THESE DRAWINGS DO NOT INCLUDE NECESSARY COMPONENTS FOR CONSTRUCTION SAFETY WHICH SHALL BE THE SOLE RESPONSIBILITY OF THE CONTRACTOR
- CONTRACTOR SHALL BRACE STRUCTURES UNTIL ALL STRUCTURAL ELEMENTS NEEDED FOR STABILITY ARE INSTALLED. THESE ELEMENTS ARE AS FOLLOWS: LATERAL BRACING
- CONTRACTOR SHALL DETERMINE EXACT LOCATION OF EXISTING UTILITIES, GROUNDS DRAINS, DRAIN PIPES, VENTS, ETC, BEFORE COMMENCING WORK
- INCORRECTLY FABRICATED, DAMAGED, OR OTHERWISE MISFITTING OR NONCONFORMING MATERIALS OR CONDITIONS SHALL BE REPORTED TO THE AT&T REP PRIOR TO REMEDIAL OR CORRECTIVE ACTION, ANY SUCH REMEDIAL ACTION SHALL REQUIRE WRITTEN APPROVAL BY THE AT&T REP PRIOR TO PROCEEDING.
- EACH CONTRACTOR SHALL COOPERATE WITH THE AT&T REP, AND COORDINATE HIS WORK WITH THE WORK OF OTHERS.
- CONTRACTOR SHALL REPAIR ANY DAMAGE CAUSED BY CONSTRUCTION OF THIS PROJECT TO MATCH EXISTING PRE-CONSTRUCTION CONDITIONS TO THE SATISFACTION OF THE AT&T CONSTRUCTION MANAGER.
- ALL CABLE/CONDUIT ENTRY/EXIT PORTS SHALL BE WEATHERPROOFED DURING 15. INSTALLATION LISING A SILICONE SEALANT
- WHERE EXISTING CONDITIONS DO NOT MATCH THOSE SHOWN IN THIS PLAN SET. CONTRACTOR SHALL NOTIFY THE AT&T REP AND ENGINEER OF RECORD IMMEDIATELY
- CONTRACTOR SHALL ENSURE ALL SUBCONTRACTORS ARE PROVIDED WITH A COMPLETE AND CURRENT SET OF DRAWINGS AND SPECIFICATIONS FOR THIS PROJECT
- CONTRACTOR SHALL REMOVE ALL RUBBISH AND DEBRIS FROM THE SITE AT THE END OF
- CONTRACTOR SHALL COORDINATE WORK SCHEDULE WITH AMERICAN TOWER CORPORATION (ATC) AND TAKE PRECAUTIONS TO MINIMIZE IMPACT AND DISRUPTION OF OTHER OCCUPANTS OF THE FACILITY
- CONTRACTOR SHALL FURNISH AT&T AND AMERICAN TOWER CORPORATION (ATC) WITH A PDF MARKED UP AS-BUILT SET OF DRAWINGS UPON COMPLETION OF WORK.
- PRIOR TO SUBMISSION OF BID. CONTRACTOR SHALL COORDINATE WITH AT&T REP TO DETERMINE WHAT, IF ANY, ITEMS WILL BE PROVIDED. ALL ITEMS NOT PROVIDED SHALL BE PROVIDED AND INSTALLED BY THE CONTRACTOR. CONTRACTOR WILL INSTALL ALL
- 22. PRIOR TO SUBMISSION OF BID, CONTRACTOR SHALL COORDINATE WITH AT&T REP TO

- DETERMINE IF ANY PERMITS WILL BE OBTAINED BY CONTRACTOR. ALL REQUIRED PERMITS NOT OBTAINED BY AT&T MUST BE OBTAINED, AND PAID FOR, BY THE
- CONTRACTOR SHALL INSTALL ALL SITE SIGNAGE IN ACCORDANCE WITH AT&T SPECIFICATIONS AND REQUIREMENTS
- 24. CONTRACTOR SHALL SUBMIT ALL SHOP DRAWINGS TO AT&T FOR REVIEW AND APPROVAL PRIOR TO FABRICATION.
- ALL EQUIPMENT SHALL BE INSTALLED ACCORDING TO MANUFACTURER'S SPECIFICATIONS AND LOCATED ACCORDING TO AT&T SPECIFICATIONS, AND AS SHOWN
- THE CONTRACTOR SHALL SUPERVISE AND DIRECT THE PROJECT DESCRIBED HEREIN. THE CONTRACTOR SHALL BE SOLELY RESPONSIBLE FOR ALL THE CONSTRUCTION MEANS METHODS, TECHNIQUES, SEQUENCES AND PROCEDURES AND FOR COORDINATING ALL PORTIONS OF THE WORK UNDER THE CONTRACT.
- 27. CONTRACTOR SHALL NOTIFY AT&T REP A MINIMUM OF 48 HOURS IN ADVANCE OF POURING CONCRETE OR BACKFILLING ANY UNDERGROUND UTILITIES. FOUNDATIONS OR SEALING ANY WALL, FLOOR OR ROOF PENETRATIONS FOR ENGINEERING REVIEW AND
- 28. CONTRACTOR SHALL BE RESPONSIBLE FOR SITE SAFETY INCLUDING COMPLIANCE WITH ALL APPLICABLE OSHA STANDARDS AND RECOMMENDATIONS AND SHALL PROVIDE ALL NECESSARY SAFETY DEVICES INCLUDING PPE AND PPM AND CONSTRUCTION DEVICES SUCH AS WELDING AND FIRE PREVENTION, TEMPORARY SHORING, SCAFFOLDING, TRENCH BOXES/SLOPING, BARRIERS, ETC
- THE CONTRACTOR SHALL PROTECT AT HIS OWN EXPENSE. ALL EXISTING FACILITIES AND SUCH OF HIS NEW WORK LIABLE TO INJURY DURING THE CONSTRUCTION PERIOD. ANY DAMAGE CAUSED BY NEGLECT ON THE PART OF THIS CONTRACTOR OR HIS REPRESENTATIVES, OR BY THE ELEMENTS DUE TO NEGLECT ON THE PART OF THIS CONTRACTOR OR HIS REPRESENTATIVES, EITHER TO THE EXISTING WORK, OR TO HIS WORK OR THE WORK OF ANY OTHER CONTRACTOR, SHALL BE REPAIRED AT HIS EXPENSE TO THE OWNER'S SATISFACTION.
- ALL WORK SHALL BE INSTALLED IN A FIRST CLASS, NEAT AND WORKMANLIKE MANNER BY MECHANICS SKILLED IN THE TRADE INVOLVED. THE QUALITY OF WORKMANSHIP SHALL BE SUBJECT TO THE APPROVAL OF THE AT&T, REP., ANY WORK FOUND BY THE AT&T REP TO BE OF INFERIOR QUALITY AND/OR WORKMANSHIP SHALL BE REPLACED AND/OR REWORKED AT CONTRACTOR EXPENSE UNTIL APPROVAL IS OBTAINED.
- 31 IN ORDER TO ESTABLISH STANDARDS OF QUALITY AND PERFORMANCE ALL TYPES OF MATERIALS LISTED HEREINAFTER BY MANUFACTURER'S NAMES AND/OR
 MANUFACTURER'S CATALOG NUMBER SHALL BE PROVIDED BY THESE MANUFACTURERS
- 32 AT&T FURNISHED FOLIPMENT SHALL BE PICKED-LIP AT THE AT&T WAREHOUSE NO LATER THAN 48HR AFTER BEING NOTIFIED INSURED, STORED, UNCRATE, PROTECTED AND INSTALLED BY THE CONTRACTOR WITH ALL APPURTENANCES REQUIRED TO PLACE THE EQUIPMENT IN OPERATION, READY FOR USE. THE CONTRACTOR SHALL BE RESPONSIBLE FOR THE EQUIPMENT AFTER PICKING IT UP
- 33. AT&T OR HIS ARCHITECT/ENGINEER RESERVES THE RIGHT TO REJECT ANY EQUIPMENT OR MATERIALS WHICH, IN HIS OWN OPINION ARE NOT IN COMPLIANCE WITH THE CONTRACT DOCUMENTS, EITHER BEFORE OR AFTER INSTALLATION AND THE EQUIPMENT SHALL BE REPLACED WITH EQUIPMENT CONFORMING TO THE REQUIREMENTS OF THE CONTRACT DOCUMENTS BY THE CONTRACTOR AT NO COST TO AT&T OR THEIR

SPECIAL CONSTRUCTION ANTENNA INSTALLATION NOTES:

- WORK INCLUDED
 - ANTENNA AND COAXIAL CABLES ARE FURNISHED BY AT&T UNDER A SEPARATE CONTRACT. THE CONTRACTOR SHALL ASSIST ANTENNA INSTALLATION CONTRACTOR IN TERMS OF COORDINATION AND SITE ACCESS. ERECTION SUBCONTRACTOR SHALL BE RESPONSIBLE FOR THE PROTECTION OF
 - B. INSTALL ANTENNAS AS INDICATED ON DRAWINGS AND AT&T SPECIFICATIONS.
 - C. INSTALL GALVANIZED STEEL ANTENNA MOUNTS AS INDICATED ON DRAWINGS.
 - D. INSTALL FURNISHED GALVANIZED STEEL OR ALUMINUM WAVEGUIDE
 - CONTRACTOR SHALL PROVIDE FOUR (4) SETS OF SWEEP TESTS USING ANRITZU-PACKARD 8713B RF SCALAR NETWORK ANALYZER. SUBMIT FREQUENCY DOMAIN REFLECTOMETER(FDR) TESTS RESULTS TO THE PROJECT MANAGER. SWEEP TESTS SHALL BE AS PER ATTACHED RFS "MINIMUM FIELD TESTING RECOMMENDED FOR ANTENNA AND HELIAX COAXIAL CABLE SYSTEMS" DATED 10/5/93 TESTING SHALL BE PERFORMED BY AN INDEPENDENT TESTING SERVICE BE BOUND AND SUBMITTED WITHIN ONE WEEK OF WORK COMPLETION.
 - INSTALL COAXIAL CABLES AND TERMINATING BETWEEN ANTENNAS AND EQUIPMENT PER MANUFACTURER'S RECOMMENDATIONS, WEATHERPROOF ALL CONNECTIONS BETWEEN THE ANTENNA AND EQUIPMENT PER MANUFACTURERS' REQUIREMENTS. TERMINATE ALL COAXIAL CABLE THREE (3) FEET IN EXCESS OF ENTRY PORT LOCATION UNLESS OTHERWISE STATED.
 - G. ANTENNA AND COAXIAL CABLE GROUNDING:
- ALL EXTERIOR #6 GREEN GROUND WIRE "DAISY CHAIN" CONNECTIONS ARE TO BE WEATHER SEALED WITH RFS CONNECTORS/SPLICE WEATHERPROOFING KIT #221213 OR **EQUAL**
- ALL COAXIAL CABLE GROUNDING KITS ARE TO BE INSTALLED ON STRAIGHT RUNS OF





99 SUMMER STREET SUITE 700 BOSTON, MA 02110 PHONE: 617.695.3400 FAX: 617.695.3310

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ATC SITE NUMBER: 302537

ATC SITE NAME: MIDDLETOWN CT 3

AT&T SITE NAME:

ROCKY HILL, CT 06067

CROMWELL EAST SITE ADDRESS: 47 INWOOD ROAD





DATE DRAWN:	02/23/22
ATC JOB NO:	13747862_D1
CUSTOMER ID:	CTL05121
CUSTOMER #:	10070983

GENERAL NOTES

SHEET NUMBER:

ALL DISCREPANCIES FROM WHAT IS SHOWN ON THESE

CONSTRUCTION DRAWINGS SHALL BE COMMUNICATED TO ATC ENGINEERING IMMEDIATELY FOR CORRECTION OR RE-DESIGN.

FAILURE TO COMMUNICATE DIRECTLY WITH ATC ENGINEERING OR

ANY CHANGES FROM THE DESIGN CONDUCTED WITHOUT PRIOR

APPROVAL FROM ATC ENGINEERING SHALL BE THE SOLE

RESPONSIBILITY OF THE GENERAL CONTRACTOR.

REVISION

G-002

SITE PLAN NOTES:

TRN

- THIS SITE PLAN REPRESENTS THE BEST PRESENT KNOWLEDGE AVAILABLE TO THE ENGINEER AT THE TIME OF THIS DESIGN. THE CONTRACTOR SHALL VISIT THE SITE PRIOR TO CONSTRUCTION AND VERIFY ALL EXISTING CONDITIONS RELATED TO THE SCOPE OF WORK FOR THIS PROJECT.
- ICE BRIDGE, CABLE LADDER, COAX PORT, AND COAX CABLE ARE SHOWN FOR REFERENCE ONLY, CONTRACTOR SHALL CONFIRM THE EXACT LOCATION OF ALL PROPOSED AND EXISTING EQUIPMENT AND STRUCTURES DEPICTED ON THIS PLAN. BEFORE UTILIZING EXISTING CABLE SUPPORTS, COAX PORTS, INSTALLING NEW PORTS OR ANY OTHER EQUIPMENT, CONTRACTOR SHALL VERIFY ALL ASPECTS OF THE COMPONENTS MEET THE ATC SPECIFICATIONS.
- THIS PROJECT INCLUDES NO INSTALL OR MODIFICATION AT GRADE.


LEGEND ⊗ GROUNDING TEST WELL AUTOMATIC TRANSFER SWITCH ATS **BOLLARD** CSC CELL SITE CABINET D DISCONNECT ELECTRICAL **FIBER** GEN **GENERATOR** GENERATOR RECEPTACAL HH, V HAND HOLE, VAULT ΙB ICE BRIDGE KENTROX BOX LC LIGHTING CONTROL М METER PB PULL BOX PP POWER POLE TELCO


TRANSFORMER

CHAINLINK FENCE

PROPOSED CABLE LENGTH:

- ESTIMATED LENGTH OF PROPOSED CABLE IS <u>250'±</u>.
 ESTIMATED LENGTH OF CABLE WAS PROVIDED BY CUSTOMER OR CALCULATED BY ADDING THE RAD CENTER AND THE DISTANCE FROM THE SHELTER ENTRY PLATE TO THE TOWER (ALONG THE ICE BRIDGE) AND A SAFETY FACTOR MEASUREMENT OF 15% (OF THE TWO PREVIOUS VALUES), CDS DEFER TO GREATEST CABLE LENGTH.
- ROUTE PROPOSED CABLES ALONG SAME PATH AS EXISTING CABLES AND IN ACCORDANCE WITH STRUCTURAL ANALYSIS. WHERE POSSIBLE UTILIZE EXISTING CABLE SUPPORT STRUCTURES AS PROVIDED FOR CARRIER TO ADEQUATELY SECURE CABLES, USING EITHER APPROPRIATELY SIZED STAINLESS STEEL SNAP-INS OR MOUNTING HARDWARE AND BRACKETS AS SPECIFIED BY CABLE MANUFACTURER. OTHERWISE, ATTACH CABLES TO HORIZONTAL OR DIAGONAL TOWER MEMBERS USING PROPOSED STAINLESS STEEL ADAPTERS (DO NOT ATTACH TO TOWER LEG).

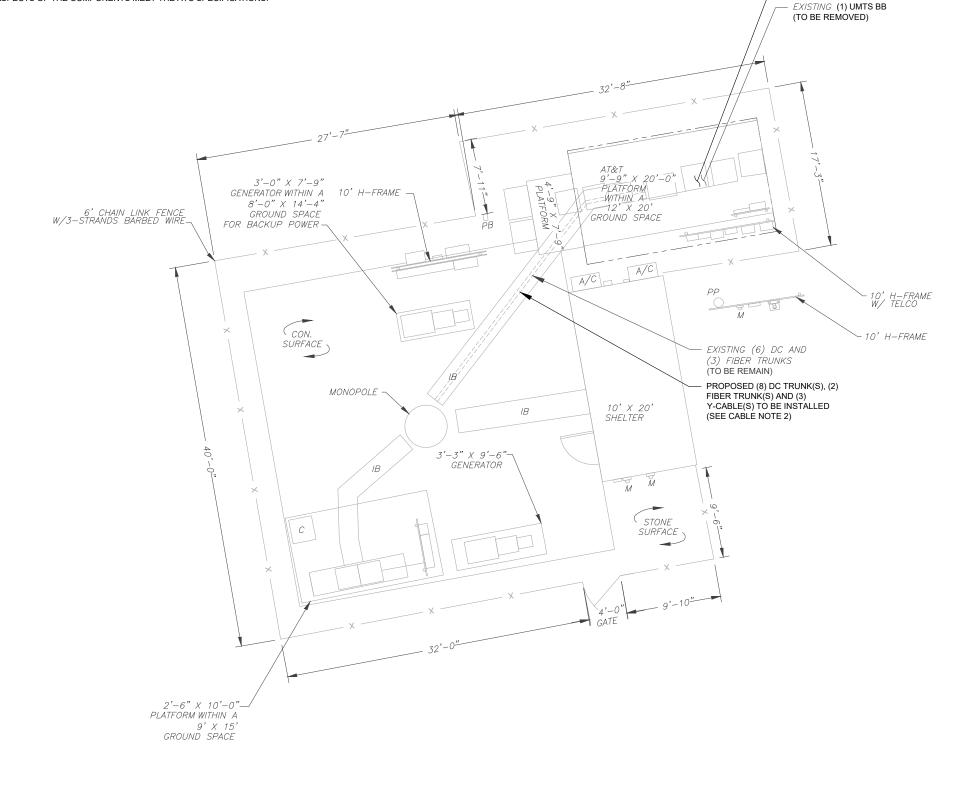

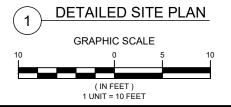







PROPOSED (1) 5216, (1) XMU, (1) 6630 & IDLe IN EXISTING CABINET

Dewberry Engineers Inc. 99 SUMMER STREET SUITE 700 BOSTON, MA 02110 PHONE: 617.695.3400 FAX: 617.695.3310

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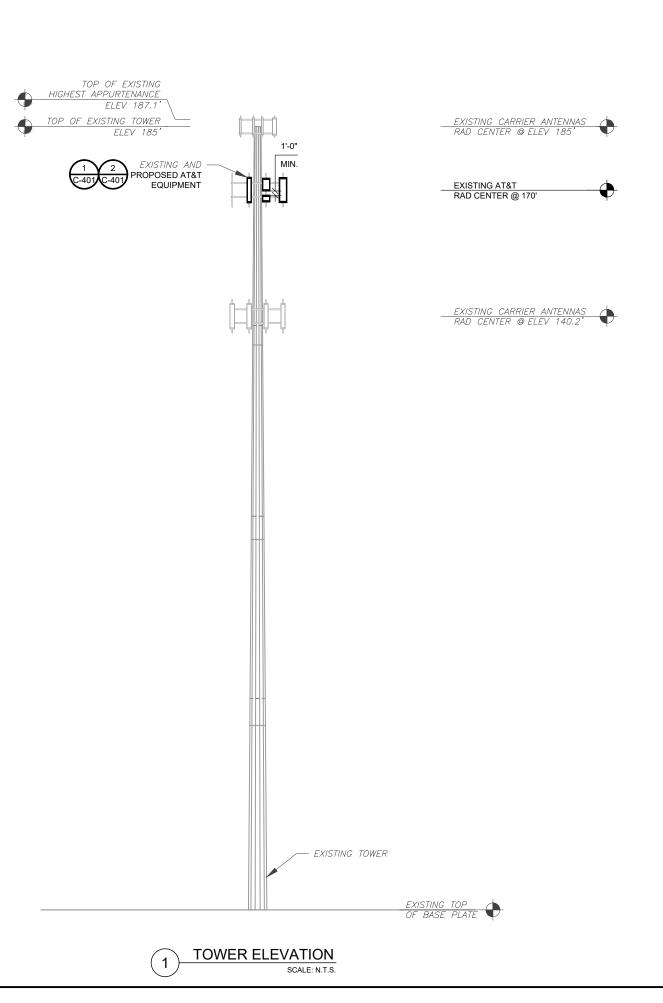
	DATE DRAWN:	02/23/22
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DETAILED SITE PLAN

SHEET NUMBER:

C-101

REVISION: 0



PER MOUNT ANALYSIS COMPLETED BY TELEMON TOWER ENGINEERING PLLC, DATED 04/19/2022, THE EXISTING MOUNT MUST BE MODIFIED TO ADEQUATELY SUPPORT THE PROPOSED LOADING. THE MOUNT MODIFICATION PROPOSED IN THE MOUNT ANALYSIS, INCLUDED AT THE END OF THIS PLAN SET, MUST BE INSTALLED PRIOR TO THE INSTALLATION OF THE PROPOSED ANTENNAS AND OTHER EQUIPMENT.

1. IT IS THE CONTRACTOR'S RESPONSIBILITY TO CONFIRM WITH THE PROJECT MANAGER THAT THEY HAVE THE MOST RECENT VERSION OF THE STRUCTURAL ANALYSIS BEFORE COMMENCING WORK. EXISTING AND PROPOSED TOWER APPURTENANCES, MOUNTS, AND ANTENNAS ARE SHOWN BASED ON THE STRUCTURAL ANALYSIS.

2. WHERE APPLICABLE, ALL NEW ANTENNAS, EQUIPMENT, MOUNTS, CABLING, ETC. SHALL BE PAINTED/SOCKED TO MATCH EXISTING EQUIPMENT IN ACCORDANCE WITH FAA, JURISDICTION, AND/OR

3. ROUTE PROPOSED CABLES ALONG SAME PATH AS EXISTING CABLES AND IN ACCORDANCE WITH STRUCTURAL ANALYSIS. IF ADEQUATE SPACE EXISTS, ROUTE CABLES THROUGH ENTRY PORT HOLE, UP INSIDE OF MONOPOLE, AND THROUGH EXIT PORT HOLE. IF ROUTING OUTSIDE THE MONOPOLE, ATTACH CABLES USING STAND-OFF ADAPTERS MOUNTED TO TOWER USING STAINLESS STEEL BANDING. ADEQUATELY SECURE CABLES

USING EITHER APPROPRIATELY SIZED STAINLESS STEEL SNAP-INS OR MOUNTING HARDWARE AND

MANUFACTURER.
TOWER ELEVATIONS ARE MEASURED FROM TOP

TOWER ELEVATION DEPICTION MAY NOT REFLECT

ANALYSIS. REFER TO STRUCTURAL ANALYSIS FOR

ALL EQUIPMENT INCLUDED IN STRUCTURAL

BRACKETS AS SPECIFIED BY CABLE

ABOVE GROUND LEVEL (A.G.L.)

FULL TOWER LOADING.

OF BASE PLATE TO MATCH STRUCTURAL ANALYSIS. ELEVATIONS DO NOT REFLECT TRUE

OTHER LOCAL REQUIREMENTS.





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SEAL





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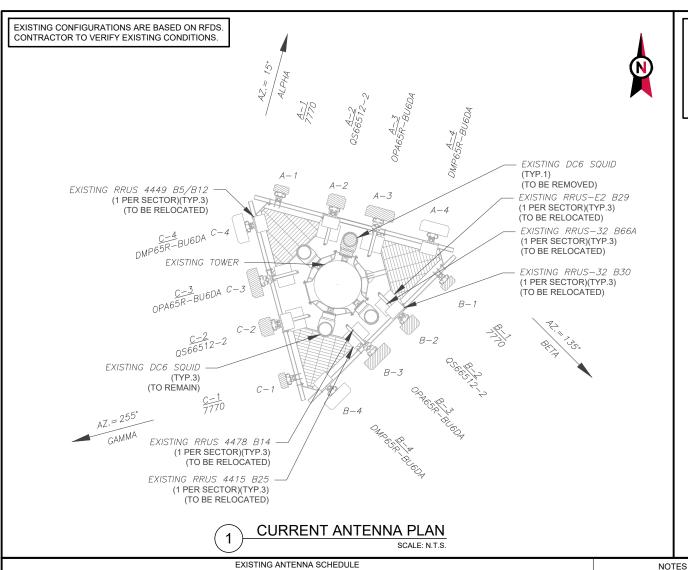
TOWER ELEVATION

SHEET NUMBER:

REVISION:

C-201

201



NON ANTENNA SUMMARY

REL

EQUIPMENT

RRUS-E2 B29

RRUS-32 R664

RRUS-32 B30

RRUS 4478 B14

RRUS 4415 B25

RRUS 4449 B5/B12

RRUS-E2 B29

RRUS-32 B66A

RRUS-32 B30

RRUS 4478 B14

RRUS 4415 B25

RRUS 4449 B5/B12

RRUS-E2 B29

RRUS-32 B66A

RRUS-32 B30

RRUS 4478 B14

RRUS 4415 B25

RRUS 4449 B5/B12

STATUS

RMV

RMV

RMV

RMN

RMV

RMV


RMN

RMV

RMV

RMV

RMN

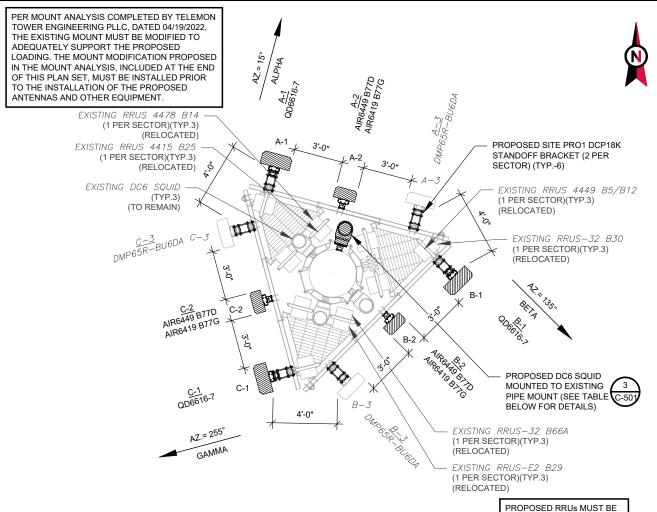

FINAL ANTENNA SCHEDULE CONFIRM WITH AT&T REP FOR LOCATION ANTENNA SUMMARY ADDITIONAL TOWER MOUNTED STATUS APPLICABLE UPDATES/REVISIONS SECTOR RAD ΑZ POS ANTENNA AND MOST RECENT RFDS FOR NSN CONFIGURATION (CONFIG). GC TO CAP ALL UNUSED PORTS CONFIRM SPACING OF PROPOSED Α1 QD6616-7 EQUIP DOES NOT CAUSE TOWER CONFLICTS NOR IMPEDE TOWER CLIMBING PEGS. 170' 15° AI PHA THE ANTENNA ORIENTATION PLAN AIR6449 B77D A2 IS A SCHEMATIC. ATC DID NOT AIR6419 B77G CONFIRM EXISTING SITE CONDITIONS INCLUDING BUT NOT DMP65R-BU6DA LIMITED TO, ANTENNA AZIMUTHS, MOUNT CONFIGURATIONS AND TOWER ORIENTATION, SCALES SHOWN ARE FOR REFERENCE ONLY AND EXISTING DIMENSIONS В1 QD6616-7 ARE APPROXIMATE. THE CONTRACTOR SHALL VERIFY ALL BETA 170' 135° EXISTING CONDITIONS PRIOR TO AIR6449 B77D INSTALLATION AND NOTIFY ATC B2 AIR6419 B77G OF ANY DISCREPANCIES CONTRACTOR TO ENSURE PROPER SEPARATION IN В3 DMP65R-BU6DA ACCORDANCE WITH AT&T'S

> STATUS ABBREVIATIONS RMN: TO REMAIN ADD: TO BE ADDED

CABLE LENGTHS FOR JUMPERS

RMV: TO BE REMOVED REL: TO BE RELOCATED

SHEET R-602)

JUNCTION BOX TO RRU: 15'

EQUIPMENT SCHEDULES

				1000,71			KKI	JS-32 B00A	KEL
70' 2	2550						RR	US-E2 B29	REL
'0' 255°		C2	AIR6449 B77D	5G CBAI	ND	ADD			_
		62	AIR6419 B77G	LSUB	LSUB6 ADD			-	
		C3	DMP65R-BU6DA LTE 700, WCS, 5G 850		EC 050	RMN	44	49 B5/B12	REL
		C3	DIVIPOSK-BUODA	LIE 700, WCS, 5G 650		RIVIN	RR	US-32 B30	REL
	FINAL FIBER DISTRIBUTION/SQUID FINAL CABLING SUMMARY								
	MODEL NUMBER		STATUS	COAX		DC	FIBER	STATUS	
(3) DC6 RMN		-		(3)	_	RMN			

ADD





Dewberry Engineers Inc. 99 SUMMER STREET SUITE 700 BOSTON, MA 02110 PHONE: 617.695.3400 FAX: 617.695.3310

REV.	DESCRIPTION	BY	DATE
<u> </u>	PRELIM	BR	04/29/22
<u> </u>	FINAL	BR	04/29/22
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ATC SITE NUMBER 302537

ATC SITE NAME: MIDDLETOWN CT 3

AT&T SITE NAME: **CROMWELL EAST**

SITE ADDRESS: 47 INWOOD ROAD





DATE DRAWN:	02/23/22
ATC JOB NO:	13747862_D1
CUSTOMER ID:	CTL05121
CUSTOMER #:	10070983

RF SCHEDULE AND ANTENNA INSTALLATION

SHEET NUMBER:

C-401

REVISION 0

EXISTING FIBER DISTRIBUTION/SQUID		EXISTING CABLING SUMMARY			
MODEL NUMBER	STATUS	COAX	DC	FIBER	STATUS
(3) DC6	RMN	_	(3)	-	RMN
(1) DC6	RMV	_	_	_	_

ANTENNA SUMMARY

BAND

UMTS 850

LTE 700. AWS

LTE 700, 1900

LTE 850, 700, 5G 850

UMTS 850

LTE 700, AWS

LTE 700, 1900

LTE 850, 700, 5G 850

UMTS 850

LTE 700, AWS

LTE 700, 1900

LTE 850, 700, 5G 850

ANTENNA

7770

QS66512-2

OPA65R-BU6DA

DMP65R-BU6DA

7770

QS66512-2

OPA65R-BU6DA

DMP65R-BU6DA

7770

QS66512-2

OPA65R-BU6DA

DMP65R-BU6DA

LOCATION

170'

170'

170'

ΑZ

15°

135°

255°

POS

A2

A3

A4

B1

B2

В3

R4

C1

C2

C3

SECTOR RAD

AI PHA

BETA

GAMMA

4449 B5/B12 REL LTE 700, WCS, 5G 850 RRUS-32 B30 REL 4478 B14 REL 4415 B25 REL LTE 700, 1900, AWS, 5G ADD 1900, AWS RRUS-32 B66A REL REL RRUS-E2 B29 5G CBAND ADD LSUB6 ADD 4449 B5/B12 REL LTE 700, WCS, 5G 850 RMN RRUS-32 B30 REL FIRSTNET REQUIREMENTS (SEE REL 4478 B14 4415 B25 REL LTE 700, 1900, AWS, 5G C1 QD6616-7 ADD 170 GAMMA

(1) DC6-48-60-18-8F

FINAL ANTENNA PLAN

SCALE: N.T.S

BAND

LTE 700, 1900, AWS, 5G

1900. AWS

5G CBAND

LSUB6

STATUS

ADD

ADD

ADD

INSTALLED A MINIMUM OF 8"

AWAY FROM ALL ANTENNAS

ADDITIONAL TOWER MOUNTED

EQUIPMENT

4478 B14

4415 B25

RRUS-32 B66A

RRUS-F2 B29

(2)

(8)

ADD

NON ANTENNA SUMMARY

STATUS


REL

REL


REL

REL

RRU TO ANTENNA: 10'

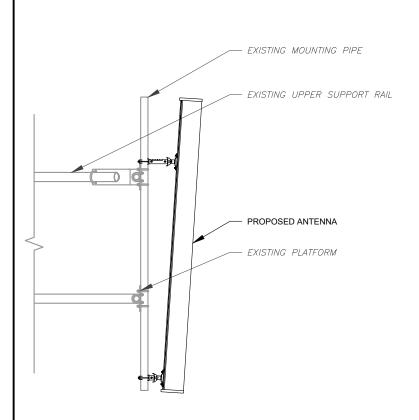


ANTENNA DETAIL

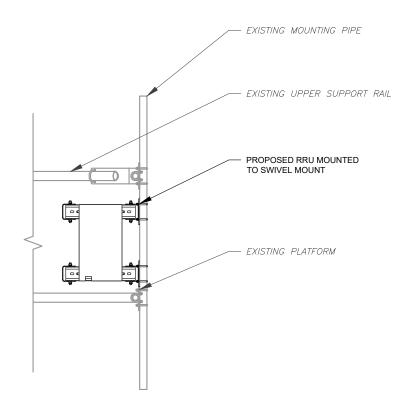



EXISTING MOUNTING PIPE PROPOSED SQUID (MOUNT PER MANUFACTURER'S SPECS) (ENSURE THAT BRACKET DOES NOT CONFLICT WITH EXISTING OR PROPOSED EQUIPMENT)

PROPOSED RRU MOUNTING DETAIL - TYPICAL

PROPOSED SQUID MOUNTING SCALE: N.T.S.

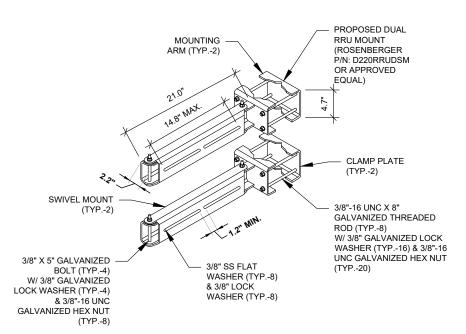

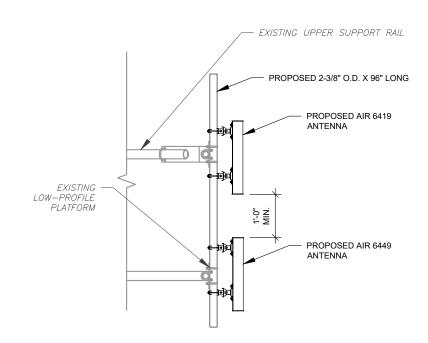


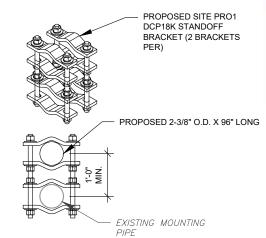

FITS 1-1/2" TO 5" PIPE O.D.

PROPOSED 5G ANTENNA MOUNTING DETAIL - TYPICAL

ANTENNA STAND OFF DETAIL

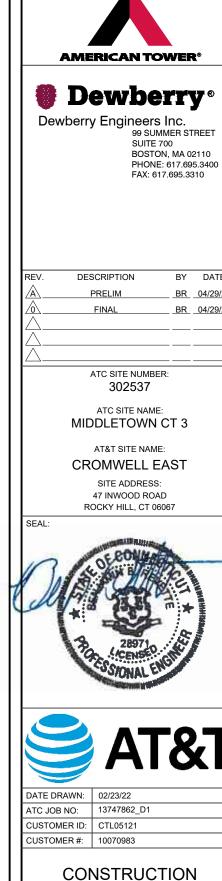

99 SUMMER STREET SUITE 700

BY DATE

BR 04/29/22


BR 04/29/22

PROPOSED SWIVEL MOUNT DETAIL

SHEET NUMBER: REVISION C-501

DETAILS

0

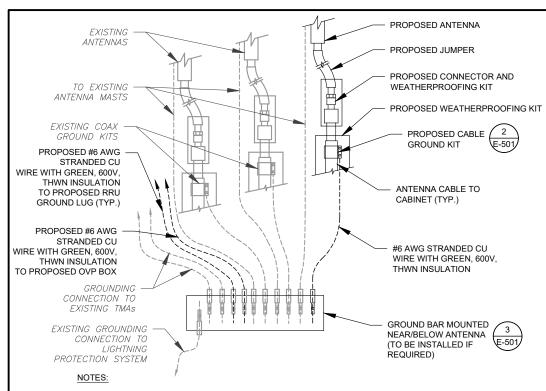

- THIS DETAIL IS INTENDED TO SHOW THE GENERAL GROUNDING REQUIREMENTS. SLIGHT ADJUSTMENTS MAY BE REQUIRED BASED ON EXISTING SITE CONDITIONS. THE CONTRACTOR SHALL MAKE FIELD ADJUSTMENTS AS NEEDED AND INFORM THE CONSTRUCTION MANAGER OF ANY CONFLICTS.
- 2. SITE GROUNDING SHALL COMPLY WITH AT&T GROUNDING STANDARDS, LATEST EDITION, AND COMPLY WITH AT&T GROUNDING CHECKLIST, LATEST VERSION. WHEN NATIONAL AND LOCAL GROUNDING CODES ARE MORE STRINGENT THEY SHALL GOVERN.



3/8" X 3/4" SS


GROUND BAR

BOLT (TYP.)

1/4" X 4" X 12"

TWO-HOLE LUG, TO BE USED WITH #2 AWG BCW

GALVANIZED BUSS

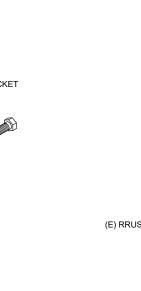

GROUND BAR NOTES


3/8" SS LOCK WASHER (TYP.)

1/4"Ø HILTI KWIK BOLT III

WHERE INDICATED

3/8" THREADED INSULATOR


- GROUND KITS COME WITH ALL HARDWARE, NUTS, BOLTS, WASHERS, ETC. EXCEPT THE STRUCTURAL MOUNTING MEMBER(S)
- 2. GROUND BAR SHALL BE BOLTED TO STRUCTURAL MEMBER OR ANCHORED TO CONCRETE SLAB W/ HILTI KWIK BOLT III.

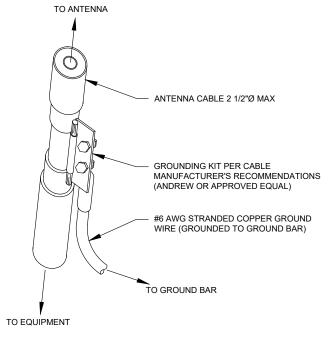

- <u>GROUND KIT NOTES:</u>

 1. DO NOT INSTALL CABLE GROUND KIT AT A BEND AND ALWAYS DIRECT GROUND WIRE DOWN TO GROUND BAR.
- 2. CONTRACTOR SHALL PROVIDE WEATHERPROOFING KIT (ANDREW PART NUMBER 221213) AND INSTALL/TAPE PER MANUFACTURER'S SPECIFICATIONS.


CABLE GROUND KIT CONNECTION DETAIL

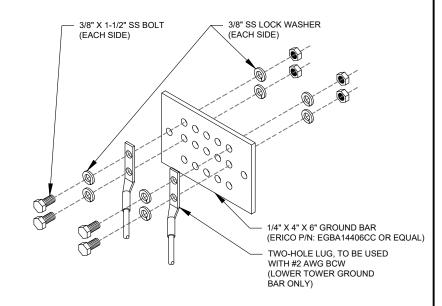

GROUND BAR NOTES:

- GROUND BAR KITS COME WITH ALL HARDWARE, NUTS, BOLTS, WASHERS, ETC. EXCEPT THE STRUCTURAL MOUNTING MEMBER(S).
- 2. GROUND BAR TO BE BONDED DIRECTLY TO TOWER.



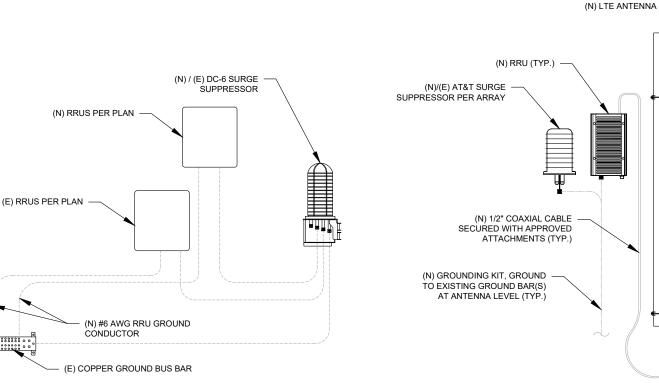





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REV.	DESCRIPTION	BY	DATE
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<u></u>	FINAL	BR	04/29/22
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ATC SITE NUMBER: 302537

ATC SITE NAME: MIDDLETOWN CT 3

AT&T SITE NAME:

CROMWELL EAST

SITE ADDRESS: 47 INWOOD ROAD ROCKY HILL, CT 06067



ATC JOB NO: 13747862_D1 CUSTOMER ID: CTL05121 CUSTOMER #: 10070983

GROUNDING DETAILS

SHEET NUMBER:

REVISION


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E-501


MAIN GROUND BAR DETAIL


RRU GROUNDING


ANTENNA/RRU GROUNDING

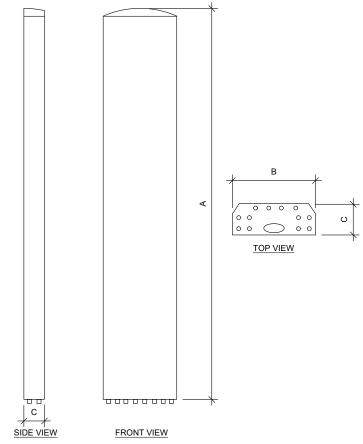

				
ANTENNA SPECIFICATIONS				
ANTENNA MODEL	А	В	С	WEIGHT (LBS)
AIR 6419 B77G	28.3"	16.1"	7.9"	66.1
AIR 6449 B77D	30.4"	15.9"	8.1"	81.6
QD6616-1	72.0"	22.0"	9.6"	130.0

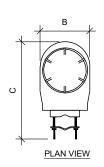

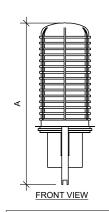

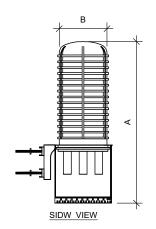

RAYCA	P SPECIFICA	ATIONS		
RAYCAP MODEL	А	В	С	WEIGHT (LBS)
DC6-48-60-18-8F	23.5"	9.7"	9.7"	20.0





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SEAL




DATE DRAWN: 02/23/22
ATC JOB NO: 13747862_D1
CUSTOMER ID: CTL05121
CUSTOMER #: 10070983

SUPPLEMENTAL

SHEET NUMBER:

RF REQUIREMENTS FOR 700 B14 FIRSTNET, 700 B12, 700D B29 ANTENNA SEPARATION

- ☐ Horizontal separation (side to side of antenna): >= 3'
- \Box Vertical separation (between the tips of the antennas): > 3'
- \square Inter-sector separation: > 4' between the center of the antenna backplanes.

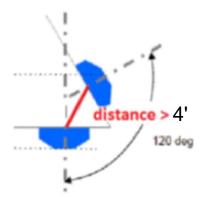

- ☐ Please note additional horizontal separation may be required if B14 antennas azimuth are different from others or antennas are severely angled with respect to the mount.
- ☐ Typical 3' horizontal separation can tolerate skew angle up to 6°.







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EAV. 617.606.3310

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SEAL:



	DATE DRAWN:	02/23/22
	ATC JOB NO:	13747862_D1
	CUSTOMER ID:	CTL05121
l	CUSTOMER #:	10070983

SUPPLEMENTAL

CUEET NII IMDE



This report was prepared for American Tower Corporation by



Antenna Mount Analysis Report

ATC Site Name : Middletown CT 3

ATC Asset Number : 302537

Engineering Number : 13747862 C8 01

Mount Elevation : 172 ft

Carrier : AT&T Mobility

Carrier Site Name : MRCTB050837

Carrier Site Number : CTCN005121

Site Location : 47 Inwood Road

Rocky Hill, CT 06067-3453

41.63858611, -72.67928889

County : Hartford

Date : April 19, 2022

Max Usage : 92%

Result : Contingent Pass*

*See condusion for requirements

Prepared By: Gunjan Donode

Telamon Tower Engineering, PLLC

Reviewed By: William Holt, P.E.

Telamon Tower Engineering, PLLC

Digitally signed by William Holt Date: 2022.04.20 13:13:36 -04'00'

PEX.35568
LLC

Solonal ENGINEER

William to A. P.

Chemical Complete Comple

tclamon ** • 319 Chapanoke Road, Suite 118, Raleigh, NC 27603 • Engineering@tteplic.com

Mount Analysis for American Tower

302537 - Middletown CT 3

April 19, 2022

Telamon Tower Engineering, PLLC Project #41124-13747862_C8_01-01-MA-R1

Conclusion

Based on the analysis, the antenna mount meets the requirements per the applicable codes listed above. The mounting configuration considered in this analysis will be capable of supporting the referenced loading pursuant to referenced standards once the following scope is executed:

AT&T CONMAT does not have parts which connect HSS tube to pipe. Hence proposing modifications parts which are not listed in the CONMAT list.

- Install (2) proposed 8 ft long pipe 2 STD, A53 Gr. B mount pipes at each sector for proposed RRU (6 total) as shown. Connect to existing HSS tube standoff arms using (3) Site Pro 1 BBPM-K3 (3 total).
- Install (2) proposed 10 ft long pipe 2 STD, A53 Gr. B secondary mount pipes at Position 1 and Position 3 at each sector for proposed panel configuration (6 total) as shown. Connect to existing primary mount pipes using (1) Site Pro 1 DCP12K kit (6 total).

No structural failures were addressed with the noted contingencies. Contingencies address Carrier's antenna spacing requirements.

If you have any questions or require additional information, please contact American Tower via email at Engineering@americantower.com. Please include the American Tower site name, site number, and engineering number in the subject line for any questions.

tclamon* • 319 Chapanoke Road, Suite 118, Raleigh, NC 27603 • Engineering@tteplk.com

Page 3





Dewberry Engineers Inc.
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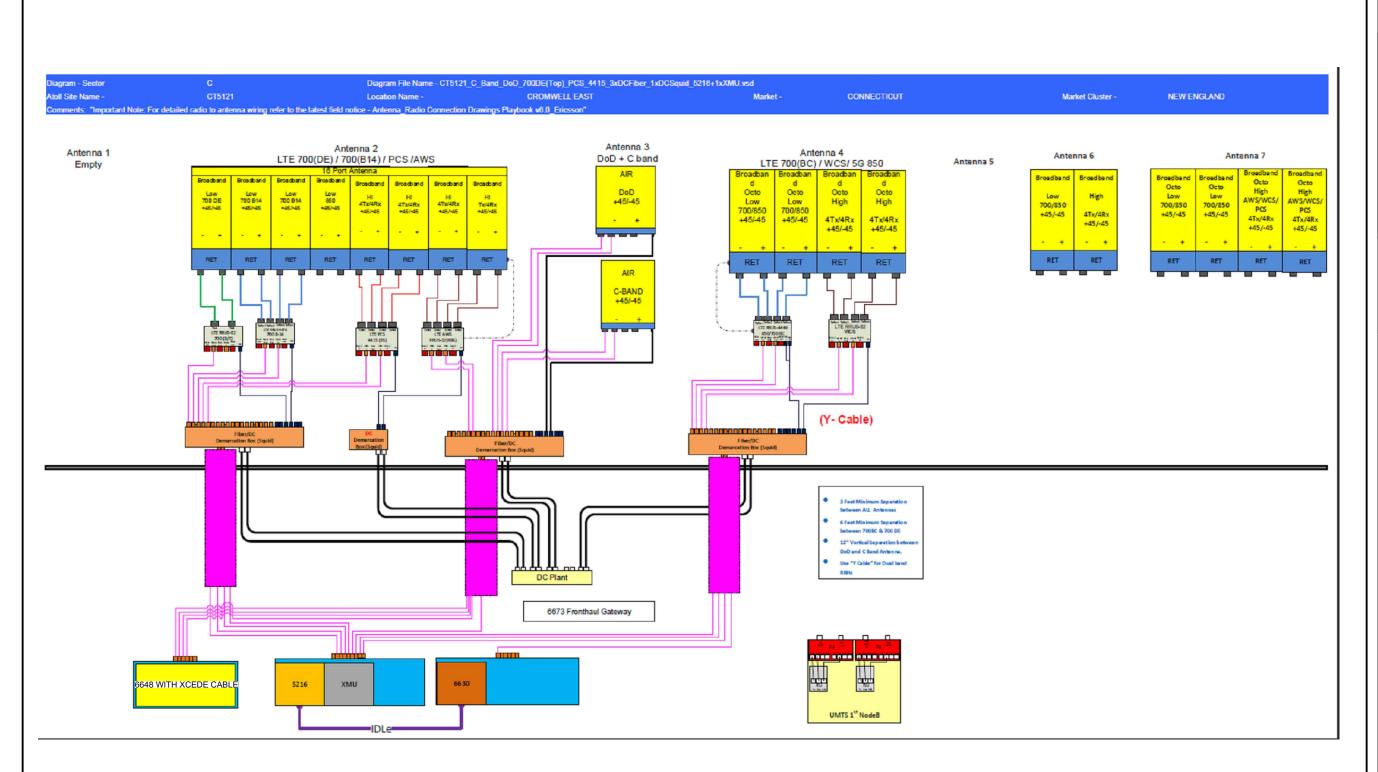
SEAL



DATE DRAWN: 02/23/22
ATC JOB NO: 13747862_D1
CUSTOMER ID: CTL05121
CUSTOMER #: 10070983

SUPPLEMENTAL

CHEET NI IMPE



NOTE: THIS SHEET WAS CREATED BY OTHERS
AND PROVIDED AT THE REQUEST OF THE
CUSTOMER WITHOUT EDIT. GENERAL
CONTRACTOR IS TO CHECK WITH THE AT&T
CM TO ENSURE THIS IS THE MOST RECENT
VERSION OF THE RFDS.





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SHEET NUMBER: