PROJECT TEAM CLIENT REPRESENTATIVE: EMPIRE TELECOM 16 ESQUIRE ROAD BILLERICA, MA 01821 DAVID COOPER 617-639-4908 dcooper@empiretelecc SITE ACQUISITION & ZONING: EMPIRE TELECOM 16 ESQUIRE ROAD BILLERICA, MA 01821 DAVID COOPER 617-639-4908 ENGINEERING: TRYLON TSF 24 QUEEN ST E BRAMPTON, ON L6V 1A2 KATYA SERAVALLE PHONE: 519-465-4125 RF ENGINEER: AT&T MOBILITY - NEW ENGLAND 550 COCHITUATE ROAD SUITE 550 13 & 14 FRAMINGHAM, MA 01701 CAMERON SYME 508-596-7146 cs6970@att.com CONSTRUCTION MANAGEMENT: EMPIRE TELECOM 16 ESQUIRE ROAD BILLERICA, MA 01821 GRZEGORZ "GREG" DORMAN 484-683-1750 gdorman@empiretelecomm.c

GENERAL NOTES

DO NOT SCALE DRAWINGS

TOWER OWNER: CHARLES BRADSHAW

CONTRACTOR SHALL VERIFY ALL PLANS AND EXISTING DIMENSIONS AND CONDITIONS ON THE JOB SITE AND SHALL IMMEDIATELY NOTIFY THE ARCHITECT/ENGINEER IN WRITING O ANY DISCREPANCIES BEFORE PROCEEDING WITH THE WORK OR BE RESPONSIBLE FOR SAME.

THE FACILITY IS UNMANNED AND NOT FOR HUMAN HABITATION. A TECHNICIAN WILL VISIT THE SITE AS REQUIRED FOR ROUTINE MAINTENANCE. THE PROJECT WILL NOT RESULT IN AMY SIGNIFICANT DISTURBANCE OR EFFECT ON DRAINAGE; NO SANITARY SEWER SERVICE, POTABLE WATER, OR TRASH DISPOSAL IS REQUIRED AND NO COMMERCIAL SIGNAGE IS PROPOSED.

SITE INFORMATION

LATITUDE: 41° 30' 40.37004" N LONGITUDE: 72° 58' 57.09684" W LAT./LONG. TYPE: NAD 83 GROUND ELEVATION: N/A APN/UPC:

AREA OF CONSTRUCTION: **EXISTING**

ZONING/JURISDICTION: TOWN OF PROSPECT

CURRENT ZONING: UNKNOWN

EXISTING USE: TELECOMMUNICATIONS FACILITY

COUNTY: NEW HAVEN

HANDICAP REQUIREMENTS: FACILITY IS UNMANNED AND NOT FOR HUMAN

HABITATION. HANDICAPPED ACCESS NOT REQUIRED.



LTE EXTENDED CARRIER RRH ADD CT2218 PROSPECT BRADSHAW TWR 54 WATERBURY ROAD PROSPECT, CT 06712 FA CODE: 10035230

APPROVALS		
AT&T (RF):	DATE:	
AT&T (CONST.):	DATE:	
AT&T (OPS):	DATE:	
TOWER OWNER:	DATE:	

JURISDICTIONAL APPROVAL

BASED ON INFORMATION PROVIDED BY AT&T REGULATORY COMPLIANCE PROFESSIONALS AND LEGAL COUNSEL, THIS TELECOMMUNICATIONS EQUIPMENT DEPLOYMENT IS CONSIDERED AN ELIGIBLE FACILITY UNDER THE MIDDLE CLASS TAX RELIEF AND JOB CREATION ACT OF 2012, 47 USC 1455(A), SECTION 6409(A), AND IS SUBJECT TO AN ELIGIBLE FACILITY REQUEST, EXPEDITED REVIEW AND LIMITED/PARTIAL ZONING PRE-EMPTION FOR LOCAL DISCRETIONARY PERMITS (VARIANCE, SPECIAL PERMIT, SITE PLAN REVIEW OR ADMINISTRATIVE REVIEW).

FOR (3) SÈCTORS. REUSE REUSE REUSE

PROJECT DESCRIPTION

THIS PROJECT WILL BE COMPRISED OF: CHANGES ON THE EXISTING ROOF TOP:

REMOVE (3) EXISTING ANTENNA (1) PER SECTOR FOR (3)

• REMOVE (3) EXISTING RRUS-12 (1) PER SECTOR

INSTALL (2) NEW HPA-65R-BUU-H8 ANTENNA (1) PER SECTOR

FOR ALPHA AND GAMMA SECTORS. INSTALL (1) NEW HPA-65R-BUU-H6 ANTENNA (1) PER SECTOR FOR BETA SECTOR.

RECONNECT (3) EXISTING RRUS-11 TO NEW LTE ANTENNA, (1) PER SECTOR FOR (3) SECTORS.

INSTALL (3) NEW RRUS-32 B2, (1) PER SECTOR FOR (3)

(4) EXISTING TMA'S.

(1) EXISTING SQUID.

(2) EXISTING DC POWER TRUNK.


(1) EXISTING FIBER TRUNK.

REUSE (1) EXISTING RET CABLE.

(8) EXISTING RF CABLES.

CHANGES IN THE EXISTING AT&T EQUIPMENT ENCLOSURE AREA: INSTALL (1) NEW XMU.

DUL TO DUS UPGRADE

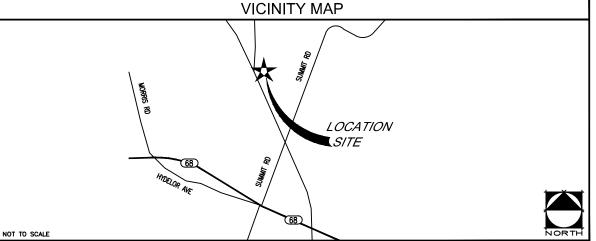

DRIVING DIRECTIONS

2218 PROSPECT NORTH | 84 WEST TO EXIT 25 SCOTT RD LEFT AT END OF EXIT GO STRAIGHT UNTIL YOU REACH THE INTERSECTION OF RT 69 GO LEFT AND DRIVEWAY IS YOUR IMMEDIATE LEFT BEHIND HOUSE ADDRESS 54 WATERBURY ROADLMU LAT/LONG- 41.511307 -72.982550GSM SPANS-DHXV238837,238838, AND HCGS723929UMT. SPANS-HCGS743757,743758

CODE COMPLIANCE

BUILDING CODE: 2011 MASSACHUSETTS COMMERCIAL BUILDING CODE ELECTRICAL CODE: 2012 MASSACHUSETTS ELECTRICAL CODE GHTNING PROTECTION CODE: NFPA 780 - 2000, LIGHTNING PROTECTION CODE

SUBCONTRACTOR'S WORK SHALL COMPLY WITH ALL APPLICABLE NATIONAL STATE, AND SUBCONTRACTORS WORK STALL COMPLET WITH ALL APPLICABLE MATIONAL, STATE, AND LOCAL COLOES AS ADDOPTED BY THE LOCAL AUTHORITY HAVING JURISDICTION (AH.) FOR THE LOCATION. THE EDITION OF THE AHA ADDOPTED CODES AND STANDARDS IN EFFECT ON THE DATE OF CONTRACT MAKEN SHALL GOVERN THE DESIGN.

FOR ANY CONFLICTS BETWEEN SECTIONS OF LISTED CODES AND STANDARDS REGARDING MATERIAL, METHODS OF CONSTRUCTION, OR OTHER REQUIREMENTS, THE MOST RESTRICTIV REQUIREMENT SHALL GOVERN. WHERE THERE IS CONFLICT BETWEEN A GENERAL REQUIREMENT AND A SPECIFIC REQUIREMENT, THE SPECIFIC REQUIREMENT SHALL GOVERN.



MASSACHUSETTS LAW REQUIRES 72 WORKING HOURS NOTICE PRIOR TO ANY EARTH MOVING ACTIVITIES BY CALLING

SHEET **DESCRIPTION** TITLE SHEET GN-1 GROUNDING & GENERAL NOTES SITE PLAN EQUIPMENT LAYOUTS A-2 A-3 ANTENNA LAYOUTS A-4 TOWER ELEVATION A-5 DETAILS G-1 GROUNDING, ONE-LINE DIAGRAM & DETAILS S-1 MOUNT REINFORCING @ ± 126'-0" AGL





PLANS PREPARED BY:



24 QUEEN ST E BRAMPTON, ON 1 (519) 572-9995

– NO –	- DATE -	DESCRIPTION —	— BY —
A	09/29/16	FOR REVIEW	NPS
В	11/22/16	ADDED MOUNT REINFORCING	SE
0	11/30/16	ISSUE FOR CONSTRUCTION	SE

CT2218 PROSPECT BRADSHAW **TWR** FA CODE: 10035230

> 54 WATERBURY ROAD PROSPECT, CT 06712



TITLE SHEET

SHEET NUMBER:

T-1

GENERAL NOTES:

1. FOR THE PURPOSE OF CONSTRUCTION DRAWING, THE FOLLOWING DEFINITIONS SHALL APPLY:

CONTRACTOR - EMPIRE TELECOM

SUBCONTRACTOR - GENERAL CONTRACTOR (CONSTRUCTION)

NNFR - AT&T MOBILITY

OEM - ORIGINAL EQUIPMENT MANUFACTURER

- 2. PRIOR TO THE SUBMISSION OF BIDS, THE BIDDING SUBCONTRACTOR SHALL VISIT THE CELL SITE TO FAMILIARIZE WITH THE EXISTING CONDITIONS AND TO CONFIRM THAT THE WORK CAN BE ACCOMPLISHED AS SHOWN ON THE CONSTRUCTION DRAWINGS. ANY DISCREPANCY FOUND SHALL BE BROUGHT TO THE ATTENTION OF CONTRACTOR.
- 3. ALL MATERIALS FURNISHED AND INSTALLED SHALL BE IN STRICT ACCORDANCE WITH ALL APPLICABLE CODES, REGULATIONS, AND ORDINANCES. SUBCONTRACTOR SHALL ISSUE ALL APPROPRIATE NOTICES AND COMPLY WITH ALL LAWS, ORDINANCES, RULES, REGULATIONS, AND LAWFUL ORDERS OF ANY PUBLIC AUTHORITY REGARDING THE PERFORMANCE OF THE WORK. ALL WORK CARRIED OUT SHALL COMPLY WITH ALL APPLICABLE MUNICIPAL AND UTILITY COMPANY SPECIFICATIONS AND LOCAL JURISDICTIONAL CODES, ORDINANCES AND APPLICABLE REGULATIONS.
- 4. DRAWINGS PROVIDED HERE ARE NOT TO BE SCALED AND ARE INTENDED TO SHOW OUTLINE ONLY.
- 5. UNLESS NOTED OTHERWISE, THE WORK SHALL INCLUDE FURNISHING MATERIALS, EQUIPMENT, APPURTENANCES, AND LABOR NECESSARY TO COMPLETE ALL INSTALLATIONS AS INDICATED ON THE DRAWINGS.
- 6. THE SUBCONTRACTOR SHALL INSTALL ALL EQUIPMENT AND MATERIALS IN ACCORDANCE WITH MANUFACTURER'S RECOMMENDATIONS UNLESS SPECIFICALLY STATED OTHERWISE.
- 7. IF THE SPECIFIED EQUIPMENT CANNOT BE INSTALLED AS SHOWN ON THESE DRAWINGS, THE SUBCONTRACTOR SHALL PROPOSE AN ALTERNATIVE INSTALLATION SPACE FOR APPROVAL BY THE CONTRACTOR.
- 8. SUBCONTRACTOR SHALL DETERMINE ACTUAL ROUTING OF CONDUIT, POWER AND T1 CABLES, GROUNDING CABLES AS SHOWN ON THE POWER, GROUNDING AND TELCO PLAN DRAWING. SUBCONTRACTOR SHALL UTILIZE EXISTING TRAYS AND/OR SHALL ADD NEW TRAYS AS NECESSARY. SUBCONTRACTOR SHALL CONFIRM THE ACTUAL ROUTING WITH THE CONTRACTOR. ROUTING OF TRENCHING SHALL BE APPROVED BY CONTRACTOR.
- 9. THE SUBCONTRACTOR SHALL PROTECT EXISTING IMPROVEMENTS, PAVEMENTS, CURBS, LANDSCAPING AND STRUCTURES. ANY DAMAGED PART SHALL BE REPAIRED AT SUBCONTRACTOR'S EXPENSE TO THE SATISFACTION OF OWNER.
- 10. SUBCONTRACTOR SHALL LEGALLY AND PROPERLY DISPOSE OFF ALL SCR1 'AP MATERIALS SUCH AS COAXIAL CABLES AND OTHER ITEMS REMOVED FROM THE EXISTING FACILITY. ANTENNAS REMOVED SHALL BE RETURNED TO THE OWNER'S DESIGNATED LOCATION.
- 11. SUBCONTRACTOR SHALL LEAVE PREMISES IN CLEAN CONDITION.
- 12. ALL CONCRETE REPAIR WORK SHALL BE DONE IN ACCORDANCE WITH AMERICAN CONCRETE INSTITUTE (ACI) 301.
- 13. ANY NEW CONCRETE NEEDED FOR THE CONSTRUCTION SHALL HAVE 4000 PSI STRENGTH AT 28 DAYS UNLESS OTHERWISE SPECIFIED. ALL CONCRETING WORK SHALL BE DONE IN ACCORDANCE WITH ACI 318 CODE REQUIREMENTS.
- 14. ALL STRUCTURAL STEEL WORK SHALL BE DETAILED, FABRICATED AND ERECTED IN ACCORDANCE WITH AISC SPECIFICATIONS. ALL STRUCTURAL STEEL SHALL BE ASTM A36 (Fy=36 ksi).
 ALL STEEL EXPOSED TO WEATHER SHALL BE HOT DIPPED GALVANIZED. TOUCH UP ALL SCRATCHES AND OTHER MARKS IN THE FIELD AFTER STEEL IS ERECTED USING A COMPATIBLE TINC RICH PAINT.
- 15. CONSTRUCTION SHALL COMPLY WITH SPECIFICATION 25741-000-3APS-AOOZ-00002, "GENERAL CONSTRUCTION SERVICES FOR CONSTRUCTION OF AT&T MOBILITY SITES."
- 16. SUBCONTRACTOR SHALL VERIFY ALL EXISTING DIMENSIONS AND CONDITIONS PRIOR TO COMMENCING ANY WORK, ALL DIMENSIONS OF EXISTING CONSTRUCTION SHOWN ON THE DRAWINGS MUST BE VERIFIED. SUBCONTRACTOR SHALL NOTIFY THE CONTRACTOR OF ANY DISCREPANCIES PRIOR TO ORDERING MATERIAL OR PROCEEDING WITH CONSTRUCTION.
- 17. THE EXISTING CELL SITE IS IN FULL COMMERCIAL OPERATION. ANY CONSTRUCTION WORK BY SUBCONTRACTOR SHALL NOT DISRUPT THE EXISTING NORMAL OPERATION. ANY WORK ON EXISTING EQUIPMENT MUST BE COORDINATED WITH CONTRACTOR. ALSO, WORK MAY NEED TO BE SCHEDULED FOR AN APPROPRIATE MAINTENANCE WINDOW USUALLY IN LOW TRAFFIC PERIODS AFTER MIDNIGHT.
- 18. SINCE THE CELL SITE MAY BE ACTIVE, ALL SAFETY PRECAUTIONS MUST BE TAKEN WHEN WORKING AROUND HIGH LEVELS OF ELECTROMAGNETIC RADIATION. EQUIPMENT SHOULD BE SHUTDOWN PRIOR TO PERFORMING ANY WORK THAT COULD EXPOSE THE WORKERS TO DANGER. PERSONAL RF EXPOSURE MONITORS ARE REQUIRED TO BE WORN TO ALERT OF ANY DANGEROUS EXPOSURE LEVELS.
- 19. SUBCONTRACTOR'S WORK SHALL COMPLY WITH ALL APPLICABLE NATIONAL, STATE, AND LOCAL CODES AS ADOPTED BY THE LOCAL AUTHORITY HAVING JURISDICTION (AHJ) FOR THE LOCATION. THE EDITION OF THE AHJ ADOPTED CODES AND STANDARDS IN EFFECT ON THE DATE OF CONTRACT AWARD SHALL GOVERN THE DESIGN.
 - INTERNATIONAL BUILDING CODE: IBC 2009 WITH LOCAL & COUNTY AMENDMENTS
 - NATIONAL ELECTRICAL CODE: NEC 2011 WITH LOCAL & COUNTY AMENDMENTS
- FIRE/LIFE SAFETY CODE: NFPA-101 2009 WITH LOCAL & COUNTY AMENDMENTS
- 20. SUBCONTRACTOR'S WORK SHALL COMPLY WITH THE LATEST EDITION OF THE FOLLOWING STANDARDS:
 - AMERICAN CONCRETE INSTITUTE (ACI) 318, BUILDING CODE REQUIREMENTS FOR STRUCTURAL CONCRETE
 - AMERICAN INSTITUTE OF STEEL CONSTRUCTION (AISC), MANUAL OF STEEL CONSTRUCTION, THIRTEENTH EDITION
 - AMERICAN SOCIETY OF TESTING OF MATERIALS, ASTM
 - TELECOMMUNICATIONS INDUSTRY ASSOCIATION (ANSI/TIA-222-G-1), STRUCTURAL STANDARDS FOR STEEL ANTENNA TOWER AND ANTENNA SUPPORTING STRUCTURES:
 - TIA 607, COMMERCIAL BUILDING GROUNDING AND BONDING REQUIREMENTS FOR
 TELECOMMUNICATIONS
 - OCCUPATIONAL SAFETY AND HEALTH ADMINISTRATION, OSHA
 - INSTITUTE FOR ELECTRICAL AND ELECTRONICS ENGINEERS (IEEE) 81, GUIDE FOR MEASURING EARTH RESISTIVELY, GROUND IMPEDANCE, AND EARTH SURFACE POTENTIALS OF A GROUND SYSTEM IEEE 1100 (1999) RECOMMENDED PRACTICE FOR POWERING AND GROUNDING OF ELECTRONIC EQUIPMENT
 - TELCORDIA GR-1503, COAXIAL CABLE CONNECTIONS
- 21. FOR ANY CONFLICTS BETWEEN SECTIONS OF LISTED CODES AND STANDARDS REGARDING MATERIAL, METHODS OF CONSTRUCTION, OR OTHER REQUIREMENTS, THE MOST RESTRICTIVE REQUIREMENT SHALL GOVERN. WHERE THERE IS CONFLICT BETWEEN A GENERAL REQUIREMENT AND A SPECIFIC REQUIREMENT, THE SPECIFIC REQUIREMENT SHALL GOVERN.

GROUNDING NOTES:

- 1. THE SUBCONTRACTOR SHALL REVIEW AND INSPECT THE EXISTING FACILITY GROUNDING SYSTEM AND LIGHTNING PROTECTION SYSTEM (AS DESIGNED AND INSTALLED) FOR STRICT COMPLIANCE WITH THE NEC (AS ADOPTED BY THE AHJ), THE SITE-SPECIFIC (UL, LPI, OR NFPA) LIGHTNING PROTECTION CODE, AND GENERAL COMPLIANCE WITH TELCORDIA AND TIA GROUNDING STANDARDS. THE SUBCONTRACTOR SHALL REPORT ANY VIOLATIONS OR ADVERSE FINDINGS TO THE CONTRACTOR FOR RESOLUTION.
- ALL GROUND ELECTRODE SYSTEMS (INCLUDING TELECOMMUNICATION, RADIO, LIGHTNING PROTECTION, AND
 AC POWER GES'S) SHALL BE BONDED TOGETHER, AT OR BELOW GRADE, BY TWO OR MORE COPPER
 BONDING CONDUCTORS IN ACCORDANCE WITH THE NEC.
- 3. THE SUBCONTRACTOR SHALL PERFORM IEEE FALL-OF-POTENTIAL RESISTANCE TO EARTH TESTING (PER IEEE 1100 AND 81) FOR NEW GROUND ELECTRODE SYSTEMS. THE SUBCONTRACTOR SHALL FURNISH AND INSTALL SUPPLEMENTAL GROUND ELECTRODES AS NEEDED TO ACHIEVE A TEST RESULT OF 5 OHMS OR LESS. TESTS SHALL BE PERFORMED IN ACCORDANCE WITH 25471-000-3PS-EG00-0001, DESIGN & TESTING OF FACILITY GROUNDING FOR CELL SITES.
- 4. METAL RACEWAY SHALL NOT BE USED AS THE NEC REQUIRED EQUIPMENT GROUND CONDUCTOR. STRANDED COPPER CONDUCTORS WITH GREEN INSULATION, SIZED IN ACCORDANCE WITH THE NEC, SHALL BE FURNISHED AND INSTALLED WITH THE POWER CIRCUITS TO BTS EQUIPMENT.
- EACH BTS CABINET FRAME SHALL BE DIRECTLY CONNECTED TO THE MASTER GROUND BAR WITH GREEN INSULATED SUPPLEMENTAL EQUIPMENT GROUND WIRES, 6 AWG STRANDED COPPER OR LARGER FOR INDOOR BTS: 2 AWG STRANDED COPPER FOR OUTDOOR BTS.
- 6. EXOTHERMIC WELDS SHALL BE USED FOR ALL GROUNDING CONNECTIONS BELOW GRADE.
- APPROVED ANTIOXIDANT COATINGS (I.E., CONDUCTIVE GEL OR PASTE) SHALL BE USED ON ALL
 COMPRESSION AND BOLTED GROUND CONNECTIONS.
- 8. ICE BRIDGE BONDING CONDUCTORS SHALL BE EXOTHERMICALLY BONDED OR BOLTED WITH STAINLESS STEEL HARDWARE TO THE BRIDGE AND THE TOWER GROUND BAR.
- ALUMINUM CONDUCTOR OR COPPER CLAD STEEL CONDUCTOR SHALL NOT BE USED FOR GROUNDING CONNECTIONS.
- 10. MISCELLANEOUS ELECTRICAL AND NON-ELECTRICAL METAL BOXES, FRAMES AND SUPPORTS SHALL BE BONDED TO THE GROUND RING, IN ACCORDANCE WITH THE NEC.
- 11. METAL CONDUIT AND TRAY SHALL BE GROUNDED AND MADE ELECTRICALLY CONTINUOUS WITH LISTED BONDING FITTINGS OR BY BONDING ACROSS THE DISCONTINUITY WITH 6 AWG COPPER WIRE UL APPROVED GROUNDING TYPE CONDUIT CLAMPS.
- 12. GROUND CONDUCTORS USED IN THE FACILITY GROUND AND LIGHTNING PROTECTION SYSTEMS SHALL NOT BE ROUTED THROUGH METALLIC OBJECTS THAT FORM A RING AROUND THE CONDUCTOR, SUCH AS METALLIC CONDUITS, METAL SUPPORT CLIPS OR SLEEVES THROUGH WALLS OR FLOORS. WHEN IT IS REQUIRED TO BE HOUSED IN CONDUIT TO MEET CODE REQUIREMENTS OR LOCAL CONDITIONS, NON-METALLIC MATERIAL SUCH AS PVC PLASTIC CONDUIT SHALL BE USED. WHERE USE OF METAL CONDUIT IS UNAVOIDABLE (E.G., NON-METALLIC CONDUIT PROHIBITED BY LOCAL CODE) THE GROUND CONDUCTOR SHALL BE BONDED TO EACH END OF THE METAL CONDUIT.
- 13. ALL TOWER GROUNDING SYSTEMS SHALL COMPLY WITH THE REQUIREMENTS OF ANSI/TIA 222. FOR TOWERS BEING BUILT TO REV-G OF THE STANDARD, THE WIRE SIZE OF THE BURIED GROUND RING AND CONNECTIONS BETWEEN THE TOWER AND THE BURIED GROUND RING SHALL BE CHANGED FROM 2 AWG TO 2/0 AWG. IN ADDITION, THE MINIMUM LENGTH OF THE GROUND RODS SHALL BE INCREASED FROM EIGHT FEET (8') TO TEN FEET (10').
- 14. ALL NEW STRUCTURES WITH A FOUNDATION AND/OR FOOTING HAVING 20 FT. OR MORE ½" OR GREATER ELECTRICALLY CONDUCTIVE REINFORCING STEEL MUST HAVE IT BONDED TO THE GROUND RING USING AN EXOTHERMIC WELD CONNECTION USING #2 AWG SOLID TINNED COPPER GROUND WIRE, PER NEC 250.50.



1355 WEST UNIVERSITY DRIVE MESA, AZ 85201-5419



PLANS PREPARED BY:

Trylon

24 QUEEN ST E BRAMPTON, ON 1 (519) 572-9995

_NO -	NO. DATE DESCRIPTION BY					
A .	09/29/16	FOR REVIEW	NPS			
В	11/22/16	ADDED MOUNT REINFORCING	SE			
0	11/30/16	ISSUE FOR CONSTRUCTION	SE			

CT2218 PROSPECT BRADSHAW

SITE INFORMATION: -

TWR FA CODE: 10035230

54 WATERBURY ROAD PROSPECT, CT 06712




SHEET TITLE:

GENERAL NOTES & GROUNDING NOTES

SHEET NUMBER:

GN-1

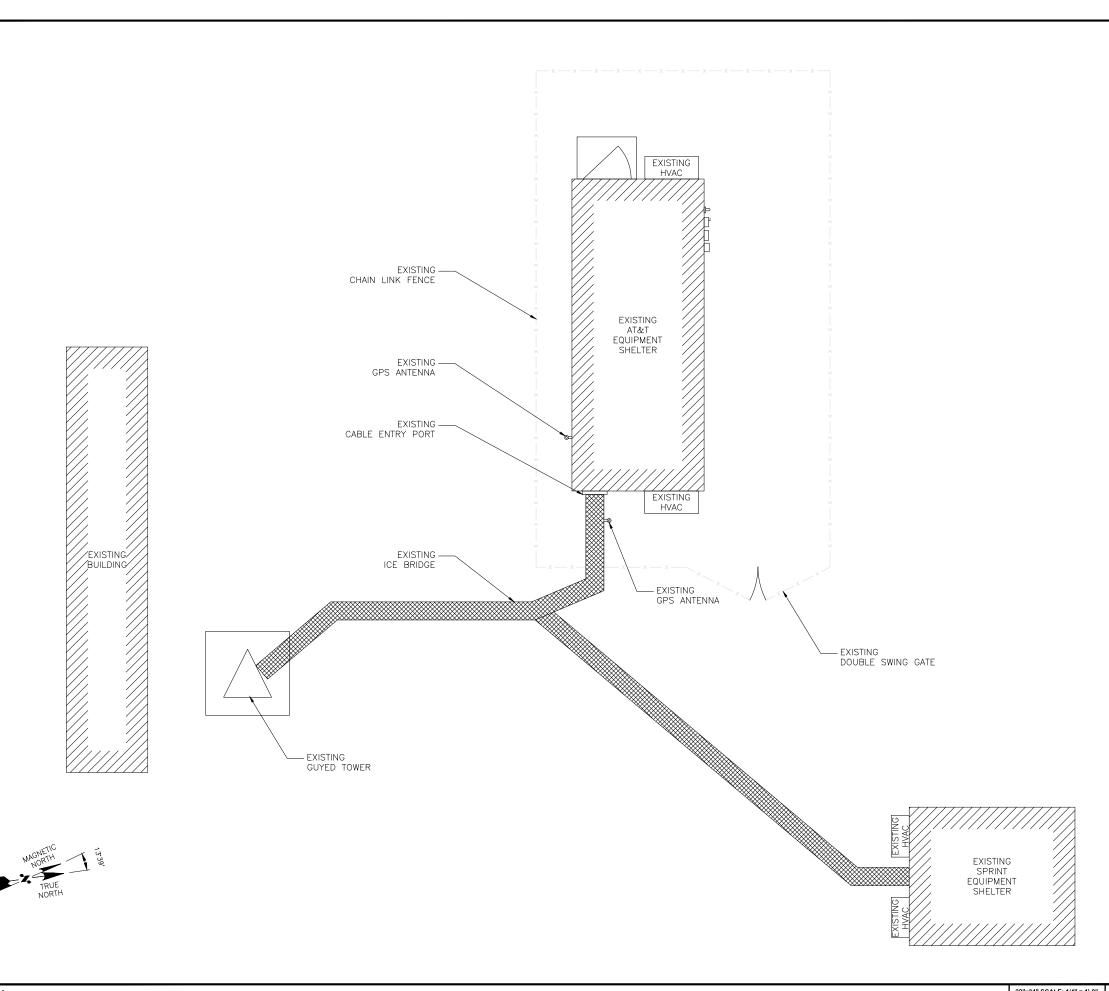





PLANS PREPARED BY: Trylon

24 QUEEN ST E BRAMPTON, ON 1 (519) 572-9995

I -	-NO	DATE -	- DESCRIPTION -	— BY —
Ш	А	09/29/16	FOR REVIEW	NPS
	В	11/22/16	ADDED MOUNT REINFORCING	SE
	0	11/30/16	ISSUE FOR CONSTRUCTION	SE
Ш				
П				

SITE INFORMATION:

CT2218
PROSPECT BRADSHAW

TWR FA CODE: 10035230

54 WATERBURY ROAD PROSPECT, CT 06712



SHEET TITLE:


SITE PLAN

SHEET NUMBER:

A-1

22"x34" SCALE: 1/4" = 1'-0" 11"x17" SCALE: 1/8" = 1'-0" 4' 3' 2' 1' 0"

ROOF PLAN

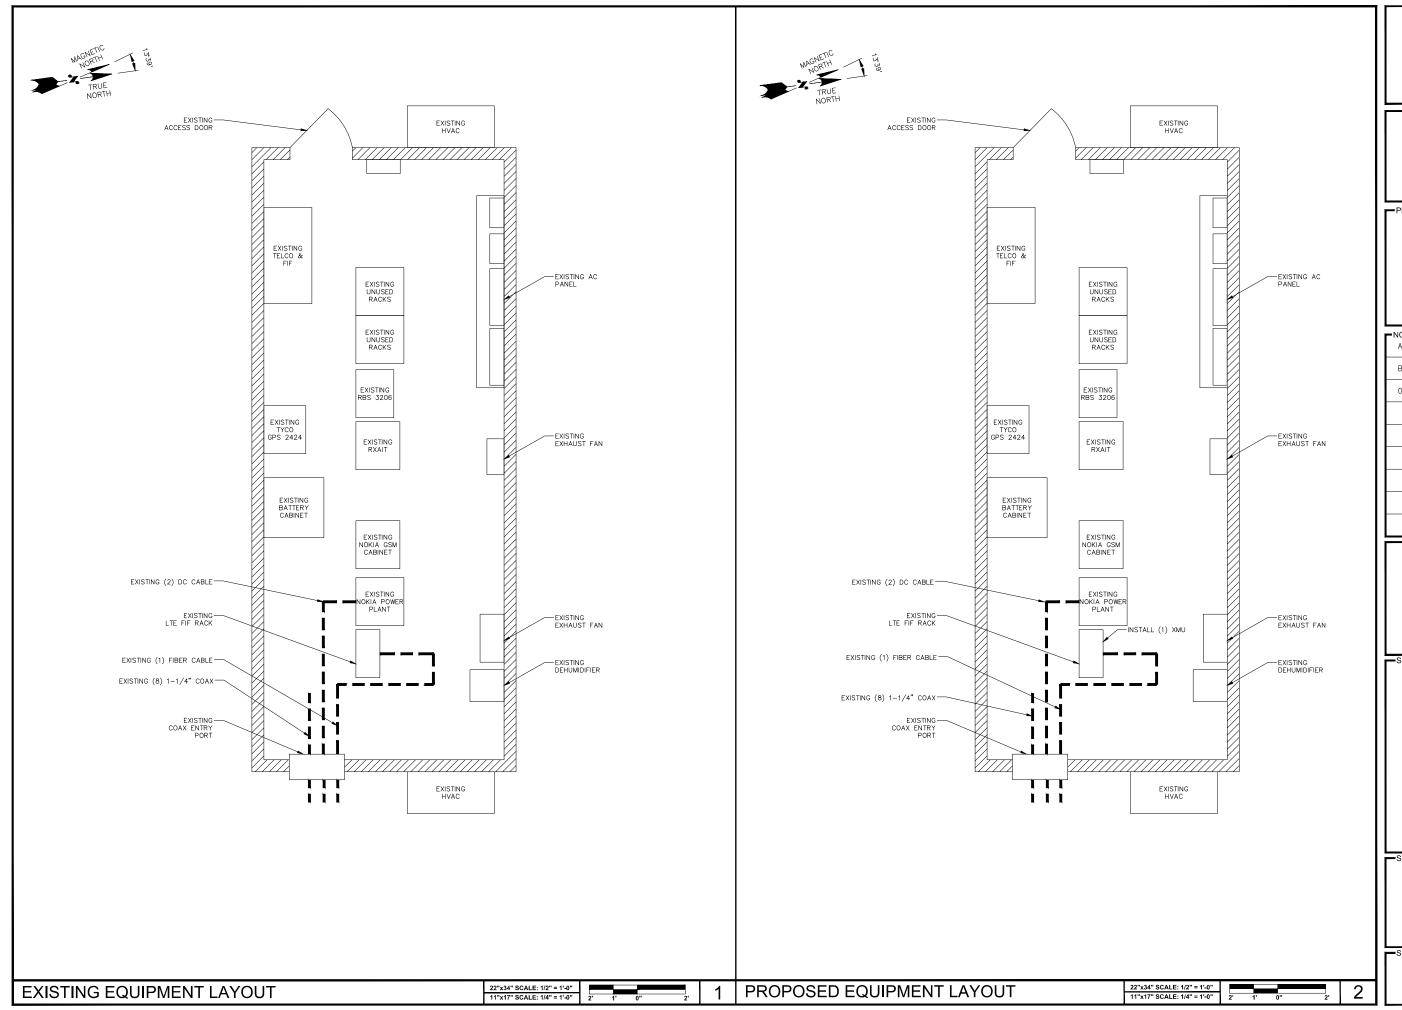







- NO	DATE -	— DESCRIPTION —	— BY —
Α	09/29/16	FOR REVIEW	NPS
В	11/22/16	ADDED MOUNT REINFORCING	SE
0	11/30/16	ISSUE FOR CONSTRUCTION	SE

CT2218 PROSPECT BRADSHAW TWR

SITE INFORMATION:

FA CODE: 10035230 54 WATERBURY ROAD PROSPECT, CT 06712




SHEET TITLE:=


EQUIPMENT LAYOUTS

-SHEET NUMBER:

A-2

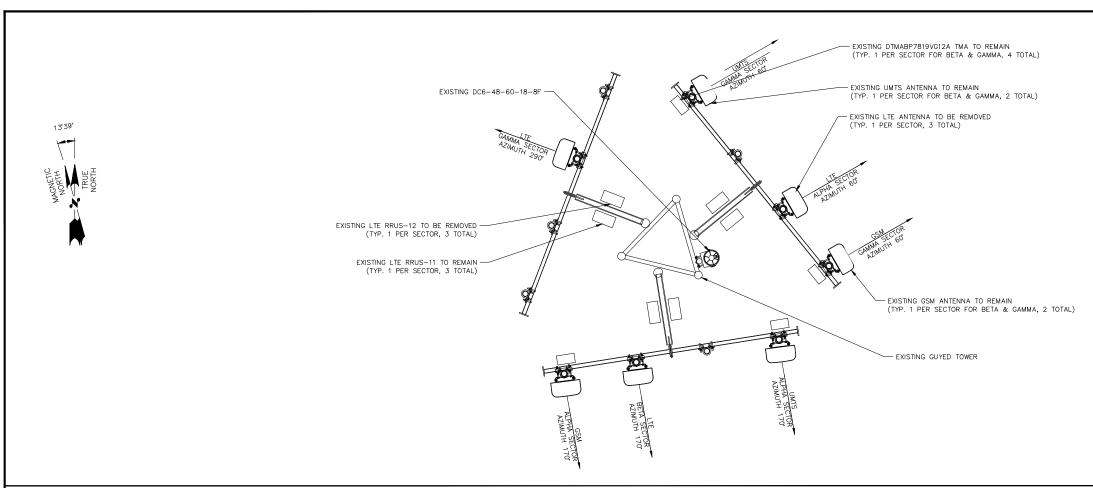

EXISTING ANTENNA LAYOUT

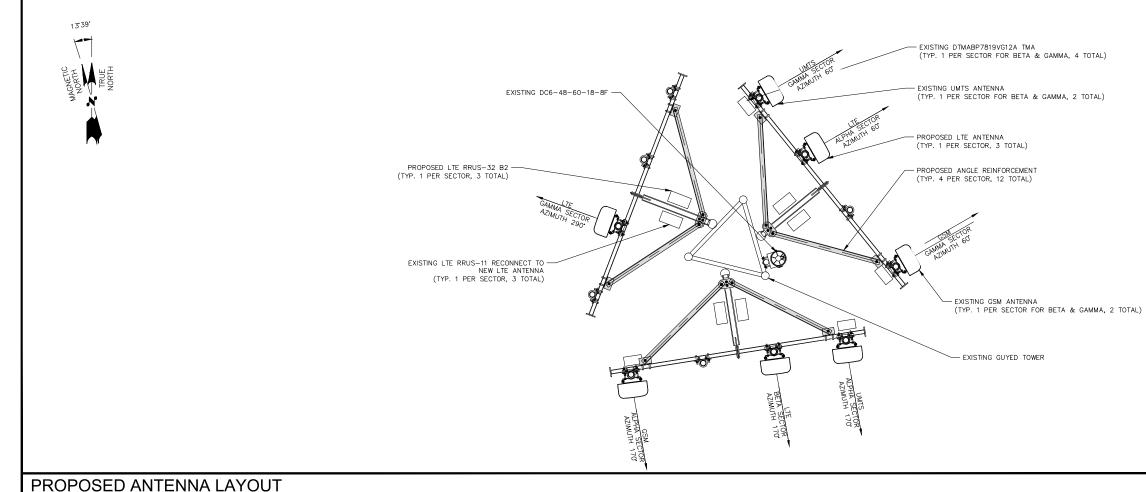



1355 WEST UNIVERSITY DRIVE MESA, AZ 85201-5419



Trylon


24 QUEEN ST E BRAMPTON, ON 1 (519) 572-9995

-NO -	DATE	- DESCRIPTION -	BY
Α.	09/29/16	FOR REVIEW	NPS
В	11/22/16	ADDED MOUNT REINFORCING	SE
0	11/30/16	ISSUE FOR CONSTRUCTION	SE

SITE INFORMATION:

CT2218 PROSPECT BRADSHAW TWR

FA CODE: 10035230 54 WATERBURY ROAD PROSPECT, CT 06712

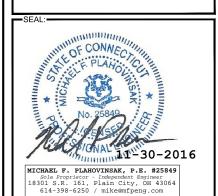


SHEET TITLE:

ANTENNA LAYOUTS

-SHEET NUMBER:-

NOT TO SCALE **A-3**

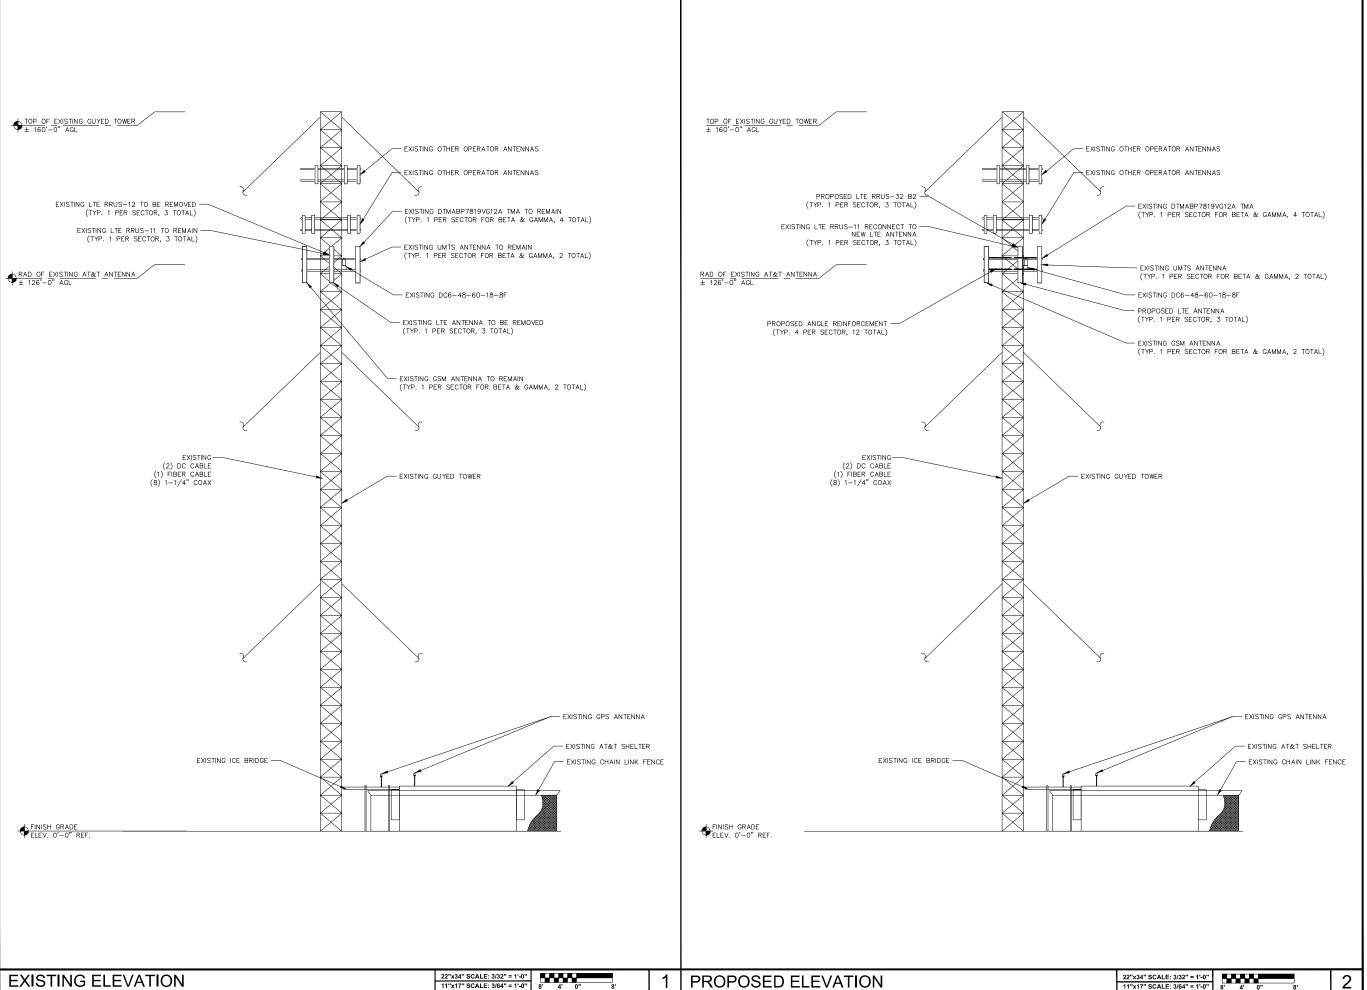







Ι'						
	– NO. – A	09/29/16	FOR REVIEW	NPS		
	В	11/22/16	ADDED MOUNT REINFORCING	SE		
	0	11/30/16	ISSUE FOR CONSTRUCTION	SE		

CT2218 PROSPECT BRADSHAW **TWR**

SITE INFORMATION:

FA CODE: 10035230

54 WATERBURY ROAD PROSPECT, CT 06712





TOWER ELEVATION

SHEET NUMBER:

A-4



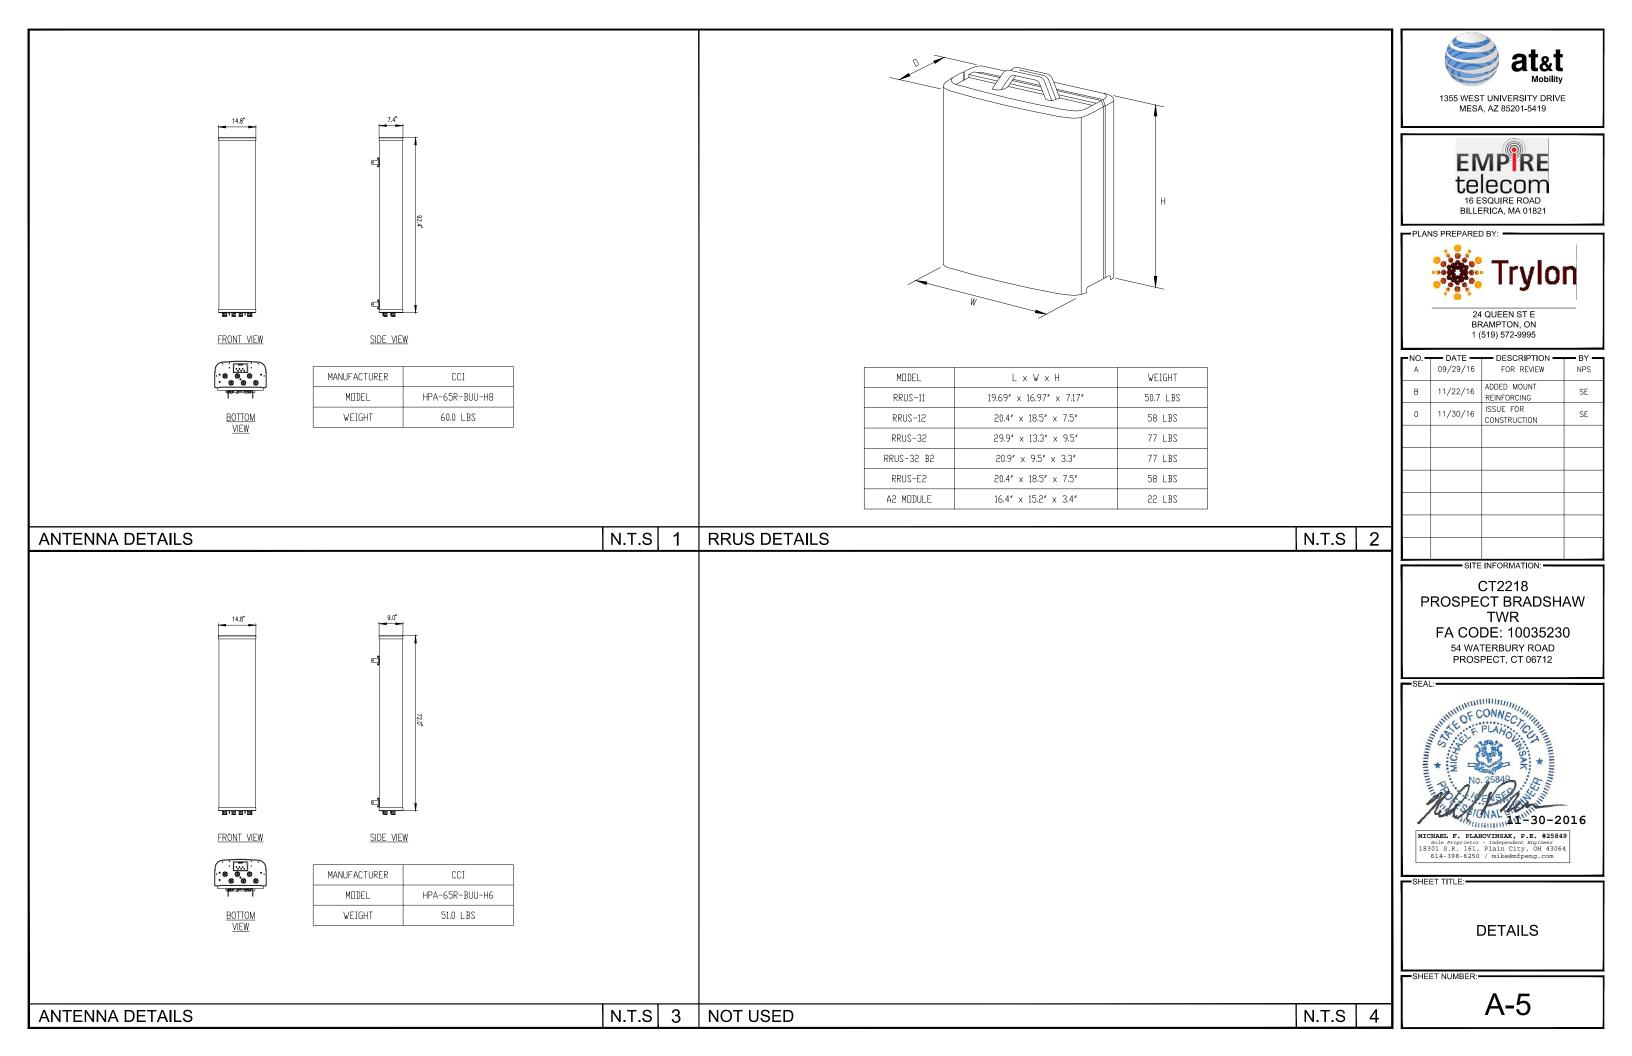

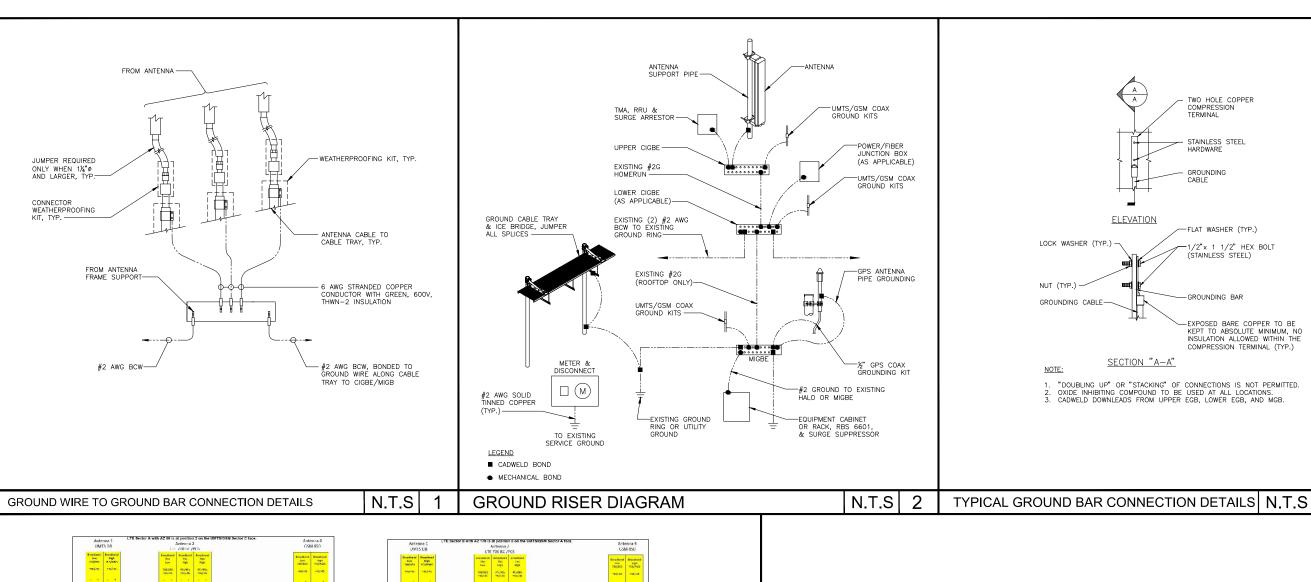


new

LTE ONLY ON

Sector 290

PCU

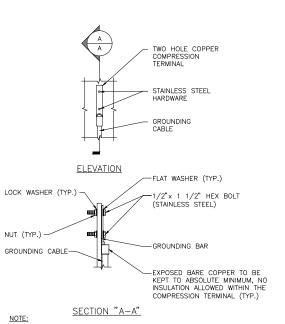

"DOUBLING UP" OR "STACKING" OF CONNECTIONS IS NOT PERMITTED.
 OXIDE INHIBITING COMPOUND TO BE USED AT ALL LOCATIONS.
 CADWELD DOWNLEADS FROM UPPER EGB, LOWER EGB, AND MGB.

at&t 1355 WEST UNIVERSITY DRIVE MESA, AZ 85201-5419

> **EMP**RE telecom 16 ESQUIRE ROAD BILLERICA, MA 01821



		– NO. –	DATE	DESCRIPTION — FOR REVIEW	— BY — NPS
		В	11/22/16	ADDED MOUNT REINFORCING	SE
		0	11/30/16	ISSUE FOR CONSTRUCTION	SE
┪	-				
┨					

SITE INFORMATION: CT2218 PROSPECT BRADSHAW

TWR FA CODE: 10035230

54 WATERBURY ROAD PROSPECT, CT 06712




-SHEET TITLE:-

GROUNDING, ONE-LINE **DIAGRAM & DETAILS**

-SHEET NUMBER:-

G-1

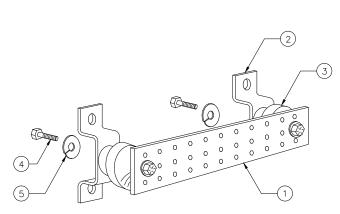

ITEM ND. QTY. DESC		DESCRIPTION
1	1	SOLID GROUND BAR (20'x 4'x ¼')
2	2	WALL MOUNTING BRACKET
3 2 INSULATORS		INSULATORS
4	4	%"-11×1" H.H.C.S.
5	4	%′ LOCK WASHER

NOTES:

NOTE:

EACH GROUND CONDUCTOR TERMINATING ON ANY GROUND BAR SHALL HAVE AN IDENTIFICATION TAG ATTACHED AT EACH END THAT WILL IDENTIFY ITS ORIGIN AND DESTINATION

- SECTION "P" SURGE PRODUCERS

 CABLE ENTRY PORTS (HATCH PLATES) (#2)


 GENERATOR FRAMEWORK (IF AVAILABLE) (#2)


 TELCO GROUND BAR
- IELCO GROUND BAR
 COMMERCIAL POWER COMMON NEUTRAL/GROUND BOND (#2)
 +24V POWER SUPPLY RETURN BAR (#2)
 -48V POWER SUPPLY RETURN BAR (#2)
 RECTIFIER FRAMES

- SECTION "A" SURGE ABSORBERS
 INTERIOR GROUND RING (#2)
 EXTERNAL EARTH GROUND FIELD (BURIED GROUND RING) (#2)
 METALLIC COLD WATER PIPE (IF AVAILABLE) (#2)
- BUILDING STEEL (IF AVAILABLE) (#2)

PLUMBING DIAGRAM N.T.S N.T.S 5 **GROUND BAR DETAILS**

MCD/CCU

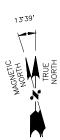

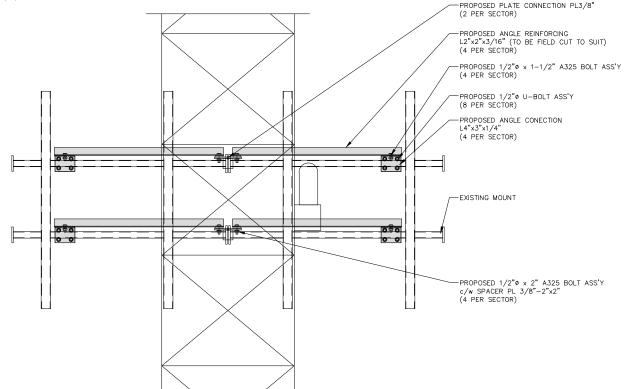

ELEVATION VIEW

	BILL OF MATERIALS					
NO.	QTY.	DIMENSIONS	DESCRIPTION	PART NO.		
1	6	PL 3/8"-6-3/4"x3-3/4"	PLATE CONNECTION	3.969.0752.001		
2	12	L2"x2"x3/16"-53"	ANGLE REINFORCING	3.969.0752.002		
3	12	L4"x3"x1/4"-5"	ANGLE CONECTION	3.969.0752.003		
4	24	1/2"ø U-BOLT ASS'Y	FOR 1-3/4"ø BAR	3.963.0001.005		
5	12	1/2"ø	1/2"ø x 2" A325 BOLT ASS'Y	1202023		
6	12	1/2"ø	1/2"ø x 1-1/2" A325 BOLT ASS'Y	1202021		
7	12	1/2"ø	1/2"ø x 3-3/4" A325 BOLT ASS'Y	1202030		
8	12	PL 3/8"-2"x2"	SPACER	3.963.0700.006		







1 (519) 572-9995

I NO. -	DATE 09/29/16	FOR REVIEW	BY -
В	11/22/16	ADDED MOUNT REINFORCING	SE
0	11/30/16	ISSUE FOR CONSTRUCTION	SE

CT2218 PROSPECT BRADSHAW TWR

SITE INFORMATION: -

FA CODE: 10035230 54 WATERBURY ROAD PROSPECT, CT 06712




SHEET TITLE:

MOUNT REINFORCING © ± 126'-0" AGL

SHEET NUMBER:

S-1

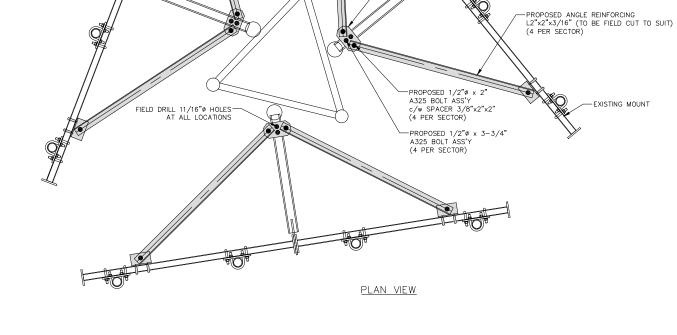

PROPOSED 1/2"ø U-BOLT ASS'Y (8 PER SECTOR)

-PROPOSED ANGLE CONECTION L4"x3"x1/4"

-PROPOSED 1/2"ø x 1-1/2" A325 BOLT ASS'Y (4 PER SECTOR)

-PROPOSED PLATE CONNECTION PL3/8" (2 PER SECTOR)