

Northeast Site Solutions
Victoria Masse
5 Melrose Drive
Farmington, CT 06032
victoria@northeastsitesolutions.com

February 1, 2024

Members of the Siting Council Connecticut Siting Council Ten Franklin Square New Britain, CT 06051

RE: Notice of Exempt Modification

33 Keegan Road (a/k/a 55 Keegan Road), Plymouth, CT 06782

Latitude: 41.66190500 N Longitude: -73.04573400 W Site#: CTNH584A NHP

Dear Ms. Bachman:

T-Mobile currently maintains nine (9) antennas at the 130-foot mount on the existing 140-foot monopole tower located at 33 Keegan Road in Plymouth. The property is owned by Steven A Westall and tower is owned by Verizon. T-Mobile now intends to add a 48Kw generator on an existing concrete pad within the existing compound.

Planned Modifications:

Ground work only-Install New:

- (1) GENERAC RD 48KW AC DIESEL GENERATOR 233-gallon double walled self-contained tank with fuel sensor. Requires two
- (2) 12-minute run cycles bi-weekly.

The facility was approved by the Connecticut Siting Council in TS-T-MOBILE-111-161114 on December 12, 2016. Please see attached.



Please accept this letter as notification pursuant to Regulations of Connecticut State Agencies §16-50j-73, for construction that constitutes an exempt modification pursuant to R.C.S.A. § 16-50j-72(b)(2). In accordance with R.S.C.A. § 16-50j-73, a copy of this letter is being sent to Mayor David V. Merchant, Mayor and Scott Eisenlohr ZEO, Zoning & Wetlands Enforcement Officer, as well as the property owner and tower owner.

The planned modifications to the facility fall squarely within those activities explicitly provided for in R.C.S;A. § 16-50j-72(b)(2).

- 1. The proposed modifications will not result in an increase in the height of the existing structure.
- 2. The proposed modifications will not require the extension of the site boundary.
- 3. The proposed modifications will not increase noise levels at the facility by six decibels or more, or to levels that exceed state and local criteria.
- 4. The operation of the replacement antennas will not increase radio frequency emissions at the facility to a level at or above the Federal Communications Commission safety standard.
- 5. The proposed modifications will not cause a change or alteration in the physical or environmental characteristics of the site.
- 6. The existing structure and its foundation can support the proposed loading.

For the foregoing reasons, T-Mobile respectfully submits that the proposed modifications to the above referenced telecommunications facility constitute an exempt modification under R.C.S.A. § 16-50j-72(b)(2).

Sincerely,

Victoria Masse

Mobile: 860-306-2326 Fax: 413-521-0558

Office: 5 Melrose Drive, Farmington, CT 06032 Email: victoria@northeastsitesolutions.com



Attachments

Cc:

David V. Merchant, Mayor Town of Plymouth 80 Main Street Terryville, CT 06786

Scott Eisenlohr ZEO, Zoning & Wetlands Enforcement Officer Town of Plymouth 80 Main Street Terryville, CT 06786

Steven A Westall, Property Owner 41 Keegan Road Plymouth, CT 06782

Verizon Wireless, Tower Owners 20 Alexander Drive Wallingford, CT 06492

Exhibit A

STATE OF CONNECTICUT



CONNECTICUT SITING COUNCIL

Ten Franklin Square, New Britain, CT 06051 Phone: (860) 827-2935 Fax: (860) 827-2950 E-Mail: siting.council@ct.gov www.ct.gov/csc

December 12, 2016

Matthew Bandle Site Acquisition Project Manager Vertical Development 20 Commercial Street Branford, CT 06405

RE: TS-T-MOBILE-111-161114 - T-Mobile request for an order to approve tower sharing at an existing telecommunications facility located at 33 Keegan Road, Plymouth, Connecticut.

Dear Mr. Bandle:

At a public meeting held on December 8, 2016, the Connecticut Siting Council (Council) ruled that the shared use of this existing tower site is technically, legally, environmentally, and economically feasible and meets public safety concerns, and therefore, in compliance with General Statutes § 16-50aa, the Council has ordered the shared use of this facility to avoid the unnecessary proliferation of tower structures with the following conditions:

- 1. Any deviation from the proposed installation as specified in the original tower share request and supporting materials with the Council shall render this decision invalid;
- 2. Any material changes to the proposed installation as specified in the original tower share request and supporting materials filed with the Council shall require an explicit request for modification to the Council pursuant to Connecticut General Statutes § 16-50aa, including all relevant information regarding the proposed change with cumulative worst-case modeling of radio frequency exposure at the closest point of uncontrolled access to the tower base, consistent with Federal Communications Commission, Office of Engineering and Technology, Bulletin 65;
- 3. Not less than 45 days after completion of the proposed installation, the Council shall be notified in writing that the installation has been completed;
- 4. Any nonfunctioning antenna and associated antenna mounting equipment on this facility owned and operated by T-Mobile shall be removed within 60 days of the date the antenna ceased to function;
- 5. The validity of this action shall expire one year from the date of this letter; and
- 6. The applicant may file a request for an extension of time beyond the one year deadline provided that such request is submitted to the Council not less than 60 days prior to the expiration.

This decision is under the exclusive jurisdiction of the Council and applies only to this request for tower sharing dated November 10, 2016 and additional information received on December 5, 2016. This facility has been carefully modeled to ensure that radio frequency emissions are conservatively below State and federal standards applicable to the frequencies now used on this tower. Any deviation from the approved tower sharing request is enforceable under the provisions of Connecticut General Statutes § 16-50u.



The proposed shared use is to be implemented as specified in your letter dated November 10, 2016, including the placement of all necessary equipment and shelters within the tower compound.

Please be advised that the validity of this action shall expire one year from the date of this letter.

Thank you for your attention and cooperation.


Very truly yours,

Robert Stein Chairman

RS/FOC/lm

c: The Honorable David V. Merchant, Mayor, Town of Plymouth
Margus T. Laan, AICP, Director of Planning & Economic Development, Town of Plymouth
Kenneth C. Baldwin, Esq., Robinson & Cole LLP
Steven A. Westall, property owner

Exhibit B

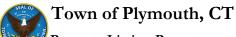

Property Listing Report

Map Block Lot

064-065-016A-1

Building #

Unique Identifier

00018250

Property Information

Property Location	33 KEEGAN RD
Mailing Adduse	41 KEEGAN RD
Mailing Address	PLYMOUTH CT 06782
Land Use	Residential Vacant Land
Zoning Code	R-40
Neighborhood	103

Owner	WESTALL STEVEN A
Co-Owner	
Book / Page	0171/0948
Land Class	Vacant Land
Census Tract	4254
Acreage	2.25

Valuation Summary

(Assessed value = 70% of Appraised Value)

Item	Appraised	Assessed
Buildings	0	0
Outbuildings	272900	191030
Land	63400	44380
Total	336300	235410

Utility Information

Cunty Inform	iation .
Electric	No
Gas	No
Sewer	No
Public Water	No
Well	No





Primary Construction Details

Year Built	
Building Desc.	
Building Style	
Stories	
Exterior Walls	
Exterior Walls 2	
Interior Walls	
Interior Walls 2	
Interior Floors 1	
Interior Floors 2	

Heating Fuel	
Heating Type	
AC Type	
Bedrooms	
Full Bathrooms	
Half Bathrooms	
Extra Fixtures	
Total Rooms	
Bath Style	
Kitchen Style	
Occupancy	

Building Use	
Building Condition	
Frame Type	
Fireplaces	
Bsmt Gar	
Fin Bsmt Area	
Fin Bsmt Quality	
Building Grade	
Roof Style	
Roof Cover	
eport Created On	1/29/2024

Report Created On

Town of Plymouth, CT

Property Listing Report	Map Block Lot	064-065-016A-1 Bui	Unique Ident	ifier 00018250
Detached Outbuildings				
Туре	Description	Area (sq ft)	Condition	Year Built
Shed	Frame	200	Average	2014
Tower	Cell Tower	180	Average	2014
Attached Extra Features				
Туре	Description	Area (sq ft)	Condition	Year Built
Sales History				
Owner of Record		Book/ Page	Sale Date	Sale Price

Plymouth

Card No: **Unique ID:** 00018100

Location:	55 KE	EGAN RD			IVIa	p ia: 054-0	65-016	Zone	: R-40	ושטן ט	te Printea:	2/1/2024
Neig						ighborhood:	103			Las	st Update:	2/1/2024
		Owner	Of Record			Volume/Pag	e Date		Sales Ty	уре	Valid	Sale Price
WESTALL STEVE	N A					0171/0948						
								Exempt				
					Prior Owner F	listory						
											\perp	
											++	
											+ +	
Permit Number	Date		Permit Description									
	5/13/2019 12/4/2009	REPLACE WOO	D DE									
	12/4/2009	FIRE PLACE INS	DE									
			Su	pplemental	Data					App	raised Value	
Census/Tract	4254			, , , , , , , , , , , , , , , , , , ,					Total	Land Value		140,000
Dev Map ID	L-5											140,000
GIS ID									Total	Building Value	9	0
Route	D2-E3								Total	Outbldg Value	•	0
District	0								Total	Market Value		140,000
Utilities												,
			Acres					State Iter	n Codes			
Land Type		Acres	490	Tota	al Value	Code				Quantity	Valu	
Res Vac Exces	ss	19.48	19.48			62-Forest				20.40		5.600
Res Vacant Ho	use Lot	0.92	0.92									
Total					140,000							
			nt History (Prior Years							ised Totals		
		2023	2022	2021	2020	2019		Acres	Value	Туре	Acre	s Value
Land		5,600	5,600	5,600	128,170	3,430	Forest	20.40	7956			
Building		0	0	0	0	0						
Outbuilding		0	0	0	0	0						
Cutbullullig		Ü	Ü	U	O	O O						
Total		5,600	5,600	5,600	3,430	3,430				Totals	20.40	7956
		-,	-,000	-,	Commen		Application	Date:		Expiration Dat	ie:	
11/19/2021 P/	A490 FORES	T.			Commen							
I												

Unique ID: ()	0010100		Plvmout	h		Car	rd No:	1 Of 1
				$\overline{}$		Cai	iu No.	1 01 1
ocation:	55 KEEGAN RI	<u>J</u>		_				
/lap ld:	054-065-016	,						
General	Description	Description	Area/C	ity				
Building Use Units Diverall Condition Class Stories Design (Style) Construction Fear Built Dercent Complete Finished Area								
	ndation	i						
Basement Area Finished Basement Barage Bays Dutside Entry Bump Pump		Attached Compo	nents					
	IVAC	Туре	Year Area					
cloors Attic Access Valls Valls Citchen Cond Citchen Cond Cixterior Coof Cover	nterior kterior al Features Count/Area	Total Building Value:						
		Type Year	Condition	Detached Comp Area/Qty	Type	Year	Condition	Area/Qty
	Summary ens Full Baths Half Baths		Continue	ловиц	1,750			riouvy

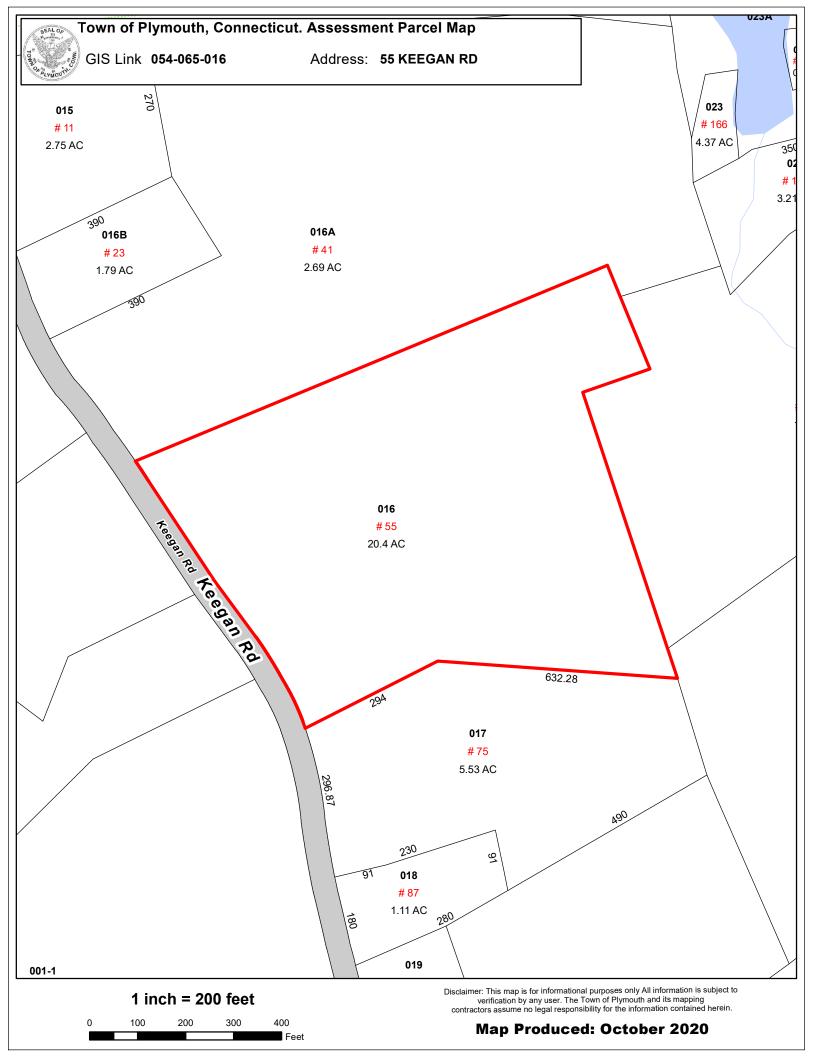


Exhibit C

SITE NAME: CTNH584A

33 KEEGAN RD PLYMOUTH, CT 06782 LITCHFIELD COUNTY

SITE NUMBER: CTNH584A (GENERATOR ADD)

GENERAL NOTES

THIS DOCUMENT IS THE CREATION, DESIGN, PROPERTY AND COPYRIGHTED WORK OF T-MOBILE. ANY DUPLICATION OR USE WITHOUT EXPRESS WRITTEN CONSENT IS STRICTLY PROHIBITED. DUPLICATION AND USE BY GOVERNMENT AGENCIES FOR THE PURPOSES OF CONDUCTING THEIR LAWFULLY AUTHORIZED REGULATORY AND ADMINISTRATIVE FUNCTIONS IS SPECIFICALLY ALLOWED.

THE FACILITY IS AN UNMANNED PRIVATE AND SECURED EQUIPMENT INSTALLATION. IT IS ONLY ACCESSED BY TRAINED TECHNICIANS FOR PERIODIC ROUTINE MAINTENANCE AND THEREFORE DOES NOT REQUIRE ANY WATER OR SANITARY SEWER SERVICE. THE FACILITY IS NOT GOVERNED BY REGULATIONS REQUIRING PUBLIC ACCESS PER ADA REQUIREMENTS.

CONTRACTOR SHALL VERIFY ALL PLANS AND EXISTING DIMENSIONS AND CONDITIONS ON THE JOB SITE AND SHALL IMMEDIATELY NOTIFY THE T-MOBILE NORTHEAST, LLC REPRESENTATIVE IN WRITING OF DISCREPANCIES BEFORE PROCEEDING WITH THE WORK OR BE RESPONSIBLE FOR SAME.



PROJECT SUMMARY

T-MOBILE NORTHEAST, LLC 35 GRIFFIN ROAD SOUTH BLOOMFIELD, CT 06002 APPLICANT:

UNMANNED TELECOMMUNICATIONS FACILITY T-MOBILE EQUIPMENT INSTALLATION SCOPE OF WORK:

BASED ON INFORMATION PROVIDED BY T-MOBILE, THIS TELECOMMUNICATIONS EQUIPMENT DEPLOYMENT IS AN EMGEDI FACILITY UNDER THE TAX RELIEF ACT OF 2012, 47 USC 1455(A), AND IS SUBJECT TO AN EXPEDITED ELIGIBLE FACILITIES REQUEST/REVIEW AND ZONING PRE-EMPTION FOR LOCAL DISCRETIONARY PERMITS (VARIANCE, SPECIAL PERMIT,

SITE PLAN REVIEW).

33 KEEGAN RD SITE ADDRESS:

PLYMOUTH, CT 06782

LATITUDE: 41° 39' 42.48" N

LONGITUDE: 73° 02' 44.63" W

PROPOSED USE:

DRAWING INDEX

JURISDICTION: TOWN OF PLYMOUTH, CT

EQUIPMENT ONE-LINE DIAGRAM

EXISTING USE: TELECOMMUNICATIONS FACILITY

APPROVALS PROJECT MANAGER DATE CONSTRUCTION DATE RF ENGINEERING DATE ZONING / SITE ACQ. DATE OPERATIONS DATE TOWER OWNER DATE

72 HOURS



UNDERGROUND SERVICE ALERT

SHEE DESCRIPTION REV. T NO. T-1 TITLE SHEET 1 GN-1 GENERAL NOTES A-1 COMPOUND & EQUIPMENT PLANS 1 A-2 DETAILS 1 GENERATOR DETAILS A-3

TELECOMMUNICATIONS FACILITY

T-MOBILE NORTHEAST LLC

BLOOMFIELD, CT 06002 OFFICE: (860) 648-1116







CHECKED BY:

DPH APPROVED BY:

SUBMITTALS DESCRIPTION 1 06/13/23 ISSUED FOR CONSTRUCTION TR 0 06/08/23 ISSUED FOR REVIEW

CTNH584A

CTNH584A

33 KEEGAN RD PLYMOUTH, CT 06782 LITCHFIELD COUNTY

TITLE SHEET

SHEET TITLE

(GENERATOR PROJECT)

| - 1

1

SHEET NUMBER

GROUNDING NOTES

- 1. THE SUBCONTRACTOR SHALL REVIEW AND INSPECT THE EXISTING FACILITY GROUNDING SYSTEM AND LIGHTNING PROTECTION SYSTEM (AS DESIGNED AND INSTALLED) FOR STRICT COMPLIANCE WITH THE NEC (AS ADOPTED BY THE AHJ), THE SITE-SPECIFIC (UL, LPI, OR NFPA) LIGHTING PROTECTION CODE, AND GENERAL COMPLIANCE WITH TELCORDIA AND TIA GROUNDING STANDARDS. THE SUBCONTRACTOR SHALL REPORT ANY VIOLATIONS OR ADVERSE FINDINGS TO THE CONTRACTOR FOR RESOLUTION.
- 2. ALL GROUND ELECTRODE SYSTEMS (INCLUDING TELECOMMUNICATION, RADIO, LIGHTNING PROTECTION, AND AC POWER GES'S) SHALL BE BONDED TOGETHER, AT OR BELOW GRADE, BY TWO OR MORE COPPER BONDING CONDUCTORS IN ACCORDANCE WITH THE NEC.
- 3. THE SUBCONTRACTOR SHALL PERFORM IEEE FALL-OF-POTENTIAL RESISTANCE TO EARTH TESTING (PER IEEE 1100 AND 81 STANDARDS) FOR NEW GROUND ELECTRODE SYSTEMS, THE SUBCONTRACTOR SHALL FURNISH AND INSTALL SUPPLEMENTAL GROUND ELECTRODES AS NEEDED TO ACHIEVE A TEST RESULT OF 5 OHMS OR LESS.
- 4. METAL RACEWAY SHALL NOT BE USED AS THE NEC REQUIRED EQUIPMENT GROUND CONDUCTOR. STRANDED COPPER CONDUCTORS WITH GREEN INSULATION, SIZED IN ACCORDANCE WITH THE NEC, SHALL BE FURNISHED AND INSTALLED WITH THE POWER CIRCUITS TO BTS EQUIPMENT.
- 5. EACH BTS CABINET FRAME SHALL BE DIRECTLY CONNECTED TO THE MASTER GROUND BAR WITH GREEN INSULATED SUPPLEMENTAL EQUIPMENT GROUND WIRES. #6 AWG STRANDED COPPER OR LARGER FOR INDOOR BTS AND #2 AWG STRANDED COPPER FOR OUTDOOR BTS
- 6. EXOTHERMIC WELDS SHALL BE USED FOR ALL GROUNDING CONNECTIONS BELOW GRADE.
- APPROVED ANTIOXIDANT COATINGS (I.E., CONDUCTIVE GEL OR PASTE) SHALL BE USED ON ALL COMPRESSION AND BOLTED GROUND CONNECTIONS.
- 8. ICE BRIDGE BONDING CONDUCTORS SHALL BE EXOTHERMICALLY BONDED OR BOLTED TO GROUND BAR
- 9. ALUMINUM CONDUCTOR OR COPPER CLAD STEEL CONDUCTOR SHALL NOT BE USED
- 10. MISCELLANEOUS ELECTRICAL AND NON-ELECTRICAL METAL BOXES, FRAMES AND SUPPORTS SHALL BE BONDED TO THE GROUND RING, IN ACCORDANCE WITH THE
- 11. METAL CONDUIT SHALL BE MADE ELECTRICALLY CONTINUOUS WITH LISTED BONDING FITTINGS OR BY BONDING ACROSS THE DISCONTINUITY WITH #6 AWS COPPER WIRE UL APPROVED GROUNDING TYPE CONDUIT CLAMPS.
- 12. ALL NEW STRUCTURES WITH A FOUNDATION AND/OR FOOTING HAVING 20 FT. OR MORE OF 1/2 IN. OR GREATER ELECTRICALLY CONDUCTIVE REINFORCING STEEL MUST HAVE IT BONDED TO THE GROUND RING USING AN EXOTHERMIC WELD CONNECTION USING #2 AWG SOLID BARE TINNED COPPER GROUND WIRE, PER NEC

GENERAL NOTES

1. FOR THE PURPOSE OF CONSTRUCTION DRAWING, THE FOLLOWING DEFINITIONS SHALL APPLY:

CONTRACTOR - NORTHEAST SITE SOLUTIONS SUBCONTRACTOR - GENERAL CONTRACTOR (CONSTRUCTION) OWNER - T-MOBILE

- 2. PRIOR TO THE SUBMISSION OF BIDS, THE BIDDING SUBCONTRACTOR SHALL VISIT THE CELL SITE TO FAMILIARIZE WITH THE EXISTING CONDITIONS AND TO CONFIRM THAT THE WORK CAN BE ACCOMPLISHED AS SHOWN ON THE CONSTRUCTION DRAWINGS. ANY DISCREPANCY FOUND SHALL BE BROUGHT TO THE ATTENTION OF
- 3. ALL MATERIALS FURNISHED AND INSTALLED SHALL BE IN STRICT ACCORDANCE WITH ALL APPLICABLE CODES, REGULATIONS, AND ORDINANCES, SUBCONTRACTOR SHALL ISSUE ALL APPROPRIATE NOTICES AND COMPLY WITH ALL LAWS, ORDINANCES, RULES, REGULATIONS, AND LAWFUL ORDERS OF ANY PUBLIC AUTHORITY REGARDING THE PERFORMANCE OF THE WORK. ALL WORK CARRIED OUT SHALL COMPLY WITH ALL APPLICABLE MUNICIPAL AND UTILITY COMPANY SPECIFICATIONS AND LOCAL JURISDICTIONAL CODES, ORDINANCES AND APPLICABLE REGULATIONS.
- 4. DRAWINGS PROVIDED HERE ARE NOT TO BE SCALED AND ARE INTENDED TO SHOW
- UNLESS NOTED OTHERWISE, THE WORK SHALL INCLUDE FURNISHING MATERIALS, EQUIPMENT, APPURTENANCES, AND LABOR NECESSARY TO COMPLETE ALL INSTALLATIONS AS INDICATED ON THE DRAWINGS.
- "KITTING LIST" SUPPLIED WITH THE BID PACKAGE IDENTIFIES ITEMS THAT WILL BE SUPPLIED BY CONTRACTOR. ITEMS NOT INCLUDED IN THE BILL OF MATERIALS AND KITTING LIST SHALL BE SUPPLIED BY THE SUBCONTRACTOR.
- THE SUBCONTRACTOR SHALL INSTALL ALL EQUIPMENT AND MATERIALS IN ACCORDANCE WITH MANUFACTURER'S RECOMMENDATIONS UNLESS SPECIFICALLY STATED OTHERWISE.
- 8. IF THE SPECIFIED EQUIPMENT CANNOT BE INSTALLED AS SHOWN ON THESE DRAWINGS, THE SUBCONTRACTOR SHALL PROPOSE AN ALTERNATIVE INSTALLATION SPACE FOR APPROVAL BY THE CONTRACTOR
- SUBCONTRACTOR SHALL DETERMINE ACTUAL ROUTING OF CONDUIT, POWER AND T1 CABLES, GROUNDING CABLES AS SHOWN ON THE POWER, GROUNDING AND TELCO PLAN DRAWING. SUBCONTRACTOR SHALL UTILIZE EXISTING TRAYS AND/OR SHALL ADD NEW TRAYS AS NECESSARY. SUBCONTRACTOR SHALL CONFIRM THE ACTUAL ROUTING WITH THE CONTRACTOR.
- 10. THE SUBCONTRACTOR SHALL PROTECT EXISTING IMPROVEMENTS, PAVEMENTS, CURBS, LANDSCAPING AND STRUCTURES. ANY DAMAGED PART SHALL BE REPAIRED AT SUBCONTRACTOR'S EXPENSE TO THE SATISFACTION OF OWNER.
- 11. SUBCONTRACTOR SHALL LEGALLY AND PROPERLY DISPOSE OF ALL SCRAP MATERIALS SUCH AS COAXIAL CABLES AND OTHER ITEMS REMOVED FROM THE EXISTING FACILITY. ANTENNAS REMOVED SHALL BE RETURNED TO THE OWNER'S DESIGNATED
- 12. SUBCONTRACTOR SHALL LEAVE PREMISES IN CLEAN CONDITION.
- 13. ALL CONCRETE REPAIR WORK SHALL BE DONE IN ACCORDANCE WITH AMERICAN

CONCRETE INSTITUTE (ACI) 301.

- 14. ANY NEW CONCRETE NEEDED FOR THE CONSTRUCTION SHALL BE AIR-ENTRAINED AND SHALL HAVE 4000 PSI STRENGTH AT 28 DAYS. ALL CONCRETE WORK SHALL BE DONE IN ACCORDANCE WITH ACI 318 CODE REQUIREMENTS.
- 15. ALL STRUCTURAL STEEL WORK SHALL BE DETAILED, FABRICATED AND ERECTED IN ACCORDANCE WITH AISC SPECIFICATIONS. ALL STRUCTURAL STEEL SHALL BE ASTM A36 (Fy = 36 ksi) UNLESS OTHERWISE NOTED. PIPES SHALL BE ASTM A53 TYPE E (Fy = 36 ksi). ALL STEEL EXPOSED TO WEATHER SHALL BE HOT DIPPED GALVÁNIZED. TÓUCHUP ALL SCRATCHES AND OTHER MARKS IN THE FIELD AFTER STEEL IS ERECTED USING A COMPATIBLE ZINC RICH PAINT.
- 16. CONSTRUCTION SHALL COMPLY WITH SPECIFICATIONS AND "GENERAL CONSTRUCTION SERVICES FOR CONSTRUCTION OF T-MOBILE SITES.'
- 17. SUBCONTRACTOR SHALL VERIFY ALL EXISTING DIMENSIONS AND CONDITIONS PRIOR TO COMMENCING ANY WORK. ALL DIMENSIONS OF EXISTING CONSTRUCTION SHOWN ON THE DRAWINGS MUST BE VERIFIED. SUBCONTRACTOR SHALL NOTIFY THE CONTRACTOR OF ANY DISCREPANCIES PRIOR TO ORDERING MATERIAL OR PROCEEDING
- 18. THE EXISTING CELL SITE IS IN FULL COMMERCIAL OPERATION. ANY CONSTRUCTION WORK BY SUBCONTRACTOR SHALL NOT DISRUPT THE EXISTING NORMAL OPERATION. ANY WORK ON EXISTING EQUIPMENT MUST BE COORDINATED WITH CONTRACTOR. ALSO, WORK SHOULD BE SCHEDULED FOR AN APPROPRIATE MAINTENANCE WINDOW USUALLY IN LOW TRAFFIC PERIODS AFTER MIDNIGHT.
- 19. SINCE THE CELL SITE IS ACTIVE, ALL SAFETY PRECAUTIONS MUST BE TAKEN WHEN WORKING AROUND HIGH LEVELS OF ELECTROMAGNETIC RADIATION. EQUIPMENT SHOULD BE SHUTDOWN PRIOR TO PERFORMING ANY WORK THAT COULD EXPOSE THE WORKERS TO DANGER. PERSONAL RF EXPOSURE MONITORS ARE ADVISED TO BE WORN TO ALERT OF ANY DANGEROUS EXPOSURE LEVELS.
- 20. APPLICABLE BUILDING CODES:

SUBCONTRACTOR'S WORK SHALL COMPLY WITH ALL APPLICABLE NATIONAL, STATE, AND LOCAL CODES AS ADOPTED BY THE LOCAL AUTHORITY HAVING JURISDICTION (AHJ) FOR THE LOCATION. THE EDITION OF THE AHJ ADOPTED CODES AND STANDARDS IN EFFECT ON THE DATE OF CONTRACT AWARD SHALL GOVERN THE DESIGN.

BUILDING CODE: IBC 2021 WITH 2022 CT STATE BUILDING CODE AMENDMENT ELECTRICAL CODE: 2020 NATIONAL ELECTRICAL CODE (NFPA 70-2020) LIGHTNING CODE: REFER TO ELECTRICAL DRAWINGS

SUBCONTRACTOR'S WORK SHALL COMPLY WITH THE LATEST EDITION OF THE FOLLOWING STANDARDS:

AMERICAN CONCRETE INSTITUTE (ACI) 318: BUILDING CODE REQUIREMENTS FOR STRUCTURAL CONCRETE;

AMERICAN INSTITUTE OF STEEL CONSTRUCTION (AISC)

MANUAL OF STEEL CONSTRUCTION, ASD, FOURTEENTH EDITION;

TELECOMMUNICATIONS INDUSTRY ASSOCIATION (TIA) 222-H, STRUCTURAL STANDARDS FOR STEEL

EQUIPMENT AND ANTENNA SUPPORTING STRUCTURES: REFER TO ELECTRICAL DRAWINGS FOR SPECIFIC ELECTRICAL STANDARDS.


FOR ANY CONFLICTS BETWEEN SECTIONS OF LISTED CODES AND STANDARDS REGARDING MATERIAL, METHODS OF CONSTRUCTION, OR OTHER REQUIREMENTS, THE MOST RESTRICTIVE REQUIREMENT SHALL GOVERN. WHERE THERE IS CONFLICT BETWEEN A GENERAL REQUIREMENT AND A SPECIFIC REQUIREMENT, THE SPECIFIC REQUIREMENT SHALL GOVERN.

T-MOBILE NORTHEAST LLC

35 GRIFFIN ROAD SOUTH BLOOMFIELD, CT 06002 OFFICE: (860) 648-1116





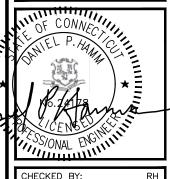

CHECKED BY:

APPROVED BY: DPH

	SUBMITTALS							
REV.	DATE	DESCRIPTION	BY					
1	06/13/23	ISSUED FOR CONSTRUCTION	TR					
0	06/08/23	ISSUED FOR REVIEW	TR					

SITE NUMBER CTNH584A

SITE NAME CTNH584A

SITE ADDRESS: 33 KEEGAN RD PLYMOUTH, CT 06782 LITCHFIELD COUNTY


SHEET TITLE


GENERAL NOTES

(GENERATOR PROJECT)


SHEET NUMBER

GN-1

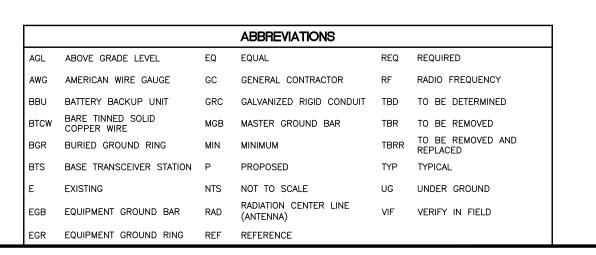

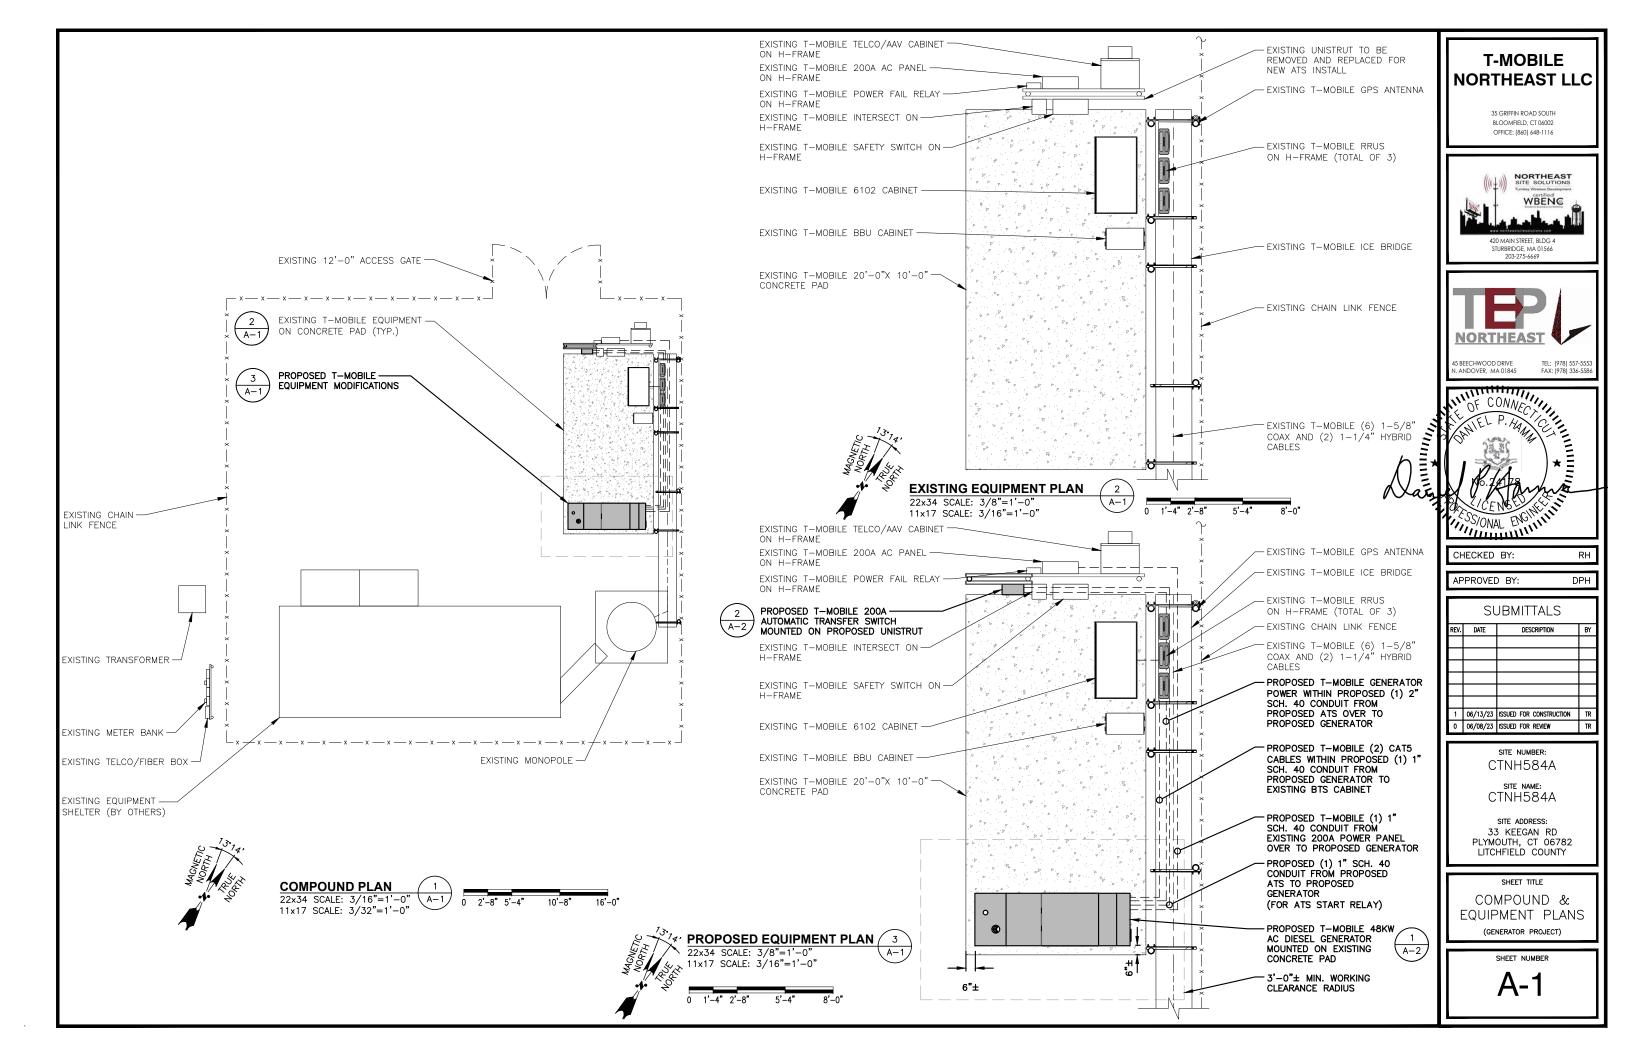

NOTE:
PROPOSED T-MOBILE AC GENERATOR
TO BE INSTALLED PER MANUFACTURER'S SPECIFICATIONS.

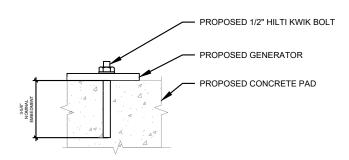


NOTE:

INSTALL HILTI KWIK BOLT ANCHORS STRICTLY PER INSTALLATION INSTRUCTIONS INCLUDED WITH PRODUCT OR FOUND ONLINE AT WWW.US.HILTI.COM. PROPER INSTALLATION IS CRITICAL FOR FULL PERFORMANCE.

PROPOSED GENERATOR ATTACHMENT DETAIL SCALE: N.T.S

AUTOMATIC TRANSFER SWITCH DIMENSIONS MODEL # RXC200A3 MANUF. GENERAC WIDTH 14.6" DEPTH 7.09" HEIGHT WEIGHT W/O BATTERIES 20 LBS

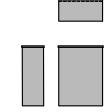

<u>PLAN</u>

SIDE FRONT


AUTOMATIC TRANSFER SWITCH DETAIL



35 GRIFFIN ROAD SOUTH BLOOMFIELD, CT 06002 OFFICE: (860) 648-1116

T-MOBILE NORTHEAST LLC



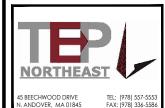



CHECKED BY:

APPROVED BY:

DPH

	SUBMITTALS								
REV.	DATE	E DESCRIPTION							
1		ISSUED FOR CONSTRUCTION	TR						
0	06/08/23	ISSUED FOR REVIEW	TF						

SITE NUMBER: CTNH584A


SITE NAME: CTNH584A

SITE ADDRESS: 33 KEEGAN RD PLYMOUTH, CT 06782 LITCHFIELD COUNTY

SHEET TITLE

DETAILS

(GENERATOR PROJECT) SHEET NUMBER

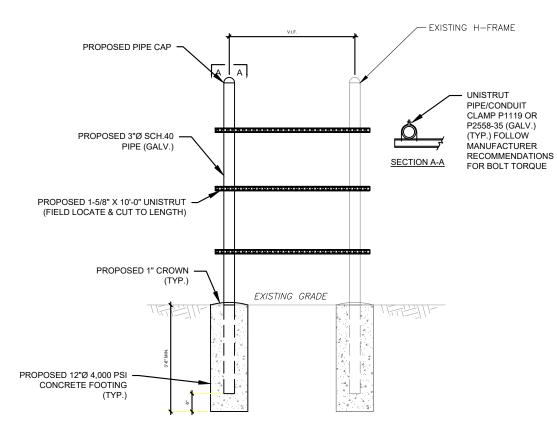



H-FRAME NOTES:

- IF IT IS NECESSARY TO EXTEND THE H-FRAME, AN ADDITIONAL POST WILL ALWAYS BE REQUIRED.
- PROPOSED UNISTRUTS TO BE FIELD CUT AND SHOULD NOT EXTEND MORE THAN 6 INCHES BEYOND THE LAST POST.
- SPRAY ENDS OF UNISTRUT WITH COLD GALVANIZING SPRAY PAINT, ALLOW TO DRY, THEN COVER WITH RUBBER PROTECTIVE CAPS FOR SAFETY.
- 4. UNISTRUT TO BE CUT FLUSH WITH NO SHARP OR JAGGED EDGES.
- ALL PROPOSED HARDWARE TO BE MOUNTED PER MANUFACTURERS SPECS.
- ALL H-FRAME POSTS SHALL BE GROUNDED TO EQUIPMENT GROUND RING.

TYPICAL H-FRAME EXTENSION DETAIL



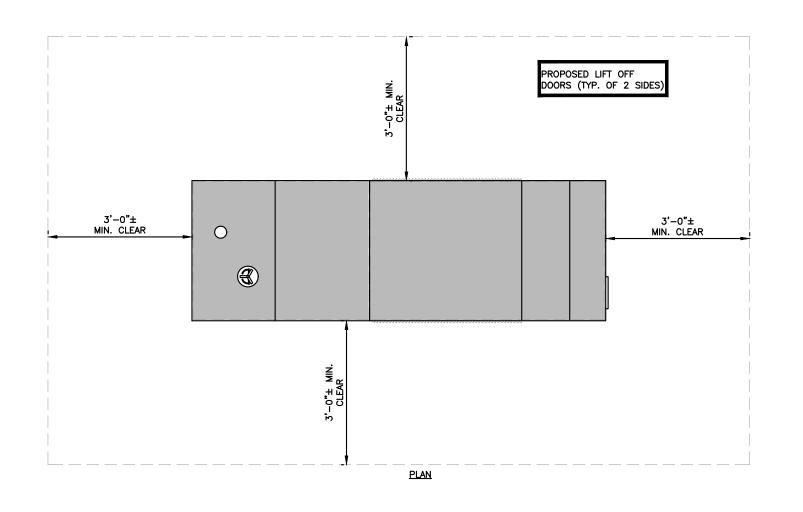

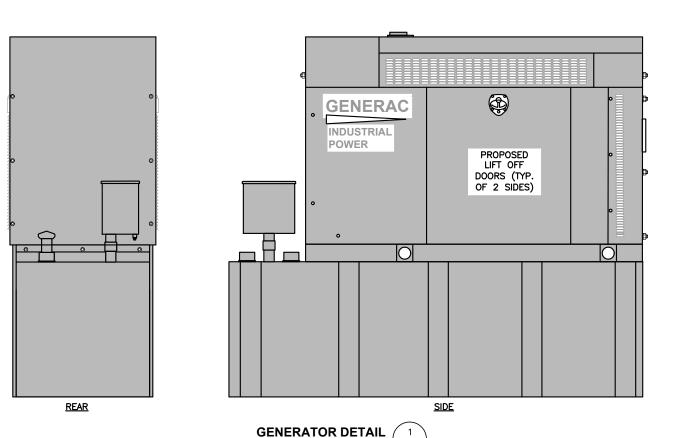

SCALE: N.T.S

48KW AC GENERATOR		
DIMENSIONS		
ODEL #	RD048	
ANUF.	GENERAC	
EIGHT	90.0"	
'IDTH	35.0"	
ENGTH	103.4"	
'EIGHT	2,954 LBS	
UEL TANK SIZE	240 GALLONS	


NOTE:
PROPOSED T-MOBILE AC GENERATOR
TO BE INSTALLED PER
MANUFACTURER'S SPECIFICATIONS.

T-MOBILE NORTHEAST LLC

35 GRIFFIN ROAD SOUTH BLOOMFIELD, CT 06002 OFFICE: (860) 648-1116





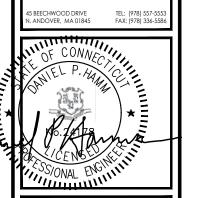

CHECKED BY:

APPROVED BY:

DPH

SUBMITTALS			
REV.	DATE	DESCRIPTION	BY
1		ISSUED FOR CONSTRUCTION	TR
0	06/08/23	ISSUED FOR REVIEW	TR
		•	

SITE NUMBER: CTNH584A

SITE NAME: CTNH584A

SITE ADDRESS: 33 KEEGAN RD PLYMOUTH, CT 06782 LITCHFIELD COUNTY

SHEET TITLE


GENERATOR

DETAILS

(GENERATOR PROJECT)

SHEET NUMBER

A-3

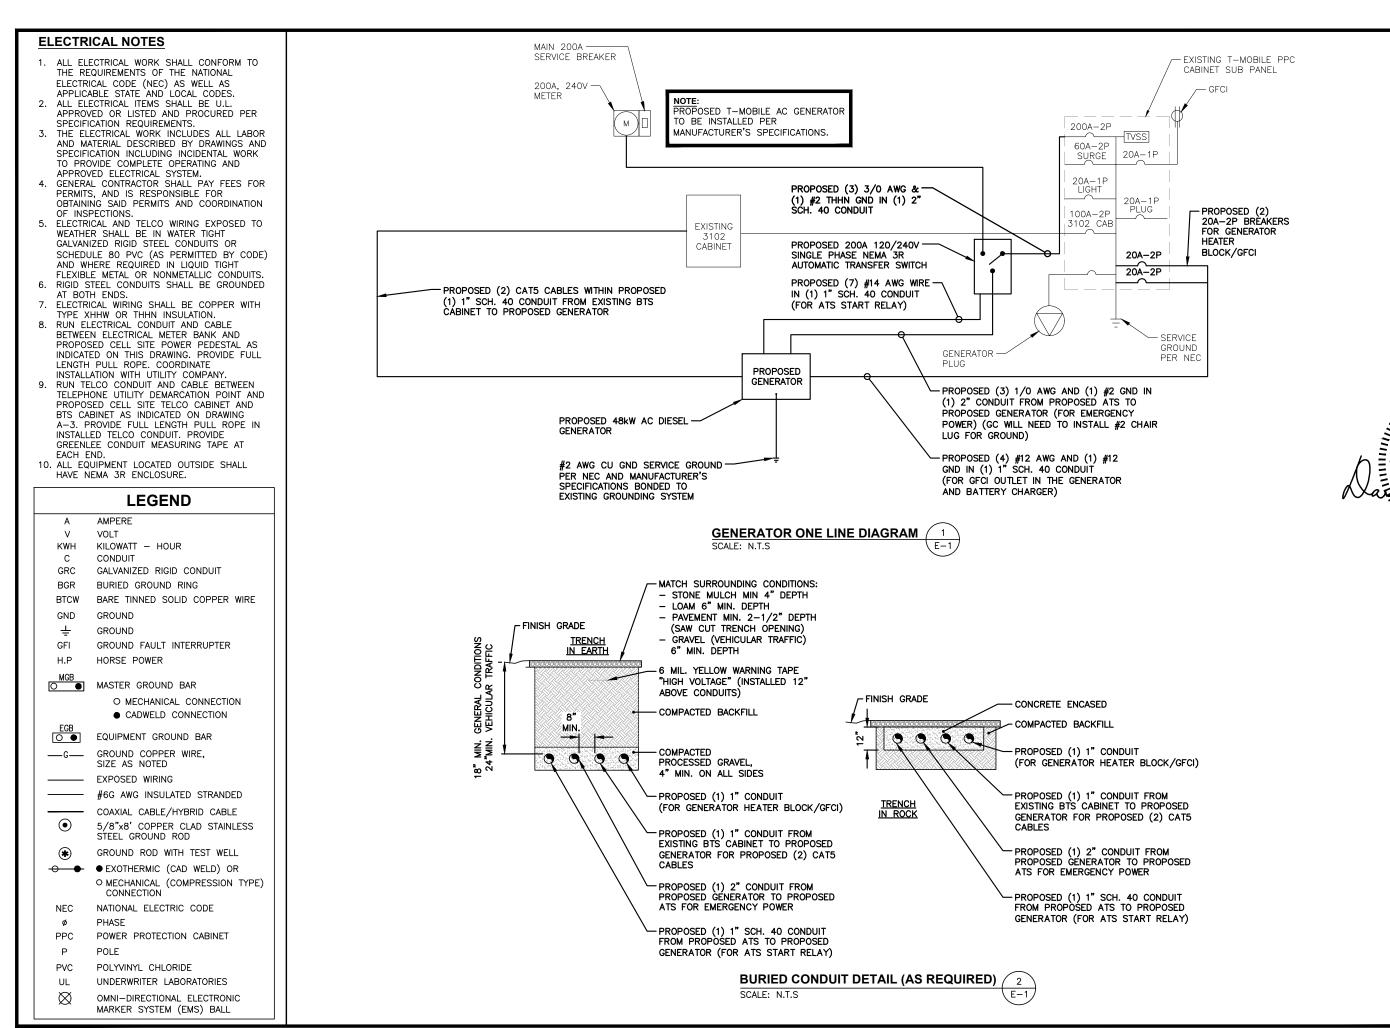

T-MOBILE NORTHEAST LLC

35 GRIFFIN ROAD SOUTH BLOOMFIELD, CT 06002 OFFICE: (860) 648-1116







CHECKED BY:

APPROVED BY:

SUBMITTALS

RH

DPH

30DWITTAL3			
REV.	DATE	DESCRIPTION	B'
1	06/13/23	ISSUED FOR CONSTRUCTION	Ti
0	06/08/23	ISSUED FOR REVIEW	T

SITE NUMBER CTNH584A

SITE NAME: CTNH584A

SITE ADDRESS: 33 KEEGAN RD PLYMOUTH, CT 06782 LITCHFIELD COUNTY

SHEET TITLE **EQUIPMENT** ONE-LINE DIAGRAM (GENERATOR PROJECT)

SHEET NUMBER

Exhibit D

EPA Certified Stationary Emergency



Standby Power Rating 48 kW, 60 kVA, 60 Hz







Image used for illustration purposes only

Codes and Standards

Not all codes and standards apply to all configurations. Contact factory for details.



UL2200, UL508, UL489, UL142



CSA 22.2





BS5514 and DIN 6271



SAE J1349



NFPA 37, 70, 99



ISO 3046, 8528, 9001



NEMA ICS1, ICS10, MG1, 250, ICS6, AB1



an National Standards Institute ANSI/IEEE C62.41

Powering Ahead

For over 50 years, Generac has led the industry with innovative design and superior manufacturing.

Generac ensures superior quality by designing and manufacturing most of its generator components, including alternators, enclosures and base tanks, control systems and communications software.

Generac's gensets utilize a wide variety of options, configurations and arrangements, allowing us to meet the standby power needs of practically every application.

Generac searched globally to ensure the most reliable engines power our generators. We choose only engines that have already been proven in heavy-duty industrial application under adverse conditions.

Generac is committed to ensuring our customers' service support continues after their generator purchase.

RD048 | 3.4L | 48 kW

INDUSTRIAL DIESEL GENERATOR SET

EPA Certified Stationary Emergency

Standard Features

ENGINE SYSTEM

- Cold Weather Kit
- Oil Drain Extension
- Fan Guard
- Stainless Steel Flexible Exhaust Connection
- · Factory Filled Oil & Coolant

Fuel System

Primary Fuel Filter

Cooling System

- Closed Coolant Recovery System
- Factory-Installed Radiator
- 50/50 Ethylene Glycol Antifreeze
- Radiator Drain Extension
- Can Operate at up to 122°F (50°C) Ambient Temperature

Electrical System

- Battery Charging Alternator
- Battery Cables
- Battery Tray
- Rubber-Booted Engine Electrical Connections
- Solenoid Activated Starter Motor
- Smart Battery Charger

ALTERNATOR SYSTEM

- Class H Insulation Material
- 2/3 Pitch
- Skewed Stator
- Sealed Bearings
- Low Temperature Rise (<120°C)
- Low THD (<5%)

GENERATOR SET

GENERAC

Sound Attenuated Aluminum Enclosure

INDUSTRIAL

- Internal Genset Vibration Isolation
- Separation of Circuits High/Low Voltage
- Wrapped Exhaust Piping
- Standard Factory Testing
- 5 Year Limited Warranty
- Ready to Accept Full Load in <10 Seconds
- E-Stop

TANKS

- 48 Hour Run Time Tank
- UL 142 Listed Tank

CONTROL SYSTEM



Evolution ™ Controller

- Two-Line Plain Text LCD Display
- Programmable Start Delay Between 10-30 seconds
- 10 second Engine Start Sequence
- 5 second Engine Warm Up
- 1 minute Engine Cool-Down
- Starter Lock-Out
- Smart Battery Charger
- Automatic Voltage Regulation with Over and Under Protection
- Automatic Low Oil Pressure Shutdown
- Overspeed Shutdown
- High Temperature Shutdown

- Overcrank Protection
- Safety Fused
- · Failure to Transfer Protection
- Low Battery Protection
- 50 Even Run Log
- Future Set Capable Exerciser
- Incorrect Wiring Protection
- Internal Fault Protection
- Common External Fault Capability
- · Governor Failure Protection

Optional Shipped Loose and Field Install Kits

GENERATOR SET

- O Paint Kit
- O Scheduled Maintance Kit

CONTROL SYSTEM

○ Mobile Link TM and Adapter Kit

TANKS

- O Spill Box
- O 90% Fuel Alarm
- Tank Risers
- O Spill Box Drainback Kit
- O Vent Extension Support Kit
- O 5 Day Run Time Tank
- Overfill Prevention Valve
- O Fuel Fill Drop Tube
- Lockable Fuel Cap

RD048 | 3.4L | 48 kW

INDUSTRIAL DIESEL GENERATOR SET

EPA Certified Stationary Emergency



APPLICATION AND ENGINEERING DATA

ENGINE SPECIFICATIONS

General

Make	Generac
Cylinder #	4
Туре	In-Line
Displacement - in ³ (L)	3.4 (207.48)
Bore - in (mm)	3.86 (98)
Stroke - in (mm)	4.45 (113)
Compression Ratio	18.5:1
Intake Air Method	Turbocharged/Aftercooled

Cast Iron OHV

Aluminum

Engine Governing

Cylinder Head

Piston Type

Governor	Electronic
Frequency Regulation (Steady State)	±0.25%

Lubrication System

Oil Pump Type	Gear
Oil Filter Type	Full Flow Spin-On Canister
Crankcase Capacity with Filters- qt (L)	7.4 (7.0)

Cooling System

Cooling System Type	Closed Recovery
Fan Type	Pusher
Fan Speed- rpm	2,029
Fan Diameter - in (mm)	22 (559)

Fuel System

Fuel Type	Ultra Low Sulfur Diesel Fuel
Fuel Specification	ASTM
Fuel Pump Type	Mechanical Engine Driven Gear
Injector Type	Mechanical
Fuel Supply Lin (mm/in)	7.94/0.31 (ID)
Fuel Return Line (mm/in)	7.94/0.31 (ID)
Fuel Filtering (microns)	25

Engine Electrical System

System Voltage	12 VDC
Battery Charger Alternator	Standard
Battery Size	Group 27F
Battery Voltage	12 VDC
Ground Polarity	Negative

ALTERNATOR SPECIFICATIONS

Standard Model	Generac
Poles	4
Field Type	Rotating
Insulation Class - Rotor	Н
Insulation Class - Stator	Н
Total Harmonic Distortion	<5%
Telephone Interference Factor (TIF)	<50

Standard Excitation	Direct
Bearings	Single Sealed
Coupling	Flexible Disc
Prototype Short Circuit Test	Yes
Voltage Regulator Type	Full Digital
Number of Sensed Phases	2
Regulation Accuracy (Steady State)	±1.0%

RD048 | 3.4L | 48 kW

INDUSTRIAL DIESEL GENERATOR SET

EPA Certified Stationary Emergency



OPERATING DATA

POWER RATINGS

Standby

Single-Phase 120/480 VAC @0.1pf

48 kW

Amps: 200

MOTOR STARTING CAPABILITIES (SKVA)

sKVA vs. Voltage Dip at 30%

120/240 V, Single-Phase at 0.4pf	189
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FUEL CONSUMPTION RATES*

Percent Load	Diesel gal/hr (L/hr)
25%	1.35 (5.11)
50%	2.15 (8.14)
75%	3.06 (11.58)
100%	3.98 (15.07)

^{*} Fuel supply installation must accommodate fuel consumption rates at 100% load.

COOLING

		Standby
Air Flow (Radiator and Alternator)	ft³/min (m³/min)	2824 (80)
Coolant System Capacity	gal (L)	2.8 (10.6)
Heat Rejection to Coolant	BTU/hr (MJ/hr)	135,900 (143.4)
Temperature Deration	3% for every 5°C above 25°C or 1	.7% for every 5°F over 77°F
Altitude Deration	1% for every 100 m above 915 or 3% fo	r every 1000 ft over 3000 ft
Maximum Radiator Backpressure	in H ₂ O (kPa)	0.50 (0.12)

COMBUSTION AIR REQUIREMENTS

	Standby
Flow at Rated Power ft ³ /min (m ³ /min)	190 (5.38)


ENGINE			EXHAUST		
		Standby			Standby
Rated Engine Speed	rpm	1,800	Exhaust Flow (Rated Output)	ft³/min (m³/min)	448 (12.7)
Horsepower at rated kW	HP	85	Exhaust Temp (Rated Output - Post Silencer)	°F (°C)	1120 (604.4)

Deration – Operational characteristics consider maximum ambient conditions. Derate factors may apply under atypical site conditions.

Please consult a Generac Power Systems Industrial Dealer for additional details. All performance ratings in accordance with ISO3046, BS5514, ISO8528 and DIN6271 standards. Standby - See Bulletin 0187500SSB



DIMENSIONS AND WEIGHTS*

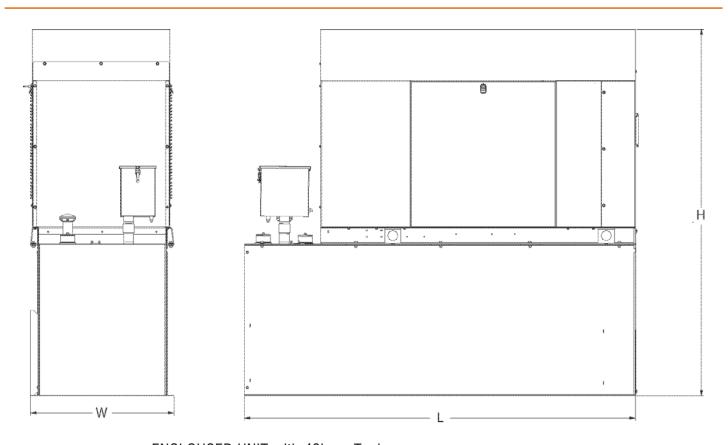

ENCLOUSED UNIT with 48hour Tank

L x W x H in (mm)	95.4 (2,422) x 35.0 (880) x 89.3 (2,269)
Sound output in dB(A) at 23ft with generator operating at normal Load	65

* All measurements are approximate and for estimation purposes only.

YOUR FACTORY RECOGNIZED GENERAC INDUSTRIAL DEALER			

Specification characteristics may change without notice. Dimensions and weights are for preliminary purposes only. Please consult a Generac Power Systems Industrial Dealer for detailed installation drawings.

Exhibit E

Protector™ Series



Diesel Generator Set

INCLUDES:

- Two Line LCD Multilingual Digital Evolution™ Controller (English/Spanish/French/ Portuguese) with external viewing window for easy indication of generator status and breaker position.
- Isochronous Electronic Governor
- Sound Attenuated Aluminum Enclosure
- Smart Battery Charger
- UV/Ozone Resistant Hoses
- ±1% Voltage Regulation
- Integrated Base Tank Provides Up to 40 Hours of Run Time
- 5 Year Limited Warranty*
- UL 2200 / UL142 / ULC S601 Listed
- Meets code requirements for External Vent and Fill

Standby Power Rating

Model RD015 - 15 kW 60 Hz Model RD020 - 20 kW 60 Hz Model RD030 - 30 kW 60 Hz

Model RD048 - 48 kW 60 Hz (single phase only) Model RD050 - 50 kW 60 Hz (three phase only)





Meets EPA Emission Regulations CA/MA Emissions Compliant

* 5 year warranty applicable to U.S. and Territories/Canada. International warranty is 3 year limited.

FEATURES

- INNOVATIVE DESIGN & PROTOTYPE TESTING are key components of GENERAC'S success in "IMPROVING POWER BY DESIGN." But it doesn't stop there. Total commitment to component testing, reliability testing, environmental testing, destruction and life testing, plus testing to applicable CSA, NEMA, EGSA, and other standards, allows you to choose GENERAC POWER SYSTEMS with the confidence that these systems will provide superior performance.
- TEST CRITERIA:
 - √ PROTOTYPE TESTED
- √ NEMA MG1-22 EVALUATION
- **V** SYSTEM TORSIONAL TESTED
- **V** MOTOR STARTING ABILITY

SOLID-STATE, FREQUENCY COMPENSATED VOLTAGE REGULATION.

This state-of-the-art power maximizing regulation system is standard on all Generac models. It provides optimized FAST RESPONSE to changing load conditions and MAXIMUM MOTOR STARTING CAPABILITY by electronically torque-matching the surge loads to the engine. Digital voltage regulation at $\pm 1\%$.

- SINGLE SOURCE SERVICE RESPONSE from Generac's extensive dealer network provides parts and service know-how for the entire unit, from the engine to the smallest electronic component.
- GENERAC TRANSFER SWITCHES. Long life and reliability are synonymous with GENERAC POWER SYSTEMS. One reason for this confidence is that the GENERAC product line includes its own transfer systems and controls for total system compatibility.







15 • 20 • 30 • 48 • 50 kW

application & engineering data

GENERATOR SPECIFICATIONS

Туре	Synchronous
Rotor Insulation Class	H (15 & 20 kW) or F (30, 48 & 50 kW)
Stator Insulation Class	Н
Telephone Interference Factor (TIF)	<50
Alternator Output Leads 1-Phase	3 wire
Alternator Output Leads 3-Phase	6 wire
Bearings	Single Sealed Cartridge
Coupling	Direct, Flexible Disc
Excitation System	Direct

VOLTAGE REGULATION

Туре	Electronic
Sensing	Single Phase
Regulation	± 1%
Features	Adjustable Voltage & Gain

GOVERNOR SPECIFICATIONS

Туре	Electronic Isochronous
Steady State Regulation	± 0.25%

ELECTRICAL SYSTEM

Battery Charge Alternator	50 Amp (15 & 20 kW) or 70 Amp (30, 48 & 50 kW)
Smart Battery Charger	2 Amp
Recommended Battery (battery not included)	Group 27F, 700 CCA
System Voltage	12 Volts

GENERATOR FEATURES

Revolving field heavy duty generator

Directly connected to the engine

Operating temperature rise 120°C above a 40°C ambient

Class H insulation is NEMA rated

Class F insulation is NEMA rated

All models fully prototype tested

ENCLOSURE FEATURES

Aluminum weather protective enclosure	Ensures protection against mother nature. Electrostatically applied textured epoxy paint for added durability.
Enclosed critical grade muffler	Quiet, critical grade muffler is mounted inside the unit to prevent injuries and maximize sound dampening.
Small, compact, attractive	Makes for an easy, eye appealing installation.
SAE	Sound attenuated enclosure ensures quiet operation.

GENERAC°

15 • 20 • 30 • 48 • 50 kW

application & engineering data

ENGINE SPECIFICATIONS: 15 & 20 kW

Make	Generac
Model	In-line
Cylinders	4
Displacement (Liters)	2.28
Bore (in./mm)	3.46/88
Stroke (in./mm)	3.70/94
Compression Ratio	21.3:1
Intake Air System	Naturally Aspirated
Cylinder Head Type	Cast Iron OHV
Piston Type	Aluminum
EPA Emissions Compliance	Emergency Stationary

ENGINE SPECIFICATIONS: 30 kW

Make	Generac		
Model	In-line		
Cylinders	4		
Displacement (Liters)	2.4		
Bore (in/mm)	3.54/90		
Stroke (in/mm)	3.70/94		
Compression Ratio	21.3:1		
Intake Air System	Turbocharged		
Cylinder Head Type	Cast Iron OHV		
Piston Type	Aluminum		
EPA Emissions Compliance	Emergency Stationary		

ENGINE SPECIFICATIONS: 48/50 kW

Make	Generac		
Model	In-Line		
Cylinders	4		
Displacement (Liters)	3.4		
Bore in/mm	3.86/98		
Stroke in/mm	4.45/113		
Compression Ratio	18.5:1		
Intake Air System	Turbocharged/Aftercooled		
Cylinder Head Type	Cast Iron OHV		
Piston Type	Aluminum		
EPA Emissions Compliance	Emergency Stationary		

ENGINE LUBRICATION SYSTEM

Oil Pump Type	Ge		
Oil Filter Type	Full flow spin-on canister		
Crankcase Capacity (quarts/liters)	6.87/6.5 - 15 & 20 kW 6.8/6.4 - 30 kW		
(444.15)	7.4/7 - 48 & 50 kW		

ENGINE COOLING SYSTEM

Туре	Pressurized radiator - 15 & 20 kV Closed recovery - 30, 48 & 50 kV Pre-lubed, self-seating		
Water Pump			
Fan Speed (rpm)	1800 - 15 & 20 kW 2061 - 30 kW 2029 - 48 & 50 kW		
Fan Diameter (in/mm)	18.11/460 (15 & 20 kW) 22/559 (30, 48 & 50 kW)		
Fan Mode	Pusher		

FUEL SYSTEM

Fuel Type	Ultra Low Sulfur Diesel Fuel		
Fuel Pump Type	Mechanical Engine Driven Gear		
Injector Type	Mechanical		
Fuel Supply Line (mm/in)	7.94/0.31 (ID		
Fuel Return Line (mm/in)	7.94/0.31(ID)		
Fuel Specification	ASTM		
Fuel Filtering (microns)	5 - 15, 20 & 30 kW 10 - 48 & 50 kW		

TANK SPECIFICATIONS

Total Size (gallons/liters)	34/128.7 - 15 & 20 kW 62/234.7 - 30, 48 & 50 kW
Usable Size (gallons/liters)	32/121.1 - 15 & 20 kW 57/215.8 - 30, 48 & 50 kW
Run Time @ 1/2 Load (hrs)	41 - 15 kW 31 - 20 kW 38 - 30 kW 25 - 48 & 50 kW
Listings	UL142 ULC-S601

WEIGHTS AND DIMENSIONS

	15 kW	20 kW	30 kW	48 kW	50 kW
Weight (lb/kg)	1380)/626	1927/874	2197	7/997
Dimensions (LxWxH) (in/cm)	81 x 31 x 50/2	205 x 78 x 128	95 x 35 x 57/242 x 89 x 145		

GENERAC

operating data

15 • 20 • 30 • 48 • 50 kW

GENERATOR OUTPUT VOLTAGE/kW - 60 Hz

		kW (Standby)	Amp (Standby)	CB Size
	120/240 V, 1Ø, 1.0 pf	15	62	70
RD015	120/208 V, 3Ø, 0.8 pf	15	52	60
	120/240 V, 3Ø, 0.8 pf	15	45	50
	120/240 V, 1Ø, 1.0 pf	20	83	100
RD020	120/208 V, 3Ø, 0.8 pf	20	69	80
	120/240 V, 3Ø, 0.8 pf	20	60	70
	120/240 V, 1Ø, 1.0 pf	30	125	150
RD030	120/208 V, 3Ø, 0.8 pf	30	104	125
וטטטטוו	120/240 V, 3Ø, 0.8 pf	30	90	100
	277/480 V, 3Ø, 0.8 pf	30	45	50
	120/240 V, 1Ø, 1.0 pf	48	200	200
RD048/	120/208 V, 3Ø, 0.8 pf	50	173	200
RD050	120/240 V, 3Ø, 0.8 pf	50	150	175
	277/480 V, 3Ø, 0.8 pf	50	75	90

SURGE CAPACITY IN AMPS

Voltage Dip @ < .4 pf 15% 30%

			0070
	120/240 V, 1Ø	53	129
RD015	120/208 V, 3Ø	37	90
	120/240 V, 3Ø	32	78
	120/240 V, 1Ø	87	211
RD020	120/208 V, 3Ø	59	143
	120/240 V, 3Ø	51	124
RD030	120/240 V, 1Ø	66	168
	120/208 V, 3Ø	59	144
	120/240 V, 3Ø	51	125
	277/480 V, 3Ø	26	64
	120/240 V, 1Ø	69	189
RD048/	120/208 V, 3Ø	90	218
RD050	120/240 V, 3Ø	78	189
	277/480 V, 3Ø	36	87

ENGINE FUEL CONSUMPTION

		gai/nr	L/nr
	25% of rated load	0.51	1.93
RD015	50% of rated load	0.79	2.99
NDOTS	75% of rated load	1.14	4.31
	100% of rated load	1.48	5.58
	25% of rated load	0.67	2.6
RD020	50% of rated load	1.05	3.97
NDUZU	75% of rated load	1.52	5.32
	100% of rated load	1.98	7.48
	25% of rated load	0.92	3.5
RD030	50% of rated load	1.45	5.5
	75% of rated load	1.96	7.4
	100% of rated load	2.74	10.4
	25% of rated load	1.35	5.11
RD048/	50% of rated load	2.15	8.14
RD050	75% of rated load	3.06	11.58
	100% of rated load	3.98	15.07



15 • 20 • 30 • 48 • 50 kW

operating data

ENGINE COOLING

	15 kW	20 kW	30 kW	48/50 kW
Air flow (inlet air including alternator and combustion air in cfm/cmm)	2824/80	2824/80	3038/86	2824/80
System coolant capacity (gal/liters)	2.8/10.6	2.8/10.6	2.8/10.6	2.8/10.6
Heat rejection to coolant (BTU per hr/MJ per hr)	63,535/67	63,535/67	111,000/117.1	135,900/143.4
Maximum operation air temperature on radiator (°C/°F)	50/122			
Maximum ambient temperature (°C/°F)	50/122			

COMBUSTION REQUIREMENTS

Flow at rated power (cfm/cmm) 84.	76/2.4 84.7	6/2.4 90/2.5	55 190/5.38
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SOUND EMISSIONS

Sound output in dB(A) at 23 ft (7 m) with generator in exercise mode*	65	
Sound output in dB(A) at 23 ft (7 m) with generator operating at normal load*	70	

^{*}Sound levels are taken from the front of the generator. Sound levels taken from other sides of the generator may be higher depending on installation parameters.

EXHAUST

Exhaust flow at rated output (cfm/cmm)	98.88/2.8	98.88/2.8	230/6.51	448/12.7
Exhaust temperature at rated output (°C/°F)	604.4/1120	604.4/1120	454.4/850	604.4/1120

ENGINE PARAMETERS

Rated Synchronous RPM		1800			
HP at rated kW	26.4	33.5	49	85	

POWER ADJUSTMENT FOR AMBIENT CONDITIONS

Temperature Deration	
Altitude Deration (15, 30, 48 & 50 kW)	
Altitude Deration (20 kW)	1% for every 100 m above 305 m or 3% for every 1000 ft above 1000 ft


CONTROLLER FEATURES

2-Line Plain Text Multilingual LCD Display	Simple user interface for ease of operation. Automatic Start on Utility failure. Programmable 7 day exerciser.
wiode Buttons: Auto	
Manual	Start with starter control unit stays on. If utility fails, transfer to load takes place
Off	Stons unit Power is removed. Control and charger still apprato
Ready to Run/Maintenance Messages	Standard
Engine Run Hours Indication	Standard
Programmable start delay between 2-1500 seconds	Standard (programmable by dealer only)
Other voiding costrolling of this voil	From 140 171 V/100 016 V
Future Set Capable Exerciser/Exercise Set Error Warning	Standard Step to Secondary of the secon
Run/Alarm/Maintenance Logs	50 Events Each
Engine Start Sequence	
Starter Lock-out	Starter cannot re-engage until 5 sec after engine has stopped.
Smart Battery Charger	Standard
Charger Fault/Missing AC Warning	Starter cannot re-engage until 5 sec after engine has stopped. Standard Standard Standard
Low Battery/Battery Problem Protection and Battery Condition Indication	Standard
Automatic Voltage Regulation with Over and Under Voltage Protection	Standard
HIGHE-FIRMURICAL INFIDACINATION OF THE PROTOCOLOR	
Automatic Low Oil Pressure/High Oil Temperature Shutdown	Standard Standard
Overcrainy Overspeed ((a) 12 Hz//hrivi Selise Loss Silutiowii	Standard
High Engine Temperature Shutdown	Standard
Internal Fault/Incorrect Wiring Protection	Standard Standard Standard
Common External Fault Capability	Standard
Field Upgradable Firmware	
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6 of 12


installation layout

Drawing #0K7025-C (1 of 2)

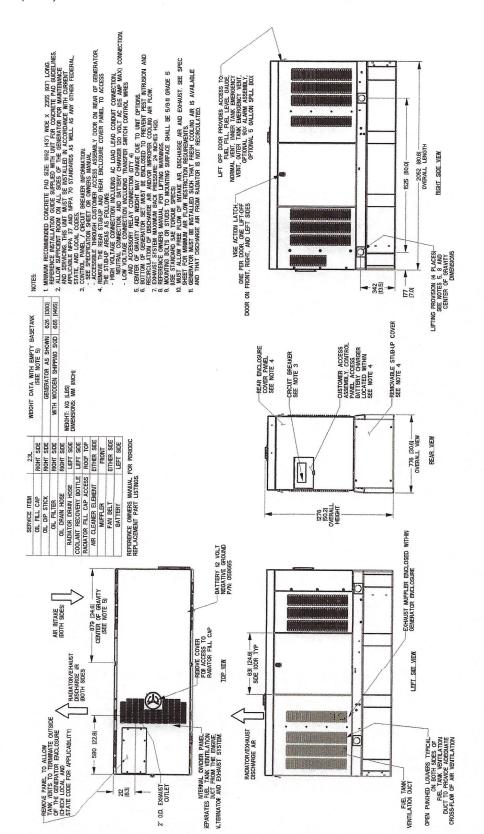

installation layout

Drawing #0K7025-C (2 of 2)

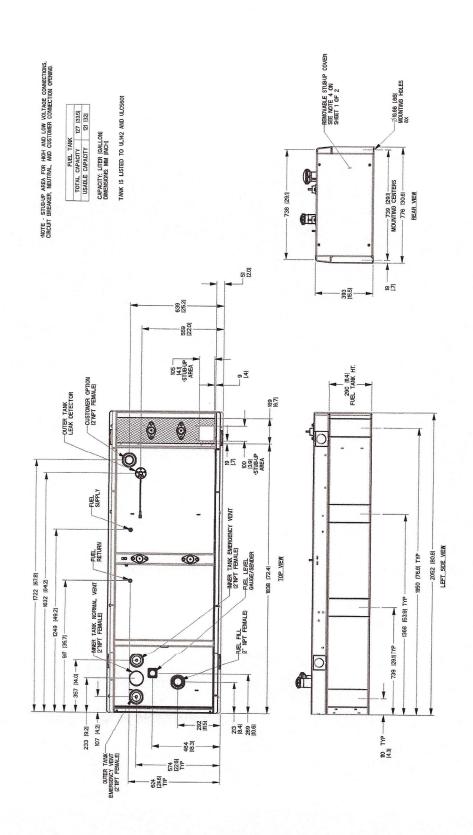


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GENERAC

installation layout


Drawing #0K7002-C (1 of 2)

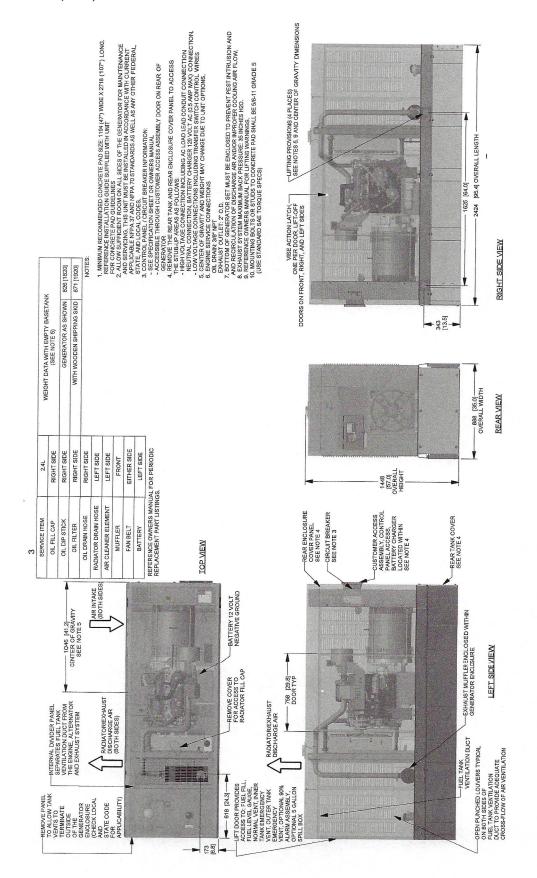

GENERAC®

installation layout

Drawing #0K7002-B (2 of 2)

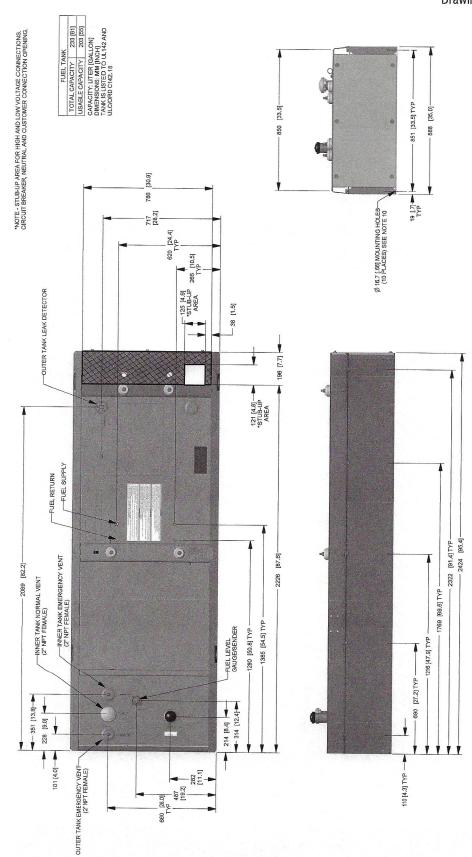

9 of 12


10 of 12

48 & 50 kW

GENERAC


installation layout

Drawing #0K6968-C (1 of 2)

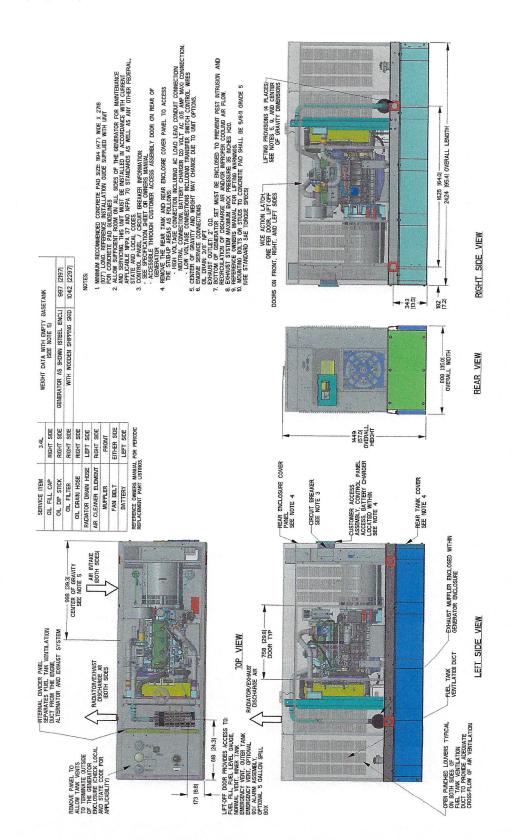

installation layout

Drawing #0K6968-A (2 of 2)

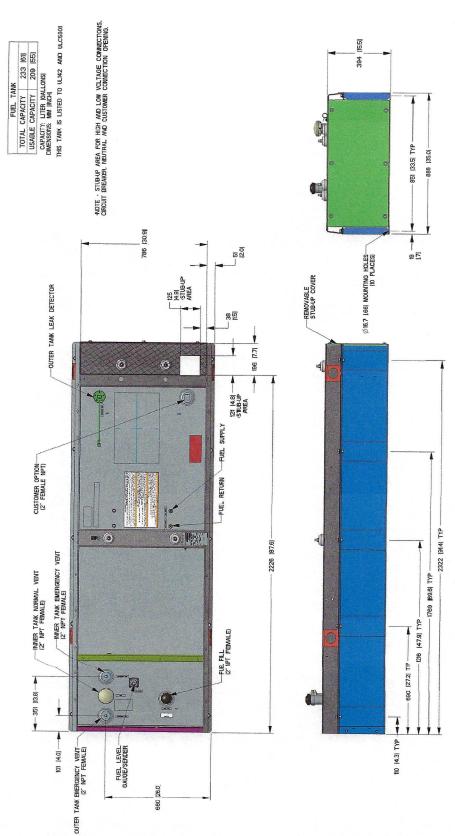

11 of 12




15 • 20 • 30 • 48 • 50 kW

available accessories

Model #	Product	Description
G006463-4	Mobile Link™	Generac's Mobile Link allows you to check the status of your generator from anywhere that you have access to an Internet connection from a PC or with any smart device. You will even be notified when a change in the generator's status occurs via e-mail or text message. Note: Harness Adapter Kit required. Available in the U.S. only.
G006478-0	Harness Adapter Kit	The Harness Adapter Kit is required to make liquid-cooled units compatible with Mobile Link™.
G006502-0	Spill Box	The 5-gallon spill box screws into the existing fuel fill port of the base tank. It captures and contains fuel if over fueling or spilling occurs during the fill process.
G006504-0	90% Fuel Level Alarm	The 90% fuel level alarm alerts the fuel fill operator when the tank reaches a 90% fill level by sounding an audible alarm and triggering an LED warning light.
G006505-0 - 15 & 20 kW G006506-0 - 30, 48 & 50 kW	Tank Risers	Tank risers are required in some municipalities to help avoid potential base tank corrosion caused by mounting on rough surfaces.
G006507-0	Fuel Fill Drop Tube	A powder coat painted, steel fuel fill drop tube is required in some municipalities to prevent sparking due to static electricity buildup, which can be caused by the fuel dropping into the tank from the fill area. Using a drop tube also results in submerged filling, which increases the fuel delivery flow rate and reduces vapors, foam and potential tank evaporation.
G006513-0 - 15 & 20 kW G006517-0 - 30 kW G006516-0 - 48 & 50 kW	Stainless Steel Fuel Lines	Some municipalities require the use of stainless steel fuel lines instead of the standard hoses provided with the diesel generator products. These stainless steel lines are fire resistant for additional safety.
G006510-0	E-Stop	E-stop allows for immediate fuel shutoff and generator shutdown in the event of an emergency.
006511-0	Spill Box Drainback Kit	The spill box drainback kit allows fuel that was captured in the 5-gallon spill box to be drained directly back into the fuel tank to avoid vapors.
G006588-1	Vent Extension Support Kit	The vent extension support kit consists of two aluminum plates with the appropriate pipe cutouts to secure the vent extension pipes coming through the top of the generator enclosure. It helps to minimize stress on the NPT fittings integrated on the tank and also helps protect against pests.
G006512-0	Lockable Fuel Cap	The cast iron, lockable fuel cap provides the ability to lock the fuel system to prevent unwanted fuel tampering or fuel siphoning.
G006572-0 - 15 & 20 kW G006571-0 - 30 kW G006570-0 - 48 & 50 kW	Maintenance Kits	The Protector Maintenance Kits offer all the hardware necessary to perform complete maintenance on Generac Protector generators.
G006560-0 - 15 & 20 kW G006559-0 - 30 kW G006558-0 - 48 & 50 kW	Cold Weather Kits	Recommended for generators installed in regions where the temperature regularly falls below 32 °F (0 °C). The Cold Weather Kits consist of a block heater with all necessary mounting hardware and a battery warmer with a thermostat built into the battery wrap.
G005704-0	Paint Kit	If the generator enclosure is scratched or damaged, it is important to touch-up the paint to protect from future corrosion. The paint kit includes the necessary paint to properly maintain or touch-up a generator enclosure.
G006664-0	Local Wireless Remote	Completely wireless and battery powered, Generac's wireless remote monitor provides you with instant status information without ever leaving the house.
G006665-0	Wireless Remote Extension Harness	Recommended for use with the Wireless Remote on units up to 60 kW, required for use on units 70 kW or greater.
G006873-0	Smart Management Module (50 Amps)	Manage large loads by utilizing up to 8 individual Smart Management modules. These devices are installed directly in line with existing appliance wiring for easy installation.



Exhibit F

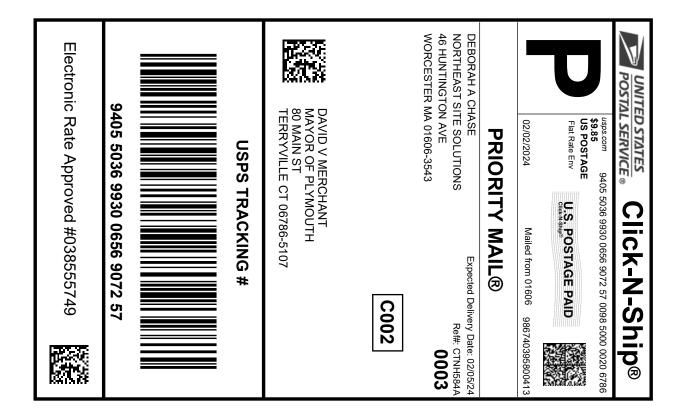



Instructions

- 1. Each Click-N-Ship® label is unique. Labels are to be used as printed and used only once. DO NOT PHOTO **COPY OR ALTER LABEL.**
- 2. Place your label so it does not wrap around the edge of the package.
- 3. Adhere your label to the package. A self-adhesive label is recommended. If tape or glue is used, DO NOT TAPE OVER BARCODE. Be sure all edges are secure.
- 4. To mail your package with PC Postage®, you may schedule a Package Pickup online, hand to your letter carrier, take to a Post Office™, or drop in a USPS collection box.
- 5. Mail your package on the "Ship Date" you selected when creating this label.

Click-N-Ship® Label Record

USPS TRACKING #: 9405 5036 9930 0656 9072 57

599592194 02/02/2024 02/02/2024 Trans. #: Print Date: 02/05/2024 Delivery Date:

Priority Mail® Postage: Total:

\$9.85 \$9.85

Ref#: CTNH584A

From: DEBORAH A CHASE

NORTHEAST SITE SOLUTIONS


46 HUNTINGTON AVE WORCESTER MA 01606-3543

DAVID V MERCHANT

MAYOR OF PLYMOUTH

80 MAIN ST

TERRYVILLE CT 06786-5107

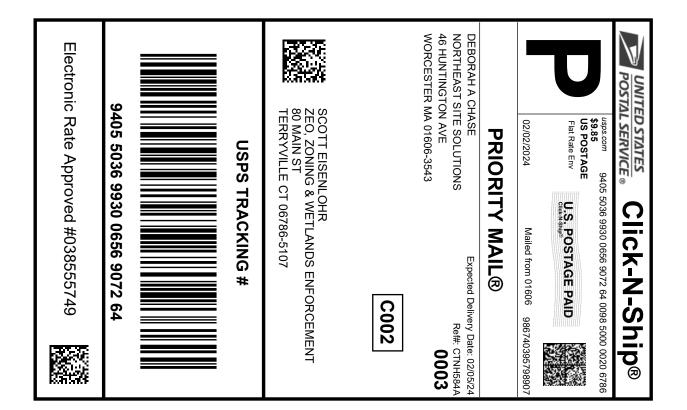



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Click-N-Ship® Label Record

USPS TRACKING #: 9405 5036 9930 0656 9072 64

599592194 02/02/2024 02/02/2024 Trans. #: Print Date: 02/05/2024 Delivery Date:

Priority Mail® Postage: Total:

\$9.85 \$9.85

Ref#: CTNH584A

From: **DEBORAH A CHASE**

NORTHEAST SITE SOLUTIONS


46 HUNTINGTON AVE WORCESTER MA 01606-3543

SCOTT EISENLOHR

ZEO, ZONING & WETLANDS ENFORCEMENT OFFICER

80 MAIN ST

TERRYVILLE CT 06786-5107

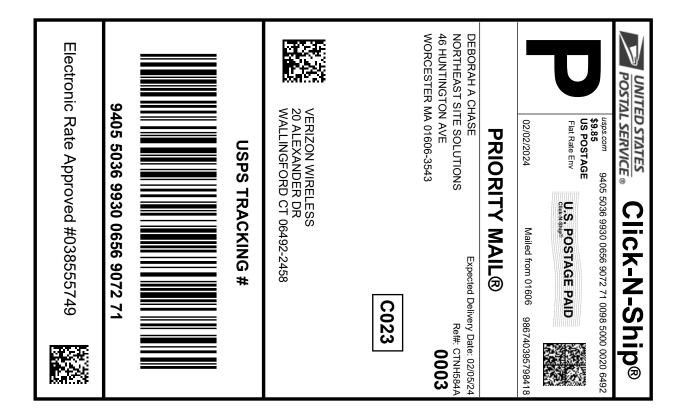



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USPS TRACKING #: 9405 5036 9930 0656 9072 71

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Priority Mail® Postage: Total:

\$9.85 \$9.85

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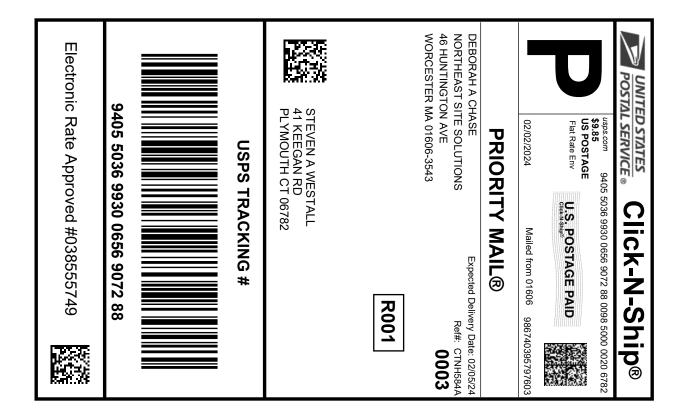
From: DEBORAH A CHASE

NORTHEAST SITE SOLUTIONS

46 HUNTINGTON AVE WORCESTER MA 01606-3543

VERIZON WIRELESS 20 ALEXANDER DR

WALLINGFORD CT 06492-2458





Instructions

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599592194 02/02/2024 02/02/2024 Trans. #: Print Date: 02/05/2024 Delivery Date:

Priority Mail® Postage: Total:

\$9.85 \$9.85

Ref#: CTNH584A

From: DEBORAH A CHASE

NORTHEAST SITE SOLUTIONS

46 HUNTINGTON AVE WORCESTER MA 01606-3543

STEVEN A WESTALL

41 KEEGAN RD PLYMOUTH CT 06782

CTNH584A-NHD



LINCOLN MALL 560 LINCOLN ST STE 8 WORCESTER, MA 01605-1925 (800)275-8777

02/02/2024	(800)275-8	777	
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Product	Qty	Unit Price	Price
	7.70 oz ate:	9072 57	\$0.00
Prepaid Mail Terryville, (Weight: O lb Acceptance Da Fri 02/02 Tracking #: 9405 5036	7.70 oz	9072 64	\$0.00
Prepaid Mail Wallingford, Weight: 0 lb Acceptance Da Fri 02/02 Tracking #: 9405 5036	7.70 oz te:	9072 71	\$0.00
Prepaid Mail Plymouth, CT-(Weight: 0 1b Acceptance Dat Fri 02/02/ Tracking #: 9405 5036	ie:	9072 88	\$0.00
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