

August 31, 2017

Melanie A. Bachman Acting Executive Director Connecticut Siting Council 10 Franklin Square New Britain, CT 06051

**RE:** Notice of Exempt Modification for Sprint/ Crown Site BU: 806939

**Sprint Site ID: CT03XC019** 

800 OGG Meadow Road Orange, CT 06477

Latitude: 41° 18' 28.36"/ Longitude: -73° 01' 56.22"

Dear Ms. Bachman:

Sprint currently maintains three (3) antennas at the 137-foot level of the existing 161-foot monopole tower at 800 OGG Meadow Road in Orange, Connecticut. The tower is owned by Crown Castle. The property is owned by the South Central Connecticut Regional Water Authority. Sprint intends to install (3) antennas and (3) RRUs with (1) hybrid cable.

This facility was approved by the Council on August 6, 1997, Docket No. 177A, subject to the following conditions:

- 1. The towers shall be constructed as proposed, no taller than necessary to provide the proposed communications service, sufficient to accommodate the antennas of BANM, Springwich Cellular Limited Partnership (Springwich), Smart SMR of New York, Inc. d/b/a Nextel Communications (Nextel), and Sprint Spectrum L.P. d/b/a Sprint PCS (Sprint). Neither tower, excluding antennas, shall exceed 160 feet above ground level.
- 2. The Certificate Holder shall prepare Development and Management (D&M) Plans for the prime A and prime B sites in compliance with Sections 16-50j-75 through 16-50j-77 of the Regulations of Connecticut State Agencies. The D&M Plans shall be submitted to and approved by the Council prior to the commencement of facility construction. The prime A D&M plan shall include a tower and foundation plan, signed by a professionally licensed engineer, designed to be safe and adequate to protect the electric supply system, and provisions for landscaping, architectural treatment, and traffic management consistent with terms established with the Town. The prime B D&M plan shall include relocation of the prime B tower within the leased parcel to prevent the fall zone of the tower from crossing paved sections of the Route 15 right-of-way; a tower and foundation plan, signed by a professionally licensed engineer; plans for dewatering the site if necessary; installation of a propane tank to fuel the emergency generator; placement of a

The Foundation for a Wireless World.

CrownCastle.com

counter-sunk and sealed concrete floor for the equipment building; traffic management with schedule to construct during daytime hours; and best management practices for on-site use of construction equipment. In addition, we will require landscaping and the establishment of vegetation to stabilize the site consistent with watershed management plans. Both site plans shall provide specifications for the placement of all antennas to be attached to the towers, and plans for the equipment buildings, foundation pads for Sprint's equipment, security fencing and gate, access roads, utility lines, site clearing, tree trimming, and erosion and sedimentation control consistent with the Connecticut Guidelines for Soil Erosion and Sediment Control, as amended.

- 3. Consistent with Section 16-50j-77 of the Regulations of Connecticut State Agencies, the Certificate Holder shall provide the Council notification of:
  - a. commencement of construction;
  - b. completion of construction;
  - c. completion of site rehabilitation;
  - d. commencement of operation;
  - e. transfer of ownership of the prime A tower to the Town of Orange; and
  - f. final construction cost.
- 4. Upon the establishment of any new State or federal radio frequency power density standards applicable to frequencies of this facility, the facility granted herein shall be brought into compliance with such standards.
- 5. The Certificate Holder shall provide the Council a recalculated report of electromagnetic radio frequency power density if and when circumstances in operation cause a change in power density above the levels originally calculated and provided in the application.
- 6. The Certificate Holder shall permit public or private entities to share space on the proposed tower for fair consideration, or shall provide any requesting entity with specific legal, technical, environmental, or economic reasons precluding such tower sharing.
- 7. If the facility does not initially provide, or permanently ceases to provide telecommunications services following completion of construction, this Decision and Order shall be void, and the Certificate Holder shall dismantle the tower and remove all associated equipment or reapplication for any continued or new use shall be made to the Council before any such use is made.
- 8. Unless otherwise approved by the Council, this Decision and Order shall be void if all construction authorized herein is not completed within three years of the effective date of this Decision and Order or within three years after all appeals to this Decision and Order have been resolved.

The proposed Sprint installation complies with the aforementioned conditions.

Please accept this letter as notification pursuant to Regulations of Connecticut State Agencies § 16-50j-73, for construction that constitutes an exempt modification pursuant to R.C.S.A. § 16-50j-72(b)(2). In accordance with R.S.C.A. § 16-50j-73, a copy of this letter is being sent The Honorable James Zeoli, First Selectman of the Town of Orange, the Town Zoning Administrator and Enforcement Officer Paul Dinice, and to the land owner the South Central Connecticut Regional Water Authority. Crown Castle is the tower owner.

- 1. The proposed modifications will not result in an increase in the height of the existing tower.
- 2. The proposed modifications will not require the extension of the site boundary.
- 3. The proposed modification will not increase noise levels at the facility by six decibels or more, or to levels that exceed state and local criteria.
- 4. The operation of the replacement antennas will not increase radio frequency emissions at the facility to a level at or above the Federal Communication Commission safety standard.
- 5. The proposed modifications will not cause a change or alteration in the physical or environmental characteristics of the site.
- 6. The existing structure and its foundation can support the proposed loading.

For the foregoing reasons, Sprint respectfully submits that the proposed modifications to the above-reference telecommunications facility constitutes an exempt modification under R.C.S.A. § 16-50j-72(b)(2). Please send approval/rejection letter to Attn: Jeffrey Barbadora.

# Sincerely,

Jeffrey Barbadora Real Estate Specialist 12 Gill Street, Suite 5800, Woburn, MA 01801 781-729-0053 Jeff.Barbadora@crowncastle.com

### Attachments:

Tab 1: Exhibit-1: Compound plan and elevation depicting the planned changes


Tab 2: Exhibit-2: Structural Modification Report

Tab 3: Exhibit-3: General Power Density Table Report (RF Emissions Analysis Report)

cc: The Honorable James Zeoli, First Selectman Town of Orange Orange Town Hall 617 Orange Center Road Orange, CT 06477

> Paul Dinice, ZEO Orange Town Hall 617 Orange Center Road Orange, CT 06477

South Central Connecticut Regional Water Authority Attn: Dianne L. Tompkins, Senior Land Use Manager 30 Sargent Drive New Haven, CT 06511-5966

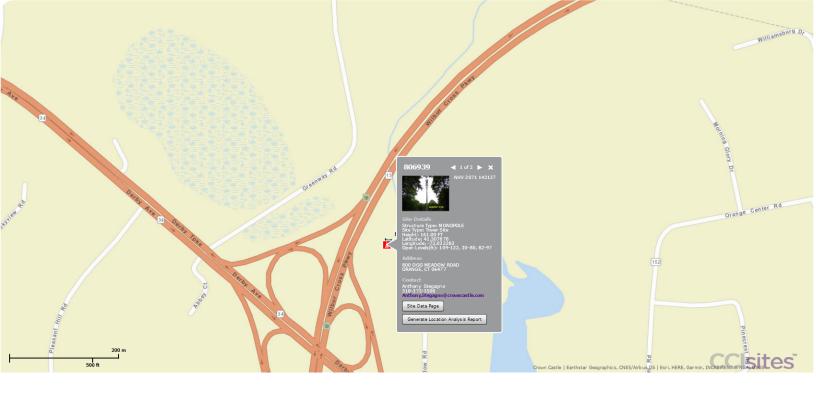

Lagrand

The State of Contract (Contract) (Contract) (Contract)

Amendment of Contract (Contract)

Amendment of Contract (Contract)

Amendment of Contract (Contract)

Amendment of Contract

# **800 OGG MEADOW RD**

**Location** 800 OGG MEADOW RD **Assessment** \$78,500

**Mblu** 97/ 4/ 2-1/ / **Appraisal** \$112,000

**Acct#** 85805 **PID** 5565

Owner SOUTH CENTRAL REGIONAL Building Count 1

WATER AUTHORITY

#### **Current Value**

Appraisal				
Valuation Year	Improvements	Land	Total	
2014	\$24,800	\$87,200	9112,000	
	Assessment			
Valuation Year	Improvements	Land	Total	
2014	\$17,500	\$61,000	\$78,500	

## **Owner of Record**

Owner SOUTH CENTRAL REGIONAL WATER AUTHORITY

**Co-Owner** C/O CROWN ATLANTIC COMPANY LLC

**Address** 4017 WASHINGTON ROAD

PMB 353

MCMURRAY, PA 15317

Sale Price \$0
Certificate
Book & Page
Sale Date

# **Ownership History**

Ownership History				
Owner	Sale Price	Certificate	Book & Page	Sale Date
SOUTH CENTRAL REGIONAL WATER AUTHORITY				

# **Building Information**

## **Building 1: Section 1**

Year Built:

Living Area: Replacement Cost

**Less Depreciation:** \$0

Building Attributes				
	Field	Description		
	Style	Vacant Land		
	Model			
	Stories			
	Exterior Wall 1			
	Exterior Wall 2			

0

# **Building Photo**

	1
Roof Structure	
Roof Cover	
Interior Wall 1	
Interior Wall 2	
Interior Floor 1	
Interior Floor 2	
Heat Fuel	
Heat Type	
AC Type	
Bedrooms	
Full Baths	
Half Baths	
Extra Fixtures	
Total Rooms	
Stacks	
Fireplace(s)	
Gas Fireplace(s)	
Attic	
Frame	
Traffic	
Bsmt Gar(s)	
SF FBM	
Basement	
Bsmt Floor	



# **Building Layout**

**S** Building

Building Sub-Areas	<u>Legend</u>
No Data for Building Sub-Areas	

# **Extra Features**

Extra Features <u>I</u>	<u>Legend</u>
No Data for Extra Features	

# Land

Land Use		Land Line Valuation	
Use Code	520	Size (Acres)	0.23
Description	Comm Vacant	Frontage	
Zone	RES	Depth	
Neighborhood	010	Assessed Value	\$61,000
Alt Land Appr	No	Appraised Value	\$87,200
Category			

# Outbuildings

Outbuildings					Legend	
Code	Description	Sub Code	Sub Description	Size	Value	Bldg #
SHD1	Shed - Wood			400 UNITS	\$5,500	1

SHD1	Shed - Wood		400 UNITS	\$5,500	1
SHD9	Shed - Block		400 UNITS	\$6,300	1
SHD7	Cell Shed		200 UNITS	\$7,500	1

# **Valuation History**

Appraisal				
Valuation Year	Improvements	Land	Total	
2013	\$24,800	\$87,200	\$112,000	
2012	\$24,800	\$87,200	\$112,000	
2011	\$0	\$96,600	\$96,600	

Assessment				
Valuation Year	Improvements	Land	Total	
2013	\$17,500	\$61,000	\$78,500	
2012	\$17,500	\$61,000	\$78,500	
2011	\$0	\$67,600	\$67,600	

<sup>(</sup>c) 2014 Vision Government Solutions, Inc. All rights reserved.





Search



# CONNECTICUT SITING COUNCIL

Home

About Us

**Pending Matters** 

Decisions

Forms

Contact Us



Filing Guides

Meetings & Minutes

Public Participation

Audio Link to New Britain Hearing Rooms

Programs & Services

Telecommunications Database

Publications

Other Resources

Statutes & Regulations

Electric Transmission Upgrade Projects

Frequently Asked













Robert Stein Chairman

Melanie Bachman, Executive Director

#### **NOTICE TO USERS**

The Connecticut Siting Council posts filed documents to this site as a public service. The Council disclaims any liability for the content of submissions made by parties, intervenors, public officials, and the general public. Further, while the Council seeks to be complete in its postlings, the Council urges users of this site to confirm with the submitter the completeness of the postings made. The posting of any document does not constitute or imply endorsement by the Connecticut Siting Council. Finally, the

DOCKET NO. 177A - An amended application of Cellco Partnership d/b/a Bell Atlantic NYNEX Mobile for a Certificate of Environmental Compatibility and Public Need for a two cell-site configuration in the Town of Orange. The proposed Prime A site would be located approximately 875 feet east of Orange Center Road at the rear of the High Plains Community Center, 525 Orange Center Road, with the Prime B site located approximately 400 feet northwest from the end of Ogg Meadow Road. These sites would replace the previously proposed Camp Cedarcrest site. A proposed alternate site is located within a 5.5 acre parcel of property approximately 250 feet south and west of Robert Treat Drive Extension, Orange, Connecticut.

#### ConnecticutSitingCouncil

August 6, 1997

#### **Decision and Order**

Pursuant to the foregoing Findings of Fact and Opinion, the Connecticut Siting Council (Council) finds that the effects associated with the construction, operation, and maintenance of a two-cell site configuration consisting of a prime A site at the High Plains Community Center property on Orange Center Road and a prime B site on South Central Regional Water Authority (SCRWA) property located off the end of Ogg Meadow Road in Orange, Connecticut, including effects on the natural environment; ecological integrity and balance; public health and safety; scenic, historic, and recreational values; forests and parks; air and water purity; and fish and wildlife are not disproportionate either alone or cumulatively with other effects when compared to need, are not in conflict with the policies of the State concerning such effects, and are not sufficient reason to deny the application and therefore directs that a Certificate of Environmental Compatibility and Public Need, as provided by General Statutes § 16-50k, be issued to Cellco Partnership d/b/a Bell Atlantic NYNEX Mobile (BANM) for the construction, operation, and maintenance of two cellular telecommunications towers and associated equipment. We deny the alternate site on Robert Treat Drive Extension

The facilities shall be constructed, operated, and maintained substantially as specified in the Council's record in this matter, and subject to the following conditions:

- 1. The towers shall be constructed as proposed, no taller than necessary to provide the proposed communications service, sufficient to accommodate the antennas of BANM, Springwich Cellular Limited Partnership (Springwich), Smart SMR of New York, Inc. d/b/a Nextel Communications (Nextel), and Sprint Spectrum L.P. d/b/a Sprint PCS (Sprint). Neither tower, excluding antennas, shall exceed 160 feet above ground level.
- 2. The Certificate Holder shall prepare Development and Management (D&M) Plans for the prime A amd prime B sites in compliance with Sections 16-50j-75 through 16-50j-77 of the Regulations of Connecticut State Agencies. The D&M Plans shall be submitted to and approved by the Council prior to the commencement of facility construction. The prime A D&M plan shall include a tower and foundation plan, signed by a professionally licensed engineer, designed to be safe and adequate to protect the electric supply system, and provisions for landscaping, architectural treatment, and traffic management consistent with terms established with the Town. The prime B D&M plan shall include relocation of the prime B tower within the leased parcel to prevent the fall zone of the tower from crossing paved sections of the Route 15 rightof-way; a tower and foundation plan, signed by a professionally licensed engineer; plans for dewatering the site if necessary; installation of a propane tank to fuel the emergency generator; placement of a countersunk and sealed concrete floor for the equipment building; traffic management with schedule to construct during daytime hours; and best management practices for on-site use of construction equipment. In addition, we will require landscaping and the establishment of vegetation to stabilize the site consistent with watershed management plans. Both site plans shall provide specifications for the placement of all antennas to be attached to the towers, and plans for the equipment buildings, foundation pads for Sprint's equipment, security fencing and gate, access roads, utility lines, site clearing, tree trimming, and erosion and sedimentation control consistent with the Connecticut Guidelines for Soil Erosion and Sediment Control, as amended.
- 3. Consistent with Section 16-50j-77 of the Regulations of Connecticut State Agencies, the Certificate Holder shall provide the Council notification of:
  - a. commencement of construction;
  - b. completion of construction;
  - c. completion of site rehabilitation;
  - d. commencement of operation:
  - e. transfer of ownership of the prime A tower to the Town of Orange; and
  - f. final construction cost.

Connecticut Siting Council assumes no responsibility for the use of documents posted on this site.

For further information about the proper use of material posted on this site, please see the State of Connecticut disclaimer.

- 4. Upon the establishment of any new State or federal radio frequency power density standards applicable to frequencies of this facility, the facility granted herein shall be brought into compliance with such standards.
- 5. The Certificate Holder shall provide the Council a recalculated report of electromagnetic radio frequency power density if and when circumstances in operation cause a change in power density above the levels originally calculated and provided in the application.
- 6. The Certificate Holder shall permit public or private entities to share space on the proposed tower for fair consideration, or shall provide any requesting entity with specific legal, technical, environmental, or economic reasons precluding such tower sharing.
- 7. If the facility does not initially provide, or permanently ceases to provide telecommunications services following completion of construction, this Decision and Order shall be void, and the Certificate Holder shall dismantle the tower and remove all associated equipment or reapplication for any continued or new use shall be made to the Council before any such use is made.
- 8. Unless otherwise approved by the Council, this Decision and Order shall be void if all construction authorized herein is not completed within three years of the effective date of this Decision and Order or within three years after all appeals to this Decision and Order have been resolved.

Pursuant to General Statutes § 16-50p, we hereby direct that a copy of the Findings of Fact, Opinion, and Decision and Order be served on each person listed below, and notice of issuance shall be published in the New Haven Register.

By this Decision and Order, the Council disposes of the legal rights, duties, and privileges of each party named or admitted to the proceeding in accordance with Section 16-50j-17 of the Regulations of Connecticut State Agencies.

The parties and intervenors to this proceeding are:

#### **APPLICANT**

Cellco Partnership d/b/a

#### ITS REPRESENTATIVE

Kenneth C. Baldwin, Esq. Brian C. S. Freeman, Esq. Bell Atlantic NYNEX Mobile Robinson & Cole One Commercial Plaza

One Commercial Plaza Hartford, CT 06103-3597

Mr. David S. Malko, P.E.

Jennifer Young Gaudet, Mgr. - Regulatory

Bell Atlantic NYNEX Mobile 20 Alexander Drive Wallingford, CT 06492

#### PARTY

Residents of Robert Treat Extension, Elvera Spinaci Ross Court, and Mapledale Road 829 Robert Treat Extension Orange, CT 06477

#### INTERVENOR

Eugene Burshuliak 864 Mapledale Road Orange, CT 06477

#### INTERVENOR

Springwich Cellular Limited Partnership

#### ITS REPRESENTATIVE

Peter J. Tyrrell, Esq.

Springwich Cellular Limited Partnership 500 Enterprise Drive Rocky Hill, CT 06067-3900

# ITS REPRESENTATIVE

Francis A. Teodosio, Esq. Orange Town Hall 617 Orange Center Road Orange, CT 06477

#### INTERVENOR

Town of Orange

Smart SMR of New York, Inc.

# ITS REPRESENTATIVE

Christopher B. Fisher, Esq.

d/b/a Nextel Communications Cuddy, Feder & Worby

90 Maple Avenue

White Plains, NY 10601-5196

# PARTY

PARTY

John Rechi 805 Grassy Hill Road Orange, CT 06477

#### PARTY

Erwin H. Levine

875 Robert Treat Extension

Orange, CT 06477

PARTY

Jeffery Friedrichs 248 Ross Court Orange, CT 06477

PARTY

INTERVENOR

Sprint Spectrum L.P.

Orange Land Trust, Inc.

Edmund B. Tucker, President Orange Land Trust, Inc. 433 Pudden Lane Orange, CT 06477

ITS REPRESENTATIVE

ITS REPRESENTATIVE

Elias A. Alexiades, Esq. d/b/a Sprint PCS Andrew C. Kruger, Esq.

Harris, Beach & Wilcox, LLP 147 North Broad Street Milford, CT 06460

**PARTY** 

Jay Nastri 820 Ogg Meadow Road Orange, CT 06477

Content Last Modified on 8/9/2002 12:03:42 PM

Ten Franklin Square New Britain, CT 06051 / 860- 827-2935

Home | CT.gov Home | Send Feedback | Login | Register State of Connecticut Disclaimer, Privacy Policy, and Web Site Accessibility Policy. Copyright © 2002-2017 State of Connecticut.





SITE NUMBER:

CT03XC019

SITE NAME:

ORANGE

SITE ADDRESS:

800 OGG MEADOW RD ORANGE, CT 06477

SITE

CROWN ID#: 806939 CROWN SITE NAME: ORANGE

CT03XC019

ORANGE

NEW HAVEN

201'± AMSL

137'-0"± AGL

TOWN OF ORANGE

97 4 2-1

RES

41° 18' 28.36"N

73° 1' 56.22"W

800 OGG MEADOW RD ORANGE, CT 06477

SITE NUMBER:

SITE NAME:

COUNTY:

(NAD 83)

SITE ADDRESS:

COORDINATES:

GROUND ELEV:

STRUCTURE

ZONING JURISDICTION:

PARCEL ID:

CLASSIFICATION:

STRUCTURE TYPE: MONOPOLE

STRUCTURE HEIGHT: 161'-0"± AGL

SHEET INFORMATION

LANDLORD:

COMPANY:

APPLICANT:

ENGINEER:

SPRINT CM:

CROWN CM:

LOCAL POWER

CROWN CASTLE USA 2000 CORPORATE DRIVE

CONNECTICUT LIGHT AND

SPRINT 6580 SPRINT PARKWAY OVERLAND PARK, KANSAS 66251

JAMES QUICKSELL

GARY WOOD

(860) 940-9168

JASON D'AMICO

(860) 209-0104

FIBERTECH


CONTACT CUSTOMER SERVICE (800) 286-2000

(845) 567-6656 EXT. 2835 JQuicksell@tectonicengineering.com

jason.d'amico@crowncastle.com

CANONSBURG, PA

POWER

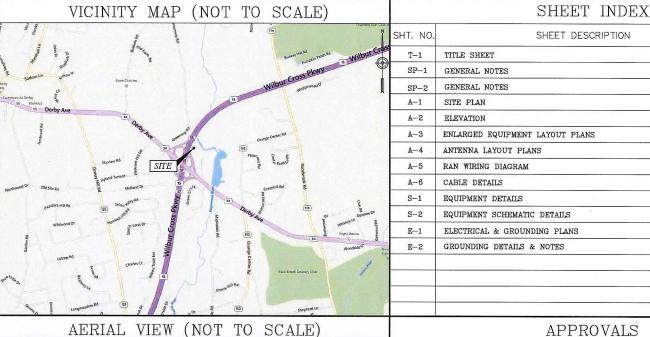

# APPROVALS

THE FOLLOWING PARTIES HEREBY APPROVE AND ACCEPT THESE DOCUMENTS AND AUTHORIZE THE CONTRACTOR TO PROCEED WITH THE CONSTRUCTION DESCRIBED HEREIN. ALL DOCUMENTS ARE SUBJECT TO REVIEW BY THE LOCAL BUILDING DEPARTMENT AND MAY IMPOSE CHANGES OR MODIFICATIONS.

CONSTRUCTION:	DATE:	
LEASING/ SITE ACQUISITION:	DATE:	
LANDLORD/ PROPERTY OWNER:	DATE:	
R.F. ENGINEER:	DATE:	

# CALL TOLL FREE FOR CONNECTICUT



6580 SPRINT PARKWAY **OVERLAND PARK, KANSAS 66251** 



# TECTONIC

TECTONIC Engineering & Surveying

1279 Route 300 Newburgh, NY 12550 Phone: (845) 567-6656 Fax: (845) 567-8703

		: 7225.CT03XC0I9	T
0 0	06/11/14	DESCRIPTION FOR COMMENT	BY
1	10/28/14	FOR CONSTRUCTION	DC

DATE REVIEWED BY



CT03XC019

SITE NAME: ORANGE

SITE ADDRESS:

800 OGG MEADOW RD ORANGE, CT 06477

> SHEET TITLE: TITLE SHEET

SHEET NO:

T-1

THIS IS AN UNMANNED TELECOMMUNICATION FACILITY AND NOT FOR HUMAN HABITATION: HANDICAP ACCESS REQUIREMENTS ARE NOT REQUIRED. FACILITY HAS NO PLUMBING OR REFRIGERANTS. THIS FACILITY SHALL MEET OR EXCEED ALL FAA AND FCC REGULATOR REQUIREMENTS. CONTRACTOR SHALL VERIFY ALL PLANS AND EXISTING DIMENSIONS AND CONDITIONS ON THE JOB SITE AND SHALL IMMEDIATELY NOTIFY THE PROJECT OWNER'S REPRESENTATIVE IN WRITING OF DISCREPANCIES BEFORE PROCEEDING WITH THE WORK

GENERAL NOTES

OR BE RESPONSIBLE FOR SAME

DEVELOPMENT AND USE OF THIS SITE WILL CONFORM TO ALL APPLICABLE CODES

- 2005 STATE OF CONNECTICUT BUILDING CODE.
- ANSI/TIA/EIA-222-F-1996.
  NATIONAL ELECTRICAL CODE, LATEST EDITION.

# PROJECT DESCRIPTION

- 1. (1) NEW 2.5 EQUIPMENT RACK INSIDE EXIST MMBTS CABINET.
- 2. (3) NEW RFS APXVTM14-C-120 ANTENNAS.
- 3. (3) NEW TD-RRH8x20-25 RRH.
- 4. (1) NEW 5/8" FIBER CABLE.

#### DIVISION 01000-GENERAL NOTES

- 1. THE CONTRACTOR SHALL GIVE ALL NOTICES AND COMPLY WITH ALL LAWS, ORDINANCES, RULES, REQULATIONS AND LAWFUL ORDERS OF ANY PUBLIC AUTHORITY, MUNICIPAL AND UTILITY COMPANY SPECIFICATIONS, AND LOCAL AND STATE JURISDICTIONAL CODES BEARING ON THE PERFORMANCE OF THE WORK. THE WORK PERFORMED ON THE PROJECT AND THE MATERIALS INSTALLED SHALL BE IN STRICT ACCORDANCE WITH ALL APPLICABLE CODES, REGULATIONS, AND ORDINANCES.
- 2. THE ARCHITECT/ENGINEER HAVE MADE EVERY EFFORT TO SET FORTH IN THE CONSTRUCTION AND CONTRACT DOCUMENTS THE COMPLETE SCOPE OF WORK. THE CONTRACTOR BIDDING THE JOB IS NEVERTHELESS CAUTIONED THAT MINOR OMISSIONS OR ERRORS IN THE DRAWNINGS AND OR SPECIFICATIONS SHALL NOT EXCUSE SAID CONTRACTOR FROM COMPLETING THE PROJECT AND IMPROVEMENTS IN ACCORDANCE WITH THE INTENT OF
- 3. THE CONTRACTOR OR BIDDER SHALL BEAR THE RESPONSIBILITY OF NOTIFYING (IN WRITING) THE PROJECT OWNER'S REPRESENTATIVE OF ANY CONFLICTS, ERRORS, OR OMISSIONS PRIOR TO THE SUBMISSION OF CONTRACTOR'S PROPOSAL OR PERFORMANCE OF WORK.
- 4. THE SCOPE OF WORK SHALL INCLUDE FURNISHING ALL MATERIALS, EQUIPMENT, LABOR AND ALL OTHER MATERIALS AND LABOR DEEMED NECESSARY TO COMPLETE THE WORK/PROJECT AS DESCRIBED HEREIN.
- 5. THE CONTRACTOR SHALL VISIT THE JOB SITE PRIOR TO THE SUBMISSION OF BIDS OR PERFORMING WORK TO FAMILIARIZE HIMSELF WITH THE FIELD CONDITIONS AND TO VERIFY THAT THE PROJECT CAN BE CONSTRUCTED IN ACCORDANCE WITH THE CONTRACT DOCUMENTS.
- 6. ONCE THE CONTRACTOR HAS RECEIVED AND ACCEPTED THE NOTICE TO PROCEED, CONTRACTOR WILL CONTACT THE CROWN CASTLE CONSTRUCTION MANAGER OF RECORD (NOTED ON THE FIRST PAGE ON THIS CONSTRUCTION DRAWING) A MINIMUM OF 48 HOURS PRIOR TO WORK START, UPON ARRIVAL TO THE JOB SITE, CONTRACTOR CREW IS REQUIRED. CALL 1-800-788-7011 TO NOTIFY THE CROWN CASTLE NOC WORK HAS
- 7. THE CONTRACTOR SHALL INSTALL ALL EQUIPMENT AND MATERIALS ACCORDING TO THE MANUFACTURER'S/VENDOR'S SPECIFICATIONS UNLESS NOTED OTHERWISE OR WHERE LOCAL CODES OR ORDINANCES TAKE
- 8, THE CONTRACTOR SHALL PROVIDE A FULL SET OF CONSTRUCTION DOCUMENTS AT THE SITE UPDATED WITH THE LATEST REVISIONS AND ADDENDUMS OR CLARIFICATIONS AVAILABLE FOR THE USE BY ALL PERSONNEL INVOLVED WITH THE PROJECT.
- 9. THE CONTRACTOR SHALL SUPERVISE AND DIRECT THE PROJECT DESCRIBED HEREIN. THE CONTRACTOR SHALL BE SOLELY RESPONSIBLE FOR ALL CONSTRUCTION MEANS, METHODS, TECHNIQUES, SEQUENCES AND PROCEDURES AND FOR COORDINATING ALL PORTIONS OF THE WORK UNDER
- 10. THE CONTRACTOR SHALL BE RESPONSIBLE FOR OBTAINING ALL PERMITS AND INSPECTIONS WHICH MAY BE REQUIRED FOR THE WORK BY THE ARCHITECT/ENGINEER, THE STATE, COUNTY OR LOCAL GOVERNMENT
- 11. THE CONTRACTOR SHALL MAKE NECESSARY PROVISIONS TO PROTECT EXISTING IMPROVEMENTS, EASEMENTS, PAVING, CURBING, ETC. DURING CONSTRUCTION. UPON COMPLETION OF WORK, THE CONTRACTOR SHALL REPAIR ANY DAMAGE THAT MAY HAVE OCCURRED DUE TO CONSTRUCTION
- 12. THE CONTRACTOR SHALL KEEP THE GENERAL WORK AREA CLEAN AND HAZARD FREE DURING CONSTRUCTION AND DISPOSE OF ALL DIRT, DEBRIS, RUBBISH AND REMOVE EQUIPMENT NOT SPECIFIED AS REMAINING ON THE PROPERTY. PREMISES SHALL BE LEFT IN CLEAN CONDITION AND FREE FROM PAINT SPOTS, DUST, OR SMUDGES OF ANY NATURE.
- 13. THE CONTRACTOR SHALL COMPLY WITH ALL PERTINENT SECTIONS OF THE 5. THE CONTRACTOR SHALL COMPLY WITH ALL PERTINENT SECTIONS OF THE BASIC STATE BUILDING CODE, LATEST EDITION, AND ALL OSHA REQUIREMENTS AS THEY APPLY TO THIS PROJECT. ALL EXISTING ACTIVE SEWER, WATER, GAS, ELECTRIC, AND OTHER UTILITIES WHERE ENCOUNTERED IN THE WORK SHALL BE PROTECTED AT ALL TIMES, AND WHERE REQUIRED FOR THE PROPER EXECUTION OF THE WORK SHALL BE RELOCATED AS DIRECTED BY THE ARCHITECT/ENGINEER. EXTREME CAUTION SHOULD BE USED BY THE CONTRACTOR WHEN EXCAVATING OR PIER DRILLING AROUND OR NEAR UTILITIES. THE CONTRACTOR SHALL PROVIDE SAFETY TRAINING FOR THE WORKING CREW. THIS WILL INCLUDE BUT NOT LIMITED TO A) FALL PROTECTION, B) CONFINED SPACE, C) ELECTRICAL SAFETY, D) TRENCHING AND EXCAVATION OF ALL EXISTING INACTIVE SEWER, WATER, GAS, ELECTRIC AND OTHER UTILITIES WHICH INTERFERE WITH THE EXECUTION OF THE WORK SHALL BE REMOVED AND OR CAPPEL PLUGGED OR OTHERWISE DISCONTINUED AT THE POINTS WHICH WILL NOT INTERFERE WITH THE EXECUTION OF THE WORK SUBJECT TO THE APPROVAL OF THE ARCHITECT/ENGINEER
- 14. THE CONTRACTOR SHALL NOTIFY THE PROJECT OWNER'S REPRESENTATIVE IN WRITING WHERE A CONFLICT OCCURS ON ANY OF THE CONTRACT DOCUMENTS. THE CONTRACTOR IS NOT TO ORDER MATERIAL OR CONSTRUCT ANY PORTION OF THE WORK THAT IS IN CONFLICT UNTIL CONFLICT IS RESOLVED BY THE LESSEE/LICENSEE REPRESENTATIVE.
- THE CONTRACTOR SHALL VERIFY ALL DIMENSIONS, ELEVATIONS, PROPERTY LINES, ETC. ON THE JOB.
- 16. THE CONTRACTOR SHALL NOTIFY THE THE RF ENGINEER FOR ANTENNA AZIMUTH VERIFICATION (DURING ANTENNA INSTALLATION) PRIOR TO CONDUCTING SWEEP TESTS.
- 17. THE CONTRACTOR SHALL SUBMIT AT THE END OF THE PROJECT A COMPLETE SET OF AS-BUILT DRAWINGS TO THE CLIENT REPRESENTATIVE.

- 18. REFER TO: CONSTRUCTION STANDARDS-SPRINT DOCUMENT EXHIBIT A-STANDARD CONSTRUCTION SPECIFICATIONS FOR WIRELESS SITES REV. 4.0- 02.15.2011.DOCM.
- 19. REFER TO: WEATHER PROOFING SPECS: EXCERPT EXH A-WIHRPRF-STD CONSTR SPECS.\_157201110421855492.DOCM.
- 20. REFER TO: COLOR CODING-SPRINT NEXTEL ANT AND LINE COLOR CODING
- 21. REFER TO LATEST DOCUMENTATION REVISION.

#### DIVISION 03000-CONCRETE

#### 1.03 APPLICABLE STANDARDS (USE LATEST EDITIONS)

- AC1-301 SPECIFICATIONS FOR STRUCTURAL CONCRETE FOR BUILDINGS. ACI-347 GUIDE TO FORM WORK FOR CONCRETE. ASTM C33- CONCRETE AGGREGATE
- ASTM C94 READY MIXED CONCRETE e. ASTM C150 PORTLAND CEMENT
- ASTM C260 AIR—ENTRAINING ADMIXTURES FOR CONCRETE
  ASTM C309— LIQUID MEMBRANE FORMING COMPOUNDS FOR CURING CONCRETE.
- ASTM C494 CHEMICAL ADMIXTURES FOR CONCRETE
- ASTM A615- DEFORMED AND PLAIN BILLET-STEEL BARS FOR CONCRETE REINFORCEMENT
- J. ASTM A185- STEEL WELDED WIRE FABRIC (PLAIN) FOR CONCRETE REINFORCEMENT

CONCRETE MATERIALS AND OPERATIONS SHALL BE TESTED AND INSPECTED BY THE ARCHITECT/ENGINEER AS DIRECTED BY THE CLIENT'S REPRESENTATIVE.

#### 3.04 SURFACE FINISHES

A. SURFACES AGAINST WHICH BACKFILL OR CONCRETE SHALL BE PLACED REQUIRE NO TREATMENT EXCEPT REPAIR OF DEFECTIVE AREAS.

B. SURFACES THAT WILL BE PERMANENTLY EXPOSED SHALL PRESENT A UNIFORM FINISH PROVIDED BY THE REMOVAL OF FINS AND THE FILLING HOLES AND OTHER IRREGULARITIES WITH DRY PACK GROUT, OR BY SACKING WITH UTILITY OR ORDINARY GROUT.

C. SURFACES THAT WOULD NORMALLY BE LEVEL AND WHICH WILL BE PERMANENTLY EXPOSED TO THE WEATHER SHALL BE SLOPED FOR DRAINAGE. UNLESS ENGINEER'S DESIGN DRAWING SPECIFIES A HORIZONTAL SURFACE OR SURFACES SUCH AS STAIR TREADS, WALLS, CURBS, AND PARAPETS SHALL BE SLOPED APPROXIMATELY 1/4" PER FOOT.

SURFACES THAT WILL BE COVERED BY BACKFILL OR CONCRETE

E. EXPOSED SLAB SURFACES SHALL BE CONSOLIDATED, SCREENED, FLOATED, AND STEEL TROWELED. HAND OR POWER-DRIVEN EQUIPMENT MAY BE USED FOR FLOATING, FLOATING SHALL BE STARTED AS SOON AS THE SCREENED SURFACE HAS ATTAINED A STIFFNESS TO PERMIT FINISHING OPERATIONS. OPERATIONS. ALL EDGES MUST HAVE A 3/4" CHAMFER

1.04 QUALITY ASSURANCE CONCRETE MATERIALS AND OPERATIONS SHALL BE TESTED AND INSPECTED BY THE ENGINEER.

#### 3.05 PATCHING

THE CONTRACTOR SHALL NOTIFY THE ENGINEER IMMEDIATELY UPON REMOVAL OF THE FORMS TO OBSERVE CONCRETE SURFACE CONDITIONS. IMPERFECTIONS SHALL BE PATCHED ACCORDING TO THE ENGINEER'S

#### 3.06 DEFECTIVE CONCRETE

THE CONTRACTOR SHALL NOTIFY OR REPLACE CONCRETE NOT CONFORMING TO REQUIRED LEVELS AND LINES, DETAILS, AND ELEVATIONS AS SPECIFIED IN ACI 301.

A. IMMEDIATELY AFTER PLACEMENT. THE CONTRACTOR SHALL PROTECT THE CONCRETE FROM PREMATURE DRYING, EXCESSIVELY HOT OR COLD TEMPERATURES, AND MECHANICAL INJURY. FINISHED WORK SHALL BE PROTECTED.

CONCRETE SHALL BE MAINTAINED WITH MINIMAL MOISTURE LOSS AT RELATIVELY CONSTANT TEMPERATURE FOR PERIOD NECESSARY FOR HYDRATION OF CEMENT AND HARDENING OF CONCRETE.

C. ALL CONCRETE SHALL BE WATER CURED PER ACCEPTABLE PRACTICES SPECIFIED BY ACI CODE (LATEST EDITION)

#### DIVISION 05000 - METALS

#### PART 1 - GENERAL

#### 1.01 WORK INCLUDED

- A. THE WORK CONSISTS OF THE FABRICATION AND INSTALLATION OF ALL MATERIALS TO BE FURNISHED. AND WITHOUT LIMITING THE GENERALITY THEREOF, INCLUDING ALL EQUIPMENT, LABOR AND SERVICES REQUIRED FOR ALL STRUCTURAL STEEL WORK AND ALL ITEMS INCIDENTAL AS SPECIFIED AND AS SHOWN ON THE DRAWINGS
- STEEL FRAMING INCLUDING BEAMS, ANGLES, CHANNELS AND PLATES.
- WELDING AND BOLTING OF ATTACHMENTS.

#### 1.02 REFERENCE STANDARDS

- A. THE WORK SHALL CONFORM TO THE CODES AND STANDARDS OF THE FOLLOWING AGENCIES AS FURTHER CITED HEREIN:
- ASTM: AMERICAN SOCIETY FOR TESTING AND MATERIALS AS PUBLISHED IN "COMPILATION OF ASTM STANDARDS IN BUILDING CODES" OR LATEST EDITION
- OR LATEST EDITION.

  AWS: AMERICAN WELDING SOCIETY CODE OR LATEST EDITION.

  AISC: AMERICAN INSTITUTE OF STEEL CONSTRUCTION,

  "SPECIFICATION FOR THE DESIGN, FABRICATION AND ERECTION OF STRUCTURAL STEEL FOR BUILDINGS" (LATEST EDITION).

#### PART 2 - PRODUCTS 2.01 MATERIALS

A. STRUCTURAL STEEL: SHALL COMPLY WITH THE REQUIREMENTS OF ASTM A36 AND A992 FOR STRUCTURAL STEEL,

ALL PROPOSED STRUCTURAL STEEL SHALL BE FABRICATED AND ERECTED IN ACCORDANCE WITH AISC CODE AND ASTM SPECIFICATIONS (LATEST EDITION) ALL NEW STEEL SHALL CONFORM TO THE FOLLOWING.

- STRUCTURAL WIDE FLANGE: ASTM A992 Fv=50KSL 2. MISCELLANEOUS STEEL (PLATES), CHANNELS, ANGLES, ETC): ASTM A36 (Fy=36KSI). 3.STRUCTURAL TUBING: ASTM A500 Gr. B (Fy=46KSI).
- 4. STEEL PIPE: ASTM A53 Gr B (Fy=35KSI).

#### 2 02 WELDING

- A. ALL WELDING SHALL BE DONE BY CERTIFIED WELDERS, CERTIFICATION DOCUMENTS SHALL BE MADE AVAILABLE FOR ENGINEER'S AND/OR OWNER'S REVIEW IF REQUESTED.
- WELDING ELECTRODES FOR MANUAL SHIELDED METAL ARC WELDING SHALL CONFORM TO ASTM 1-233, E70 SERIES. BARE ELECTRODES AND GRANULAR FLUX USED IN THE SUBMERGED ARC PROCESS SHALL CONFORM TO AISC SPECIFICATIONS
- FIELD WELDING SHALL BE DONE AS PER AWS D1.1 REQUIREMENTS VISUAL
- D. STUD WELDING SHALL BE ACCOMPLISHED BY CAPACITOR DISCHARGE (CD) WELDING TECHNIQUE USING CAPACITOR DISCHARGE STUD WELDER.
- PROVIDE STUD FASTENERS OF MATERIALS AND SIZES SHOWN ON DRAWINGS OR AS RECOMMENDED BY THE MANUFACTURER FOR STRUCTURAL LOADINGS REQUIRED
- FOLLOW MANUFACTURERS SPECIFICATIONS AND INSTRUCTIONS TO PROPERLY SELECT AND INSTALL STUD WELDS.

#### 2.03 BOLTING

- BOLTS SHALL BE CONFORMING TO ASTM A35 HIGH STRENGTH HOT DIP GALVANIZED WITH ASTM A153 HEAVY HEX TYPE NUTS.
- BOLTS SHALL BE 3/4" (MINIMUM) CONFORMING TO ASTM A325, HOT DIP GALVANIZED, ASTM A153 NUTS SHALL BE HEAVY HEX TYPE.
- ALL CONNECTIONS SHALL BE 2 BOLTS MINIMUM.
- EXCEPT WHERE SHOWN, ALL BEAM TO BEAM AND BEAM TO COLUMN CONNECTIONS TO BE DOUBLE ANGLED CONNECTIONS WITH HIGH STRENGTH BOLTS (THREADS EXCLUDED FROM SHEAR PLANE) AND
- E. STANDARD, OVERSIZED OR HORIZONTAL SHORT SLOTTED HOLES.
- SNUG-TIGHT STRENGTH BEARING BOLTS MAY BE USED IN STANDARD HOLES CONFORMING TO ACIS, USING THE TURN OF THE NUT METHOD.
- FULLY-TENSIONED HIGH STRENGTH (SLIP CRITICAL) SHALL BE USED IN OVERSIZED SLOT HOLES (RESPECTIVE OF SLOT ORIENTATION).
- ALL BRACED CONNECTION, MOMENT CONNECTION AND CONNECTIONS NOTED AS "SLIP CRITICAL" SHALL BE BE SLIP CRITICAL JOINTS WITH CLASS A SURFACE CONDITIONS, UNLESS OTHERWISE NOTED.
- EPOXY ANCHOR ASSEMBLIES SHALL BE AS MANUFACTURED BY HILTI OR ENGINEER APPROVED EQUAL, AS FOLLOWS:

#### BASE MATERIAL

#### ANCHOR SYSTEM

CONCRETE HOLLOW & GROUTED CMU OR BRICK

HILTI HIT-HY 200

#### 2.04 FABRICATION

A. FABRICATION OF STEEL SHALL CONFORM TO THE AISC AND AWS

#### 2.05 FINISH

A. STRUCTURAL STEEL EXPOSED TO WEATHER SHALL BE HOT-DIP GALVANIZED AFTER FABRICATION
IN ACCORDANCE WITH ASTM A123. (LATEST EDITION) UNLESS OTHERWISE NOTED

#### 2.06 PROTECTION

A. UPON COMPLETION OF ERECTION, INSPECT ALL GALVANIZED STEEL AND PAINT ANY FIELD CUTS, WELDS OR GALVANIZED BREAKS WITH (2) COATS OF ZINC, RICH COLD GALVANIZING PAINT.

#### PART 3 - FRECTION

- A. PROVIDE ALL ERECTION, EQUIPMENT, BRACING, PLANKING, FIELD BOLTS, NUTS, WASHERS, GRIFT PINS, AND SIMILAR MATERIALS WHICH DO NOT FORM A PART OF THE COMPLETED CONSTRUCTION, BUT ARE NECESSARY FOR ITS PROPER ERECTION.
- B. ERECT AND ANCHOR ALL STRUCTURAL STEEL IN ACCORDANCE WITH AISC REFERENCE STANDARDS. ALL WORK SHALL BE ACCURATELY SET TO ESTABLISHED SUITABLE ATTACHMENTS TO THE CONSTRUCTION OF THE BUILDING
- TEMPORARY BRACING, GUYING, AND SUPPORT SHALL BE PROVIDED TO KEEP THE STRUCTURE SHALL BE PROVIDED TO KEEP THE STRUCTURE SET AND ALIGNED AT ALL TIMES DURING CONSTRUCTION, AND TO PREVENT DANGER TO PERSONS AND PROPERTY. CHECK ALL TEMPORARY LOADS AND STAY WITHIN SAFE CAPACITY OF ALL BUILDING COMPONENTS.



6580 SPRINT PARKWAY

OVERLAND PARK, KANSAS 66251



# TECTONIC

www.tectonicengineering.com

TECTONIC Engineering & Surveying Consultants P.C.

1279 Route 300 Newburgh, NY 12550 Phone: (845) 567-6656 Fax: (845) 567-8703

THIS DOCUMENT IS THE CREATION, DESIGN, PROPERTY AND COPYRIGHTED WORK OF SPRINT COMMUNICATIONS, INC. ANY DUPLICATION OR USE WITHOUT EXPRESS WRITTEN CONSENT IS STRICTLY PROHIBITED, DUPLICATION AND USE BY GOVERNHEMENT AGENCIES FOR THE PURPOSES OF CONDUCTING THEIR CHAPFLICT AUTHORS OF THE AUTHORS OF THE PURPOSES OF CONDUCTING THEIR CAPFLICT AUTHORS OF THE PURPOSES OF CONDUCTING THEIR PURPOSES OF CONDUCTIONS IS SPECIFICALLY ALLOWED.

_			
	SL	JBMITTALS	
PRO	DJECT NO	7225.CT03XC0I9	
NO	DATE	DESCRIPTION	E
0	06/11/14	FOR COMMENT	1
Ì	10/28/14	FOR CONSTRUCTION	
			T
			T
			t

DATE	REVIEWED BY
- 98	1000000000
615.	MALL VA.
60, 45	SEAL



SITE NUMBER CT03XC019

SITE NAME:

ORANGE SITE ADDRESS

800 OGG MEADOW RD ORANGE, CT 06477

SHEET TITLE:

GENERAL NOTES

SHEET NO.

SP-1

#### DIVISION 13000-SPECIAL CONSTRUCTION ANTENNA INSTALLATION

PART 1 - GENERAL

1.01 WORK INCLUDED

A. ANTENNAS AND HYBRIFLEX CABLES ARE FURNISHED BY CLIENT'S REPRESENTATIVE UNDER SEPARATE CONTRACT. THE CONTRACTOR SHALL ASSIST ANTENNA INSTALLATION CONTRACTOR IN TERMS OF COORDINATION AND SITE ACCESS. ERECTION SUBCONTRACTOR SHALL BE RESPONSIBLE FOR THE PROPERTY.

- B. INSTALL ANTENNAS AS INDICATED ON DRAWINGS AND CLIENT'S REPRESENTATIVE SPECIFICATIONS.
- INSTALL GALVANIZED STEEL ANTENNA MOUNTS AS INDICATED ON
- D. INSTALL FURNISHED GALVANIZED STEEL OR ALUMINUM WAVEGUIDE AND PROVIDE PRINTOUT OF THAT RESULT
- INSTALL HYBRIFLEX CABLES AND TERMINATIONS BETWEEN ANTENNAS AND EQUIPMENT PER MANUFACTURER'S RECOMMENDATIONS.
  WEATHERPROOF ALL CONNECTORS BETWEEN THE ANTENNA AND EQUIPMENT PER MANUFACTURER'S REQUIREMENTS.
- ANTENNA AND HYBRIFLEX CABLE GROUNDING:
- ALL EXTERIOR #6 GREEN GROUND WIRE DAISY CHAIN CONNECTIONS ARE TO BE WEATHER SEALED WITH ANDREWS CONNECTOR/SPLICE WEATHERPROOFING KIT TYPE 3221213 OR
- ALL HYBRIFLEX CABLE GROUNDING KITS ARE TO BE INSTALLED ON STRAIGHT RUNS OF HYBRIFLEX CABLE (NOT WITHIN BENDS).

  1.02 RELATED WORK FURNISH THE FOLLOWING WORK AS SPECIFIED UNDER CONSTRUCTION DOCUMENTS, BUT COORDINATE WITH QOTHER TRADES PRIOR TO BID:
- FLASHING OF OPENING INTO OUTSIDE WALLS.
   SEALING AND CAULKING ALL OPENINGS.
   PAINTING.
   CUTTING AND PATCHING.

- 1.03 REQUIREMENTS OF REGULATOR AGENCIES
- A. FURNISH U.I. LISTED FQUIPMENT WHERE SUCH LABEL IS
- FURNISH U.L. LISTED EQUIPMENT WHERE SUCH LABEL IS AVAILABLE. INSTALL IN CONFORMANCE WITH U.L. STANDARDS WHERE APPLICABLE.
  INSTALL ANTENNA, ANTENNA CABLES, GROUNDING SYSTEM IN ACCORDANCE WITH DRAWINGS AND SPECIFICATIONS IN EFFECT AT PROJECT LOCATION AND RECOMMENDATIONS OF STATE AND LOCAL BUILDING CODES HAVING JURISDICTION OVER SPECIFIC PORTIONS OF WORK. THIS WORK INCLUDES, BUT IS NOT LIMITED TO THE LOWING:
- EIA ELECTRONIC INDUSTRIES ASSOCIATION RS-22 STRUCTURAL STANDARDS FOR STEEL ANTENNA TOWERS AND ANTENNA SUPPORTING STRUCTURES.
- FAA FEDERAL AVIATION ADMINISTRATION ADVISORY CIRCULAR AC 70/7480-IH, CONSTRUCTION MARKING AND LIGHTING.
- FCC FEDERAL COMMUNICATION COMMISSION RULES AND REGULATIONS FORM 715, OBSTRUCTION MARKING AND LIGHTING SPECIFICATION FOR ANTENNA STRUCTURES
- AISC AMERICAN INSTITUTE OF STEEL CONSTRUCTION FOR STRUCTURAL JOINTS USING ASTM 1325 OR A490 BOLTS.
- 5. NEC NATIONAL ELECTRIC CODE ON TOWER LIGHTING KITS.
- UL UNDERWRITER'S LABORATORIES APPROVED ELECTRICAL
- IN ALL CASES, PART 77 OF THE FAA RULES AND PARTS 17 AND 22 OF THE FCC RULES ARE APPLICABLE AND IN THE EVENT OF CONFLICT, SUPERSEDE ANY OTHER STANDARDS OR
- 8. LIFE SAFETY CODE NFPA, LATEST EDITION

DIVISION 13000-EARTHWORK

PART 1 GENERAL

- WORK INCLUDED: REFER TO SURVEY AND SITE PLAN FOR WORK INCLUDED.
- 1.02 RELATED WORK
- CONSTRUCTION OF EQUIPMENT FOUNDATIONS
- INSTALLATION OF ANTENNA SYSTEM

PART 2 PRODUCTS

2.01 MATERIALS

- ROAD AND SITE MATERIALS; FILL MATERIAL SHALL BE ACCEPTABLE, SELECT FILL SHALL BE IN ACCORDANCE WITH LOCAL DEPARTMENT OF HIGHWAY AND PUBLIC TRANSPORTATION
- SOIL STERILIZER SHALL BE EPA REGISTERED OF LIQUID COMPOSITION AND OF PRE-EMERGENCE DESIGN.
- SOIL STABILIZER FABRIC SHALL BE MIRAFI OR EQUAL 600X AT C. ACCESS ROAD AND COMPOUND.
- GRAVEL FILL; WELL GRADED, HARD, DURABLE, NATURAL SAND AND GRAVEL, FREE FROM ICE AND SNOW, ROOTS, SOD RUBBISH, AND OTHER DELETERIOUS OR ORGANIC MATTER.

MATERIAL SHALL CONFORM TO THE FOLLOWING GRADATION

GRAVEL FILL TO BE PLACED IN LIFTS OF 9" MAXIMUM THICKNESS AND 90 % DENSITY. COMPACTED TO 95

E. NO FILL OR EMBANKMENT MATERIALS SHALL BE PLACED ON FROZEN GROUND. FROZEN MATERIALS SNOW OR ICE SHALL NOT BE PLACED IN ANY FILL OF EMBANKMENT

2.02 EQUIPMENT

- COMPACTION SHALL BE ACCOMPLISHED BY MECHANICAL MEANS. LARGER AREAS SHALL BE COMPACTED BY SHEEPS FOOT, VIBRATORY OR RUBBER TIED ROLLERS WEIGHING AT LEAST FIVE TONS. SMALLER AREAS SHALL BE COMPACTED BY POWER-DRIVER, HAND HELD TAMPERS.
- PRIOR TO OTHER EXCAVATION AND CONSTRUCTION EFFORTS GRUB ORGANIC MATERIAL TO A MINIMUM OF 6" BELOW ORIGINAL GROUND
- UNLESS OTHERWISE INSTRUCTED BY CLIENT'S REPRESENTATIVE REMOVE TREES, BRUSH AND DEBRIS FROM THE PROPERTY TO AN AUTHORIZED DISPOSAL LOCATION.
- PRIOR TO PLACEMENT OF FILL OR BASE MATERIALS, ROLL THE SOIL.
- WHERE UNSTABLE SOIL CONDITIONS ARE ENCOUNTERED, LINE THE GRUBBED AREAS WITH STABILIZER MAT PRIOR TO PLACEMENT OF FILL OR BASE MATERIAL.

- THE SITE AND TURNAROUND AREAS SHALL BE AT THE SUB-BASE COURSE ELEVATION PRIOR TO FORMING FOUNDATIONS. GRADE OR FILL THE SITE AND ACCESS ROAD AS REQUIRED TO PRODUCE EVEN DISTRIBUTION OF SPOILS RESULTING FROM FOUNDATION EXCAVATIONS. THE RESULTING GRADE SHALL CORRESPOND WITH SAID SUB-BASE COURSE, ELEVATIONS ARE TO BE CALCULATED FORM FINISHED GRADES OR SLOPES INDICATED.
- THE ACCESS ROAD SHALL BE BROUGHT TO BASE COURSE ELEVATION PRIOR TO FOUNDATION CONSTRUCTION.
- DO NOT CREATE DEPRESSIONS WHERE WATER MAY POND. C.
- THE CONTRACT INCLUDES ALL NECESSARY GRADING BANKING DITCHING AND COMPLETE SURFACE COURSE FOR ACCESS ROAD.

  ALL ROADS OR ROUTES UTILIZED FOR ACCESS TO PUBLIC

  THOROUGHFARE IS INCLUDED IN SCOPE OF WORK UNLESS OTHERWISE INDICATED.
- WHEN IMPROVING AN EXISTING ACCESS ROAD, GRADE THE EXISTING ROAD TO REMOVE ANY ORGANIC MATTER AND SMOOTH THE SURFACE BEFORE PLACING FILL OR STONE.
- PLACE FILL OR STONE IN 3" MAXIMUM LIFTS AND COMPACT BEFORE PLACING NEXT LIFT.
- THE FINISH GRADE, INCLUDING TOP SURFACE COURSE, SHALL EXTEND A MINIMUM OF 12" BEYOND THE SITE FENCE AND SHALL COVER THE AREA AS INDICATED.
- RIPRAP SHALL BE APPLIED TO THE SIDE SLOPES OF ALL FENCED AREAS, PARKING AREAS AND TO ALL OTHER SLOPES GREATER THAN
- RIPRAP SHALL BE APPLIED TO THE SIDES OF DITCHES OR DRAINAGE SWALES AS INDICATED ON PLANS
- RIPRAP ENTIRE DITCH FOR 6'-0" IN ALL DIRECTIONS AT CULVERT

- SEED, FERTILIZER AND STRAW COVER SHALL BE APPLIED TO ALL OTHER DISTURBED AREAS AND DITCHES, DRAINAGE, SWALES, NOT OTHERWISE RIP-RAPPED.
- UNDER NO CIRCUMSTANCES SHALL DITCHES, SWALES OR CULVERTS BE PLACED SO THEY DIRECT WATER TOWARDS, OR PERMIT STANDING WATER IMMEDIATELY ADJACENT TO SITE. I OWNER DESIGNS OR IF DESIGN ELEVATIONS CONFLICT WITH THIS GUIDANCE ADVISE THE OWNER IMMEDIATELY.
- IF A DITCH LIES WITH SLOPE GREATER THAN TEN PERCENT, MOUND DIVERSIONARY HEADWALL IN THE DITCH AT CULVERT ENTRANCES. RIP-RAP THE UPSTREAM SIDE OF THE HEADWALL AS WELL AS THE DITCH FOR 6'-0" ABOVE THE CULVERT.
- N. IF A DITCH LIES WITH SLOPES GREATER THAN TEN PERCENT, MOUND DIVERSIONARY HEADWALLS IN THE DITCH FOR 6'-0" ABOVE THE CULVERT ENTRANCE.
- SEED AND FERTILIZER SHALL BE APPLIED TO SURFACE CONDITIONS WHICH WILL ENCOURAGE RODTING. RAKE AREAS TO BE SEEDED TO EVEN THE SURFACE AND TO LOOSEN THE SOIL.
- P. SOW SEED IN TWO DIRECTIONS IN TWICE THE QUANTITY RECOMMENDED BY THE SEED PRODUCER.
- Q. IT IS THE CONTRACTOR'S RESPONSIBILITY TO ENSURE GROWTH OF SEEDED AND LANDSCAPED AREAS BY WATERING UP TO THE POINT OF RELEASE FROM THE CONTRACT. CONTINUE TO REWORK BARE AREAS UNTIL COMPLETE COVERAGE IS OBTAINED.


FIELD QUALITY CONTROL

- A. COMPACTION SHALL BE D-1557 FOR SITE WORK AND 95 % MAXIMUM DENSITY UNDER SLAB AREAS. AREAS OF SETTLEMENT WILL BE EXCAVATED AND REFILLED AT CONTRACTOR'S EXPENSE. REQUIRED. USE OF EROSION CONTROL MESH OR MULCH NET SHALL BE AN ACCEPTABLE ALTERNATIVE.
- B. THE COMPACTION TEST RESULTS SHALL BE AVAILABLE PRIOR TO THE CONCRETE POUR.

3.05 PROTECTION

- A. PROTECT SEEDED AREAS FORM EROSION BY SPREADING STRAW TO A UNIFORM LOOSE DEPTH OF 1"-2". STAKE AND TIE DOWN AS REQUIRED. USE OF EROSION CONTROL MESH OR MULCH NET SHALL BE AN ACCEPTABLE ALTERNATIVE.
- B. ALL TREES PLACED IN CONJUNCTION WITH A LANDSCAPE CONTRACT SHALL BE WRAPPED, TIED WITH HOSE PROTECTED WIRE AND SECURED TO STAKES EXTENDING 2'-0" INTO THE GROUND ON FOUR SIDES OF THE TREE.
- ALL EXPOSED AREAS SHALL BE PROTECTED AGAINST WASHOUTS AND SOIL EROSION. STRAW BALES SHALL BE PLACED AT THE INLET APPROACH TO ALL NEW OR EXISTING CULVERTS. REFER TO DETAILS ON DRAWINGS

SYMBOLS	ABBREVIATIONS
	GROUND WIRE
— — — Е— — — Е—	ELECTRIC
	TELEPHONE
——————————————————————————————————————	OVERHEAD WIRE
	PROPERTY LINE
_xxx	CHAIN LINK FENCE
A-1	ANTENNA MARK
(E)	EXISTING
(P)	PROPOSED DETAIL
DET #	REFERENCE
<b>•</b>	SURFACE ELEVATION

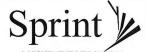

2.5 FOLIPMENT DEPLOYMENT 6580 SPRINT PARKWAY **OVERLAND PARK, KANSAS 66251** 



TECTONIC

Consultants P.C.

1279 Route 300 Newburgh, NY 12550 Phone: (845) 567-6656 Fax: (845) 567-8703

THIS DOCUMENT IS THE CREATION, DESIGN, PROPERTY AND COPYRIGHTED WORK OF SPRINT COMMUNICATIONS, INC. ANY DUP. ICATION OR USE WITHOUT STREES WRITTEN CONSENT IS STRICTLY PROHIBITED, DUPLICATION AND USE BY GOVERNIHENT AGENCES FOR THE PURPOSES OF CONDUCTING THEIR LAWFULLY AUTHORIZED REGULATORY AND APMINISTRATIVE FINCTIONS IS

	SI	JBMITTALS
-		DIVITIALS
PRO	DJECT NO	7225.CT03XC0I9
NO	DATE	DESCRIPTION
0	06/11/14	FOR COMMENT
1	10/28/14	FOR CONSTRUCTION

DATE	REVIEWED BY
	000000
	88 Cassaches Sala
0300	SEAL A SEAL
50	100000000000000000000000000000000000000
C. Car	
30.7	
· ·	



SITE NUMBER CT03XC019

> SITE NAME: ORANGE

SITE ADDRESS:


800 OGG MEADOW RD ORANGE, CT 06477

SHEET TITLE:

GENERAL NOTES


SHEET NO:

SP-2

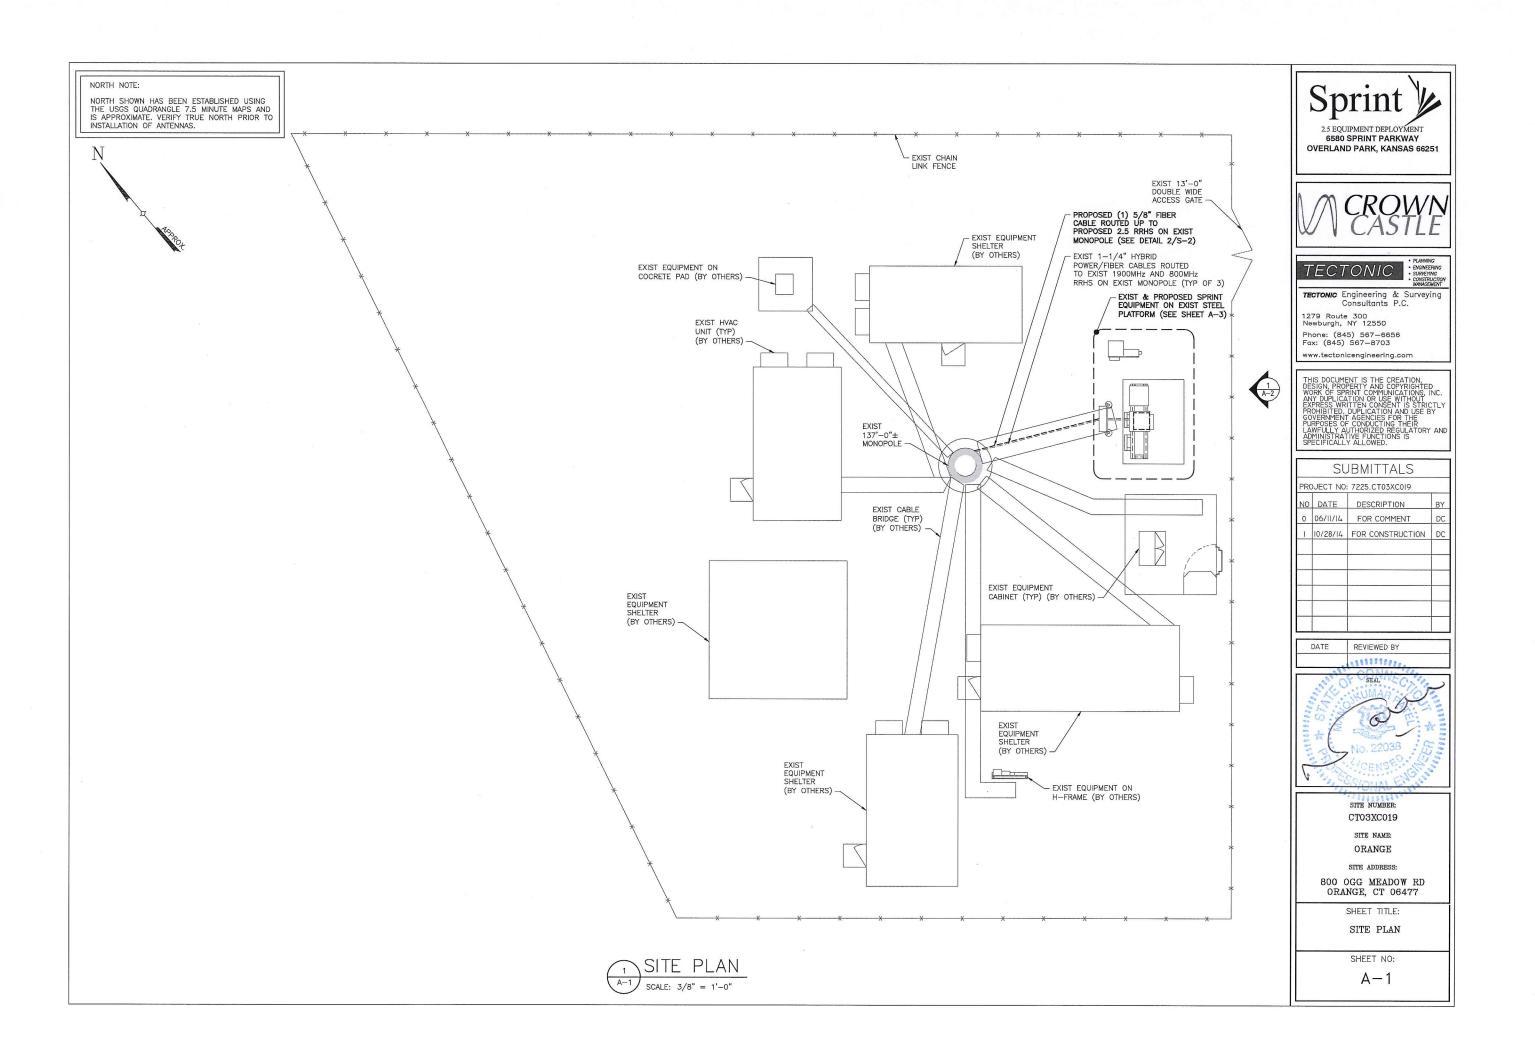

THE EXISTING MONOPOLE SHALL BE ANALYZED BY A PROFESSIONAL ENGINEER LICENSED IN THE STATE OF CONNECTICUT

THE EXISTING MOUNT HAS BEEN ANALYZED BY TECTONIC ENGINEERING AND FOUND TO BE ADEQUATE TO SUPPORT THE PROPOSED SPRINT UPGRADE AS DETAILED IN THE STRUCTURAL ANALYSIS EVALUATION LETTER

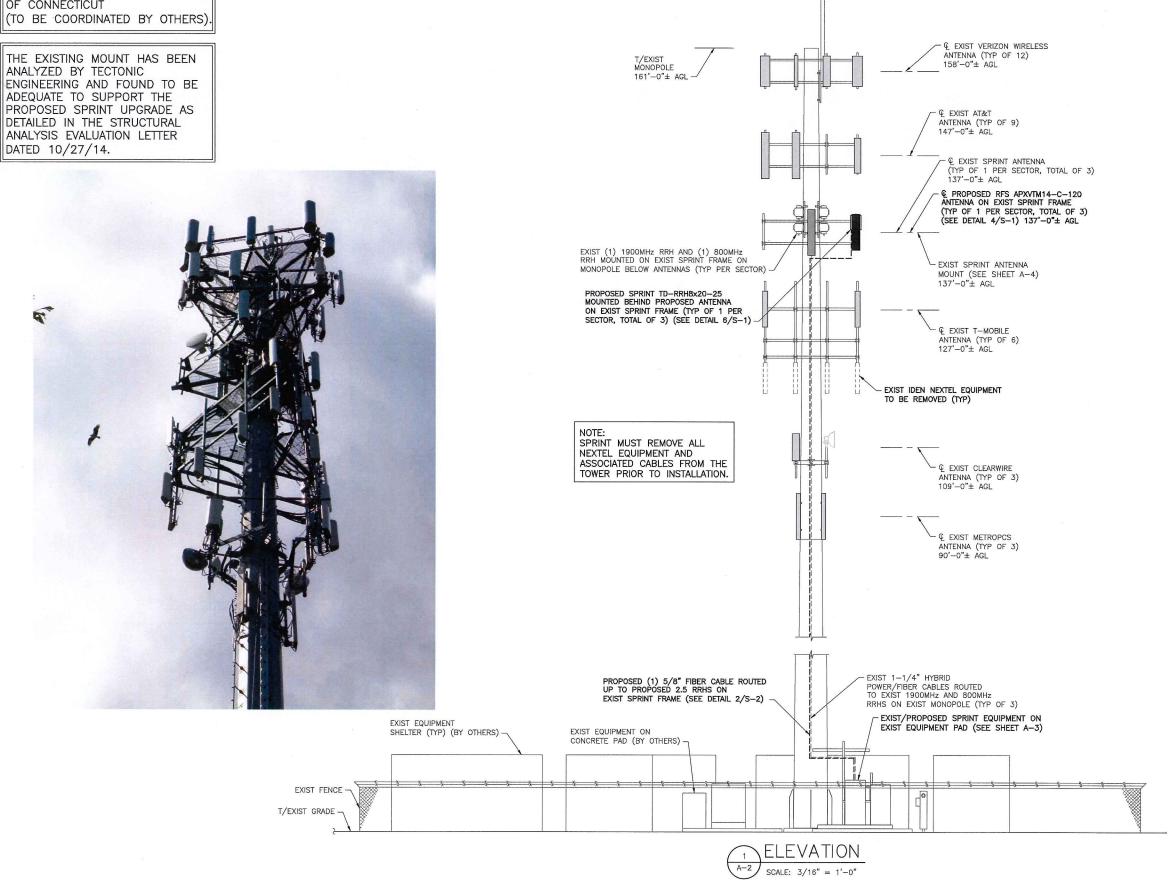



€ EXIST ANTENNA

(TYP OF 3) (BY OTHERS) \_ 170'-0"± AGL

6580 SPRINT PARKWAY **OVERLAND PARK, KANSAS 66251** 

# TECTONIC

TECTONIC Engineering & Surveying

1279 Route 300 Newburgh, NY 12550 Phone: (845) 567-6656 Fax: (845) 567-8703

# SUBMITTALS PROJECT NO: 7225.CT03XC019 NO DATE DESCRIPTION 0 06/11/14 FOR COMMENT I 10/28/14 FOR CONSTRUCTION

DATE	KEVIEWED BT
4.0	and the
378	SEAL



SITE NUMBER CT03XC019


> SITE NAME: ORANGE

SITE ADDRESS:

800 OGG MEADOW RD ORANGE, CT 06477

> SHEET TITLE: ELEVATION


SHEET NO: A-2

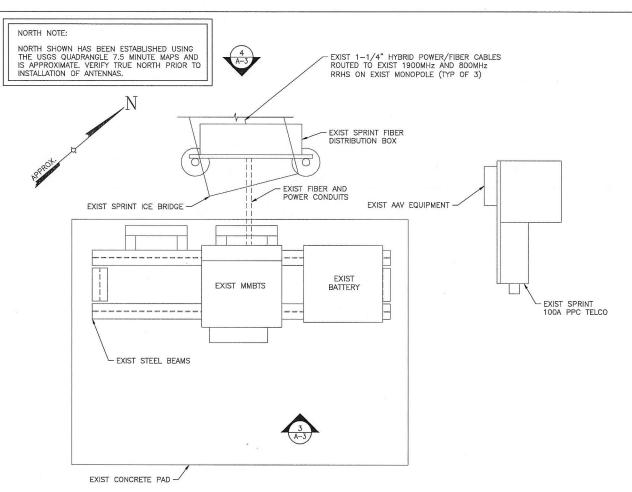

ENLARGED EQUIP. LAYOUT PLAN (EXIST)



EXIST EQUIPMENT PAD

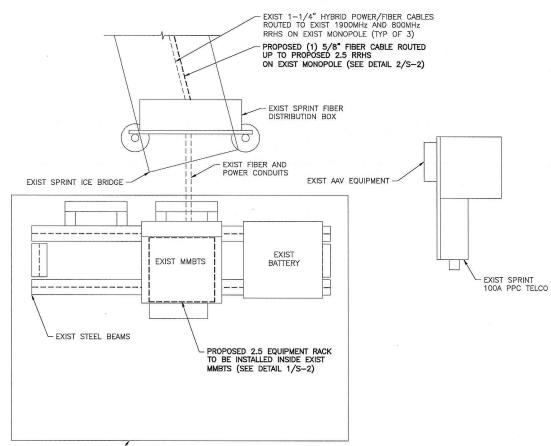

ENLARGED EQUIP. LAYOUT PLAN (FINAL)



EXIST CONCRETE PAD

EXIST FIBER DISTRIBUTION BOX



2.5 EQUIPMENT DEPLOYMENT 6580 SPRINT PARKWAY OVERLAND PARK, KANSAS 66251

CROWN

TECTONIC

ENGINEERING
 SURVEYING
 CONSTRUCTION
 MANAGEMENT

**TECTONIC** Engineering & Surveying Consultants P.C.


1279 Route 300 Newburgh, NY 12550 Phone: (845) 567-6656 Fax: (845) 567-8703

THIS DOCUMENT IS THE CREATION, DESIGN, PROPERTY AND COPYRIGHTED WORK OF SPRINT COMMUNICATIONS, INC. ANY DUPLICATION OR USE WITHOUT STRICTLY PROPERTY OF THE PROPERTY OF THE PROPERTY OF THE PROPERTY OF CONDUCTIONS THEIR LAWFULLY AUTHORIZED REGULATORY AND ADMINISTRATURE FUNCTIONS IS

SUBMITTALS
PROJECT NO: 7225.CT03XC019

NO DATE DESCRIPTION BY
0 06/11/14 FOR COMMENT DC
1 10/28/14 FOR CONSTRUCTION DC

DATE REVIEWED BY

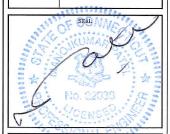

CTO3XC019

SITE NAME: ORANGE

SITE ADDRESS:


800 OGG MEADOW RD ORANGE, CT 06477

SHEET TITLE:

ENLARGED EQUIPMENT LAYOUT PLANS

SHEET NO:


A-3

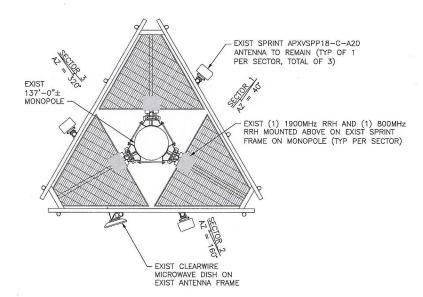

NOTE: CONTRACTER TO FIELD VERIFY AZMITHS AND ADJUST EXIST ANTENNAS TO MATCH THE AZMITHS SHOWN IN THE FINAL LAYOUT.


1 ANTENNA LAYOUT PLAN (EXIST)

A-4 Scale: 3/8" = 1'-0"

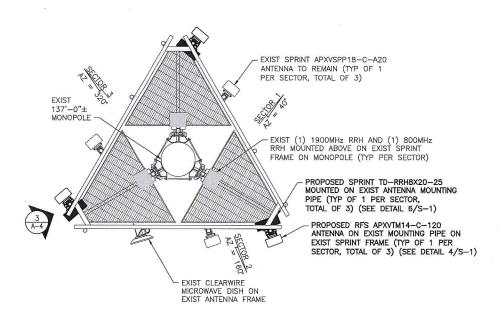

ANTENNA LAYOUT PLAN (FINAL)

SCALE: 3/8" = 1'-0"

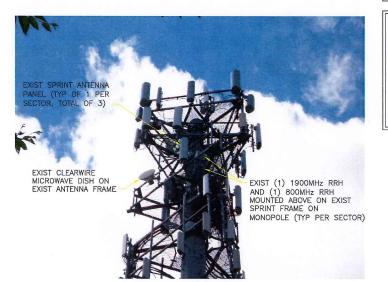

THE EXISTING MONOPOLE SHALL
BE ANALYZED BY A PROFESSIONAL
ENGINEER LICENSED IN THE STATE
OF CONNECTICUT

(TO BE COORDINATED BY OTHERS)

THE EXISTING MOUNT HAS BEEN ANALYZED BY TECTONIC ENGINEERING AND FOUND TO BE ADEQUATE TO SUPPORT THE PROPOSED SPRINT UPGRADE AS DETAILED IN THE STRUCTURAL ANALYSIS EVALUATION LETTER DATED 10/27/14.



CROWN

# TECTONIC

ENGINEERING
 SURVEYING
 CONSTRUCTION
 MANAGEMENT

TECTONIC Engineering & Surveying Consultants P.C.

1279 Route 300 Newburgh, NY 12550 Phone: (845) 567—6656 Fax: (845) 567—8703

www.tectonicengineering.com

I HIS DOCUMENT IS THE CREATION,
DESIGN, PROPERTY AND COPYRIGHTED
WORK OF SPRINT COMMUNICATIONS, INC.
ANY DUPLICATION OF USE WITHOUT
EXPRESS WRITTEN CONSENT IS STRICTLY
PROHIBITED, DUPLICATION AND USE BY
GOVERNMENT AGENCIES FOR THE
PURPOSES OF CONDUCTING THEIR
LAWFULLY AUTHORIZED REGULATORY AND
ADMINISTRATIVE FUNCTIONS IS
SPECIFICALLY ALLOWED.

	SL	JBMITTALS	
PRO	JECT NO	7225.CT03XC0I9	
NO	DATE	DESCRIPTION	BY
0	06/11/14	FOR COMMENT	DC
1	10/28/14	FOR CONSTRUCTION	DC

DATE REVIEWED BY



SITE NUMBER: CTO3XC019 SITE NAME:


ORANGE SITE ADDRESS:

800 OGG MEADOW RD ORANGE, CT 06477

SHEET TITLE:

ANTENNA LAYOUT PLANS

SHEET NO: A-4

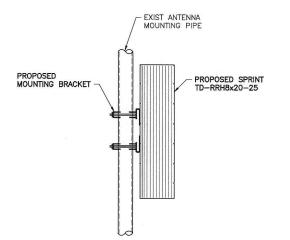



# **ANTENNA DATA**

Status	Exist	Proposed
Antenna Manufacturer	RFS-CEL WAVE	RFS-CEL WAVE
Antenna Model Number	APXVSPP18C-C-A20	APXVTM14-C-120
Number of Antennas	3	3
Antenna RAD Center	137'	137'
Antenna Azimuth	40/160/320	40/160/320
Antenna RRH Model Number	1900MHz/800MHz RRHS	TD-RRH8x20-25
Number of RRH	3	3