

# TOTALLY COMMITTED.

June 24, 2021

Melanie A. Bachman Executive Director Connecticut Siting Council 10 Franklin Square New Britain, CT 06051

Notice of Exempt Modification Facility Address: 223 Rogers Road, Norwich, CT Facility Coordinates: 41.53366667, -72.135

Dear Ms. Bachman,

American Tower (ATC) currently maintains an Existing Cellular Tower Facility (151' Monopole) at 223 Rogers Road, Norwich, CT 06360. The property is owned by Michael J. Coleman. American Tower (ATC) now intends to install an 80kw Generator within the leased, fenced ground space area of the facility. The purpose of the generator installation is to allow for a shared back up emergency power option for its current (and future) wireless carrier tenants.

Because this proposed generator is within the existing, approved compound space, and the applicant is NOT requesting expansion of ground space beyond the approved conditions, please accept this letter, as notification pursuant to Regulations of Connecticut State Agencies @16-50j-73, for construction that constitutes an exempt modification pursuant to R.C.S.A. @16-50j-72(b)(2). IN accordance with R.C.S.A.@16-50j-73, a copy of this letter is being sent to Peter Nystrom, Mayor of the City of Norwich, Richard Shuck, Zoning Officer, as well as the property owner and tower owner.



#### ATTACHMENT A

The planned modifications to the facility fall squarely within those activities explicitly provided for in R.C.S.A @ 16-50j-72(b)(2).

- 1. The proposed modifications will not result in an increase in the height of the existing structure.
- 2. The proposed modifications will not require the extension of the site boundary
- 3. The proposed modifications will not increase noise levels at the facility by six decibels or more, or to levels that exceed state and local criteria.
- 4. The operation of the generator back up power facility will not increase radio frequency emissions at the facility to the level at or above the Federal Communications Commission safety standard.
- 5. The proposed modifications will not cause a change or alteration in the physical or environmental characteristics of the site.
- 6. The existing structure and its foundation can support the proposed loading if the tower will be reenforced to support them. <<< NOTE This condition is N/A. The proposed Generator is based on the ground, and not associated or loaded onto the tower or foundation.

For the foregoing reasons, American Tower Corporation (ATC) respectfully submits that the proposed modifications to the above referenced telecommunications facility constitute an exempt modification under R.C.S.A. @16-50j-72(b)(2).

If you have any questions, I can be reached at <a href="mailto:mweber@nbcllc.com">mweber@nbcllc.com</a> or 215.416.0363

Best Regards,

### Margie Weber

**Attachments** 

cc: Peter Nystrom, Mayor Richard Shuck, Zoning Officer Michael J. Coleman - Property Owner American Tower (ATC) – Tower Owner



#### LETTER OF AUTHORIZATION

ATC SITE # / NAME/PROJECT: 302493/ Nrwc - Norwich / 13351900

SITE ADDRESS: 225 Rogers Rd, Norwich, CT 06360-4035

APN: NORW-000088-000001-000009

LICENSEE: T-MOBILE d/b/a T-MOBILE NORTHEAST LLC

I, Margaret Robinson, Senior Counsel for American Tower\*, owner of the tower facility located at the address identified above (the "Tower Facility"), do hereby authorize T-MOBILE d/b/a T-MOBILE NORTHEAST LLC, its successors and assigns, and/or its agent, (collectively, the "Licensee") to act as American Tower's non-exclusive agent for the sole purpose of filing and consummating any land-use or building permit application(s) as may be required by the applicable permitting authorities for Licensee's telecommunications' installation.

We understand that this application may be denied, modified, or approved with conditions. The above authorization is limited to the acceptance by Licensee only of conditions related to Licensee's installation and any such conditions of approval or modifications will be Licensee's sole responsibility.

Signature:

Print Name: Margaret Robinson

Senior Counsel American Tower\*

#### NOTARY BLOCK

Commonwealth of MASSACHUSETTS County of Middlesex

This instrument was acknowledged before me by Margaret Robinson, Senior Counsel for American Tower\*, personally known to me (or proved to me on the basis of satisfactory evidence) to be the person whose name is subscribed to the within instrument and acknowledged to me that he executed the same.

WITNESS my hand and official seal, this 14th day of May, 2021.

NOTARY SEAL

GERARD T. HEFFRON

Notary Public:

Commonwealth of Massachusetts
My Commission Expires

Notary Public

My Commission Expires: August 9, 2024

\*American Tower includes all affiliates and subsidiaries of American Tower Corporation.

#### 223 ROGERS RD

**Location** 223 ROGERS RD **Mblu** 88/ 1/ 10/ 1/

Acct# 0007550001 Owner COLEMAN MICHAEL J TR

**Assessment** \$295,200 **Appraisal** \$421,700

PID 743 Building Count 1

#### **Current Value**

Appraisal					
Valuation Year Improvements Land					
2018	\$196,100	\$225,600	\$421,700		
	Assessment				
Valuation Year	Improvements	Land	Total		
2018	\$137,300	\$157,900	\$295,200		

#### **Parcel Addreses**

Additional Addresses	
No Additional Addresses available for this parcel	

#### **Owner of Record**

Owner COLEMAN MICHAEL J TR Sale Price \$0

C/O PROPERTY TAX DEPT Certificate

 Address
 P.O BOX 723597
 Book & Page
 1297/0025

 ATLANTA, GA 31139
 Sale Date
 01/22/1997

#### **Ownership History**

Ownership History				
Owner	Sale Price Certificate		Book & Page	Sale Date
COLEMAN MICHAEL J TR	\$0		1297/0025	01/22/1997

#### **Building Information**

#### **Building 1: Section 1**

Year Built:

Living Area: 0 \$0 Replacement Cost:

**Building Percent Good: Replacement Cost** 

Building Attr	ibutos				
	Building Attributes				
Field	Description				
Style	Vacant Land				
Model					
Grade:					
Stories:					
Occupancy					
Exterior Wall 1					
Exterior Wall 2					
Roof Structure:					
Roof Cover					
Interior Wall 1					
Interior Wall 2					
Interior Flr 1					
Interior Flr 2					
Heat Fuel					
Heat Type:					
AC Type:					
Total Bedrooms:					
Total Bthrms:					
Total Half Baths:					
Total Xtra Fixtrs:					
Total Rooms:					
Bath Style:					
Kitchen Style:					
Num Kitchens					
Fireplace (s)					
Whirlpool					
FPLG Gas					
FPLW Wood					
FPO					
Usrfld 107					
park					
Fireplaces					
Usrfld 108					
Usrfld 101					
Usrfld 102					

#### **Building Photo**



(http://images.vgsi.com/photos/NorwichCTPhotos/\00\01\99\75.jpg)

#### **Building Layout**

(ParcelSketch.ashx?pid=743&bid=743)

Building Sub-A	reas (sq ft)	<u>Legend</u>
No Data for Bu	ilding Sub-Areas	

Usrfld 100	
Usrfld 300	
Usrfld 301	

#### **Extra Features**

Extra Features	<u>Legend</u>
No Data for Extra	- Features

#### Land

Land Use		Land Line Valuation		
Use Code	431V	Size (Acres)	2.85	
Description	TEL REL TW M-00	Frontage	0	
Zone	R80	Depth	0	
Neighborhood		Assessed Value	\$157,900	
Alt Land Appr	No	Appraised Value	\$225,600	
Category				

#### Outbuildings

Outbuildings					<u>Legend</u>	
Code	Description	Sub Code	Sub Description	Size	Value	Bldg #
SHD5	Shed Comm Mas			625.00 S.F.	\$7,800	1
FN4	Fence Chain 8'			240.00 L.F.	\$2,000	1
TWR	CELL TOWER			150.00 UNITS	\$56,300	1
MSC4	ARRAY			1.00 UNIT	\$130,000	1

#### **Valuation History**

Appraisal				
Valuation Year	Improvements	Land	Total	
2020	\$196,100	\$225,600	\$421,700	
2019	\$196,100	\$225,600	\$421,700	
2018	\$196,100	\$225,600	\$421,700	

Assessment					
Valuation Year Improvements Land Total					
2020	\$137,300	\$157,900	\$295,200		
2019	\$137,300	\$157,900	\$295,200		
2018	\$137,300	\$157,900	\$295,200		

#### **Margie Weber**

From: TrackingUpdates@fedex.com
Sent: Tuesday, June 29, 2021 1:47 PM

To: Margie Weber

**Subject:** FedEx Shipment 774115335466: Your package has been delivered



# Hi. Your package was delivered Tue, 06/29/2021 at 1:46pm.



Delivered to 23 UNION ST, NORWICH, CT 06360 Received by A.BLAKE

#### **OBTAIN PROOF OF DELIVERY**

**TRACKING NUMBER** <u>774115335466</u>

FROM NB+C

1777 Sentry Parkway West

Veva 17, Suite 400

BLUE BELL, PA, US, 19422

TO City of Norwich

Richard Shuck 23 Union St

NORWICH, CT, US, 06360

REFERENCE 100510

1

SHIPPER REFERENCE 100510

**SHIP DATE** Mon 6/28/2021 03:48 PM

**DELIVERED TO** Receptionist/Front Desk

PACKAGING TYPE FedEx Envelope

**ORIGIN** BLUE BELL, PA, US, 19422


**DESTINATION** NORWICH, CT, US, 06360

SPECIAL HANDLING Deliver Weekday

NUMBER OF PIECES 1

TOTAL SHIPMENT WEIGHT 0.50 LB

SERVICE TYPE FedEx Standard Overnight

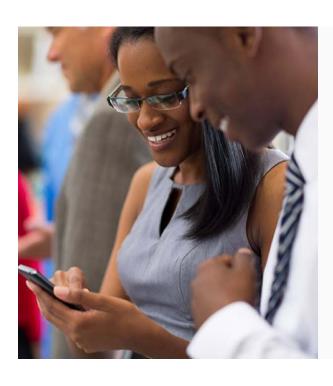

# Download the FedEx® Mobile app

Get the flexibility you need to create shipments and request to customize your deliveries through the app.

**LEARN MORE** 

#### **FOLLOW FEDEX**















Please do not respond to this message. This email was sent from an unattended mailbox. This report was generated at approximately 12:47 PM CDT 06/29/2021.

All weights are estimated.

#### **Margie Weber**

From: TrackingUpdates@fedex.com
Sent: Tuesday, June 29, 2021 1:17 PM

To: Margie Weber

**Subject:** FedEx Shipment 774115350433: Your package has been delivered



# Hi. Your package was delivered Tue, 06/29/2021 at 1:16pm.



Delivered to 219 ROGERS RD, NORWICH, CT 06360

#### **OBTAIN PROOF OF DELIVERY**

**TRACKING NUMBER** <u>774115350433</u>

FROM NB+C

1777 Sentry Parkway West

Veva 17, Suite 400

BLUE BELL, PA, US, 19422

TO Michael J. Coleman

219 Rogers Road

NORWICH, CT, US, 06360

REFERENCE 100510

SHIPPER REFERENCE 100510

**SHIP DATE** Mon 6/28/2021 03:48 PM

**DELIVERED TO** Residence

PACKAGING TYPE FedEx Envelope

ORIGIN BLUE BELL, PA, US, 19422

**DESTINATION** NORWICH, CT, US, 06360


SPECIAL HANDLING Deliver Weekday

Residential Delivery

NUMBER OF PIECES 1

TOTAL SHIPMENT WEIGHT 0.50 LB

SERVICE TYPE FedEx Standard Overnight

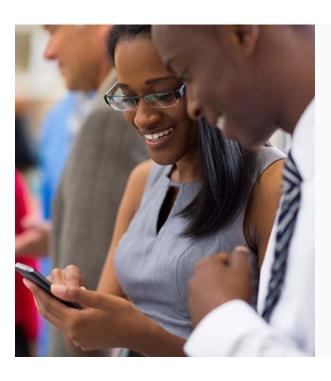

# Download the FedEx® Mobile app

Get the flexibility you need to create shipments and request to customize your deliveries through the app.

**LEARN MORE** 

#### **FOLLOW FEDEX**















Please do not respond to this message. This email was sent from an unattended mailbox. This report was generated at approximately 12:17 PM CDT 06/29/2021.

All weights are estimated.

#### **Margie Weber**

From: TrackingUpdates@fedex.com
Sent: Tuesday, June 29, 2021 10:31 AM

To: Margie Weber

**Subject:** FedEx Shipment 774115315637: Your package has been delivered



# Hi. Your package was delivered Tue, 06/29/2021 at 10:30am.



Delivered to 100 BROADWAY, NORWICH, CT 06360 Received by T.PRICE

#### **OBTAIN PROOF OF DELIVERY**

**TRACKING NUMBER** <u>774115315637</u>

FROM NB+C

1777 Sentry Parkway West

Veva 17, Suite 400

BLUE BELL, PA, US, 19422


TO City of Norwich

Mayor Peter Nystrom

100 Broadway Norwich City Hall

NORWICH, CT, US, 06360

1

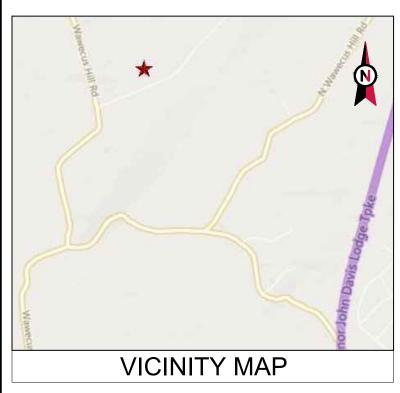



ATC SITE NAME: NRWC - NORWICH

SITE NUMBER: 302493

SITE ADDRESS: 223 ROGERS ROAD

NORWICH, CT 06360



**LOCATION MAP** 

# SHARED GENERATOR PROGRAM ANCHOR TENANT

COMPLIANCE CODE	PROJECT SUMMARY	PROJECT DESCRIPTION		SHEET INDEX			
ALL WORK SHALL BE PERFORMED AND MATERIALS INSTALLED IN ACCORDANCE WITH THE CURRENT EDITIONS OF THE	SITE ADDRESS:	THE PROPOSED PROJECT INSTALLS AN OPTIONAL STANDBY GENERATOR SYSTEM. AUTOMATIC TRANSFER SWITCH.	SHEET NO:	DESCRIPTION:	REV:	DATE:	BY:
FOLLOWING CODES AS ADOPTED BY THE LOCAL GOVERNMENT AUTHORITIES. NOTHING IN THESE PLANS IS	223 ROGERS ROAD NORWICH, CT 06360	GENERATOR AUXILIARY POWER DISTRIBUTION, AND REMOTE MONITORING COMMUNICATIONS CIRCUITRY FOR A	G-001	TITLE SHEET	0	03/30/21	AB
TO BE CONSTRUED TO PERMIT WORK NOT CONFORMING TO THESE CODES.	COUNTY: NEW LONDON	COMMUNICATION TOWER TENANT.	G-002	GENERAL NOTES	0	03/30/21	AB
INTERNATIONAL BUILDING CODE (IBC)	GEOGRAPHIC COORDINATES:	PROJECT NOTES	C-101	SITE PLAN	0	03/30/21	AB
2. NATIONAL ELECTRIC CODE (NEC)	LATITUDE: 41.53366667 LONGITUDE: -72.135		C-501	CONCRETE PAD DETAILS	0	03/30/21	AB
LOCAL BUILDING CODE     CITY/COUNTY ORDINANCES	GROUND ELEVATION: 385' AMSL	THE FACILITY IS UNMANNED.	E-601	ELECTRICAL ONE-LINE AND WIRING DETAILS	0	03/30/21	AB
	ZONING INFORMATION:	<ol><li>A TECHNICIAN WILL VISIT THE SITE APPROXIMATELY ONCE A MONTH FOR ROUTINE INSPECTION AND MAINTENANCE.</li></ol>	R-601	SUPPLEMENTAL			
	JURISDICTION: NEW LONDON PARCEL NUMBER: NORW-000088-000001-000010-000001	THE PROJECT WILL NOT RESULT IN ANY SIGNIFICANT LAND DISTURBANCE OR EFFECT OF STORM WATER DRAINAGE.					
	PARCEL NUMBER: NORW-000088-000001-000010-000001	NO SANITARY SEWER, POTABLE WATER OR TRASH DISPOSAL IS REQUIRED.					
	PROJECT TEAM	5. HANDICAP ACCESS IS NOT REQUIRED.					
	ATC REGIONAL NETWORK DEVELOPMENT PROJECT MANAGER: MICHAEL FLINT (843) 416-7168						
UTILITY COMPANIES	ATC NETWORK OPERATIONS CENTER: (877) 518-6937						
POWER COMPANY: NORWICH PUBLIC UTILITIES PHONE: (860) 887-2555	TOWER OWNER:	PROJECT LOCATION DIRECTIONS					
TELEPHONE COMPANY: AT&T PHONE: (800) 288-2020	AMERICAN TOWER 10 PRESIDENTIAL WAY WOBURN. MA 01801	TROCEST ESSATION BIRLESTICAS					
	PROPERTY OWNER:						
<b>911</b>	MICHAEL J COLEMAN 219 ROGERS RD.	I-395 S TO EXIT 82. AT END OF EXIT GO STRAIGHT ACROSS					
	NORWICH, CT 6360	BETWEEN SHELL AND MOBIL. FOLLOW TO FORK IN ROAD AND GO TO THE LEFT. FOLLOW ROGERS ROAD TO TOWER ON					
	ENGINEERED BY:	RIGHT SIDE.					
Know what's <b>below. Call</b> before you dig.	ATC TOWER SERVICES 3500 REGENCY PARKWAY SUITE 100 CARY, NC 27518						

# AMERICAN TOWERS

A.T. ENGINEERING SERVICE, PLLC 3500 REGENCY PARKWAY

500 REGENCY PARKWAY SUITE 100 CARY, NC 27518 PHONE: (919) 468-0112 COA: PEC.0001553

THESE DRAWINGS AND/OR THE ACCOMPANYING
SPECIFICATION AS INSTRUMENTS OR SERVICE ARE THE
EXCLUSIVE PROPERTY OF AMERICAN TOWER. THEIR USE AND
PUBLICATION SHALL BE RESTRICTED TO THE ORIGINAL SITE
FOR WHICH THEY ARE PREPARED. ANY USE OR DISCLOSURE
OTHER THAN THAT WHICH RELATES TO AMERICAN TOWER OR
THE SPECIFIED CARRIER IS STRICTLY PROHIBITED. TITLE TO
THESE DOCUMENTS SHALL REMAIN THE PROPERTY OF
AMERICAN TOWER WHETHER OR NOT THE PROJECT IS
EXECUTED. NEITHER THE ARCHITECT NOR THE ENGINEER WILL
BE PROVIDING ON-SITE CONSTRUCTION REVIEW OF THIS
PROJECT. CONTRACTOR(S) MUST VERIFY ALL DIMENSIONS AND
ADVISE AMERICAN TOWER OF ANY DISCREPANCIES. ANY PRIOR
ISSUANCE OF THIS DRAWING IS SUPERSEDED BY THE LATEST
VERSION ON FILE WITH AMERICAN TOWER.

REV.	DESCRIPTION	BY	DATE
<u></u>	FOR CONSTRUCTION	AB	03/30/21
$\triangle$			
$\overline{\wedge}$			
$\overline{}$			
-			

ATC SITE NUMBER:

302493

ATC SITE NAME:

NRWC - NORWICH

SITE ADDRESS: 223 ROGERS ROAD NORWICH, CT 06360

SEAL



# T··Mobile

DRAWN BY:	AB
APPROVED BY:	РВ
DATE DRAWN:	03/30/21
ATC JOB NO:	13348360_M4

TITLE SHEET

G-001

REVISION:

0

#### **GENERAL CONSTRUCTION NOTES:**

- ALL WORK SHALL CONFORM TO ALL CURRENT APPLICABLE FEDERAL, STATE, AND LOCAL CODES, INCLUDING ANSI/EIA/TIA-222, AND COMPLY WITH ATC CONSTRUCTION SPECIFICATIONS.
- CONTRACTOR SHALL CONTACT LOCAL 811 FOR IDENTIFICATION OF UNDERGROUND UTILITIES
   PRIOR TO START OF CONSTRUCTION.
- 3. CONTRACTOR SHALL BE RESPONSIBLE FOR COORDINATING ALL REQUIRED INSPECTIONS.
- ALL DIMENSIONS TO, OF, AND ON EXISTING BUILDINGS, DRAINAGE STRUCTURES, AND SITE IMPROVEMENTS SHALL BE VERIFIED IN FIELD BY CONTRACTOR WITH ALL DISCREPANCIES REPORTED TO THE ENGINEER.
- 5. DO NOT CHANGE SIZE OR SPACING OF STRUCTURAL ELEMENTS.
- DETAILS SHOWN ARE TYPICAL; SIMILAR DETAILS APPLY TO SIMILAR CONDITIONS UNLESS OTHERWISE NOTED.
- 7. THESE DRAWINGS DO NOT INCLUDE NECESSARY COMPONENTS FOR CONSTRUCTION SAFETY WHICH SHALL BE THE SOLE RESPONSIBILITY OF THE CONTRACTOR.
- 8. CONTRACTOR SHALL BRACE STRUCTURES UNTIL ALL STRUCTURAL ELEMENTS NEEDED FOR STABILITY ARE INSTALLED. THESE ELEMENTS ARE AS FOLLOWS: LATERAL BRACING, ANCHOR BOLTS FTC.
- 9. CONTRACTOR SHALL DETERMINE EXACT LOCATION OF EXISTING UTILITIES, GROUNDS DRAINS, DRAIN PIPES, VENTS, ETC. BEFORE COMMENCING WORK.
- INCORRECTLY FABRICATED, DAMAGED, OR OTHERWISE MISFITTING OR NONCONFORMING MATERIALS OR CONDITIONS SHALL BE REPORTED TO THE ATC CM PRIOR TO REMEDIAL OR CORRECTIVE ACTION. ANY SUCH REMEDIAL ACTION SHALL REQUIRE WRITTEN APPROVAL BY THE ATC CM PRIOR TO PROCEEDING.
- 11. EACH CONTRACTOR SHALL COOPERATE WITH THE ATC CM, AND COORDINATE HIS WORK WITH THE WORK OF OTHERS.
- 12. CONTRACTOR SHALL REPAIR ANY DAMAGE CAUSED BY CONSTRUCTION OF THIS PROJECT TO MATCH EXISTING PRE-CONSTRUCTION CONDITIONS TO THE SATISFACTION OF THE ATC CONSTRUCTION MANAGER
- ALL CABLE/CONDUIT ENTRY/EXIT PORTS SHALL BE WEATHERPROOFED DURING INSTALLATION USING A SILICONE SEALANT.
- WHERE EXISTING CONDITIONS DO NOT MATCH THOSE SHOWN IN THIS PLAN SET, CONTRACTOR SHALL NOTIFY THE ATC CONSTRUCTION MANAGER IMMEDIATELY.
- 15. CONTRACTOR SHALL ENSURE ALL SUBCONTRACTORS ARE PROVIDED WITH A COMPLETE AND CURRENT SET OF DRAWINGS AND SPECIFICATIONS FOR THIS PROJECT.
- CONTRACTOR SHALL REMOVE ALL RUBBISH AND DEBRIS FROM THE SITE AT THE END OF EACH DAY.
- 17. CONTRACTOR SHALL COORDINATE WORK SCHEDULE WITH LANDLORD AND TAKE PRECAUTIONS TO MINIMIZE IMPACT AND DISRUPTION OF OTHER OCCUPANTS OF THE FACILITY.
- CONTRACTOR SHALL FURNISH ATC WITH A PDF MARKED UP AS-BUILT SET OF DRAWINGS UPON COMPLETION OF WORK.
- 19. PRIOR TO SUBMISSION OF BID, CONTRACTOR SHALL COORDINATE WITH ATC CM TO DETERMINE WHAT, IF ANY, ITEMS WILL BE PROVIDED. ALL ITEMS NOT PROVIDED SHALL BE PROVIDED AND INSTALLED BY THE CONTRACTOR. CONTRACTOR WILL INSTALL ALL ITEMS PROVIDED.
- 20. PRIOR TO SUBMISSION OF BID, CONTRACTOR SHALL COORDINATE WITH ATC CONSTRUCTION MANAGER TO DETERMINE IF ANY PERMITS WILL BE OBTAINED BY ATC. ALL REQUIRED PERMITS NOT OBTAINED BY ATC MUST BE OBTAINED, AND PAID FOR, BY THE CONTRACTOR.
- 21. CONTRACTOR SHALL INSTALL ALL SITE SIGNAGE IN ACCORDANCE WITH ATC SPECIFICATIONS AND REQUIREMENTS.
- 22. CONTRACTOR SHALL SUBMIT ALL SHOP DRAWINGS TO ATC FOR REVIEW AND APPROVAL PRIOR TO FABRICATION.
- 23. ALL EQUIPMENT SHALL BE INSTALLED ACCORDING TO MANUFACTURER'S SPECIFICATIONS AND LOCATED ACCORDING TO ATC SPECIFICATIONS, AND AS SHOWN IN THESE PLANS.
- 24. THE CONTRACTOR SHALL SUPERVISE AND DIRECT THE PROJECT DESCRIBED HEREIN. THE CONTRACTOR SHALL BE SOLELY RESPONSIBLE FOR ALL THE CONSTRUCTION MEANS, METHODS, TECHNIQUES, SEQUENCES AND PROCEDURES AND FOR COORDINATING ALL PORTIONS OF THE WORK UNDER THE CONTRACT.
- 25. CONTRACTOR SHALL NOTIFY ATC CM A MINIMUM OF 48 HOURS IN ADVANCE OF POURING CONCRETE OR BACKFILLING ANY UNDERGROUND UTILITIES, FOUNDATIONS OR SEALING ANY WALL, FLOOR OR ROOF PENETRATIONS FOR ENGINEERING REVIEW AND APPROVAL.
- 26. CONTRACTOR SHALL BE RESPONSIBLE FOR SITE SAFETY INCLUDING COMPLIANCE WITH ALL APPLICABLE OSHA STANDARDS AND RECOMMENDATIONS AND SHALL PROVIDE ALL NECESSARY SAFETY DEVICES INCLUDING PPE AND PPM AND CONSTRUCTION DEVICES SUCH AS WELDING AND FIRE PREVENTION, TEMPORARY SHORING, SCAFFOLDING, TRENCH BOXES/SLOPING, BARRIERS, ETC.
- 27. THE CONTRACTOR SHALL PROTECT AT HIS OWN EXPENSE, ALL EXISTING FACILITIES AND SUCH OF HIS NEW WORK LIABLE TO INJURY DURING THE CONSTRUCTION PERIOD. ANY DAMAGE CAUSED BY NEGLECT ON THE PART OF THIS CONTRACTOR OR HIS REPRESENTATIVES, OR BY THE ELEMENTS DUE TO NEGLECT ON THE PART OF THIS CONTRACTOR OR HIS

- REPRESENTATIVES, EITHER TO THE EXISTING WORK, OR TO HIS WORK OR THE WORK OF ANY OTHER CONTRACTOR. SHALL BE REPAIRED AT HIS EXPENSE TO THE OWNER'S SATISFACTION.
- 28. ALL WORK SHALL BE INSTALLED IN A FIRST CLASS, NEAT AND WORKMANLIKE MANNER BY MECHANICS SKILLED IN THE TRADE INVOLVED. THE QUALITY OF WORKMANSHIP SHALL BE SUBJECT TO THE APPROVAL OF THE ATC CM. ANY WORK FOUND BY THE ATC CM TO BE OF INFERIOR QUALITY AND/OR WORKMANSHIP SHALL BE REPLACED AND/OR REWORKED AT CONTRACTOR EXPENSE UNTIL APPROVAL IS OBTAINED.
- 29. IN ORDER TO ESTABLISH STANDARDS OF QUALITY AND PERFORMANCE, ALL TYPES OF MATERIALS LISTED HEREINAFTER BY MANUFACTURER'S NAMES AND/OR MANUFACTURER'S CATALOG NUMBER SHALL BE PROVIDED BY THESE MANUFACTURERS AS SPECIFIED.

#### CONCRETE AND REINFORCING STEEL NOTES:

- DESIGN AND CONSTRUCTION OF ALL CONCRETE ELEMENTS SHALL CONFORM TO THE LATEST EDITIONS OF ALL APPLICABLE CODES INCLUDING: ACI 301 "SPECIFICATIONS FOR STRUCTURAL CONCRETE FOR BUILDINGS", ACI 117 "SPECIFICATIONS FOR TOLERANCES FOR CONCRETE CONSTRUCTION AND MATERIALS", AND ACI 318 "BUILDING CODE REQUIREMENTS FOR REINFORCED CONCRETE"
- 2. MIX DESIGN SHALL BE APPROVED BY ATC CM PRIOR TO PLACING CONCRETE.
- CONCRETE SHALL BE NORMAL WEIGHT, 6 % AIR ENTRAINED (+/- 1.5%) WITH A SLUMP RANGE OF 3-5" AND HAVE A MINIMUM 28-DAY COMPRESSIVE STRENGTH OF 4000 PSI UNLESS OTHERWISE NOTED.
- 4. THE FOLLOWING MATERIALS SHALL BE USED:

PORTLAND CEMENT: ASTM C150, TYPE 2

REINFORCEMENT: ASTM A185, PLAIN STEEL WELDED WIRE FABRIC

REINFORCEMENT BARS: ASTM A615, GRADE 60, DEFORMED

NORMAL WEIGHT AGGREGATE: ASTM C33
WATER: ASTM C 94/C 94M

ADMIXTURES

-WATER-REDUCING AGENT: ASTM C 494/C 494M, TYPE A

-AIR-ENTERING AGENT: ASTM C 260/C 260M

-SUPERPLASTICIZER: ASTM C494, TYPE F OR TYPE G

-RETARDING: ASTM C 494/C 494M, TYPE B

- 5. MINIMUM CONCRETE COVER FOR REINFORCING STEEL SHALL BE NO LESS THAN 3".
- A 3/4" CHAMFER SHALL BE PROVIDED AT ALL EXPOSED EDGES OF CONCRETE IN ACCORDANCE WITH ACI 301 SECTION 4.2.4, UNLESS NOTED OTHERWISE.
- 7. INSTALLATION OF CONCRETE EXPANSION/WEDGE ANCHOR SHALL BE PER MANUFACTURER'S WRITTEN RECOMMENDED PROCEDURE. THE ANCHOR BOLT, DOWEL, OR ROD SHALL CONFORM TO MANUFACTURER'S RECOMMENDATION FOR EMBEDMENT DEPTH OR AS SHOWN ON THE DRAWINGS. NO REBAR SHALL BE CUT WITHOUT PRIOR ATC CM APPROVAL WHEN DRILLING HOLES IN CONCRETE.
- ADMIXTURES SHALL CONFORM TO THE APPROPRIATE ASTM STANDARD AS REFERENCED IN "METHOD 1" OF ACI 301.
- DO NOT WELD OR TACK WELD REINFORCING STEEL.
- 10. ALL DOWELS, ANCHOR BOLTS, EMBEDDED STEEL, ELECTRICAL CONDUITS, PIPE SLEEVES, GROUNDS AND ALL OTHER EMBEDDED ITEMS AND FORMED DETAILS SHALL BE IN PLACE BEFORE START OF CONCRETE PLACEMENT.
- 11. REINFORCEMENT SHALL BE COLD BENT WHENEVER BENDING IS REQUIRED.
- 12. DO NOT PLACE CONCRETE IN WATER, ICE, OR ON FROZEN GROUND.
- 13. DO NOT ALLOW REINFORCEMENT, CONCRETE OR SUBBASE TO FREEZE DURING CONCRETE CURING AND SETTING PERIOD, OR FOR A MINIMUM OF 3 DAYS AFTER PLACEMENT.
- 14. FOR COLD-WEATHER(ACI 306) AND HOT-WEATHER(ACI 301M) CONCRETE PLACEMENT, CONFORM TO APPLICABLE ACI CODES AND RECOMMENDATIONS. IN EITHER CASE, MATERIALS CONTAINING CHLORIDE, CALCIUM, SALTS, ETC. SHALL NOT BE USED. PROTECT FRESH CONCRETE FROM WEATHER FOR 7 DAYS, MINIMUM.
- 15. ALL CONCRETE SHALL HAVE A "SMOOTH FORM FINISH."
- 16. UNLESS OTHERWISE NOTED:
  - ALL REINFORCING STEEL SHALL BE DEFORMED BARS CONFORMING TO ASTM A615/A 615M/A-996, GRADE 60.
  - B. WELDED WIRE FABRIC SHALL CONFORM TO ASTM A185.
- 17. SPLICING OF REINFORCEMENT IS PERMITTED ONLY AT LOCATIONS SHOWN IN THE CONTRACT DRAWINGS OR AS ACCEPTED BY THE ENGINEER. UNLESS OTHERWISE SHOWN OR NOTED REINFORCING STEEL SHALL BE SPLICED TO DEVELOP ITS FULL TENSILE CAPACITY (CLASS A) IN ACCORDANCE WITH ACI 318.
- 18. REINFORCING BAR DEVELOPMENT LENGTHS, AS COMPUTED IN ACCORDANCE WITH ACI 318, FORM THE BASIS FOR BAR EMBEDMENT LENGTHS AND BAR SPLICED LENGTHS SHOWN IN THE

- DRAWINGS. APPLY APPROPRIATE MODIFICATION FACTORS FOR TOP STEEL, BAR SPACING, COVER AND THE LIKE.
- DETAILING OF REINFORCING STEEL SHALL CONFORM TO "ACI MANUAL OF STANDARD PRACTICE FOR DETAILING REINFORCED CONCRETE STRUCTURES" (ACI 315).
- 20. ALL SLAB CONSTRUCTION SHALL BE CAST MONOLITHICALLY WITHOUT HORIZONTAL CONSTRUCTION JOINTS. UNLESS SHOWN IN THE CONTRACT DRAWINGS.
- 11. LOCATION OF ALL CONSTRUCTION JOINTS ARE SUBJECT TO THE REQUIREMENTS OF THE CONTRACT DOCUMENTS, CONFORMANCE WITH ACI 318, AND ACCEPTANCE OF THE ENGINEER. DRAWINGS SHOWING LOCATION OF DETAILS OF THE PROPOSED CONSTRUCTION JOINTS SHALL BE SUBMITTED WITH REINFORCING STEEL PLACEMENT DRAWINGS.
- 22. SPLICES OF WWF, AT ALL SPLICED EDGES, SHALL BE SUCH THAT THE OVERLAP MEASURED BETWEEN OUTERMOST CROSS WIRES OF EACH FABRIC SHEET IS NOT LESS THAN THE SPACING OF THE CROSS WIRE PLUS 2 INCHES, NOR LESS THAN 6".
- BAR SUPPORTS SHALL BE ALL-GALVINIZED METAL WITH PLASTIC TIPS.
- 24. ALL REINFORCEMENT SHALL BE SECURELY TIED IN PLACE TO PREVENT DISPLACEMENT BY CONSTRUCTION TRAFFIC OR CONCRETE. TIE WIRE SHALL BE OF SUFFICIENT STRENGTH FOR INTENDED PURPOSE, BUT NOT LESS THAN NO. 18 GAUGE.
- 25. SLAB ON GROUND:
  - A. COMPACT SUBGRADE AND ENSURE THERE IS PLACE 6" GRAVEL BENEATH SLAB.
  - B. PROVIDE VAPOR BARRIER BENEATH SLAB ON GROUND.

#### STRUCTURAL STEEL NOTES:

- STRUCTURAL STEEL SHALL CONFORM TO THE LATEST EDITION OF THE AISC "SPECIFICATION FOR THE DESIGN, FABRICATION AND ERECTION OF STRUCTURAL STEEL FOR BUILDINGS."
- STRUCTURAL STEEL ROLLED SHAPES, PLATES AND BARS SHALL CONFORM TO THE FOLLOWING ASTM DESIGNATIONS:
  - A. ASTM A-572, GRADE 50 ALL W SHAPES, UNLESS NOTED OR A992 OTHERWISE
  - B. ASTM A-36 ALL OTHER ROLLED SHAPES, PLATES AND BARS UNLESS NOTED OTHERWISE
  - C. ASTM A-500, GRADE B HSS SECTION (SQUARE, RECTANGULAR, AND ROUND)
  - D. ASTM A-325, TYPE SC OR N ALL BOLTS FOR CONNECTING STRUCTURAL MEMBERS
  - E. ASTM F-1554 07 ALL ANCHOR BOLTS, UNLESS NOTED OTHERWISE
- ALL EXPOSED STRUCTURAL STEEL MEMBERS SHALL BE HOT-DIPPED GALVANIZED AFTER FABRICATION PER ASTM A123. EXPOSED STEEL HARDWARE AND ANCHOR BOLTS SHALL BE GALVANIZED PER ASTM A153 OR B695
- 4. ALL FIELD CUT SURFACES, FIELD DRILLED HOLES AND GROUND SURFACES WHERE EXISTING PAINT OR GALVANIZATION REMOVAL WAS REQUIRED SHALL BE REPAIRED WITH (2) BRUSHED COATS OF ZRC GALVILITE COLD GALVANIZING COMPOUND PER ASTM A780 AND MANUFACTURER'S RECOMMENDATIONS
- DO NOT DRILL HOLES THROUGH STRUCTURAL STEEL MEMBERS EXCEPT AS SHOWN AND DETAILED ON STRUCTURAL DRAWINGS.
- 6. CONNECTIONS:
  - A. ALL WELDING TO BE PERFORMED BY AWS CERTIFIED WELDERS AND CONDUCTED IN ACCORDANCE WITH THE LATEST EDITION OF THE AWS WELDING CODE D1.1.
  - B. ALL WELDS SHALL BE INSPECTED VISUALLY. 25% OF WELDS SHALL BE INSPECTED WITH DYE PENETRANT OR MAGNETIC PARTICLE TO MEET THE ACCEPTANCE CRITERIA OF AWS D1.1. REPAIR ALL WELDS AS NECESSARY.
  - C. INSPECTION SHALL BE PERFORMED BY AN AWS CERTIFIED WELD INSPECTOR.
  - D. IT IS THE CONTRACTORS RESPONSIBILITY TO PROVIDE BURNING/WELDING PERMITS AS REQUIRED BY LOCAL GOVERNING AUTHORITY AND IF REQUIRED SHALL HAVE FIRE DEPARTMENT DETAIL FOR ANY WELDING ACTIVITY.
  - E. ALL ELECTRODES TO BE LOW HYDROGEN, MATCHING FILLER METAL, PER AWS D1.1, UNLESS NOTED OTHERWISE.
  - F. MINIMUM WELD SIZE TO BE 0.1875 INCH FILLET WELDS, UNLESS NOTED OTHERWISE.
  - G. PRIOR TO FIELD WELDING GALVANIZING MATERIAL, CONTRACTOR SHALL GRIND OFF GALVANIZING ½" BEYOND ALL FIELD WELD SURFACES. AFTER WELD AND WELD INSPECTION IS COMPLETE, REPAIR ALL GROUND AND WELDED SURFACES WITH ZRC GALVILITE COLD GALVANIZING COMPOUND PER ASTM A780 AND MANUFACTURERS RECOMMENDATIONS.



A.T. ENGINEERING SERVICE, PLLC 3500 REGENCY PARKWAY SUITE 100 CARY, NC 27518 PHONE: (919) 468-0112

THESE DRAWINGS AND/OR THE ACCOMPANYING SPECIFICATION AS INSTRUMENTS OR SERVICE ARE THE EXCLUSIVE PROPERTY OF AMERICAN TOWER. THEIR USE AND PUBLICATION SHALL BE RESTRICTED TO THE ORIGINAL SITE FOR WHICH THEY ARE PREPARED. ANY USE OR DISCLOSURE OTHER THAN THAT WHICH RELATES TO AMERICAN TOWER OR THE SPECIFIED CARRIER IS STRICTLY PROHIBITED. TITLE TO THESE DOCUMENTS SHALL REMAIN THE PROPERTY OF AMERICAN TOWER WHETHER OR NOT THE PROJECT IS EXECUTED. NEITHER THE ARCHITECT NOR THE ENGINEER WILL BE PROVIDING ON-SITE CONSTRUCTION REVIEW OF THIS PROJECT. CONTRACTOR(S) MUST VERIFY ALL DIMENSIONS AND ADVISE AMERICAN TOWER OF ANY DISCREPANCIES. ANY PRIOR ISSUANCE OF THIS DRAWING IS SUPERSEDED BY THE LATEST VERSION ON FILE WITH AMERICAN TOWER.

l	REV.	DESCRIPTION	BY	DATE
l	$\triangle_{-}$	FOR CONSTRUCTION	_AB_	_03/30/21_
l	$\triangle_{-}$			
l	$\triangle_{-}$			
l	$\wedge_{-}$			
l	$\overline{\wedge}$			
ı				

ATC SITE NUMBER

302493

ATC SITE NAME:

NRWC - NORWICH

SITE ADDRESS: 223 ROGERS ROAD NORWICH, CT 06360

SEAL:



T··Mobile

 DRAWN BY:
 AB

 APPROVED BY:
 PB

 DATE DRAWN:
 03/30/21

 ATC JOB NO:
 13348360\_M4

**GENERAL NOTES** 

SHEET NUMBER

G-002

 $\mathsf{C}$ 

REVISION

#### SITE PLAN NOTES:

- THIS SITE PLAN REPRESENTS THE BEST PRESENT KNOWLEDGE AVAILABLE TO THE ENGINEER AT THE TIME OF THIS DESIGN. THE CONTRACTOR SHALL VISIT THE SITE PRIOR TO CONSTRUCTION AND VERIEY ALL EXISTING CONDITIONS RELATED TO THE SCOPE OF WORK FOR THIS PROJECT
- ICE BRIDGE, CABLE LADDER, COAX PORT, AND COAX CABLE ARE SHOWN FOR REFERENCE ONLY. CONTRACTOR SHALL CONFIRM THE EXACT LOCATION OF ALL PROPOSED AND EXISTING EQUIPMENT AND STRUCTURES DEPICTED ON THIS PLAN. BEFORE UTILIZING EXISTING CABLE SUPPORTS, COAX PORTS, INSTALLING NEW PORTS OR ANY OTHER EQUIPMENT, CONTRACTOR SHALL VERIFY ALL ASPECTS OF THE COMPONENTS MEET THE ATC SPECIFICATIONS.
- IT IS THE RESPONSIBILITY OF THE CONTRACTOR TO COORDINATE WITH THE ATC CONSTRUCTION MANAGER AND LOCAL UTILITY COMPANY FOR THE INSTALLATION OF CONDUITS, CONDUCTORS, BREAKERS, DISCONNECTS, OR ANY OTHER EQUIPMENT REQUIRED FOR ELECTRICAL SERVICE. ALL ELECTRICAL WORK SHALL BE PERFORMED IN ACCORDANCE WITH LATEST EDITION OF THE STATE AND NATIONAL CODES, ORDINANCES AND REGULATIONS APPLICABLE TO THIS PROJECT
- CONTRACTOR SHALL INSURE THAT ALL WORKING SPACE REQUIREMENTS ARE MET PER APPLICABLE CODES AND MANUFACTURER SPECIFICATIONS.
- ABOVE GROUND CONDUITS NEED TO BE SUPPORTED/FASTENED PER NEC 344, NEC 352, AND PER ATC CONSTRUCTION SPECIFICATIONS.
- THE FOLLOWING SIGNS SHALL BE INSTALLED AT TENANT SERVICE MAIN DISCONNECT PER NEC 702.7.
- "CAUTION: TWO SOURCES OF SUPPLY STANDBY GENERATOR LOCATED
- "WARNING: SHOCK HAZARD EXISTS IF GROUNDING ELECTRODE 6.2. CONDUCTOR OR BONDING JUMPER CONNECTION IN THIS EQUIPMENT IS REMOVED WHILE ALTERNATE SOURCE IS ENERGIZED"

THAN 1/4 INCH ANY DIMENSION SEAL ALL CONDUITS INCLUDING CONDUITS ENTERING GENERATOR


INSTALL ALL PROVIDED SEALS, PLUGS, COVERS, ETC. IN GENERATOR AND

FUEL TANK ENVELOPE. SEAL ALL REMAINING OPENINGS (EXCEPT NORMAL

VENTING) WITH RODENT FOAM SEALANT. NO OPENING SHALL BE LARGER

RODENT CONTROL AROUND GENERATOR ENVELOPE:

- EQUIPMENT, BOXES, ATTACHMENTS, ETC. WITH RODENT FOAM SEALANT.
- SEAL ALL CONDUIT ACCESS OPENINGS THROUGH CONCRETE PAD WITH

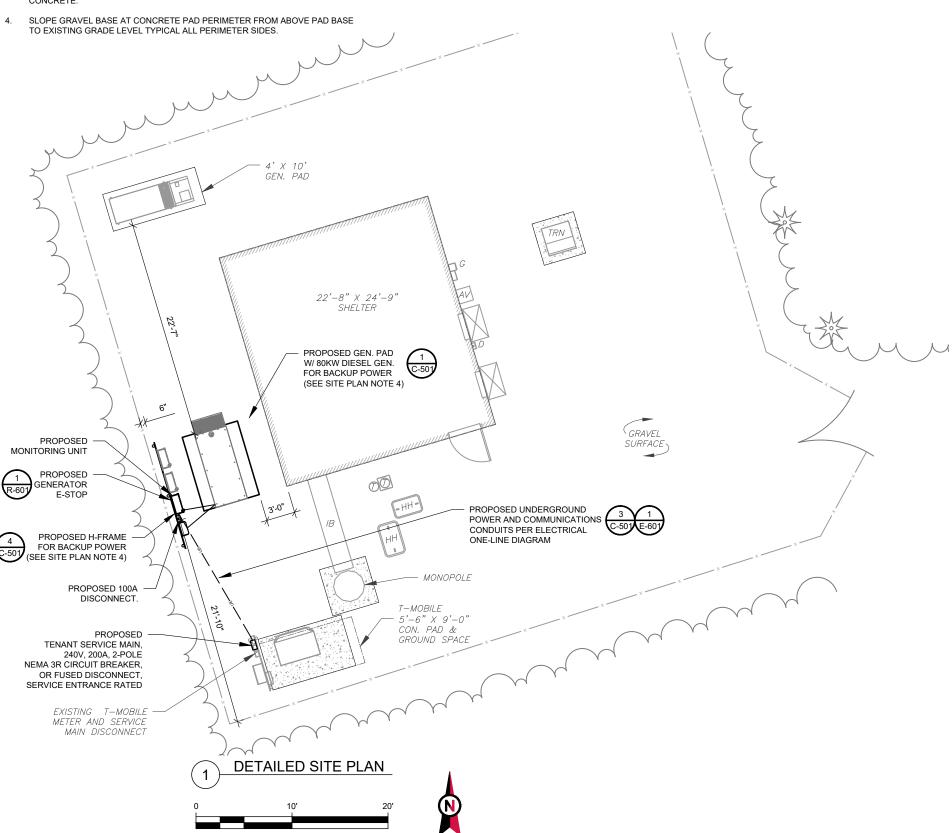

SCALE: 1"=10' (11X17) 1"=5' (22X34)

### APPROXIMATE TRENCH DISTANCES

LEGEND

**BOLLARD** 

DISCONNECT

ELECTRICAL

**GENERATOR** 

ICE BRIDGE

METER

TELCO

PULL BOX

POWER POLE

TRANSFORMER

CHAINLINK FENCE

KENTROX BOX

FIBER

ATS

CSC

GEN

HH. V

LC

PR

PP

TRN

G

D

GROUNDING TEST WELL AUTOMATIC TRANSFER SWITCH

GENERATOR RECEPTACAL

CELL SITE CABINET

HAND HOLE, VAULT

LIGHTING CONTROL

18' POWER CONDUIT TRENCH



**AMERICAN TOWER®** A.T. ENGINEERING SERVICE, PLLC

3500 REGENCY PARKWAY SUITE 100 **CARY, NC 27518** PHONE: (919) 468-0112 COA: PEC.0001553

THESE DRAWINGS AND/OR THE ACCOMPANYING SPECIFICATION AS INSTRUMENTS OR SERVICE ARE THE EXCLUSIVE PROPERTY OF AMERICAN TOWER. THEIR USE AND PUBLICATION SHALL BE RESTRICTED TO THE ORIGINAL SITE FOR WHICH THEY ARE PREPARED. ANY USE OR DISCLOSURE OTHER THAN THAT WHICH RELATES TO AMERICAN TOWER OR THE SPECIFIED CARRIER IS STRICTLY PROHIBITED. ITILE TO THESE DOCUMENTS SHALL REMAIN THE PROPERTY OF AMERICAN TOWER WHETHER OR NOT THE PROJECT IS EXECUTED. NEITHER THE ARCHITECT NOR THE ENGINEER WILL BE PROVIDING ON-SITE CONSTRUCTION REVIEW OF THIS PROJECT. CONTRACTOR(S) MUST VERIFY ALL DIMENSIONS AND ADVISE AMERICAN TOWER OF ANY DISCREPANCIES. ANY PRIOR ISSUANCE OF THIS DRAWING IS SUPERSEDED BY THE LATEST VERSION ON FILE WITH AMERICAN TOWER. THESE DRAWINGS AND/OR THE ACCOMPANYING

REV.	DESCRIPTION	BY	DATE
<u> </u>	FOR CONSTRUCTION	AB	03/30/21
$\overline{\wedge}$			
$\overline{\wedge}$			
$\square$			
<b> </b>			

ATC SITE NUMBER:

302493

ATC SITE NAME:

NRWC - NORWICH

SITE ADDRESS: 223 ROGERS ROAD NORWICH, CT 06360



T··Mobile


П	DRAWN BY:	AB
П	APPROVED BY:	РВ
	DATE DRAWN:	03/30/21
	ATC JOB NO:	13348360_M4
		•

SITE PLAN


SHEET NUMBER:

C-101

REVISION:

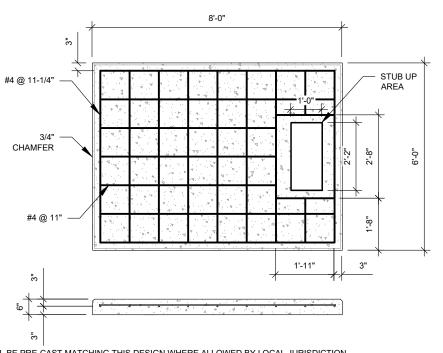

- 1. PADS SHALL BE PRE-CAST MATCHING THIS DESIGN WHERE ALLOWED BY LOCAL JURISDICTION.
- PADS SHALL HAVE A MIN 28 DAY COMPRESSIVE STRENGTH AS SPECIFIED ON G-002. CONCRETE AND REINFORCING STEEL NOTES #3
- REFER TO CONCRETE & REINFORCED STEEL NOTES ON SHEET G-002 & ATC CONSTRUCTION SPECIFICATION 033000 FOR
- STUB UP AREA SHALL BE FILLED WITH QUIKRETE, OR APPROVED EQUAL, PRIOR TO FINAL SET OF GENERATOR ON PAD.
- AFTER FINAL SET OF GENERATOR ON PAD, GROUT ALL EXTERIOR OPENINGS AT PAD INTERFACE SO THAT FINISHED MAXIMUM
- 6. GROUT SHALL BE PER ATC CONSTRUCTION SPECIFICATION DIVISION 03, CONCRETE.

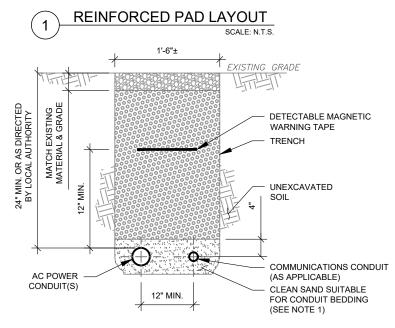

#### TRENCH NOTES:

PAD NOTES:

- IF FREE OF ORGANIC OR OTHER DELETERIOUS MATERIAL, EXCAVATED MATERIAL MAY BE USED FOR BACKFILL. IF NOT, PROVIDE CLEAN, COMPACTIBLE MATERIAL.
- COMPACT IN 8" LIFTS USING A MECHANICAL PLATE TAMPER, MIN 3 PASSES. REMOVE ANY LARGE ROCKS PRIOR TO BACKFILLING. CONTRACTOR TO VERIFY LOCATION OF EXISTING U/G UTILITIES PRIOR TO DIGGING. SEE ATC CONSTRUCTION SPECIFICATION 312000 SECTION 3.15.
- IF CURRENT AS-BUILT DRAWINGS ARE NOT AVAILABLE CONTRACTOR SHALL HAND DIG U/G TRENCHING. CONFIRM SPACING AND DEPTH WITH NEC OR LOCAL CODE REQUIREMENTS




UNISTRUT PIPE/CONDUIT CLAMP P1119 OR P2558-35 (GALV.) (TYP.) FOLLOW MANÚFACTURER RECOMMENDATIONS FOR BOLT TORQUE


CONDUCTOR LOOP

- IF IT IS NECESSARY TO EXTEND THE H-FRAME, AN ADDITIONAL POST SHALL BE REQUIRED.
- PROTECTIVE CAPS FOR SAFETY.
- UNISTRUT TO BE CUT FLUSH WITH NO SHARP OR JAGGED EDGES.
- ALL PROPOSED HARDWARE TO BE MOUNTED AND GROUNDED PER MANUFACTURERS SPECS
- ALL ITEMS ARE PROPOSED UNLESS OTHERWISE NOTED.

BY JURISDICTION)


- FOOTINGS SHALL BE ONE OF THE FOLLOWING: USS POLECRETE STABILIZER SYSTEM, PRECAST CONCRETE (WHERE ALLOWED BY JURISDICTION) OR CAST IN PLACE. FOR PRECAST FOOTINGS, CONTRACTORS SHALL THOROUGHLY

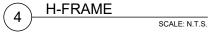

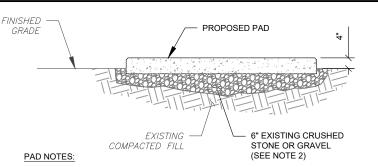

- SUBGRADE AND FILL SHALL CONSIST OF CLEAN SOIL. DELETRIOUS MATERIAL AND ORGANICS SHALL BE REMOVED.
- MECHANICALLY COMPACT FOOTPRINT OF PAD PLUS 2' PERIMETER USING A MECHANICAL PLATE TAMPER, MIN 3 PASSES. SEE ATC CONSTRUCTION SPECIFICATION 312000 ACCESS ROAD AND EARTH WORK
- 3. USE GALVANIZED HILTI EXPANSION ANCHORS OR, APPROVED EQUAL, FOR
- FOR SIZE AND LOCATION OF ANCHORS AND OTHER REQUIREMENT, SEE EQUIPMENT VENDOR DRAWINGS.



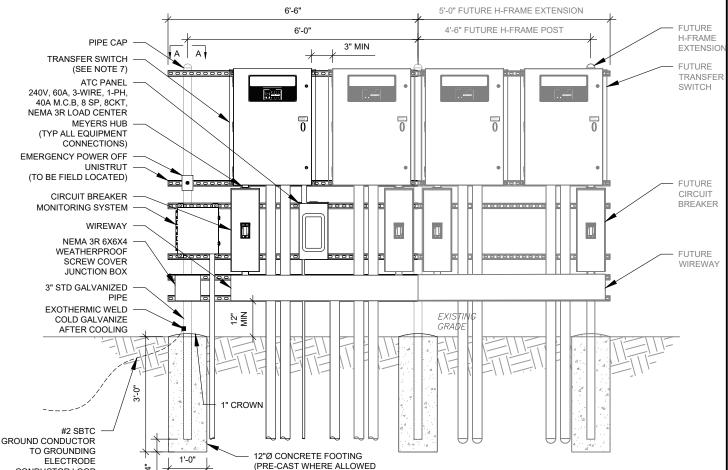

#### H-FRAME NOTES:

- PROPOSED UNISTRUTS TO BE FIELD CUT AND SHALL NOT EXTEND MORE THAN 6 INCHES BEYOND THE LAST POST. SPRAY ENDS OF UNISTRUT WITH COLD GALVANIZING SPRAY PAINT, ALLOW TO DRY, THEN COVER WITH RUBBER

- LAYOUT H-FRAME & PROPOSED EQUIPMENT EXACTLY AS SHOWN TO ALLOW FOR FUTURE EQUIPMENT. ANY DEVIATIONS MUST BE APPROVED BY ATC CM, IN WRITING, NO EXCEPTIONS.
- COMPACT THE PERIMETER (2' MIN) OF FOOTING WITH MECHANICAL PLATE TAMPER.



# T··Mobile

**AMERICAN TOWER** A.T. ENGINEERING SERVICE, PLLC 3500 REGENCY PARKWAY SUITE 100

**CARY, NC 27518** 

PHONE: (919) 468-0112

COA: PEC.0001553

THESE DRAWINGS AND/OR THE ACCOMPANYING SPECIFICATION AS INSTRUMENTS OR SERVICE ARE THE EXCLUSIVE PROPERTY OF AMERICAN TOWER. THEIR USE AND PUBLICATION SHALL BE RESTRICTED TO THE ORIGINAL SITE FOR WHICH THEY ARE PREPARED. ANY USE OR DISCLOSURE OTHER THAN THAT WHICH RELATES TO AMERICAN TOWER OR THE SPECIFIED CARRIER IS STRICTLY PROHIBITED. TITLE TO THESE DOCUMENTS SHALL REMAIN THE PROPERTY OF AMERICAN TOWER WHETHER DRAW OF NOT THE PROJECT IS STRICTLY PROHIBITED. THE SECOND THE PROJECT IS MALERICAN TOWER WHETHER OR NOT THE PROJECT IS STRICTLY PROHIBITED.

EXECUTED. NEITHER THE ARCHITECT NOR THE ENGINEER WIL

ATC SITE NUMBER:

302493

ATC SITE NAME:

NRWC - NORWICH

SITE ADDRESS:

223 ROGERS ROAD

NORWICH, CT 06360

BE PROVIDING ON-SITE CONSTRUCTION REVIEW OF THIS PROJECT. CONTRACTOR(S) MUST VERIFY ALL DIMENSIONS AND
ADVISE AMERICAN TOWER OF ANY DISCREPANCIES. ANY PRIO ISSUANCE OF THIS DRAWING IS SUPERSEDED BY THE LATEST VERSION ON FILE WITH AMERICAN TOWER.

DESCRIPTION

FOR CONSTRUCTION

THESE DRAWINGS AND/OR THE ACCOMPANYING

	DRAWN BY:	AB
	APPROVED BY:	PB
	DATE DRAWN:	03/30/21
	ATC JOB NO:	13348360_M4

#### **CONCRETE PAD DETAILS**


SHEET NUMBER:

C-501

REVISION



**CONDUIT TRENCH DETAILS** 

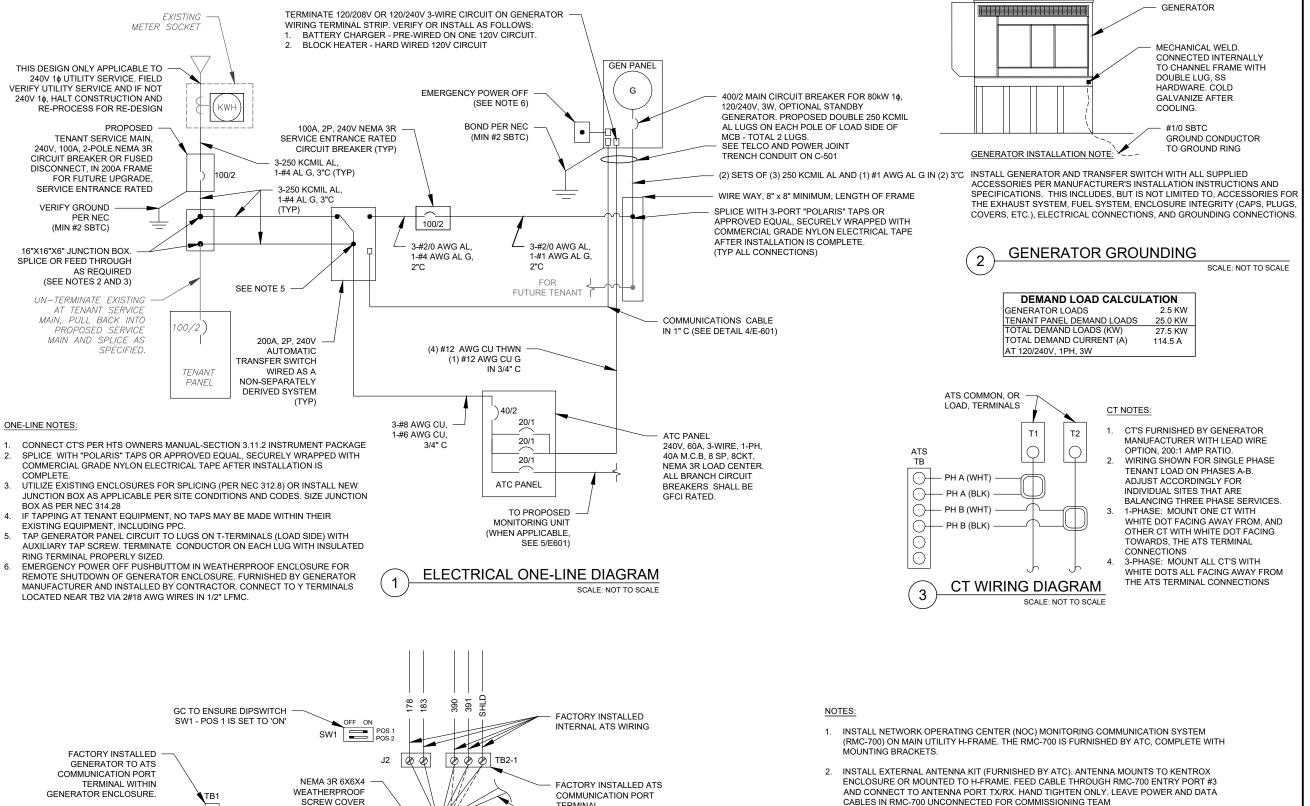

CONNECT TO E-STOP BUTTON

MOUNTED ON ATS H-FRAME

WIRING CONNECTION TO NEXT FUTURE ATS

KNOCK OUT REMOVED FOR

CONDUIT TO FUTURE ATS

AMERICAN TOWER A.T. ENGINEERING SERVICE, PLLC 3500 REGENCY PARKWAY

SUITE 100 **CARY, NC 27518** PHONE: (919) 468-0112 COA: PEC.0001553

THESE DRAWINGS AND/OR THE ACCOMPANYING THESE DRAWINGS AND/OR THE ACCOMPANYING
SPECIFICATION AS INSTRUMENTS OR SERVICE ARE THE
EXCLUSIVE PROPERTY OF AMERICAN TOWER. THEIR USE AND
PUBLICATION SHALL BE RESTRICTED TO THE ORIGINAL SITE
FOR WHICH THEY ARE PREPARED. ANY USE OR DISCLOSURE
OTHER THAN THAT WHICH RELATES TO AMERICAN TOWER OR
THE SPECIFIED CARRIER IS STRICTLY PROHIBITED. TITLE TO
THESE DOCUMENTS SHALL REMAIN THE PROPERTY OF AMERICAN TOWER WHETHER OR NOT THE PROJECT IS EXECUTED, NEITHER THE ARCHITECT NOR THE ENGINEER WIL BE PROVIDING ON-SITE CONSTRUCTION REVIEW OF THIS PROJECT. CONTRACTOR(S) MUST VERIFY ALL DIMENSIONS AN ADVISE AMERICAN TOWER OF ANY DISCREPANCIES. ANY PRIC ISSUANCE OF THIS DRAWING IS SUPERSEDED BY THE LATEST VERSION ON FILE WITH AMERICAN TOWER.

REV.	DESCRIPTION	BY	DATE
△_	FOR CONSTRUCTION	_ <u>AB</u> _	03/30/21
$\triangle$			
$\overline{\wedge}$			
$\overline{\wedge}$			

ATC SITE NUMBER:

302493

ATC SITE NAME:

NRWC - NORWICH

SITE ADDRESS: 223 ROGERS ROAD NORWICH, CT 06360

3. BRANCH CIRCUIT WIRING FOR MONITORING DEVICE SHALL BE 2-#12 AWG CU. 1-#12 AWG CU

PROPOSED MONITORING

G IN 3/4" C





	DRAWN BY:	AB
	APPROVED BY:	PB
	DATE DRAWN:	03/30/21
	ATC JOB NO:	13348360_M4

**ELECTRICAL ONE-LINE** AND WIRING DETAILS

SHEET NUMBER

REVISION

E-601

COMMUNICATIONS CABLE DETAIL SCALE: NOT TO SCALE

TO GENERATOR PANEL. CONNECT PER

MANUFACTURER'S SPECIFICATIONS (DO NOT CONNECT "SHLD" AT GENERATOR)

JUNCTION BOX

2-#14 AWG CU

2 WIRE ENGINE START

2 WIRE E-STOP

2#18 AWG CU

1 - 0

2 - 183


15A/220A


15A1/220A1

4 - 390/485+ 5 - 391/485-6 - SHLD

## GENERAC | INDUSTRIAL

### **REMOTE EMERGENCY STOP SWITCH SURFACE MOUNT, H-PANEL**

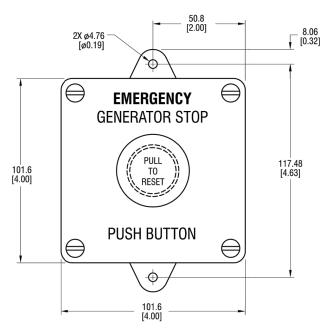

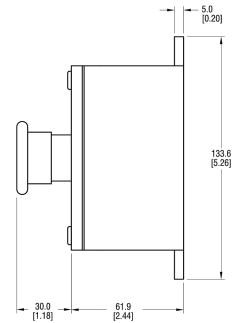



- MANUFACTURER: PILLA ELECTRICAL PRODUCTS, INC.
- MODEL SG120
- GENERAC PART NUMBER 061129E
- SURFACE MOUNT, NEMA 4X
- NONMETALLIC BACKBOX

DIMENSIONS: mm[INCHES]

# GENERAC | INDUSTRIAL

## **REMOTE EMERGENCY STOP SWITCH SURFACE MOUNT, H-PANEL**

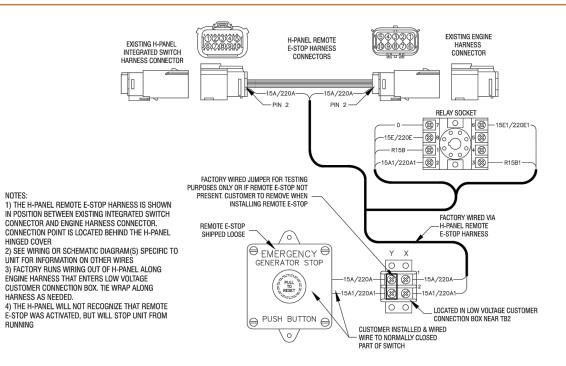

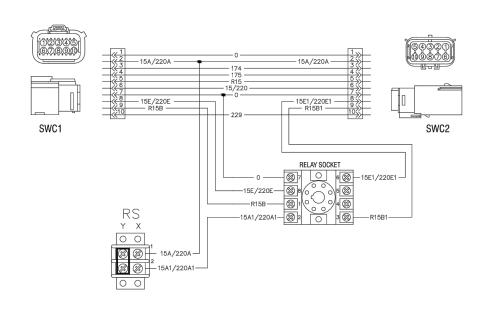

Generac Power Systems, Inc. | P.O. Box 8 | Waukesha, WI 53187 |
P: (262) 544-4811 © 2015 Generac Power Systems, Inc. All rights reserved. All specifications are subject to change without notice.

Part No. 0L6260 Rev A 10/15/15

**SUPPLEMENTAL** 

REVISION:

0

SHEET NUMBER:

R-601

E-STOP SWITCH

1 OF 2

GENSET CONTROLS

#### **STANDBY POWER RATING**

80 kW, 100 kVA, 60 Hz

#### **PRIME POWER RATING\***

72 kW, 90 kVA, 60 Hz





\*Built in the USA using domestic and foreign parts

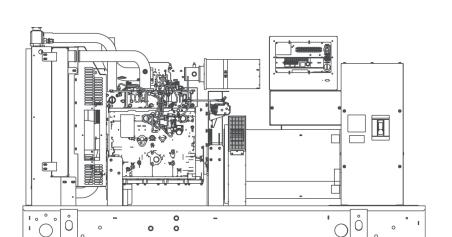


Image used for illustration purposes only

#### **CODES AND STANDARDS**

Generac products are designed to the following standards:



UL2200, UL508, UL142, UL498



NFPA70, 99, 110, 37



NEC700, 701, 702, 708



ISO9001, 8528, 3046, 7637, Pluses #2b, 4



NEMA ICS10, MG1, 250, ICS6, AB1



ANSI C62.41

#### **POWERING AHEAD**

For over 50 years, Generac has led the industry with innovative design and superior manufacturing.

Generac ensures superior quality by designing and manufacturing most of its generator components, including alternators, enclosures and base tanks, control systems and communications software.

Generac's gensets utilize a wide variety of options, configurations and arrangements, allowing us to meet the standby power needs of practically every application.

Generac searched globally to ensure the most reliable engines power our generators. We choose only engines that have already been proven in heavy-duty industrial application under adverse conditions.

Generac is committed to ensuring our customers' service support continues after their generator purchase.

<sup>\*</sup>EPA Certified Prime ratings are not available in the U.S. or its Territories.

<sup>\*\*</sup>Certain options or customization may not hold certification valid.

## **SD080** | 4.5L | 80 kW

#### INDUSTRIAL DIESEL GENERATOR SET

**EPA Certified Stationary Emergency** 

#### STANDARD FEATURES

#### **ENGINE SYSTEM**

#### General

- · Oil Drain Extension
- Air Cleaner
- · Fan Guard
- · Stainless Steel flexible exhaust connection
- · Critical Exhaust Silencer (enclosed only)
- · Factory Filled Oil
- · Radiator Duct Adapter (open set only)

#### **Fuel System**

- · Fuel lockoff solenoid
- · Primary fuel filter

#### **Cooling System**

- · Closed Coolant Recovery System
- · UV/Ozone resistant hoses
- · Factory-Installed Radiator
- · Radiator Drain Extension
- 50/50 Ethylene glycol antifreeze
- 120 VAC Coolant Heater

#### **Engine Electrical System**

- · Battery charging alternator
- · Battery cables
- · Battery tray
- · Solenoid activated starter motor
- Rubber-booted engine electrical connections

#### **ALTERNATOR SYSTEM**

- UL2200 GENprotect™
- 12 leads (3-phase, non 600 V)
- · Class H insulation material
- Vented rotor
- 2/3 pitch
- · Skewed stator
- · Auxiliary voltage regulator power winding
- · Amortisseur winding
- · Brushless Excitation
- · Sealed Bearings
- Automated manufacturing (winding, insertion, lacing, varnishing)
- · Rotor dynamically spin balanced
- · Full load capacity alternator
- · Protective thermal switch

#### **GENERATOR SET**

- · Internal Genset Vibration Isolation
- · Separation of circuits high/low voltage
- · Separation of circuits multiple breakers
- · Silencer Heat Shield
- Wrapped Exhaust Piping
- · Silencer housed in discharge hood (enclosed only)
- · Standard Factory Testing
- · 2 Year Limited Warranty (Standby rated Units)
- 1 Year Limited Warranty (Prime rated Units)
- · Silencer mounted in the discharge hood (enclosed only)

#### **ENCLOSURE (IF SELECTED)**

- Rust-proof fasteners with nylon washers to protect finish
- · High performance sound-absorbing material
- · Gasketed doors
- · Stamped air-intake louvers
- · Air discharge hoods for radiator-upward pointing
- · Stainless steel lift off door hinges
- · Stainless steel lockable handles
- Rhino Coat<sup>™</sup> Textured polyester powder coat

#### TANKS (IF SELECTED)

- UL 142
- · Double wall
- Vents
- Sloped top
- Sloped bottom
- · Factory pressure tested (2 psi)
- Rupture basin alarm
- Fuel level
- · Check valve in supply and return lines
- Rhino Coat<sup>™</sup>- Textured polyester powder coat
- Stainless hardware

#### **CONTROL SYSTEM**



#### **Control Panel**

- Digital H Control Panel Dual 4x20 Display
- · Programmable Crank Limiter
- 7-Day Programmable Exerciser
- · Special Applications Programmable PLC
- RS-232/485
- · All-Phase Sensing DVR
- · Full System Status
- · Utility Monitoring
- Low Fuel Pressure Indication
- 2-Wire Start Compatible
- · Power Output (kW)

- Power Factor
- kW Hours, Total & Last Run
- Real/Reactive/Apparent Power
- All Phase AC Voltage
- · All Phase Currents
- Oil Pressure
- · Coolant Temperature
- Coolant Level
- Engine Speed
- Battery Voltage
- FrequencyDate/Time Fault History (Event Log)
- Isochronous Governor Control
- Waterproof/sealed Connectors
- Audible Alarms and Shutdowns
- Not in Auto (Flashing Light)
- Auto/Off/Manual SwitchE-Stop (Red Mushroom-Type)
- NFPA110 Level I and II (Programmable)
- Customizable Alarms, Warnings, and Events
- Modbus protocol
- Predictive Maintenance algorithm
- Sealed Boards
- Password parameter adjustment protection

- Single point ground
- 15 channel data logging
- 0.2 msec high speed data logging
- Alarm information automatically comes up on the display

#### Alarms

- Oil Pressure (Pre-programmable Low Pressure Shutdown)
- Coolant Temperature (Pre-programmed High Temp Shutdown)
- Coolant Level (Pre-programmed Low Level Shutdown)
- Low Fuel Pressure Alarm
- Engine Speed (Pre-programmed Over speed Shutdown)
- Battery Voltage Warning
- Alarms & warnings time and date stamped
- Alarms & warnings for transient and steady state conditions
- Snap shots of key operation parameters during alarms & warnings
- Alarms and warnings spelled out (no alarm codes)

#### SD080

### | 4.5L | 80 kW



INDUSTRIAL DIESEL GENERATOR SET

#### **CONFIGURABLE OPTIONS**

**EPA Certified Stationary Emergency** 

#### **ENGINE SYSTEM**

#### General

- O Oil Heater
- O Industrial Exhaust Silencer

#### **Fuel System**

- O Flexible fuel lines
- O Primary fuel filter

#### **Engine Electrical System**

- O 10A UL battery charger
- O 2.5A UL battery charger
- O Battery Warmer

#### ALTERNATOR SYSTEM

- O Alternator Upsizing
- O Anti-Condensation Heater
- O Tropical coating
- O Permanent Magnet Excitation

#### **ENGINEERED OPTIONS**

#### **ENGINE SYSTEM**

- O Coolant heater ball valves
- O Block Heaters
- O Fluid containment pans

#### **ALTERNATOR SYSTEM**

O 3rd Breaker Systems

#### **CONTROL SYSTEM**

- O Spare inputs (x4) / outputs (x4) H Panel Only
- O Battery Disconnect Switch

#### **CIRCUIT BREAKER OPTIONS**

- O Main Line Circuit Breaker
- O 2nd Main Line Circuit Breaker
- O Shunt Trip and Auxiliary Contact
- O Electronic Trip Breaker

#### **GENERATOR SET**

- O Gen-Link Communications Software (English Only)
- O IBC Seismic Certification
- O 8 Position Load Center
- O 2 Year Extended Warranty
- O 5 Year Warranty
- O 5 Year Extended Warranty

#### **ENCLOSURE**

- O Weather Protected
- O Level 1 Sound Attenuation
- O Level 2 Sound Attenuation
- O Steel Enclosure
- O Aluminum Enclosure
- O 150 MPH Wind Kit
- O 12 VDC Enclosure Lighting Kit
- O 120 VAC Enclosure Lighting Kit
- O AC/DC Enclosure Lighting Kit
- O Door Alarm Switch

#### TANKS (Size on last page)

- O Electrical Fuel Level
- O Mechanical Fuel Level
- O 8" Fill Extension
- O 13" Fill Extension
- O 19" Fill Extension

#### **CONTROL SYSTEM**

- O 21-Light Remote Annunciator
- O Remote Relay Panel (8 or 16)
- O Oil Temperature Sender with Indication Alarm
- O Remote E-Stop (Break Glass-Type, Surface Mount)
- O Remote E-Stop (Red Mushroom-Type, Surface Mount)
- O Remote E-Stop (Red Mushroom-Type, Flush Mount)
- O Remote Communication Modem
- O Remote Communication Ethernet
- O 10A Run Relay
- O Ground Fault Indication and Protection Functions

#### **GENERATOR SET**

O Special Testing

#### **ENCLOSURE**

- O Motorized Dampers
- O Door switched for intrusion alert
- O Enclosure ambient heaters

#### TANKS

- O Overfill Protection Valve
- O UL2085 Tank
- O ULC S-601 Tank
- O Stainless Steel Tank
- O Special Fuel Tanks (MIDEQ and FL DEP/DERM, etc.)
- O Vent Extensions

#### **RATING DEFINITIONS**

Standby - Applicable for a varying emergency load for the duration of a utility power outage with no overload capability.

Prime - Applicable for supplying power to a varying load in lieu of utility for an unlimited amount of running time. A 10% overload capacity is available for 1 out of every 12 hours. The Prime Power option is only available on International applications. Power ratings in accordance with ISO 8528-1, Second Edition

### INDUSTRIAL DIESEL GENERATOR SET

**EPA Certified Stationary Emergency** 

#### **APPLICATION AND ENGINEERING DATA**

ENGINE SPECIFICATIONS General		Cooling System	
delleral		Cooling System	
Make	Iveco/FPT	Cooling System Type	Closed
EPA Emissions Compliance	Stationary Emergency	Water Pump	Belt Driven Centrifugal
EPA Emissions Reference	See Emissions Data Sheet	Fan Type	Pusher
Cylinder #	4	Fan Speed (rpm)	2538
Туре	In-Line	Fan Diameter mm (in)	660.4 (26)
Displacement - L (cu In)	4.5 (274.6)	Coolant Heater Wattage	1500
Bore - mm (in)	105 (4.1)	Coolant Heater Standard Voltage	120 V /240 V
Stroke - mm (in)	132 (5.2)		
Compression Ratio	17.5:1		
Intake Air Method	Turbocharged/Aftercooled	Fuel System	
Cylinder Head Type	2 Valve	Fuel Type	Ultra Low Sulfur Diesel Fue
Piston Type	Aluminium	Fuel Specifications	ASTM
Crankshaft Type	Forged Steel	Fuel Filtering (microns)	5
		Fuel Injection	Stanadyne
Engine Governing		Fuel Pump Type	Engine Driven Gear
Governor	Electronic Isochronous	Injector Type	Mechanical
Frequency Regulation (Steady State)	+/- 0.25%	Fuel Supply Line mm (in)	12.7 (0.5) NPT
		Fuel Return Line mm (in)	12.7 (0.5) NPT
Lubrication System			
Oil Pump Type	Gear		
Oil Filter Type	Full Flow	Engine Electrical System	
Crankcase Capacity - L (qts)	13.6 (14.4)	System Voltage	12 VDC
		Battery Charging Alternator	20 A
		Battery Size	See Battery Index 0161970SBY
		Battery Voltage	12 VDC
		Ground Polarity	Negative

#### **ALTERNATOR SPECIFICATIONS**

Standard Model	390
Poles	4
Field Type	Revolving
Insulation Class - Rotor	Н
Insulation Class - Stator	Н
Total Harmonic Distortion	<3%
Telephone Interference Factor (TIF)	< 50

Standard Excitation	Synchronous Brushless
Bearings	One-Pre Lubed & Sealed
Coupling	Direct, Flexible Disc
Load Capacity - Standby	100%
Prototype Short Circuit Test	Yes
Voltage Regulator Type	Digital
Number of Sensed Phases	3
Regulation Accuracy (Steady State)	±0.25%

INDUSTRIAL DIESEL GENERATOR SET **EPA Certified Stationary Emergency** 

#### **OPERATING DATA**

#### **POWER RATINGS**

		Standby
Single-Phase 120/240 VAC @1.0pf	80 kW	Amps: 333
Three-Phase 120/208 VAC @0.8pf	80 kW	Amps: 278
Three-Phase 120/240 VAC @0.8pf	80 kW	Amps: 241
Three-Phase 277/480 VAC @0.8pf	80 kW	Amps: 120
Three-Phase 346/600 VAC @0.8pf	80 kW	Amps: 96

#### STARTING CAPABILITIES (sKVA)

sKVA vs. Voltage Dip

		480 VAC						208/24	10 VAC				
<u>Alternator</u>	<u>kW</u>	10%	15%	20%	25%	30%	35%	10%	15%	20%	25%	30%	35%
Standard	80	59	88	117	147	176	205	44	66	88	110	132	154
Upsize 1	100	79	118	157	197	236	275	59	89	118	148	177	206
Upsize 2	130	116	174	232	290	348	406	87	131	174	218	261	305

#### **FUEL CONSUMPTION RATES\***

Diesel - gal/hr (l/hr)

Fuel Pump Lift - ft (m)	Percent Load	Standby
3 (1)	25%	2.1 (7.9)
	50%	3.7 (14.0)
Total Fuel Pump Flow (Combustion + Return)	75%	5.2 (19.7)
13.6 gal/hr	100%	6.3 (23.8)

<sup>\*</sup> Fuel supply installation must accommodate fuel consumption rates at 100% load.

#### COOLING

		Standby
Coolant Flow per Minute	gal/min (l/min)	32.7 (123.8)
Coolant System Capacity	gal (L)	4.5 (17.44)
Heat Rejection to Coolant	BTU/hr	232,270
Inlet Air	cfm (m³/hr)	6360 (180)
Max. Operating Radiator Air Temp	Fo (Co)	122 (50)
Max. Ambient Temperature (before derate)	Fo (Co)	104 (40)
Maximum Radiator Backpressure	in H <sub>2</sub> O	0.5

#### **COMBUSTION AIR REQUIREMENTS**

		Standby
Flow at Rated Power	cfm (m³/min)	306 (8.67)

ENGINE			EXHAUST		
		Standby			Standby
Rated Engine Speed	rpm	1800	Exhaust Flow (Rated Output)	cfm (m³/min)	782 (22.14)
Horsepower at Rated kW**	hp	131	Max. Backpressure (Post Silencer)	inHg (Kpa)	1.5 (5.1)
Piston Speed	ft/min (m/min)	1559 (475)	Exhaust Temp (Rated Output)	°F (°C)	887 (475)
BMEP	psi	210	Exhaust Outlet Size (Open Set)	mm (in)	76.2 (3.0)


<sup>\*\*</sup> Refer to "Emissions Data Sheet" for maximum bHP for EPA and SCAQMD permitting purposes.


INDUSTRIAL DIESEL GENERATOR SET


**EPA Certified Stationary Emergency** 


#### **DIMENSIONS AND WEIGHTS\***




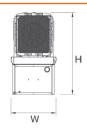


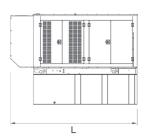


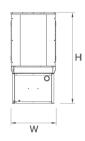

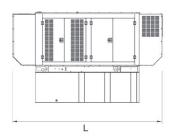

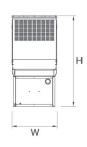

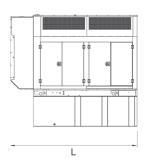

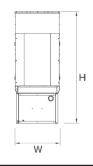

#### **OPEN SET**

RUN TIME HOURS	USABLE CAPACITY GAL (L)	L x W x H in (mm)	WT lbs (kg) - Tank & Open Set
NO TANK	-	93 (2362.2) x 40 (1016) x 49 (1244.6)	2425 (1100)
13	79 (299)	93 (2362.2) x 40 (1016) x 62 (1574.8)	2947 (1201)
30	189 (715.4)	93 (2362.2) x 40 (1016) x 74 (1879.6)	3183 (1444)
48	300 (1135.6)	93 (2362.2) x 40 (1016) x 86 (2184.4)	3407 (1545)
56	350 (1325)	110 (2794) x 40 (1016) x 86 (2184.4)	NA
81	510 (1930.5)	117 (2971.8) x 47 (1193.8) x 86 (2184.4)	3790 (1719)
93	589 (2229.6)	128 (3251.2) x 49 (1244.6) x 86 (2184.4)	4269 (1936)

#### STANDARD ENCLOSURE

RUN TIME	USABLE CAPACITY	L x W x H in (mm)	WT lbs (kg) - Enclosure Only		
HOURS	GAL (L)	L X W X I I III (I I I I I I I	Steel	Aluminum	
NO TANK	-	112 (2844.8) x 41 (1041.4) x 56 (1422.4)	_		
13	79 (299)	112 (2844.8) x 41 (1041.4) x 69 (1752.6)			
30	189 (715.4)	112 (2844.8) x 41 (1041.4)x 81 (2057.4)	_		
48	300 (1135.6)	112 (2844.8) x 41 (1041.4) x 93 (2362.2)	425 (193)	155 (70)	
56	350 (1325)	112 (2844.8) x 41 (1041.4) x 93 (2362.2)	_		
81	510 (1930.5)	117 (2971.8) x 47 (1193.8) x 93 (2362.2)	_		
93	589 (2229.6)	128 (3251.2) x 49 (1244.6) x 93 (2362.2)			

#### **LEVEL 1 ACOUSTIC ENCLOSURE**

RUN TIME	USABLE CAPACITY	LyWyllin/mm)	WT lbs (kg) - Enclosure Only		
HOURS	GAL (L)	L x W x H in (mm)	Steel	Aluminum	
NO TANK	-	130 (3302) x 41 (1041.4) x 56 (1422.4)	_		
13	79 (299)	130 (3302) x 41 (1041.4) x 69 (1752.6)	_		
30	189 (715.4)	130 (3302) x 41 (1041.4) x 81 (2057.4)	_		
48	300 (1135.6)	130 (3302) x 41 (1041.4) x 93 (2362.2)	450 (204)	285 (129)	
56	350 (1325)	130 (3302) x 41 (1041.4) x 93 (2362.2)			
81	510 (1930.5)	130 (3302) x 47 (1193.8) x 93 (2362.2)	_		
93	589 (2229.6)	130 (3302) x 49 (1244.6) x 93 (2362.2)	_		

#### **LEVEL 2 ACOUSTIC ENCLOSURE**

RUN TIME	USABLE	Lu Wu Llin (nana)	WT lbs (kg) - Enclosure Only		
HOURS	CAPACITY GAL (L)	L x W x H in (mm)	Steel	Aluminum	
NO TANK	-	112 (2844.8) x 41 (1041.4) x 69 (1752.6)			
13	79 (299)	112 (2844.8) x 41 (1041.4) x 82 (2082.8)			
30	189 (715.4)	112 (2844.8) x 41 (1041.4) x 94 (2387.6)	,		
48	300 (1135.6)	112 (2844.8) x 41 (1041.4) x 106 (2692.4)	625 (284)	395 (180)	
56	350 (1325)	112 (2844.8) x 41 (1041.4) x 106 (2692.4)			
81	510 (1930.5)	117 (2971.8) x 47 (1193.8) x 106 (2692.4)			
93	589 (2229.6)	128 (3251.2) x 49 (1244.6) x 106 (2692.4)			

<sup>\*</sup>All measurements are approximate and for estimation purposes only. Sound dBA can be found on the sound data sheet. Enclosure Only weight is added to Tank & Open Set weight to determine total weight.

Specification characteristics may change without notice. Dimensions and weights are for preliminary purposes only. Please consult a Generac Power Systems Industrial Dealer for detailed installation drawings.

REFERENCE 100510

SHIPPER REFERENCE 100510

**SHIP DATE** Mon 6/28/2021 03:48 PM

**DELIVERED TO** Receptionist/Front Desk

PACKAGING TYPE FedEx Envelope

ORIGIN BLUE BELL, PA, US, 19422


**DESTINATION** NORWICH, CT, US, 06360

SPECIAL HANDLING Deliver Weekday

NUMBER OF PIECES 1

TOTAL SHIPMENT WEIGHT 0.50 LB

SERVICE TYPE FedEx Standard Overnight

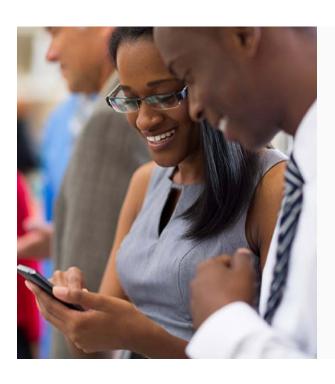

# Download the FedEx® Mobile app

Get the flexibility you need to create shipments and request to customize your deliveries through the app.

**LEARN MORE** 

#### **FOLLOW FEDEX**















☑ Please do not respond to this message. This email was sent from an unattended mailbox.
This report was generated at approximately 9:31 AM CDT 06/29/2021.