#### EM-CING-101-201005

From: Daniel Hatab <daniel.hatab@ramapocom.com>

**Sent:** Friday, April 2, 2021 10:35 AM

**To:** CSC-DL Siting Council <Siting.Council@ct.gov>

**Subject:** AT&T Site CTL02012

Good Morning,

The site below has been completed on 3/05, we have CSC exempt letter, attached for reference, but CCA letter was received and attached as well.

AT&T Site: CTL02012

Address: 15 DEWIGHT STREET, NORTH HAVEN, CT 06473

Thank You,

## Daniel Hatab

daniel.hatab@ramapocom.com 20 Romanelli Ave, S. Hackensack, NJ 07606

Cell Phone: (201) 742-1070 Office Phone: (201) 343-2995



Date: March 30, 2021

State of Connecticut Connecticut Siting Council Ten Franklin Square New Britain, Ct. 06051 Phone: (860) 827-2935

SMW Engineering Group, Inc. 158 Business Center Dr Birmingham AL. 35244 (205) 252-6985

Jurisdiction: Town of North Haven, CT

Building Permit: B-20-1207

Subject: Special Inspection Letter – Final Certification

ATC Site: North Haven Ct 1 – 302482

AT&T site: CTL02012 – FA:10034972

Site Address: 15 Dwight Street

North Haven, Ct. 06473-1198

AT&T Scope of work: Antenna Amendment Drawings

SMW Engineering Project: 20-10277.1

Dear Sir or Madam,

On March 30, 2021, SMW Engineering Group, Inc., reviewed detailed photographs of the AT&T telecommunication facility located at the above referenced site. The purpose of these pictures was to inspect the installation in accordance with the following codes:

- International Building Code (IBC)
- National Electric Code (NEC)
- Local Building Code
- City / County Ordinances

#### Proposed scope of work on tower from Construction Drawings:

- Removal of (3) existing Powerwave 7770 antennas (1) per sector
- Relocate of (3) existing CCI OPA-65R-LCUU-H6 antennas (1) per sector
- Removal of (3) existing RRUS-11 B12 (1) per sector
- Removal of (3) existing RRUS-12 B2 (1) per sector
- Installation of Handrail Reinforcement Kit Site pro 1 P/N HSRK-35 Typ. each sector
- Installation of (3) new CCI DMP65R-BU6DA antennas (1) per sector

- Installation of (3) RRUS 4449 B5/B12 (1) per sector
- Installation of (3) RRUS 8843 B2/B66A (1) per sector
- Installation of (1) DC6-48-60-18-8F- squid

#### **Discrepancies from Permitted Drawings:**

None


To the best of our knowledge, belief, and professional judgment, the connections of the installed equipment were performed **in substantial compliance** with the approved construction drawings prepared by SMW Engineering Group, Inc. dated 09-22-20 Rev. 1.

Should you have any questions or wish to discuss any aspect of this letter, please do not hesitate to contact the undersigned.

Sincerely,

John T. Liu, PE **SMW Engineering Group, INC.** Principal Engineer Connecticut Registration #33076



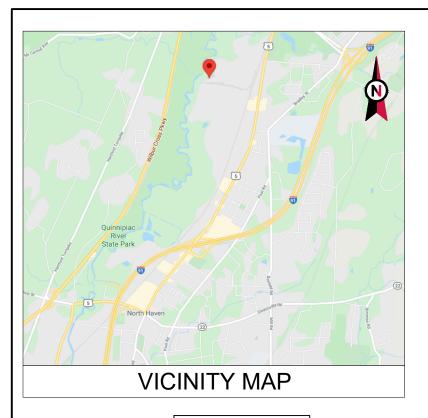



## **AMERICAN TOWER®**


ATC SITE NAME: NORTH HAVEN CT 1

ATC SITE NUMBER: 302482 AT&T SITE ID: CTL02012 AT&T FA CODE:10034972

AT&T SITE NAME: NORTH HAVEN-DWIGHT ST

SITE ADDRESS: 15 DEWIGHT STREET

NORTH HAVEN, CT 06473-1198

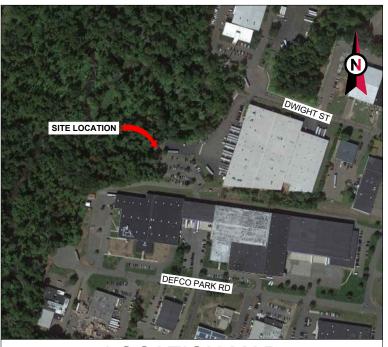

**LOCATION MAP** 

Matthew Schlosser

Matthew Schlosser

## CURRENT PROJECTS:

Call before you dig.

5C - PACE #: MRCTB046848 4TX4RX - PACE #: MRCTB046681 4TX4RX - PACE #: MRCTB046511 5G NR - PACE #: MRCTB046791

## AT&T MOBILITY ANTENNA AMENDMENT PLAN

COMPLIANCE CODE	PROJECT S	UMMARY	PROJECT DESCRIPTION	SHEET INDEX				
ALL WORK SHALL BE PERFORMED AND MATERIALS INSTALLED IN ACCORDANCE WITH THE CURRENT EDITIONS OF THE	15 DEWIGHT STREET		THE PROPOSED PROJECT INCLUDES MODIFYING GROUND BASED AND TOWER MOUNTED EQUIPMENT AS INDICATED PER BELOW:		DESCRIPTION:	REV:	DATE:	BY:
FOLLOWING CODES AS ADOPTED BY THE LOCAL GOVERNMENT AUTHORITIES. NOTHING IN THESE PLANS IS			TOWER WORK: REMOVE (3) UMTS ANTENNAS, (6) LTE RRH'S, AND (2) 0.51" HYBRID	G-001	COVER SHEET	1	09/22/20	ZDS
TO BE CONSTRUED TO PERMIT WORK NOT CONFORMING TO THESE CODES.	NORTH HAVEN, O		CABLES	G-002	GENERAL NOTES	1	09/22/20	ZDS
INTERNATIONAL BUILDING CODE (IBC)	COUNTY: NE GEOGRAPHIC CO		INSTALL (3) LTE ANTENNAS, (9) LTE RRH'S, (1) DC6 SQUID, (2) 0.78" 8AWG6 DC TRUNKS, (2) 0.39" FIBER CABLES, AND MOUNT	C-101	DETAILED SITE PLAN	1	09/22/20	ZDS
2. NATIONAL ELECTRIC CODE (NEC)	LATITUDE: 41		MODIFICATIONS	C-201	TOWER ELEVATION	1	09/22/20	ZDS
LOCAL BUILDING CODE     CITY/COUNTY ORDINANCES	LONGITUDE:		EXISTING (6) LTE ANTENNAS, (3) LTE RRH'S, (12) DPLEXERS, (6) TMA'S, (2) DC6 SQUIDS, (4) 0.78" 8AWG6 DC TRUNKS, AND (12) 1-1/4"	C-401	RF SCHEDULE AND ANTENNA INSTALLATION	1	09/22/20	ZDS
	GROUND ELEVAT	ION: 26' AMSL	COAX CABLES TO REMAIN GROUND WORK:	C-501	CONSTRUCTION DETAILS	1	09/22/20	ZDS
			INSTALL (1) 6630 AND (1) IDLE	C-502	EQUIPMENT SPECIFICATIONS	1	09/22/20	ZDS
	PROJECT TEAM		EXISTING (2) RRUS-4478 B14 TO REMAIN		GROUNDING DETAILS	1	09/22/20	ZDS
				R-601	SUPPLEMENTAL			
			PROJECT NOTES	R-602	SUPPLEMENTAL			
	TOWER OWNER:  AMERICAN TOWER	APPLICANT: AT&T MOBILITY	THE FACILITY IS UNMANNED.     A TECHNICIAN WILL VISIT THE SITE APPROXIMATELY ONCE     A MONTH FOR ROUTINE INSPECTION AND MAINTENANCE.     THE PROJECT WILL NOT RESULT IN ANY SIGNIFICANT LAND     DISTURBANCE OR EFFECT OF STORM WATER DRAINAGE.		MOUNT MODIFICATIONS			
	10 PRESIDENTIAL WAY WOBURN, MA 01801							
UTILITY COMPANIES			4. NO SANITARY SEWER, POTABLE WATER OR TRASH DISPOSAL IS REQUIRED.  5. HANDICAP ACCESS IS NOT REQUIRED.					
POWER COMPANY: UNITED ILLUMINATING								
PHONE: (800) 722-5584	jsharit@smweng.com							
TELEPHONE COMPANY: FRONTIER COMMUNICATIONS PHONE: (800) 376-6843	SMW ENGINEERING GROUP INC. 158 BUSINESS CENTER DR.		PROJECT LOCATION DIRECTIONS					
Know what's below.	BIRMINGHAM, AL. 35244  JOB# 20-10277   CONSULTING ENGINEER  PROPERTY OWNER:  15 DWIGHT ST LLC  C/O NEIL F CARRANO  11 SAGAMORE TERRACE S. WESTBROOK, CT 06498		I-91 TO EXIT 13 TO RT 5 SOUTH. TURN RIGHT ONTO DEFCO PARK ROAD. TAKE FIRST RIGHT ONTO DODGE THEN LEFT ONTO DWIGHT. GO TO END OF STREET AND TURN LEFT INTO GATED PARKING LOT. TOWER IS IN BACK TO THE RIGHT.				ILT CDs o Communica 21	ion Corp
Know wnat's Delow.						Matthey	w Schlosser	



TOCETHER PLANNING A BETTER TOMORROW
158 BUSINESS CENTER DRIVE BIRMINGHAM, AL 35244

TEL: 205-252-6985 FAX: 205-320-1504

REV	. DESCRIPTION	BY	DATE
$\triangle$	FOR CONSTRUCTION	ZDS	09/22/20
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$\overline{\wedge}$			
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ATC SITE NUMBER:

302482

ATC SITE NAME:

NORTH HAVEN CT 1

AT&T MOBILITY SITE NAME:

#### NORTH HAVEN-DWIGHT ST

SITE ADDRESS: 15 DEWIGHT STREET NORTH HAVEN, CT 06473-1198





П	DATE DRAWN:	06/24/20					
П	ATC JOB NO:	13242626_G3					
П	CUSTOMER ID:	NORTH HAVEN-DWIGHT ST					
П	CUSTOMER #:	10034972					

TITLE SHEET

SHEET NUMBER:

REVISION: G-001

#### **GENERAL CONSTRUCTION NOTES:**

- OWNER FURNISHED MATERIALS, AT&T MOBILITY "THE COMPANY" WILL PROVIDE AND THE 22. CONTRACTOR WILL INSTALL
  - A. BTS EQUIPMENT FRAME (PLATFORM) AND ICEBRIDGE SHELTER (GROUND BUILD/CO-LOCATE ONLY)
  - AC/TELCO INTERFACE BOX (PPC)
  - ICE BRIDGE (CABLE TRAY WITH COVER) (GROUND BUILD/CO-LOCATE ONLY, GC TO FURNISH AND INSTALL FOR ROOFTOP INSTALLATION)

  - D. TOWERS, MONOPOLES
  - TOWER LIGHTING
  - GENERATORS & LIQUID PROPANE TANK
  - ANTENNA STANDARD BRACKETS, FRAMES AND PIPES FOR MOUNTING
  - ANTENNAS (INSTALLED BY OTHERS)
  - TRANSMISSION LINE
  - TRANSMISSION LINE JUMPERS
  - TRANSMISSION LINE CONNECTORS WITH WEATHERPROOFING KITS
  - TRANSMISSION LINE GROUND KITS
  - HANGERS
  - HOISTING GRIPS
  - O. BTS EQUIPMENT
- THE CONTRACTOR IS RESPONSIBLE TO PROVIDE ALL OTHER MATERIALS FOR THE COMPLETE INSTALLATION OF THE SITE INCLUDING, BUT NOT LIMITED TO, SUCH
  MATERIALS AS FENCING, STRUCTURAL STEEL SUPPORTING SUB-FRAME FOR PLATFORM ROOFING LABOR AND MATERIALS GROUNDING RINGS GROUNDING WIRES COPPER-CLAD OR XIT CHEMICAL GROUND ROD(S), BUSS BARS, TRANSFORMERS AND DISCONNECT SWITCHES WHERE APPLICABLE, TEMPORARY ELECTRICAL POWER, CONDUIT, LANDSCAPING COMPOUND STONE, CRANES, CORE DRILLING, SLEEPERS AND RUBBER MATTING, REBAR, CONCRETE CAISSONS, PADS AND/OR AUGER MOUNTS,
  MISCELLANEOUS FASTENERS, CABLE TRAYS, NON-STANDARD ANTENNA FRAMES AND ALL OTHER MATERIAL AND LABOR REQUIRED TO COMPLETE THE JOB ACCORDING TO THE DRAWINGS AND SPECIFICATIONS. IT IS THE POSITION OF AT&T MOBILITY TO APP FOR PERMITTING AND CONTRACTOR RESPONSIBLE FOR PICKUP AND PAYMENT OF
- ALL WORK SHALL CONFORM TO ALL CURRENT APPLICABLE FEDERAL, STATE, AND LOCAL CODES, INCLUDING ANSI/EIA/TIA-222, AND COMPLY WITH ATC CONSTRUCTION
- CONTRACTOR SHALL CONTACT LOCAL 811 FOR IDENTIFICATION OF UNDERGROUND
- CONTRACTOR SHALL BE RESPONSIBLE FOR COORDINATING ALL REQUIRED
- ALL DIMENSIONS TO, OF, AND ON EXISTING BUILDINGS, DRAINAGE STRUCTURES, AND SITE IMPROVEMENTS SHALL BE VERIFIED IN FIELD BY CONTRACTOR WITH ALL DISCREPANCIES REPORTED TO THE ENGINEER.
- DO NOT CHANGE SIZE OR SPACING OF STRUCTURAL ELEMENTS
- DETAILS SHOWN ARE TYPICAL; SIMILAR DETAILS APPLY TO SIMILAR CONDITIONS UNLESS 32.
- THESE DRAWINGS DO NOT INCLUDE NECESSARY COMPONENTS FOR CONSTRUCTION SAFETY WHICH SHALL BE THE SOLE RESPONSIBILITY OF THE CONTRACTOR
- CONTRACTOR SHALL BRACE STRUCTURES UNTIL ALL STRUCTURAL ELEMENTS NEEDED 33. FOR STABILITY ARE INSTALLED. THESE ELEMENTS ARE AS FOLLOWS: LATERAL BRACING,
- CONTRACTOR SHALL DETERMINE EXACT LOCATION OF EXISTING UTILITIES, GROUNDS DRAINS, DRAIN PIPES, VENTS, ETC, BEFORE COMMENCING WORK
- INCORRECTLY FABRICATED, DAMAGED, OR OTHERWISE MISFITTING OR NONCONFORMING MATERIALS OR CONDITIONS SHALL BE REPORTED TO THE AT&T MOBILITY REP PRIOR TO REMEDIAL OR CORRECTIVE ACTION. ANY SUCH REMEDIAL ACTION SHALL REQUIRE WRITTEN APPROVAL BY THE AT&T MOBILITY REP PRIOR TO
- EACH CONTRACTOR SHALL COOPERATE WITH THE AT&T MOBILITY REP, AND COORDINATE HIS WORK WITH THE WORK OF OTHERS
- CONTRACTOR SHALL REPAIR ANY DAMAGE CAUSED BY CONSTRUCTION OF THIS PROJECT TO MATCH EXISTING PRE-CONSTRUCTION CONDITIONS TO THE SATISFACTION OF THE AT&T MOBILITY CONSTRUCTION MANAGER.
- ALL CABLE/CONDUIT ENTRY/EXIT PORTS SHALL BE WEATHERPROOFED DURING
- WHERE EXISTING CONDITIONS DO NOT MATCH THOSE SHOWN IN THIS PLAN SET CONTRACTOR SHALL NOTIFY THE AT&T MOBILITY REP AND ENGINEER OF RECORD
- CONTRACTOR SHALL ENSURE ALL SUBCONTRACTORS ARE PROVIDED WITH A COMPLETE AND CURRENT SET OF DRAWINGS AND SPECIFICATIONS FOR THIS PROJECT.
- CONTRACTOR SHALL REMOVE ALL RUBBISH AND DEBRIS FROM THE SITE AT THE END OF
- CONTRACTOR SHALL COORDINATE WORK SCHEDULE WITH AMERICAN TOWER CORPORATION (ATC) AND TAKE PRECAUTIONS TO MINIMIZE IMPACT AND DISRUPTION OF OTHER OCCUPANTS OF THE FACILITY.
- CONTRACTOR SHALL FURNISH AT&T MOBILITY AND AMERICAN TOWER CORPORATION (ATC) WITH A PDF MARKED UP AS-BUILT SET OF DRAWINGS UPON COMPLETION OF
- PRIOR TO SUBMISSION OF BID, CONTRACTOR SHALL COORDINATE WITH AT&T MOBILITY REP TO DETERMINE WHAT, IF ANY, ITEMS WILL BE PROVIDED. ALL ITEMS NOT PROVIDED SHALL BE PROVIDED AND INSTALLED BY THE CONTRACTOR. CONTRACTOR WILL INSTALL 2. ALL EXTERIOR #6 GREED GROUND WIRE "DAISY CHAIN" CONNECTIONS ARE TO BE

- ALL ITEMS PROVIDED.
- PRIOR TO SUBMISSION OF BID. CONTRACTOR SHALL COORDINATE WITH AT&T MOBILITY REP TO DETERMINE IF ANY PERMITS WILL BE OBTAINED BY CONTRACTOR. ALL
  REQUIRED PERMITS NOT OBTAINED BY AT&T MOBILITY MUST BE OBTAINED, AND PAID
- 23. CONTRACTOR SHALL INSTALL ALL SITE SIGNAGE IN ACCORDANCE WITH AT&T MOBILITY
- CONTRACTOR SHALL SUBMIT ALL SHOP DRAWINGS TO AT&T MOBILITY FOR REVIEW AND APPROVAL PRIOR TO FABRICATION.
- 25. ALL EQUIPMENT SHALL BE INSTALLED ACCORDING TO MANUFACTURER'S SPECIFICATIONS AND LOCATED ACCORDING TO AT&T MOBILITY SPECIFICATIONS, AND AS SHOWN IN THESE PLANS.
- THE CONTRACTOR SHALL SUPERVISE AND DIRECT THE PROJECT DESCRIBED HEREIN. THE CONTRACTOR SHALL BE SOLELY RESPONSIBLE FOR ALL THE CONSTRUCTION MEANS, METHODS, TECHNIQUES, SEQUENCES AND PROCEDURES AND FOR COORDINATING ALL PORTIONS OF THE WORK UNDER THE CONTRACT.
- 27. CONTRACTOR SHALL NOTIFY AT&T MOBILITY REP A MINIMUM OF 48 HOURS IN ADVANCE OF POURING CONCRETE OR BACKFILLING ANY UNDERGROUND UTILITIES, FOUNDATIONS OR SEALING ANY WALL, FLOOR OR ROOF PENETRATIONS FOR ENGINEERING REVIEW
- CONTRACTOR SHALL BE RESPONSIBLE FOR SITE SAFETY INCLUDING COMPLIANCE WITH ALL APPLICABLE OSHA STANDARDS AND RECOMMENDATIONS AND SHALL PROVIDE ALL NECESSARY SAFETY DEVICES INCLUDING PPE AND PPM AND CONSTRUCTION DEVICES SUCH AS WELDING AND FIRE PREVENTION, TEMPORARY SHORING, SCAFFOLDING FRENCH BOXES/SLOPING, BARRIERS, ETC.
- THE CONTRACTOR SHALL PROTECT AT HIS OWN EXPENSE, ALL EXISTING FACILITIES AND SUCH OF HIS NEW WORK LIABLE TO INJURY DURING THE CONSTRUCTION PERIOD. ANY DAMAGE CAUSED BY NEGLECT ON THE PART OF THIS CONTRACTOR OR HIS REPRESENTATIVES, OR BY THE ELEMENTS DUE TO NEGLECT ON THE PART OF THIS CONTRACTOR OR HIS REPRESENTATIVES. FITHER TO THE EXISTING WORK, OR TO HIS WORK OR THE WORK OF ANY OTHER CONTRACTOR, SHALL BE REPAIRED AT HIS EXPENSE TO THE OWNER'S SATISFACTION.
- 30. ALL WORK SHALL BE INSTALLED IN A FIRST CLASS, NEAT AND WORKMANLIKE MANNER BY MECHANICS SKILLED IN THE TRADE INVOLVED. THE QUALITY OF WORKMANSHIP SHALL BE SUBJECT TO THE APPROVAL OF THE AT&T MOBILITY REP. ANY WORK FOUND BY THE AT&T MOBILITY, REP TO BE OF INFERIOR QUALITY AND/OR WORKMANSHIP SHALL BE REPLACED AND/OR REWORKED AT CONTRACTOR EXPENSE UNTIL APPROVAL IS
- IN ORDER TO ESTABLISH STANDARDS OF QUALITY AND PERFORMANCE, ALL TYPES OF MATERIALS LISTED HEREINAETER BY MANUFACTURER'S NAMES AND/OF MANUFACTURER'S CATALOG NUMBER SHALL BE PROVIDED BY THESE MANUFACTURERS
- AT&T MOBILITY FURNISHED EQUIPMENT SHALL BE PICKED-UP AT THE AT&T MOBILITY WAREHOUSE, NO LATER THAN 48HR AFTER BEING NOTIFIED INSURED, STORED, UNCRATE, PROTECTED AND INSTALLED BY THE CONTRACTOR WITH ALL APPURTENANCES REQUIRED TO PLACE THE EQUIPMENT IN OPERATION, READY FOR USE. THE CONTRACTOR SHALL BE RESPONSIBLE FOR THE EQUIPMENT AFTER PICKING IT
- AT&T MOBILITY OR HIS ARCHITECT/ENGINEER RESERVES THE RIGHT TO REJECT ANY FOLIPMENT OR MATERIALS WHICH, IN HIS OWN OPINION ARE NOT IN COMPLIANCE WITH THE CONTRACT DOCUMENTS, EITHER BEFORE OR AFTER INSTALLATION AND THE EQUIPMENT SHALL BE REPLACED WITH EQUIPMENT CONFORMING TO THE REQUIREMENTS OF THE CONTRACT DOCUMENTS BY THE CONTRACTOR AT NO COST TO AT&T MOBILITY OR THEIR ARCHITECT/ENGINEER

### SPECIAL CONSTRUCTION ANTENNA INSTALLATION NOTES:

- WORK INCLUDED
  - ANTENNA AND COAXIAL CABLES ARE FURNISHED BY AT&T MOBILITY UNDER A SEPARATE CONTRACT. THE CONTRACTOR SHALL ASSIST ANTENNA INSTALLATION CONTRACTOR IN TERMS OD COORDINATION AND SITE ACCESS. ERECTION SUBCONTRACTOR SHALL BE RESPONSIBLE FOR THE PROTECTION OF
  - B. INSTALL ANTENNA AS INDICATE ON DRAWINGS AND AT&T MOBILITY
  - C. INSTALL GALVANIZED STEEL ANTENNA MOUNTS AS INDICATED ON DRAWINGS
  - D. INSTALL FURNISHED GALVANIZED STEEL OR ALUMINUM WAVEGUIDE AND PROVIDE PRINTOUT OF THAT TEST.
  - E. CONTRACTOR SHALL PROVIDE FOUR (4) SETS OF SWEEP TESTS USING ANRITZU-PACKARD 8713B RF SCALAR NETWORK ANALYZER. SUBMIT FREQUENCY DOMAIN REFLECTOMETER(FDR) TESTS RESULTS TO THE PROJECT MANAGER. SWEEP TESTS SHALL BE AS PER ATTACHED RES "MINIMUM FIELD TESTING RECOMMENDED FOR ANTENNA AND HELIAX COAXIAL CABLE SYSTEMS" DATED 10/5/93. TESTING SHALL BE PERFORMED BY AN INDEPENDENT TESTING SERVICE AND BE BOUND AND SUBMITTED WITHIN ONE WEEK OF WORK COMPLETION.
  - INSTALL COAXIAL CABLES AND TERMINATING BETWEEN ANTENNAS AND EQUIPMENT PER MANUFACTURER'S RECOMMENDATIONS. WEATHERPROOF ALL CONNECTIONS RETWEEN THE ANTENNA AND FOLIPMENT PER MANUFACTURER'S REQUIREMENTS. TERMINATE ALL COAXIAL CABLE THREE (3) FEET IN EXCESS OF ENTRY PORT LOCATION UNLESS OTHERWISE STATED.
  - G. ANTENNA AND COAXIAL CABLE GROUNDING:

WEATHER SEALED WITH RFS CONNECTORS/SPLICE WEATHERPROOFING KIT #221213 OR

ALL COAXIAL CABLE GROUNDING KITS ARE TO BE INSTALLED ON STRAIGHT RUNS OF COAXIAL CABLE (NOT WITHIN BENDS)

> ALL DISCREPANCIES FROM WHAT IS SHOWN ON THESE CONSTRUCTION DRAWINGS SHALL BE COMMUNICATED TO ATC ENGINEERING IMMEDIATELY FOR CORRECTION OR RE-DESIGN. FAILURE TO COMMUNICATE DIRECTLY WITH ATC ENGINEERING OR ANY CHANGES FROM THE DESIGN CONDUCTED WITHOUT PRIOR APPROVAL FROM ATC ENGINEERING SHALL BE THE SOLE RESPONSIBILITY OF THE GENERAL CONTRACTOR.

> > AS-BUILT CDs Ramapo Communicaion Corp 2/5/2021 Matthew Schlosser Matthew Schlosser





together planning a better tomorrow 158 BUSINESS CENTER DRIVE BIRMINGHAM AL 35244 TEL: 205-252-6985 FAX: 205-320-1504

DESCRIPTION DATE FOR CONSTRUCTION

ATC SITE NUMBER:

302482

ATC SITE NAME

NORTH HAVEN CT 1

AT&T MOBILITY SITE NAME:

NORTH HAVEN-DWIGHT ST

SITE ADDRESS: 15 DEWIGHT STREET NORTH HAVEN, CT 06473-1198





DATE DRAWN: | 06/24/20 ATC JOB NO: 13242626 G3 CUSTOMER ID: NORTH HAVEN-DWIGHT ST CUSTOMER #: 10034972


**GENERAL NOTES** 

SHEET NUMBER:


G-002

#### SITE PLAN NOTES:

- THIS SITE PLAN REPRESENTS THE BEST PRESENT KNOWLEDGE AVAILABLE TO THE ENGINEER AT THE TIME OF THIS DESIGN. THE CONTRACTOR SHALL VISIT THE SITE PRIOR TO CONSTRUCTION AND VERIFY ALL EXISTING CONDITIONS RELATED TO THE SCOPE OF WORK FOR THIS PROJECT.
- ICE BRIDGE, CABLE LADDER, COAX PORT, AND COAX CABLE ARE SHOWN FOR REFERENCE ONLY. CONTRACTOR SHALL CONFIRM THE EXACT LOCATION OF ALL PROPOSED AND EXISTING EQUIPMENT AND STRUCTURES DEPICTED ON THIS PLAN. BEFORE UTILIZING EXISTING CABLE SUPPORTS, COAX PORTS, INSTALLING NEW PORTS OR ANY OTHER EQUIPMENT, CONTRACTOR SHALL VERIFY ALL ASPECTS OF THE COMPONENTS MEET THE ATC SPECIFICATIONS.
- THIS PROJECT INCLUDES NO INSTALL OR MODIFICATION AT GRADE.

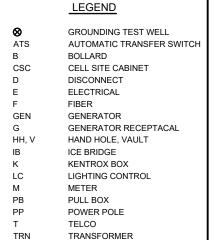

CHAINLINK FENCE

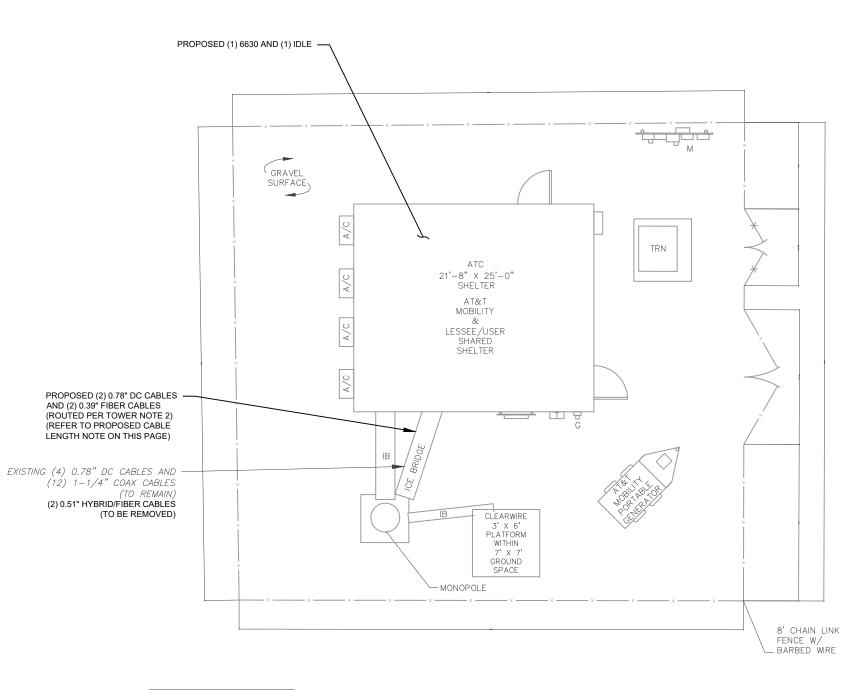

#### PROPOSED CABLE LENGTH:

- ESTIMATED LENGTH OF PROPOSED CABLE IS <u>185'</u>. ESTIMATED LENGTH OF CABLE WAS PROVIDED BY CUSTOMER OR CALCULATED BY ADDING THE RAD CENTER AND THE DISTANCE FROM THE SHELTER ENTRY PLATE TO THE TOWER (ALONG THE ICE BRIDGE) AND A SAFETY FACTOR MEASUREMENT OF 15% (OF THE TWO PREVIOUS VALUES), CDS DEFER TO GREATEST CABLE LENGTH.
- ROUTE PROPOSED CABLES ALONG SAME PATH AS EXISTING CABLES AND IN ACCORDANCE WITH STRUCTURAL ANALYSIS. IF ADEQUATE SPACE EXISTS, ROUTE CABLES THROUGH ENTRY PORT HOLE, UP INSIDE OF MONOPOLE, AND THROUGH EXIT PORT HOLE. IF ROUTING OUTSIDE THE MONOPOLE, ATTACH CABLES USING STAND-OFF ADAPTERS MOUNTED TO TOWER USING STAINLESS STEEL BANDING. ADEQUATELY SECURE CABLES USING EITHER APPROPRIATELY SIZED STAINLESS STEEL SNAP-INS OR MOUNTING HARDWARE AND BRACKETS AS SPECIFIED BY CABLE MANUFACTURER.



1"=5' (22X34)

BE RE-USED

AS-BUILT CDs Ramapo Communicaion Corp 2/5/2021 Matthew Schlosser Matthew Schlosser







TOGETHER PLANNING A BETTER TOMORROW 158 BUSINESS CENTER DRIVE BIRMINGHAM, AL 35244 TEL: 205-252-6985 FAX: 205-320-1504

REV.	DESCRIPTION	BY	DATE
<u> </u>	FOR CONSTRUCTION	ZDS	09/22/20
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ATC SITE NUMBER:

302482

ATC SITE NAME:

NORTH HAVEN CT 1

AT&T MOBILITY SITE NAME:

#### NORTH HAVEN-DWIGHT ST

SITE ADDRESS: 15 DEWIGHT STREET NORTH HAVEN, CT 06473-1198

SONAL ENGINEERS (19/22/2020




DATE DRAWN:	06/24/20
ATC JOB NO:	13242626_G3
CUSTOMER ID:	NORTH HAVEN-DWIGHT ST
CUSTOMER #:	10034972

**DETAILED SITE PLAN** 

SHEET NUMBER:

C-101

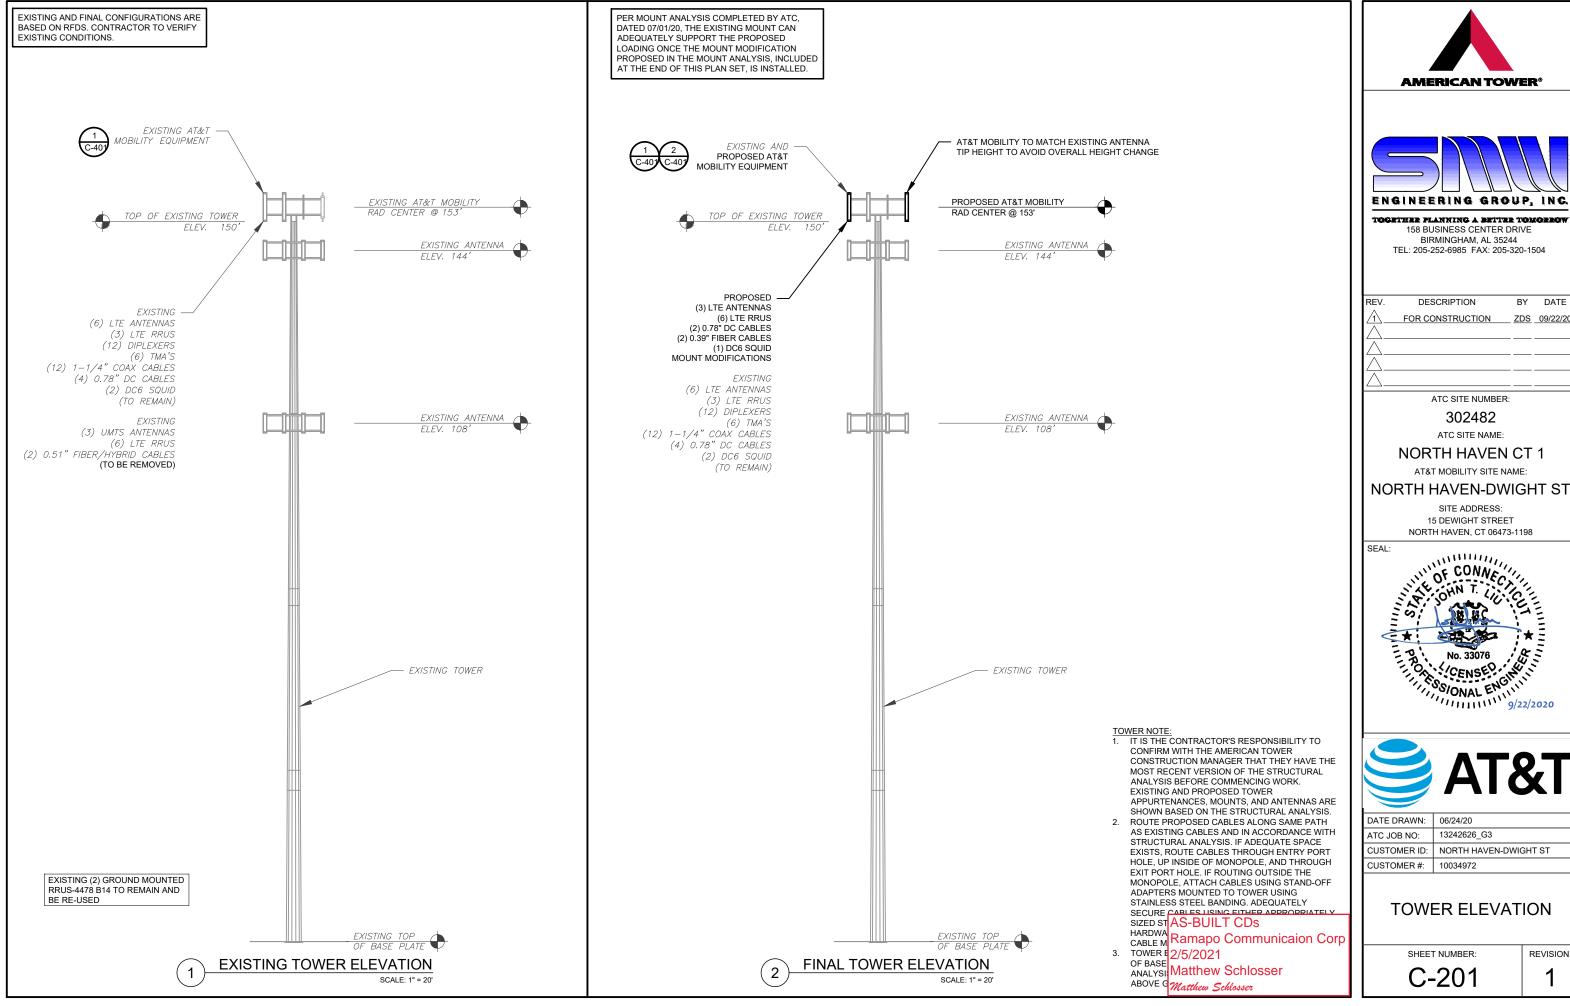




BY DATE



DATE DRAWN:	06/24/20		
ATC JOB NO:	13242626_G3		
CUSTOMER ID:	NORTH HAVEN-DWIGHT ST		
CUSTOMER #:	10034972		

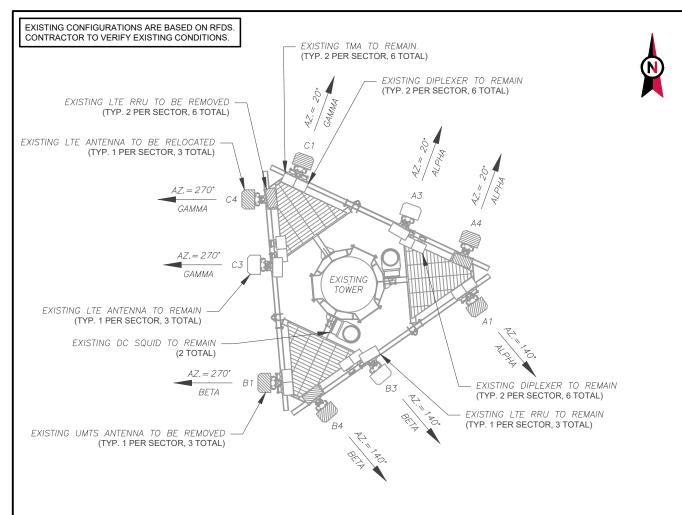

**CURRENT ANTENNA PLAN** 

EXISTING CABLING SUMMARY


**FIBER** 

(2) 0.39"

(2) 0.51"

DC

(4) 0.78'

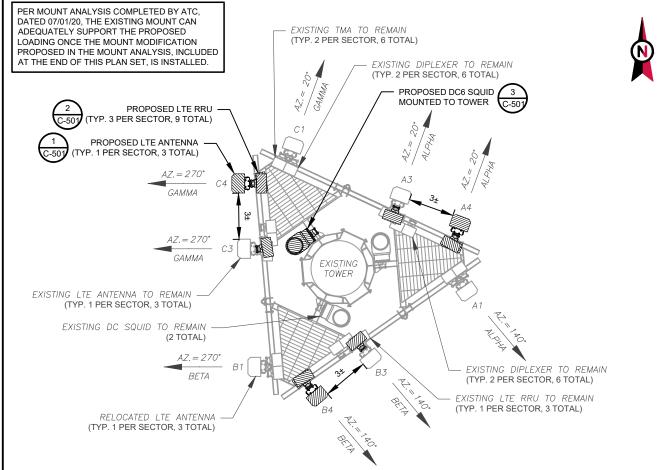

FINAL ANTENNA PLAN SCALE: 1" = 5' PROPOSED RRUS MUST BE INSTALLED A MINIMUM OF 8" AWAY FROM ALL ANTENNAS

EXISTING ANTENNA SCHEDULE												
LO	LOCATION ANTENNA SUMMARY			LOCATION			NON ANTENNA SUMMARY					
SECTOR	RAD	AZ	POS	ANTENNA	BAND STATUS		ADDITIONAL TOWER MOUNTED EQUIPMENT	STATUS				
		140°	A1	POWERWAVE 7770	UMTS	RMV	(2) 782-10250 DIPLEXER	RMN				
		140	AI	POWERWAVE ///U	UMIS	RIVIV	(2) LGP 21401 TMA	RMN				
AI PHA	153'	20°	A.3	QS66512-2	LTE	RMN	RRUS-32 B30	RMN				
ALITIA	155	20	AJ	Q300312-2	L/E	KWIV	(2) DBC0061F1V51-2 DIPLEXER	RMN				
		20°	A4	OPA-65R-LCUU-H6	LTE	LTE REL RRUS-11 B12		RMV				
		20	A4	OFA-03K-LC00-H0	LIE	NEL	RRUS-12 B2	RMV				
		270°	270°	B1	POWERWAVE 7770	UMTS	RMV	(2) 782-10250 DIPLEXER	RMN			
				FOWERWAVE 1110	UWITS	KIVIV	(2) LGP 21401 TMA	RMN				
BFTA	153'	140°	<i>B3</i>	QS66512-2	/ TF	RMN	RRUS-32 B30	RMN				
DLIA				Q300312-2	LIL	77777	(2) DBC0061F1V51-2 DIPLEXER	RMN				
		140°	40° 84 OPA-65R-LCUU-H6 LTE REL RRUS-11 B12		RRUS-11 B12	RMV						
		140	D4	OFA-03K-LC00-H0	LIE	KEL	RRUS-12 B2	RMV				
		20°	C1	POWERWAVE 7770	LIMTS	DM\/	(2) 782-10250 DIPLEXER	RMN				
		20		FOWERWAVE 1110			(2) LGP 21401 TMA	RMN				
GAMMA	153'	270°	C.3	QS66512-2	l TF	RMN	RRUS-32 B30	RMN				
OAMINA	155	270		Q300312-2	LIE	KIVIIV	(2) DBC0061F1V51-2 DIPLEXER	RMN				
		270°	C1	OPA-65R-LCUU-H6	LTE	REL	RRUS-11 B12	RMV				
						270°	70°   C4	OFA-03N-LC00-N0	""	NEL	RRUS-12 B2	RMV

EXISTING FIBER DISTRIBUTION/SQUID

STATUS

COAX

(12) 1-1/4"

MODEL NUMBER

(2) DC6-48-60-18-8F

NOTES CONFIRM WITH AT&T MOBILITY REP FOR APPLICABLE UPDATES/REVISIONS AND MOST RECENT RFDS FOR NSN CONFIGURATION (CONFIG). GC TO CAP ALL UNUSED PORTS. CONFIRM SPACING OF PROPOSED

EQUIP DOES NOT CAUSE TOWER CONFLICTS NOR IMPEDE TOWER CLIMBING PEGS. THE ANTENNA ORIENTATION PLAN IS A SCHEMATIC. ATC DID NOT CONFIRM EXISTING SITE

CONDITIONS INCLUDING, BUT NOT LIMITED TO, ANTENNA AZIMUTHS, MOUNT CONFIGURATIONS AND TOWER ORIENTATION. SCALES SHOWN ARE FOR REFERENCE ONLY AND EXISTING DIMENSIONS ARE APPROXIMATE THE CONTRACTOR SHALL VERIFY ALL EXISTING CONDITIONS PRIOR TO INSTALLATION AND NOTIFY ATC OF ANY DISCREPANCIES. CONTRACTOR TO ENSURE PROPER SEPARATION IN ACCORDANCE WITH AT&T'S

FIRSTNET REQUIREMENTS (SEE SHEET R-602)

CABLE LENGTHS FOR JUMPERS JUNCTION BOX TO RRU: 15' RRU TO ANTENNA: 10'

STATUS ABBREVIATIONS RMV: TO BE REMOVED RMN: TO REMAIN ADD: TO BE ADDED

	FINAL ANTENNA SCHEDULE								
LOCATION					ANTENNA SUMM	IARY		NON ANTENNA SUMMARY	
SEC	TOR	RAD	AZ	AZ POS ANTENNA		BAND STATUS		ADDITIONAL TOWER MOUNTED EQUIPMENT	STATUS
			140°	A1	ODA CED I CUITITIC	LTE	REL	(2) 782–10250 DIPLEXER	RMN
			140	AT	OPA-65R-LCUU-H6	LIE	KEL	(2) LGP 21401 TMA	RMN
								RRUS-4478 B14	ADD
ALF	PHA	153'	20°	A3	QS66512-2	LTE	RMN	RRUS-32 B30	RMN
								(2) DBC0061F1V51-2 DIPLEXER	RMN
			20°	A4	DMP65R-BU6DA	LTE	ADD	RRUS-4449 B5/B12	ADD
			20	74	DIMPOSIC-BOODA LIE ADD		RRUS-8843 B2/B66A	ADD	
			270°	B1	OPA-65R-LCUU-H6	LTE	REL	(2) 782–10250 DIPLEXER	RMN
			210	"				(2) LGP 21401 TMA	RMN
								RRUS-4478 B14	ADD
BE	TA	153'	140°	В3	QS66512-2	LTE	RMN	RRUS-32 B30	RMN
								(2) DBC0061F1V51-2 DIPLEXER	RMN
			140°	B4	DMP65R-BU6DA	LTE	ADD	RRUS-4449 B5/B12	ADD
			140	D4	DIVIT 03IX-BOODA	LIL	ADD	RRUS-8843 B2/B66A	ADD
			20°	C1	OPA-65R-LCUU-H6	LTE	REL	(2) 782–10250 DIPLEXER	RMN
			20	01	OFA-03K-LC00-H0	LIE	NEL	(2) LGP 21401 TMA	RMN
								RRUS-4478 B14	ADD
GAN	AMN	153'	270°	C3	QS66512-2	LTE	RMN	RRUS-32 B30	RMN
								(2) DBC0061F1V51-2 DIPLEXER	RMN
			270°	C4	DMP65R-BU6DA	LTE	ADD	RRUS-4449 B5/B12	ADD
ı L			210	04	אַטטטט-יוואור		700	RRUS-8843 B2/B66A	ADD

STATUS
RMN

RMV

REL: TO BE RELOCATED **EQUIPMENT SCHEDULES** 

FINAL FIBER DISTRIBUTION/SO	QUID		1 111	AS-BUILT CDs
MODEL NUMBER	STATUS	COAX		Ramapo Communicaion Corp
(2) DC6-48-60-18-8F	RMN	(12) 1-1/4"	/	2/5/2021 Matthew Schlosser
DC6-48-60-18-8F	ADD	_		Matthew Schlosser





TOGETHER PLANNING A BETTER TOMORROW 158 BUSINESS CENTER DRIVE BIRMINGHAM, AL 35244 TEL: 205-252-6985 FAX: 205-320-1504

REV.	DESCRIPTION	BY	DATE
<u> </u>	FOR CONSTRUCTION	ZDS	09/22/20
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$\overline{\wedge}$			
$\square$			
$\square$			

ATC SITE NUMBER:

302482


ATC SITE NAME:

NORTH HAVEN CT 1

AT&T MOBILITY SITE NAME:

#### NORTH HAVEN-DWIGHT ST

SITE ADDRESS: 15 DEWIGHT STREET

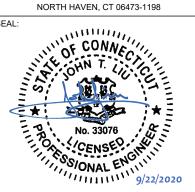




DATE DRAWN:	06/24/20		
ATC JOB NO:	13242626_G3		
CUSTOMER ID:	NORTH HAVEN-DWIGHT ST		
CUSTOMER #:	10034972		

## RF SCHEDULE AND ANTENNA INSTALLATION

SHEET NUMBER:


REVISION

C-401

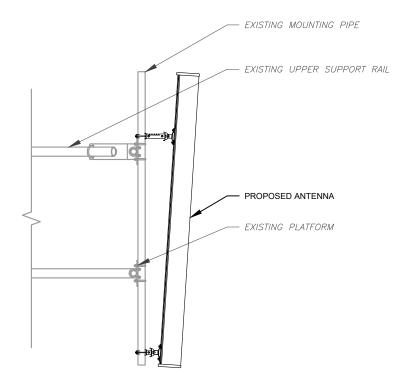


ANTENNA DETAIL

SCALE: N.T.S.

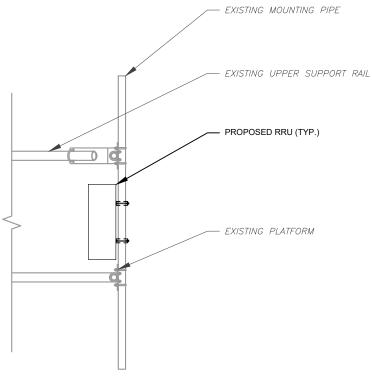



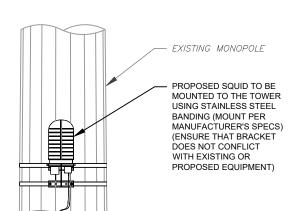

PROPOSED SQUID MOUNTING





158 BUSINESS CENTER DRIVE BIRMINGHAM, AL 35244 TEL: 205-252-6985 FAX: 205-320-1504

REV.	DESCRIPTION	BY	DATE
<u> </u>	FOR CONSTRUCTION	ZDS	09/22/20
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-			

ATC SITE NUMBER:

302482


ATC SITE NAME:

NORTH HAVEN CT 1

AT&T MOBILITY SITE NAME:

NORTH HAVEN-DWIGHT ST

SITE ADDRESS: 15 DEWIGHT STREET NORTH HAVEN, CT 06473-1198

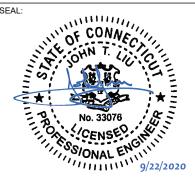




	DATE DRAWN:	06/24/20
	ATC JOB NO:	13242626_G3
	CUSTOMER ID:	NORTH HAVEN-DWIGHT ST
	CUSTOMER #:	10034972

## CONSTRUCTION **DETAILS**


SHEET NUMBER:

C-501


REVISION:

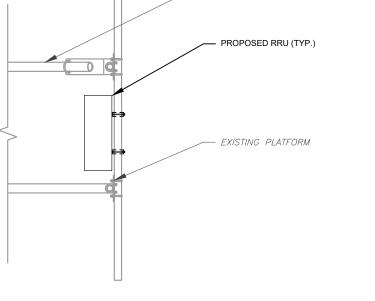



AS-BUILT CDs Ramapo Communicaion Corp 2/5/2021 Matthew Schlosser Matthew Schlosser

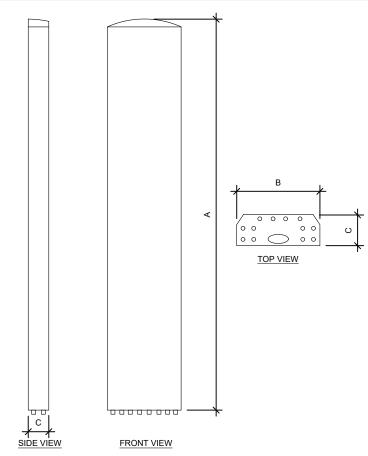

ANTENNA SPECIFICATIONS				
ANTENNA MODEL A B C WEIGHT (LBS)				
CCI DMP65R-BU6DA	71.2"	20.7"	7.7"	79.4

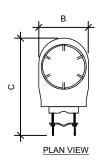


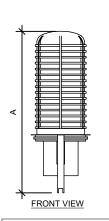

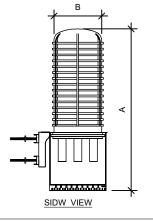

RAYCAP SPECIFICATIONS				
RAYCAP MODEL A B C WEIGHT (LBS)				
DC6-48-60-18-8F	31.41"	10.24"	18.28"	16.0



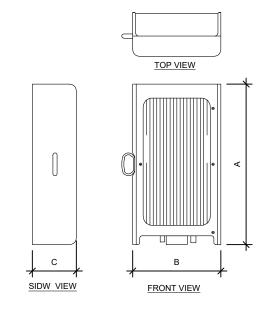

RRU SPECIFICATIONS				
RRU MODEL	А	В	С	WEIGHT (LBS)
4449 B5, B12	17.9"	13.2"	9.4"	71.0
8843 B2/B66A	18.0"	13.2"	11.3"	75.0

**AMERICAN TOWER®** 



158 BUSINESS CENTER DRIVE BIRMINGHAM, AL 35244

TEL: 205-252-6985 FAX: 205-320-1504

DESCRIPTION FOR CONSTRUCTION ZDS 09/22/20

ATC SITE NUMBER:

302482


ATC SITE NAME:

NORTH HAVEN CT 1

AT&T MOBILITY SITE NAME:

### NORTH HAVEN-DWIGHT ST

SITE ADDRESS: 15 DEWIGHT STREET NORTH HAVEN, CT 06473-1198

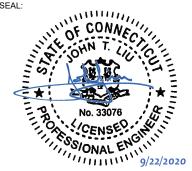



Ш	DATE DRAWN:	06/24/20
Ш	ATC JOB NO:	13242626_G3
Ш	CUSTOMER ID:	NORTH HAVEN-DWIGHT ST
	CUSTOMER #:	10034972

**EQUIPMENT SPECIFICATIONS** 

SHEET NUMBER:

AS-BUILT CDs


Matthew Schlosser

Matthew Schlosser

2/5/2021

Ramapo Communicaion Corp

C-502

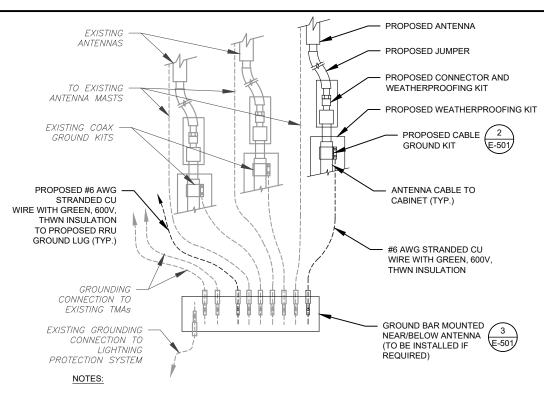


- THIS DETAIL IS INTENDED TO SHOW THE GENERAL GROUNDING REQUIREMENTS. SLIGHT ADJUSTMENTS MAY BE REQUIRED BASED ON EXISTING SITE CONDITIONS. THE CONTRACTOR SHALL MAKE FIELD ADJUSTMENTS AS NEEDED AND INFORM THE CONSTRUCTION MANAGER OF ANY CONFLICTS.
- 2. SITE GROUNDING SHALL COMPLY WITH AT&T MOBILITY GROUNDING STANDARDS, LATEST EDITION, AND COMPLY WITH AT&T MOBILITY GROUNDING CHECKLIST, LATEST VERSION. WHEN NATIONAL AND LOCAL GROUNDING CODES ARE MORE STRINGENT THEY SHALL

## TYPICAL ANTENNA GROUNDING DIAGRAM

(N) / (E) DC-6 SURGE SUPPRESSOR (N) RRUS PER PLAN -(E) RRUS PER PLAN (N) #6 AWG RRU GROUND CONDUCTOR

RRU GROUNDING


(E) COPPER GROUND BUS BAR

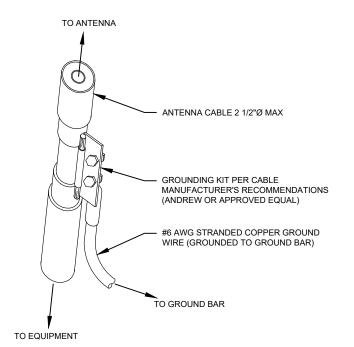

- GROUND KIT NOTES:

  1. DO NOT INSTALL CABLE GROUND KIT AT A BEND AND ALWAYS DIRECT GROUND WIRE DOWN TO GROUND BAR.
- 2. CONTRACTOR SHALL PROVIDE WEATHERPROOFING KIT (ANDREW PART NUMBER 221213) AND INSTALL/TAPE PER MANUFACTURER'S SPECIFICATIONS.

## CABLE GROUND KIT CONNECTION DETAIL

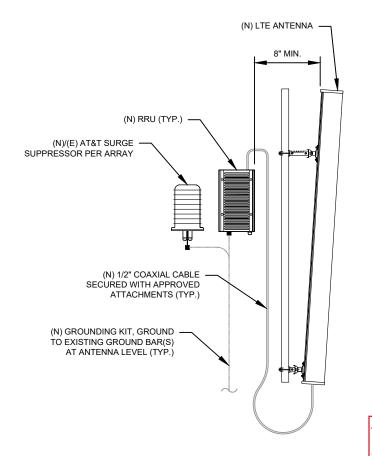

AS-BUILT CDs Ramapo Communicaion Corp 2/5/2021

ANTENNA/RRU GROUNDING Matthew Schlosser SCALE: N.T.S Matthew Schlosser

**AMERICAN TOWER®** 



Together planning a better tomorrow 158 BUSINESS CENTER DRIVE BIRMINGHAM, AL 35244

TEL: 205-252-6985 FAX: 205-320-1504

DESCRIPTION BY DATE FOR CONSTRUCTION

ATC SITE NUMBER:

302482

ATC SITE NAME:

NORTH HAVEN CT 1

AT&T MOBILITY SITE NAME:

#### NORTH HAVEN-DWIGHT ST

SITE ADDRESS: 15 DEWIGHT STREET NORTH HAVEN, CT 06473-1198






DATE DRAWN:	06/24/20
ATC JOB NO:	13242626_G3
CUSTOMER ID:	NORTH HAVEN-DWIGHT ST
CUSTOMER #:	10034972

**GROUNDING DETAILS** 

SHEET NUMBER:

E-501

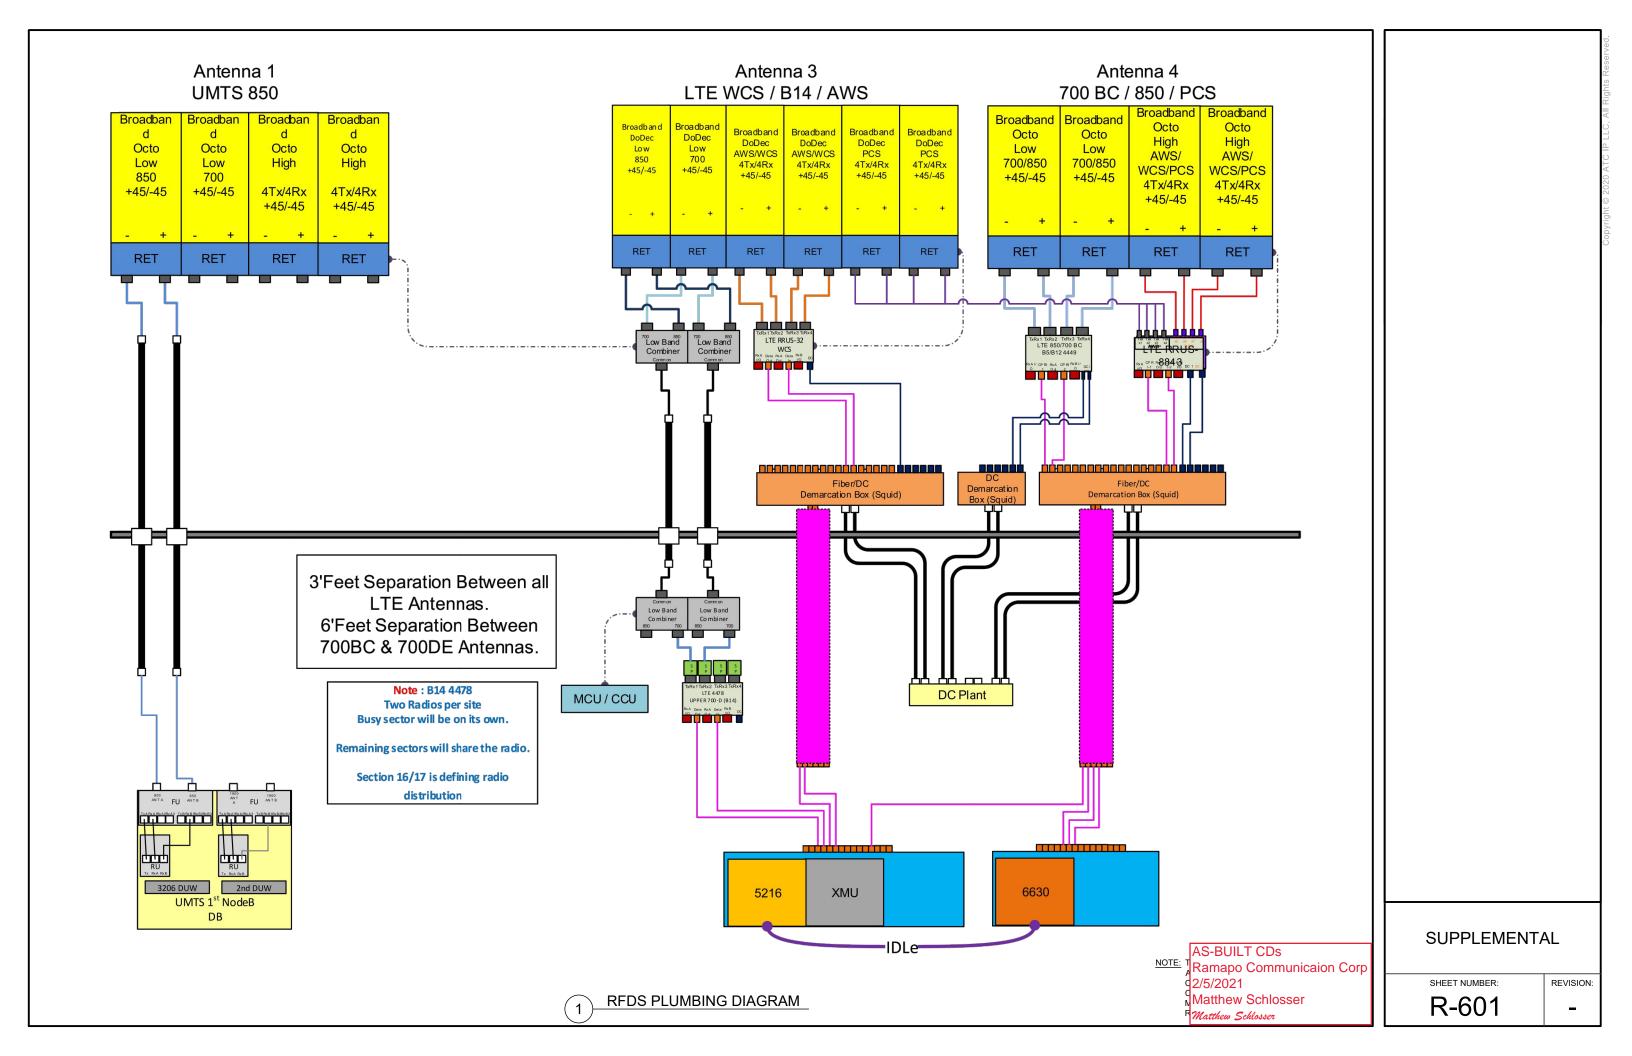



## **Antenna Mount Analysis Report**

**ATC Site Name** : North Haven CT 1, CT

**ATC Site Number** : 302482

**Engineering Number** : 13242626\_C9\_04

**Mount Elevation** : 152 ft

Carrier : AT&T Mobility

: MRCTB046848 **Carrier Site Name** 

**Carrier Site Number** : CTL02012

Site Location : 15 Dewight Street

North Haven, CT 06473-1198

Reviewed By:

41.42080556, -72.8488

County : New Haven

Date : July 1, 2020

: 80% Max Usage

Result : Contingent Pass

Prepared By: Trevor Ridilla

Structural Engineer I

Tyum Chille

COA: PEC.0001553

A.T. Engineering Service, PLLC - 3500 Regency Parkway, Suite 100 - Cary, NC 27518 - 919.468.0112 Office - 919.466.5414 Fax - www.americantower.com



Eng. Number 13242626\_C9\_04 July 1, 2020 Page 1

#### Introduction

The purpose of this report is to summarize results of the antenna mount analysis performed for AT&T Mobility at 152 ft.

#### **Supporting Documents**

Radio Frequency Data Sheet	RFDS ID #CTL02012, dated March 27, 2020
Reference Photos	Site photos from 2019
Other Document	Dewberry Engineers Project #50096232, dated March 9, 2018

#### **Analysis**

This antenna mount was analyzed using American Tower Corporation's Mount Analysis Program and RISA-3D

Basic Wind Speed:	120 mph (3-Second Gust)
Basic Wind Speed w/ Ice:	50 mph (3-Second Gust) w/ 1" radial ice concurrent
Codes:	ANSI/TIA-222-H
Exposure Category:	В
Risk Category:	II .
Topographic Factor Procedure:	Method 1
Topographic Category:	1
Spectral Response:	Ss = 0.204, S1 = 0.054
Site Class:	D - Stiff Soil
Live Loads: *	Lm = 500 lbs

<sup>\*</sup> Based on experience it has been determined that the maintenance load cases do not control over rigging load cases in platform mount analyses. Therefore, these load cases have been excluded from this analysis.

#### Conclusion

Based on the analysis results, the antenna mount does not meet the requirements per the applicable codes listed above. The mount can support the equipment as described in this report after the below listed modifications are completed:

Install modification per ATC Drawing #13242626\_C9\_04

If you have any questions or require additional information, please contact American Tower via email at Engineering@americantower.com. Please include the American Tower site name, site number, and engineering number in the subject line for any questions.

A.T. Engineering Service, PLLC - 3500 Regency Parkway, Suite 100 - Cary, NC 27518 - 919.468.0112 Office - 919.466.5414 Fax - www.americantower.com

AS-BUILT CDs NOTE: THIS SHEET WAS CREATED BY OTHERS AND PROVID Ramapo Communicaion Corp WITHOUT EDIT. PLEASE REFERENCE THE MOUNT AN 2/5/2021 ANALYSIS CALCULATIONS AND DETAILS. SUPPLEMENT CONSTRUCTION DRAWINGS ARE FOR REFERENCE O Matthew Schlosser VERYIFY THEY HAVE THE MOST RECENT MOUNT AN Matthew Schlosser

SHEET NUMBER:

R-602

SUPPLEMENTAL

REVISION:

MOUNT ANALYSIS





SITE NAME: NORTH HAVEN CT 1

SITE NUMBER: 302482

ATC PROJECT NUMBER: 13242626 C9 04

SITE ADDRESS: 15 DEWIGHT STREET

NORTH HAVEN, CT 06473



**LOCATION MAP** 

IRD WATCH SITE

PLEASE CONTACT BIRD.WATCH@AMERICANTOWER.COM OR AMERICAN TOWER NOC AT 877-518-6937 FOR ASSISTANCE

# MOUNT REINFORCEMENT DRAWINGS PREPARED FOR AT&T MOBILITY

PROJECT TEAM	PROJECT DESCRIPTION	SHEET	SHEET TITLE	REV.
TOWER OWNER  AMERICAN TOWER  10 PRESIDENTAL WAY  WOBURN, MA 01801  ENGINEERED BY  ATC TOWER SERVICES  3500 REGENCY PARKWAY, SUITE 100  CARY, NC 27518	THE MODIFICATIONS PRESENTED ON THESE DRAWINGS ARE BASED ON THE RECOMMENDATIONS OUTLINED IN THE MOUNT ANALYSIS COMPLETED UNDER ENGINEERING PROJECT NUMBER 13242626_C8_01 DATED 06/18/20.  SATISFACTORY COMPLETION OF THE WORK INDICATED ON THESE DRAWINGS WILL RESULT IN THE MOUNT MEETING THE REQUIREMENTS OF THE SPECIFICATIONS UNDER WHICH THE MOUNT ANALYSIS WAS COMPLETED.  COMPLIANCE CODE  ALL WORK SHALL BE PERFORMED AND MATERIALS INSTALLED IN ACCORDANCE WITH THE CURRENT EDITIONS OF THE FOLLOWING CODES AS ADOPTED BY THE LOCAL GOVERNMENT AUTHORITIES. NOTHING IN THESE	G-002 S-101 R-601	IBC GENERAL NOTES AND MOUNT MODIFICATION INSPECTION  MODIFICATION PROFILE  SUPPLEMENTAL	0 0 0
CARRIER INFORMATION  CARRIER: AT&T MOBILITY  CARRIER SITE NAME: MRCTB046848  CARRIER SITE NUMBER: CTL02012	PLANS IS TO BE CONSTRUED TO PERMIT WORK NOT CONFORMING TO THESE CODES.  1. ANSI/TIA/EIA: STRUCTURAL STANDARDS (222-H EDITION)  2. INTERNATIONAL BUILDING CODE (2015 IBC)  3. CONNECTICUT STATE BUILDING CODE (2018)			
Know what's below. Call before you dig.	PROJECT LOCATION  GEOGRAPHIC COORDINATES  LATITUDE: 41.42080556  LONGITUDE: -72.8488		AS-BUILT CDs Ramapo Commo 2/5/2021 Matthew Schloser  Matthew Schloser	·



3500 REGENCY PARKWAY SUITE 100 CARY, NC 27518 PHONE: (919) 468-0112 COA: PEC.0001553

THESE DRAWINGS AND/OR THE ACCOMPANYING SPECIFICATION AS INSTRUMENTS OR SERVICE ARE THE EXCLUSIVE PROPERTY OF AMERICAN TOWER. THEIR USE AND PUBLICATION SHALL BE RESTRICTED TO THE ORIGINAL SITE FOR WHICH THEY ARE PREPARED. ANY USE OR DISCLOSURE OTHER THAN THAT WHICH RELATES TO AMERICAN TOWER OR THE SPECIFIED CARRIER IS STRICTLY PROHIBITED. TITLE TO THESE DOCUMENTS SHALL REMAIN THE PROPERTY OF AMERICAN TOWER WHITHER OR NOT THE PROJECT IS EXECUTED. NEITHER THE ARCHITECT NOR THE ENGINEER WILL BE PROVIDING ON-SITE CONSTRUCTION REVIEW OF THIS PROJECT. CONTRACTOR(S) MUST VERIFY ALL DIMENSIONS AND ADVISE AMERICAN TOWER OF ANY DISCREPANCIES. ANY PRIOR ISSUANCE OF THIS DRAWING IS SUPERSEDED BY THE LATEST VERSION ON FILE WITH AMERICAN TOWER.

ı	REV.	. DESCRIPTION	BY	DATE
ı	$\triangle$	FIRST ISSUE	BJK	07/06/20
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ı	$\overline{\wedge}$			
ı	$\overline{\wedge}$			
I				
	-		-	

ATC SITE NUMBER:

302482

ATC SITE NAME:

NORTH HAVEN CT 1

CONNECTICUT

SITE ADDRESS: 15 DEWIGHT STREET NORTH HAVEN, CT 06473



DRAWN BY:	BJK
APPROVED BY:	TCR
DATE DRAWN:	07/06/20
ATC JOB NO:	13242626_C9_04

COVER

SHEET NUMBER:


G-001

#### **GENERAL**

- ALL WORK TO BE COMPLETED PER APPLICABLE LOCAL STATE FEDERAL CODES AND ORDINANCES AND COMPLY WITH ATC CONSTRUCTION SPECIFICATIONS FOR WIRELESS TOWER SITES. THE CONTRACTOR IS RESPONSIBLE FOR OBTAINING AND ABIDING BY ALL REQUIRED PERMITS
- ALL WORK INDICATED ON THESE DRAWINGS SHALL BE PERFORMED BY QUALIFIED CONTRACTORS EXPERIENCED IN TOWER AND FOUNDATION CONSTRUCTION
- 3. THE CONTRACTOR SHALL NOTIFY THE ENGINEER OF RECORD IMMEDIATELY OF ANY INSTALLATION INTERFERENCES. ALL NEW WORK SHALL ACCOMMODATE EXISTING CONDITIONS DETAILS NOT SPECIFICALLY SHOWN ON THE DRAWINGS SHALL FOLLOW SIMILAR DETAILS FOR THIS JOB.
- ANY SUBSTITUTIONS SHALL CONFORM TO THE REQUIREMENTS OF THESE NOTES AND SPECIFICATIONS, AND SHOULD BE SIMILAR TO THOSE SHOWN. ALL SUBSTITUTIONS SHALL BE SUBMITTED TO THE ENGINEER OF RECORD FOR REVIEW AND APPROVAL PRIOR TO FABRICATION
- ANY MANUFACTURED DESIGN ELEMENTS SHALL CONFORM TO THE REQUIREMENTS OF THESE NOTES AND SPECIFICATIONS AND SHOULD BE SIMILAR TO THOSE SHOWN. THESE DESIGN ELEMENTS MUST BE STAMPED BY AN ENGINEER PROFESSIONALLY REGISTERED IN THE STATE OF THE PROJECT, AND SUBMITTED TO THE ENGINEER OF RECORD FOR APPROVAL PRIOR TO FABRICATION.
- 6. ALL WORK SHALL BE DONE IN ACCORDANCE WITH LOCAL CODES AND OSHA SAFETY REGULATIONS.
- THE CONTRACTOR IS RESPONSIBLE FOR THE DESIGN AND EXECUTION OF ALL MISCELLANEOUS SHORING, BRACING, TEMPORARY SUPPORTS, ETC. NECESSARY, PER ANSI/TIA-322 AND ANSI/ASSE A10.48. TO PROVIDE A COMPLETE AND STABLE STRUCTURE AS SHOWN ON THESE DRAWINGS.
- CONTRACTOR'S PROPOSED INSTALLATION SHALL NOT INTERFERE, NOR DENY ACCESS TO, ANY EXISTING OPERATIONAL AND SAFETY EQUIPMENT.

#### STRUCTURAL STEEL

- ALL DETAILING, FABRICATION AND ERECTION OF STRUCTURAL STEEL SHALL CONFORM TO THE AISC SPECIFICATIONS LATEST EDITION
- 2. ALL EXPOSED STRUCTURAL STEEL MEMBERS SHALL BE HOT-DIPPED GALVANIZED AFTER FABRICATION PER ASTM A123. EXPOSED STEEL HARDWARE AND ANCHOR BOLTS SHALL BE GALVANIZED PER ASTM A153 OR B695.
- ALL U-BOLTS SHALL BE ASTM A36 OR EQUIVALENT, WITH LOCKING DEVICE, UNLESS NOTED OTHERWISE
- 4. FIELD CUT EDGES, EXCEPT DRILLED HOLES, SHALL BE GROUND SMOOTH.
- ALL FIELD CUT SURFACES, FIELD DRILLED HOLES & GROUND SURFACES WHERE EXISTING PAINT OR GALVANIZATION REMOVAL WAS REQUIRED SHALL BE REPAIRED WITH (2) BRUSHED COATS OF ZRC GALVILITE COLD GALVANIZING COMPOUND PER ASTM A780 AND MANUFACTURERS RECOMMENDATIONS.
- ALL STRUCTURAL STEEL EMBEDDED IN THE CONCRETE SHALL BE APPLIED WITH (2) BRUSHED COATS OF POLYGUARD CA-14 MASTIC OR FOLIVALENT. REFER TO THE MANUFACTURER SPECIFICATIONS FOR SURFACE PREPARATION AND APPLICATION. APPLICATION OF POLYGUARD 400 WRAP IS NOT ESSENTIAL
- CONTRACTOR SHALL PERFORM WORK ON ONLY ONE (1) TOWER FACE AND REPLACE/REINFORCE ONE (1) BOLT/MEMBER AT A TIME
- 8. ALL FIELD DRILLED HOLES TO BE USED FOR FIELD BOLTING INSTALLATION SHALL BE STANDARD HOLES, AS DEFINED BY AISC, UNLESS NOTED OTHERWISE.

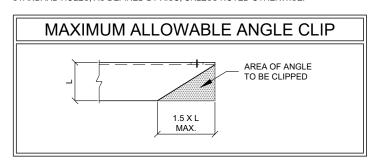

#### **PAINT**

AS REQUIRED, CLEAN AND PAINT PROPOSED STEEL ACCORDING TO FAA ADVISORY CIRCULAR AC 70/7460-1L

#### WELDING

- 1. ALL WELDING TO BE PERFORMED BY AWS CERTIFIED WELDERS AND CONDUCTED IN ACCORDANCE WITH THE LATEST EDITION OF THE AWS WELDING CODE D1.1.
- 2. ALL WELDS SHALL BE INSPECTED VISUALLY. IF DIRECTED BY ENGINEER OF RECORD, 25% OF WELDS SHALL BE INSPECTED WITH DYE PENETRANT OR MAGNETIC PARTICLE (100% IF REJECTABLE DEFECTS ARE FOUND) TO MEET THE ACCEPTANCE CRITERIA OF AWS D1.1. REPAIR ALL WELDS AS NECESSARY.
- 3. INSPECTION SHALL BE PERFORMED BY AN AWS CERTIFIED WELD INSPECTOR.
- 4. ALL ELECTRODES TO BE LOW HYDROGEN, MATCHING FILLER AND/OR BASE METAL, PER AWS D1.1, UNLESS NOTED OTHERWISE
- 5. IN CASES WHERE BASE METAL GRADE IS UNKNOWN, ALL WELDING ON LATTICE TOWERS SHALL BE DONE WITH E70XX ELECTRODES; ALL WELDING ON POLE STRUCTURES SHALL BE DONE WITH E80XX FLECTRODES UNLESS NOTED OTHERWISE
- 6. PRIOR TO FIELD WELDING GALVANIZED MATERIAL, CONTRACTOR SHALL GRIND OFF GALVANIZING 1/2" BEYOND ALL FIELD WELD SURFACES. AFTER WELD AND WELD INSPECTION IS COMPLETE, REPAIR ALL GROUND AND WELDED SURFACES WITH ZRC GALVILITE COLD GALVANIZING COMPOUND PER ASTM A780 AND MANUFACTURERS RECOMMENDATIONS.

#### **BOLT TIGHTENING PROCEDURE**

- 1. STRUCTURAL CONNECTIONS TO BE ASSEMBLED AND INSPECTED IN ACCORDANCE WITH RCSC SPECIFICATIONS.
- 2 FLANGE BOLTS SHALL BE INSTALLED AND TIGHTENED USING DIRECT TENSION INDICATING (DTI) SQUIRTER WASHERS. DTI SQUIRTER WASHERS ARE TO BE INSTALLED AND ORIENTED / TIGHTENED PER MANUFACTURER SPECIFICATIONS TO ACHIEVE DESIRED LEVEL OF BOLT PRE-TENSION
- 3. IN LIEU OF USING DTI SQUIRTER WASHERS, FLANGE BOLTS MAY BE TIGHTENED USING AISC / RCSC "TURN-OF-THE-NUT" METHOD, PENDING APPROVAL BY THE ENGINEER OF RECORD (EOR). TIGHTEN FLANGE BOLTS USING THE CHART BELOW:

#### **BOLT LENGTHS UP TO AND INCLUDING FOUR DIAMETERS**

1/2"	BOLTS UP TO AND INCLUDING 2.0 INCH LENGTH	+1/3 TURN BEYOND SNUG TIGHT
5/8"	BOLTS UP TO AND INCLUDING 2.5 INCH LENGTH	+1/3 TURN BEYOND SNUG TIGHT
3/4"	BOLTS UP TO AND INCLUDING 3.0 INCH LENGTH	+1/3 TURN BEYOND SNUG TIGHT
7/8"	BOLTS UP TO AND INCLUDING 3.5 INCH LENGTH	+1/3 TURN BEYOND SNUG TIGHT
1"	BOLTS UP TO AND INCLUDING 4.0 INCH LENGTH	+1/3 TURN BEYOND SNUG TIGHT
1-1/8"	BOLTS UP TO AND INCLUDING 4.5 INCH LENGTH	+1/3 TURN BEYOND SNUG TIGHT
1-1/4"	BOLTS UP TO AND INCLUDING 5.0 INCH LENGTH	+1/3 TURN BEYOND SNUG TIGHT
1-3/8"	BOLTS UP TO AND INCLUDING 5.5 INCH LENGTH	+1/3 TURN BEYOND SNUG TIGHT
1-1/2"	BOLTS UP TO AND INCLUDING 6.0 INCH LENGTH	+1/3 TURN BEYOND SNUG TIGHT

#### **BOLT LENGTHS OVER FOUR DIAMETERS BUT NOT EXCEEDING EIGHT DIAMETERS**

1/2"	BOLTS 2.25 TO 4.0 INCH LENGTH	+1/2 TURN BEYOND SNUG TIGHT
5/8"	BOLTS 2.75 TO 5.0 INCH LENGTH	+1/2 TURN BEYOND SNUG TIGHT
3/4"	BOLTS 3.25 TO 6.0 INCH LENGTH	+1/2 TURN BEYOND SNUG TIGHT
7/8"	BOLTS 3.75 TO 7.0 INCH LENGTH	+1/2 TURN BEYOND SNUG TIGHT
1"	BOLTS 4.25 TO 8.0 INCH LENGTH	+1/2 TURN BEYOND SNUG TIGHT
1-1/8"	BOLTS 4.75 TO 9.0 INCH LENGTH	+1/2 TURN BEYOND SNUG TIGHT
1-1/4"	BOLTS 5.25 TO 10.0 INCH LENGTH	+1/2 TURN BEYOND SNUG TIGHT
1-3/8"	BOLTS 5.75 TO 11.0 INCH LENGTH	+1/2 TURN BEYOND SNUG TIGHT
1-1/2"	BOLTS 6.25 TO 12.0 INCH LENGTH	+1/2 TURN BEYOND SNUG TIGHT

#### **BOLT TIGHTENING PROCEDURE (CONTINUED)**

SPLICE BOLTS SUBJECT TO DIRECT TENSION SHALL BE INSTALLED AND TIGHTENED AS PER SECTION 8.2.1 OF THE AISC "SPECIFICATION FOR STRUCTURAL JOINTS USING A325 OR A490 BOLTS", LOCATED IN THE AISC MANUAL OF STEEL CONSTRUCTION. THE INSTALLATION PROCEDURE IS PARAPHRASED AS FOLLOWS:

FASTENERS SHALL BE INSTALLED IN PROPERLY ALIGNED HOLES AND TIGHTENED BY ONE OF THE METHODS DESCRIBED IN SUBSECTION 8.2.1 THROUGH 8.2.4.

#### 8.2.1 TURN-OF-NUT PRETENSIONING

BOLTS SHALL BE INSTALLED IN ALL HOLES OF THE CONNECTION AND BROUGHT TO A SNUG TIGHT CONDITION AS DEFINED IN SECTION 8.1. UNTIL ALL THE BOLTS ARE SIMULTANEOUSLY SNUG TIGHT AND THE CONNECTION IS FULLY COMPACTED. FOLLOWING THIS INITIAL OPERATION ALL BOLTS IN THE CONNECTION SHALL BE TIGHTENED FURTHER BY THE APPLICABLE AMOUNT OF ROTATION SPECIFIED ABOVE DURING THE TIGHTENING OPERATION THERE SHALL BE NO ROTATION OF THE PART NOT TURNED BY THE WRENCH. TIGHTENING SHALL PROGRESS SYSTEMATICALLY.

ALL OTHER BOLTED CONNECTIONS SHALL BE BROUGHT TO A SNUG TIGHT CONDITION AS DEFINED IN SECTION 8.1 OF THE SPECIFICATION.

ALL BOLT HOLES SHALL BE ALIGNED TO PERMIT INSERTION OF THE BOLTS WITHOUT UNDUE DAMAGE TO THE THREADS. BOLTS SHALL BE PLACED IN ALL HOLES WITH WASHERS POSITIONED AS REQUIRED AND NUTS THREADED TO COMPLETE THE ASSEMBLY. COMPACTING THE JOINT TO THE SNUG-TIGHT CONDITION SHALL PROGRESS SYSTEMATICALLY FROM THE MOST RIGID PART OF THE JOINT. THE SNUG-TIGHTENED CONDITION IS THE TIGHTNESS THAT IS ATTAINED WITH A FEW IMPACTS OF AN IMPACT WRENCH OR THE FULL EFFORT OF AN IRONWORKER USING AN ORDINARY SPUD WRENCH TO BRING THE CONNECTED PLIES INTO FIRM CONTACT.

# **AMERICAN TOWER**

A.T. ENGINEERING SERVICE. PLLC 3500 REGENCY PARKWAY SUITE 100 **CARY, NC 27518** PHONE: (919) 468-0112

THESE DRAWINGS AND/OR THE ACCOMPANYING SPECIFICATION THESE DRAWINGS AND/OR THE ACCOMPANYING SPECIFICATION AS INSTRUMENTS OR SERVICE ARE THE EXCLUSIVE PROPERTY OF AMERICAN TOWER. THEIR USE AND PUBLICATION SHALL BE RESTRICTED TO THE ORIGINAL SITE FOR WHICH THEY ARE PREPARED. ANY USE OR DISCLOSURE OTHER THAN THAT WHICH STANDARD AND SERVICES OF THE STANDARD AND THE S RELATES TO AMERICAN TOWER OR THE SPECIFIED CARRIER IS STRICTLY PROHIBITED. TITLE TO THESE DOCUMENTS SHALL REMAIN THE PROPERTY OF AMERICAN TOWER WHETHER OR NO THE PROJECT IS EXECUTED, NEITHER THE ARCHITECT NOR THE ENGINEER WILL BE PROVIDING ON-SITE CONSTRUCTION REVIEW OF THIS PROJECT, CONTRACTOR(S) MUST VERIEY ALL DIMENSIONS AND ADVISE AMERICAN TOWER OF ANY DISCREPANCIES. ANY PRIOR ISSUANCE OF THIS DRAWING IS SUPERSEDED BY THE LATEST VERSION ON FILE WITH AMERICAN

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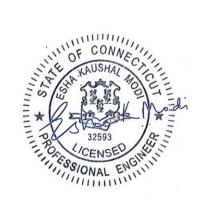
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ATC SITE NAME:

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#### CONNECTICUT

SITE ADDRESS: 15 DEWIGHT STREET NORTH HAVEN, CT 06473



DRAWN BY:	BJK
APPROVED BY:	TCR
DATE DRAWN:	07/06/20
ATC JOB NO:	13242626_C9_04

**IBC GENERAL NOTES** AND MOUNT MODIFICATION INSPECTION

REVISION

SHEET NUMBER:

G-002

#### MODIFICATION INSPECTION NOTES

THE MOUNT MODIFICATION INSPECTION (MMI) PROCEDURE IS INTENDED TO CONFIRM THAT CONSTRUCTION AND INSTALLATION MEETS ENGINEERING DESIGN. ATC PROCEDURES AND ATC STANDARD SPECIFICATIONS FOR WIRELESS TOWER SITES.

TO ENSURE THAT THE REQUIREMENTS OF THE MMI ARE MET, IT IS VITAL THAT THE GENERAL CONTRACTOR SUBMIT ALL REQUIRED PHOTOGRAPHS AND DRAWINGS TO AMERICAN TOWER CORPORATION (ATC).


#### **GENERAL CONTRACTOR**

THE GENERAL CONTRACTOR IS REQUIRED TO:


- REVIEW THE REQUIREMENTS OF THE MMI CHECKLIST.
- UNDERSTAND ALL INSPECTION REQUIREMENTS.

THE GENERAL CONTRACTOR SHALL PERFORM AND RECORD THE INSPECTION RESULTS IN ACCORDANCE WITH THE REQUIREMENTS OF THE MMI CHECKLIST.


MOUNT MODIFICATION INSPECTION CHECKLIST			
INSPECTION DOCUMENT	DESCRIPTION		RESPONSIBILITY
ON-SITE COLD GALVANIZING VERIFICATION	PHOTOGRAPHIC EVIDENCE OF COLD GALVANIZATION TYPE AND APPLICATION IN ALL APPLICABLE LOCATIONS TO BE INCLUDED WITHIN THE MMI REPORT	✓	GC
GC AS-BUILT DRAWINGS WITH CONSTRUCTION RED-LINES	REPORT		GC
PHOTOGRAPHS			AS-BUILT CDs
TABLE KEY:   MMI - MOUNT MODIFICATION INSPECTION   2/   GC - GENERAL CONTRACTOR   ATC - AMERICAN TOWER CORPORATION   M		Ramapo Communicaion Corp 2/5/2021 Matthew Schlosser	
Matthew Schlosser			

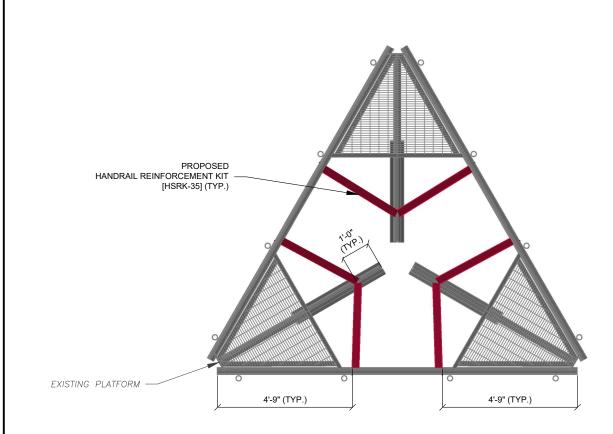


MOUNT MODIFICATION - TOP VIEW

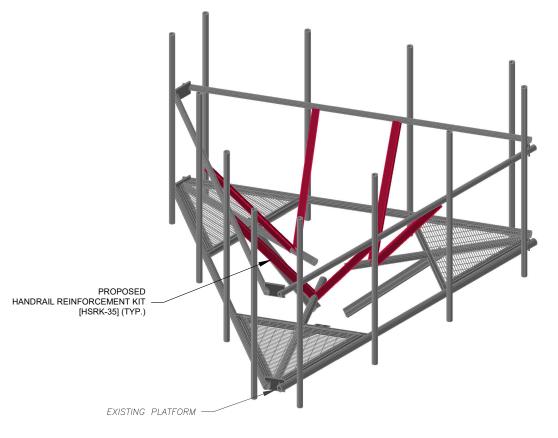

MOUNT MODIFICATION - ISOMETRIC VIEW

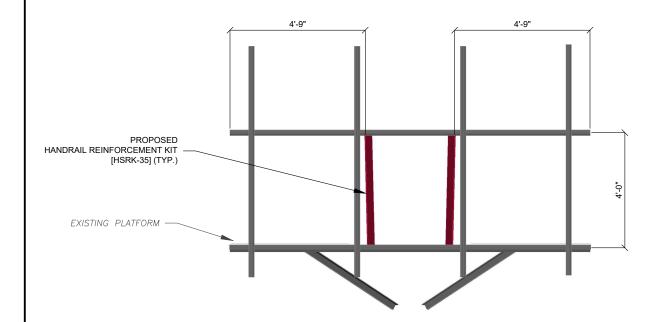

MOUNT MODIFICATION - FRONT VIEW

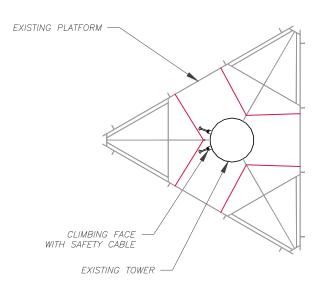

SAFETY CLIMB LOCATION



CONTRACTOR TO INSTALL MOUNT MODIFICATIONS PER THE MANUFAC SPECIFICATION. MODIFICATIONS SHALL NOT OBSTRUCT, INTERFERE, qRamapo Communicaion Corp BLOCK EXISTING SAFETY CLIMB SYSTEM. IF ANY OF THESE OCCURS D 2/5/2021 INSTALLATION CONTACT THE AMERICAN TOWER PMI INBOX PMI@AMERICANTOWER.COM

AS-BUILT CDs Matthew Schlosser Matthew Schlosser



3500 REGENCY PARKWAY SUITE 100 CARY, NC 27518 PHONE: (919) 468-0112 COA: PEC.0001553

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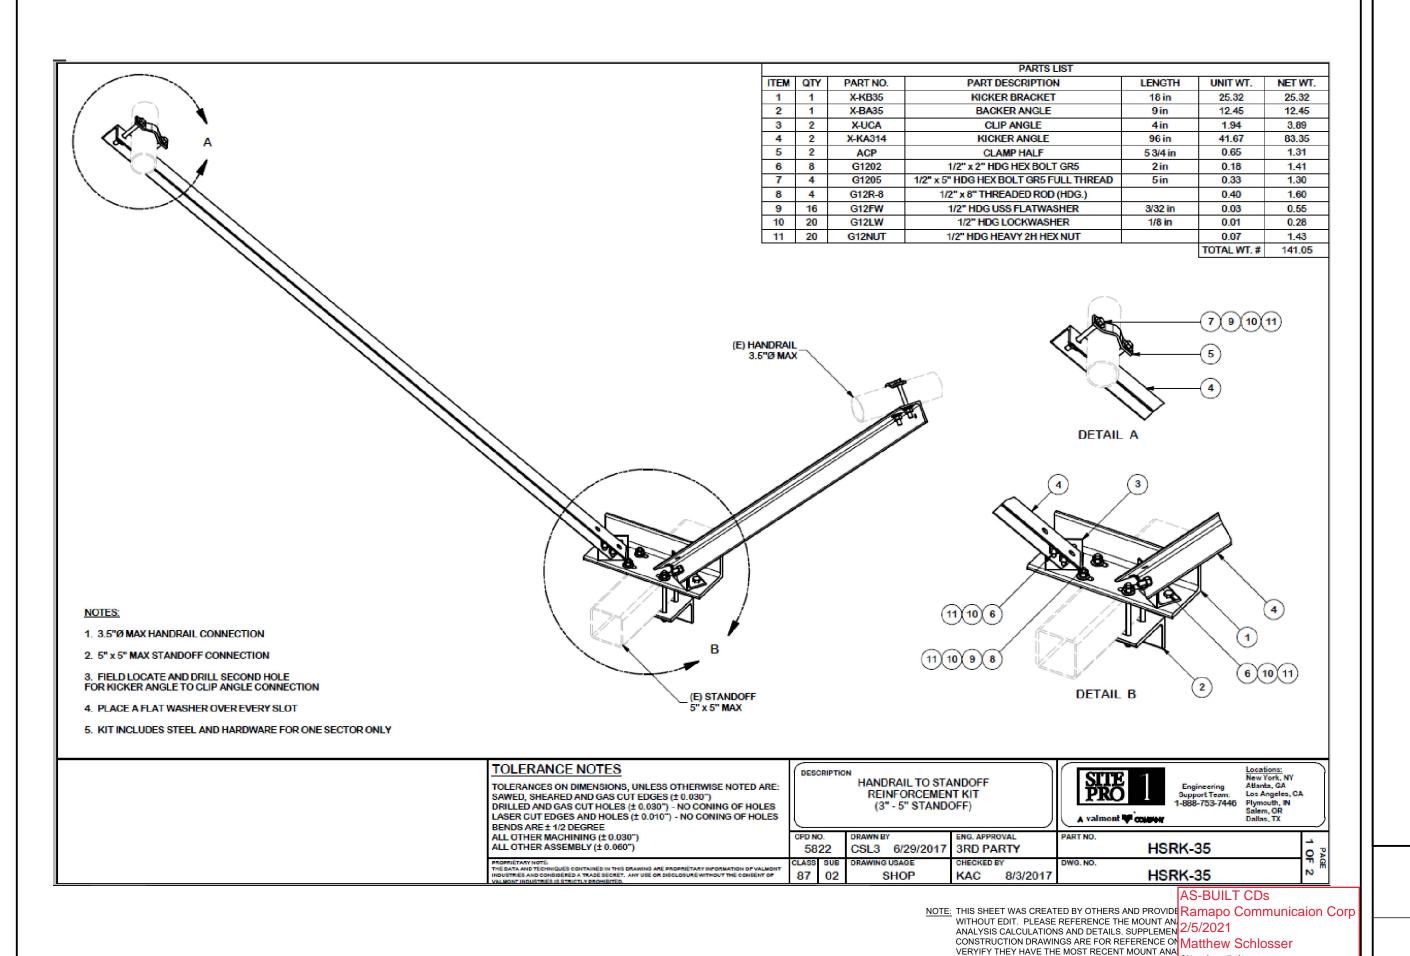


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ATC JOB NO:	13242626_C9_04

#### MODIFICATION PROFILE

SHEET NUMBER:

REVISION S-101



SUPPLEMENTAL

SHEET NUMBER:

Matthew Schlosser

REVISION:

R-601

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