

#### LETTER OF AUTHORIZATION

SITE NO: 370627

Site Name: Newington CT

#### ADDRESS: 605 Willard Ave., Newington, CT 06111-0000

I, Margaret Robinson, Senior Counsel, US Tower Division on behalf of American Tower\*, owner of the tower facility located at the address identified above (the "Tower Facility"), do hereby authorize Network Building + Consulting, its successors and assigns, to act as American Tower's non-exclusive agent for the purpose of filing and securing any zoning, land-use, building permit and/or electrical permit application(s) and approvals of the applicable jurisdiction for and to conduct the construction of the installation of antennas and related telecommunications equipment on the Tower Facility located at the above address. This installation shall not affect adjoining lands and will occur only within the area leased by American Tower.

American Tower understands that the application may be denied, modified or approved with conditions. The above authorization is limited to the acceptance by American Tower of conditions related to American Tower's installation. Any such conditions of approval or modifications will not be effective unless approved in writing by American Tower.

The above authorization does not permit Network Building + Consulting to modify or alter any existing permit(s) and/or zoning or land-use conditions or impose any additional conditions unrelated to American Tower's installation of telecommunications equipment without the prior written approval of American Tower.

Signature:

Margaret Robinson, Senior Counsel US Tower Division

NOTARY BLOCK

COMMONWEALTH OF MASSACHUSETTS County of Middlesex

This instrument was acknowledged before me by Margaret Robinson, Senior Counsel of American Tower (Tower Facility owner), personally known to me (or proved to me on the basis of satisfactory evidence) to be the person whose name is subscribed to the within instrument and acknowledged to me that he/she executed the same.

WITNESS my hand and official seal, this 27.14 day of February, 20.19

NOTARY S

GERARD T. HEFFRON Notary Public Commonwealth of Massachusetts My Commission Expires August 9, 2024

Notary Public / Care [. My Commission Expires: 0/9/

American Tower as used herein is defined as American Tower Asset Sub, LLC and any of its affiliates for *f* subsidiaries.



NB+C, LLC 100 Apollo Drive Suite 303 Chelmsford, MA 01824 Agent for American Tower Corporation David Hoogasian – Project Manager 508-344-3343 dhoogasian@nbcllc.com

February 25, 2019

Melanie A. Bachman Acting Executive Director Connecticut Siting Council 10 Franklin Square New Britain, CT 06051

#### Notice of Exempt Modification Facility Address 605 Willard Avenue, Newington, CT 06111 // ATC SITE: 370627 NEWINGTON CT Facility Coordinates (N) 41.69837222 (W) 72.73714722

Dear Ms. Bachman:

American Tower Corporation, Inc (ATC) currently maintains an Existing Cellular Tower Facility (179' Monopole) at 605 Willard Avenue, Newington, CT 06111, Parcel ID: 09/300/000 in the Town of Newington. The property is owned by The Town of Newington. American Tower Corporation, Inc (ATC) now intends install an automatic transfer switch and remote monitoring communications circuitry, to an existing optional standby generator, within the leased, fenced ground space area of the facility. The purpose of the installation is to allow for a shared back up emergency power option for its current (and future) wireless carrier tenants.

This tower facility was approved by the Town of Newington in 2002. Because the proposed transfer switch and monitoring system are within the existing, approved compound space, and the applicant is NOT requesting expansion of ground space beyond the approved conditions, this modification request complies with the conditions of the original Tower Approval.

Please accept this letter, as notification pursuant to Regulations of Connecticut State Agencies @16-50j-73, for construction that constitutes an exempt modification pursuant to R.C.S.A. @16-50j-72(b)(2). IN accordance with R.C.S.A. @16-50j-73, a copy of this letter is being sent to Mayor Roy Zartarian of the Town of Newington, Craig Minor, Newington Town Planner, as well as the property owner and tower owner.

### ATTACHMENT A

The planned modifications to the facility fall squarely within those activities explicitly provided for in R.C.S.A @ 16-50j-72(b)(2).

- 1. The proposed modifications will not result in an increase in the height of the existing structure.
- 2. The proposed modifications will not require the extension of the site boundary
- 3. The proposed modifications will not increase noise levels at the facility by six decibels or more, or to levels that exceed state and local criteria.
- 4. The operation of the generator back up power facility will not increase radio frequency emissions at the facility to the level at or above the Federal Communications Commission safety standard.
- 5. The proposed modifications will not cause a change or alteration in the physical or environmental characteristics of the site.
- 6. The existing structure and its foundation can support the proposed loading if the tower will be reenforced to support them. <<< <u>NOTE</u> – This condition is N/A. The proposed Generator attachments are based on the ground, and not associated or loaded onto the tower or foundation.

For the foregoing reasons, American Tower Corporation (ATC) respectfully submits that the proposed modifications to the above referenced telecommunications facility constitute an exempt modification under R.C.S.A. @16-50j-72(b)(2).

Sincerely,

David Hoogasian

#### Attachments

Cc:

Mayor Roy Zartarian – Chief Elected Official Craig Minor - Town Planner, Town of Newington American Tower Corporation (ATC) – Tower owner The Town of Newington – Property owner The Assessor's office is responsible for the maintenance of records on the ownership of properties. Assessments are computed at 70% of the estimated market value of real property at the time of the last revaluation which was 2015.



Information on the Property Records for the Municipality of Newington was last updated on 2/23/2019.

### Property Summary Information

rcel Data And V	Values	Building 🔻	Outbuildings	Sales Permits		
			Parce	l Information		
Location:	605 V	VILLARD AVE	Property Use:	School	Primary Use:	Elementary School
Unique ID:	N0046500		Map Block Lot:	09/300/000	Acres:	80.59
490 Acres:	0.00		Zone:	R-12/	Volume / Page:	189/67
Developers Map / Lot:	N/W 1	1860 & 1969	Census:			

### Value Information

	Appraised Value	Assessed Value
Land	8,147,790	5,703,450
Buildings	22,823,428	15,976,410

	Appraised Value	Assessed Value		
Detached Outbuildings	534,775	374,340		
Total	31,505,993	22,054,200		
	<b>Owner's Information</b>			
	Owner's Data			
NEWINGTON TOWN OF				
	NEWINGTON HIGH SCHOOL 131 CEDAR ST			

Back To Search (JavaScript:window.history.back(1);)

Print View (PrintPage.aspx?towncode=094&uniqueid=N0046500)

Information Published With Permission From The Assessor

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From:	TrackingUpdates@fedex.com
Sent:	Wednesday, February 27, 2019 10:05 AM
То:	David Hoogasian
Subject:	FedEx Shipment 774551851260 Delivered

### Tracking # 774551851260



### **Shipment Facts**

Our records indicate that the following package has been delivered.

Tracking number:	774551851260
Status:	Delivered: 02/27/2019 10:01 AM Signed for By: H.SHONTY
Reference:	100510
Signed for by:	H.SHONTY
Delivery location:	NEWINGTON, CT
Delivered to:	Receptionist/Front Desk
Service type:	FedEx 2Day®
Packaging type:	FedEx® Envelope
Number of pieces:	1
Weight:	0.50 lb.
Special handling/Services:	Adult Signature Required
	Deliver Weekday
Standard transit:	2/27/2019 by 4:30 pm



Please do not respond to this message. This email was sent from an unattended mailbox. This report was generated at approximately 9:04 AM CST on 02/27/2019.

All weights are estimated.


To track the latest status of your shipment, click on the tracking number above.

Standard transit is the date and time the package is scheduled to be delivered by, based on the selected service, destination and ship date. Limitations and exceptions may apply. Please see the FedEx Service Guide for terms and conditions of service, including the FedEx Money-Back Guarantee, or contact your FedEx Customer Support representative.

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From:	TrackingUpdates@fedex.com
Sent:	Friday, March 01, 2019 9:59 AM
То:	David Hoogasian
Subject:	FedEx Shipment 774552005791 Delivered

## Tracking # 774552005791

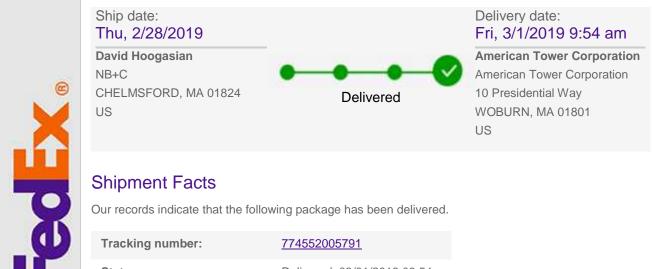

### **Shipment Facts**

Our records indicate that the following package has been delivered.

Tracking number:	774552005791
Status:	Delivered: 03/01/2019 09:54 AM Signed for By: P.ANCRI
Reference:	100510
Signed for by:	P.ANCRI
Delivery location:	WOBURN, MA
Delivered to:	Receptionist/Front Desk
Service type:	FedEx Standard Overnight®
Packaging type:	FedEx® Envelope
Number of pieces:	1
Weight:	0.50 lb.
Special handling/Services:	Adult Signature Required
	Deliver Weekday
Standard transit:	3/1/2019 by 3:00 pm

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All weights are estimated.


To track the latest status of your shipment, click on the tracking number above.

Standard transit is the date and time the package is scheduled to be delivered by, based on the selected service, destination and ship date. Limitations and exceptions may apply. Please see the FedEx Service Guide for terms and conditions of service, including the FedEx Money-Back Guarantee, or contact your FedEx Customer Support representative.

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From:	TrackingUpdates@fedex.com
Sent:	Wednesday, February 27, 2019 10:03 AM
То:	David Hoogasian
Subject:	FedEx Shipment 774551899530 Delivered

### Tracking # 774551899530

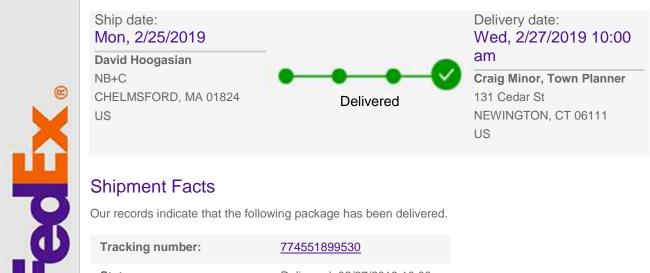

### **Shipment Facts**

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Our records indicate that the following package has been delivered.

Tracking number:	774551899530
Status:	Delivered: 02/27/2019 10:00 AM Signed for By: <u>J.IM</u>
Reference:	100510
Signed for by:	<u>J.IM</u>
Delivery location:	NEWINGTON, CT
Delivered to:	Receptionist/Front Desk
Service type:	FedEx 2Day®
Packaging type:	FedEx® Envelope
Number of pieces:	1
Weight:	0.50 lb.
Special handling/Services:	Adult Signature Required
	Deliver Weekday
Standard transit:	2/27/2019 by 4:30 pm

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All weights are estimated.


To track the latest status of your shipment, click on the tracking number above.

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From:	TrackingUpdates@fedex.com
Sent:	Wednesday, February 27, 2019 10:03 AM
То:	David Hoogasian
Subject:	FedEx Shipment 774551933594 Delivered

### Tracking # 774551933594



### **Shipment Facts**

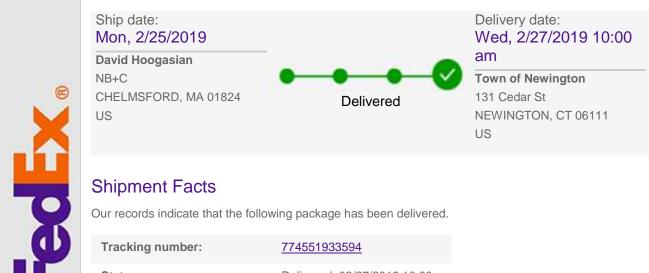e

Our records indicate that the following package has been delivered.

Tracking number:	774551933594
Status:	Delivered: 02/27/2019 10:00 AM Signed for By: <u>J.IM</u>
Reference:	100510
Signed for by:	<u>J.IM</u>
Delivery location:	NEWINGTON, CT
Delivered to:	Receptionist/Front Desk
Service type:	FedEx 2Day®
Packaging type:	FedEx® Envelope
Number of pieces:	1
Weight:	0.50 lb.
Special handling/Services:	Adult Signature Required
	Deliver Weekday
Standard transit:	2/27/2019 by 4:30 pm


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## **AMERICAN TOWER®**

ATC SITE NAME: NEWINGTON CT SITE NUMBER: 370627 SITE ADDRESS: 605 WILLARD AVE NEWINGTON, CT 06111



## SHARED GENERATOR PROGRAM ADDITIONAL TENANT

COMPLIANCE CODE	PROJECT SUMMARY	PROJECT DESCRIPTION		SHEET INDEX			
ALL WORK SHALL BE PERFORMED AND MATERIALS INSTALLED IN ACCORDANCE WITH THE CURRENT EDITIONS OF THE	SITE ADDRESS:	THE PROPOSED PROJECT INSTALLS AN AUTOMATIC TRANSFER	SHEET NO:	DESCRIPTION:	REV:	DATE:	BY:
FOLLOWING CODES AS ADOPTED BY THE LOCAL GOVERNMENT AUTHORITIES. NOTHING IN THESE PLANS IS	605 WILLARD AVE NEWINGTON, CT 06111	SWITCH AND REMOTE MONITORING COMMUNICATIONS CIRCUITRY, TO AN EXISTING GENERATOR OPTIONAL STANDBY SYSTEM FOR A COMMUNICATION TOWER TENANT.	G-001	TITLE SHEET	0	01/09/19	MG
TO BE CONSTRUED TO PERMIT WORK NOT CONFORMING TO THESE CODES.	COUNTY: HARTFORD	SYSTEM FOR A COMMUNICATION TOWER TENANT.	G-002	GENERAL NOTES	0	01/09/19	MG
	GEOGRAPHIC COORDINATES:	PROJECT NOTES	C-101	SITE PLAN	0	01/09/19	MG
1. INTERNATIONAL BUILDING CODE (IBC)	LATITUDE: 41.69837222 LONGITUDE: -72.73714722		C-501	TRENCHING AND H-FRAME DETAILS	0	01/09/19	MG
2. NATIONAL ELECTRIC CODE (NEC)	GROUND ELEVATION: 103' AMSL	1. THE FACILITY IS UNMANNED.	E-601	ELECTRICAL ONE-LINE	0	01/09/19	MG
3. LOCAL BUILDING CODE	ZONING INFORMATION:	2. A TECHNICIAN WILL VISIT THE SITE APPROXIMATELY ONCE A MONTH FOR ROUTINE INSPECTION AND MAINTENANCE.					
4. CITY/COUNTY ORDINANCES	JURISDICTION: HARTFORD	<ol> <li>THE PROJECT WILL NOT RESULT IN ANY SIGNIFICANT LAND DISTURBANCE OR EFFECT OF STORM WATER DRAINAGE.</li> </ol>					
		<ol> <li>NO SANITARY SEWER, POTABLE WATER OR TRASH DISPOSAL IS REQUIRED.</li> </ol>					
	PROJECT TEAM	5. HANDICAP ACCESS IS NOT REQUIRED.					
	ATC REGIONAL NETWORK DEVELOPMENT PROJECT MANAGER:						
UTILITY COMPANIES	GREG CSAPO (919) 749-6927						
POWER COMPANY: CONNECTICUT LIGHT AND POWER PHONE: (888) 783-6617	ATC NETWORK OPERATIONS CENTER: (877) 518-6937						
TELEPHONE COMPANY: FRONTIER COMMUNICATIONS PHONE: (800) 921-8102	TOWER OWNER:		-				
1110NL. (000) 921-0102	AMERICAN TOWER	PROJECT LOCATION DIRECTIONS					
	10 PRESIDENTIAL WAY WOBURN, MA 01801	FROM HARTFORD, CT:					
811	PROPERTY OWNER: TOWN OF NEWINGTON 131 CEDAR ST NEWINGTON, CT 06111 ENGINEERED BY:	HEAD SOUTH ON MAIN ST TOWARD TOWER SQUARE/TURN RIGHT ONTO GOLD ST/TURN LEFT ONTO TRUMBULL ST/AT THE TRAFFIC CIRCLE, TAKE THE 3RD EXIT ONTO WHITEHEAD HWY HEADING TO I-91/KEEP RIGHT AT THE FORK, FOLLOW SIGNS FOR I-91 AND MERGE ONTO I-91 S/TAKE EXIT 28 TO MERGE ONTO CT-15 S TOWARD NEWINGTON/CONTINUE ONTO CT-15 S/TAKE THE EXIT TOWARD CT-175 W/CONTINUE ONTO RUSSEL					
Know what's <b>below.</b> Call before you dig.	ATC TOWER SERVICES 3500 REGENCY PARKWAY SUITE 100 CARY, NC 27518	RD/TURN RIGHT ONTO E CEDAR ST/TURN RIGHT ONTO WILLARD AVE					
	0ART, NO 21010	DESTINATION WILL BE ON THE LEFT					

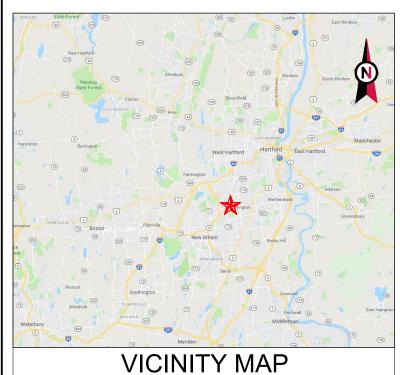AMERICAN TOWN A.T. ENGINEERING SERVIC 3500 REGENCY PARKWAY SUITE 100 CARY, NC 27518 PHONE: (919) 468-0112 COA: PEC.0001553	E, PLLC
THESE DRAWINGS AND/OR THE ACCOMPANYIN SPECIFICATION AS INSTRUMENTS OR SERVICE EXCLUSIVE PROPERTY OF AMERICAN TOWER. T PUBLICATION SHALL BE RESTRICTED TO THE OI FOR WHICH THEY ARE PREPARED. ANY USE OR OTHER THAN THAT WHICH RELATES TO AMERIC THE SPECIFIED CARRIER IS STRICTLY PROHIBIT THESE DOCUMENTS SHALL REMAIN THE PROPE AMERICAN TOWER WHETHER OR NOT THE PRO EXECUTED. NEITHER THE ARCHITECT NOR THE BE PROVIDING ON-SITE CONSTRUCTION REVIEW PROJECT. CONTRACTORIS MUST VERIFY ALL D ADVISE AMERICAN TOWER OF ANY DISCREPAN. ISSUANCE OF THIS DRAWING IS SUPERSEDED E VERSION ON FILE WITH AMERICAN TOWER.	ARE THE HEIR USE AND XIGINAL SITE DISCLOSURE AN TOWER OR ED. TITLE TO RTY OF JECT IS ENGINEER WILL V OF THIS IMENSIONS AND JES. ANY PRIOR
REV. DESCRIPTION E	Y DATE
	<u>G_01/09/19</u>
Δ	
ATC SITE NUMBER:	
370627	
ATC SITE NAME:	
NEWINGTON C	т
SITE ADDRESS: 605 WILLARD AVE	
NEWINGTON, CT 06111	
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DRAWN BY: MG APPROVED BY: PPB DATE DRAWN: 01/09/19 ATC JOB NO: 12643568	
DRAWN BY: MG APPROVED BY: PPB DATE DRAWN: 01/09/19 ATC JOB NO: 12643568 TITLE SHEET	

#### GENERAL CONSTRUCTION NOTES:

- ALL WORK SHALL CONFORM TO ALL CURRENT APPLICABLE FEDERAL, STATE, AND LOCAL CODES, INCLUDING ANSI/EIA/TIA-222, AND COMPLY WITH ATC MASTER SPECIFICATIONS.
- 2. CONTRACTOR SHALL CONTACT LOCAL 811 FOR IDENTIFICATION OF UNDERGROUND UTILITIES PRIOR TO START OF CONSTRUCTION.
- CONTRACTOR SHALL BE RESPONSIBLE FOR COORDINATING ALL REQUIRED INSPECTIONS. 3.
- ALL DIMENSIONS TO, OF, AND ON EXISTING BUILDINGS, DRAINAGE STRUCTURES, AND SITE IMPROVEMENTS SHALL BE VERIFIED IN FIELD BY CONTRACTOR WITH ALL DISCREPANCIES REPORTED TO THE ENGINEER
- DO NOT CHANGE SIZE OR SPACING OF STRUCTURAL ELEMENTS. 5
- DETAILS SHOWN ARE TYPICAL; SIMILAR DETAILS APPLY TO SIMILAR CONDITIONS UNLESS 6.
- 7. THESE DRAWINGS DO NOT INCLUDE NECESSARY COMPONENTS FOR CONSTRUCTION SAFETY WHICH SHALL BE THE SOLE RESPONSIBILITY OF THE CONTRACTOR
- CONTRACTOR SHALL BRACE STRUCTURES UNTIL ALL STRUCTURAL ELEMENTS NEEDED FOR STABILITY ARE INSTALLED. THESE ELEMENTS ARE AS FOLLOWS: LATERAL BRACING, ANCHOR BOLTS, ETC
- CONTRACTOR SHALL DETERMINE EXACT LOCATION OF EXISTING UTILITIES, GROUNDS DRAINS, 9. DRAIN PIPES, VENTS, ETC, BEFORE COMMENCING WORK
- INCORRECTLY FABRICATED, DAMAGED, OR OTHERWISE MISFITTING OR NONCONFORMING MATERIALS OR CONDITIONS SHALL BE REPORTED TO THE ATC CM PRIOR TO REMEDIAL OR CORRECTIVE ACTION. ANY SUCH REMEDIAL ACTION SHALL REQUIRE WRITTEN APPROVAL BY THE ATC CM PRIOR TO PROCEEDING.
- 11. EACH CONTRACTOR SHALL COOPERATE WITH THE ATC CM, AND COORDINATE HIS WORK WITH THE WORK OF OTHERS
- 12. CONTRACTOR SHALL REPAIR ANY DAMAGE CAUSED BY CONSTRUCTION OF THIS PROJECT TO MATCH EXISTING PRE-CONSTRUCTION CONDITIONS TO THE SATISFACTION OF THE ATC CONSTRUCTION MANAGER.
- 13. ALL CABLE/CONDUIT ENTRY/EXIT PORTS SHALL BE WEATHERPROOFED DURING INSTALLATION USING A SILICONE SEALANT.
- 14. WHERE EXISTING CONDITIONS DO NOT MATCH THOSE SHOWN IN THIS PLAN SET, CONTRACTOR SHALL NOTIFY THE ATC CONSTRUCTION MANAGER IMMEDIATELY
- CONTRACTOR SHALL ENSURE ALL SUBCONTRACTORS ARE PROVIDED WITH A COMPLETE AND CURRENT SET OF DRAWINGS AND SPECIFICATIONS FOR THIS PROJECT.
- CONTRACTOR SHALL REMOVE ALL RUBBISH AND DEBRIS FROM THE SITE AT THE END OF EACH 16. DAY
- CONTRACTOR SHALL COORDINATE WORK SCHEDULE WITH LANDLORD AND TAKE PRECAUTIONS TO MINIMIZE IMPACT AND DISRUPTION OF OTHER OCCUPANTS OF THE FACILITY.
- CONTRACTOR SHALL FURNISH ATC WITH A PDF MARKED UP AS-BUILT SET OF DRAWINGS UPON 18. COMPLETION OF WORK
- PRIOR TO SUBMISSION OF BID. CONTRACTOR SHALL COORDINATE WITH ATC CM TO DETERMINE 19. WHAT, IF ANY, ITEMS WILL BE PROVIDED. ALL ITEMS NOT PROVIDED SHALL BE PROVIDED AND INSTALLED BY THE CONTRACTOR. CONTRACTOR WILL INSTALL ALL ITEMS PROVIDED.
- PRIOR TO SUBMISSION OF BID, CONTRACTOR SHALL COORDINATE WITH ATC CONSTRUCTION 20. MANAGER TO DETERMINE IF ANY PERMITS WILL BE OBTAINED BY ATC. ALL REQUIRED PERMITS NOT OBTAINED BY ATC MUST BE OBTAINED, AND PAID FOR, BY THE CONTRACTOR.
- CONTRACTOR SHALL INSTALL ALL SITE SIGNAGE IN ACCORDANCE WITH ATC SPECIFICATIONS 21 AND REQUIREMENTS.
- 22. CONTRACTOR SHALL SUBMIT ALL SHOP DRAWINGS TO ATC FOR REVIEW AND APPROVAL PRIOR TO FABRICATION
- ALL FOUIPMENT SHALL BE INSTALLED ACCORDING TO MANUFACTURER'S SPECIFICATIONS AND 23. LOCATED ACCORDING TO ATC SPECIFICATIONS, AND AS SHOWN IN THESE PLANS.
- THE CONTRACTOR SHALL SUPERVISE AND DIRECT THE PROJECT DESCRIBED HEREIN. THE 24 CONTRACTOR SHALL BE SOLELY RESPONSIBLE FOR ALL THE CONSTRUCTION MEANS, METHODS, TECHNIQUES, SEQUENCES AND PROCEDURES AND FOR COORDINATING ALL PORTIONS OF THE WORK UNDER THE CONTRACT.
- CONTRACTOR SHALL NOTIFY ATC CM A MINIMUM OF 48 HOURS IN ADVANCE OF POURING 25. CONCRETE OR BACKFILLING ANY UNDERGROUND UTILITIES, FOUNDATIONS OR SEALING ANY WALL, FLOOR OR ROOF PENETRATIONS FOR ENGINEERING REVIEW AND APPROVAL
- CONTRACTOR SHALL BE RESPONSIBLE FOR SITE SAFETY INCLUDING COMPLIANCE WITH ALL APPLICABLE OSHA STANDARDS AND RECOMMENDATIONS AND SHALL PROVIDE ALL NECESSARY SAFETY DEVICES INCLUDING PPE AND PPM AND CONSTRUCTION DEVICES SUCH AS WELDING AND FIRE PREVENTION. TEMPORARY SHORING. SCAFFOLDING. TRENCH BOXES/SLOPING. BARRIERS ETC.
- 27. THE CONTRACTOR SHALL PROTECT AT HIS OWN EXPENSE, ALL EXISTING FACILITIES AND SUCH OF HIS NEW WORK LIABLE TO INJURY DURING THE CONSTRUCTION PERIOD. ANY DAMAGE CAUSED BY NEGLECT ON THE PART OF THIS CONTRACTOR OR HIS REPRESENTATIVES, OR BY THE ELEMENTS DUE TO NEGLECT ON THE PART OF THIS CONTRACTOR OR HIS

REPRESENTATIVES. EITHER TO THE EXISTING WORK, OR TO HIS WORK OR THE WORK OF ANY OTHER CONTRACTOR. SHALL BE REPAIRED AT HIS EXPENSE TO THE OWNER'S SATISFACTION

- 28. ALL WORK SHALL BE INSTALLED IN A FIRST CLASS, NEAT AND WORKMANLIKE MANNER BY MECHANICS SKILLED IN THE TRADE INVOLVED. THE QUALITY OF WORKMANSHIP SHALL BE SUBJECT TO THE APPROVAL OF THE ATC CM. ANY WORK FOUND BY THE ATC CM TO BE OF INFERIOR QUALITY AND/OR WORKMANSHIP SHALL BE REPLACED AND/OR REWORKED AT CONTRACTOR EXPENSE UNTIL APPROVAL IS OBTAINED.
- 29. IN ORDER TO ESTABLISH STANDARDS OF QUALITY AND PERFORMANCE, ALL TYPES OF MATERIALS LISTED HEREINAETER BY MANUFACTURER'S NAMES AND/OR MANUFACTURER'S CATALOG NUMBER SHALL BE PROVIDED BY THESE MANUFACTURERS AS SPECIFIED.

#### CONCRETE AND REINFORCING STEEL NOTES:

- DESIGN AND CONSTRUCTION OF ALL CONCRETE ELEMENTS SHALL CONFORM TO THE LATEST EDITIONS OF ALL APPLICABLE CODES INCLUDING: ACI 301 "SPECIFICATIONS FOR STRUCTURAL CONCRETE FOR BUILDINGS", ACI 117 "SPECIFICATIONS FOR TOLERANCES FOR CONCRETE CONSTRUCTION AND MATERIALS", AND ACI 318 "BUILDING CODE REQUIREMENTS FOR REINFORCED CONCRETE "
- 2. MIX DESIGN SHALL BE APPROVED BY ATC CM PRIOR TO PLACING CONCRETE.
- 3. CONCRETE SHALL BE NORMAL WEIGHT, 6 % AIR ENTRAINED (+/- 1.5%) WITH A SLUMP RANGE OF 3-5" AND HAVE A MINIMUM 28-DAY COMPRESSIVE STRENGTH OF 4000 PSI UNLESS OTHERWISE NOTED
- 4. THE FOLLOWING MATERIALS SHALL BE USED:

PORTLAND CEMENT:

REINFORCEMENT BARS:

REINFORCEMENT:

WATER

ADMIXTURES

ASTM C150, TYPE 2 ASTM A185, PLAIN STEEL WELDED WIRE FABRIC ASTM A615, GRADE 60, DEFORMED NORMAL WEIGHT AGGREGATE: ASTM C33 ASTM C 94/C 94M

- -WATER-REDUCING AGENT: ASTM C 494/C 494M, TYPE A -AIR-ENTERING AGENT ASTM C 260/C 260M -SUPERPLASTICIZER: ASTM C494, TYPE F OR TYPE G -RETARDING: ASTM C 494/C 494M, TYPE B
- 5. MINIMUM CONCRETE COVER FOR REINFORCING STEEL SHALL BE NO LESS THAN 3".
- A 3/4" CHAMFER SHALL BE PROVIDED AT ALL EXPOSED EDGES OF CONCRETE IN ACCORDANCE WITH ACI 301 SECTION 4.2.4, UNLESS NOTED OTHERWISE.
- INSTALLATION OF CONCRETE EXPANSION/WEDGE ANCHOR SHALL BE PER MANUFACTURER'S 7 WRITTEN RECOMMENDED PROCEDURE. THE ANCHOR BOLT, DOWEL, OR ROD SHALL CONFORM TO MANUFACTURER'S RECOMMENDATION FOR EMBEDMENT DEPTH OR AS SHOWN ON THE DRAWINGS. NO REBAR SHALL BE CUT WITHOUT PRIOR ATC CM APPROVAL WHEN DRILLING HOLES IN CONCRETE
- ADMIXTURES SHALL CONFORM TO THE APPROPRIATE ASTM STANDARD AS REFERENCED IN 8. "METHOD 1" OF ACL301
- DO NOT WELD OR TACK WELD REINFORCING STEEL.
- ALL DOWELS ANCHOR BOLTS EMBEDDED STEEL ELECTRICAL CONDUITS PIPE SLEEVES 10 GROUNDS AND ALL OTHER EMBEDDED ITEMS AND FORMED DETAILS SHALL BE IN PLACE BEFORE START OF CONCRETE PLACEMENT
- 11. REINFORCEMENT SHALL BE COLD BENT WHENEVER BENDING IS REQUIRED.
- 12. DO NOT PLACE CONCRETE IN WATER, ICE, OR ON FROZEN GROUND.
- 13. DO NOT ALLOW REINFORCEMENT, CONCRETE OR SUBBASE TO FREEZE DURING CONCRETE CURING AND SETTING PERIOD, OR FOR A MINIMUM OF 3 DAYS AFTER PLACEMENT.
- 14. FOR COLD-WEATHER(ACI 306) AND HOT-WEATHER(ACI 301M) CONCRETE PLACEMENT, CONFORM TO APPLICABLE ACI CODES AND RECOMMENDATIONS. IN EITHER CASE, MATERIALS CONTAINING CHLORIDE, CALCIUM, SALTS, ETC. SHALL NOT BE USED. PROTECT FRESH CONCRETE FROM WEATHER FOR 7 DAYS, MINIMUM
- 15. ALL CONCRETE SHALL HAVE A "SMOOTH FORM FINISH."
- 16. UNLESS OTHERWISE NOTED:
  - A. ALL REINFORCING STEEL SHALL BE DEFORMED BARS CONFORMING TO ASTM A615/A 615M/A-996, GRADE 60.
  - B. WELDED WIRE FABRIC SHALL CONFORM TO ASTM A185.
- SPLICING OF REINFORCEMENT IS PERMITTED ONLY AT LOCATIONS SHOWN IN THE CONTRACT 17 DRAWINGS OR AS ACCEPTED BY THE ENGINEER. UNLESS OTHERWISE SHOWN OR NOTED REINFORCING STEEL SHALL BE SPLICED TO DEVELOP ITS FULL TENSILE CAPACITY (CLASS A) IN ACCORDANCE WITH ACI 318.
- REINFORCING BAR DEVELOPMENT LENGTHS, AS COMPUTED IN ACCORDANCE WITH ACI 318, 18. FORM THE BASIS FOR BAR EMBEDMENT LENGTHS AND BAR SPLICED LENGTHS SHOWN IN THE

DRAWINGS. APPLY APPROPRIATE MODIFICATION FACTOR COVER AND THE LIKE.

- 19 DETAILING OF REINFORCING STEEL SHALL CONFORM TO ' FOR DETAILING REINFORCED CONCRETE STRUCTURES" (A
- ALL SLAB CONSTRUCTION SHALL BE CAST MONOLITHICAL CONSTRUCTION JOINTS, UNLESS SHOWN IN THE CONTRA
- LOCATION OF ALL CONSTRUCTION JOINTS ARE SUBJECT 21 CONTRACT DOCUMENTS, CONFORMANCE WITH ACI 318, AI DRAWINGS SHOWING LOCATION OF DETAILS OF THE PROF BE SUBMITTED WITH REINFORCING STEEL PLACEMENT DR
- SPLICES OF WWF, AT ALL SPLICED EDGES, SHALL BE SUCH 22. BETWEEN OUTERMOST CROSS WIRES OF EACH FABRIC S OF THE CROSS WIRE PLUS 2 INCHES, NOR LESS THAN 6".
- BAR SUPPORTS SHALL BE ALL-GALVINIZED METAL WITH P 23
- ALL REINFORCEMENT SHALL BE SECURELY TIED IN PLACE 24 CONSTRUCTION TRAFFIC OR CONCRETE. TIE WIRE SHALL INTENDED PURPOSE, BUT NOT LESS THAN NO. 18 GAUGE
- SLAB ON GROUND.
  - A. COMPACT SUBGRADE AND ENSURE THERE IS PLACE B. PROVIDE VAPOR BARRIER BENEATH SLAB ON GROU

#### STRUCTURAL STEEL NOTES:

- STRUCTURAL STEEL SHALL CONFORM TO THE LATEST ED FOR THE DESIGN, FABRICATION AND ERECTION OF STRUC
- STRUCTURAL STEEL ROLLED SHAPES, PLATES AND BARS ASTM DESIGNATIONS
  - A. ASTM A-572, GRADE 50 ALL W SHAPES, UNLESS NO
  - B. ASTM A-36 ALL OTHER ROLLED SHAPES, PLATES A
  - C. ASTM A-500, GRADE B HSS SECTION (SQUARE, RE
  - D ASTM A-325 TYPE SC OR N ALL BOLTS FOR CONN
  - E. ASTM F-1554 07 ALL ANCHOR BOLTS, UNLESS NO
- ALL EXPOSED STRUCTURAL STEEL MEMBERS SHALL BE H 3 FABRICATION PER ASTM A123, EXPOSED STEEL HARDWAF GALVANIZED PER ASTM A153 OR B695
- ALL FIELD CUT SURFACES, FIELD DRILLED HOLES AND GR PAINT OR GALVANIZATION REMOVAL WAS REQUIRED SHA COATS OF ZRC GALVILITE COLD GALVANIZING COMPOUND MANUFACTURER'S RECOMMENDATIONS
- DO NOT DRILL HOLES THROUGH STRUCTURAL STEEL MEM DETAILED ON STRUCTURAL DRAWINGS

#### CONNECTIONS

- A. ALL WELDING TO BE PERFORMED BY AWS CERTIFIE ACCORDANCE WITH THE LATEST EDITION OF THE
- B. ALL WELDS SHALL BE INSPECTED VISUALLY. 25% O DYE PENETRANT OR MAGNETIC PARTICLE TO MEET D1.1. REPAIR ALL WELDS AS NECESSARY.
- C. INSPECTION SHALL BE PERFORMED BY AN AWS CE
- D. IT IS THE CONTRACTORS RESPONSIBILITY TO PRO REQUIRED BY LOCAL GOVERNING AUTHORITY AND DEPARTMENT DETAIL FOR ANY WELDING ACTIVITY.
- E. ALL ELECTRODES TO BE LOW HYDROGEN, MATCHI UNLESS NOTED OTHERWISE.
- F. MINIMUM WELD SIZE TO BE 0.1875 INCH FILLET WEL
- G. PRIOR TO FIELD WELDING GALVANIZING MATERIAL GALVANIZING 1/2" BEYOND ALL FIELD WELD SURFAC INSPECTION IS COMPLETE REPAIR ALL GROUND A GALVILITE COLD GALVANIZING COMPOUND PER AS RECOMMENDATIONS.


RS FOR TOP STEEL, BAR SPACING,	
'ACI MANUAL OF STANDARD PRACTICE ACI 315).	
LY WITHOUT HORIZONTAL CT DRAWINGS.	AMERICAN TOWER® A.T. ENGINEERING SERVICE, PLLC
TO THE REQUIREMENTS OF THE ND ACCEPTANCE OF THE ENGINEER. POSED CONSTRUCTION JOINTS SHALL RAWINGS.	3500 REGENCY PARKWAY SUITE 100 CARY, NC 27518 PHONE: (919) 468-0112 COA: PEC.0001553
H THAT THE OVERLAP MEASURED HEET IS NOT LESS THAN THE SPACING	THESE DRAWINGS AND/OR THE ACCOMPANYING SPECIFICATION AS INSTRUMENTS OR SERVICE ARE THE EXCLUSIVE PROPERTY OF AMERICAN TOWER. THEIR USE AND PUBLICATION SHALL BE RESTRICTED TO THE ORIGINAL SITE
LASTIC TIPS.	FOR WHICH THEY ARE PREPARED. ANY USE OR DISCLOSURE OTHER THAN THAT WHICH RELATES TO AMERICAN TOWER OR THE SPECIFIED CARRIER IS STRICTLY PROHIBITED. TITLE TO
TO PREVENT DISPLACEMENT BY BE OF SUFFICIENT STRENGTH FOR	THESE DOCUMENTS SHALL REMAIN THE PROPERTY OF AMERICAN TOWER WHETHER OR NOT THE PROJECT IS EXECUTED. NEITHER THE ARCHITECT NOR THE ENGINEER WILL BE PROVIDING ON-SITE CONSTRUCTION REVIEW OF THIS PROJECT. CONTRACTOR(S) MUST VERIFY ALL DIMENSIONS AND ADVISE AMERICAN TOWER OF ANY DISCREPANCIES. ANY PRIOR ISSUANCE OF THIS DRAWING IS SUPERSEDED BY THE LATEST
CE 6" GRAVEL BENEATH SLAB.	VERSION ON FILE WITH AMERICAN TOWER.
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SHALL CONFORM TO THE FOLLOWING	
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ECTING STRUCTURAL MEMBERS	
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IBERS EXCEPT AS SHOWN AND	
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OF WELDS SHALL BE INSPECTED WITH T THE ACCEPTANCE CRITERIA OF AWS	
RTIFIED WELD INSPECTOR.	<b>T</b> ••Mobile•
VIDE BURNING/WELDING PERMITS AS I IF REQUIRED SHALL HAVE FIRE	- <u>1</u> - <u>1</u> vioniie-
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NG FILLER METAL, PER AWS D1.1, LDS, UNLESS NOTED OTHERWISE.	DATE DRAWN:         01/09/19           ATC JOB NO:         12643568
LDS, UNLESS NOTED OTHERWISE. , CONTRACTOR SHALL GRIND OFF JES. AFTER WELD AND WELD ND WELDED SURFACES WITH ZRC	ATC JOB NO: 12643568


#### SITE PLAN NOTES:

- THIS SITE PLAN REPRESENTS THE BEST PRESENT KNOWLEDGE AVAILABLE TO THE ENGINEER AT THE TIME OF THIS DESIGN. THE CONTRACTOR SHALL VISIT THE SITE PRIOR TO CONSTRUCTION AND VERIFY ALL EXISTING CONDITIONS RELATED TO THE SCOPE OF WORK FOR THIS PROJECT.
- ICE BRIDGE, CABLE LADDER, COAX PORT, AND COAX CABLE ARE SHOWN FOR 2. REFERENCE ONLY. CONTRACTOR SHALL CONFIRM THE EXACT LOCATION OF ALL PROPOSED AND EXISTING EQUIPMENT AND STRUCTURES DEPICTED ON THIS PLAN. BEFORE UTILIZING EXISTING CABLE SUPPORTS, COAX PORTS, INSTALLING NEW PORTS OR ANY OTHER EQUIPMENT, CONTRACTOR SHALL VERIFY ALL ASPECTS OF THE COMPONENTS MEET THE ATC SPECIFICATIONS.
- IT IS THE RESPONSIBILITY OF THE CONTRACTOR TO COORDINATE WITH THE 3. ATC CONSTRUCTION MANAGER AND LOCAL UTILITY COMPANY FOR THE INSTALLATION OF CONDUITS, CONDUCTORS, BREAKERS, DISCONNECTS, OR ANY OTHER EQUIPMENT REQUIRED FOR ELECTRICAL SERVICE. ALL ELECTRICAL WORK SHALL BE PERFORMED IN ACCORDANCE WITH LATEST EDITION OF THE STATE AND NATIONAL CODES. ORDINANCES AND REGULATIONS APPLICABLE TO THIS PROJECT.
- 4 CONTRACTOR SHALL INSURE THAT ALL WORKING SPACE REQUIREMENTS ARE MET PER APPLICABLE CODES AND MANUFACTURER SPECIFICATIONS.
- 5. ABOVE GROUND CONDUITS NEED TO BE SUPPORTED/FASTENED PER NEC 344 AND PER ATC MASTER SPECIFICATIONS.
- 6. THE FOLLOWING SIGNS SHALL BE INSTALLED AT TENANT SERVICE MAIN DISCONNECT PER NEC 702.7.
- "CAUTION: TWO SOURCES OF SUPPLY STANDBY GENERATOR LOCATED 6.1. OUTDOORS"
- 6.2. CONDUCTOR OR BONDING JUMPER CONNECTION IN THIS EQUIPMENT IS REMOVED WHILE ALTERNATE SOURCE IS ENERGIZED"

RODENT CONTROL AROUND GENERATOR ENVELOPE:


- INSTALL ALL PROVIDED SEALS, PLUGS, COVERS, ETC. IN GENERATOR AND 1. FUEL TANK ENVELOPE. SEAL ALL REMAINING OPENINGS (EXCEPT NORMAL VENTING) WITH RODENT FOAM SEALANT. NO OPENING SHALL BE LARGER THAN 1/4 INCH ANY DIMENSION.
- SEAL ALL CONDUITS INCLUDING CONDUITS ENTERING GENERATOR 2. EQUIPMENT, BOXES, ATTACHMENTS, ETC. WITH RODENT FOAM SEALANT.
- SEAL ALL CONDUIT ACCESS OPENINGS THROUGH CONCRETE PAD WITH 3. CONCRETE
- 4. SLOPE GRAVEL BASE AT CONCRETE PAD PERIMETER FROM ABOVE PAD BASE TO EXISTING GRADE LEVEL TYPICAL ALL PERIMETER SIDES.

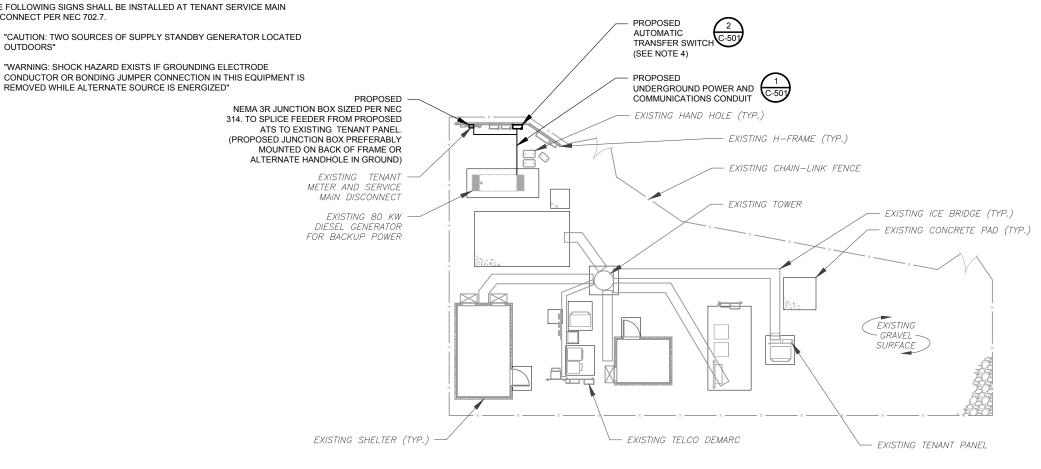

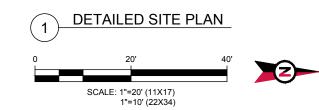

APPROXIMATE TRENCH LENGTHS 11' LINEAR DISTANCE FROM STANDBY GENERATOR TO POWER SOURCE

AMERICAN TO		
A.T. ENGINEERING SERV		PLLC
3500 REGENCY PARKV SUITE 100	VAY	
CARY, NC 27518		
PHONE: (919) 468-01		
COA: PEC.0001553		
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#### TRENCH NOTES:
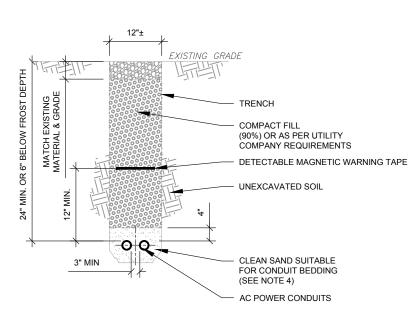
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- IF FREE OF ORGANIC OR OTHER DELETERIOUS MATERIAL, EXCAVATED 1. MATERIAL MAY BE USED FOR BACKFILL. IF NOT, PROVIDE CLEAN, COMPACTIBLE MATERIAL
- COMPACT IN 8" LIFTS USING A MECHANICAL PLATE TAMPER, MIN 3 PASSES. REMOVE ANY LARGE ROCKS PRIOR TO BACKFILLING. CONTRACTOR TO VERIFY LOCATION OF EXISTING U/G UTILITIES PRIOR TO DIGGING. SEE ATC MASTER 2. SPEC 312000 SECTION 3.15.
- IF CURRENT AS-BUILT DRAWINGS ARE NOT AVAILABLE CONTRACTOR SHALL 3 HAND DIG U/G TRENCHING.
- CONFIRM SPACING AND DEPTH WITH NEC OR LOCAL CODE REQUIREMENTS 4.

AC POWER CONDUIT TRENCH

#### SCALE: N.T.S.







